

ACTION PLANS

m: 0426 957 518

e: operations@actionplans.com.au

w: www.actionplans.com.au


DEVELOPMENT APPLICATION: \$4.55

These plans are for Development Approval only.

SHEET NUMBER	SHEET NAME	DATE PUBLISHED
MOD00	COVER	27/06/2025
MOD01	SITE ANALYSIS	27/06/2025
MOD02	SITE / ROOF / SEDIMENT EROSION / WASTE MANAGEMENT / STORMWATER CONCEPT PLAN	27/06/2025
MOD03	EXISTING GROUND FLOOR PLAN	27/06/2025
MOD04	EXISTING FIRST FLOOR PLAN	27/06/2025
MOD05	PROPOSED GARAGE FLOOR PLAN	27/06/2025
MOD06	PROPOSED GROUND FLOOR PLAN	27/06/2025
MOD07	PROPOSED FIRST FLOOR PLAN	27/06/2025
MOD08	NORTH / SOUTH ELEVATION	27/06/2025
MOD09	EAST ELEVATION	27/06/2025
MOD10	WEST ELEVATION	27/06/2025
MOD11	CROSS SECTION	27/06/2025
MOD12	LONG SECTION	27/06/2025
MOD13	DRIVEWAY PLAN / LONG SECTION	27/06/2025
MOD14	AREA CALCULATIONS	27/06/2025
MOD15	SAMPLE BOARD	27/06/2025
MOD16	WINTER SOLSTICE 9 AM	27/06/2025
MOD17	WINTER SOLSTICE 12 PM	27/06/2025
MOD18	WINTER SOLSTICE 3 PM	27/06/2025
MOD19	BASIX COMMITMENTS	27/06/2025

ITEM DETAILS	DEVELOPMENT APPLICATION			
ADDRESS	15 TANGO AVENUE, DEE WHY NSW 2099			
LOT & DP/SP	LOT 44 SEC B DP 8139			
COUNCIL	NORTHERN BEACHES COUNCIL (WARRINGAH)			
SITE AREA	645m²			
FRONTAGE	15.24m			
CONTROLS	PERMISSIBLE / REQUIRED	EXISTING	PROPOSED	COMPLIANCE
CONTROLS	m / m² / %	m / m² / %	m / m² / %	
<u>LEP</u>				
LAND ZONING	R2 – LOW DENSITY RESIDENTIAL	R2	R2	YES
MINIMUM LOT SIZE	600m²	645m²	UNCHANGED	YES
FLOOR SPACE RATIO	NOT IDENTIFIED	N/A	N/A	N/A
MAXIMUM BUILDING HEIGHT	8.5m	6.6m	UNCHANGED	YES
<u>HAZARDS</u>				
DEVELOPMENT ON SLOPING LAND	AREA A – SLOPES LESS THAN 5 DEGREES AREA B – SLOPES FROM 5 TO 25 DEGREES			PLEASE READ IN CONJUNCTION WITH STATEMENT OF ENVIRONMENTAL EFFECTS
<u>DCP</u>				
WALL HEIGHT	7.2m	6.319m	UNCHANGED	YES
NUMBER OF STOREYS	NOT IDENTIFIED	2	UNCHANGED	N/A
SIDE BOUNDARY ENVELOPE	5m		UNCHANGED	YES
SIDE BOUNDARY SETBACKS	0.9m	E: 0.359m W: 0.894m	UNCHANGED	NO (EXISTING)
FRONT BOUNDARY SETBACK	6.5m	DWELLING: 12.8m	D: UNCHANGED GARAGE: 5.028m	YES NO
REAR BOUNDARY SETBACK	6.0m	24.642m	17.989m	YES
LANDSCAPE OPEN SPACE	40% (258m²)	64% (413.05m²)	47% (304.61m²)	YES
PRIVATE OPEN SPACE	60m²	60m²	63.22m²	YES

15 TANGO AVENUE DEE WHY NSW 2099

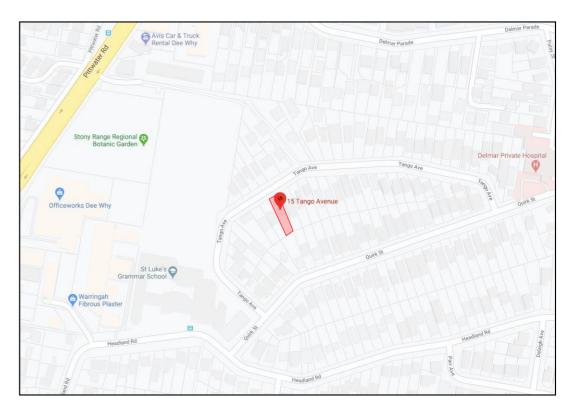

NCC & AS COMPLIANCES SPECIFICATIONS

- EARTHWORKS: METHOD OF EXCAVATIONAND FILL - PART 3.1.1 OF NCC
- SURFACE SUBSOIL-STORMWATER DRAINAGE - PART 3.1.2 OF NCC
- TERMITE-RISK MANAGEMENT - PART 3.1.3 OF NCC
- FOOTINGS & SLAB - PART 3.2 OF NCC INCLUDING AS2870
- MASONRY CONSTRUCTION - PART 3.3 OF NCC INCLUDING AS3700
- SUB FLOOR VENTILATION - PART 3.4.1 OF NCC
- FRAMING - PART 3.4 OF NCC
- ROOF, WALL-CLADDING, GUTTERS & DOWNPIPES - PART 3.5 OF NCC
- GLAZING - PART 3.6 OF NCC INCLUDING AS1288
- FIRE SEPARATION - PART 3.7.1 OF NCC
- SMOKE ALARMS - PART 3.7.2 OF NCC

- HEATING APPLIANCES - PART 3.7.3 OF NCC

- WET AREAS-PROTECTION OF WALLS & FLOORS - PART 3.8.1 OF NCC - MINIMUM ROOF HEIGHTS - PART 3.8.3 OF NCC

- FACILITIES REQUIRRED & SANITARY DOOR CONSTRUCTION - PART 3.8.3 OF NCC

- LIGHT: NATURAL AND ARTIFICIAL - PART 3.8.4 OF NCC - VENTILATION & LOCATION OF TOILETS - PART 3.8.5 OF NCC

- SOUND INSULATION - PART 3.8.6 OF NCC

- STAIR CONSTRUCTION INCLUDING DIMENSIONS - PART 3.9.1 OF NCC - BALUSTRADES & OTHER BARRIERS - PART 3.9.2 OF NCC

- FENCING & OTHER PROVISIONS - REGS & AS1926

- DEMOLITION WORKS - AS2601-1991 THE DEMOLITION OF STRUCTURES.

- ALL WATERPROOF MEMBRANES TO COMPLY WITH WITH AS 3740-2004 - ALL PLUMBING & DRAINAGE WORK TO COMPLY WITH AS 3500

> - SITE CLASSIFICATION AS TO AS 2870 - ALL PLASTERBOARD WORK TO COMPLY WITH AS 2588-1998

- ALL PLASTERBOARD WORK TO COMPLY WITH AS 2588-1998
- ALL STRUCTURAL STEEL WORK TO COMPLY WITH AS 4100 & AS 1554

- ALL CONCRETE WORK TO COMPLY WITH AS 3600

- ALL ROOF SHEETING WORK TO COMPLY WITH AS 1562-1992

- ALL SKYLIGHTS TO COMPLY WITH WITH AS 4285-2007


- ALL CERAMIC TILING TO COMPLY WITH AS 3958.1-2007 & 3958.2-1992


- ALL GLAZING ASSEMBLIES TO COMPLY WITH AS 2047 & 1288

- ALL TIMBER RETAINING WALLS ARE TO COMPLY WITH AS 1720.1-2010, AS 1720.2-2006, AS 1720.4-2006, AS 1170.1-1989 & AS 1170.4-1993

- ALL RETAINING WALLS ARE TO COMPLY WITH 3700 - 2011 & AS 3600 -2001

- ALL CONSTRUCTION TO COMPLY TO AS3959- 1991

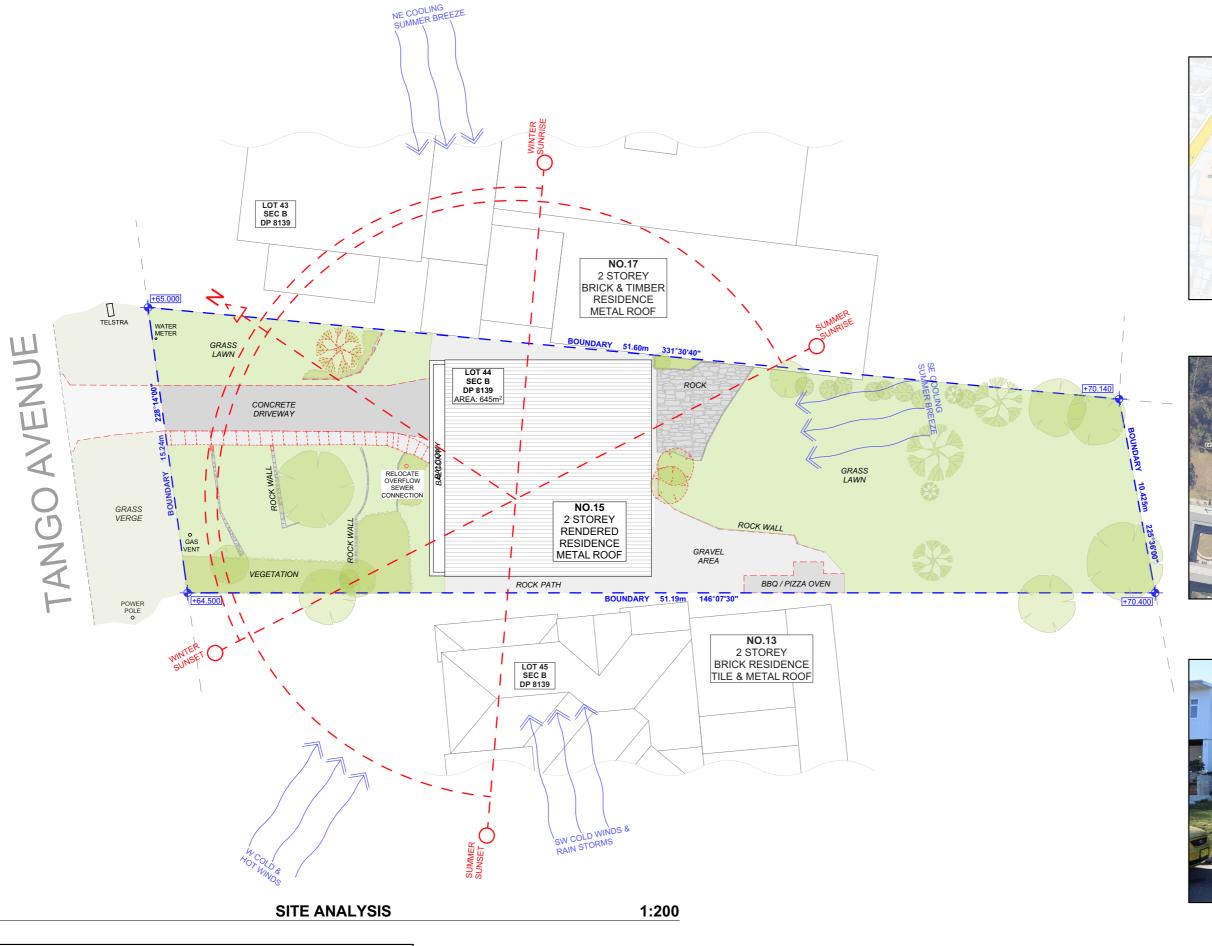

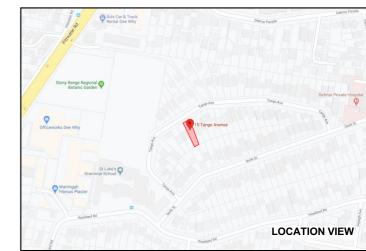






NOTE: ALL DEMOLISHED ELEMENTS TO ENG. SPECIFICATIONS AND AS. 2601 - 2001



	REV.	DATE	COMMENTS	DRWN	NOTES This drawing is the copyright of Action Plans and not be	L
,	А	27.06.2025	S 4.55 SUBMISSION	sc	altered, reproduced or transmitted in any form or by any means in part or in whole with the written permission of	
					Action Plans. Do not scale measure from drawings. Figured dimensions	
					are to be used only. The Builder/Contractor shall check and verify all levels and	
au					dimensions on site prior to commencement of any work, creation of shop drawings, or fabrication of components.	
					All errors and omissions are to be verified by the Builder/Contractor and referred to the designer prior to the	_
					commencement of works.	

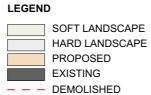

EX. EXISTING
DP. DOWNPIPE
PROP. PROPOSED
DP. DOWNPIPE

CLIENT

MARK HOPKINS &
CATHERINE MANU


PROJECT ADDRESS 15 TANGO AVENUE DEE WHY NSW 2099 DRAWING NO.

MOD01

DATEFriday, 27 June 2025

SITE ANALYSIS

DRAWING NAME

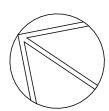



SEDIMENT FENCE

DUST CONTROL:

TO REDUCE DUST GENERATED BY WIND ACTION, THE REMOVAL OF THE TOP SOIL IS TO BE MINIMISED. TO PREVENT DUST GENERATION, WATERING DOWN OF THE SITE, ESPECIALLY DURING THE MOVEMENT OF MACHINERY IS REQUIRED. WHERE EXCAVATING INTO ROCK, KEEP THE SURFACE MOIST TO MINIMISE DUST. CONSTRUCT A GRAVEL ENTRY/EXIT POINT USING BLUE METAL AND RESTRICT ALL VEHICLE MOVEMENTS WITHIN THE SITE TO A MINIMUM. ENSURE WIND BREAKS, SUCH AS EXISTING FENCES ARE MAINTAINED DURING THE CONSTRUCTION PHASE UNTIL NEW LANDSCAPING IS PROVIDED OR REINSTATED. PREVENT DUST BY COVERING STOCKPILES

POSTS DRIVEN 0.6m INTO GROUND

WIRE OR STEEL MESH (WHERE REQUIRED)

↓ UNDISTURBED
 AREA

 χ_{AMME}

DETAIL OF OVERLAP

SEDIMENT NOTE:

1. ALL EROSION AND SEDIMENT CONTROL MEASURES TO BE INSPECTED AND MAINTAINED DAILY BY THE SITE MANAGER.

2. MINIMISE DISTURBED AREAS, REMOVE EXCESS SOIL FROM EXCAVATED AREA AS SOON AS POSSIBLE.
3. ALL MATERIAL STOCKPILE TO BE CLEAR FROM DRAINS, GUTTERS AND FOOTPATHS, OR WITHIN SEDIMENT FENCE AREA.

4. DRAINAGE TO BE CONNECTED TO STORMWATERAS SOON AS POSSIBLE. IF STORED ON SITE, IT MUST BE FILTERED BEFORE RELEASING INTO STORMWATER SYSTEM OR WATERWAYS.

5. ROADS AND FOOTPATHS TO BE SWEPT DAILY.

STOCKPILES

ALL STOCKPILES ARE TO BE KEPT ON-SITE WHERE POSSIBLE. ANY MATERIALS PLACED ON THE FOOTPATHS OR NATURE STRIPS REQUIRE COUNCIL'S PERMISSION.

ALL STOCKPILES ARE TO BE PLACED AWAY FROM THE DRAINAGE LINES AND STREET GUTTERS. IT IS BEST TO LOCATE THESE ON THE HIGHEST PART OF THE SITE IF POSSIBLE. PLACE WATERPROOF COVERING OVER STOCKPILES.

IF REQUIRED PROVIDE DIVERSION DRAIN & BANK AROUND STOCKPILES.

GUTTER PROTECTION:

PROVIDE PROTECTION TO DOWNHILL GRATE IN GUTTER BY MEANS OF SAND BAGS OR BLUE METAL WRAPPED IN GEOTEXTILE FABRIC. WHEN SOIL OR SAND BUILDS UP AROUND THIS SEDIMENT BARRIER, THE MATERIAL SHOULD BE RELOCATED BACK TO THE SITE FOR DISPOSAL.

NOTE: ALL PROPOSED STORMWATER TO CONNECT WITH EXISTING

SITE / ROOF / SEDIMENT EROSION / WASTE MANAGEMENT / STORMWATER CONCEPT PLAN

ACTION PLANS
m: 0426 957 518
e:operations@actionplans.com.au

w: www.actionplans.com.au


REV. DATE COMMENTS DRWN

A 27.06.2025 S 4.55 SUBMISSION SC This drawing is the copyright of Action Plans and not be attered, reproduced or transmitted in any form or by any means in part or in whole with the written permission of Action Plans.

Do not scale measure from drawings. Figured dimensions are to be used only.

The Builder/Contractor shall check and verify all levels and dimensions on site prior to commencement of any work, creation of shop drawings, or fabrication of components.

All errors and omissions are to be verified by the Builder/Contractor and referred to the designer prior to the commencement of works.

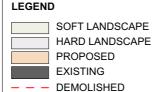

EX. EXISTING
DP. DOWNPIPE
PROP. PROPOSED
DP. DOWNPIPE

MARK HOPKINS & CATHERINE MANU

CLIENT

1:200

PROJECT ADDRESS 15 TANGO AVENUE DEF WHY NSW 2099 DRAWING NO.

MOD02

DATEFriday, 27 June 2025


SITE / ROOF / SEDIMENT EROSION / WASTE MANAGEMENT / STORMWATER


DRAWING NAME

CONCEPT PLAN

SCALE

1:200 @A3

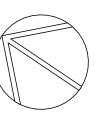

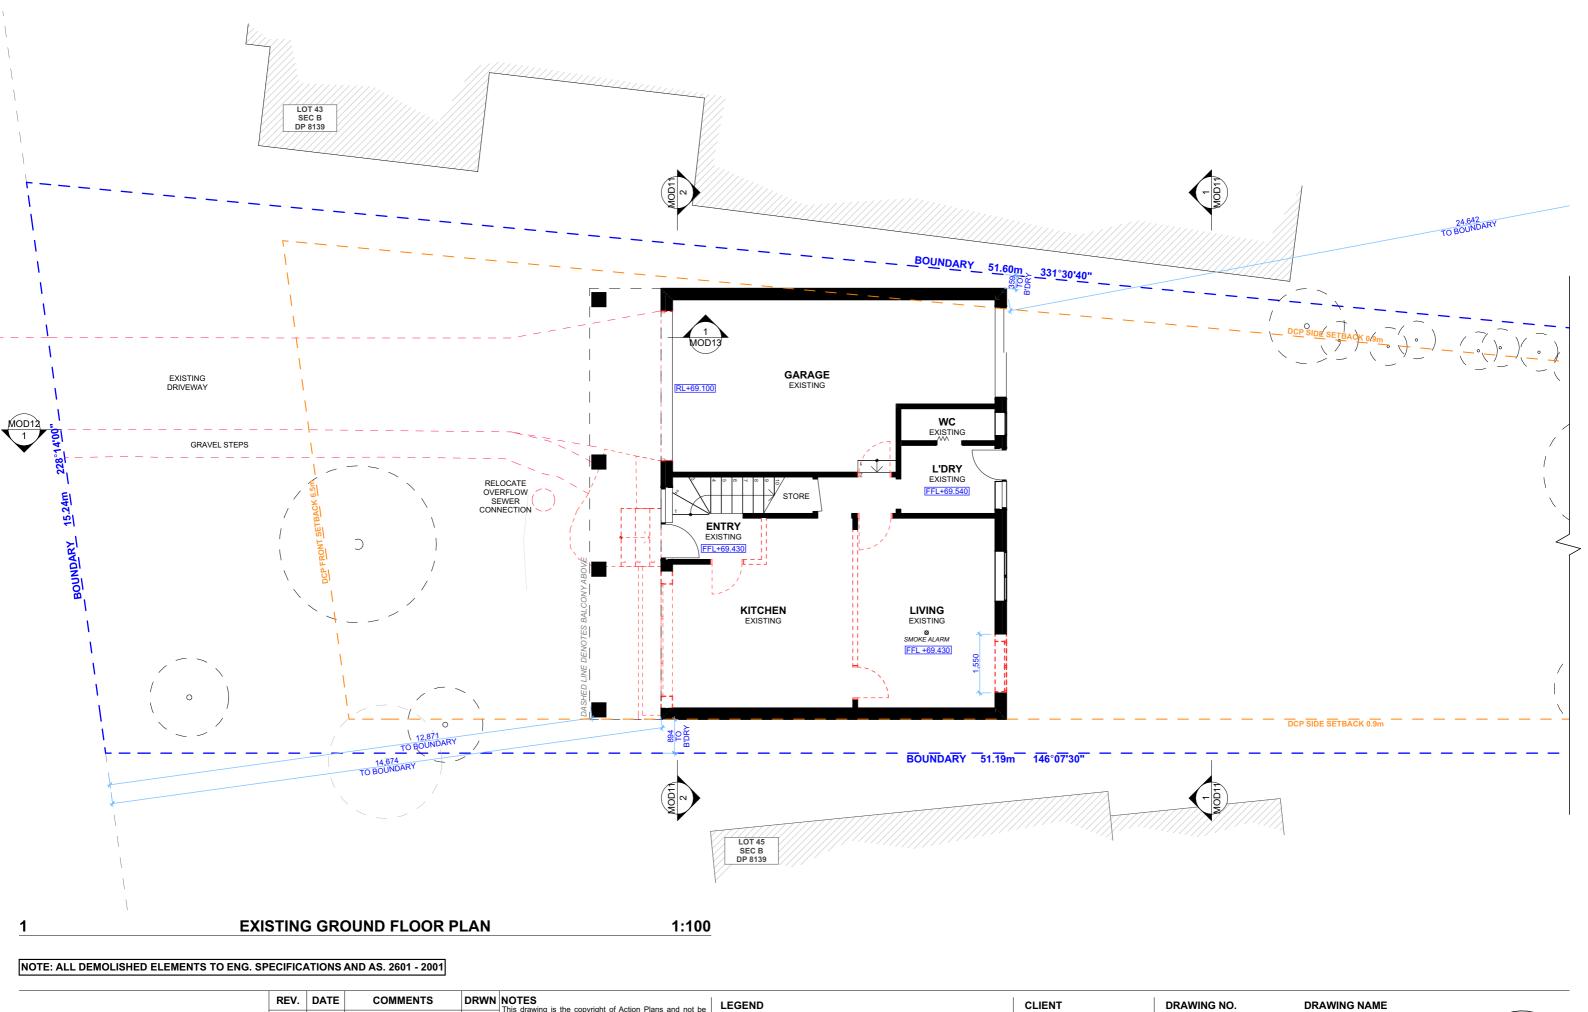



	REV.	DATE	COMMENTS	DKWIN	This descript is the conversely of Astion Diagonal and b
	A	27.06.2025	S 4.55 SUBMISSION	sc	This drawing is the copyright of Action Plans and not be altered, reproduced or transmitted in any form or by an ameans in part or in whole with the written permission or
					Action Plans. Do not scale measure from drawings. Figured dimension are to be used only.
ш					The Builder/Contractor shall check and verify all levels an dimensions on site prior to commencement of any world
_					creation of shop drawings, or fabrication of components. All errors and omissions are to be verified by the
					Builder/Contractor and referred to the designer prior to the commencement of works.





PROJECT ADDRESS 15 TANGO AVENUE DEE WHY NSW 2099

DRAWING NO. MOD03

DATE Friday, 27 June 2025 EXISTING GROUND FLOOR PLAN



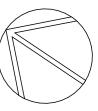

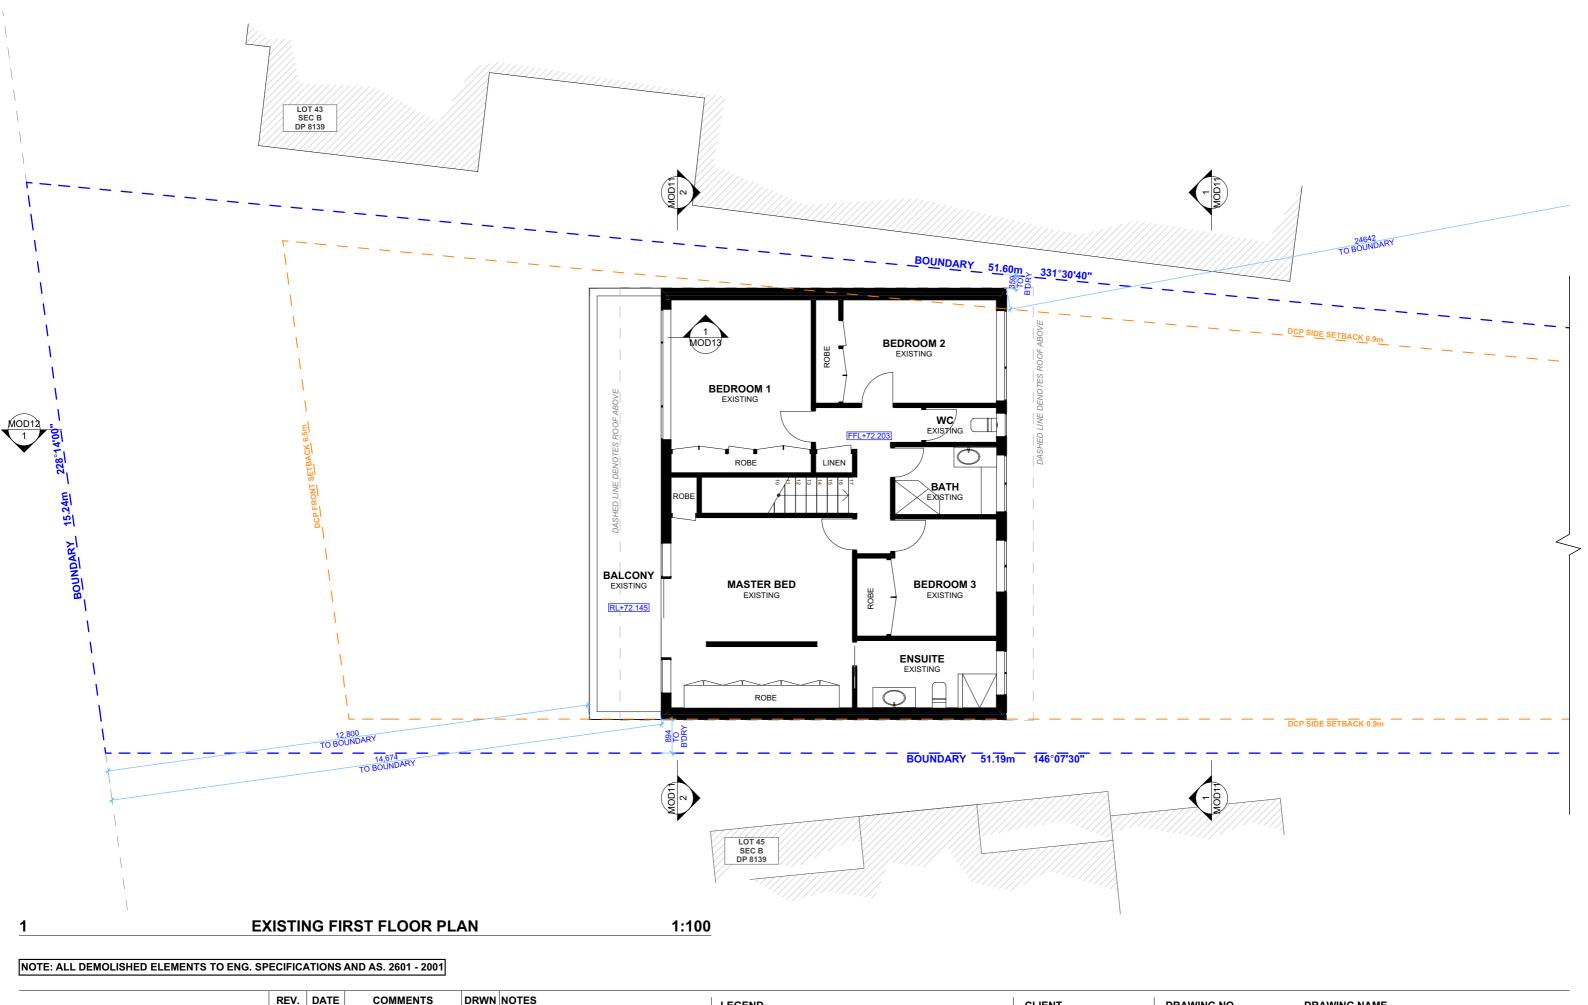



	INEV.	DAIL	COMMENTO	DIXIII	This descript is the securicular of Astice Diseased and he
	А	27.06.2025	S 4.55 SUBMISSION	sc	This drawing is the copyright of Action Plans and not be altered, reproduced or transmitted in any form or by any means in part or in whole with the written permission of
					Action Plans. Do not scale measure from drawings. Figured dimensions are to be used only.
				The Builder/Contractor	The Builder/Contractor shall check and verify all levels and
u					dimensions on site prior to commencement of any work, creation of shop drawings, or fabrication of components.
					All errors and omissions are to be verified by the Builder/Contractor and referred to the designer prior to the
					commencement of works.



CLIENT
MARK HOPKINS & CATHERINE MANU


PROJECT ADDRESS
15 TANGO AVENUE
DEE WHY NSW 2099

MOD04

DATE Friday, 27 June 2025 DRAWING NAME
EXISTING FIRST FLOOR PLAN






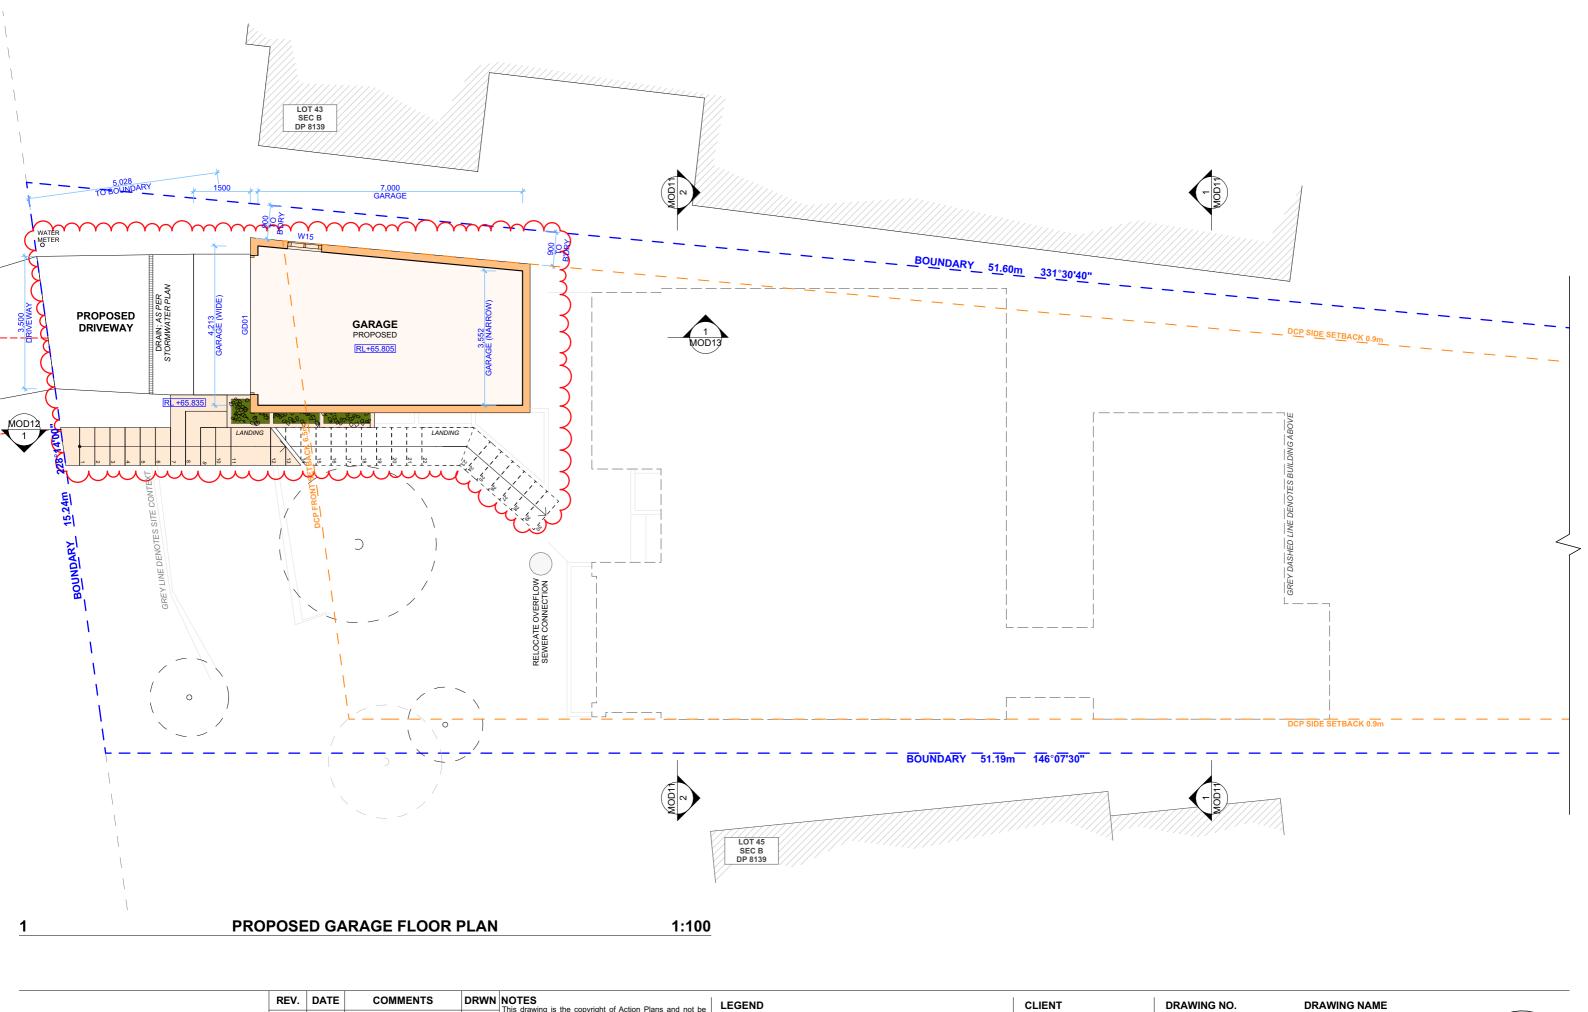



					This drawing is the copyright of Action Plans and not be
	Α	27.06.2025	S 4.55 SUBMISSION	sc	altered, reproduced or transmitted in any form or by any means in part or in whole with the written permission of
					Action Plans. Do not scale measure from drawings. Figured dimensions
					are to be used only. The Builder/Contractor shall check and verify all levels and
u					dimensions on site prior to commencement of any work, creation of shop drawings, or fabrication of components.
					All errors and omissions are to be verified by the Builder/Contractor and referred to the designer prior to the
					commencement of works.

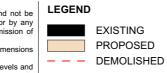



PROJECT ADDRESS 15 TANGO AVENUE DEE WHY NSW 2099

DRAWING NO. MOD05

Friday, 27 June 2025

PROPOSED GARAGE FLOOR PLAN DATE

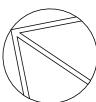

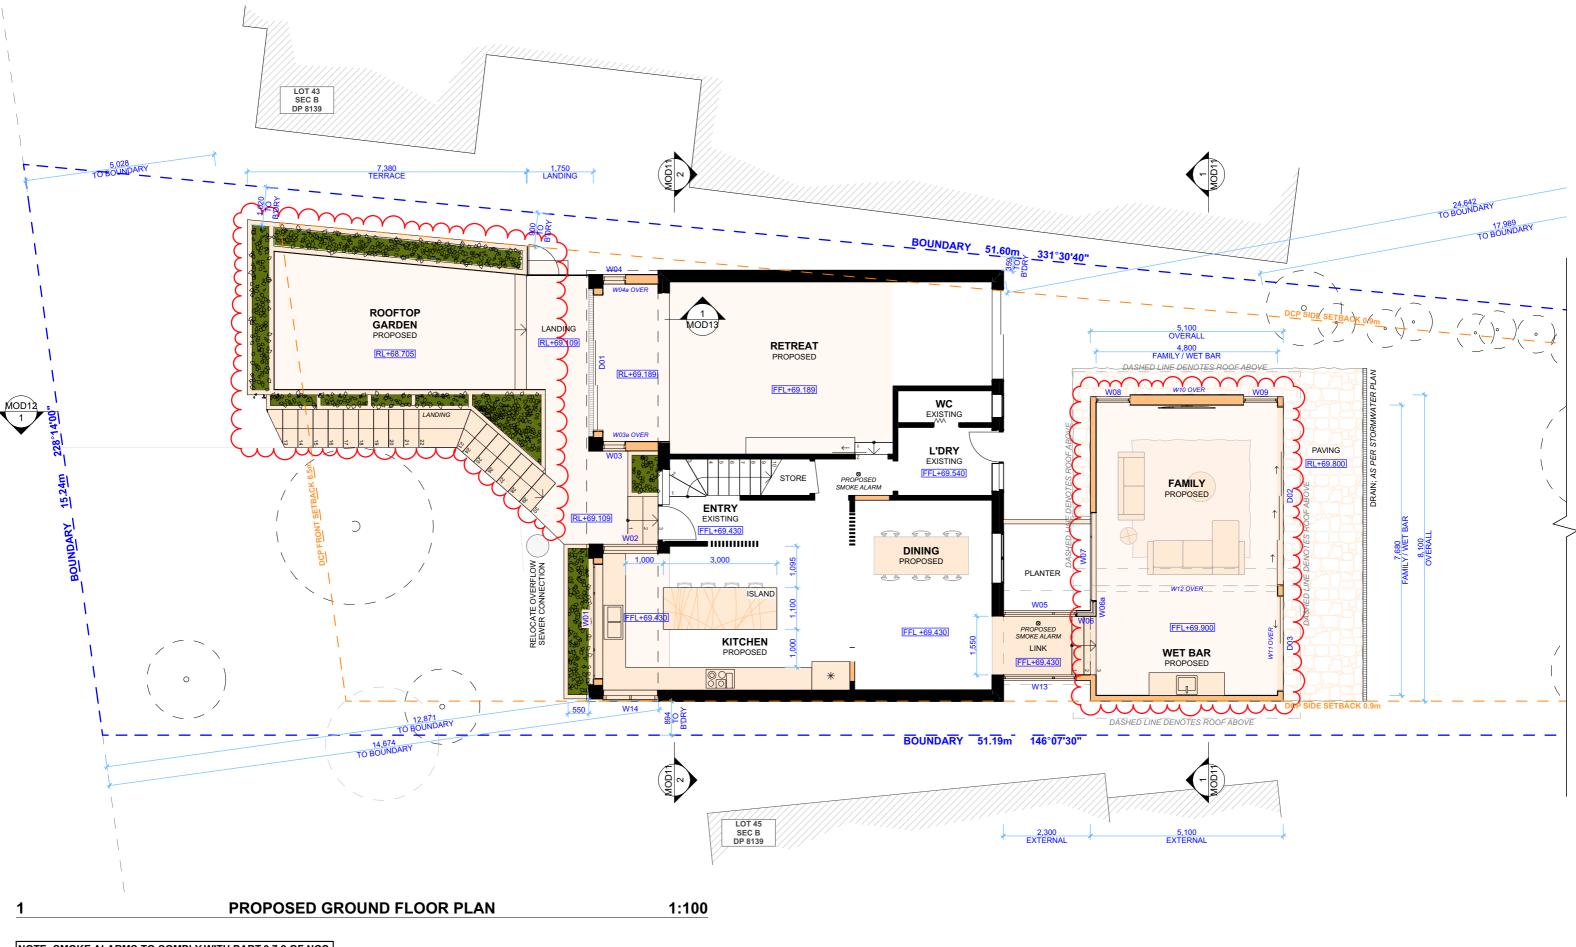

NOTE: SMOKE ALARMS TO COMPLY WITH PART 3.7.2 OF NCC


REV. DATE

COMMENTS



					This drawing is the copyright of Action Plans and not be
	А	27.06.2025	S 4.55 SUBMISSION	SC	altered, reproduced or transmitted in any form or by any means in part or in whole with the written permission of
					Action Plans. Do not scale measure from drawings. Figured dimensions
					are to be used only. The Builder/Contractor shall check and verify all levels and
lu					dimensions on site prior to commencement of any work, creation of shop drawings, or fabrication of components.
					All errors and omissions are to be verified by the Builder/Contractor and referred to the designer prior to the
					commencement of works.

DRWN NOTES

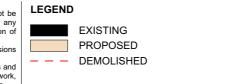

CLIENT

MARK HOPKINS &
CATHERINE MANU

PROJECT ADDRESS 15 TANGO AVENUE DEE WHY NSW 2099 MOD06


DATE
Friday, 27 June 2025 SCALE

DRAWING NAME

PROPOSED GROUND FLOOR
PLAN


SCALE

1:100 @A3

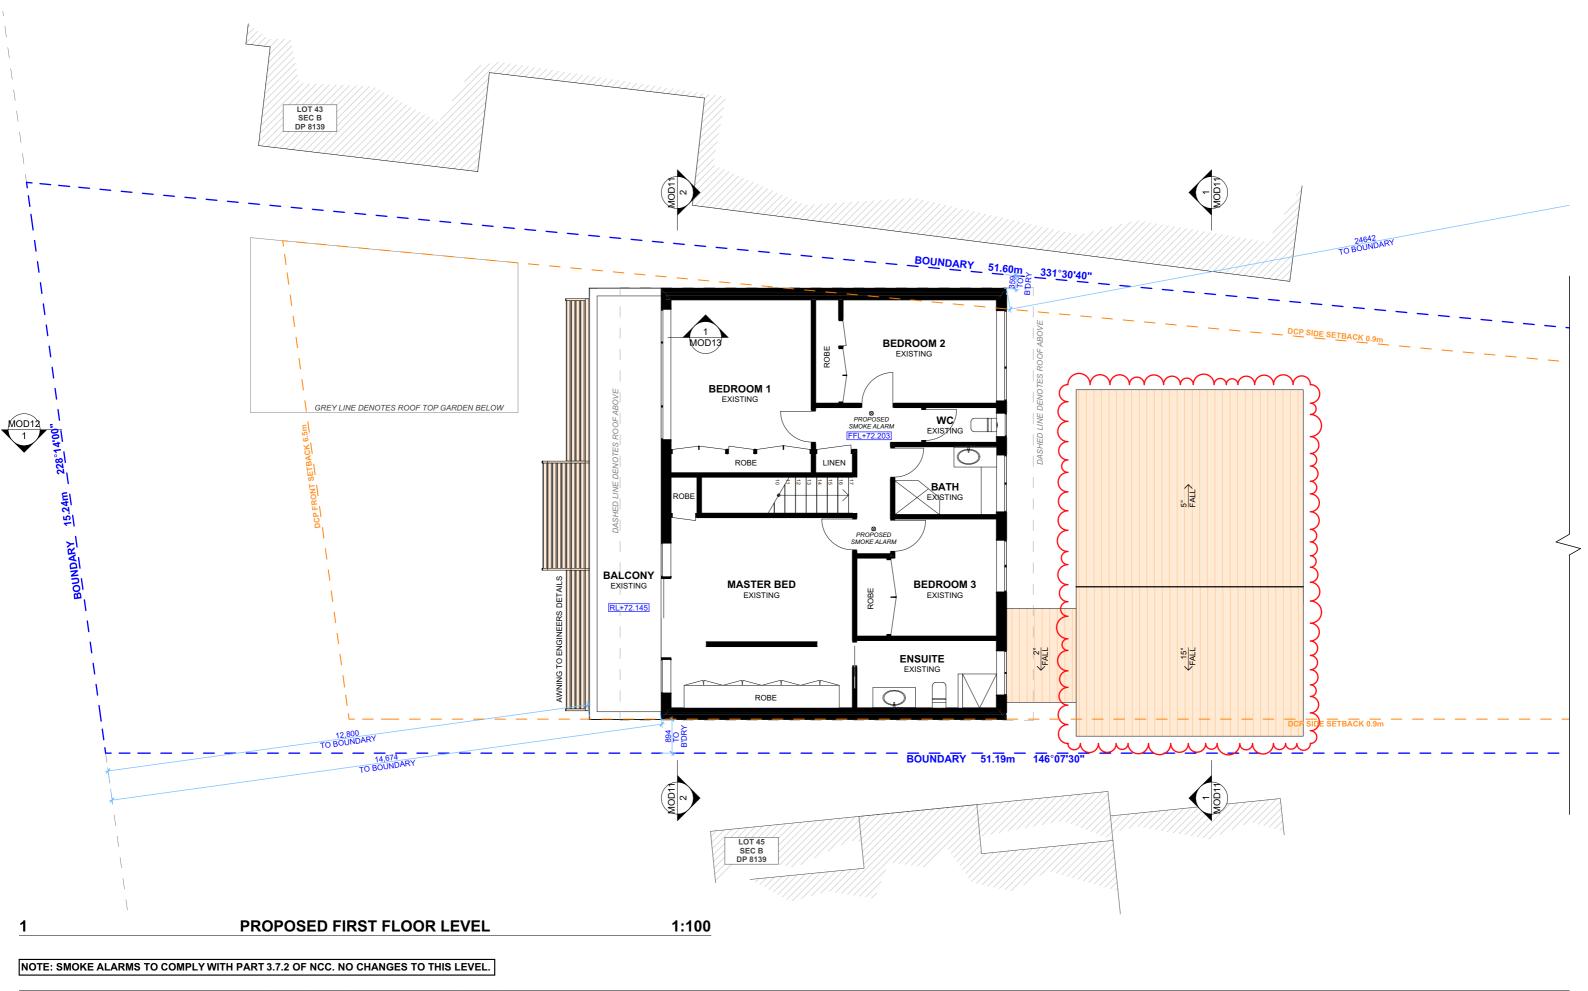



	REV.	DATE	COMMENTS	DRWN	NOTES This drawing is the copyright of Action Plans and not be
I	Α	27.06.2025	S 4.55 SUBMISSION	SC	altered, reproduced or transmitted in any form or by any means in part or in whole with the written permission of
I					Action Plans. Do not scale measure from drawings. Figured dimensions
I					are to be used only. The Builder/Contractor shall check and verify all levels and
I					dimensions on site prior to commencement of any work, creation of shop drawings, or fabrication of components.
I					All errors and omissions are to be verified by the

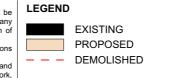



PROJECT ADDRESS 15 TANGO AVENUE DEE WHY NSW 2099 MOD07


DATE Friday, 27 June 2025

DRAWING NAME
PROPOSED FIRST FLOOR
PLAN



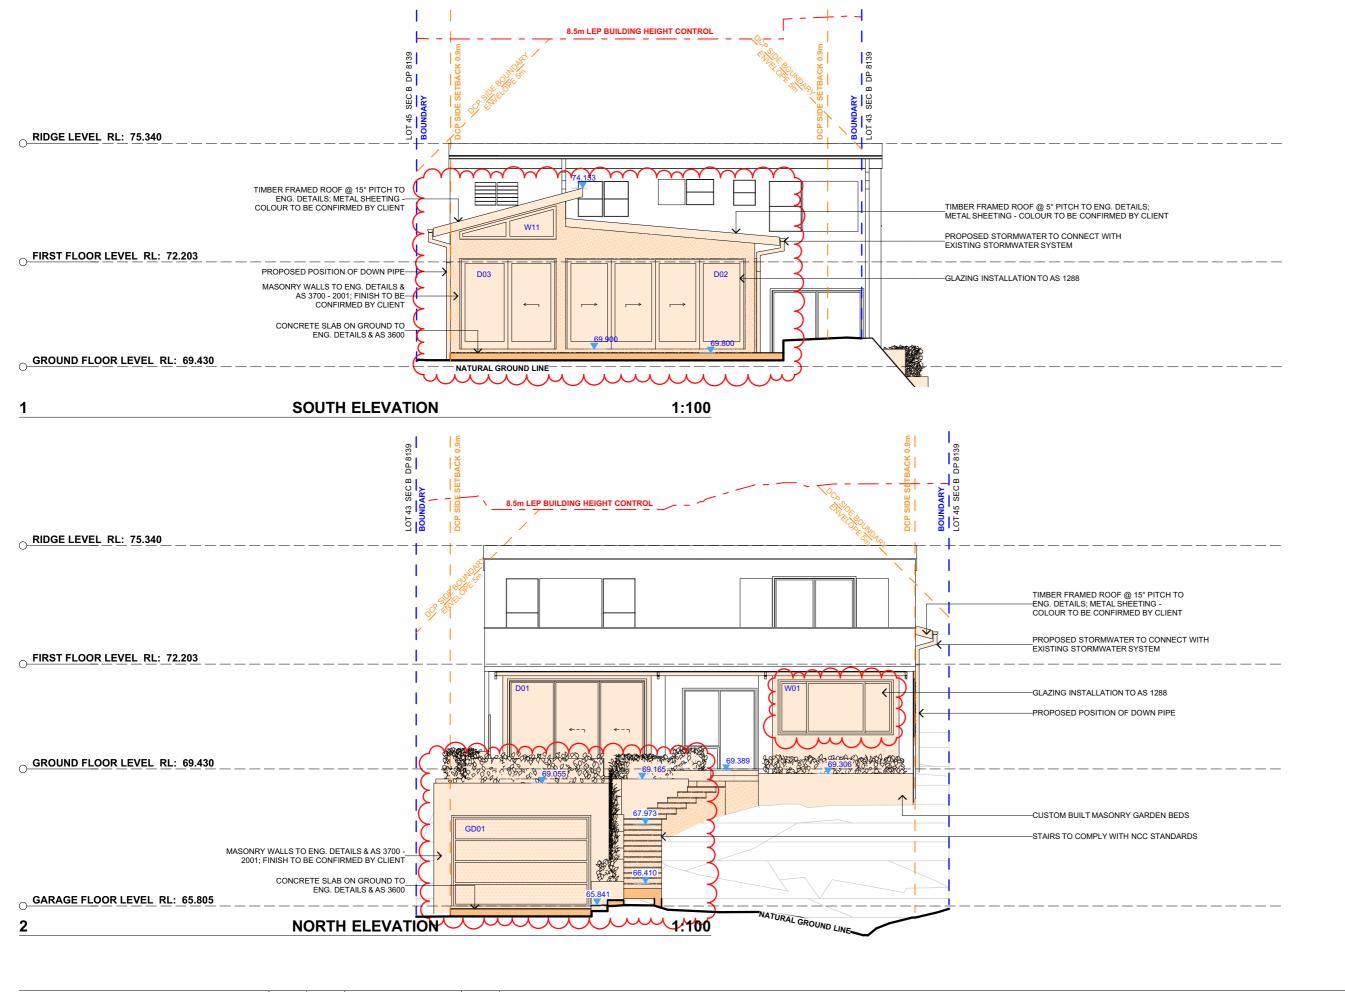

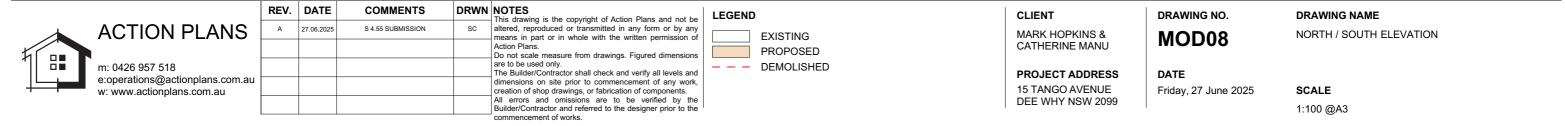


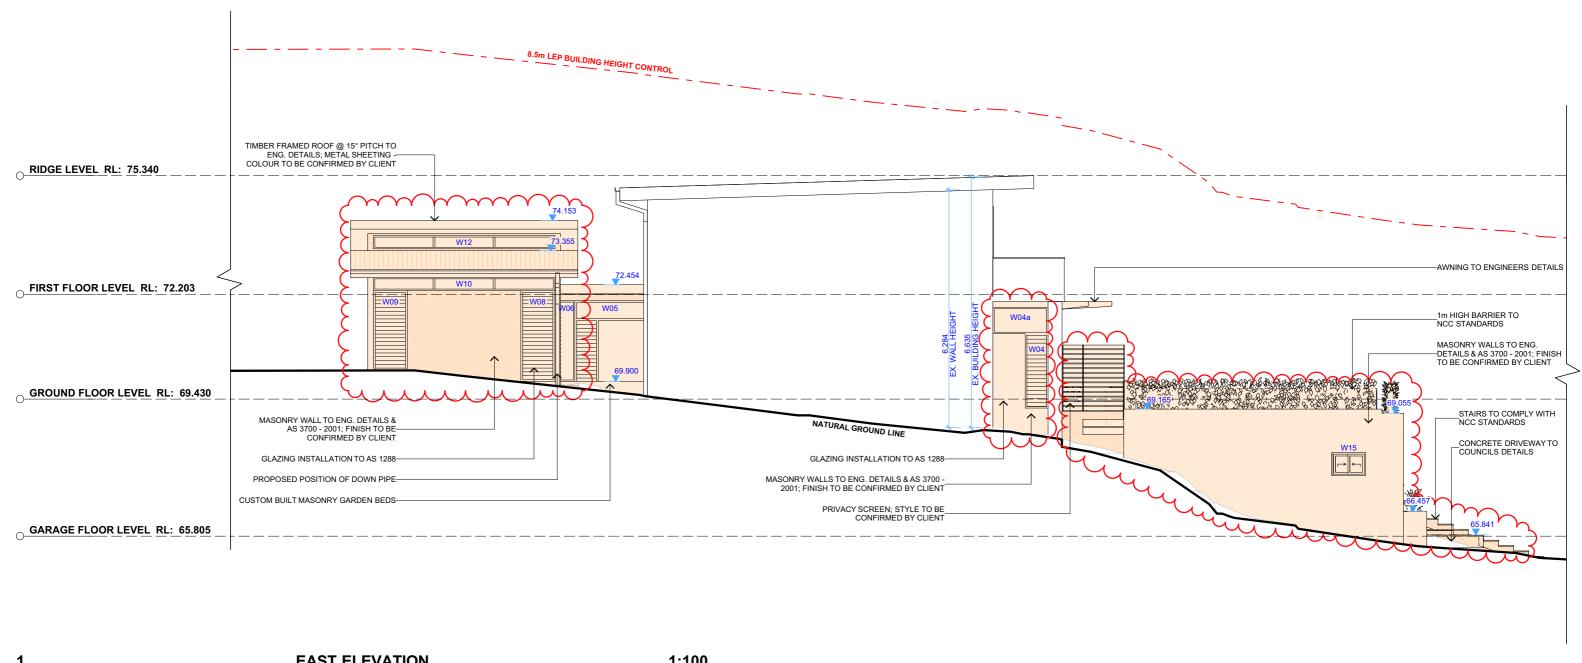

EAST ELEVATION 1:100



	REV.	DATE	COMMENTS	DRWN	NOTES This drawing is the copyright of Action Plans and not be
,	А	27.06.2025	S 4.55 SUBMISSION	sc	altered, reproduced or transmitted in any form or by any means in part or in whole with the written permission of
					Action Plans. Do not scale measure from drawings. Figured dimensions are to be used only. The Builder/Contractor shall check and verify all levels and
au					dimensions on site prior to commencement of any work, creation of shop drawings, or fabrication of components. All errors and omissions are to be verified by the
					Builder/Contractor and referred to the designer prior to the commencement of works.

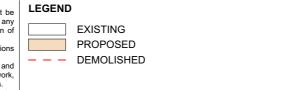

CLIENT
MARK HOPKINS & CATHERINE MANU
PROJECT ADDRESS

15 TANGO AVENUE

DEE WHY NSW 2099


MOD09

DRAWING NO.


DRAWING NAME EAST ELEVATION


DATE


Friday, 27 June 2025

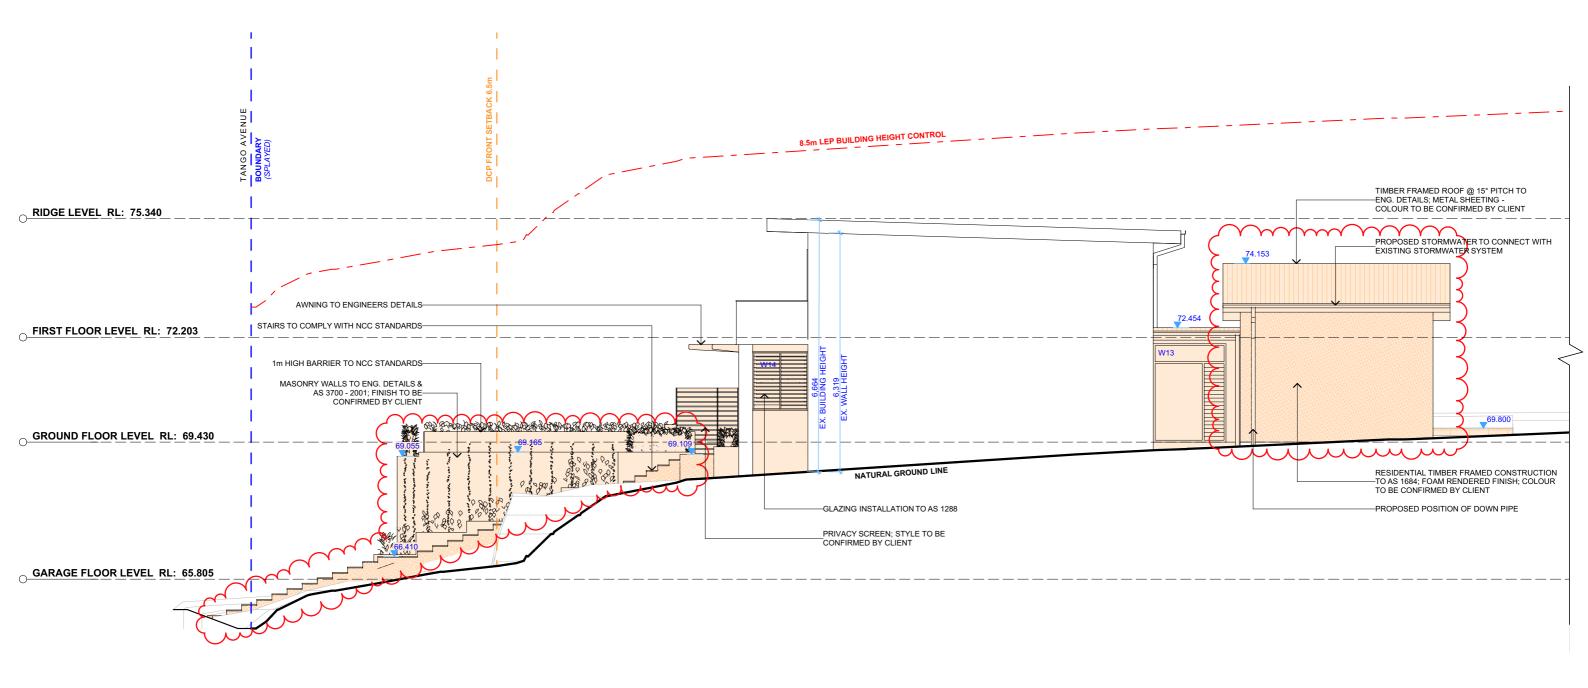


1 WEST ELEVATION 1:100

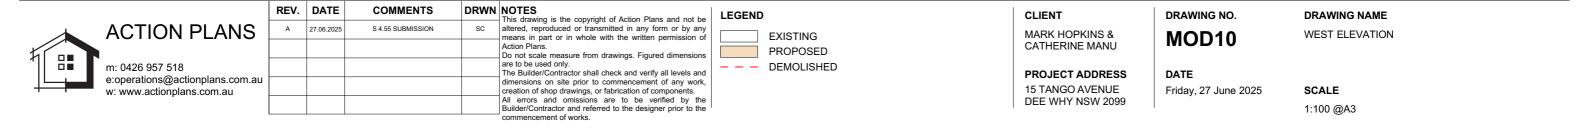


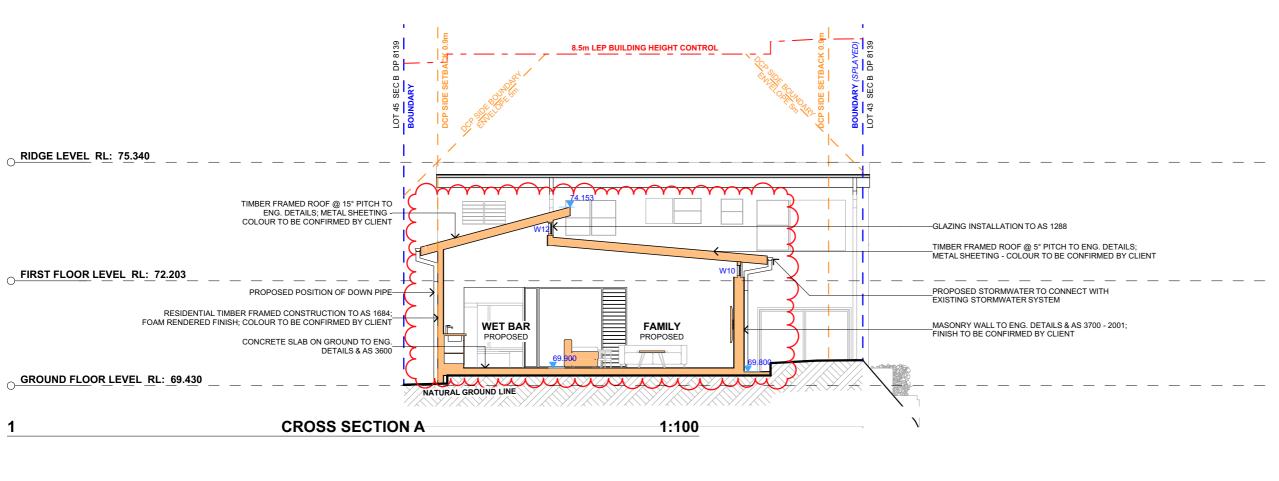

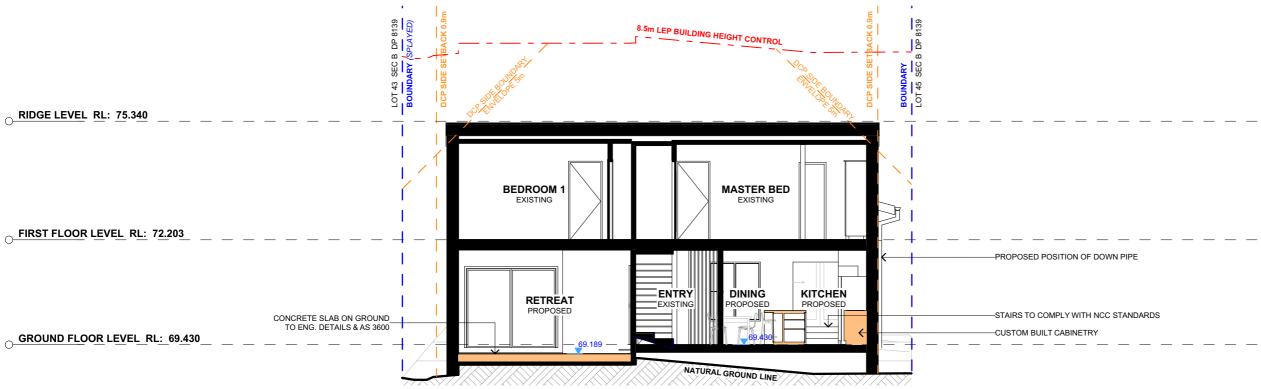



2 CROSS SECTION B 1:100

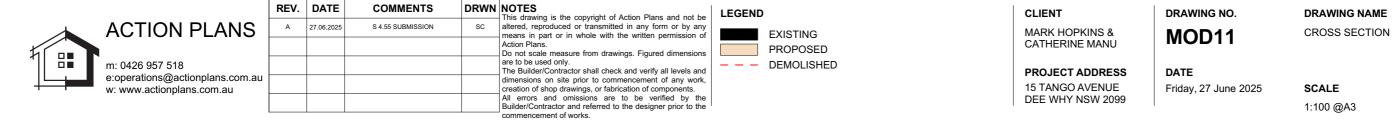


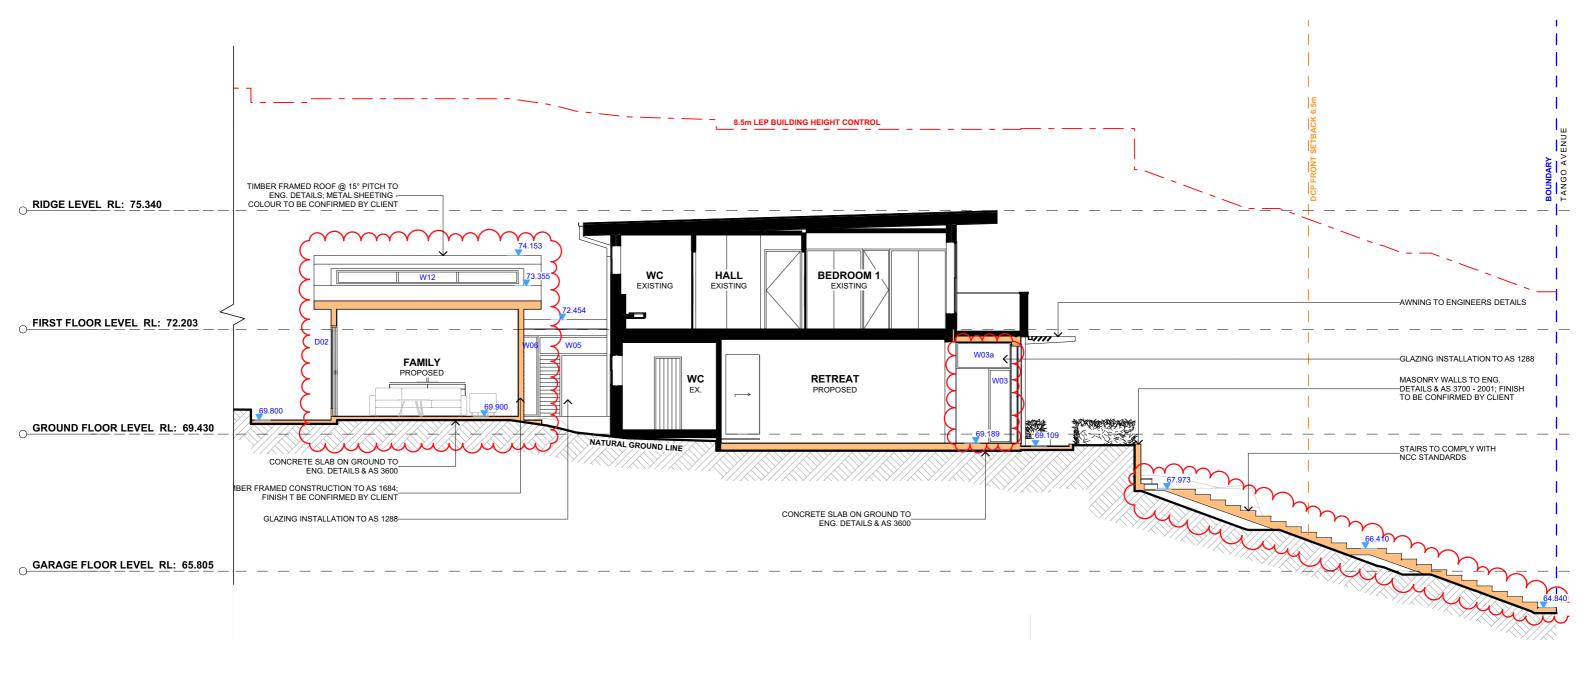


1 LONG SECTION 1:100

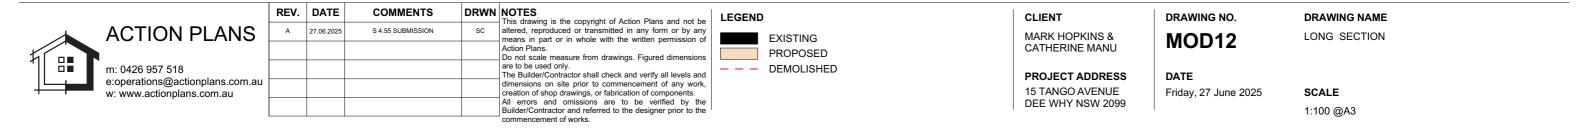


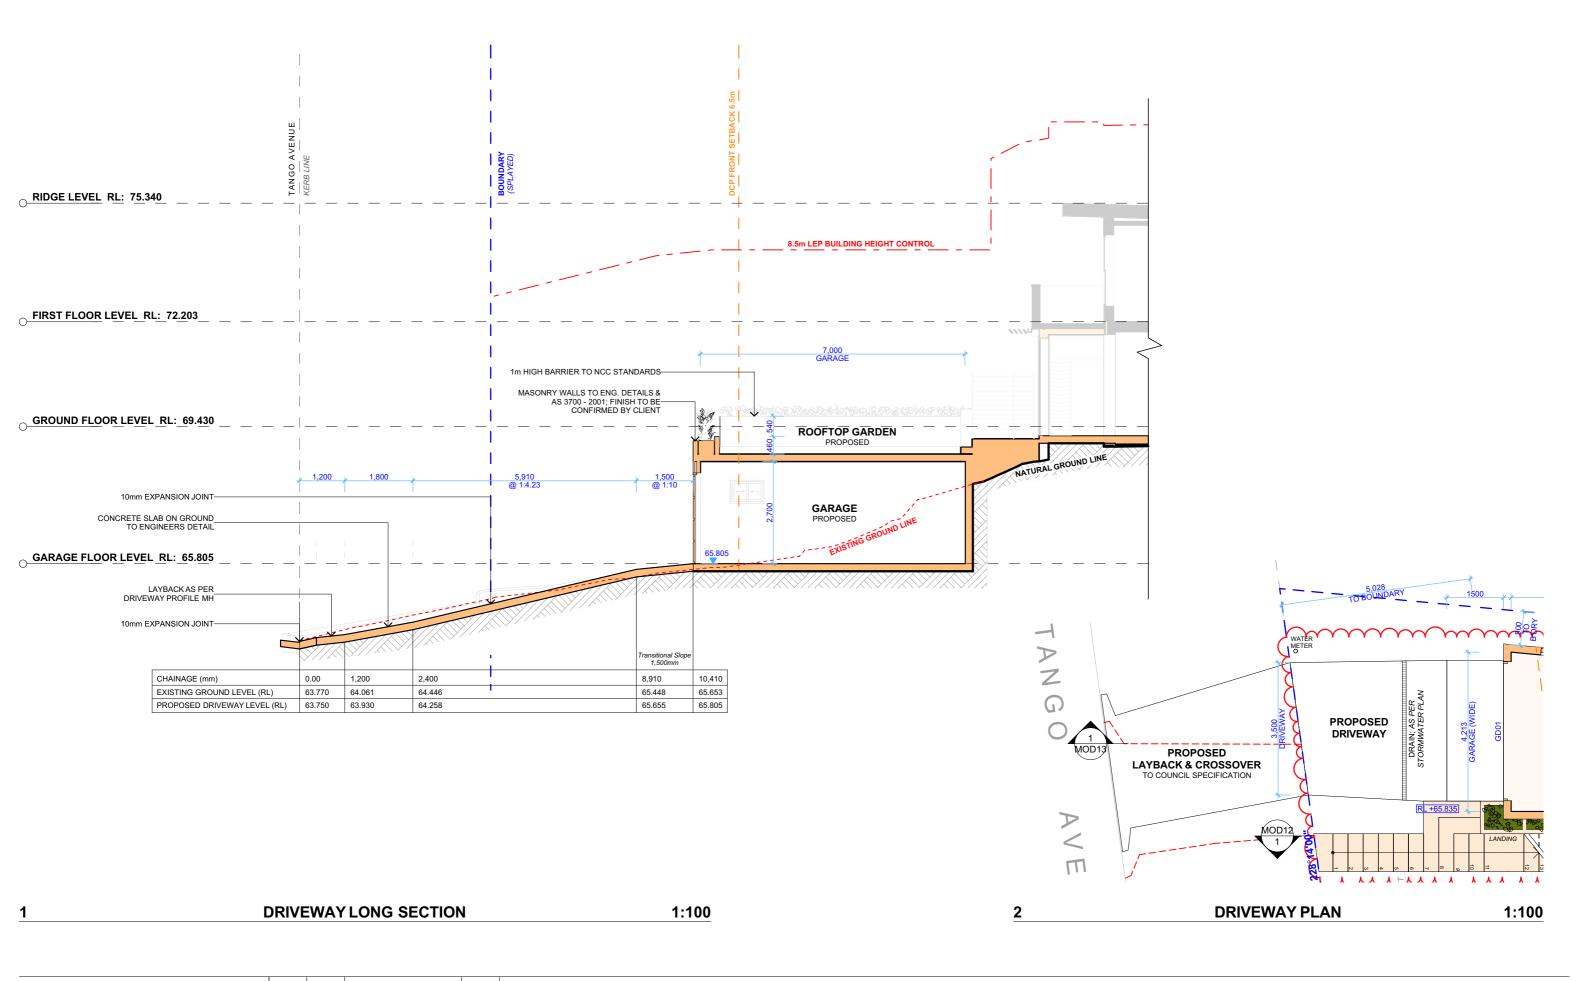


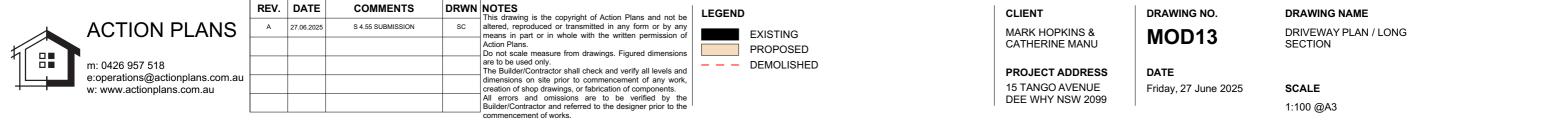

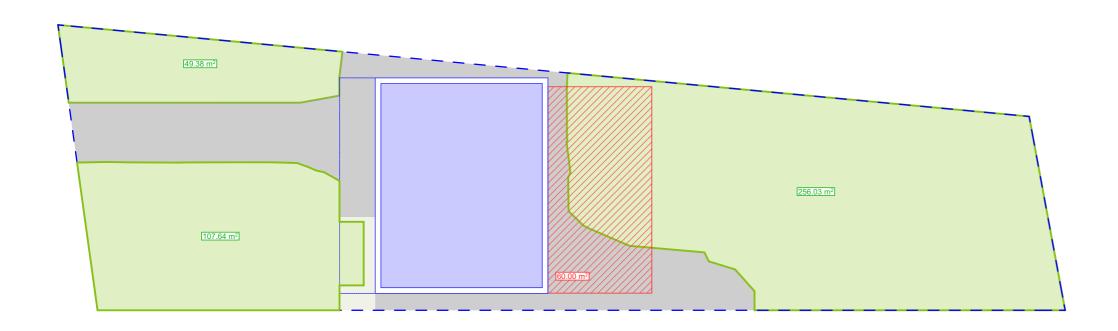

EXISTING AREA CALCULATIONS 1:200

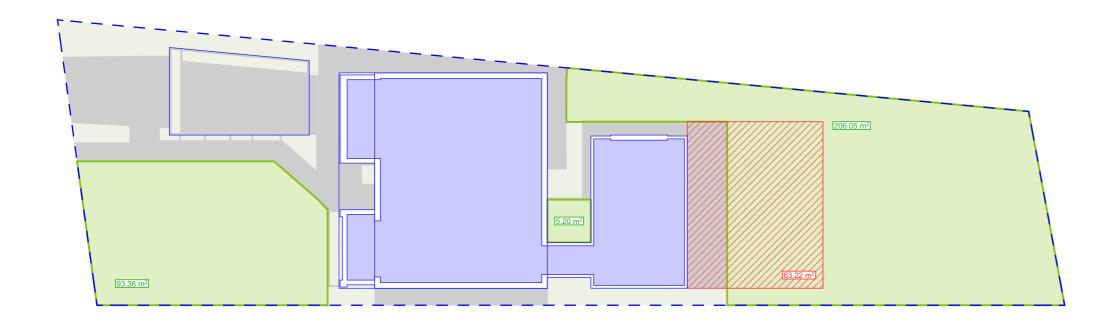

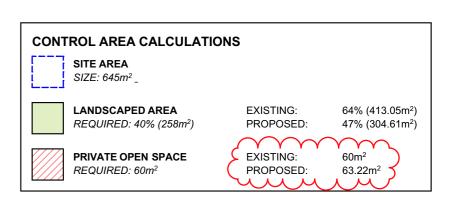

PROPOSED AREA CALCULATIONS 1:200



REV.	DATE	COMMENTS	DRWN	NOTES
А	27.06.2025	S 4.55 SUBMISSION	SC	This drawing is the copyright of Action Plans and not be altered, reproduced or transmitted in any form or by any means in part or in whole with the written permission or
				Action Plans. Do not scale measure from drawings. Figured dimensions are to be used only.
				The Builder/Contractor shall check and verify all levels and dimensions on site prior to commencement of any work
				creation of shop drawings, or fabrication of components. All errors and omissions are to be verified by the Builder/Contractor and referred to the designer prior to the
				commencement of works.

LEGEND

MARK HOPKINS & CATHERINE MANU

CLIENT


PROJECT ADDRESS 15 TANGO AVENUE DEE WHY NSW 2099


DRAWING NO. MOD14

DRAWING NAME AREA CALCULATIONS

DATE

Friday, 27 June 2025

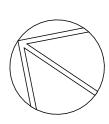

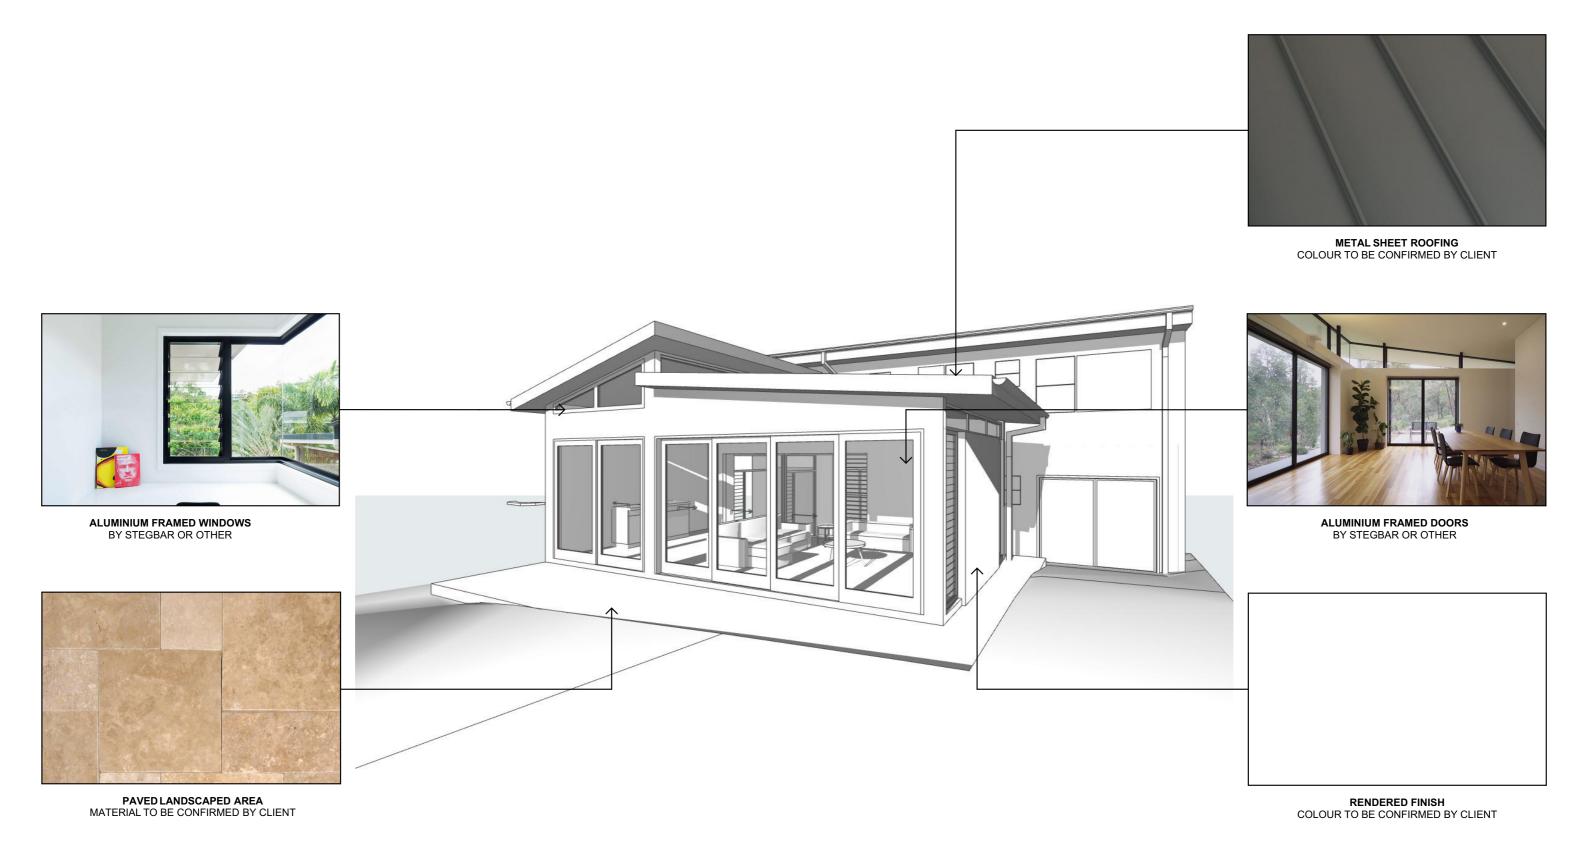

SAMPLE BOARD

ACTION PLANS

m: 0426 957 518 e:operations@actionplans.com.au w: www.actionplans.com.au

	REV.	DATE	COMMENTS	DRWN	NOTES
,	А	27.06.2025	S 4.55 SUBMISSION	sc	This drawing is the copyright of Action Plans and not be altered, reproduced or transmitted in any form or by an ameans in part or in whole with the written permission of
					Action Plans. Do not scale measure from drawings. Figured dimension
					are to be used only. The Builder/Contractor shall check and verify all levels and
au					dimensions on site prior to commencement of any work creation of shop drawings, or fabrication of components.
					All errors and omissions are to be verified by the Builder/Contractor and referred to the designer prior to the
				-	commencement of works.

LEGEND

CLIENT MARK HOPKINS & CATHERINE MANU

PROJECT ADDRESS 15 TANGO AVENUE DEE WHY NSW 2099 DRAWING NO.


MOD15

DATE

Friday, 27 June 2025


DRAWING NAME SAMPLE BOARD

SCALE @A3

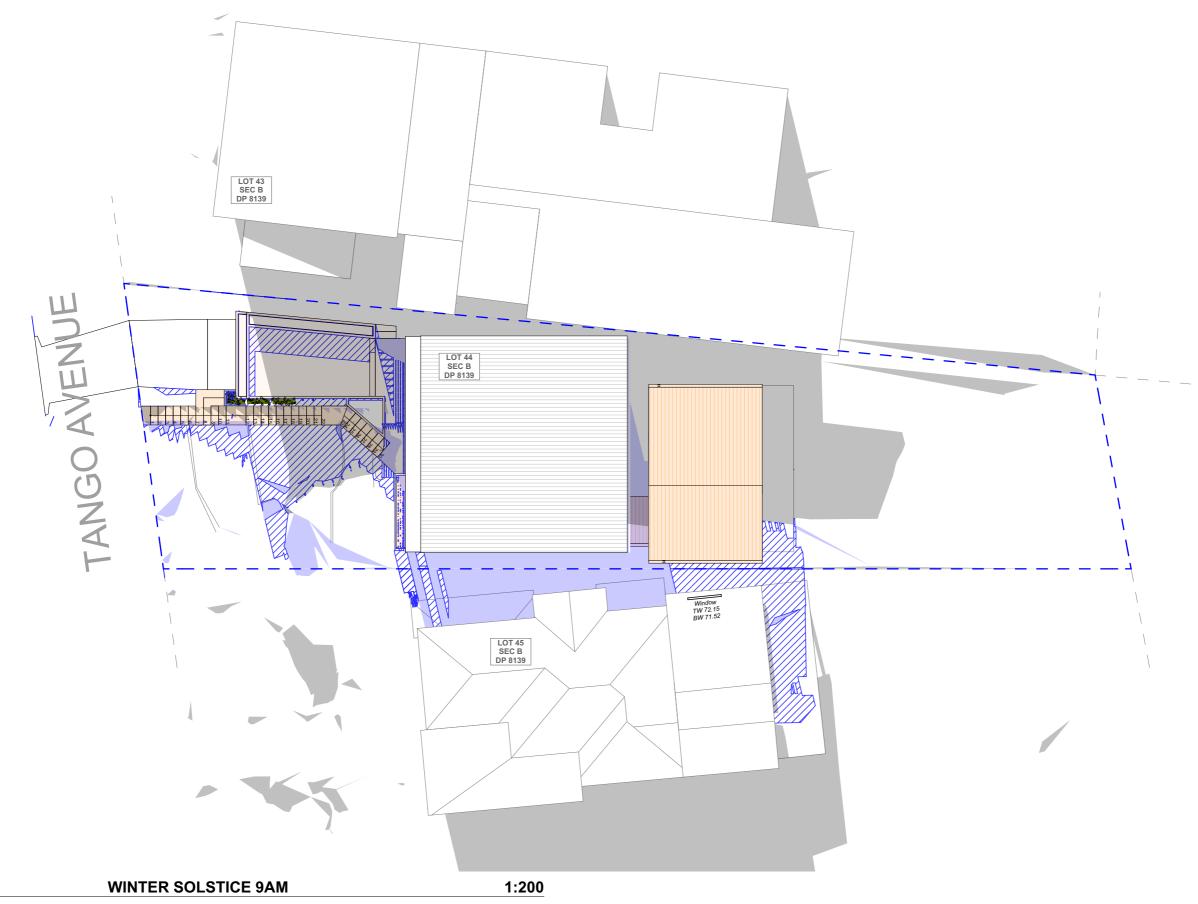




	REV.	DATE	COMMENTS	DKWN	NOTES	L
	А	27.06.2025	S 4.55 SUBMISSION	sc	This drawing is the copyright of Action Plans and not be altered, reproduced or transmitted in any form or by any means in part or in whole with the written permission of	
					Action Plans. Do not scale measure from drawings. Figured dimensions	2
au					are to be used only. The Builder/Contractor shall check and verify all levels and	
ıu					dimensions on site prior to commencement of any work, creation of shop drawings, or fabrication of components.	
					All errors and omissions are to be verified by the Builder/Contractor and referred to the designer prior to the	
					commencement of works.	

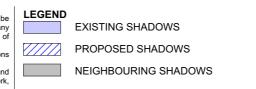


PROJECT ADDRESS 15 TANGO AVENUE DEE WHY NSW 2099

DRAWING NO. MOD16


DATE Friday, 27 June 2025 DRAWING NAME WINTER SOLSTICE 9 AM

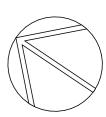

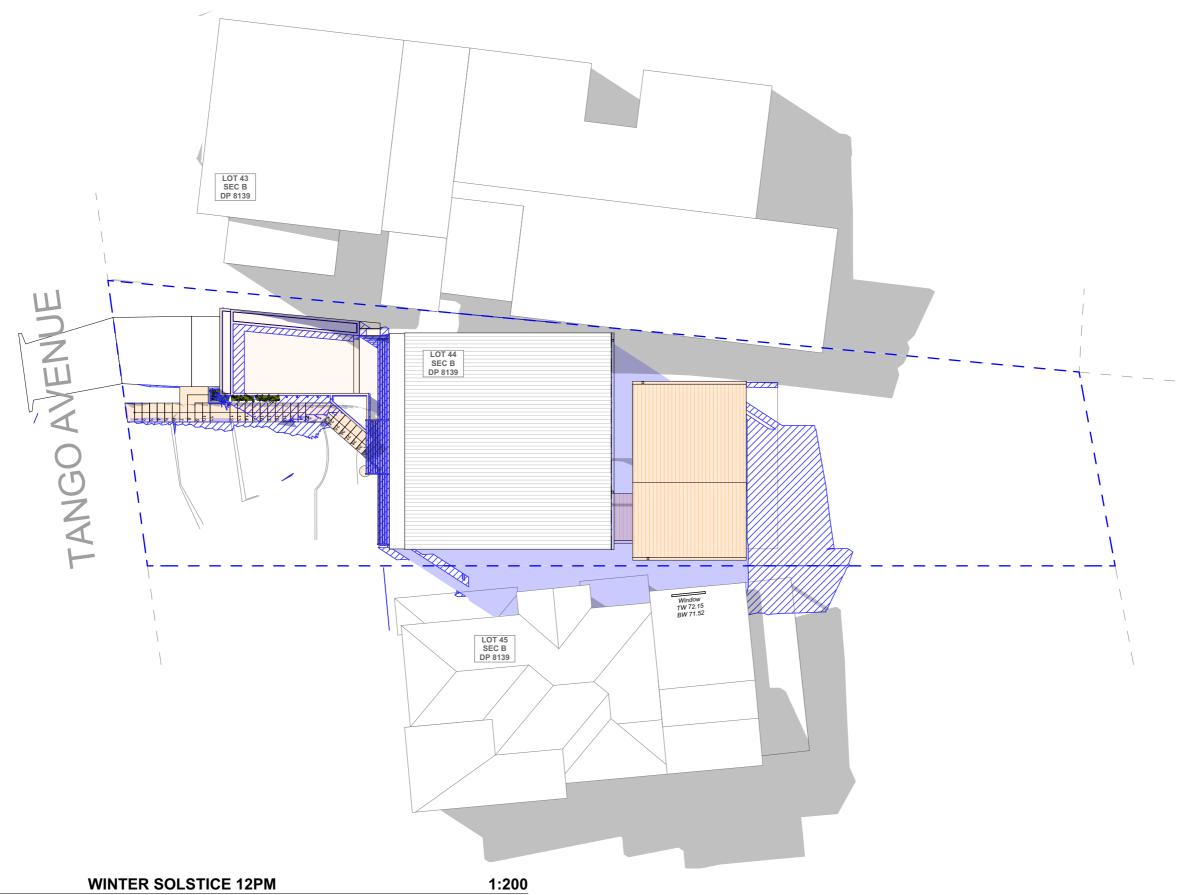



	REV.	DATE	COMMENTS	DRWN	NOTES	LI
	Α	27.06.2025	S 4.55 SUBMISSION	sc	This drawing is the copyright of Action Plans and not be altered, reproduced or transmitted in any form or by any means in part or in whole with the written permission of	
					1	
					are to be used only. The Builder/Contractor shall check and verify all levels and	
u					dimensions on site prior to commencement of any work, creation of shop drawings, or fabrication of components.	
					All errors and omissions are to be verified by the Builder/Contractor and referred to the designer prior to the	
					commencement of works.	

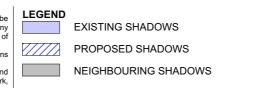

PROJECT ADDRESS 15 TANGO AVENUE DEE WHY NSW 2099 DRAWING NO.


MOD17


DATE

Friday, 27 June 2025

DRAWING NAME

WINTER SOLSTICE 12 PM

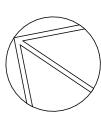


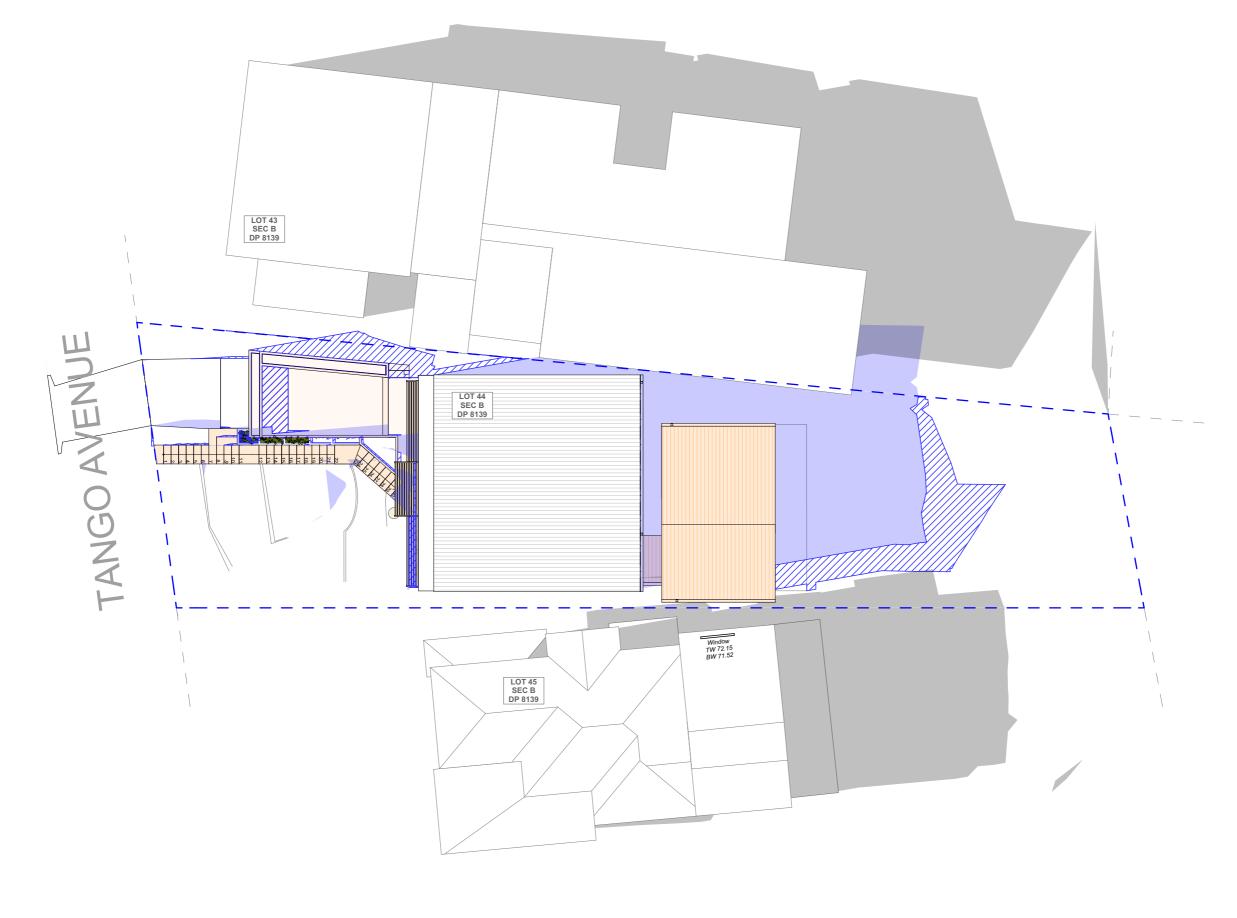

WINTER SOLSTICE 3PM 1:200



	REV.	DATE	COMMENTS	DRWN	NOTES This drawing is the copyright of Action Plans and not be	LE
	Α	27.06.2025	S 4.55 SUBMISSION	SC	altered, reproduced or transmitted in any form or by any means in part or in whole with the written permission of	
					Action Plans. Do not scale measure from drawings. Figured dimensions	\mathbb{Z}
					are to be used only. The Builder/Contractor shall check and verify all levels and	
ı					dimensions on site prior to commencement of any work, creation of shop drawings, or fabrication of components.	
					All errors and omissions are to be verified by the Builder/Contractor and referred to the designer prior to the	
					commencement of works.	

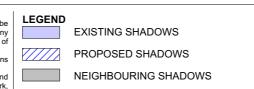

CLIENT MARK HOPKINS & CATHERINE MANU

PROJECT ADDRESS 15 TANGO AVENUE DEE WHY NSW 2099 DRAWING NO.


MOD18

DATE

WINTER SOLSTICE 3 PM

DRAWING NAME

Friday, 27 June 2025 SCALE 1:200 @A3

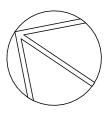

BASIX™Certificate

Building Sustainability Index www.planningportal.nsw.gov.au/development-and-assessment/basix

Alterations and Additions

Certificate number: A1801805

This certificate confirms that the proposed development will meet the NSW government's requirements for sustainability, if it is built in accordance with the commitments set out below. Terms used in this certificate, or in the commitments, have the meaning given by the document entitled "BASID Definitions" dated 10/09/2020 published by the Department. This document is available at www.planningportal.nsw.gov.au/definitions

Secretary
Date of issue: Friday, 27 June 2025
To be valid, this certificate must be lodged within 3 months of the date of issue.



	F-9
Project address	
Project name	#636 - 15 TANGO AVE, DEE WHY
Street address	15 TANGO Avenue DEE WHY 2099
Local Government Area	Northern Beaches Council
Plan type and number	Deposited Plan DP8139
Lot number	44
Section number	В
Project type	
Dwelling type	Dwelling house (detached)
Type of alteration and addition	The estimated development cost for my renovation work is \$50,000 or more, and does not include a pool (and/or spa).
N/A	N/A
Certificate Prepared by (please	se complete before submitting to Council or PCA)
Name / Company Name: ACTION PLA	INS PTY LTD
ABN (if applicable): 55660046711	

Fixtures and systems	Show on DA Plans	Show on CC/CDC Plans & specs	Certifier Check
Lighting			
The applicant must ensure a minimum of 40% of new or altered light fixtures are fitted with fluorescent, compact fluorescent, or light-emitting-diode (LED) lamps.		~	~
Fixtures			
The applicant must ensure new or altered showerheads have a flow rate no greater than 9 litres per minute or a 3 star water rating.		~	~
The applicant must ensure new or altered toilets have a flow rate no greater than 4 litres per average flush or a minimum 3 star water rating.		~	~
The applicant must ensure new or altered taps have a flow rate no greater than 9 litres per minute or minimum 3 star water rating.		~	

Construction			Show on DA Plans	Show on CC/CDC Plans & specs	Certifier Check
Insulation requirements					
listed in the table below, except that a) add	ered construction (floor(s), walls, and ceilings/ ditional insulation is not required where the are s of altered construction where insulation alrea	a of new construction is less than 2m2, b)	~	•	~
Construction	Additional insulation required (R-value)	Other specifications			
concrete slab on ground floor.	nil	N/A			
external wall: brick veneer	R1.16 (or R1.70 including construction)				
external wall: framed (weatherboard, fibro, metal clad)	R1.30 (or R1.70 including construction)				
flat ceiling, pitched roof	ceiling: R2.50 (up), roof: foil/sarking	medium (solar absorptance 0.475 - 0.70)			
raked ceiling, pitched/skillion roof: framed	ceiling: R2.50 (up), roof: foil/sarking	medium (solar absorptance 0.475 - 0.70)			

Glazing requirements	Show on DA Plans	Show on CC/CDC Plans & specs	Certifier Check
Windows and glazed doors			
The applicant must install the windows, glazed doors and shading devices, in accordance with the specifications listed in the table below. Relevant overshadowing specifications must be satisfied for each window and glazed door.	~	~	~
The following requirements must also be satisfied in relation to each window and glazed door:		~	~
Each window or glazed door with standard aluminium or timber frames and single clear or toned glass may either match the description, or, have a U-value and a Solar Heat Gain Coefficient (SHCD) no greater than that listed in the table below. Total system U-values and SHGCs must be calculated in accordance with National Fenestration Rating Council (INFRC) conditions.		~	~
Each window or glazed door with improved frames, or pyrolytic low-e glass, or clear/air gap/clear glazing, or toned/air gap/clear glazing must have a U-value and a Solar Heat Gain Coefficient (SHGC) no greater than that listed in the table below. Total system U-values and SHGCs must be calculated in accordance with National Fenestration Rating Council (NFRC) conditions. The description is provided for information only. Atternative systems with complying U-value and SHGC may be substituted.		~	~
For projections described in millimetres, the leading edge of each eave, pergola, verandah, balcony or awning must be no more than 500 mm above the head of the window or glazed door and no more than 2400 mm above the sill.	~	~	~
Pergolas with polycarbonate roof or similar translucent material must have a shading coefficient of less than 0.35.		~	~
External louvres and blinds must fully shade the window or glazed door beside which they are situated when fully drawn or closed.		~	~
Pergolas with fixed battens must have battens parallel to the window or glazed door above which they are situated, unless the pergola also shades a perpendicular window. The spacing between battens must not be more than 50 mm.		✓	~
Overshadowing buildings or vegetation must be of the height and distance from the centre and the base of the window and glazed door, as specified in the 'overshadowing' column in the table below.	~	~	~

Blazing requir	ements						Show on DA Plans	Show on CC/CDC Plans & specs	Certifier Check
/indows and gla	zed doors glazing	requirements							
Window/door number	Orientation	Area of glass including frame (m2)	Overshadowing height (m)	Overshadowing distance (m)	Shading device	Frame and glass type			
W01	N	4.4	0	0	eave/ verandah/ pergola/balcony >=750 mm	standard aluminium, single clear, (or U-value: 7.63, SHGC: 0.75)			
D01	N	9.4	0	0	eave/ verandah/ pergola/balcony >=750 mm	standard aluminium, single clear, (or U-value: 7.63, SHGC: 0.75)			
W06a	N	0.6	5.1	1.57	eave/ verandah/ pergola/balcony >=900 mm	standard aluminium, single clear, (or U-value: 7.63, SHGC: 0.75)			
W07	N	5	5.1	1.57	none	standard aluminium, single clear, (or U-value: 7.63, SHGC: 0.75)			
W02	E	1	0	0	eave/ verandah/ pergola/balcony >=900 mm	standard aluminium, single clear, (or U-value: 7.63, SHGC: 0.75)			

Blazing requirements								Show on CC/CDC Plans & specs	Certifier Check
Window/door number	Orientation	Area of glass including frame (m2)	Overshadowing height (m)	Overshadowing distance (m)	Shading device	Frame and glass type			
W04	E	1.2	2.7	1.5	none	standard aluminium, single clear, (or U-value: 7.63, SHGC: 0.75)			
W04a	Е	1	0.72	1.4	none	aluminium, double Lo- Tsol/air gap/ clear, (U-value: 4.9, SHGC: 0.33)			
W05	E	5	0	0	eave/ verandah/ pergola/balcony >=450 mm	standard aluminium, single pyrolytic low-e, (U- value: 5.7, SHGC: 0.47)			
W06	E	0.9	0	0	eave/ verandah/ pergola/balcony >=900 mm	standard aluminium, single clear, (or U-value: 7.63, SHGC: 0.75)			
W08	E	2.1	3.1	3.4	eave/ verandah/ pergola/balcony >=750 mm	standard aluminium, single clear, (or U-value: 7.63, SHGC: 0.75)			

Blazing requir	ements						Show on DA Plans	Show on CC/CDC Plans & specs	Certifie Check
/indows and gla	zed doors glazing	g requirements							
Window/door number	Orientation	Area of glass including frame (m2)	Overshadowing height (m)	Overshadowing distance (m)	Shading device	Frame and glass type			
W09	E	2.1	3.1	2.9	eave/ verandah/ pergola/balcony >=750 mm	standard aluminium, single clear, (or U-value: 7.63, SHGC: 0.75)			
W10	Е	1.7	0.67	3.1	eave/ verandah/ pergola/balcony >=750 mm	standard aluminium, single pyrolytic low-e, (U- value: 5.7, SHGC: 0.47)			
W12	E	1.7	0	0	eave/ verandah/ pergola/balcony >=450 mm	standard aluminium, single pyrolytic low-e, (U- value: 5.7, SHGC: 0.47)			
D02	s	11.4	0	0	eave/ verandah/ pergola/balcony >=450 mm	standard aluminium, single clear, (or U-value: 7.63, SHGC: 0.75)			
D03	S	6.1	0	0	none	standard aluminium, single clear, (or U-value: 7.63, SHGC: 0.75)			

Slazing requirements							Show on DA Plans	Show on CC/CDC Plans & specs	Certifier Check
Window/door number	Orientation	Area of glass including frame (m2)	Overshadowing height (m)	Overshadowing distance (m)	Shading device	Frame and glass type			
W11	s	1.4	0	0	eave/ verandah/ pergola/balcony >=450 mm	standard aluminium, single clear, (or U-value: 7.63, SHGC: 0.75)			
W03	w	1.2	0	0	eave/ verandah/ pergola/balcony >=900 mm	standard aluminium, single clear, (or U-value: 7.63, SHGC: 0.75)			
W03a	w	1	0	0	eave/ verandah/ pergola/balcony >=900 mm	standard aluminium, single clear, (or U-value: 7.63, SHGC: 0.75)			
W13	w	5	2.52	2.09	none	standard aluminium, single pyrolytic low-e, (U- value: 5.7, SHGC: 0.47)			
W14	W	2.1	1.37	2.57	external louvre/ blind (fixed)	standard aluminium, single clear, (or U-value: 7.63, SHGC: 0.75)			

Legend	
In these commitments, "applicant" means the person carrying out the development.	
Commitments identified with a 💆 in the "Show on DA plans" column must be shown on the plans accompanying the development application for the proposed development application is to be lodged for the proposed development).	/elopment (if a
Commitments identified with a 💆 in the "Show on CC/CDC plans & specs" column must be shown in the plans and specifications accompanying the application for certificate / complying development certificate for the proposed development.	or a construction
Commitments identified with a 💆 in the "Certifier check" column must be certified by a certifying authority as having been fulfilled, before a final occupation certific may be issued.	ate for the development

ACTION PLANS m: 0426 957 518 e:operations@actionplans.com.au

w: www.actionplans.com.au

REV.	DATE	COMMENTS	DRWN
А	27.06.2025	S 4.55 SUBMISSION	sc

NOTES

This drawing is the copyright of Action Plans and not be altered, reproduced or transmitted in any form or by any means in part or in whole with the written permission of Action Plans.

Do not scale measure from drawings. Figured dimensions are to be used only.

The Builder/Contractor shall check and verify all levels and dimensions on site prior to commencement of any work, creation of shop drawings, or fabrication of components.

All errors and omissions are to be verified by the Builder/Contractor and referred to the designer prior to the commencement of works.

All window & door dimensions, orientation, glazing materials, opening types, frame types are to be confirmed by a suitably qualified person prior to the ordering of any such materials are to take place.

U value takes precedence over glazing type/colour in all cases.

all new glazing must meet the BASIX specified frame and glass type, <u>OR</u> meet the certified U value and SHGC value.

CLIENT

MARK HOPKINS & CATHERINE MANU

PROJECT ADDRESS 15 TANGO AVENUE DEE WHY NSW 2099

DRAWING NO. MOD19 DRAWING NAME BASIX COMMITMENTS

DATE Friday, 27 June 2025