DEMOLITION KEY:

TO BE DEMOLISHED



EXISTING TREES TO BE



TREES TO BE REMOVED



THIS DRAWING AND DESIGN IS SUBJECT TO COPYRIGHT AND MAY NOT BE REPRODUCED WITHOUT PRIOR WRITTENCONSENT OF LEFFLER SIMES PTY LTD




Member Australian Institute of Architects


17.04.23 CSG

ISSUE AMENDMENT P1 ISSUE FOR INFORMATION

P2 ISSUE FOR DA ISSUE FOR DA ISSUE FOR DA

18.05.23 CSG 30.05.23 CSG 19.06.23 CSG ISSUE FOR DA 22.06.23 CSG ISSUE FOR DA 27.06.23 CSG 16.08.23 CSG ISSUE FOR DA ISSUE FOR DA 28.03.24 CSG G ISSUE FOR DA 02.04.24 CSG

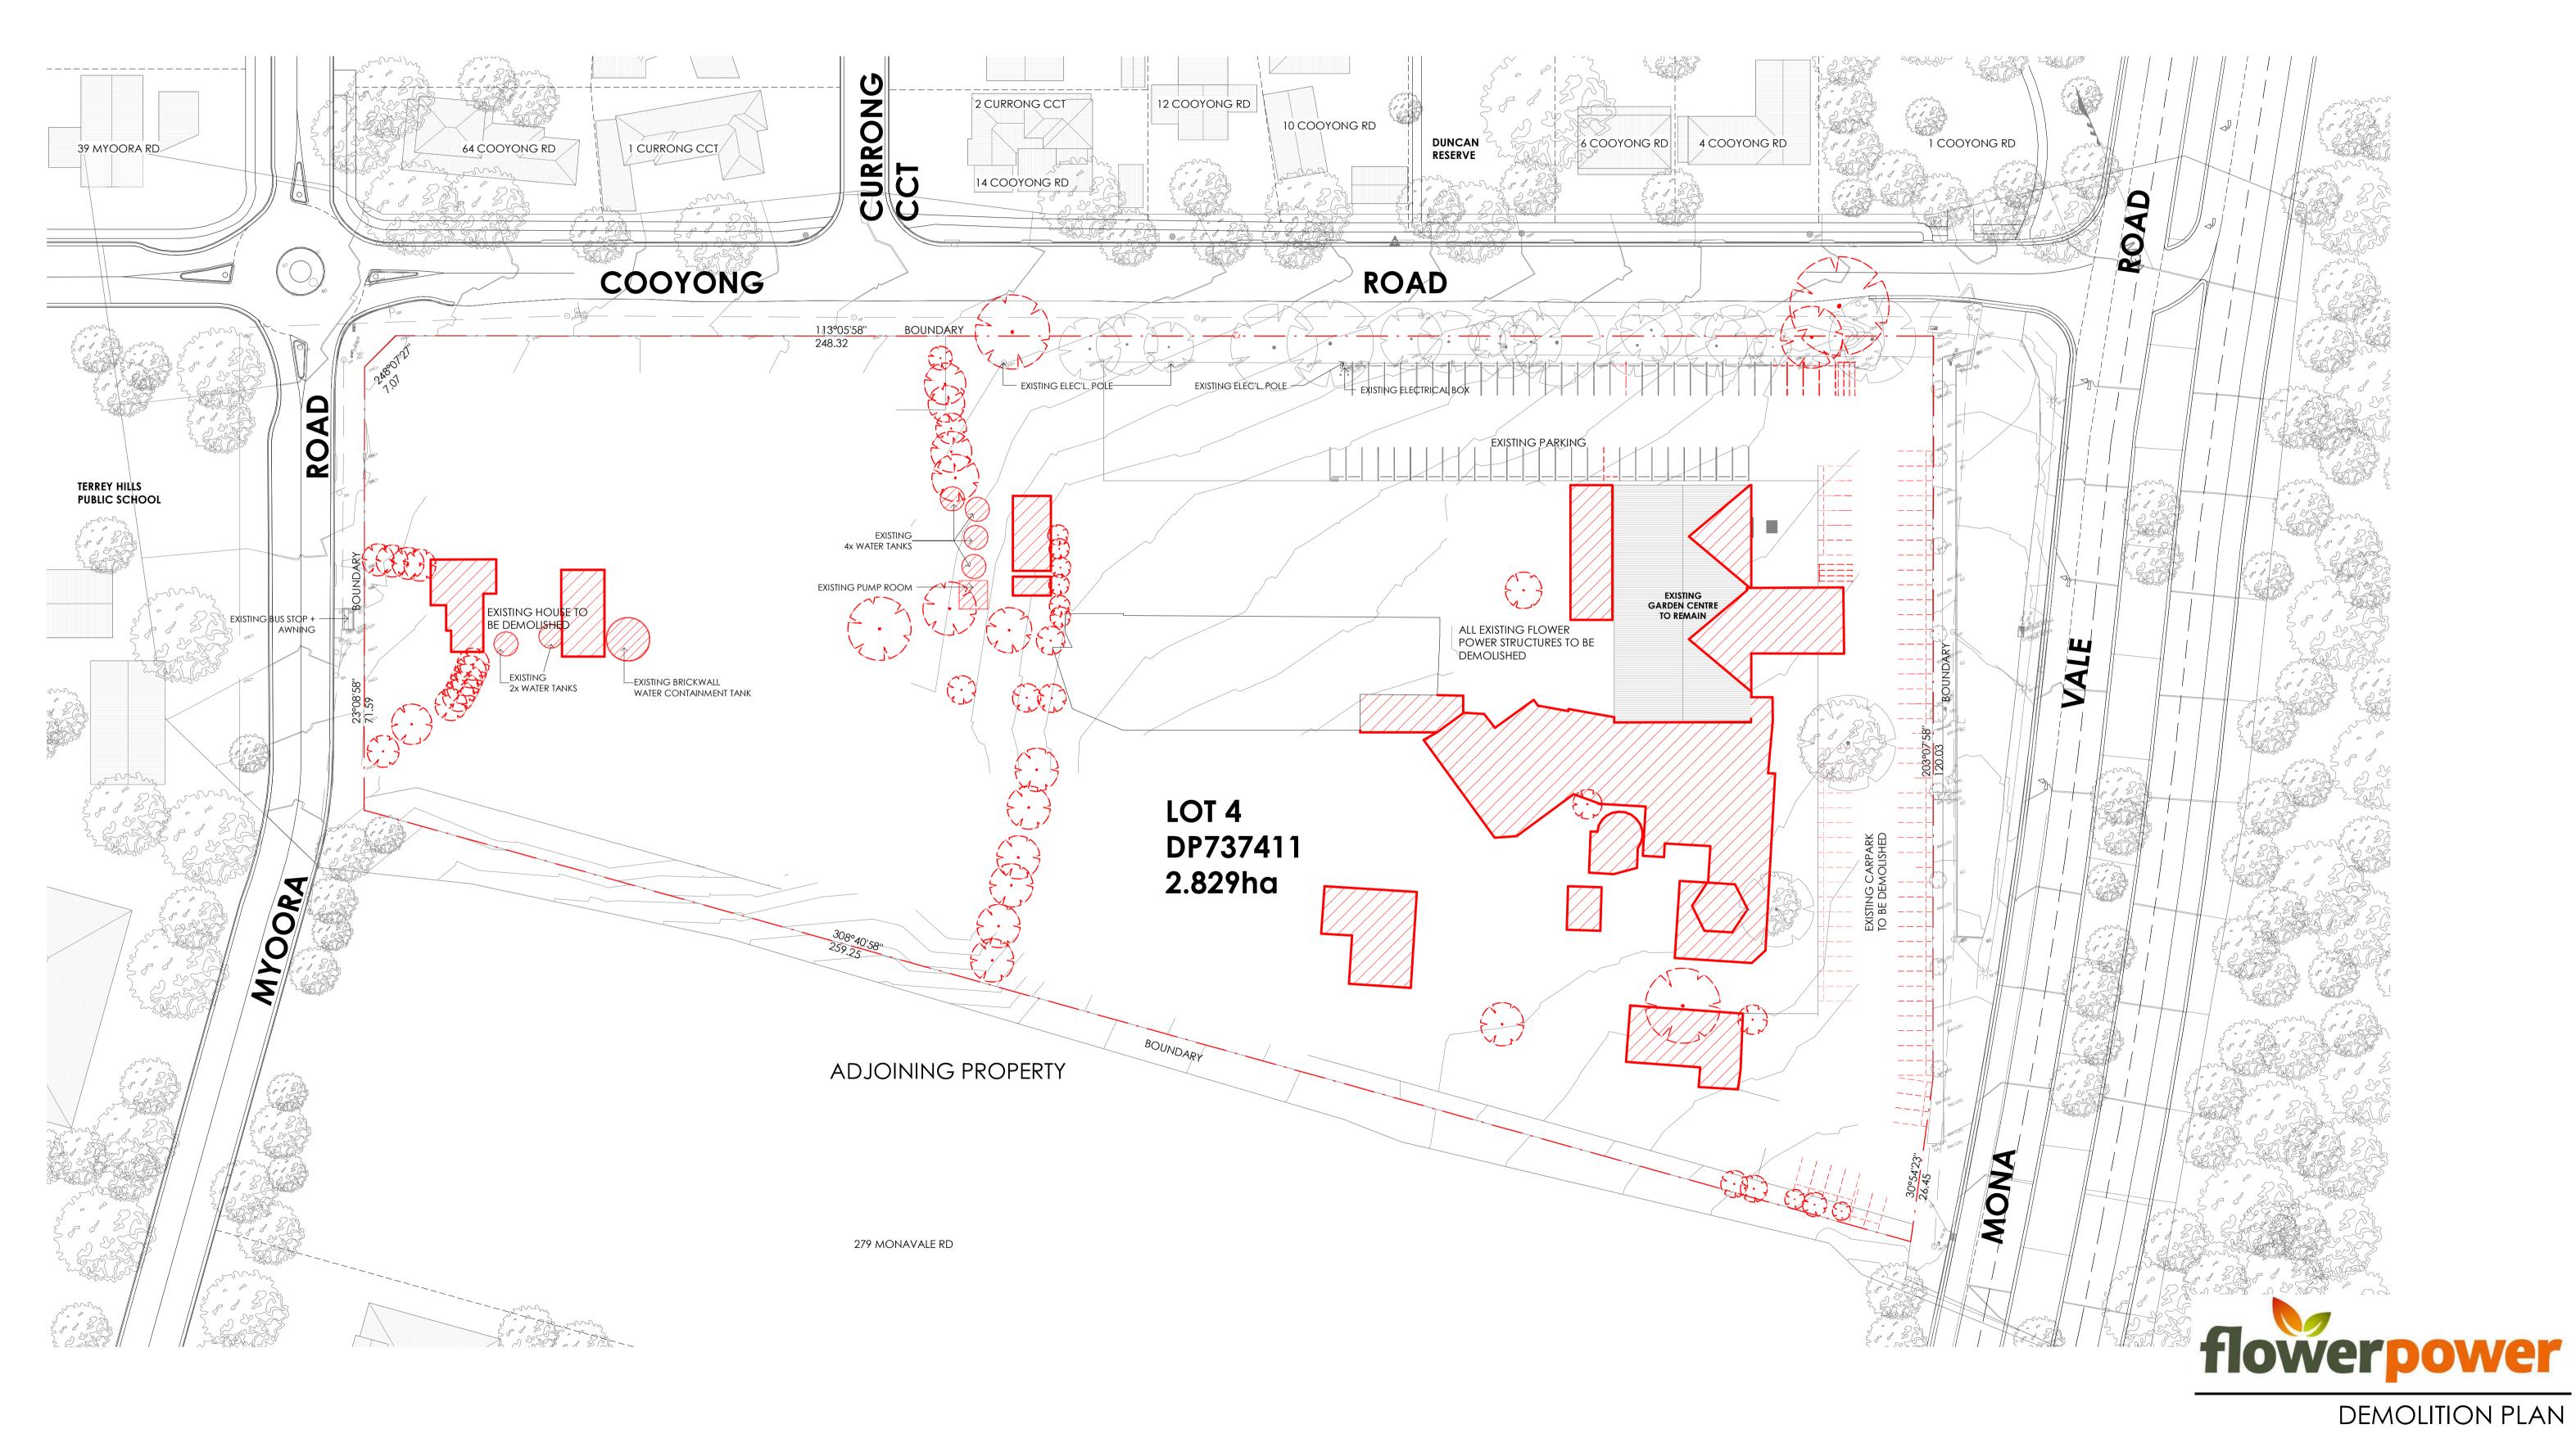

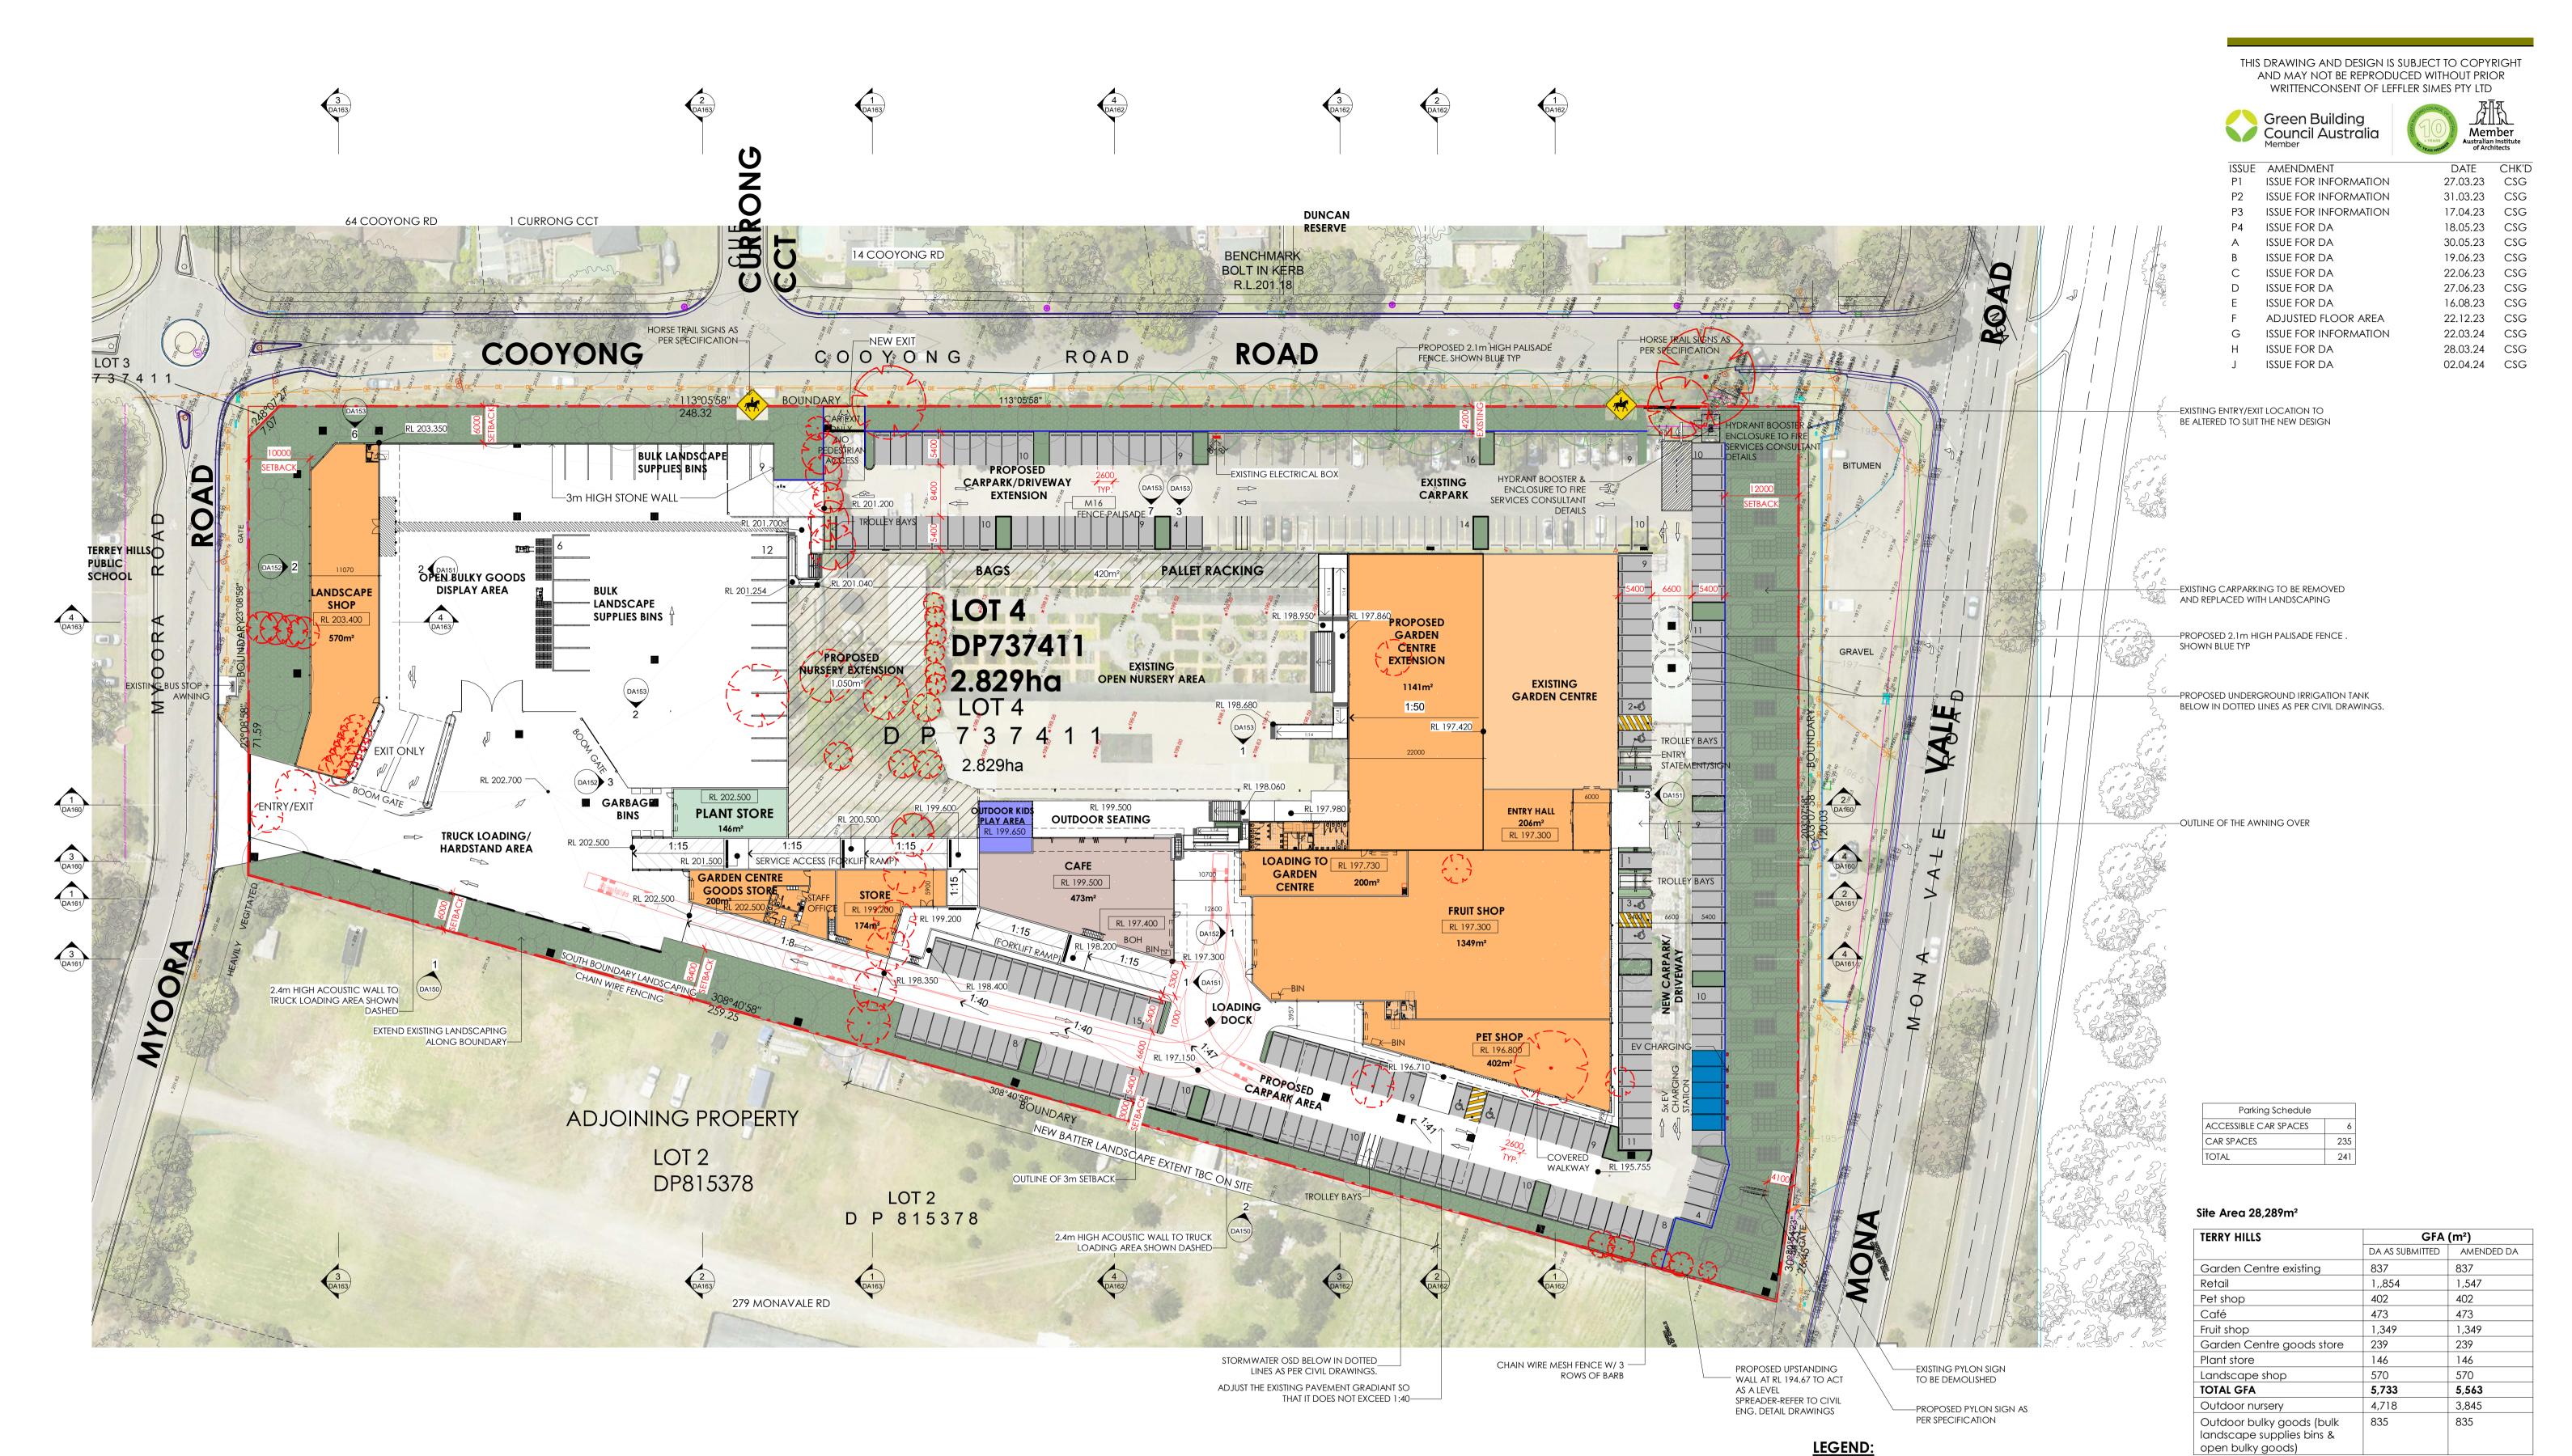





EXISTING TREES TO BE RETAINED



TREES TO BE REMOVED




EXISTING GARDEN CENTRE, OPEN NURSERY AREA, CARPARK & DRIVEWAYS (SHADED IN LIGHT ORANGE COLOR).



open bulky goods)

PROPOSED SITE PLAN



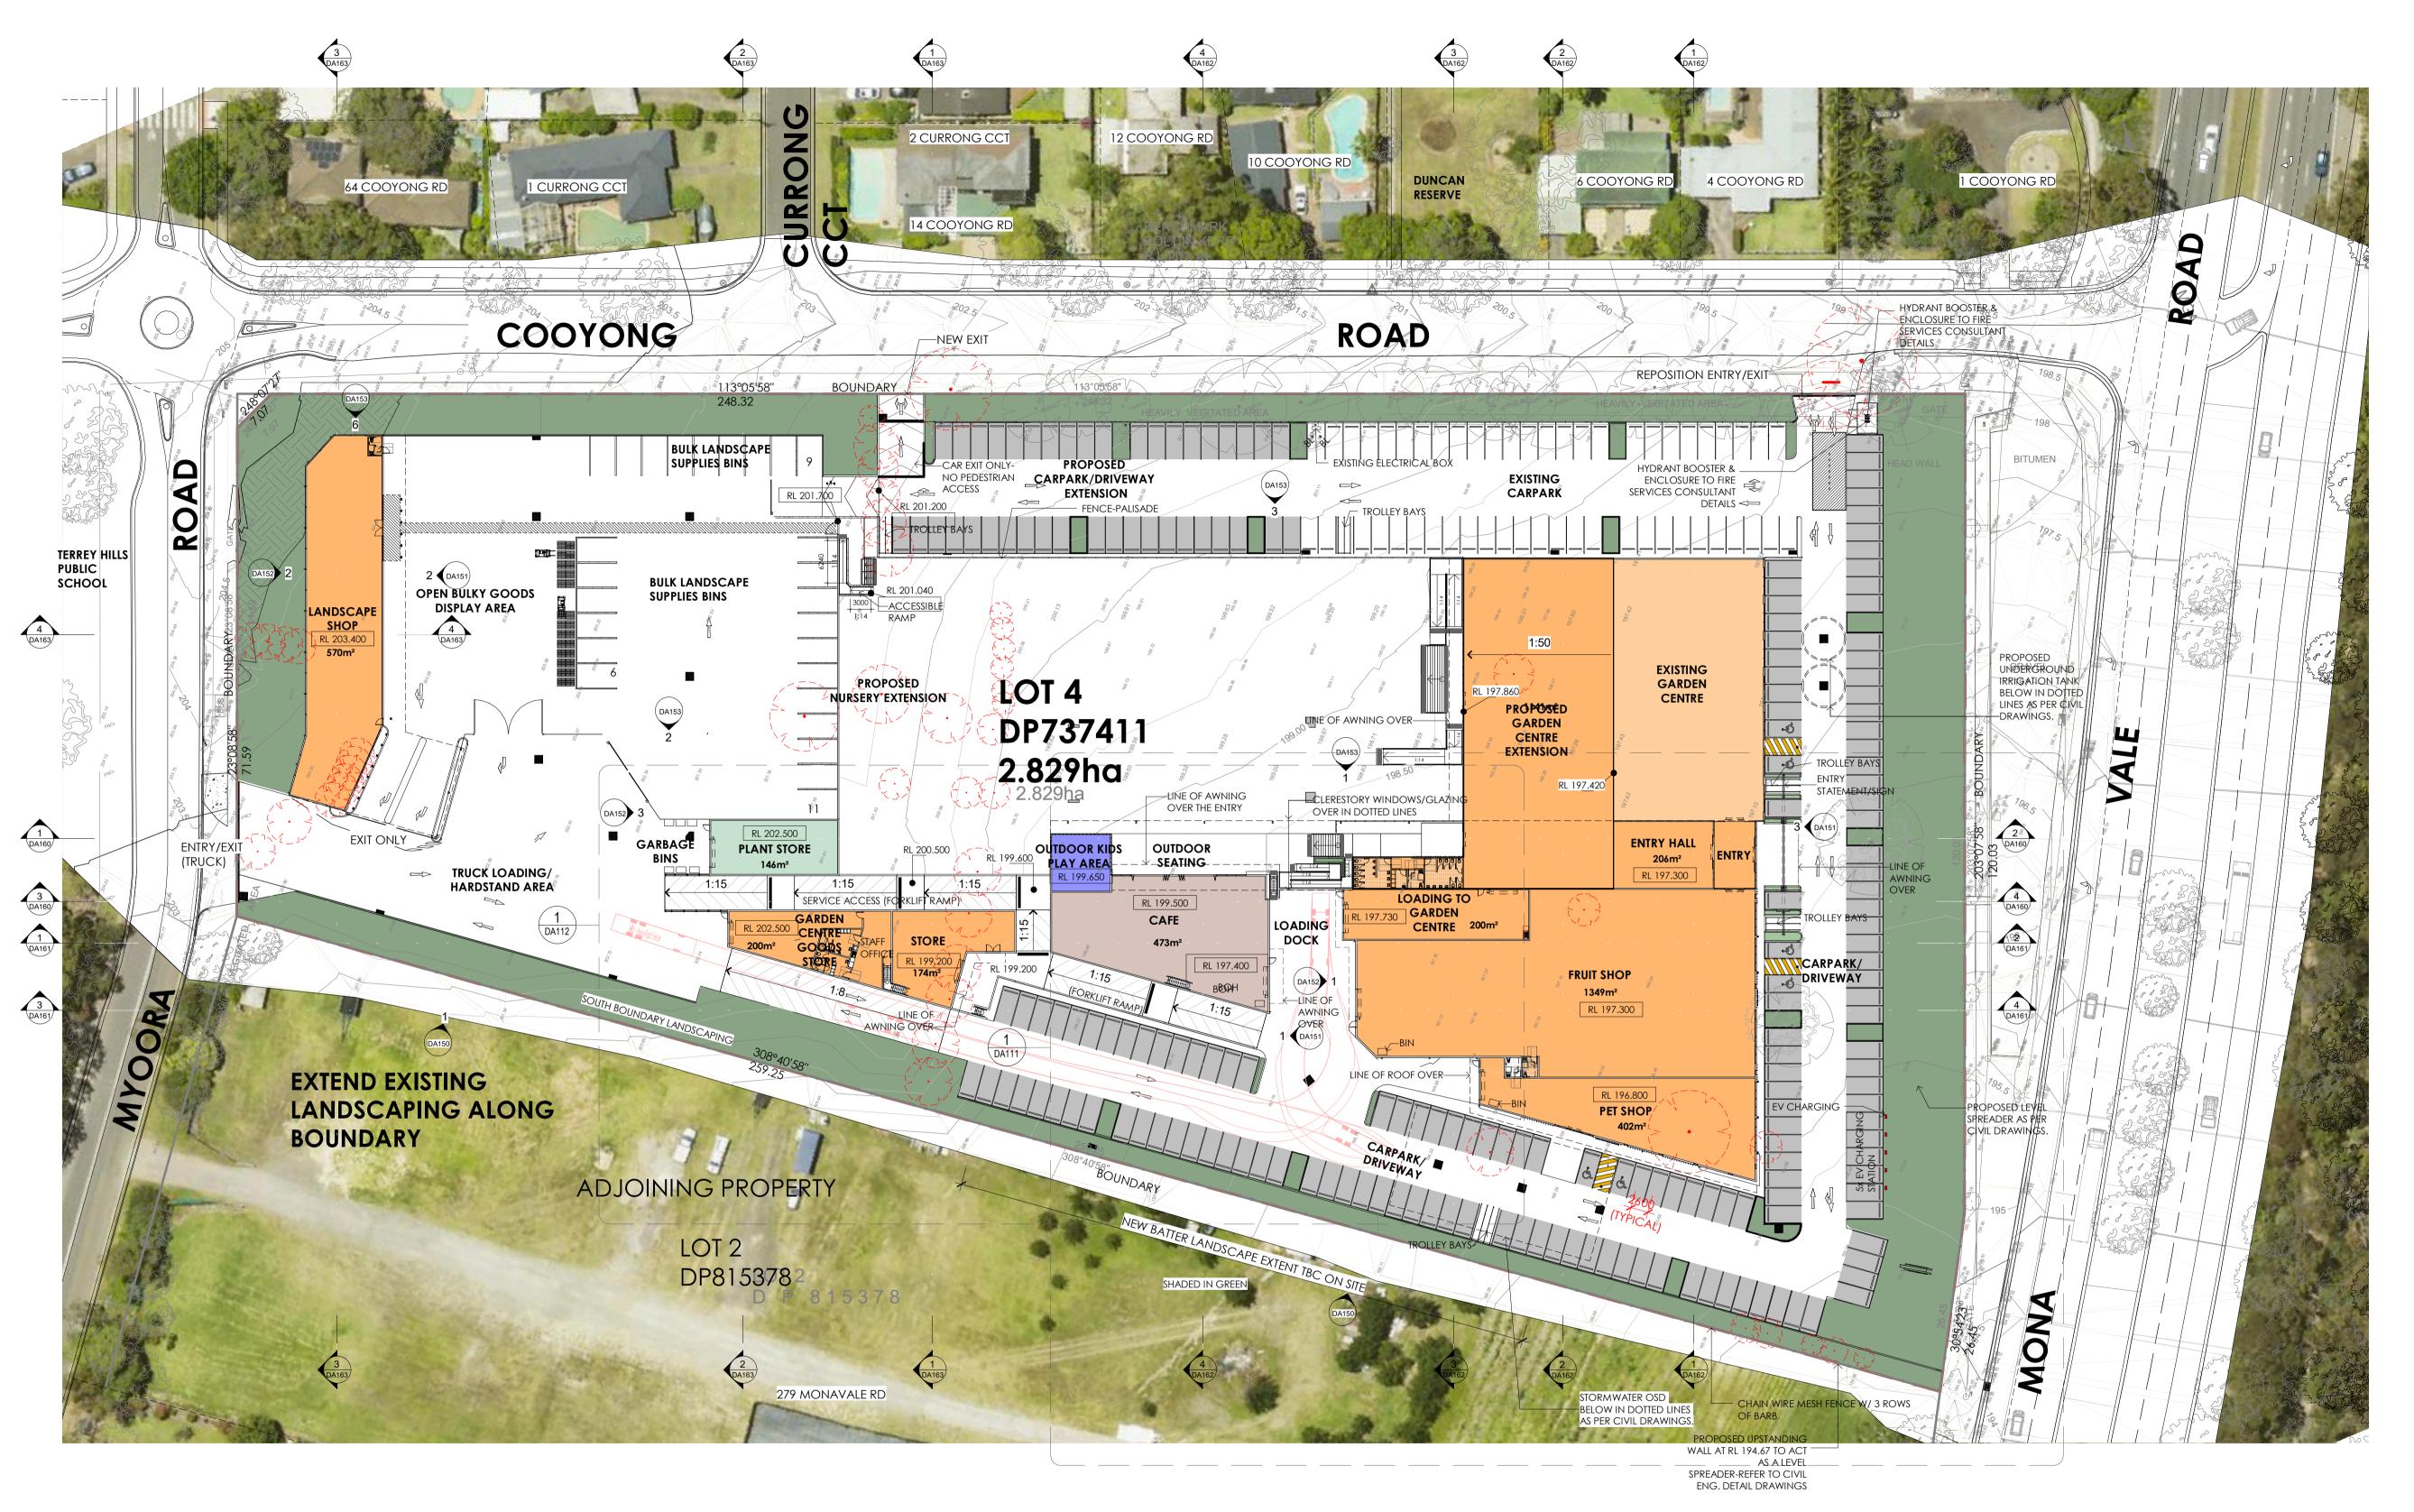

LEGEND:



EXISTING TREES TO BE RETAINED





EXISTING GARDEN CENTRE, OPEN NURSERY AREA, CARPARK & DRIVEWAYS (SHADED IN LIGHT ORANGE COLOR).



OVERALL FLOOR PLAN

THIS DRAWING AND DESIGN IS SUBJECT TO COPYRIGHT AND MAY NOT BE REPRODUCED WITHOUT PRIOR WRITTENCONSENT OF LEFFLER SIMES PTY LTD

Green Building Council Australia

P1 ISSUE FOR INFORMATION

P2 ISSUE FOR INFORMATION ISSUE FOR INFORMATION

ISSUE FOR DA

ISSUE FOR DA

ISSUE FOR DA

ISSUE FOR DA ISSUE FOR DA

ISSUE FOR DA

ISSUE FOR DA

ISSUE FOR INFORMATION

ISSUE AMENDMENT

Member Australian Institut of Architects

27.03.23 CSG 31.03.23 CSG

17.04.23 CSG

18.05.23 CSG 30.05.23 CSG

22.06.23 CSG

09.01.24 CSG

28.03.24 CSG

02.04.24 CSG

19.06.23

27.06.23

16.08.23




THIS PLAN IS TO BE READ IN **CONJUNCTION WITH** THE CONDITIONS OF DEVELOPMENT CONSENT

DA2023/1224





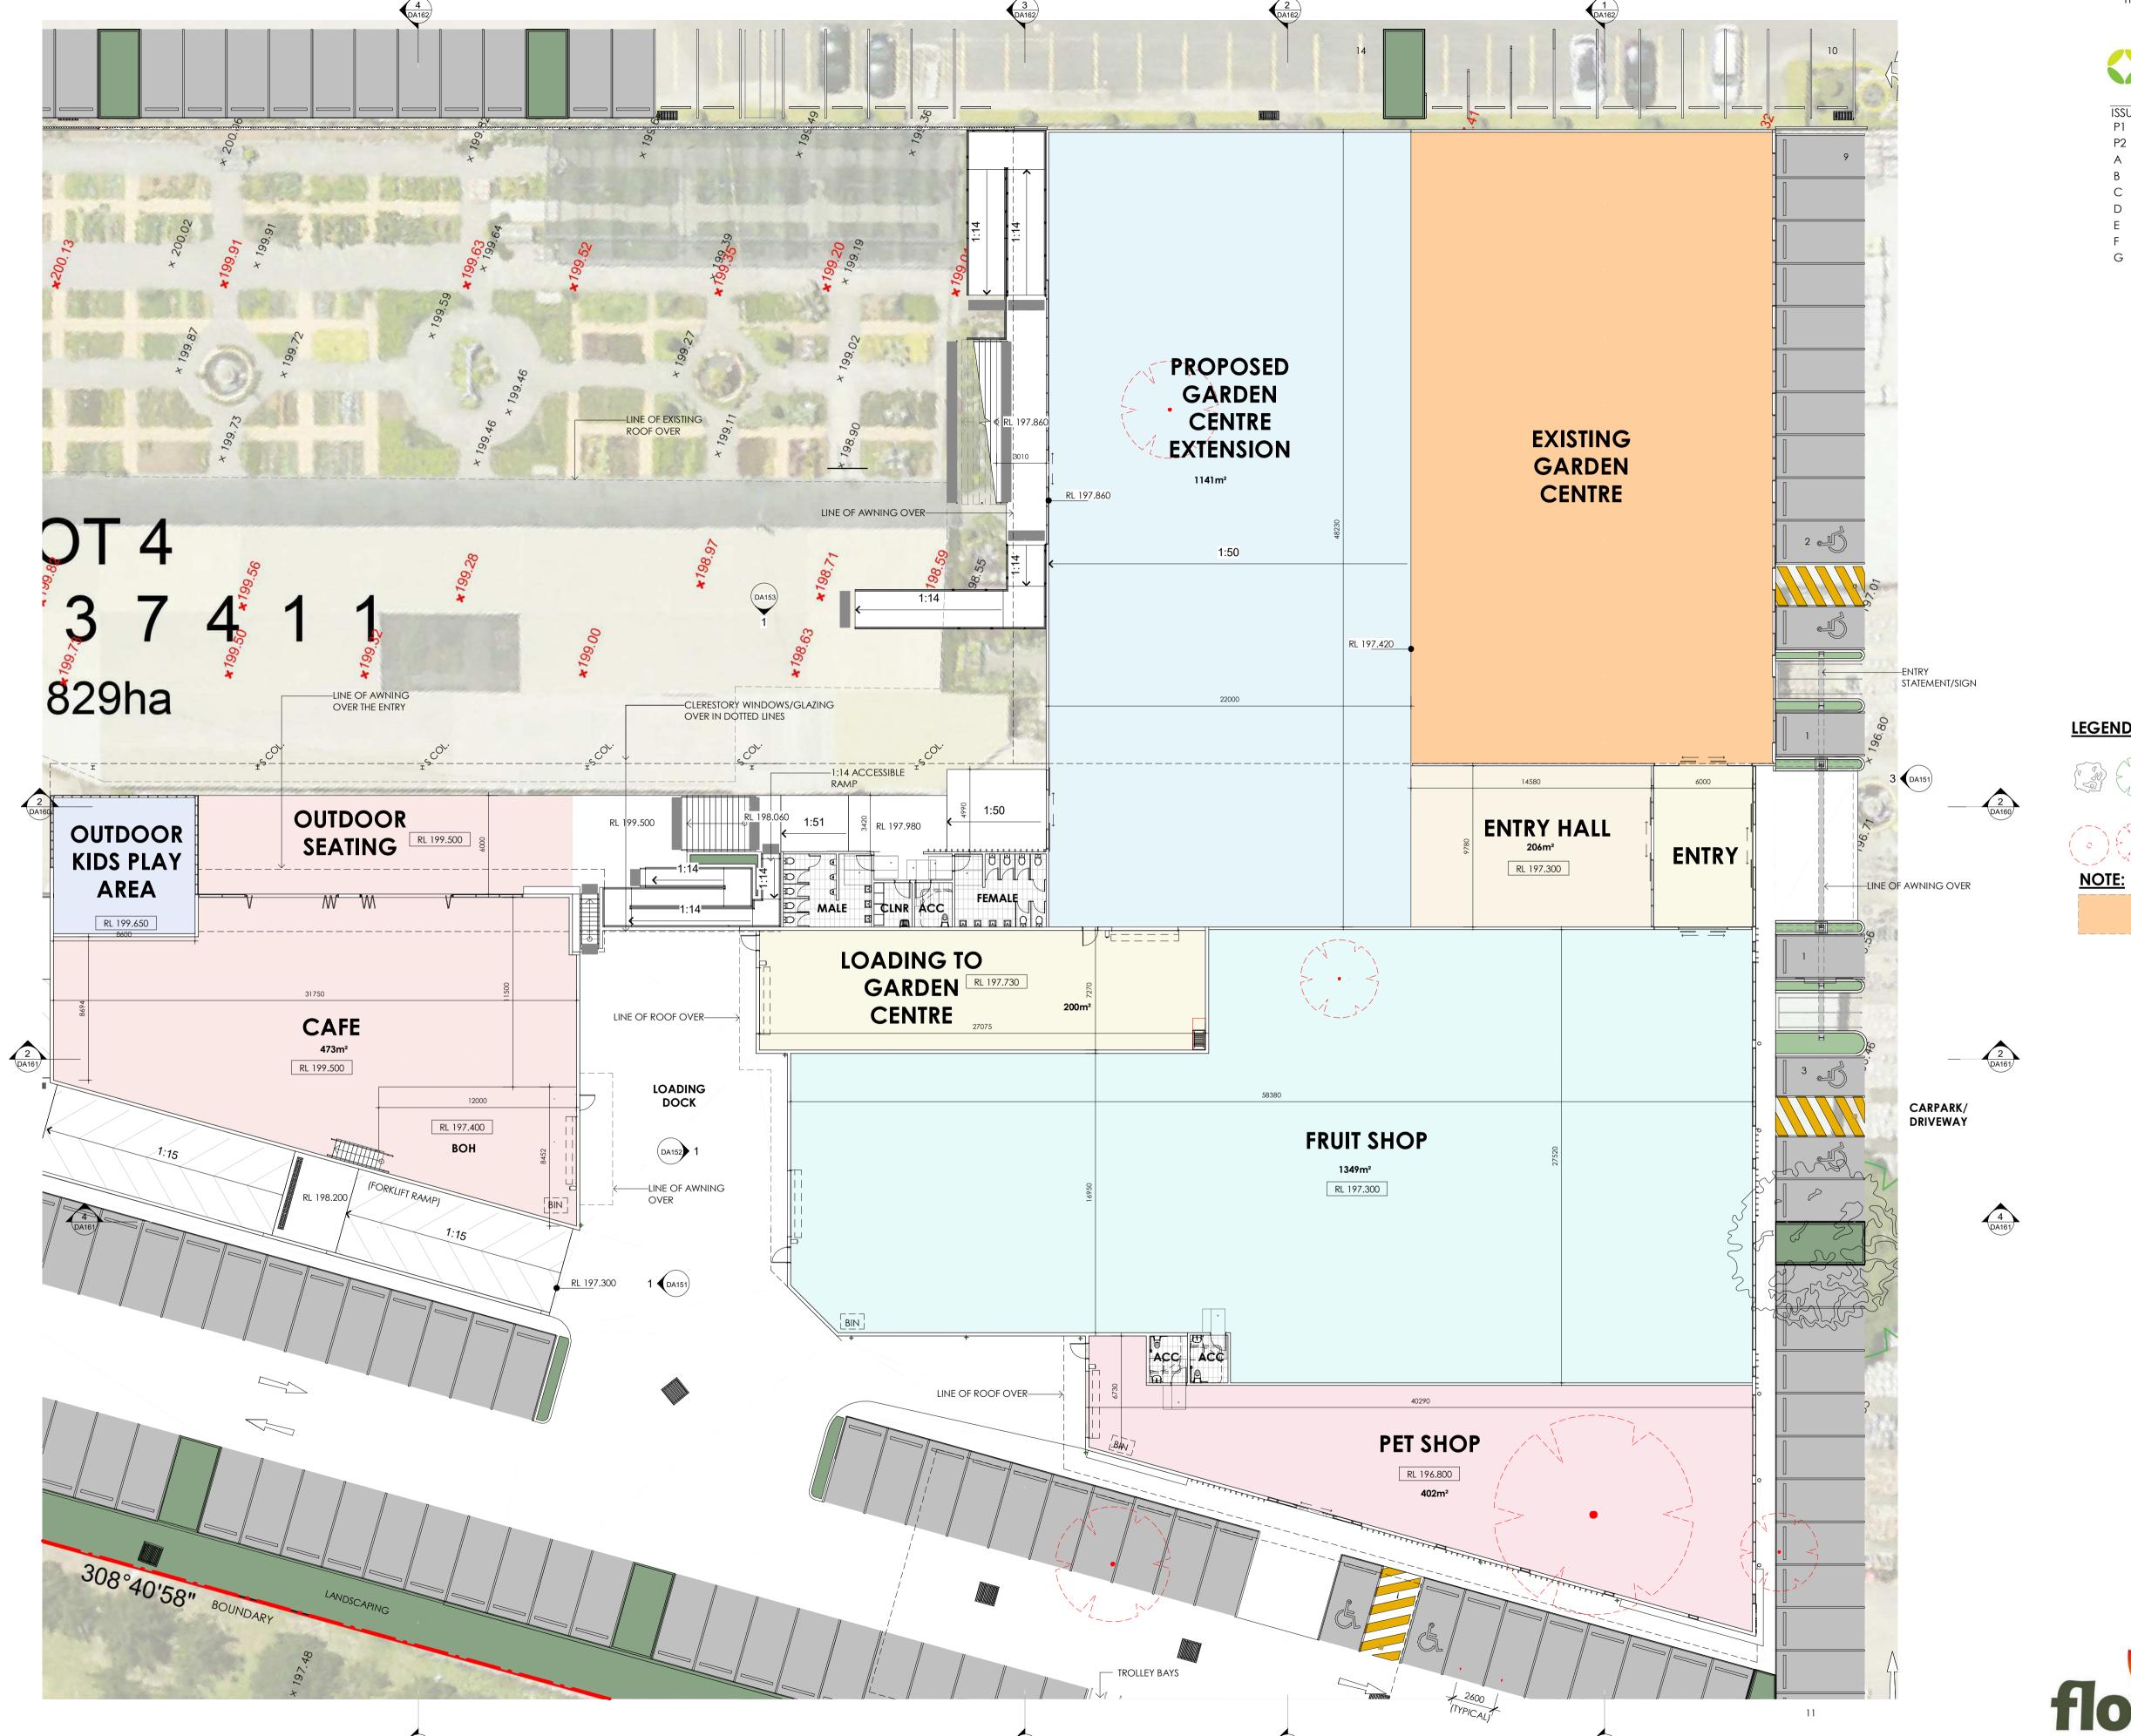

THIS DRAWING AND DESIGN IS SUBJECT TO COPYRIGHT AND MAY NOT BE REPRODUCED WITHOUT PRIOR WRITTENCONSENT OF LEFFLER SIMES PTY LTD

Green Building Council Australia

ISSUE FOR DA



02.04.24 CSG

DATE CHK'D 17.04.23 CSG **ISSUE AMENDMENT** P1 ISSUE FOR INFORMATION 18.05.23 CSG P2 ISSUE FOR DA 30.05.23 CSG ISSUE FOR DA ISSUE FOR DA 19.06.23 CSG 22.06.23 CSG 27.06.23 CSG ISSUE FOR DA 16.08.23 CSG ISSUE FOR DA 28.03.24 CSG ISSUE FOR DA

LEGEND:

EXISTING TREES TO BE RETAINED



EXISTING GARDEN CENTRE, OPEN NURSERY AREA, CARPARK & DRIVEWAYS (SHADED IN LIGHT ORANGE COLOR).

TREES TO BE REMOVED


flowerpower

THIS PLAN IS TO BE READ IN

CONJUNCTION WITH

DA2023/1224

THE CONDITIONS OF DEVELOPMENT

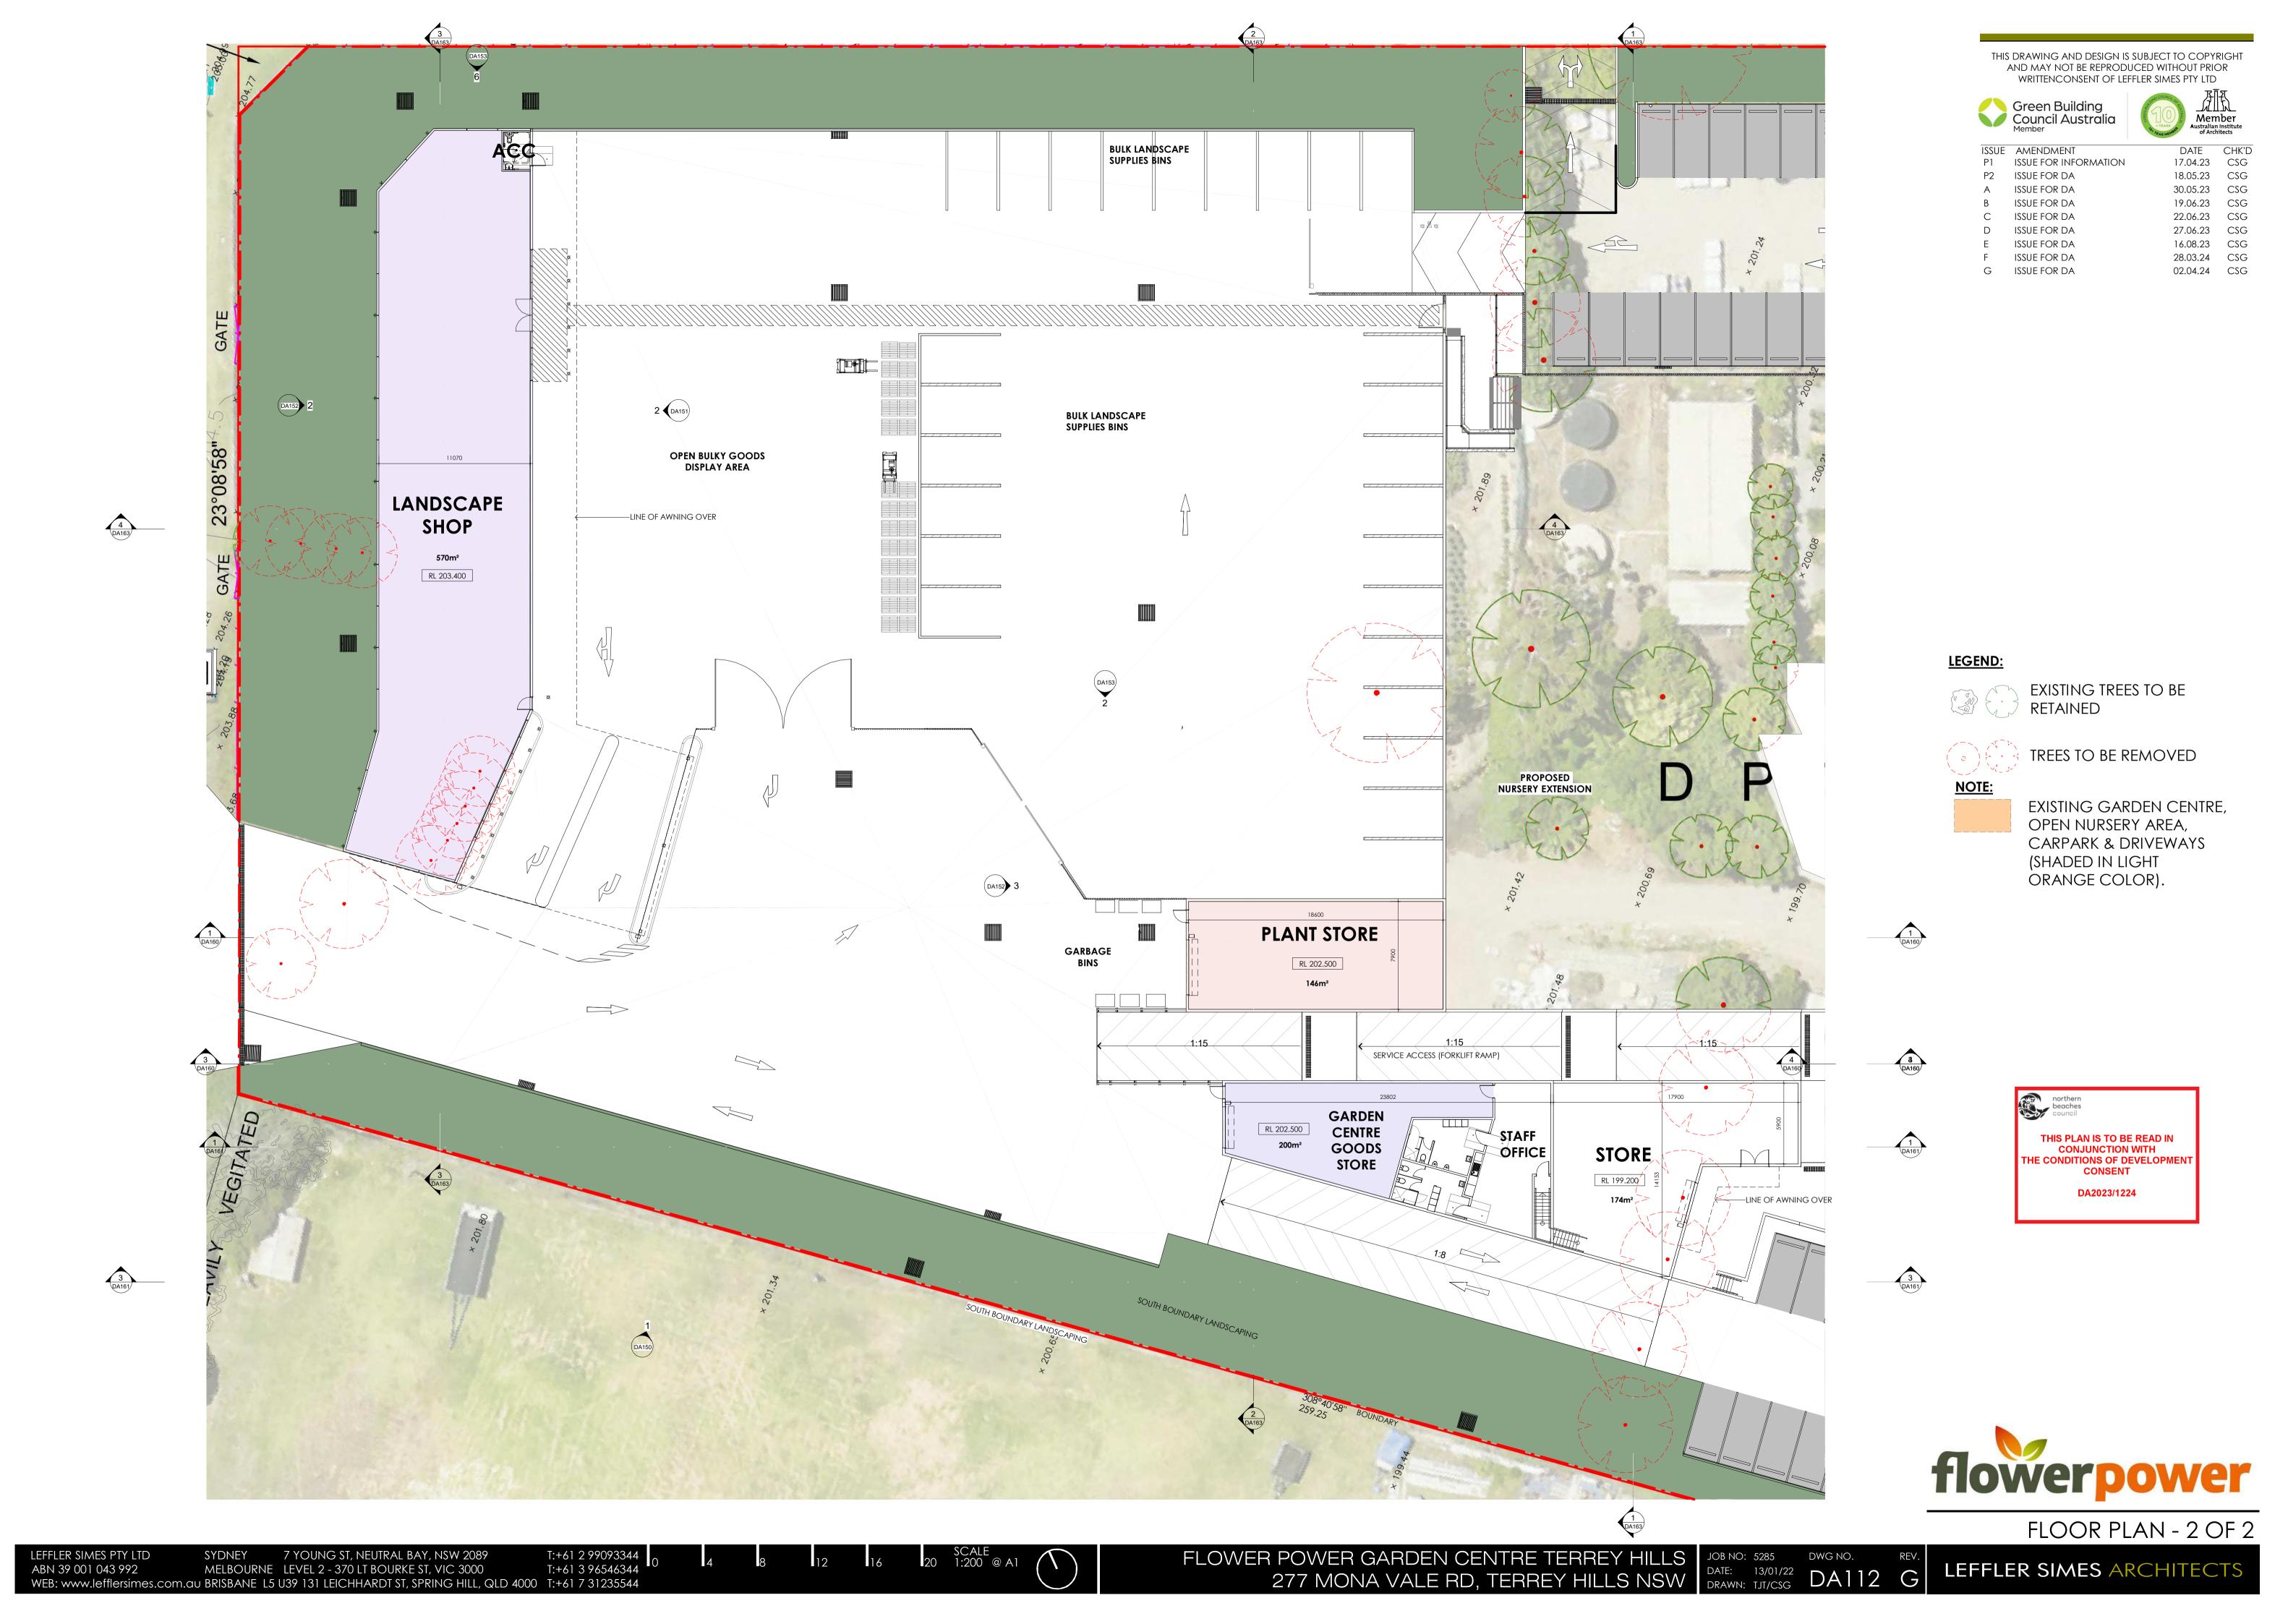




ISSUE FOR DA



02.04.24 CSG

ISSUE AMENDMENT DATE CHK'D 17.04.23 CSG P1 ISSUE FOR INFORMATION 18.05.23 CSG P2 ISSUE FOR DA ISSUE FOR DA 30.05.23 CSG ISSUE FOR DA 19.06.23 CSG 22.06.23 CSG ISSUE FOR DA ISSUE FOR DA 27.06.23 CSG 16.08.23 CSG ISSUE FOR DA ISSUE FOR INFORMATION 09.01.24 CSG ISSUE FOR DA 28.03.24 CSG

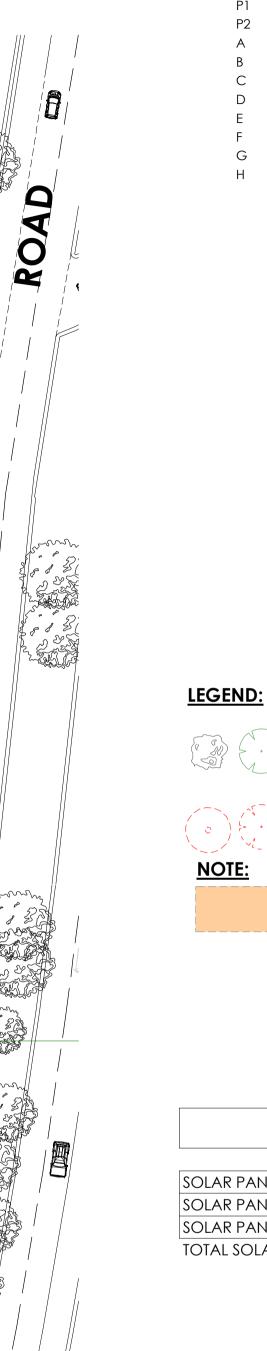

EXISTING GARDEN CENTRE, OPEN NURSERY AREA,

CARPARK & DRIVEWAYS (SHADED IN LIGHT ORANGE COLOR).


EXISTING TREES TO BE

TREES TO BE REMOVED

RETAINED


SOLAR PANELS SCHEDULE

| SOLAR PANELS (ROOF EAST) | 54 |
|----------------------------|-----|
| SOLAR PANELS (ROOF NORTH) | 190 |
| SOLAR PANELS (ROOF SOUTH) | 24 |
| TOTAL SOLAR PANELS (TBC) = | 268 |
| | |

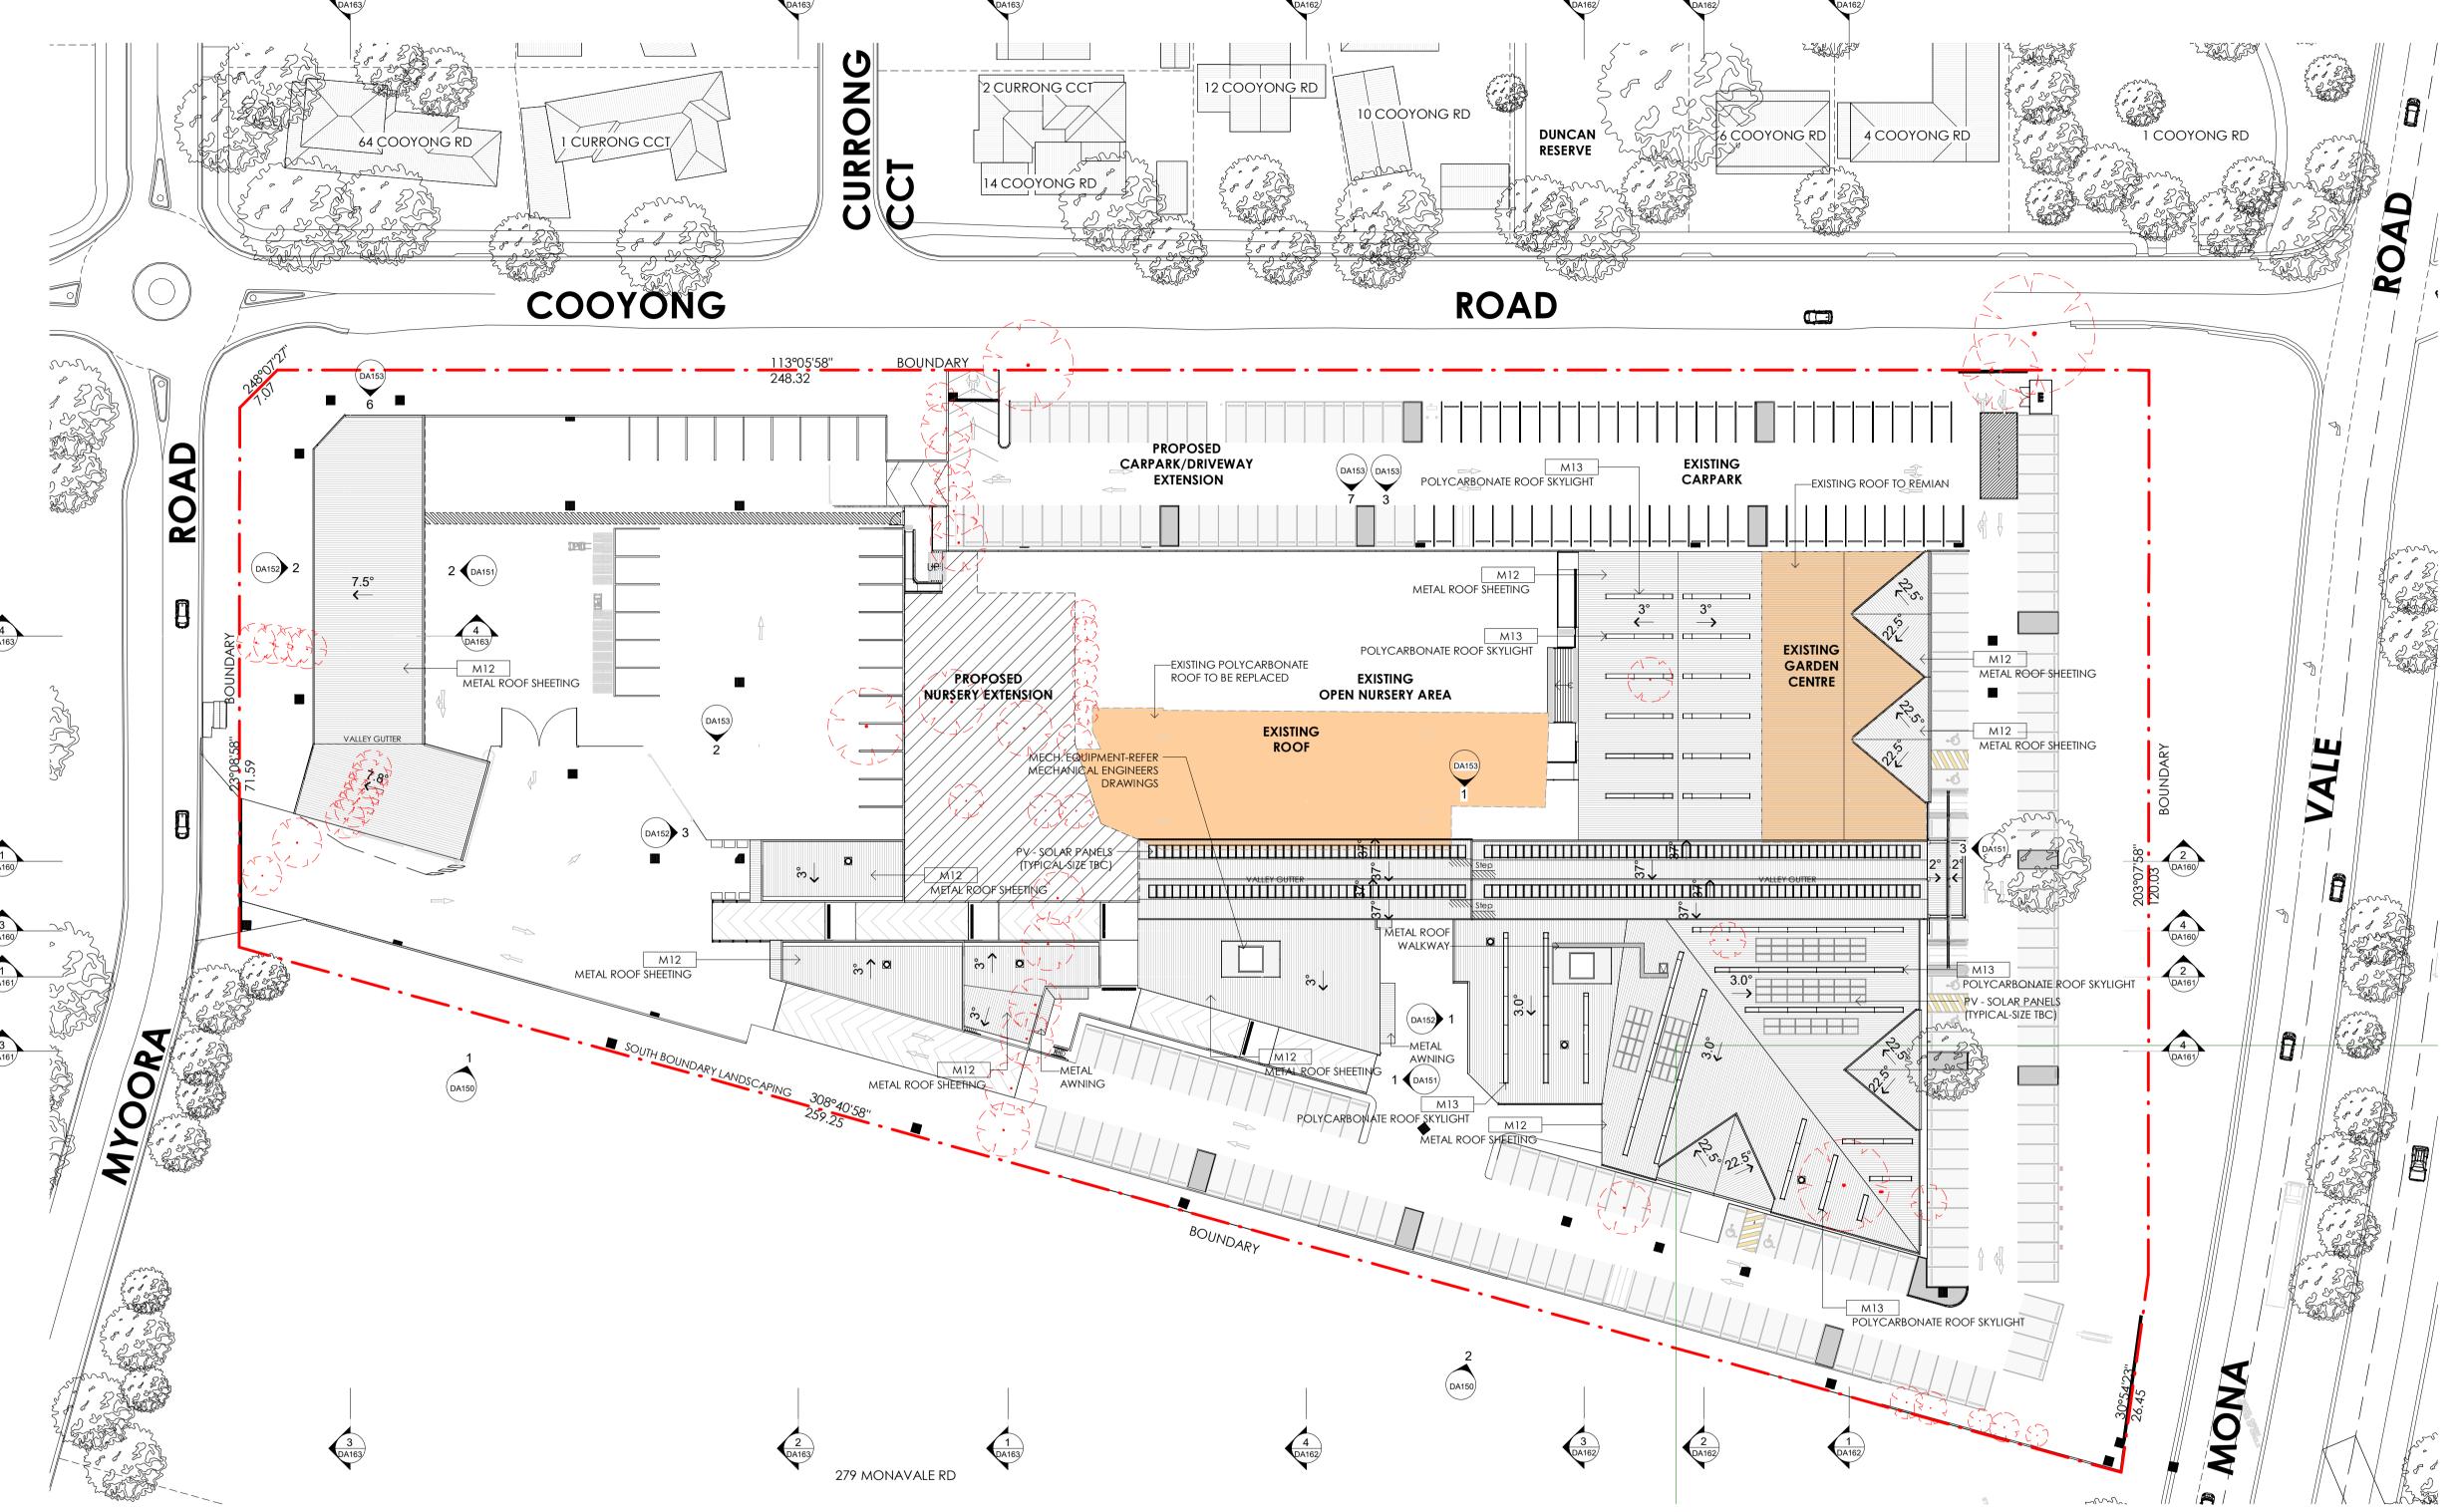





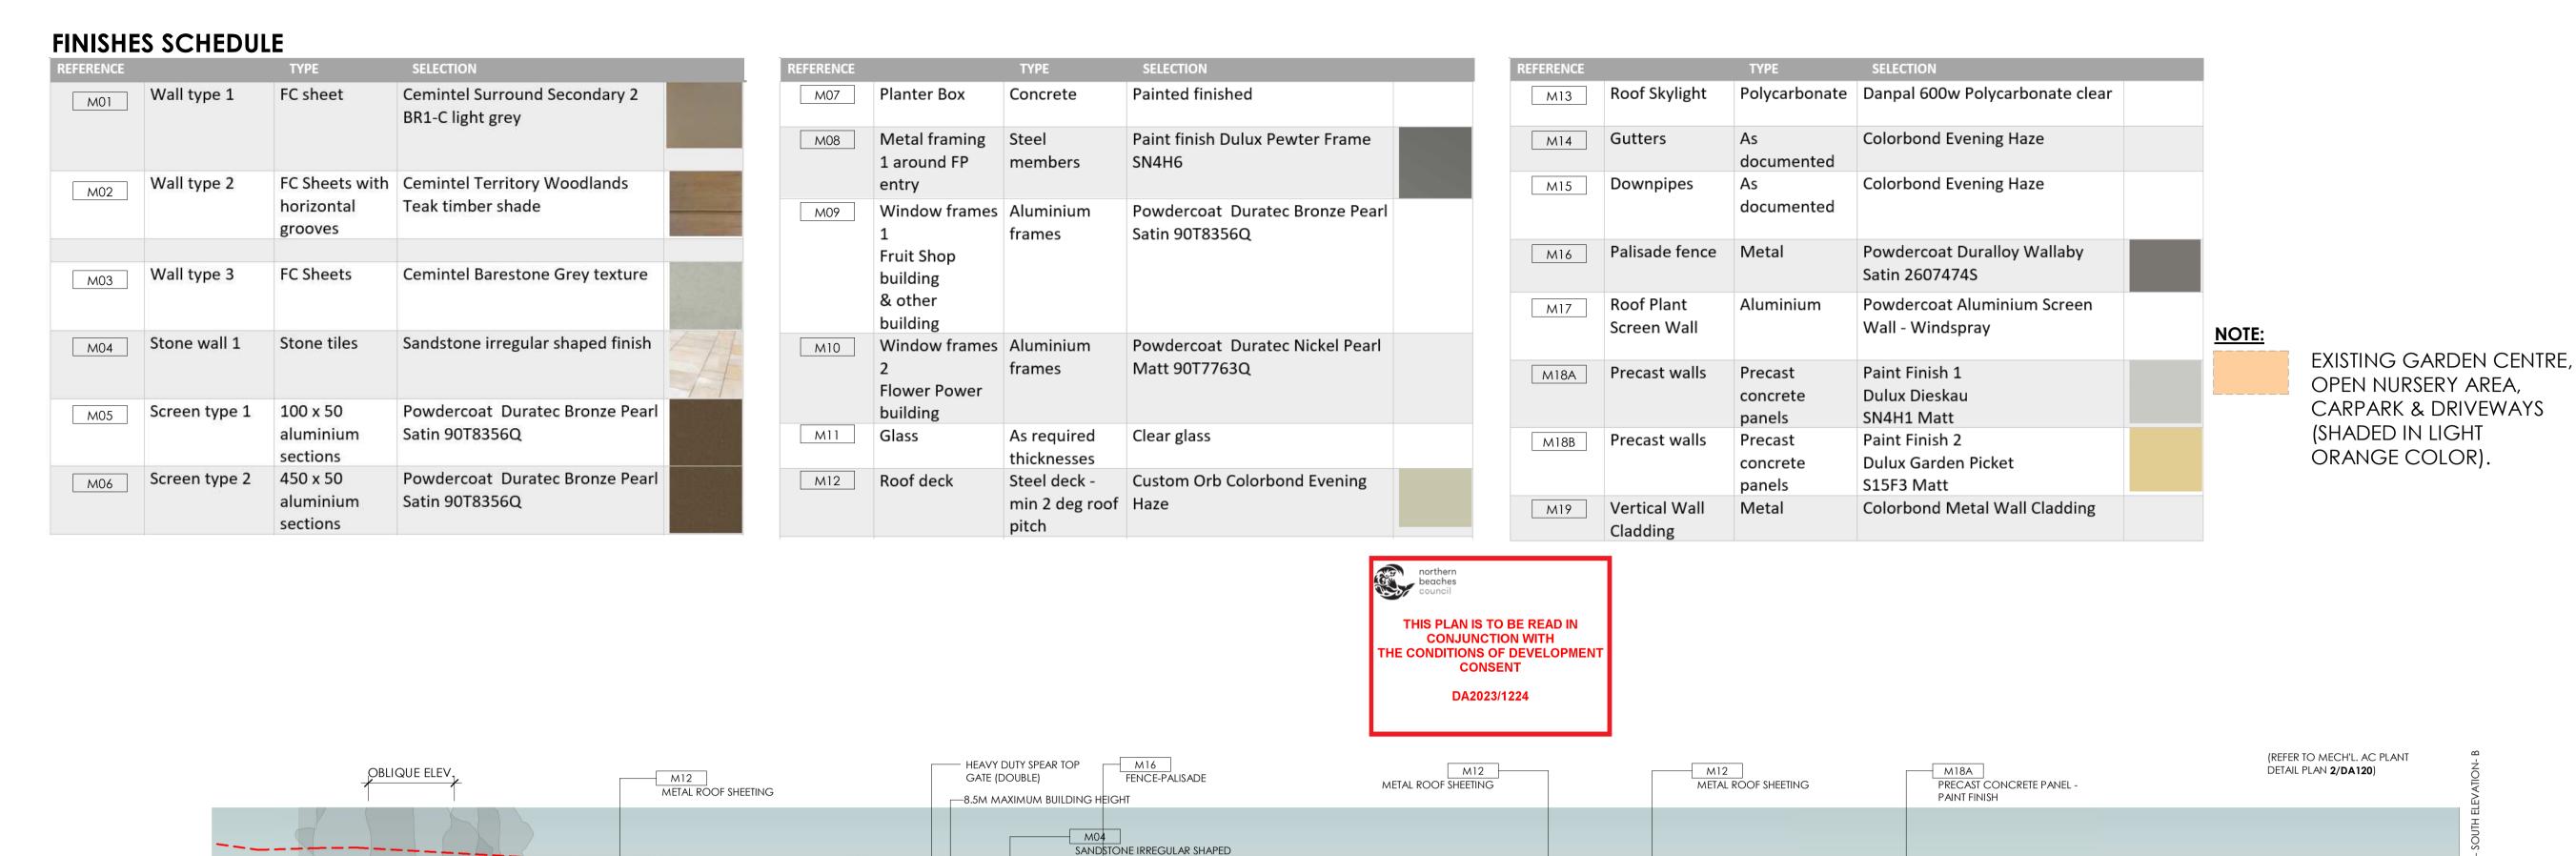

FINISH STONE TILES


PRECAST CONCRETE PANEL -


PAINT FINISH



THIS DRAWING AND DESIGN IS SUBJECT TO COPYRIGHT AND MAY NOT BE REPRODUCED WITHOUT PRIOR

WRITTENCONSENT OF LEFFLER SIMES PTY LTD

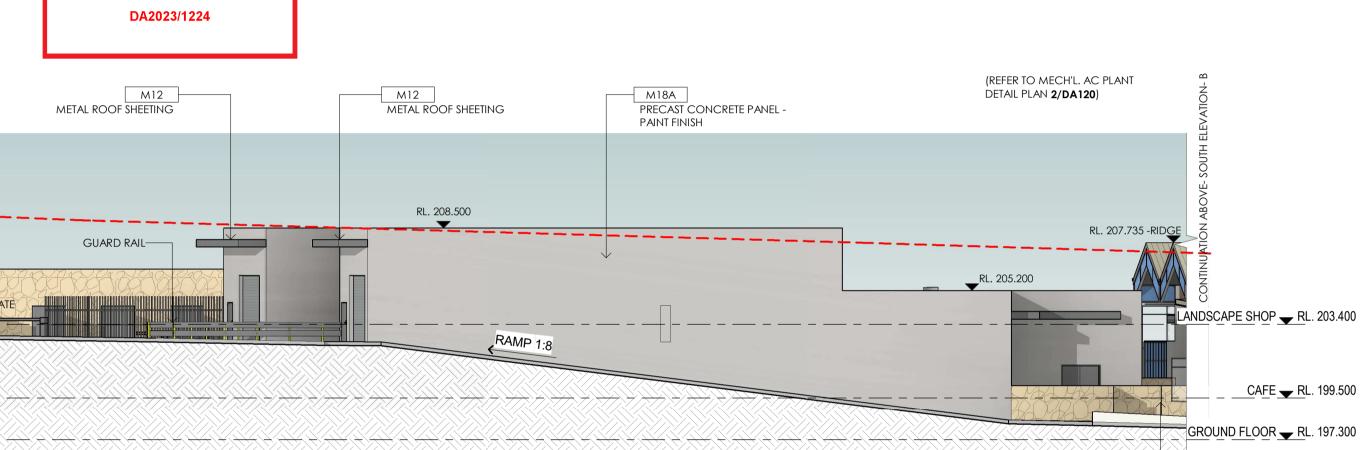

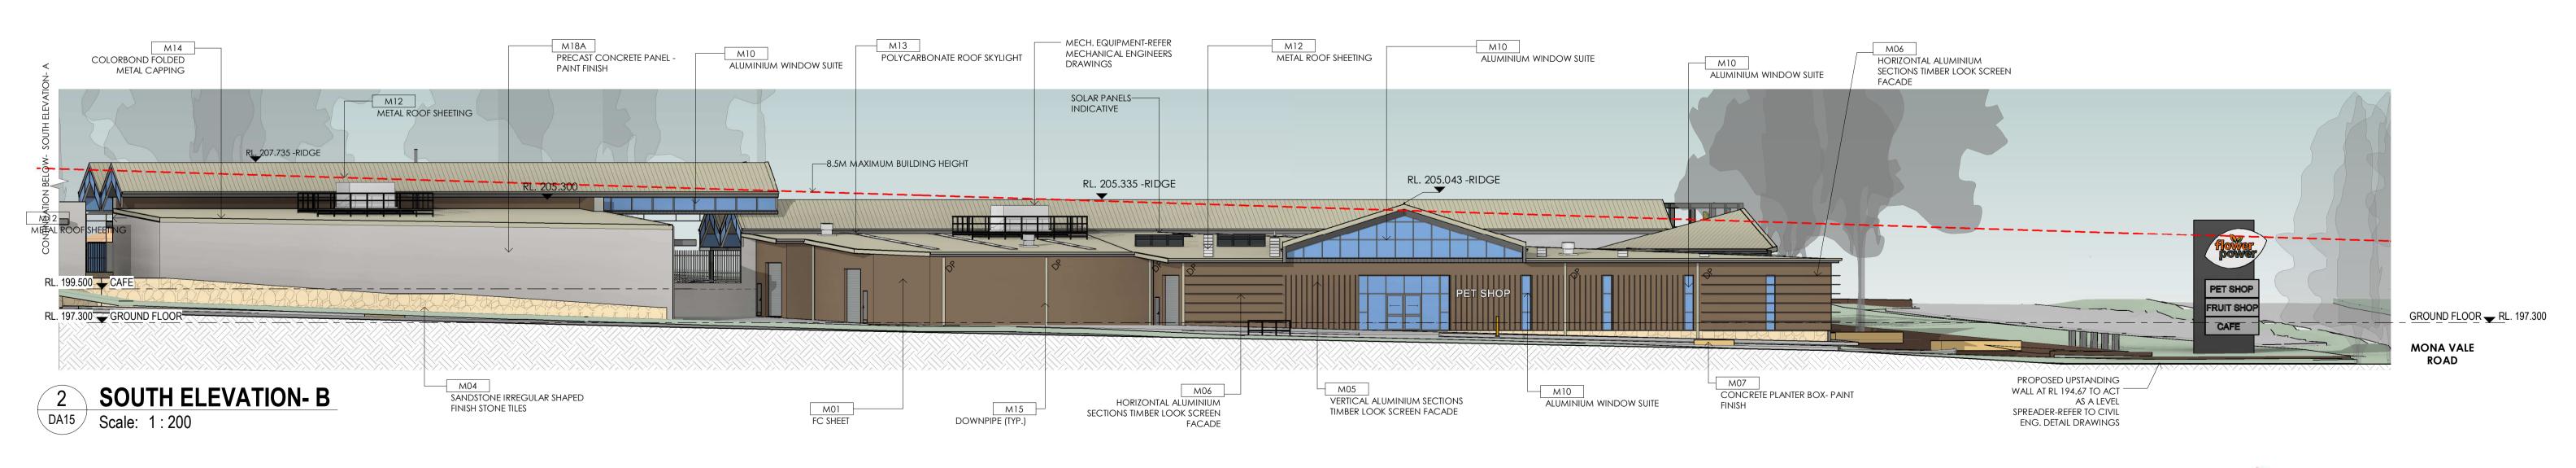



M04

FINISH STONE TILES

SANDSTONE IRREGULAR SHAPED

MYOORA ROAD

RL. 203.400 LANDSCAPE SHOP


Scale: 1:200








ISSUE AMENDMENT CHK'D P1 ISSUE FOR INFORMATION 17.04.23 CSG 18.05.23 CSG P2 ISSUE FOR DA 30.05.23 CSG ISSUE FOR DA ISSUE FOR DA 19.06.23 CSG 22.06.23 CSG ISSUE FOR DA 27.06.23 ISSUE FOR DA CSG 16.08.23 CSG ISSUE FOR DA 28.03.24 CSG ISSUE FOR DA 02.04.24 CSG G ISSUE FOR DA

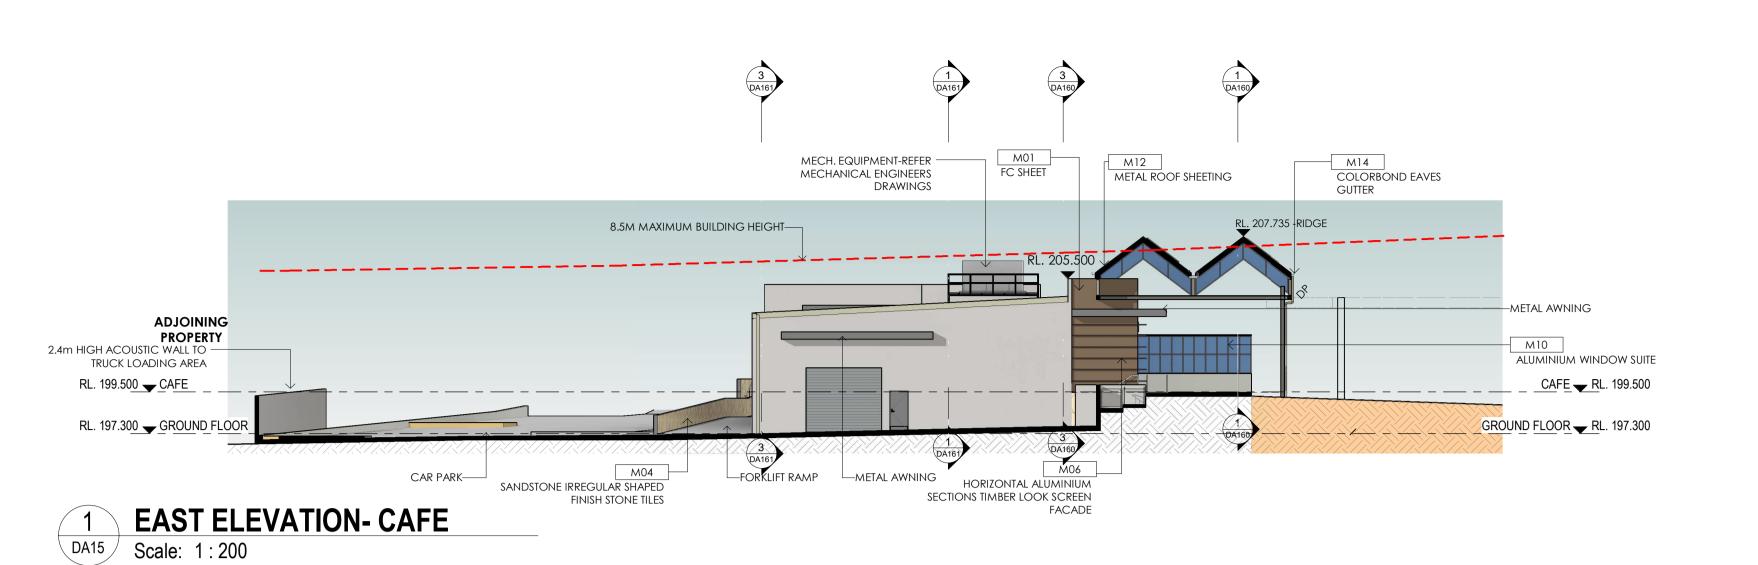

THIS PLAN IS TO BE READ IN **CONJUNCTION WITH** THE CONDITIONS OF DEVELOPMENT CONSENT DA2023/1224

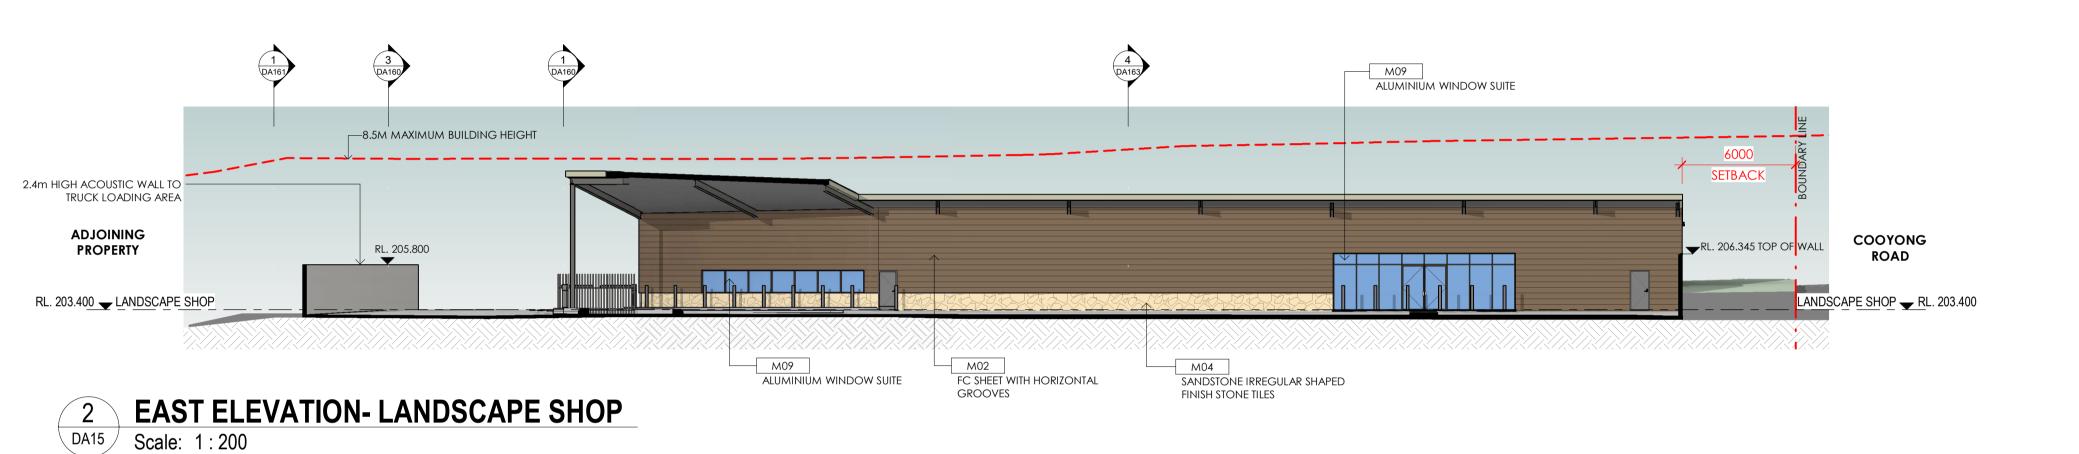


NOTE: EXISTING GARDEN CENTRE, OPEN NURSERY AREA, **CARPARK & DRIVEWAYS** (SHADED IN LIGHT ORANGE COLOR).











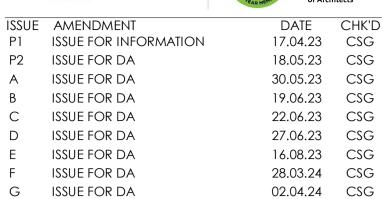


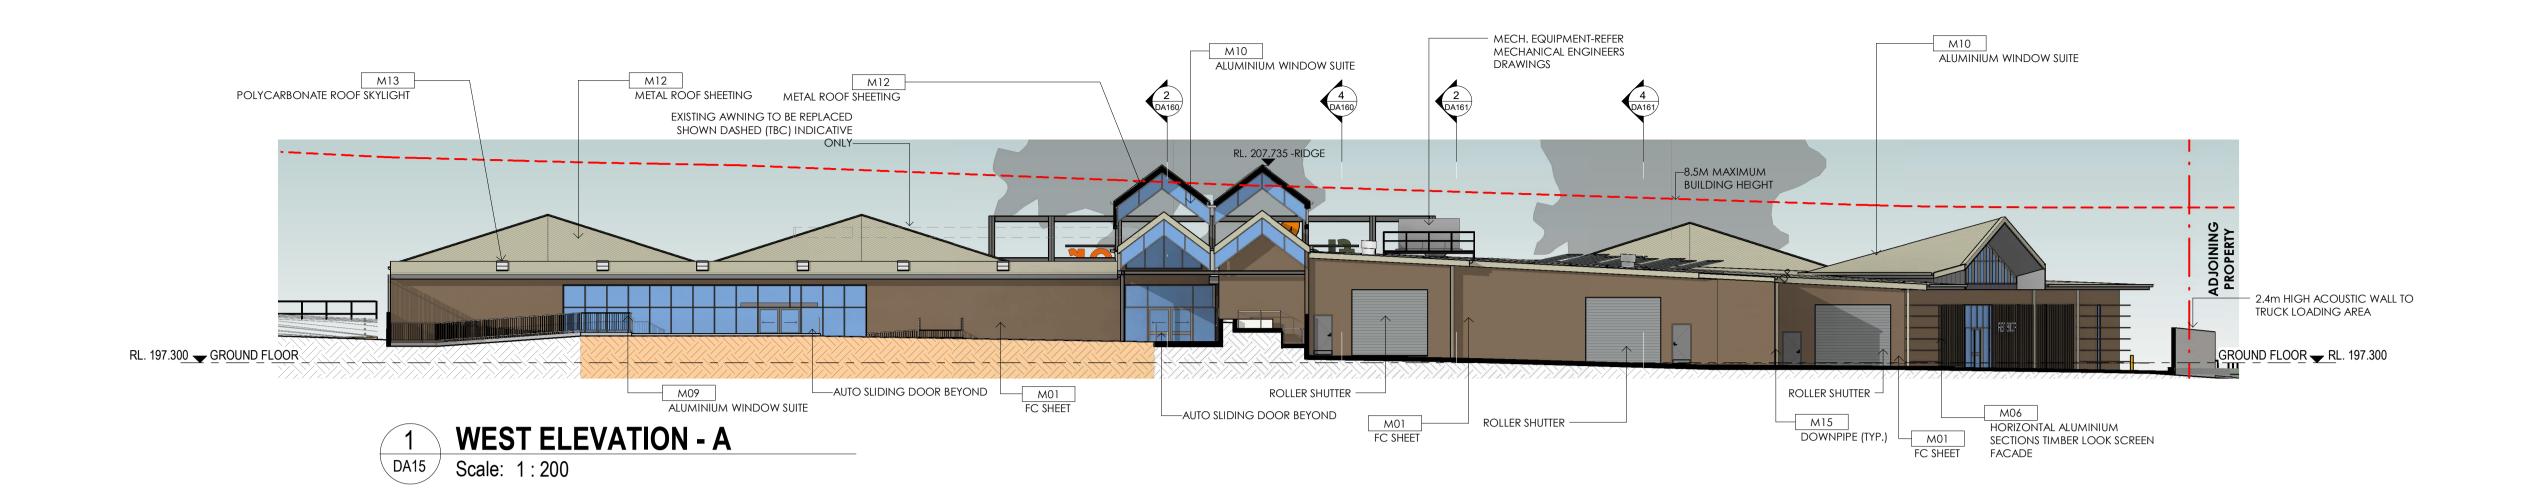

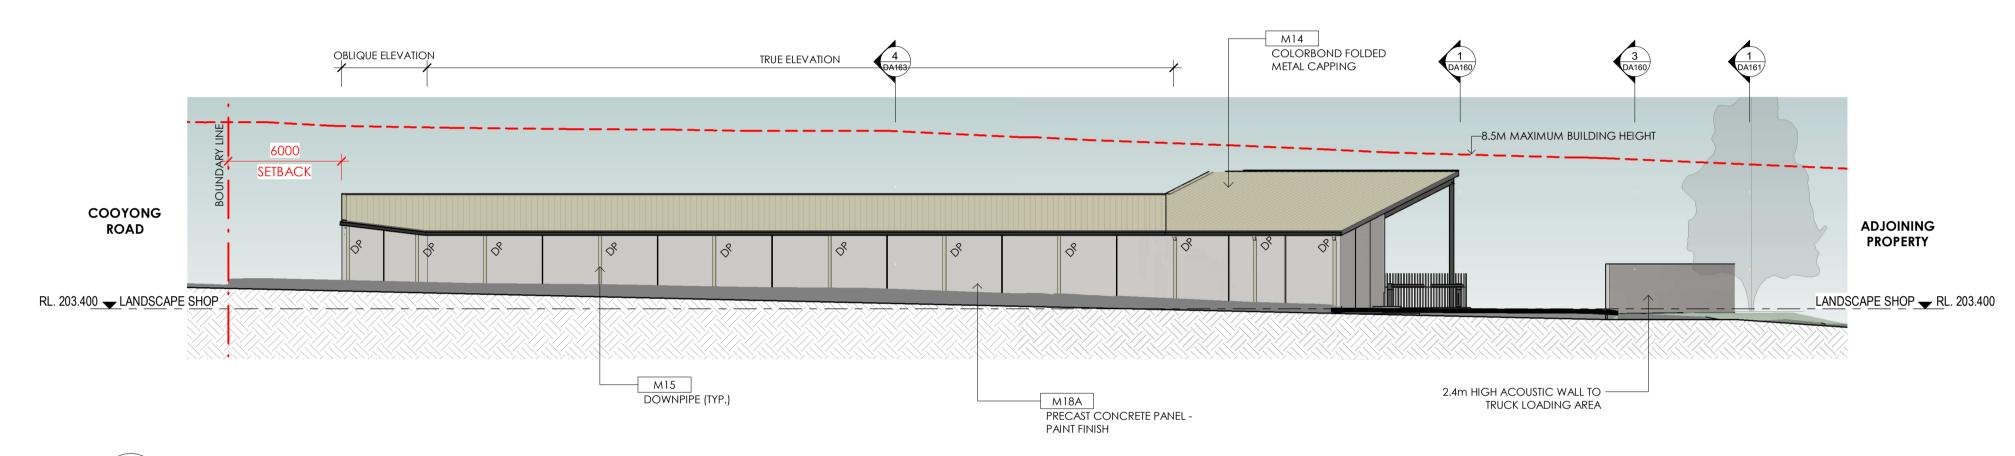

THIS PLAN IS TO BE READ IN **CONJUNCTION WITH** THE CONDITIONS OF DEVELOPMENT CONSENT DA2023/1224

WEST ELEVATION- LANDSCAPE SHOP Scale: 1:200

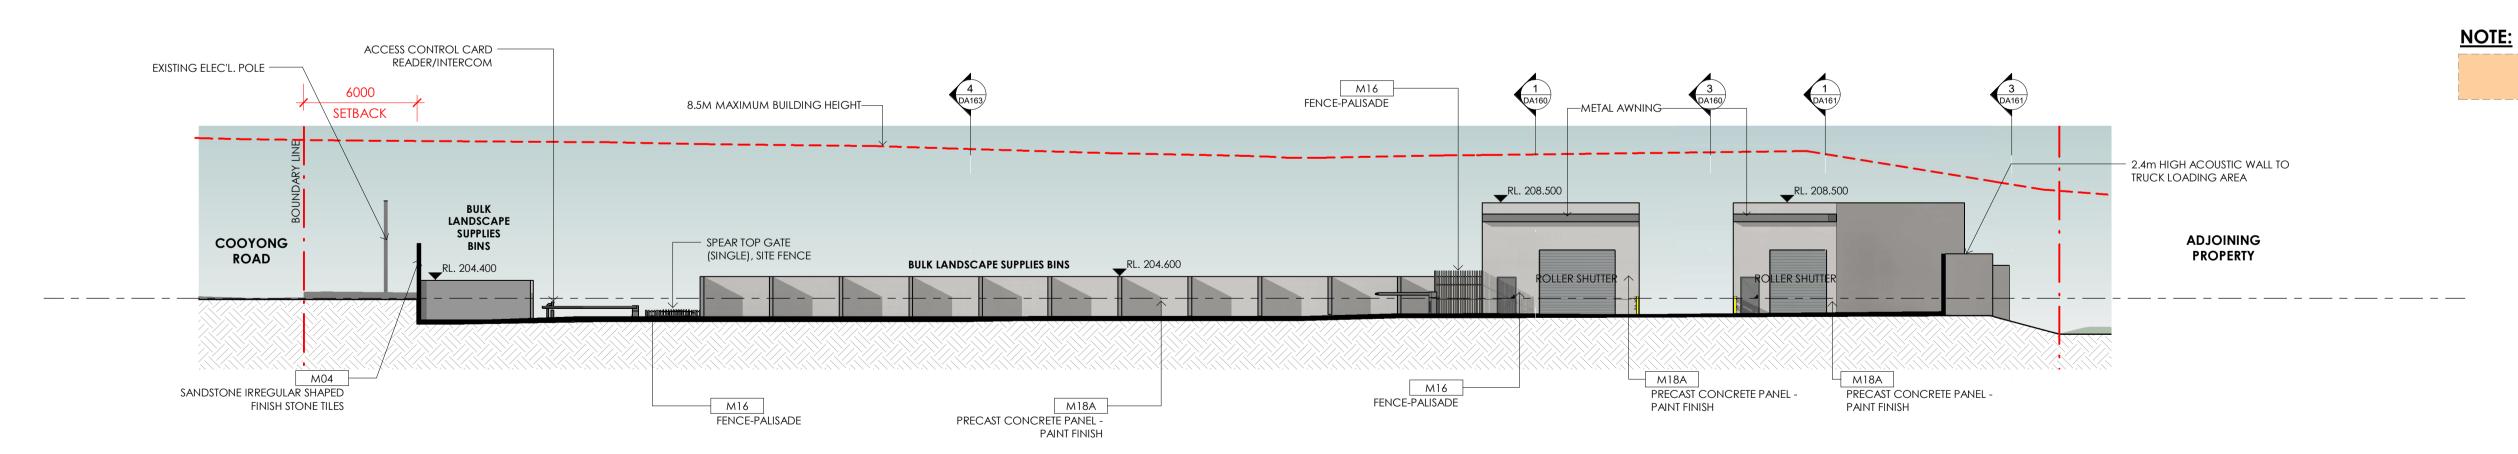

WEST ELEVATION - B Scale: 1:200




EXISTING GARDEN CENTRE,


OPEN NURSERY AREA,


(SHADED IN LIGHT ORANGE COLOR).


CARPARK & DRIVEWAYS

SCALE 20 1:200 @ A1

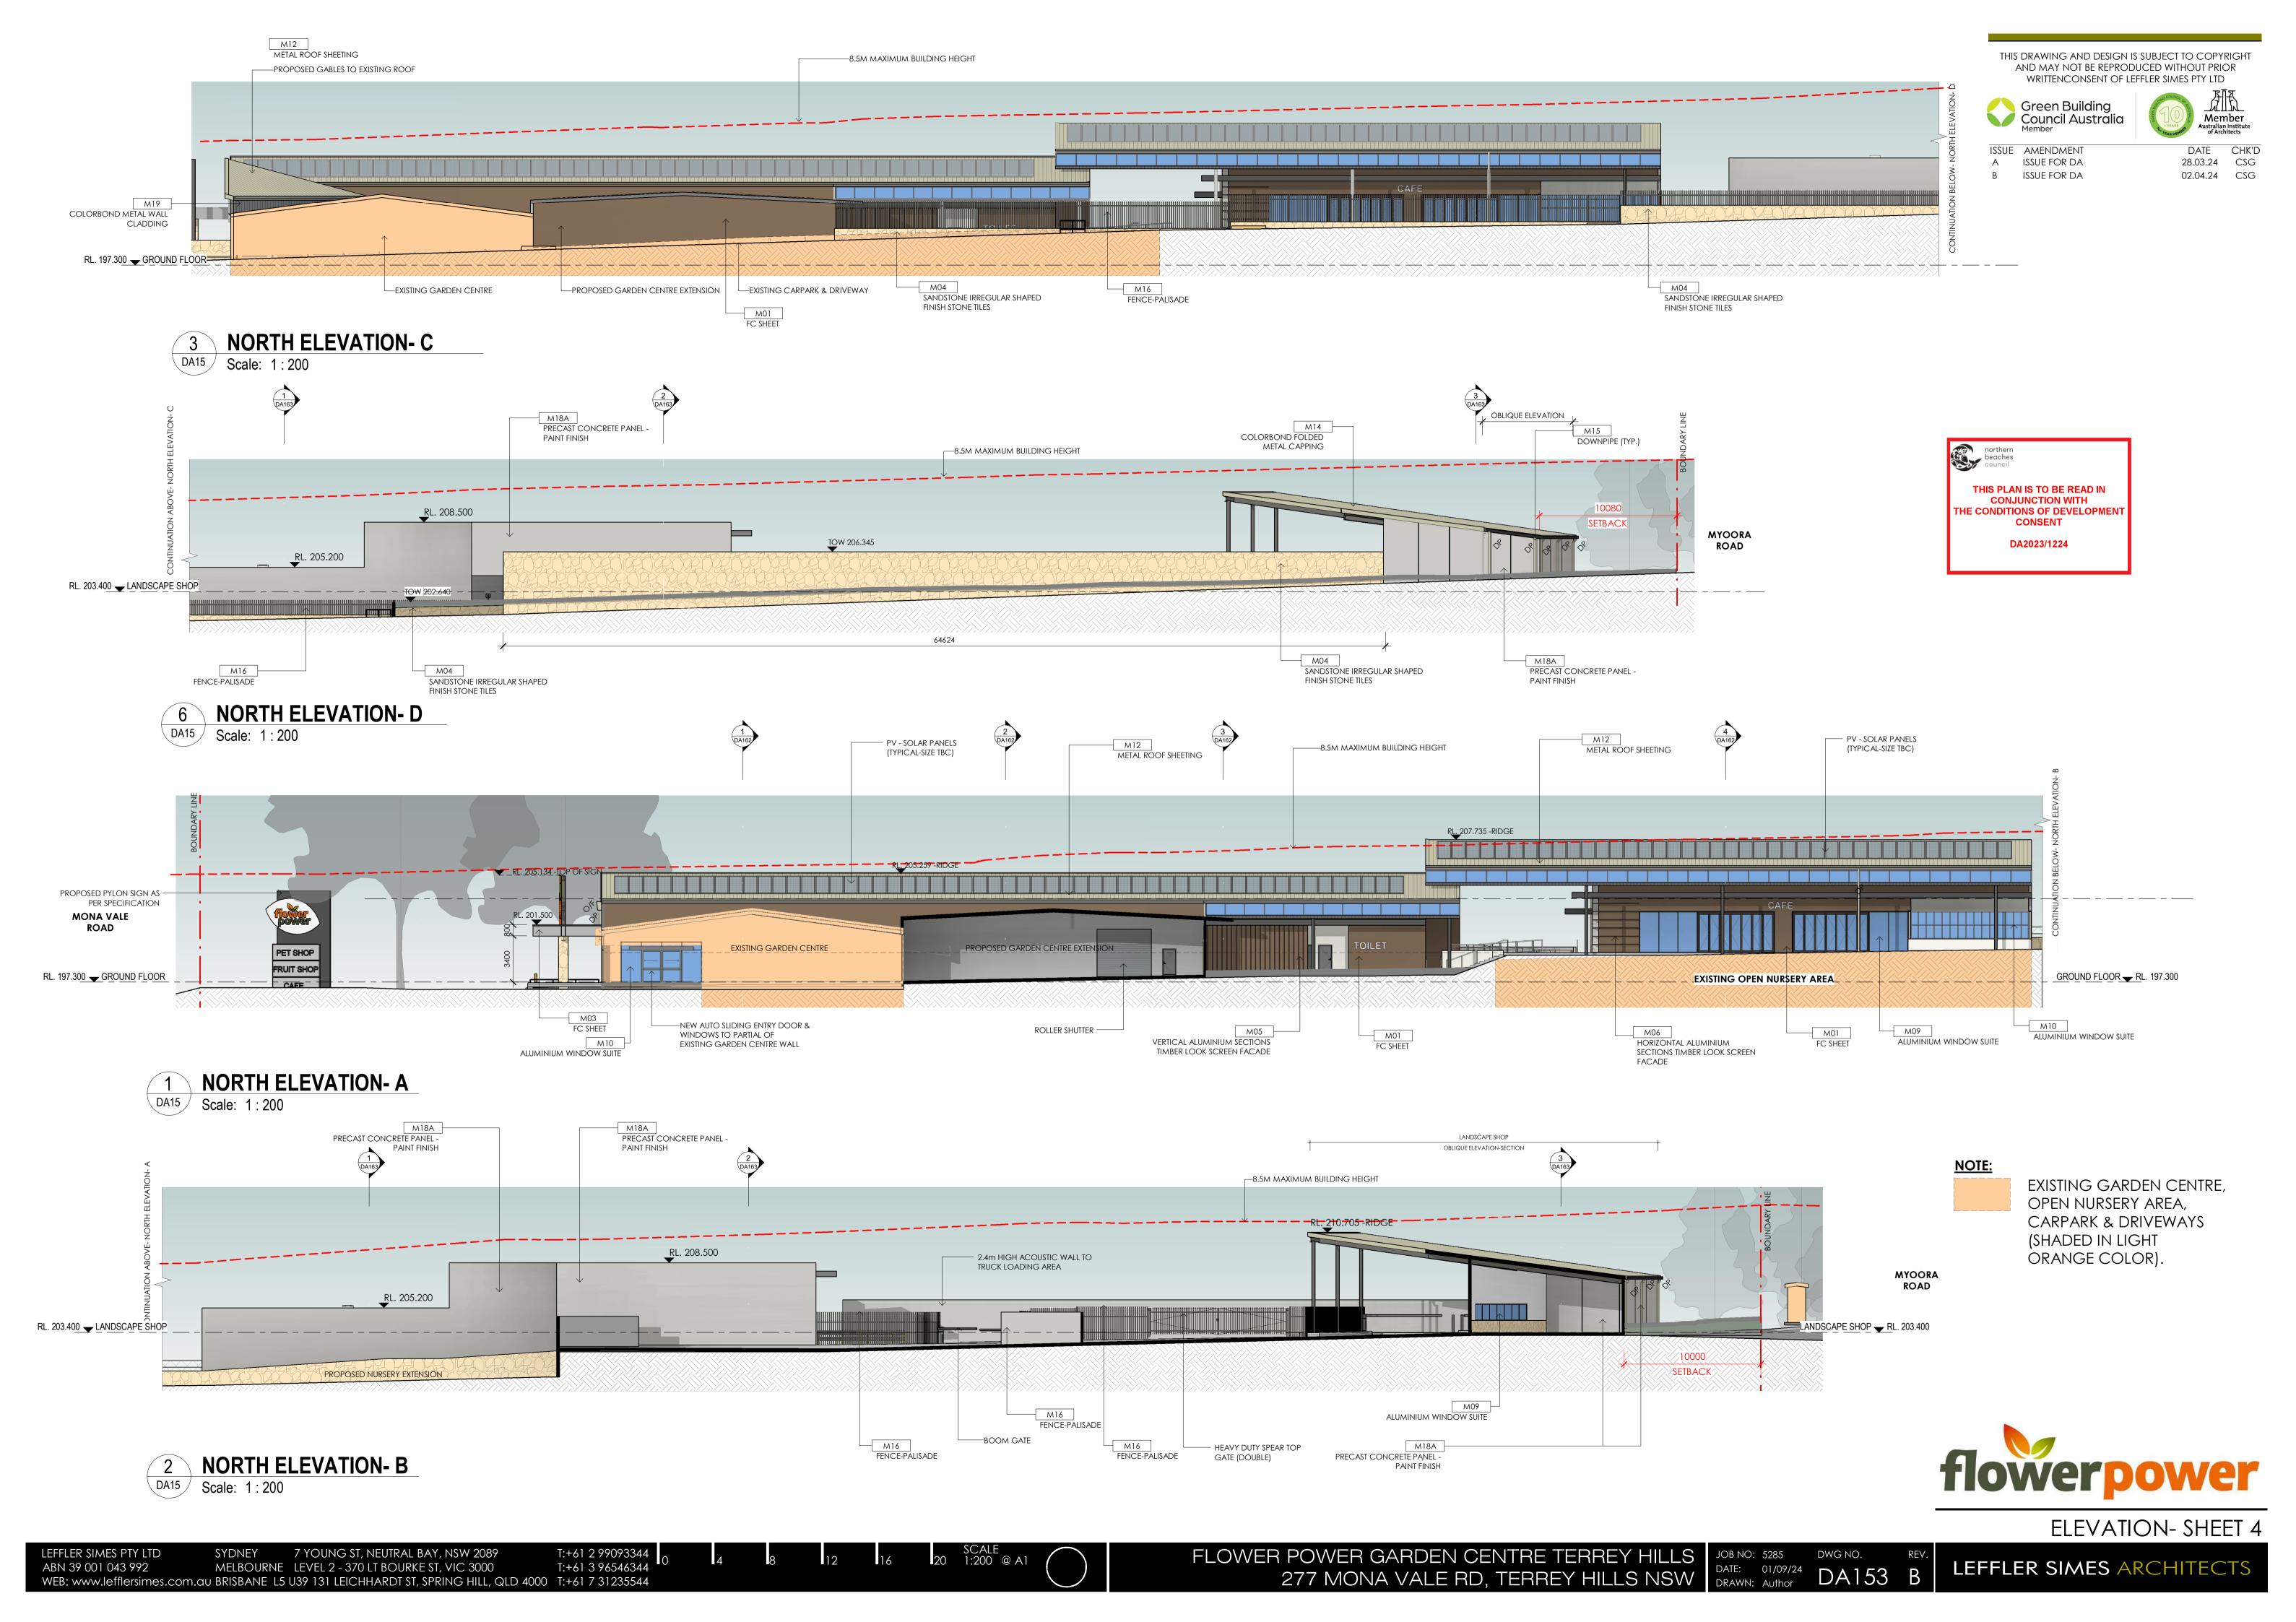

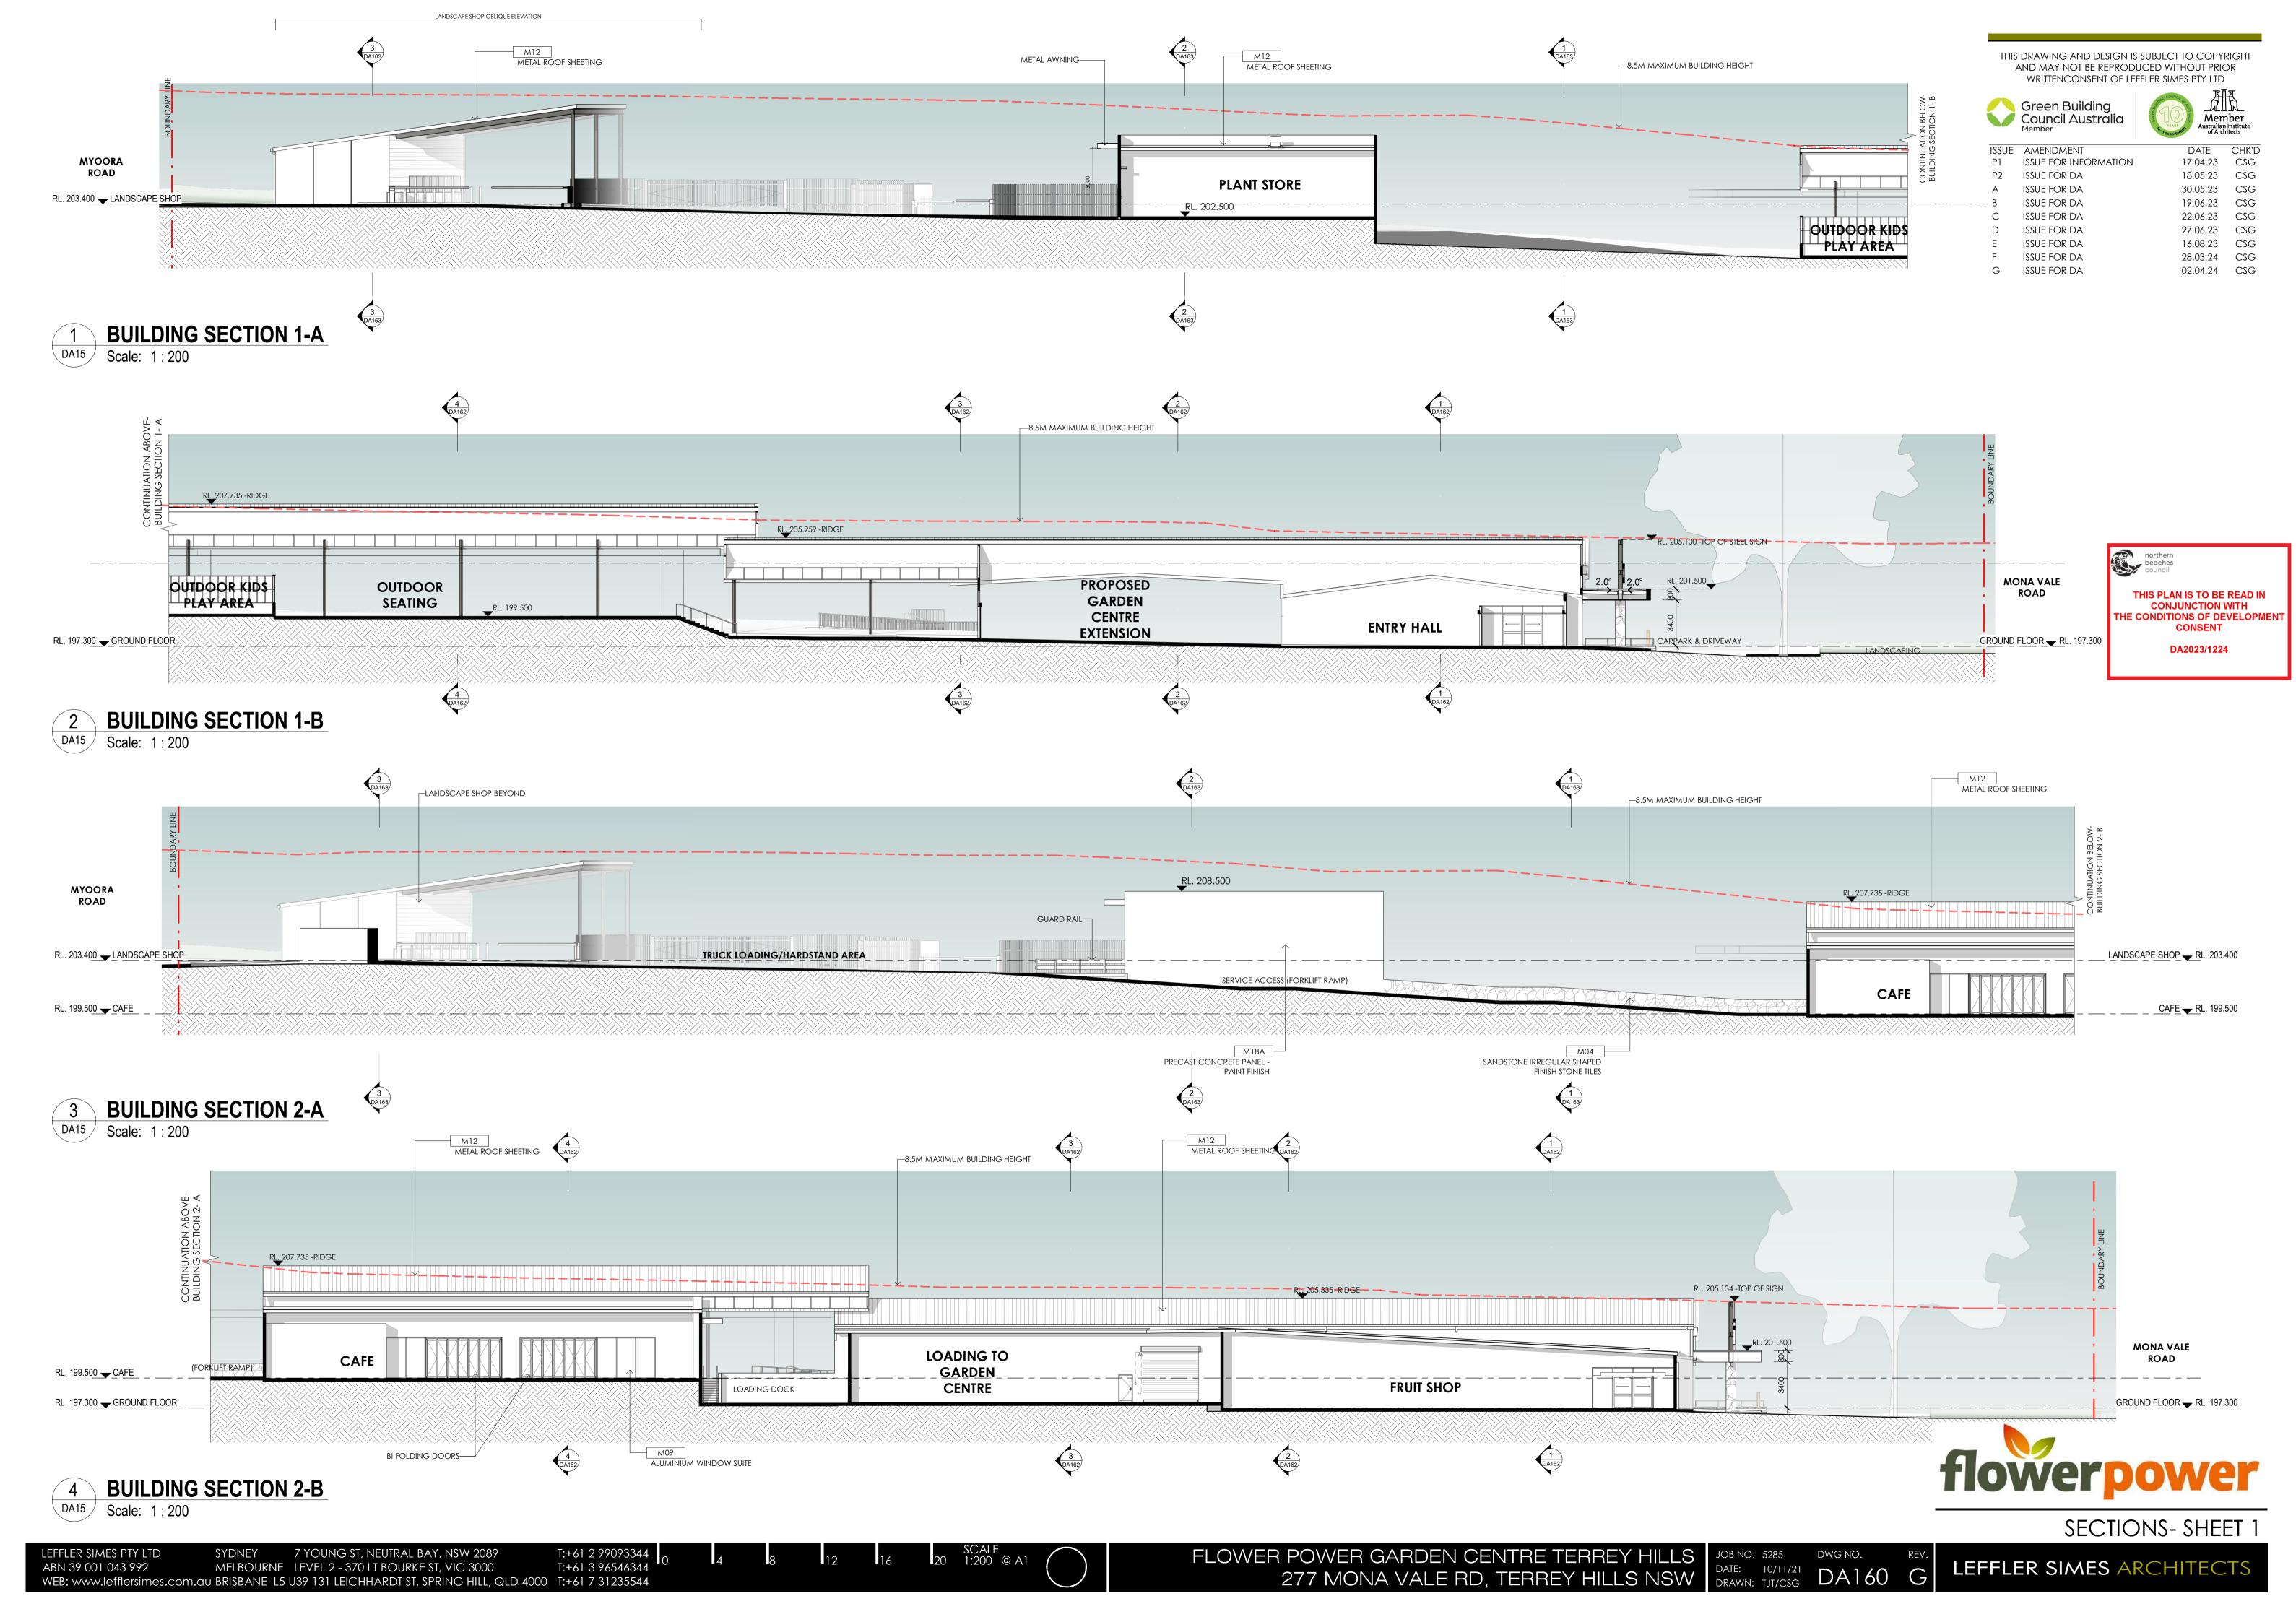

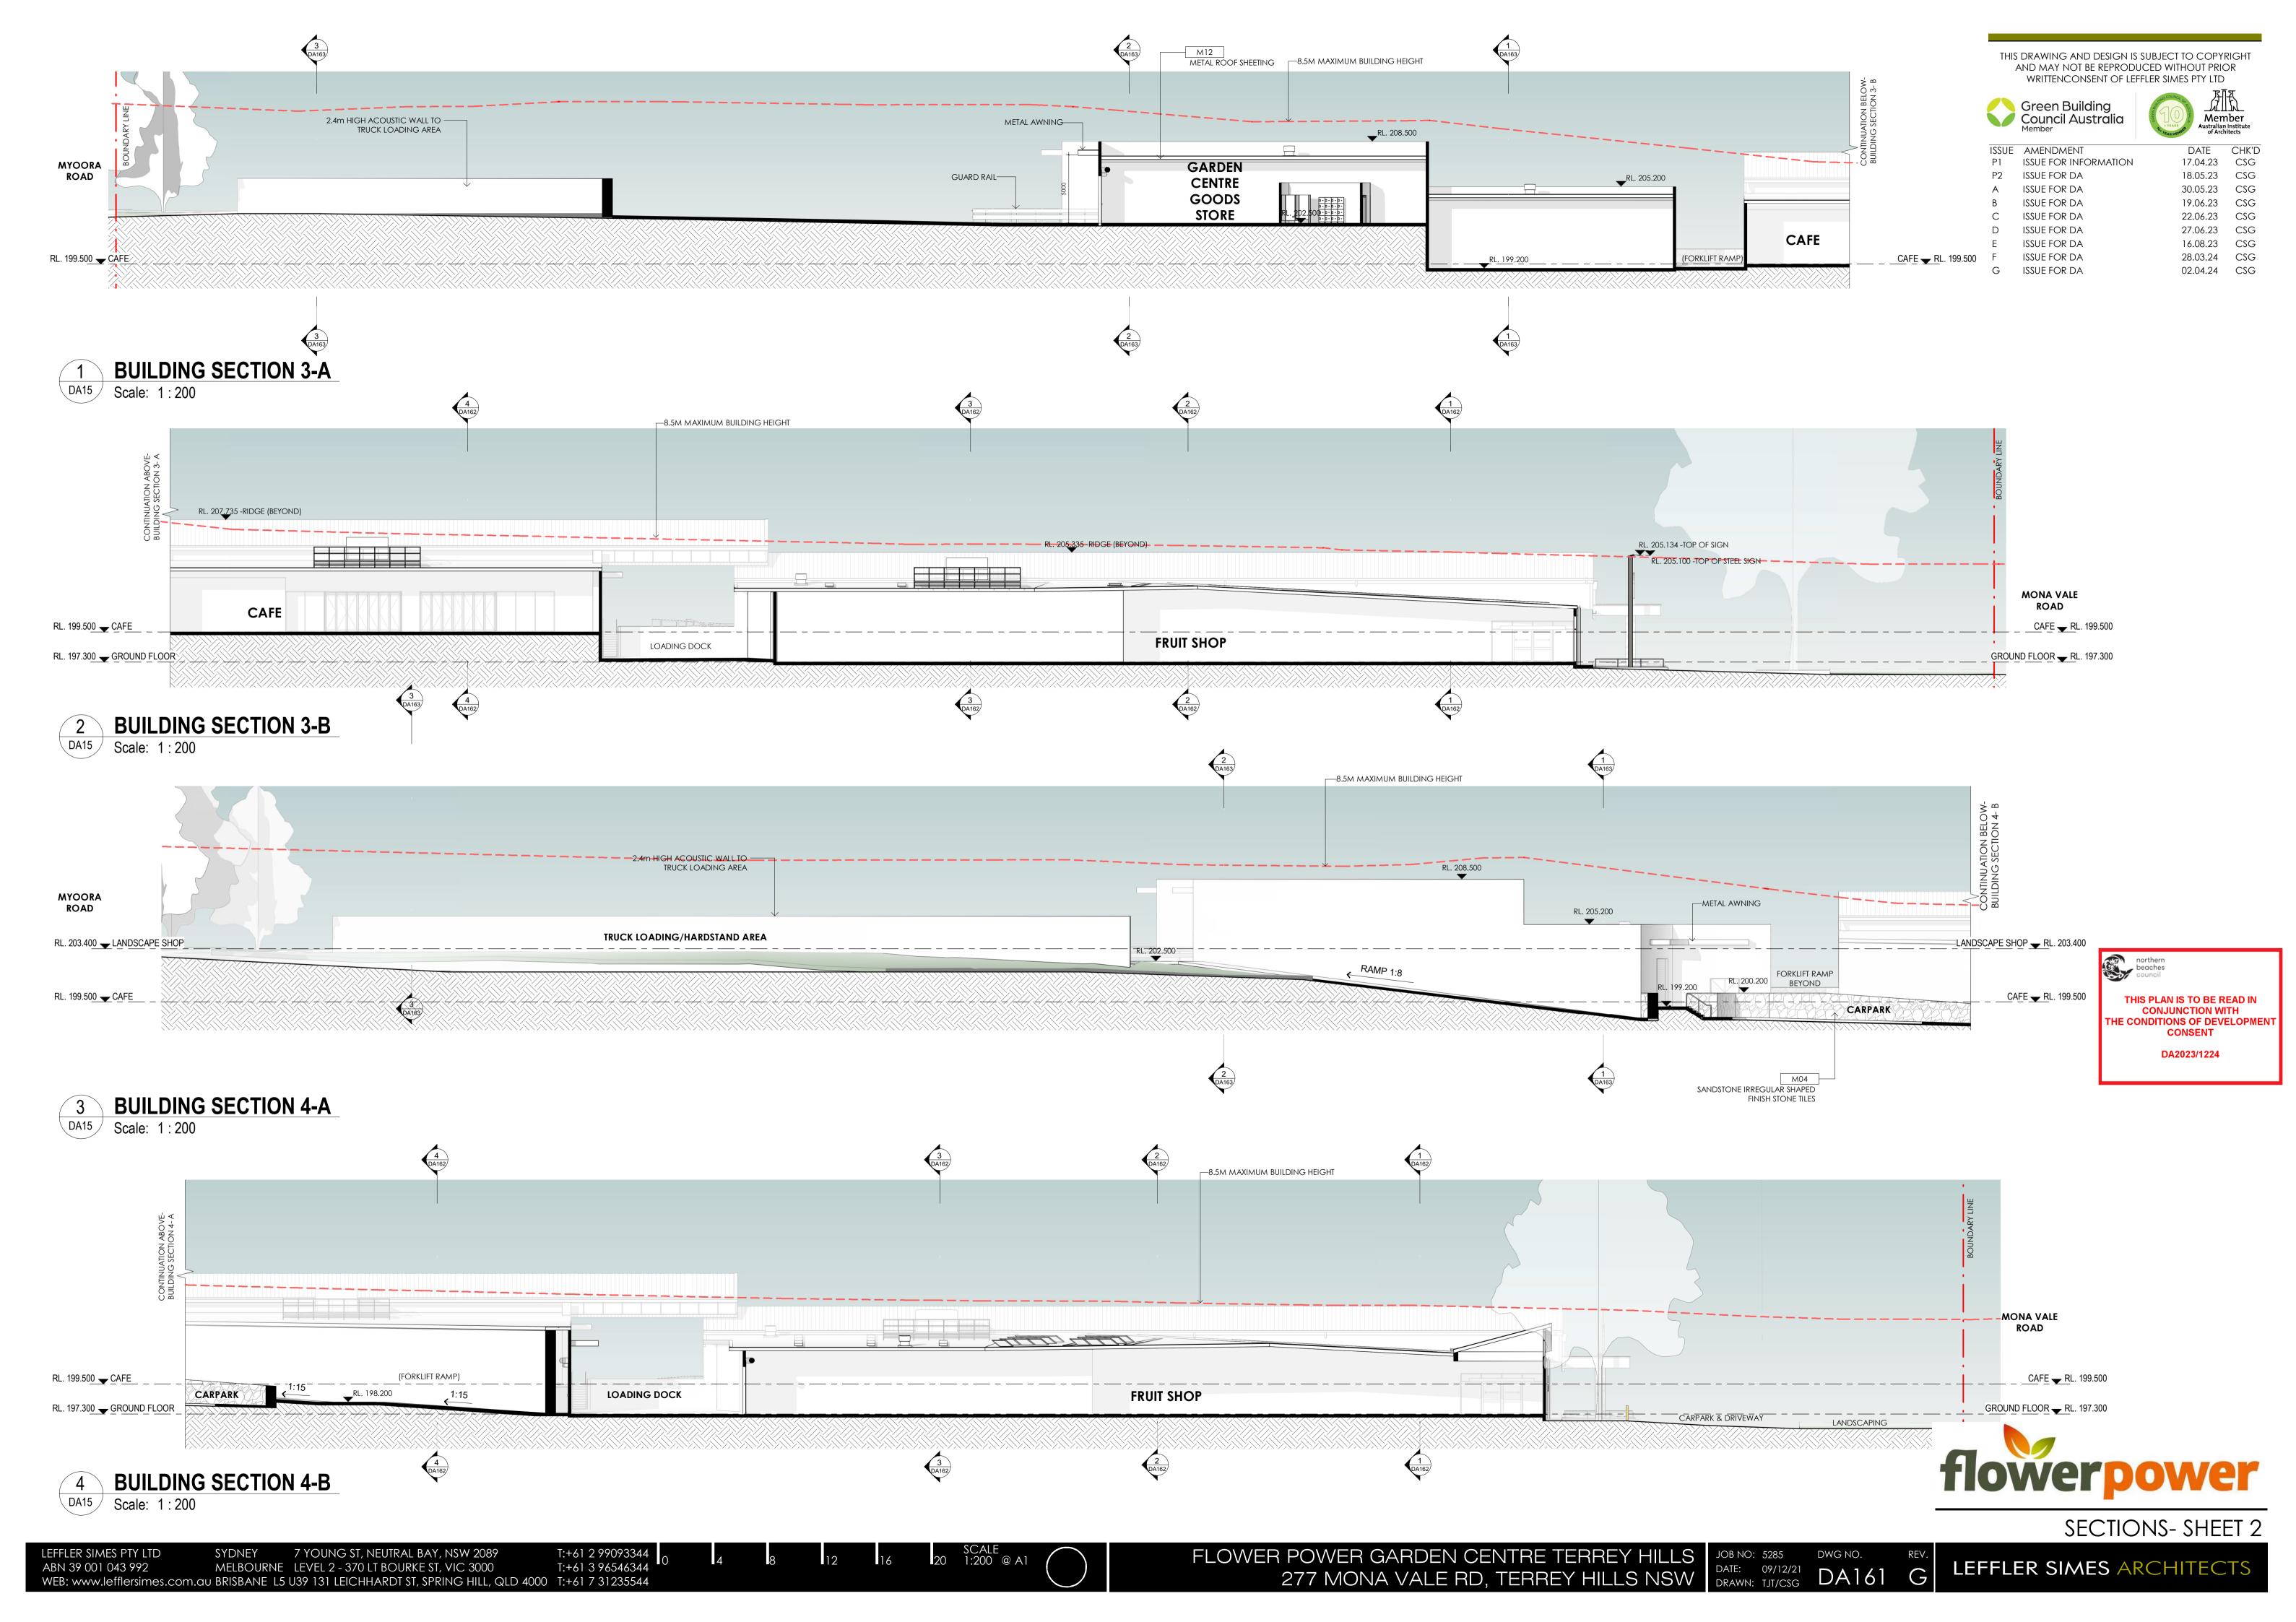

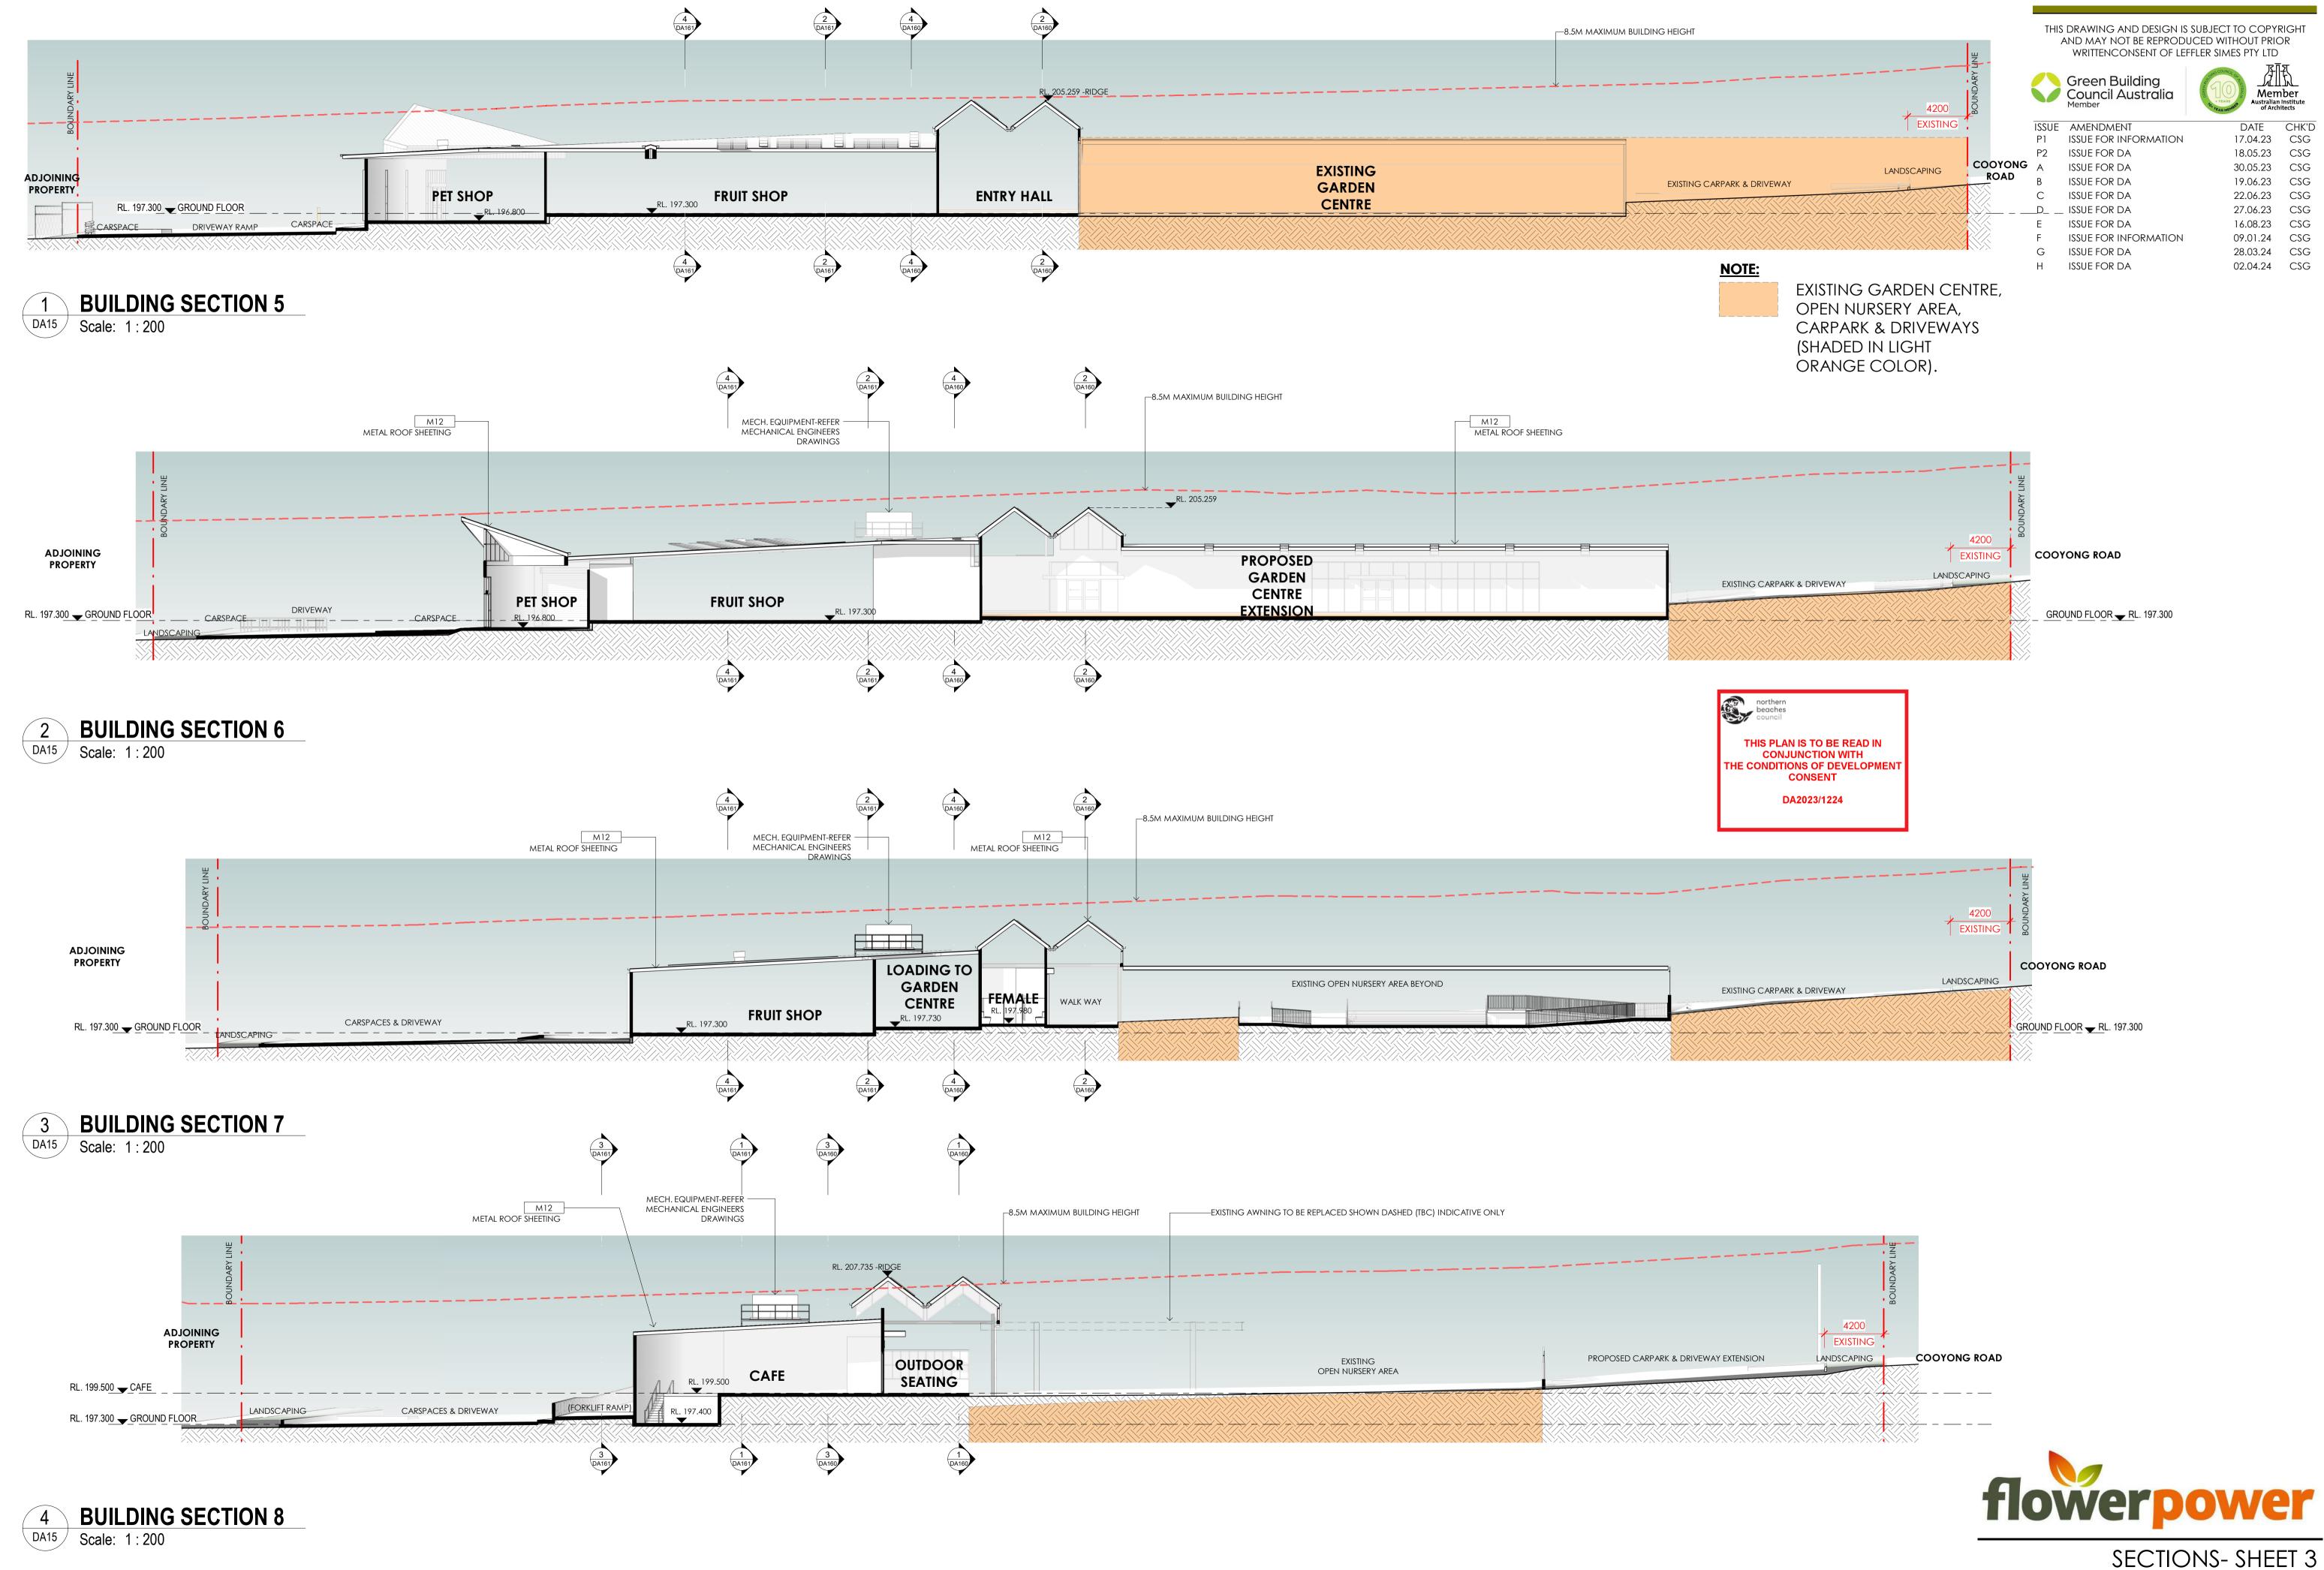

EFFLER SIMES PTY LTD

7 YOUNG ST, NEUTRAL BAY, NSW 2089 WEB: www.lefflersimes.com.au BRISBANE L5 U39 131 LEICHHARDT ST, SPRING HILL, QLD 4000 T:+61 7 31235544

SCALE 20 1:200 @ A1


FLOWER POWER GARDEN CENTRE TERREY HILLS 277 MONA VALE RD, TERREY HILLS NSW








ISSUE AMENDMENT DATE CHK'D 17.04.23 CSG P1 ISSUE FOR INFORMATION 18.05.23 CSG P2 ISSUE FOR DA 30.05.23 CSG ISSUE FOR DA ISSUE FOR DA 19.06.23 CSG 22.06.23 CSG ISSUE FOR DA 27.06.23 CSG ISSUE FOR DA 16.08.23 CSG ISSUE FOR DA ISSUE FOR DA 28.03.24 CSG 02.04.24 CSG G ISSUE FOR DA

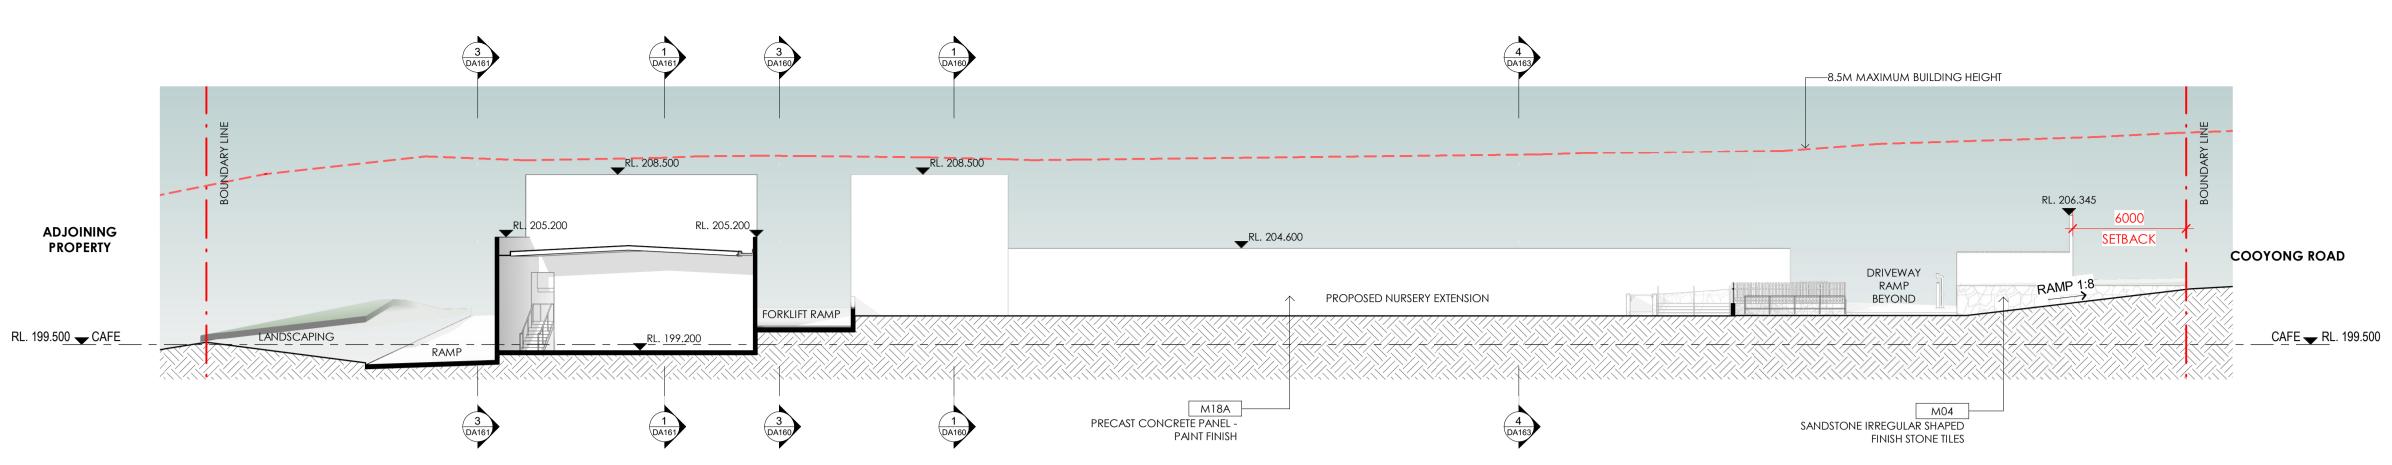



BUILDING SECTION 9

Scale: 1:200

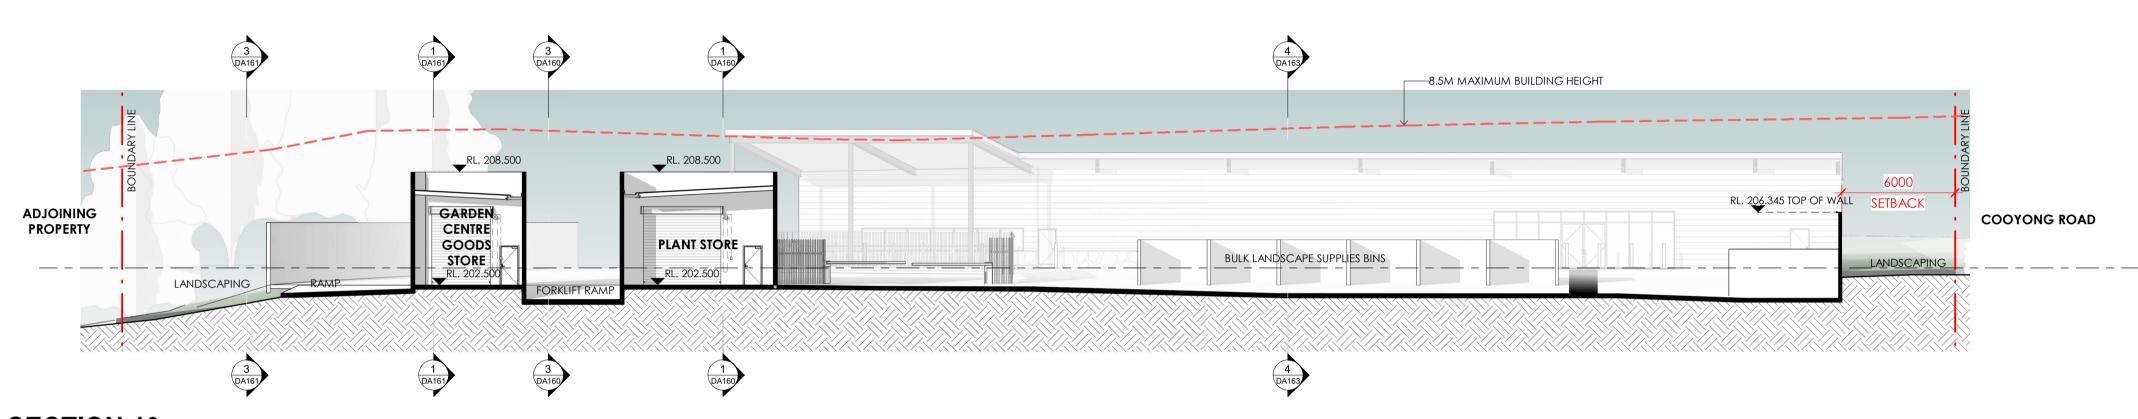

BUILDING SECTION 10 DA15 Scale: 1:200

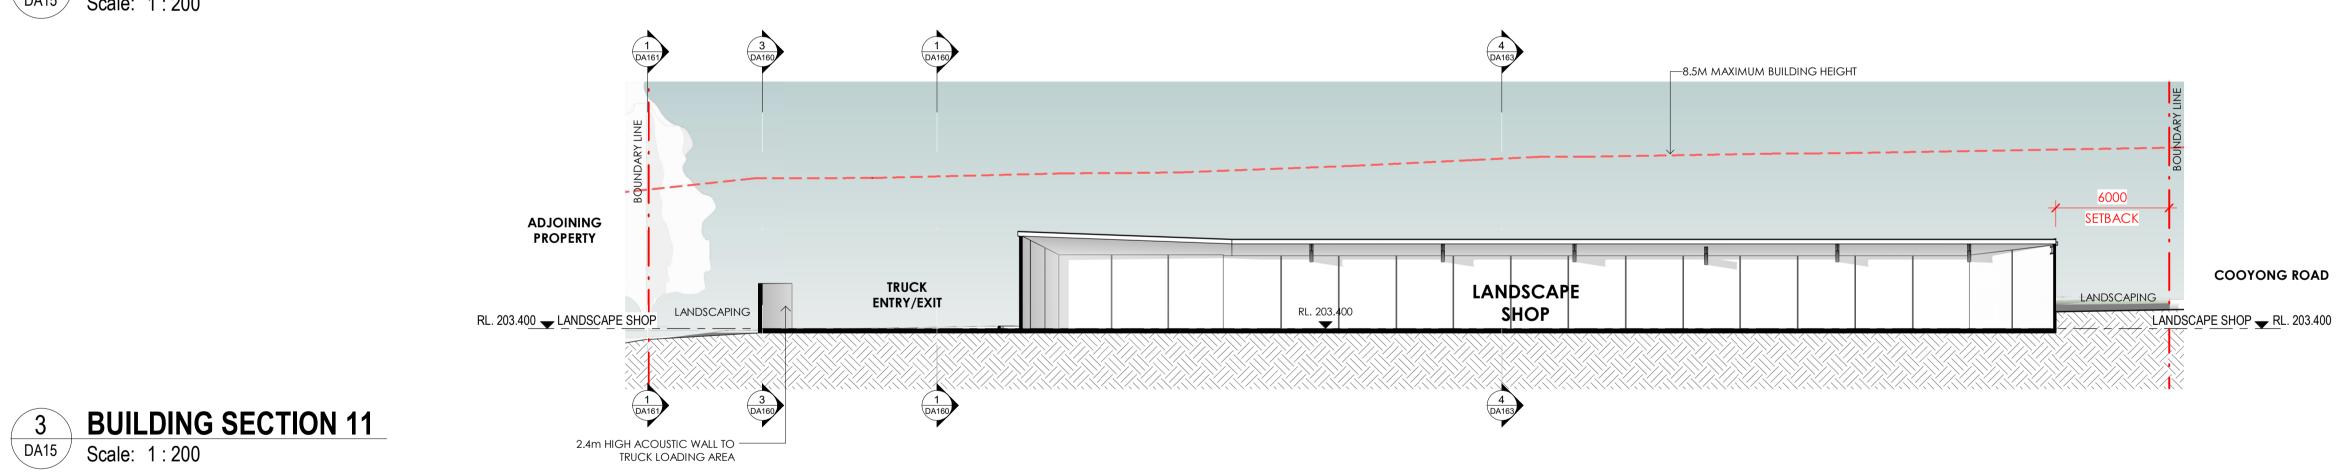

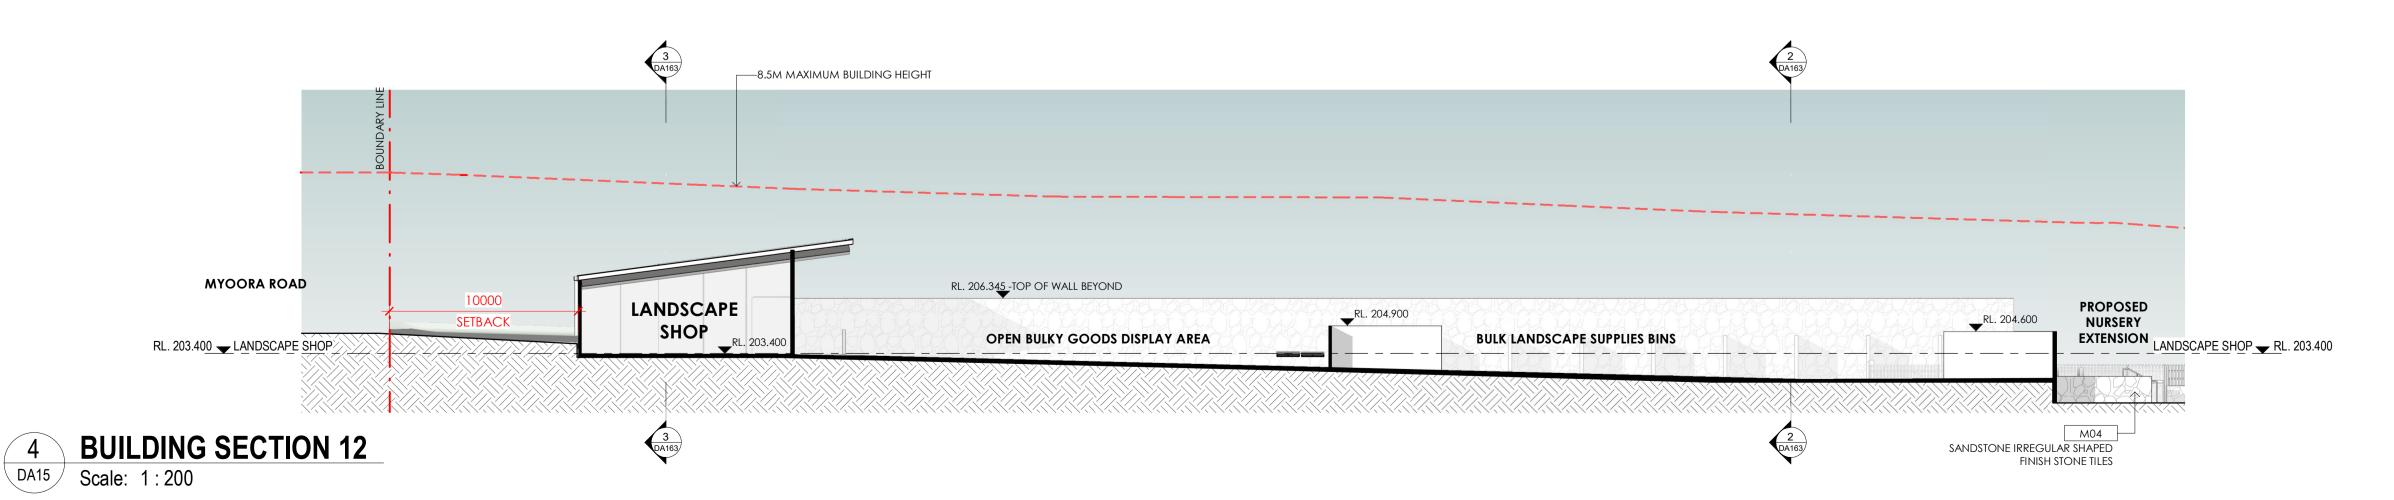


SCALE 20 1:200 @ A1



THIS PLAN IS TO BE READ IN CONJUNCTION WITH THE CONDITIONS OF DEVELOPMENT

DA2023/1224

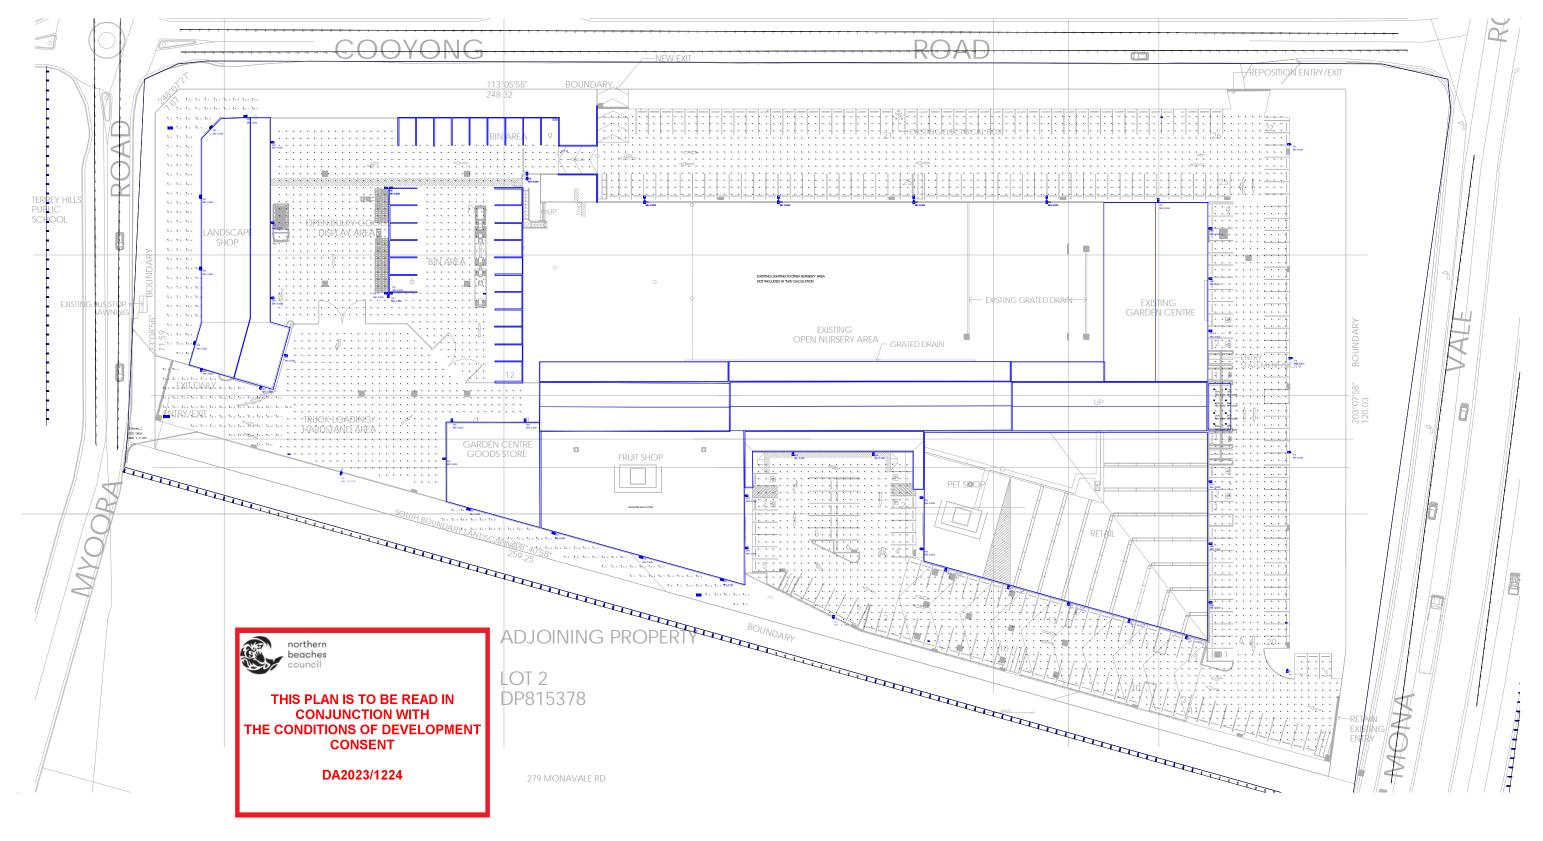

DESIGN NOTES:

- 1.THIS DESIGN SCHEME WAS PRODUCED ON ARCH BACKGROUND DA15-P4 SITE PLAN PRODUCED BY LEFFLER SIMES ARCHITECTS.
- 2.THIS DESIGN SATISFY THE AVERAGE HORIZONTAL ILLUMINANCE AS REQUIRED FOR AUSTRALINA STANDARDS. *AS1158.3.1:2020 PC3 CARPARKS & CIRCULATION 14LUX *AS1680.5:2012 LOADING & UNLOADING 40LUX
- 3.A MAINTENANCE FACTORS HAVE BEEN APPLIED THROUGHOUT THE DESIGN IN ACCORDANCE WITH AS 1158.3.1. A MAINTENANCE PLAN SHALL BE ADOPTED TO COMPLY WITH THESE FACTORS.
- 4.OBTRUSIVE LIGHT ANALYSIS HAS BEEN CONDUCTED FOR THIS DESIGN IN ACCORDANCE WITH AS4282-2019.
- 5.THIS DESIGN IS BASED ON THE INFORMATION PROVIDED BY THE CLIENT.

6.LIGHT FITTING SIMULATION AND CALCULATION RESULTS ARE BASED ON IES FILES PROVIDED BY THE LIGHTING MANUFACTURER.

| Luminaire | Schedul | e | | | | |
|-----------|---------|-----------------|-------------------------------|-----|-------|--------|
| Symbol | Qty | Label | Description | Tag | LLF | Total |
| | | | | | | Lamp |
| | | | | | | Lumens |
| • | 8 | M20C21N84-550mA | SALC MILANO DOWNLIGHT 21W REC | D1A | 0.850 | N.A. |
| | 1 | HZ2-180-4B | DNS NIKKON ZEALII 180W T4 | P6 | 0.850 | 23270 |
| | 18 | HZ2-150-4B | DNS NIKKON ZEALII 150W T4 | P5 | 0.850 | 19370 |
| | 25 | HZ2-90-4B | DNS NIKKON ZEALII 90W T4 | W4 | 0.850 | 11570 |
| -40 | 2 | HZ2-120-4B | DNS NIKKON ZEALII 120W T4 | P4 | 0.850 | 15470 |
| -[| 2 | HZ2-120-3B | DNS NIKKON ZEALII 120W T3 | P3 | 0.850 | 17040 |
| 0 | 9 | DU30 T2M | DNS NIKKON DUVAR 30W T2 WALL | W2 | 0.800 | 4238.4 |
| | | | LIGHT | | | |

| THIS DESIGN IS FOR INFORMATION ONLY, NOT FOR CONSTRUCTION | REV | <u>DATE</u> 06/12/2021 | DESCRIPTION PRELIMINARY | BY EC | r C-LEVEI |
|---|-----|---------------------------|--------------------------|----------|---|
| CONTRACTOR TO VERIFY ALL DIMENSIONS ON SITE BEFORE COMMENCING ANY WORK OR MAKING ANY SHOP DRAWING THE INFORMATION ON THIS DRAWING REMAINS THE PROPERTY C-LEVEL PTY LTD | P2 | 29/05/2023 | PRELIMINARY - NEW LAYOUT | CF | DESIGN & ENGINEERIN C-LEVEL PTY LTD SUITE 4 / 852-854 OLD PRINCES HWY. |
| | | | | | SUTHERLAND NSW 2232 P: 02 9545 2348 E: admin@c-level.com.au W: c-level.com.au |

PROJECT:

ADDRESS

АЗ

FLOWER POWER TERRY HILLS

1/2

277 MONA VALE RD, TERRY HILLS NSW

PROJECT NO

CLE-2305

DWG TITLE

DWG NO

LUX-001

EXTERNAL LIGHTING

REV

P2

| Luminaire | Schedule | | | | | |
|-----------|----------|-----------------|-------------------------------|-----|-------|--------|
| Symbol | Qty | Label | Description | Tag | LLF | Total |
| | | | | | | Lamp |
| | | | | | | Lumens |
| • | 8 | M20C21N84-550mA | SALC MILANO DOWNLIGHT 21W REC | D1A | 0.850 | N.A. |
| | 1 | HZ2-180-4B | DNS NIKKON ZEALII 180W T4 | P6 | 0.850 | 23270 |
| -[| 18 | HZ2-150-4B | DNS NIKKON ZEALII 150W T4 | P5 | 0.850 | 19370 |
| | 25 | HZ2-90-4B | DNS NIKKON ZEALII 90W T4 | W4 | 0.850 | 11570 |
| | 2 | HZ2-120-4B | DNS NIKKON ZEALII 120W T4 | P4 | 0.850 | 15470 |
| | 2 | HZ2-120-3B | DNS NIKKON ZEALII 120W T3 | P3 | 0.850 | 17040 |
| II. | 9 | DU30 T2M | DNS NIKKON DUVAR 30W T2 WALL | W2 | 0.800 | 4238.4 |
| | | | LIGHT | | | |

| UWLR Area Summary | | |
|-------------------|-------|-------------|
| Label | UWLR | Description |
| LPDArea_1 | 0.001 | SITE UWLR |

| Calculation Summary | | | | | | | |
|---------------------------------|-----------------|---------|-------|-------|-------|---------|---------|
| Label | CalcType | Units | Avg | Max | Min | Min/Avg | Min/Max |
| Bulky Goods & Bin | Illuminance | Lux | 40.29 | 99.9 | 10.5 | N.A. | N.A. |
| Carpark East | Illuminance | Lux | 49.83 | 282.8 | 4.2 | N.A. | N.A. |
| Carpark North | Illuminance | Lux | 25.40 | 79.1 | 7.2 | N.A. | N.A. |
| Carpark South | Illuminance | Lux | 34.56 | 106.2 | 4.6 | N.A. | N.A. |
| North West Sec Lighting | Illuminance | Lux | 17.66 | 100.3 | 0.4 | N.A. | N.A. |
| ObtrusiveLight_1 NORTH_Cd_Seg1 | Obtrusive - Cd | N.A. | N.A. | 3281 | 202 | N.A. | N.A. |
| ObtrusiveLight_1 NORTH_III_Seg1 | Obtrusive - III | Lux | N.A. | 2 | 0 | N.A. | N.A. |
| ObtrusiveLight_2 WEST_Cd_Seg1 | Obtrusive - Cd | N.A. | N.A. | 577 | 4 | N.A. | N.A. |
| ObtrusiveLight_2 WEST_III_Seg1 | Obtrusive - III | Lux | N.A. | 0 | 0 | N.A. | N.A. |
| ObtrusiveLight_3 SOUTH_Cd_Seg1 | Obtrusive - Cd | N.A. | N.A. | 4499 | 20 | N.A. | N.A. |
| ObtrusiveLight_3 SOUTH_III_Seg1 | Obtrusive - III | Lux | N.A. | 7 | 1 | N.A. | N.A. |
| ObtrusiveLight_4 EAST_Cd_Seg1 | Obtrusive - Cd | N.A. | N.A. | 442 | 79 | N.A. | N.A. |
| ObtrusiveLight_4 EAST_III_Seg1 | Obtrusive - III | Lux | N.A. | 1 | 0 | N.A. | N.A. |
| ObtrusiveLight_TI_1 | Obtrusive - TI | % | N.A. | 1 | 0 | N.A. | N.A. |
| ObtrusiveLight_TI_1_Lv | Obtrusive - Lv | Cd/Sq.m | N.A. | 0.009 | 0.000 | N.A. | N.A. |
| ObtrusiveLight_TI_2 | Obtrusive - TI | % | N.A. | 0 | 0 | N.A. | N.A. |
| ObtrusiveLight_TI_2_Lv | Obtrusive - Lv | Cd/Sq.m | N.A. | 0.001 | 0.000 | N.A. | N.A. |
| ObtrusiveLight_TI_3 | Obtrusive - TI | % | N.A. | 1 | 0 | N.A. | N.A. |
| ObtrusiveLight_TI_3_Lv | Obtrusive - Lv | Cd/Sq.m | N.A. | 0.018 | 0.000 | N.A. | N.A. |
| ObtrusiveLight_TI_4 | Obtrusive - TI | % | N.A. | 1 | 0 | N.A. | N.A. |
| ObtrusiveLight_TI_4_Lv | Obtrusive - Lv | Cd/Sq.m | N.A. | 0.015 | 0.000 | N.A. | N.A. |
| ObtrusiveLight_TI_5 | Obtrusive - TI | % | N.A. | 0 | 0 | N.A. | N.A. |
| ObtrusiveLight_TI_5_Lv | Obtrusive - Lv | Cd/Sq.m | N.A. | 0.001 | 0.000 | N.A. | N.A. |
| ObtrusiveLight_TI_6 | Obtrusive - TI | % | N.A. | 0 | 0 | N.A. | N.A. |
| ObtrusiveLight_TI_6_Lv | Obtrusive - Lv | Cd/Sq.m | N.A. | 0.002 | 0.000 | N.A. | N.A. |
| South Sec Lighting | Illuminance | Lux | 30.93 | 117.7 | 2.8 | N.A. | N.A. |
| Truck Entry Exit | Illuminance | Lux | 38.89 | 77.2 | 10.8 | N.A. | N.A. |
| Truck Loading | Illuminance | Lux | 40.10 | 75.8 | 18.6 | N.A. | N.A. |

Obtrusive Light - Compliance Report

AS/NZS 4282:2019, A3 - Medium District Brightness, Non-Curfew L1 Filename: flowerpower R2 30/05/2023 2:02:25 PM

Illuminance

Maximum Allowable Value: 10 Lux

Calculations Tested (4):

| Calculation Label | Results | Illum |
|---------------------------------|---------|-------|
| ObtrusiveLight 3 SOUTH III Seg1 | PASS | 7 |
| ObtrusiveLight 4 EAST III Seg1 | PASS | 1 |
| ObtrusiveLight 1 NORTH III Seg1 | PASS | 2 |
| ObtrusiveLight 2 WEST_III_Seg1 | PASS | 0 |

Luminous Intensity (Cd) At Vertical Planes

Maximum Allowable Value: 12500 Cd

Calculations Tested (4):

| | lest |
|--------------------------------|---------|
| Calculation Label | Results |
| ObtrusiveLight 3 SOUTH Cd Seg1 | PASS |
| ObtrusiveLight 4 EAST Cd Seg1 | PASS |
| ObtrusiveLight 1 NORTH Cd Seg1 | PASS |
| Obtrusivel ight 2 WEST Cd Seg1 | PASS |

Threshold Increment (TI)

Maximum Allowable Value: 20 %

Calculations Tested (6):

| | Adapt | ation Test |
|----------------------|-------|--------------|
| Calculation Label | Lumin | ance Results |
| ObtrusiveLight TI 5 | 1 | PASS |
| ObtrusiveLight TI 6 | 1 | PASS |
| ObtrusiveLight TI 3 | 1 | PASS |
| ObtrusiveLight TI 4 | 1 | PASS |
| ObtrusiveLight TI 1 | 1 | PASS |
| Obtrusive light TI 2 | 1 | PASS |

Calculated UWLR: 0.1 % Test Results:

DESIGN NOTES:



| EVEL | PROJECT FLOWI |
|-------------|-------------------|
| RINCES HWY, | ADDRESS 277 MC |
| | DADED |

| PROJECT: FLOWER | POWER TER | RRY HILLS | DWG TITLE EXTERNAL LIG | GHTING |
|--------------------|-------------------------|-----------------|---------------------------|--------|
| ADDRESS 277 MON | A VALE RD, ⁻ | TERRY HILLS NSW | | |
| PAPER | PAGES | PROJECT NO: | DWG NO | REV |
| A3 | 2/2 | CLE-2305 | LUX-001 | P2 |



THIS PLAN IS TO BE READ IN **CONJUNCTION WITH**

DA2023/1224



THE CONDITIONS OF DEVELOPMENT CONSENT



THIS DESIGN IS FOR INFORMATION ONLY, NOT FOR CONSTRUCTION.

P1 06/12/2021 PRELIMINARY

CONTRACTOR TO VERIFY ALL DIMENSIONS ON SITE
BEFORE COMMENCING ANY WORK OR MAKING ANY SHOP DRAWING.
THE INFORMATION ON THIS DRAWING REMAINS THE PROPERTY

C-LEVEL PTY LTD.


DESCRIPTION REV DATE

Upward Waste Light Ratio (UWLR) Maximum Allowable Value: 2.0 %

1. OBSTRUSIVE CALULATIONS PER AS4282:2019 CAT A3 MEDIUM DISTRICT BRIGHTNESS 2. OBSTRUSIVE CALCS TAKEN FROM 1.5M TO 6M. ROADWAY TI CALCS AT 1.5 WITH A WINDSIELD CUTOFF ANGLE OF 20DEG.

3. ASYMMETRIC OPTICS HAVE BEEN USED. COLOUR TEMPERATURE OF 4000K SHOULD BE SUPPLIED.



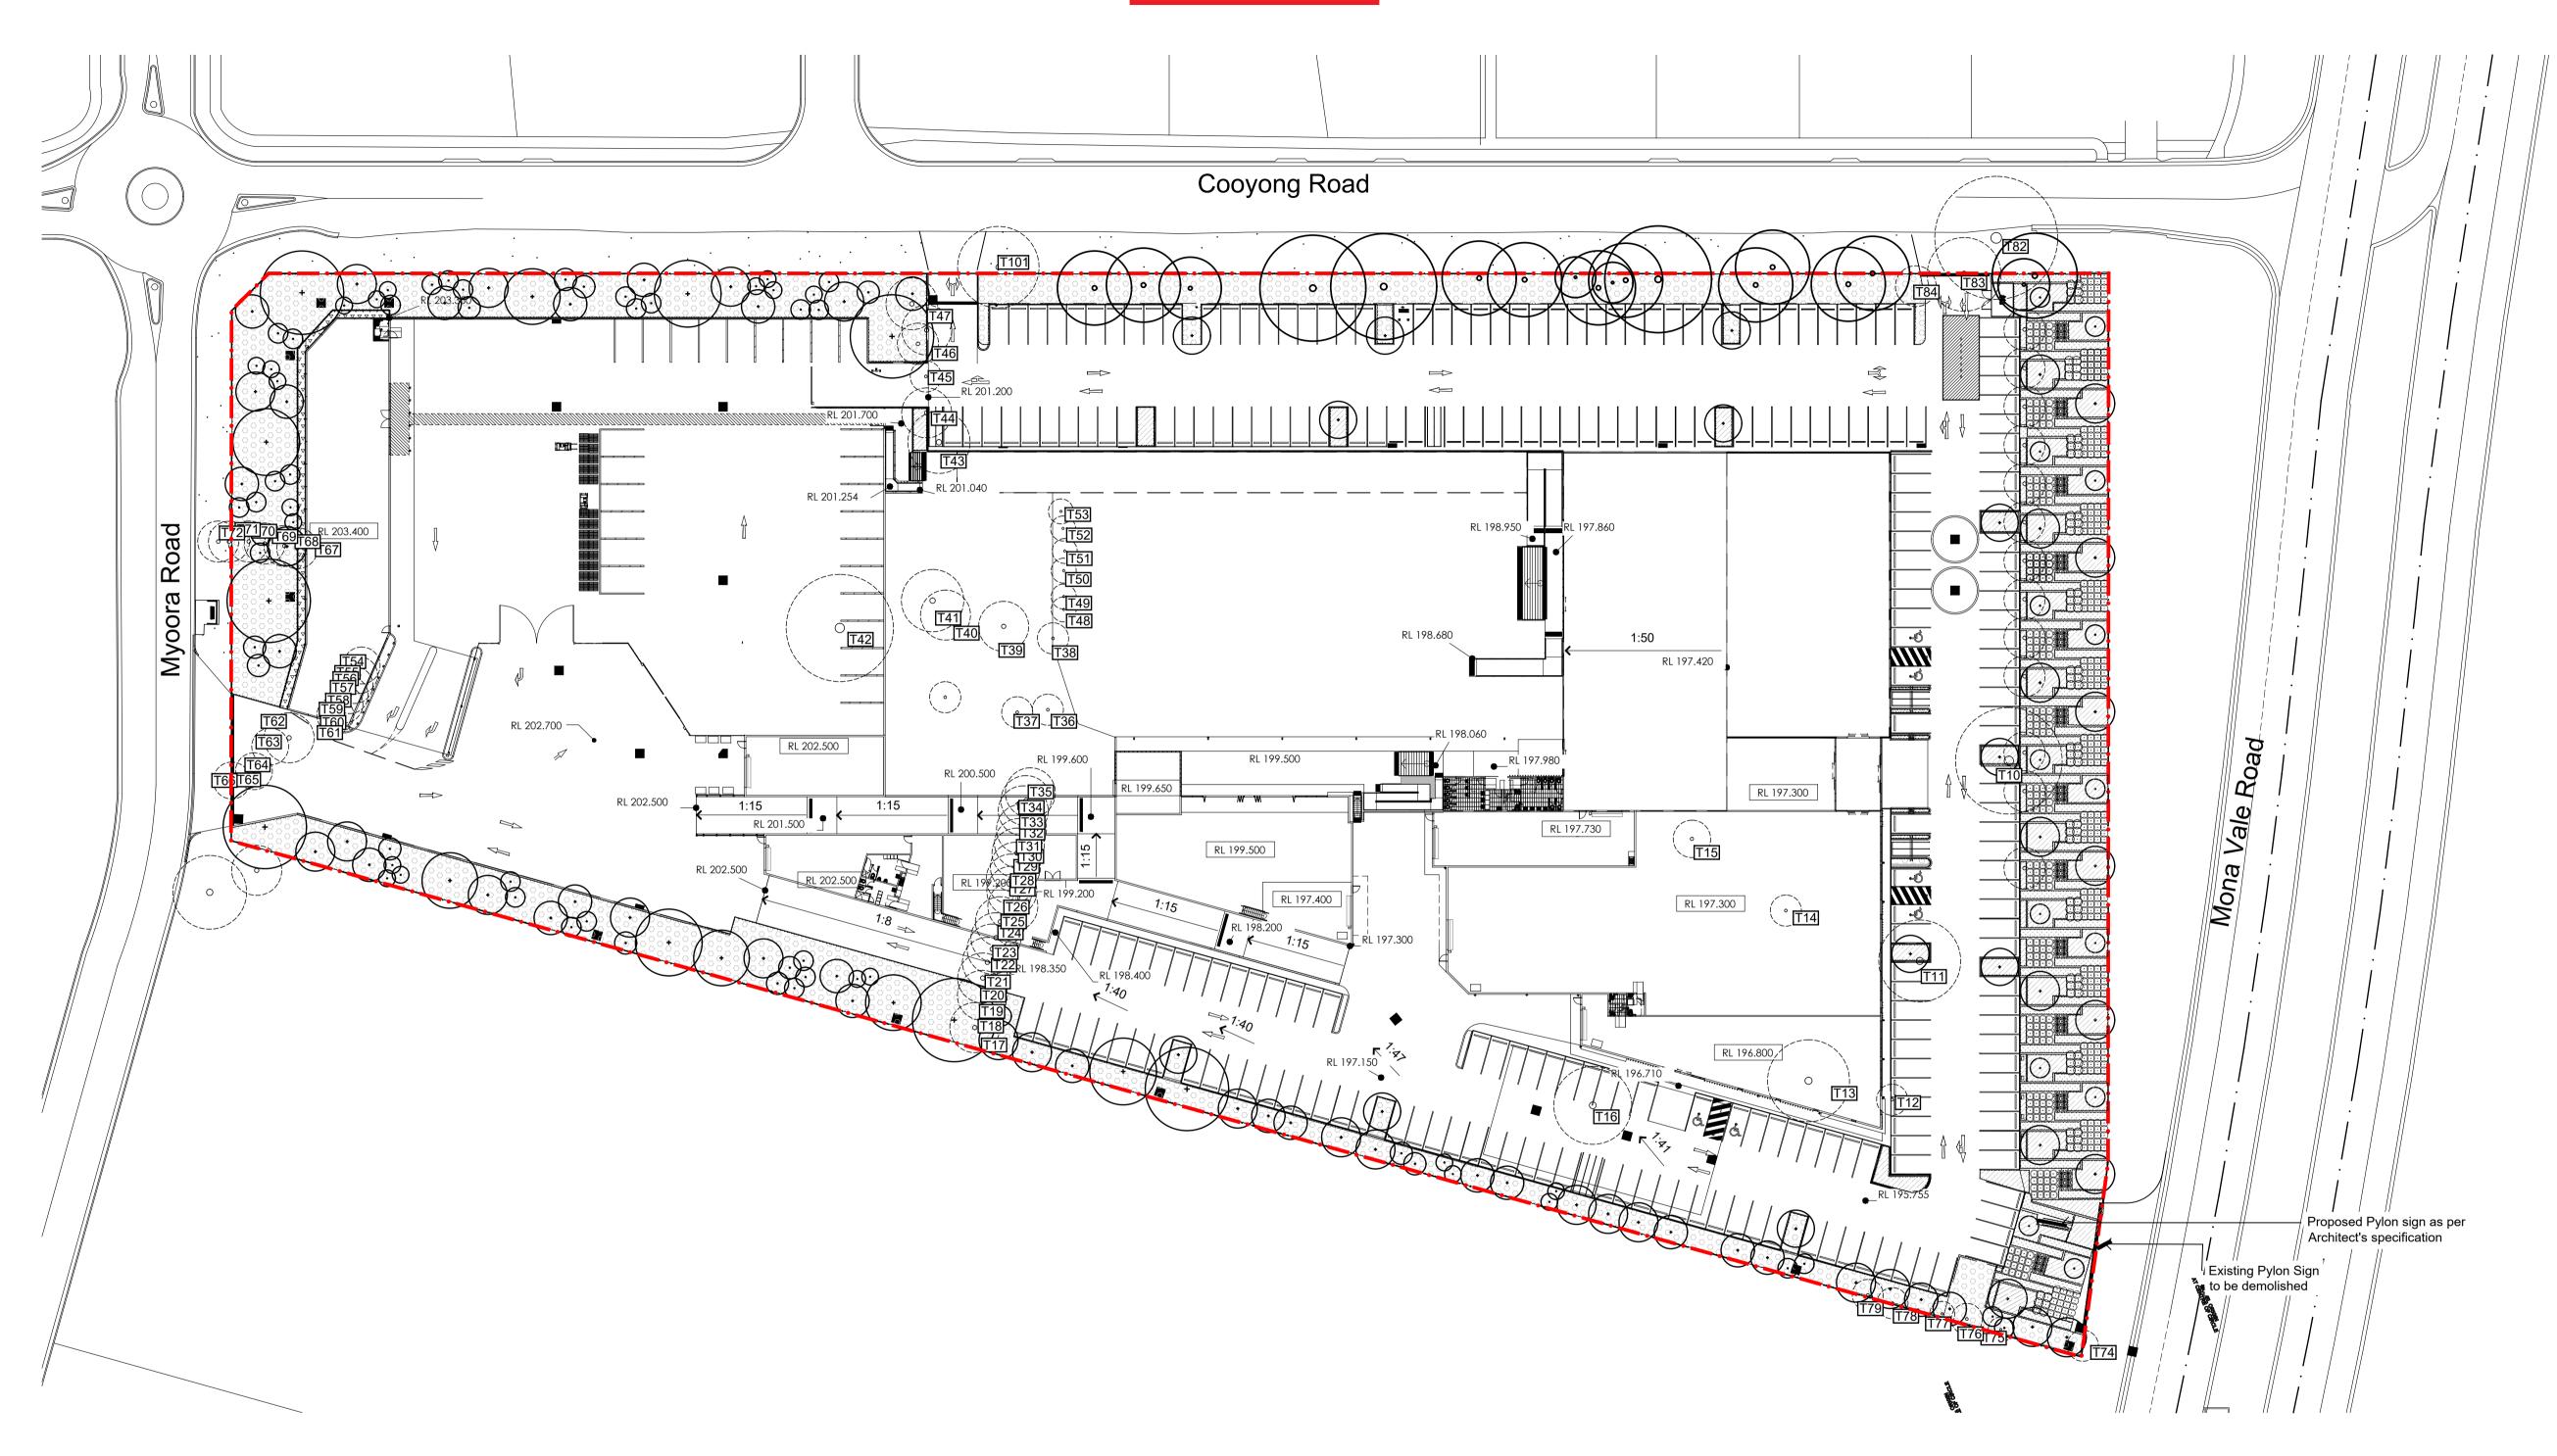

NOT FOR CONSTRUCTION

© 2021 Site Image (NSW) Pty Ltd ABN 44 801 262 380 as agent for Site Image NSW Partnership. All rights reserved. This drawing is copyright and shall not be reproduced or copied in any form or by any means (graphic, electronic or mechanical including photocopy) without the written permission of Site Image (NSW) Pty Ltd Any license, expressed or implied, to use this document for any purpose what so ever is restricted to the terms of the written agreement between Site Image (NSW) Pty Ltd and the instructing

The contractor shall check and verify all work on site (including work by others) before commencing the landscape installation. Any discrepancies are to be reported to the Project Manager or Landscape Architect prior to commencing work. Do not scale this drawing. Any required dimensions not shown shall be referred to the Landscape Architect for confirmation.

Development Application For Comment Architectural Coordination Architectural Coordination B Architectural Coordination A Preliminary

Issue Revision Description

Site Boundary Proposed Trees (Refer to Schedule and Detail) LP NM 18.04.2024 LP NM 27.03.2024 Existing Trees to be Retained LW NM 24.05.2023 LW NM 21.04.2023 LW NM 21.02.2022 Existing Trees to be LW NM 31.01.2022 Removed Drawn Check Date

Ground Cover (Refer to Schedule and Detail) **Boundary Planting** Matrix(Refer to Schedule and Shrubs and Accents (Refer to Schedule and Detail) Existing Turf

Key Plan

SITE IMAGE Client Flower Power Landscape Architects Level 1, 3-5 Baptist Street Redfern NSW 2016 Tel: (61 2) 8332 5600 Fax: (61 2) 9698 2877


www.siteimage.com.au


Flower Power Garden Centre 277 Mona Vale Road Terrey Hills, NSW


Drawing Name Landscape Plan **Ground Floor**


Development Application Scale 1:500 @ A1


001 F SS21-4790

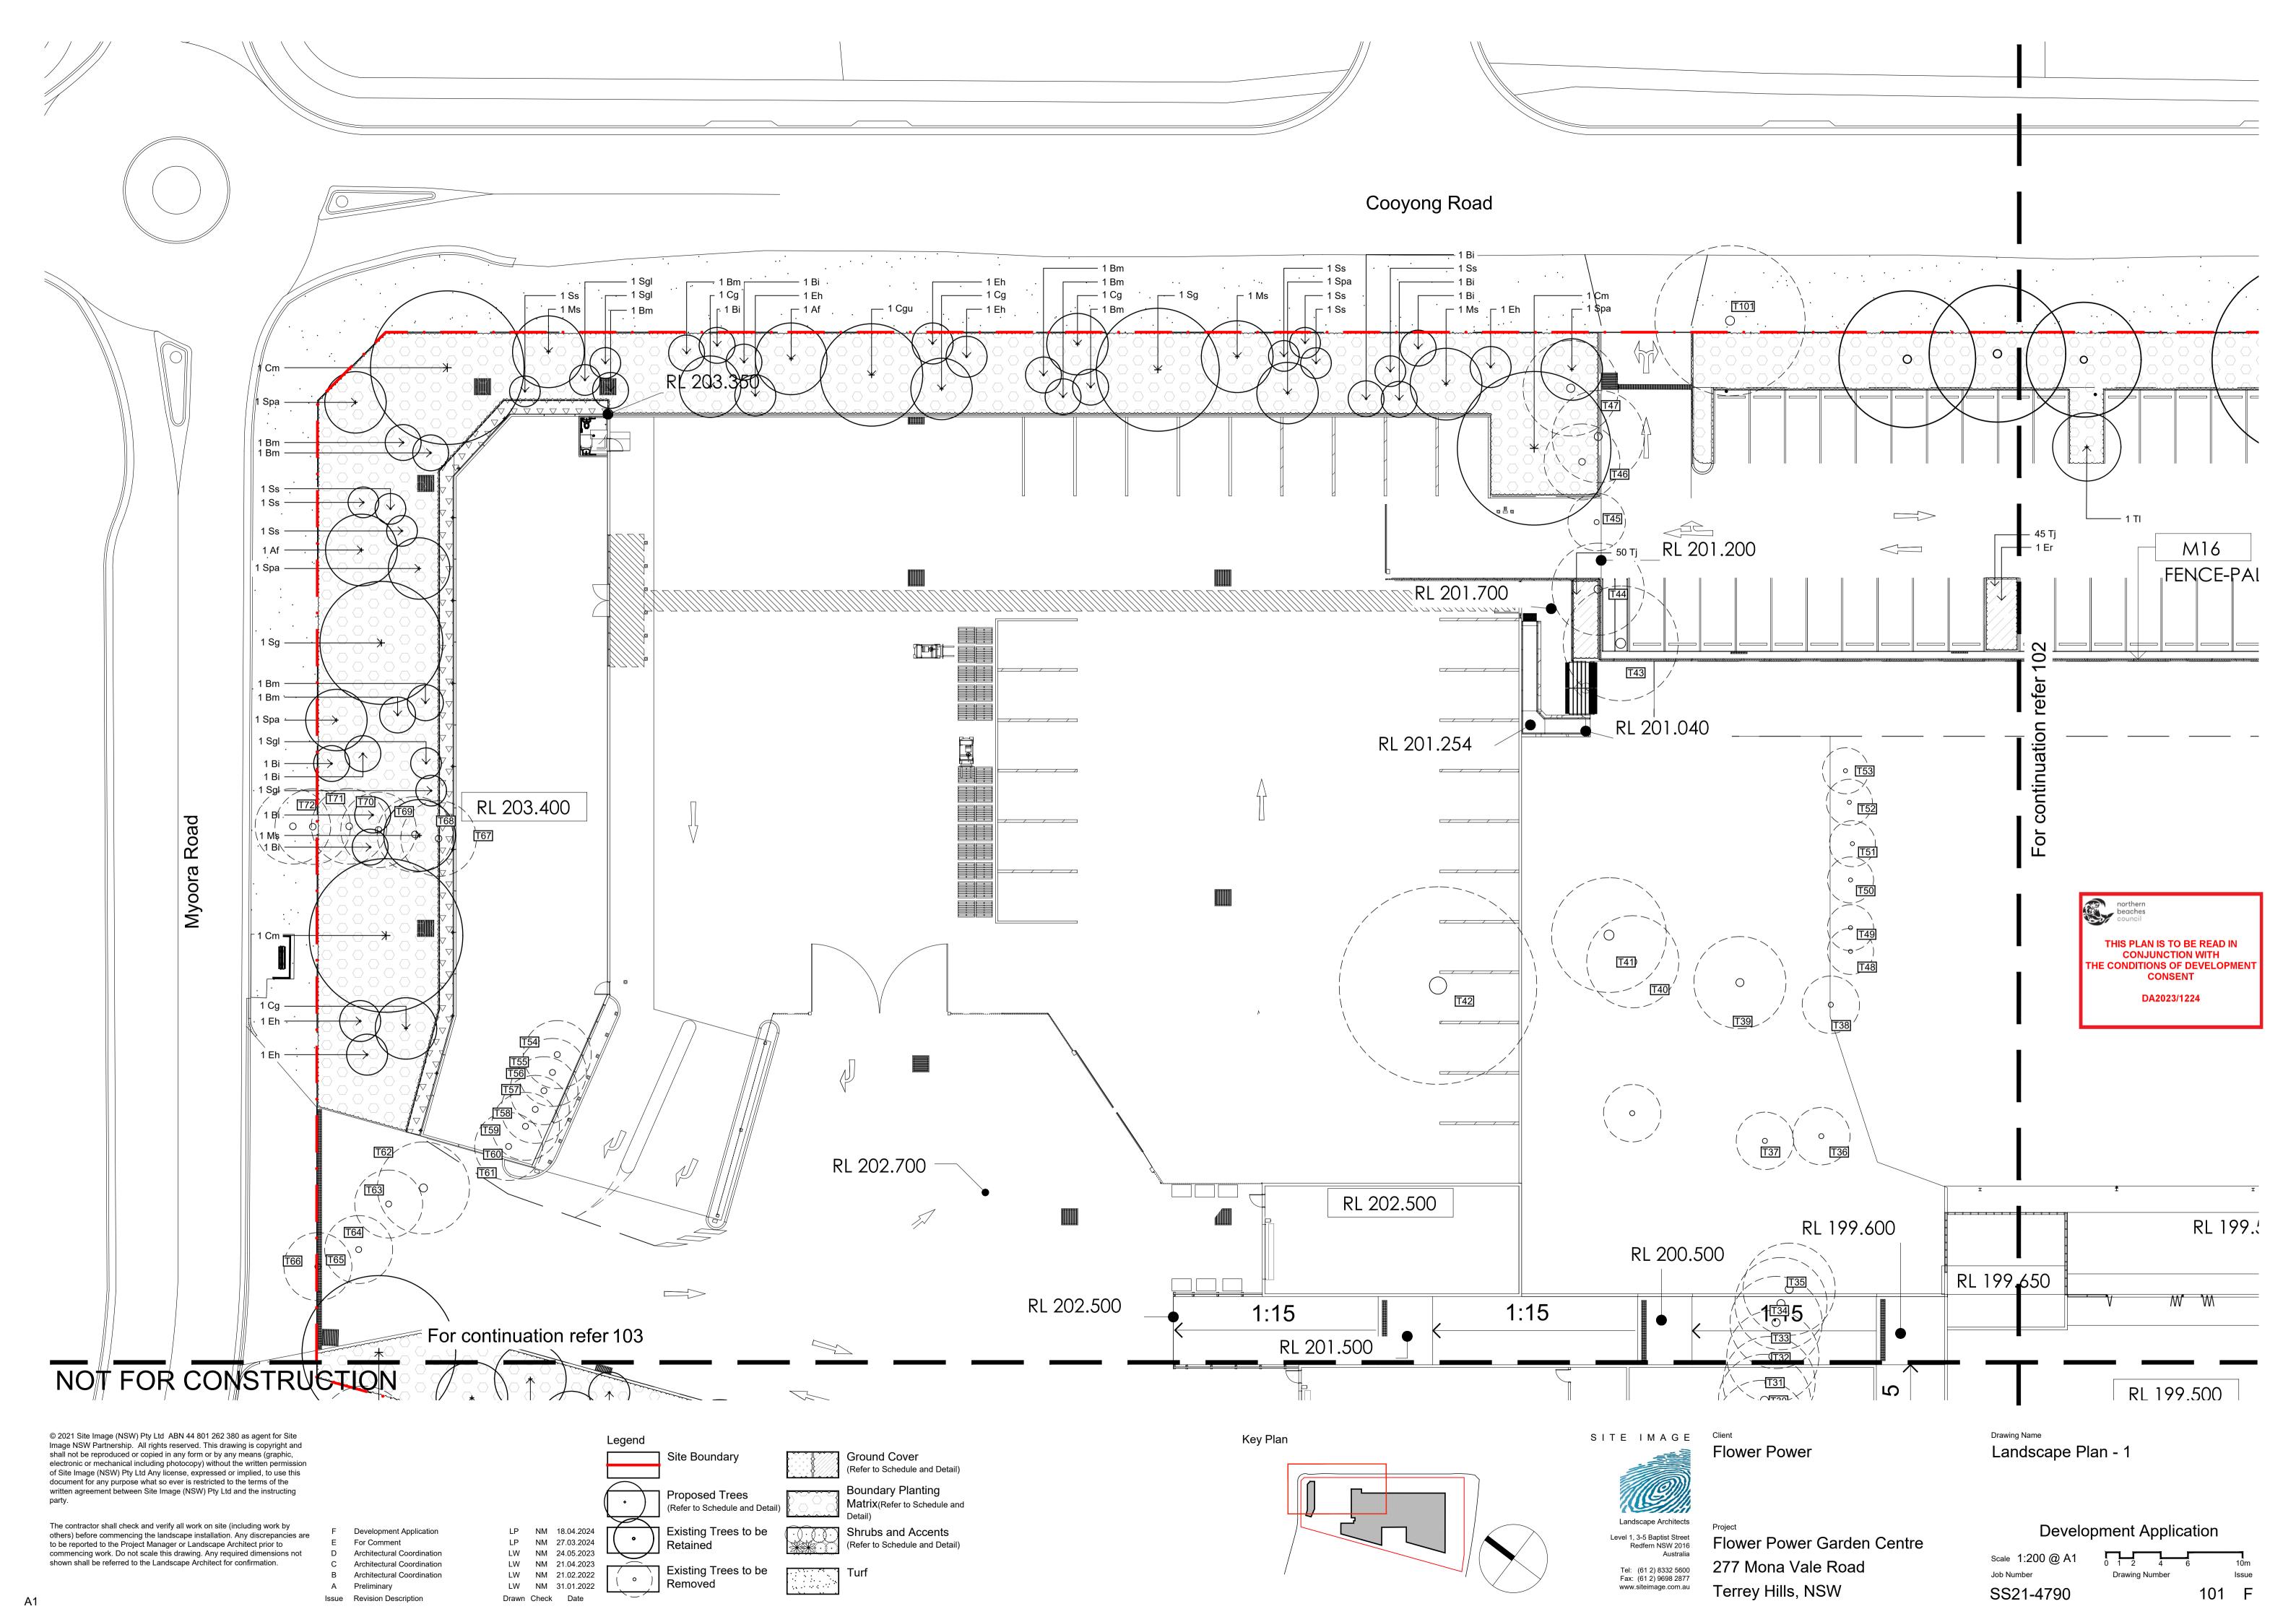

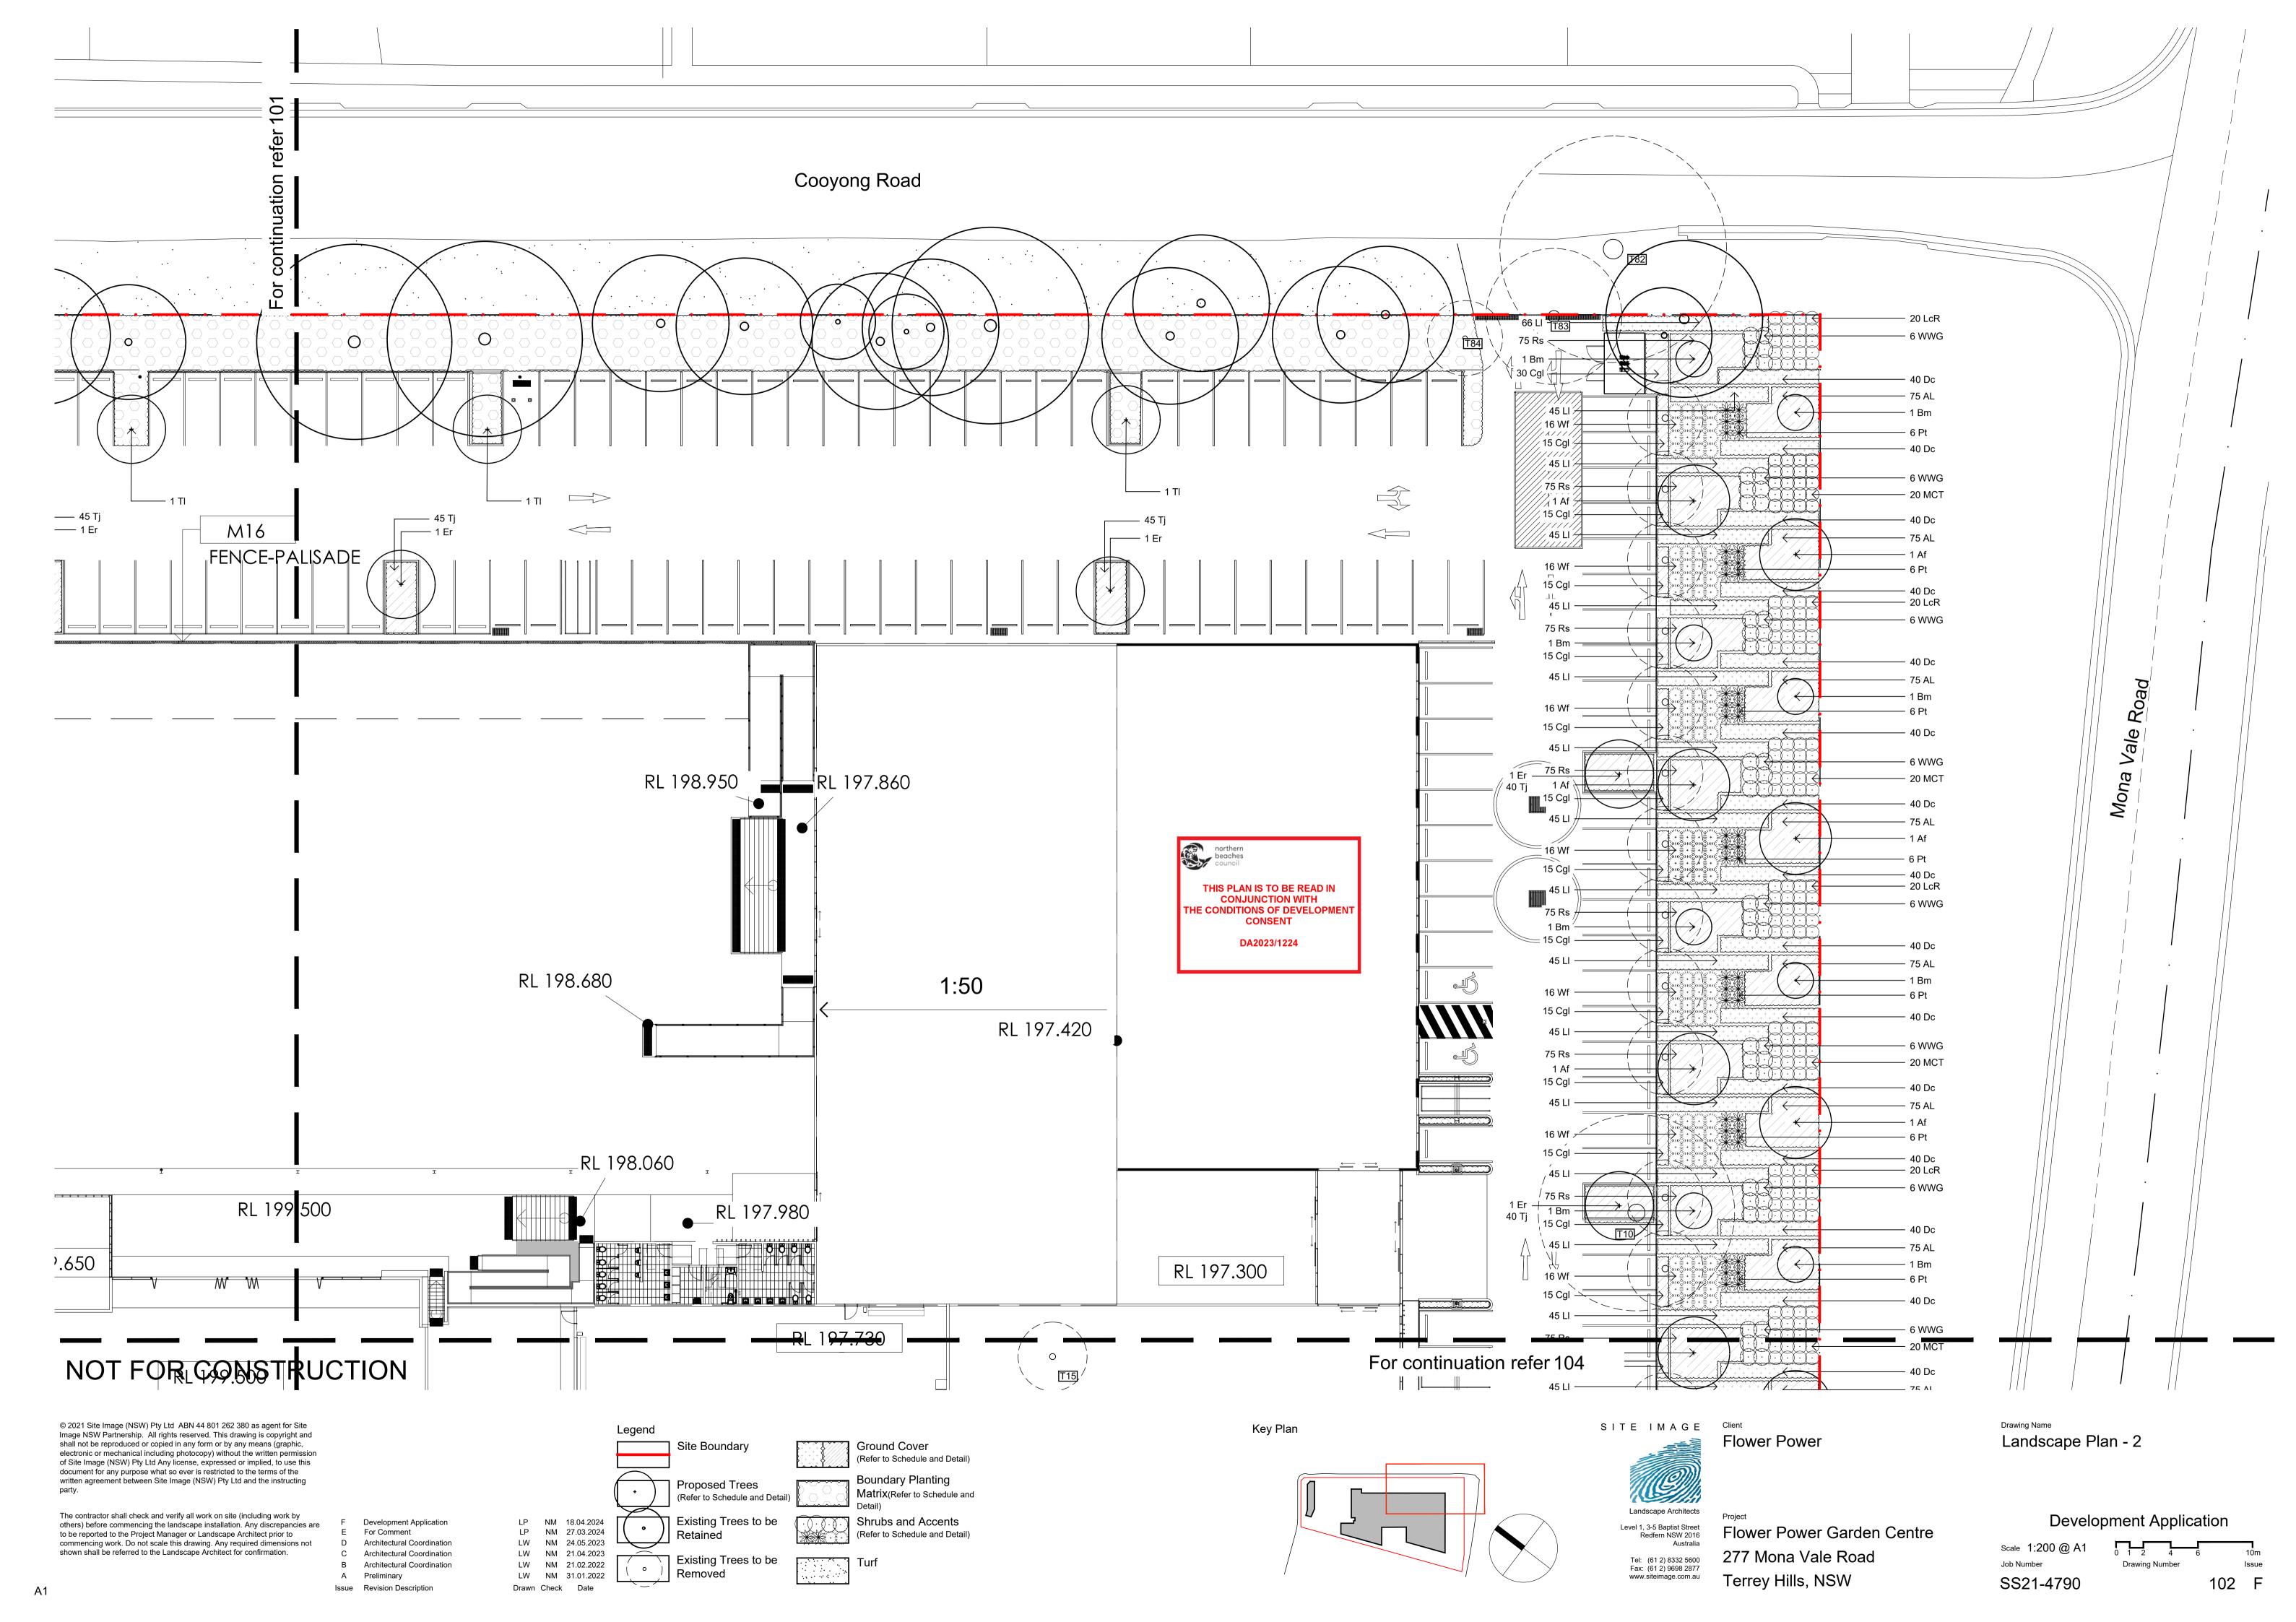


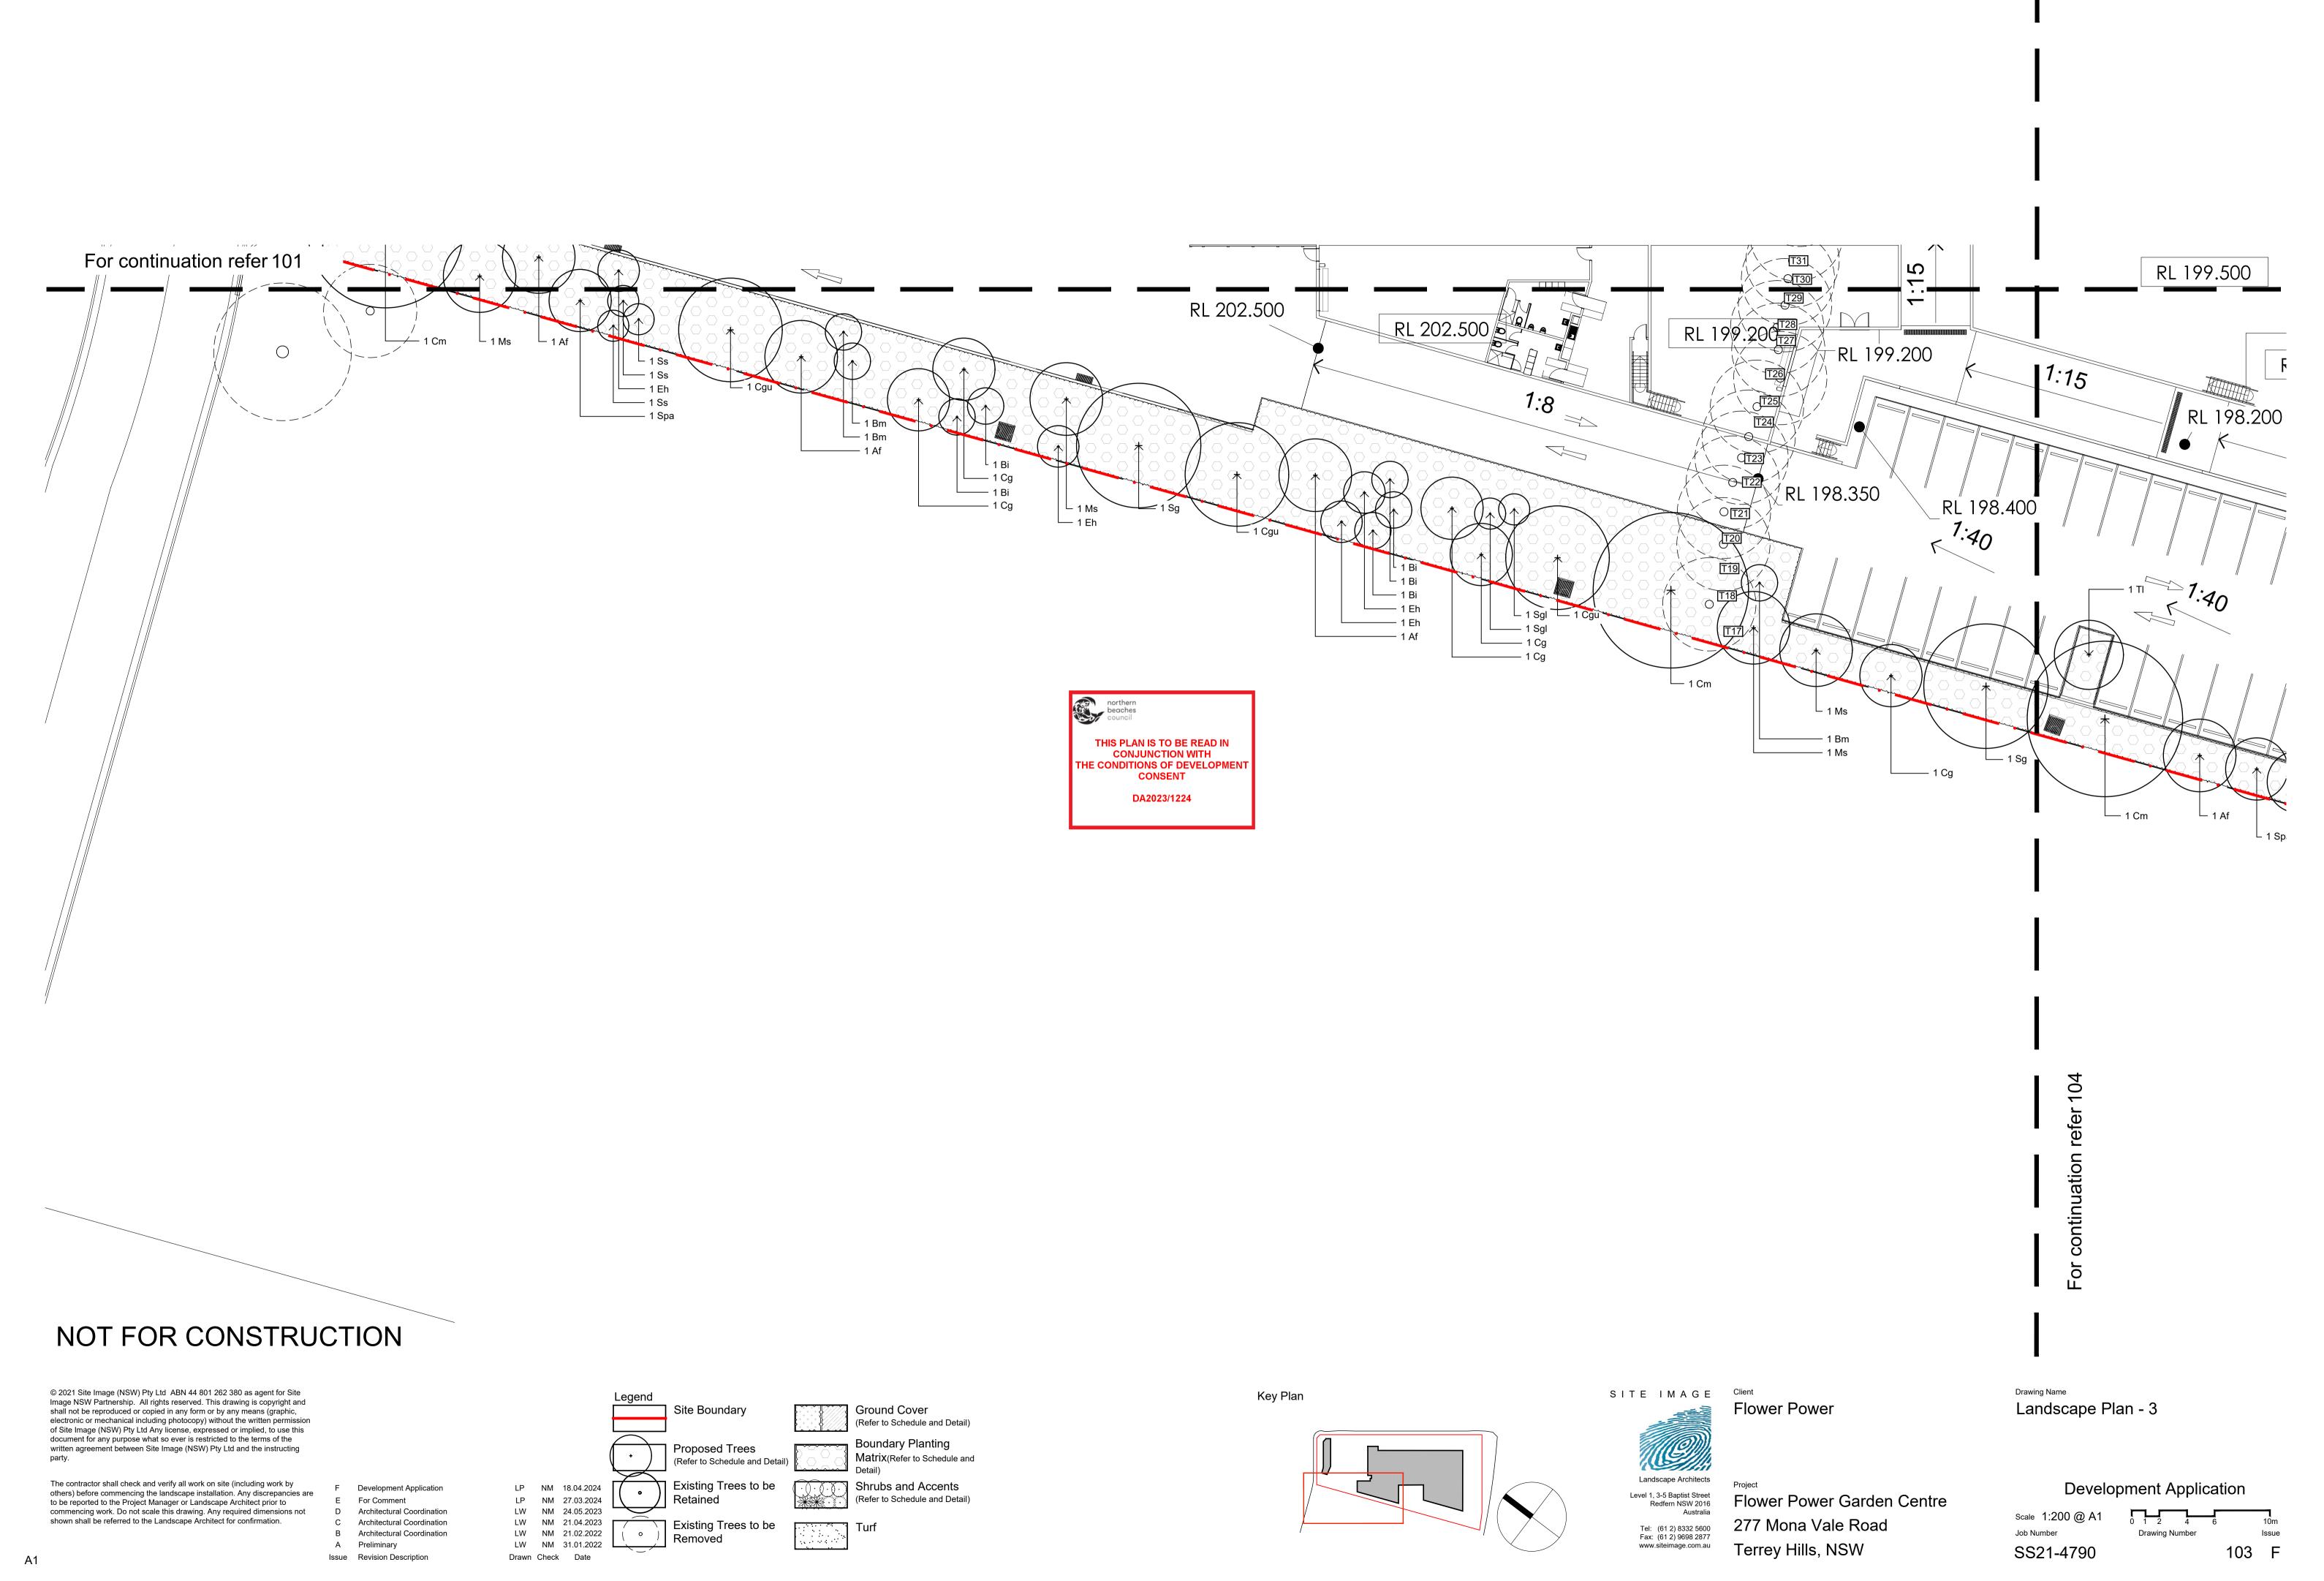

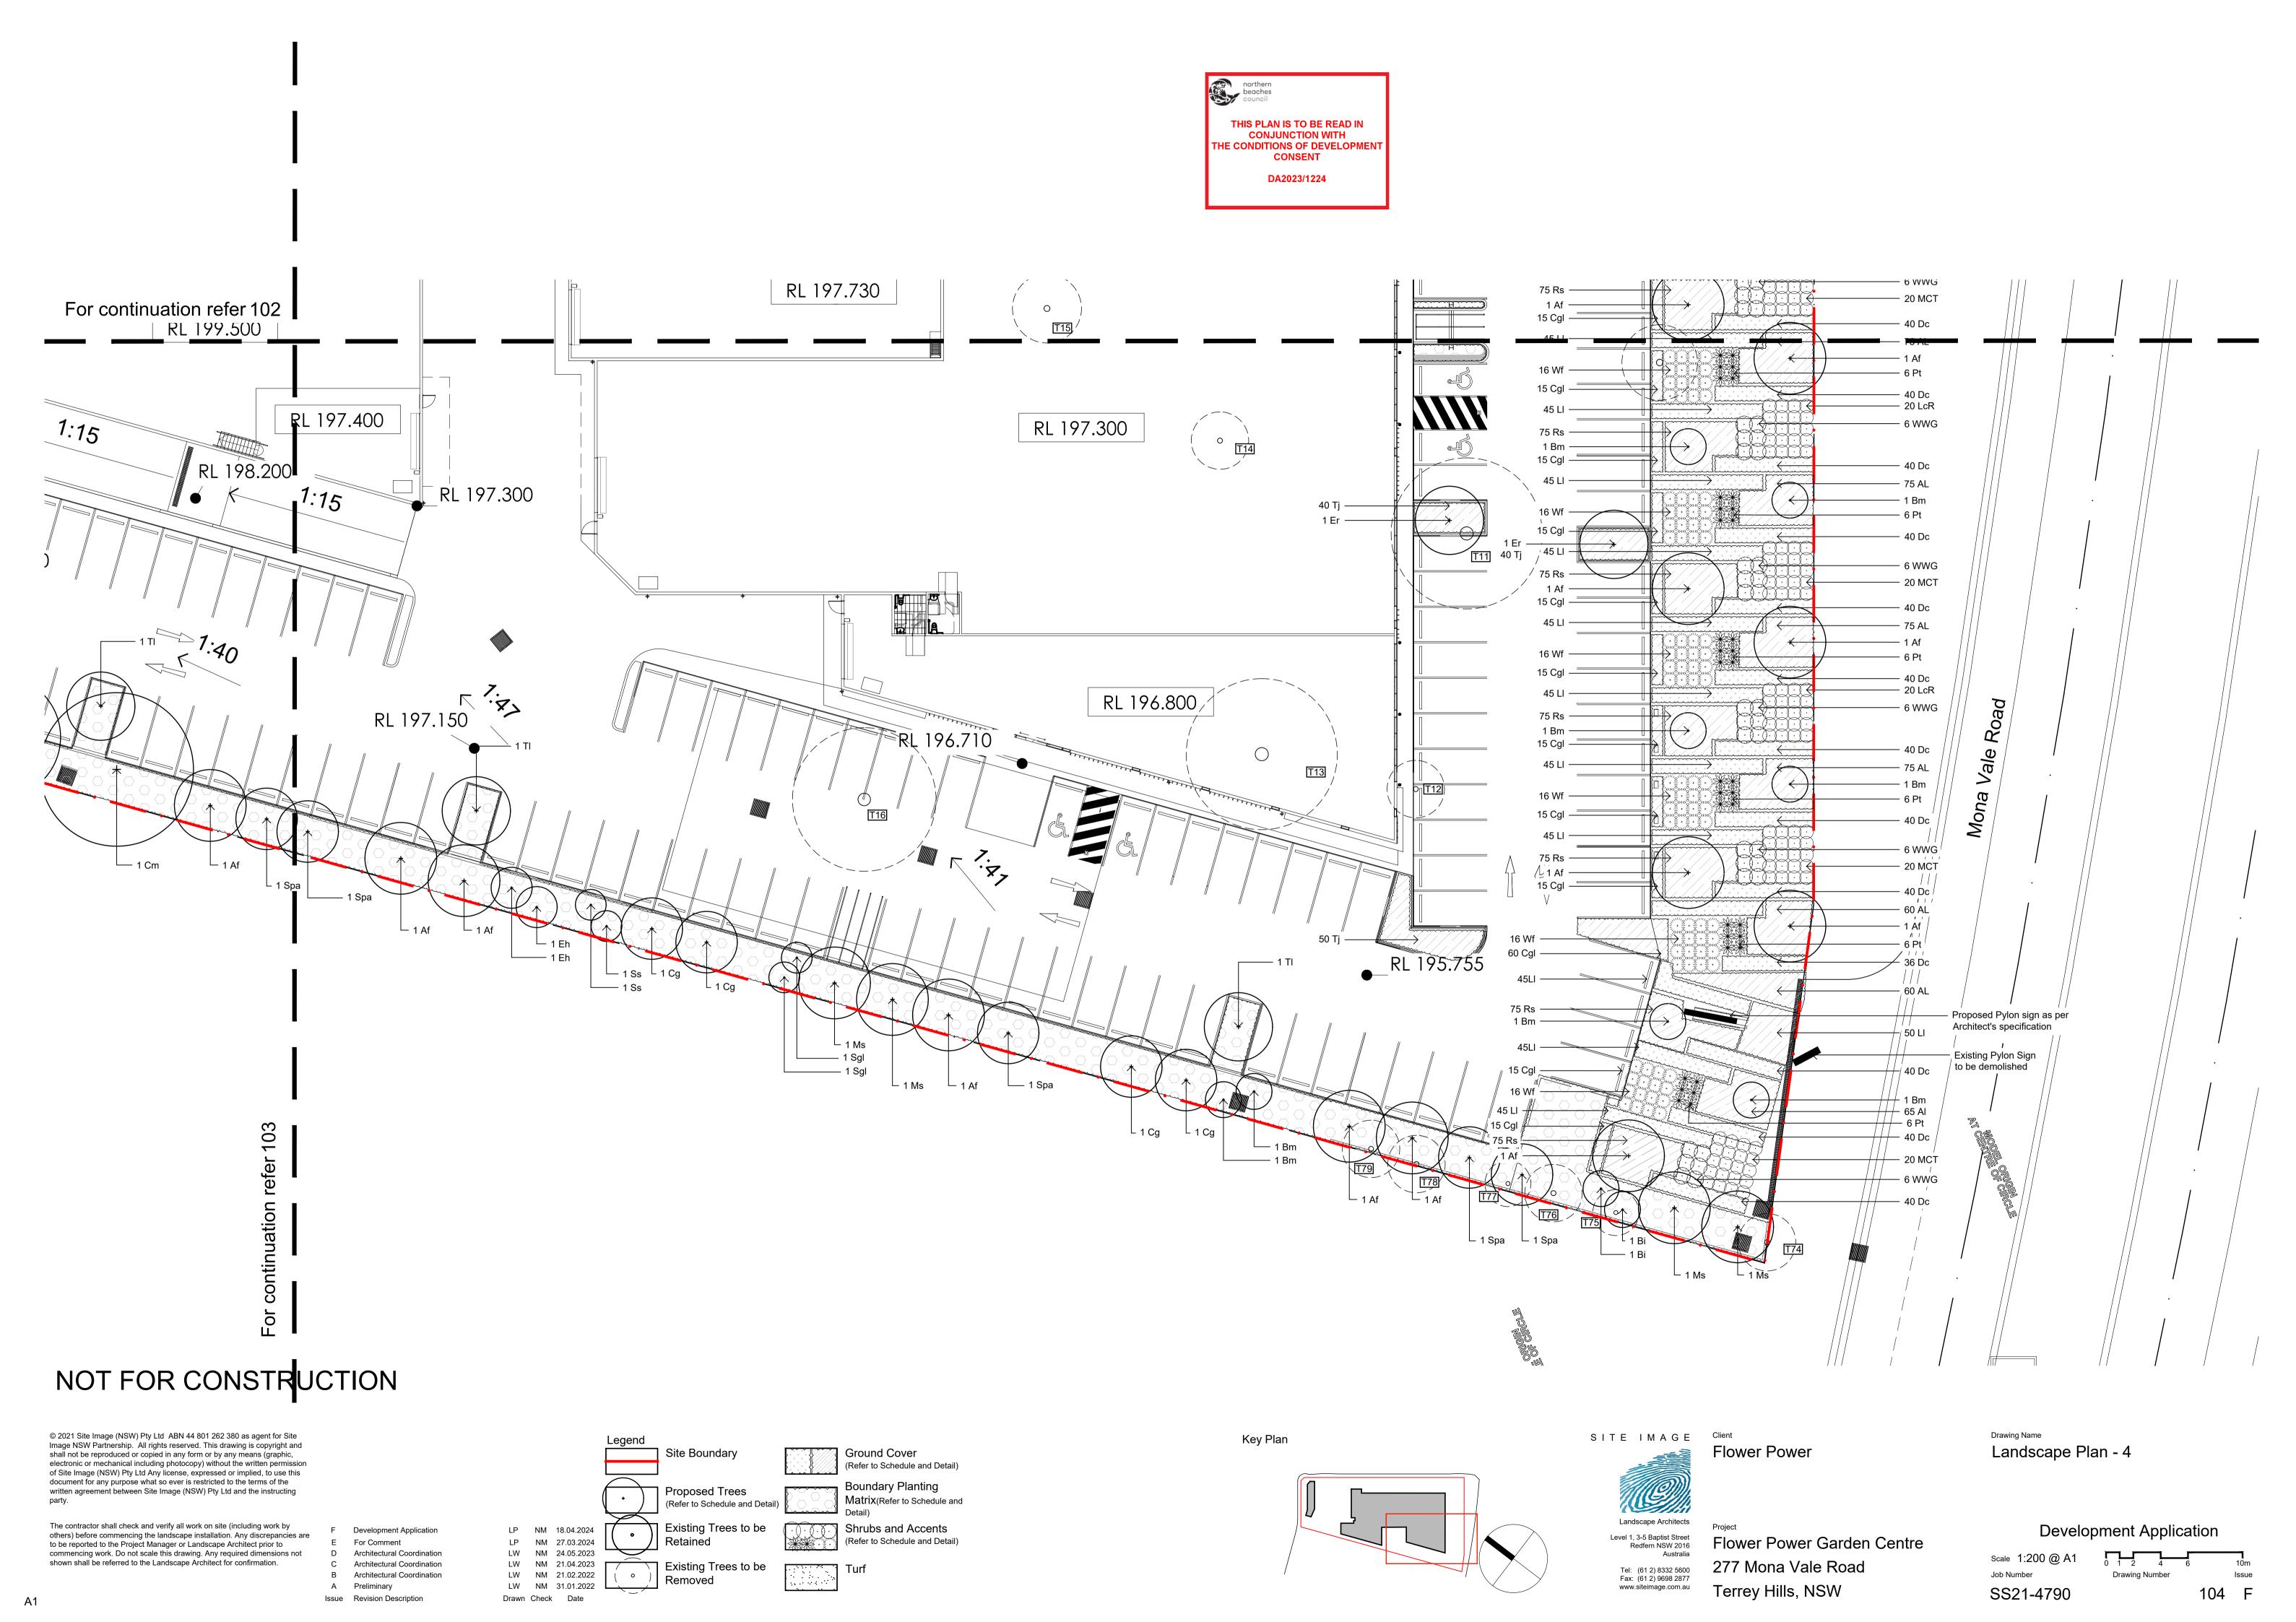


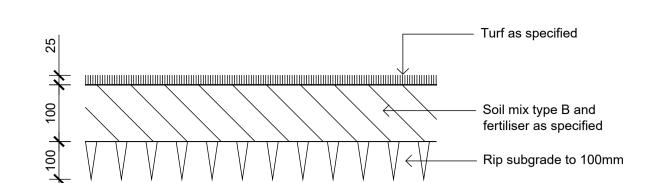

01 Detail Turf on Even Grade 501 1:10

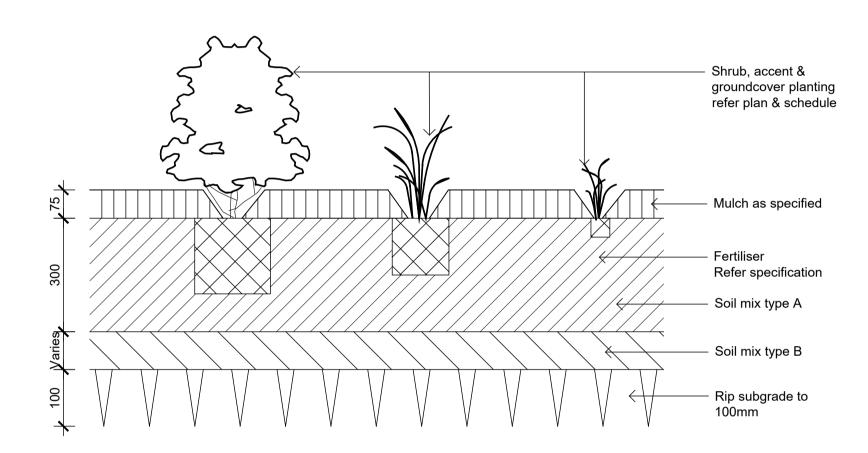

02 Detail Shrub Accent & Groundcover Planting on Grade 501 1:10

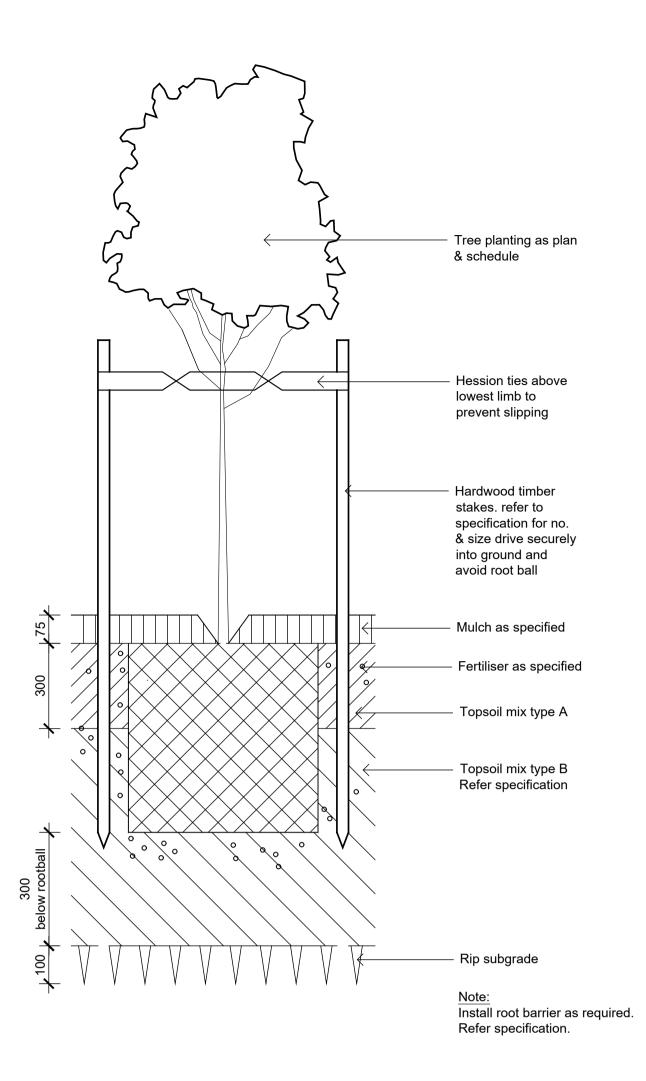

03 Detail 75-200L Tree Planting on Grade 501 1:10



NOT FOR CONSTRUCTION

© 2021 Site Image (NSW) Pty Ltd ABN 44 801 262 380 as agent for Site Image NSW Partnership. All rights reserved. This drawing is copyright and shall not be reproduced or copied in any form or by any means (graphic, electronic or mechanical including photocopy) without the written permission of Site Image (NSW) Pty Ltd Any license, expressed or implied, to use this document for any purpose what so ever is restricted to the terms of the written agreement between Site Image (NSW) Pty Ltd and the instructing

The contractor shall check and verify all work on site (including work by others) before commencing the landscape installation. Any discrepancies are to be reported to the Project Manager or Landscape Architect prior to commencing work. Do not scale this drawing. Any required dimensions not shown shall be referred to the Landscape Architect for confirmation.

Development Application For Comment Architectural Coordination Architectural Coordination B Architectural Coordination A Preliminary Issue Revision Description

LP NM 18.04.2024 LP NM 27.03.2024 LW NM 24.05.2023 LW NM 21.04.2023 LW NM 21.02.2022 LW NM 31.01.2022 Drawn Check Date

Indicative Plant Schedule

| | Botanical Name | Common Name | Mature Size (h x w) | Spacings | Pot Siz |
|-------------|---|---------------------------|---------------------------|----------|---------|
| | Carpark Trees | | | | |
| Er | Elaeocarpus reticulatus | Blueberry Ash | 10 x 4 | As Shown | 100L |
| Md | Melaleuca decora | White Feather Honeymyrtle | 6 x 3 | As Shown | 100L |
| Mq | Melaleuca quinquenervia | Paperbark | 12 x 6 | As Shown | 100L |
| TI | Tristaniopsis laurina | Water Gum | 10 x 5 | As Shown | 100L |
| | Boundary Trees | | | | |
| Af | Angophora floribunda | Rough-barked Angophora | 18 x 7 | As Shown | 45L |
| Bm | Back housia myrtifolia | Grey Myrtle | 5 x 3.5 | As Shown | 45L |
| Bi | Banksia integrifolia | Coast Banksia | 10 x 3.5 | As Shown | 45L |
| Cg | Casuarina glauca | Swamp She-oak | 14 x 6 | As Shown | 45L |
| Cgu | Corymbia gummifera | Red Bloodwood | 30 x 10 | As Shown | 45L |
| Cm | Corymbia maculata | Spotted Gum | 45 x 15 | As Shown | 45L |
| Eh | Eucalyptus haemastoma | Scribbly Gum | 10 x 4 | As Shown | 45L |
| Ms | Melaleuca stypheloides | Prickly-leaved Paperbark | 20 x 7 | As Shown | 45L |
| Sg | Syzygium glomulifera | Turpentine | 25 x 12 | As Shown | 45L |
| Sgl | Synoum glandulosum | Scentless Rosewood | 7 x 3 | As Shown | 45L |
| _ | Syzygium paniculatum | Magenta Lilly Pilly | 9 x 6 | As Shown | 45L |
| Spa Ss | Syzygium paniculatum Syzygium smithii | Common Lilly Pilly | 5 x 3 | As Shown | 45L |
| 58 | Syzygium Simum | Common Liny Piny | 3 X 3 | As Shown | 43L |
| | Shrubs and Accents | D (1.71 D)11 | 4 × 0 | A a Cha | 200 |
| AsM - | Acmena smithii 'Minor' | Dwarf Lilly Pilly | 4 x 2 | As Shown | 300mn |
| De | Doryanthes exceisa | Gymea Lily | 3 x 2 | As Shown | 200mn |
| _cR | Loropetalum chinense 'Rubrum ' | Chinese Fringe Flower | 1 x 1 | As Shown | 200mn |
| МСТ | Melaleuca linariifolia 'Claret Tops' | Honey Myrtle | 1 x 1 | As Shown | 200mn |
| PgR | Photinia glabra 'Rubens' | Japanese Photinia | 4 x 2 | As Shown | 300mn |
| Pt | Phormium tenax | New Zealand Flax | 3 x 1.5 | As Shown | 200mn |
| PX | Philodendron 'Xanadu' | Xanadu | .8 x 1 | As Shown | 200mn |
| Λ F | Westringia fruticosa | Coastal Rosemary | 2 x 2 | As Shown | 200mn |
| /W G | Westringia 'Wynyabbie Gem' | Coastal Rosemary | 2 x 2 | As Shown | 200mn |
| | Groundcovers / Grasses | | | | |
| AL | Acacia 'Limelight' | Acacia Limelight | 0.5 x 0.5 | 5/m2 | 150mn |
| Cgl | Carpobrotus glaucescens | Pigface | .2 x 1 | 5/m2 | 150mn |
| Сар | Carex appressa | Tall sedge | .8 x 1 | 5/m2 | 150mn |
| ОсВ | Dianella caerulea 'Breeze' | Breeze Paroo Lily | .6 x .6 | 5/m2 | 150mn |
| dvR | Hardenbergia violacea 'Rosea' | Native Sarsaparilla | 2 x 1 | 5/m2 | 150mr |
| ds. | Hibbertia scandens | Guinea Flower | .5 x 1 | 5/m2 | 150mn |
| LI | Lomandra longifolia | Mat Rush | .7 x 1 | 5/m2 | 150mn |
| | Myoporum parvifolium 'Yareena' | | 1.5 | 5/m2 | 150mn |
| ИрҮ | Poa labillardieri 'Eskdale' | Yareena Myoporum | | 5/m2 | 150mm |
| PIE | | Tussock Grass | .6 x .6 | 5/1112 | ISUM |
| ₹s | Rhagodia spinescens 'Aussie Flat Bush' | Saltbush | 0.4 x 1 | 5/m2 | 150mn |
| Гј | Trachelospermum jasminoides | Star Jasmine | .2 x .5 | 5/m2 | 150mr |
| | Boundary Planting Matrix | | | | |
| | | | Mature | Density | |
| | Betaniesi News | On the time of the time | Size | /25m2 | Pot Siz |
| _ | Botanical Name | Common Name | (h x w) | | 450 |
| Be | Banksia ericifolia | Heath-leaved Banksia | 6 x 2 | 7 | 150mn |
| Эе | Doryanthes exceisa | Gymea Lily | 3 x 2 | As Shown | 200mn |
| Dt | Dodonaea triquetra | Common Hop-Bush | 3 x 2 | 7 | 150mn |
| / Vf | Westringia fruticosa | Coast Rosemary | 1 x 1 | 7 | 150mr |
| Oc | Dianella caerulea | Blue Flax Lily | . 4 x .4 | 10 | Tube |
| - | Carpobrotus glaucescens | Pig Face | .2 x 1 | 10 | Tube |
| ∪g | - · · · · · · · · · · · · · · · · · · · | _ | | | |
| Cg Hs | Hibbertia scandens | Golden Guinea Flower | .2 x 1 | 10 | Tube |

SITE IMAGE Client Flower Power

Landscape Architects Level 1, 3-5 Baptist Street Redfern NSW 2016 Tel: (61 2) 8332 5600 Fax: (61 2) 9698 2877


Flower Power Garden Centre 277 Mona Vale Road Terrey Hills, NSW www.siteimage.com.au

Drawing Name Landscape Details

Development Application Scale

501 F


Job Number SS21-4790

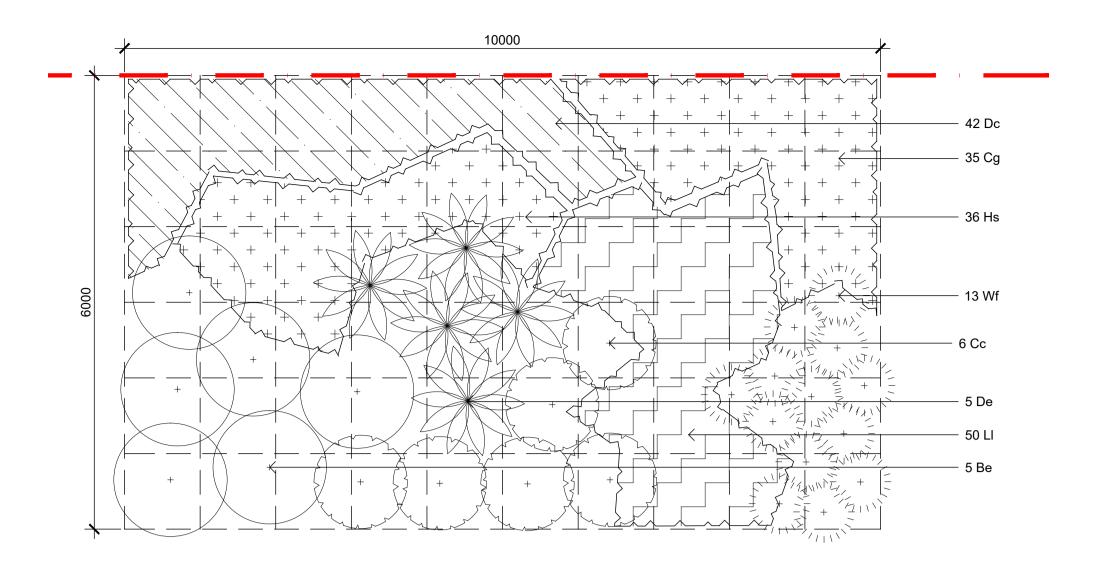



Boundary Planting Matrix

Shrubs to be planted away from existing and proposed tree's to ensure shrub and tree canopy are not connected.

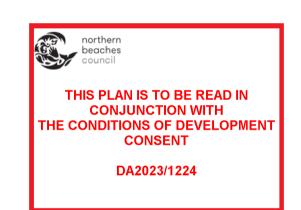

NOT FOR CONSTRUCTION

© 2021 Site Image (NSW) Pty Ltd ABN 44 801 262 380 as agent for Site Image NSW Partnership. All rights reserved. This drawing is copyright and shall not be reproduced or copied in any form or by any means (graphic, electronic or mechanical including photocopy) without the written permission of Site Image (NSW) Pty Ltd Any license, expressed or implied, to use this document for any purpose what so ever is restricted to the terms of the written agreement between Site Image (NSW) Pty Ltd and the instructing

The contractor shall check and verify all work on site (including work by others) before commencing the landscape installation. Any discrepancies are to be reported to the Project Manager or Landscape Architect prior to commencing work. Do not scale this drawing. Any required dimensions not shown shall be referred to the Landscape Architect for confirmation.

Development Application LP NM 18.04.2024 For Comment LP NM 27.03.2024 Architectural Coordination LW NM 24.05.2023 LW NM 21.04.2023 Architectural Coordination LW NM 21.02.2022 B Architectural Coordination LW NM 31.01.2022 A Preliminary Drawn Check Date Issue Revision Description



Flower Power

Flower Power Garden Centre 277 Mona Vale Road Terrey Hills, NSW

Drawing Name Landscape Details

Development Application

502 F

Job Number **Drawing Number**

SS21-4790

GENERAL NOTES

THESE DRAWINGS SHALL BE READ IN CONJUNCTION WITH OTHER CONSULTANTS' DRAWINGS AND SPECIFICATIONS AND WITH OTHER SUCH WRITTEN INSTRUCTIONS AS MAY BE ISSUED DURING THE COURSE OF THE CONTRACT. ANY DISCREPANCY SHALL BE REFERRED TO THE ENGINEER BEFORE PROCEEDING WITH THE WORK.

ALL DIMENSIONS ARE IN MILLIMETRES & ALL LEVELS ARE IN METRES, UNO (UNLESS NOTED OTHERWISE).

NO DIMENSION SHALL BE OBTAINED BY SCALING THE DRAWINGS.

ALL LEVELS AND SETTING OUT DIMENSIONS SHOWN ON THE DRAWINGS SHALL BE CHECKED ON SITE PRIOR TO THE COMMENCEMENT OF THE WORK.

DETAIL SURVEY DATA WAS SUPPLIED BY: BOXALL SURVEYORS

REF. NUMBER: 10115-002 REVISION DATE: 01.06.2021

REVISION NUMBER: A GEOCENTRIC DATUM OF AUSTRALIA: GDA94

SURVEYOR: BC APPROVED: SL

EXISTING SERVICES WHERE SHOWN HAVE BEEN PLOTTED FROM SUPPLIED DATA AND SUCH THEIR ACCURACY CAN NOT BE GUARANTEED. IT IS THE RESPONSIBILITY OF THE CONTRACTOR TO ESTABLISH THE LEVEL OF ALL EXISTING SERVICES PRIOR TO THE COMMENCEMENT OF WORK.

ON COMPLETION OF STORMWATER INSTALLATION, ALL DISTURBED AREAS MUST BE RESTORED TO ORIGINAL CONDITION, INCLUDING KERBS, FOOTPATHS, CONCRETE AREAS, GRAVEL AND GRASSED AREAS AND ROAD PAVEMENTS, UNLESS DIRECTED OTHERWISE.

ALL STORMWATER MANAGEMENT MEASURES SHOWN ON THIS DRAWING HAVE BEEN PREPARED FOR DEVELOPMENT APPLICATION PURPOSES TO DEMONSTRATE FEASIBILITY. ALL MEASURES WILL BE SUBJECT TO DETAIL DESIGN AT THE CONSTRUCTION CERTIFICATE STAGE AND MAY BE SUBJECT TO VARIATION PROVIDED THAT THE DESIGN INTENT IS MAINTAINED.

STORMWATER DRAINAGE

- 1. ALL DRAINAGE LINES SHALL BE UPVC (CLASS SN4) SEWER GRADE DRAINAGE PIPE, U.N.O.
- 2. ALL DRAINAGE LINES SHALL BE LAID AT 1% MIN. FALL, UNO.
- 3. ALL LEVELS ARE AUSTRALIAN HEIGHT DATUM (AHD).
- 4. ALL DOWNPIPES GUTTERS TO BE DESIGNED IN ACCORDANCE WITH AS/NZS 3500.3.2 - 2003 'STORMWATER' DRAINAGE
- THE STORMWATER DRAINAGE DESIGN HAS BEEN CARRIED OUT IN ACCORDANCE WITH AS/NZS 3500.3.2-2003 'STORMWATER' DRAINAGE.
- 6. ANY VARIATIONS TO THE NOMINATED LEVELS SHALL BE REFERRED TO ENGINEER IMMEDIATELY.
- SUBSOIL DRAINAGE SHALL BE PROVIDED TO ALL RETAINING WALLS & EMBANKMENTS, WITH THE LINES FEEDING INTO THE STORMWATER DRAINAGE SYSTEM.
- 8. ALL GRATES TO BE GALVANISED STEEL WITH HINGES AND CHILD PROOF LOCK.
- 9. THE STORMWATER DRAINAGE IS DESIGNED IN ACCORDANCE WITH NORTHERN BEACHES COUNCIL WATER MANAGEMENT FOR DEVELOPMENT POLICY 2021.

RAINWATER RE-USE

- PROVIDE RAINWATER RE-USE SYSTEM TO SUPPLY WATER FOR TOILET FLUSHING AND IRRIGATION
- 2. GUTTER GUARD TO BE INSTALLED ON ALL EAVES GUTTERS.
- A PERMANENT SIGN IS TO BE LOCATED IN THE VICINITY OF THE TANK STATING THE WATER IS "NON POTABLE WATER" WITH APPROPRIATE HAZARD IDENTIFICATION.
- 4. PIPEWORK USED FOR RAINWATER SERVICES SHALL BE COLOURED LILAC IN ACCORDANCE WITH AS1345.
- ALL VALVES AND APERTURES SHALL BE CLEARLY AND PERMANENTLY LABELLED WITH SAFETY SIGNS TO COMPLY WITH AS1319.
- 6. RAINWATER TANK RETICULATION SYSTEM AND MAINS WATER BYPASS ARRANGEMENT TO BE INSTALLED IN ACCORDANCE WITH AS/NZS 3500.1.2-2003 AND THE NSW CODE OF PRACTICE: PLUMBING AND DRAINING.
- 7. A FIRST FLUSH FILTRATION DEVICE IS TO BE PROVIDED AT RAINWATER TANK.

DESIGN SUMMARY

SITE DISCHARGE CALCULATIONS:

| | <u>20% AEP</u> | <u>5% AEP</u> | <u>1% AEP</u> | |
|------------------|----------------|---------------|-------------------------|--|
| PRE-DEVELOPMENT | 0.364 m³/s | 0.688 m³/s | 1.115 m³/s | |
| POST-DEVELOPMENT | 0.284 m³/s | 0.495 m³/s | 0.937 m ³ /s | |

ON-SITE DETENTION:

DESIGN BASIS:

PRE TO POST DEVELOPMENT CONDITIONS

ON-SITE DETENTION SUMMARY: BELOW GROUND BLOCK WORK TANK

TOP WATER LEVEL = RL196.150 OVERFLOW LEVEL = RL195.900 ORIFICE CENTERLINE = RL194.345 ORIFICE DIAMETER = Ø350mm

RAINWATER RE-USE:

IN ACCORDANCE WITH BASIX/COUNCIL REQUIREMENTS. RAINWATER RE-USE STORAGE PROVIDED IS TO BE DESIGNED

RAINWATER RE-USE TO BE USED FOR THE FOLLOWING;

 TOILET FLUSHING; IRRIGATION.

STORMWATER MANAGEMENT REQUIREMENTS HAVE BEEN CALCULATED IN ACCORDANCE WITH NORTHERN BEACHES COUNCIL WATER MANAGEMENT PLAN FOR DEVELOPMENT POLICY 2021: PART 9.0 ONSITE STORMWATER MANAGEMENT.

WATER QUALITY:

MUSIC MODEL SUMMARY (REFER NORTHROP REPORT FOR FURTHER DETAILS).

MUSIC MODEL PARAMETERS IN ACCORDANCE WITH NORTHERN BEACHES

TREATMENT NODES:

- RAINWATER RE-USE TANK
- 'OCEANGUARD' PIT INSERTS (OR SIMILAR)
- FILTER CARTRIDGES

COUNCIL'S MUSIC MODELLING GUIDELINES 2016.

CONCEPT SOIL & WATER MANAGEMENT

- 1. ALL WORK IS TO BE CARRIED OUT IN ACCORDANCE WITH RELEVANT ORDINANCES AND REGULATIONS; NOTE IN PARTICULAR THE REQUIREMENTS OF LANDCOMS MANAGING URBAN STORMWATER, SOILS AND CONSTRUCTION' (THE 'BLUE BOOK'). THIS SOIL AND WATER MANAGEMENT PLAN DETAILS THE ACTIONS TO BE TAKEN FOR THE MANAGEMENT AND DEWATERING OF STORMWATER DURING CONSTRUCTION OF THE PROPOSED BUILDING.
- INSTALL SEDIMENT PROTECTION FILTERS ON ALL NEW AND EXISTING STORMWATER INLET PITS IN ACCORDANCE WITH EITHER THE MESH AND GRAVEL INLET FILTER DETAIL SD6-11 OR THE GEOTEXTILE INLET
- FILTER DETAIL SD6-12 OF THE 'BLUE BOOK'. 3. ESTABLISH ALL REQUIRED SEDIMENT FENCES IN ACCORDANCE WITH DETAIL SD6-8 OF THE 'BLUE BOOK'.
- 4. INSTALL SEDIMENT FENCING AROUND INDIVIDUAL BUILDING ZONES/AREAS AS REQUIRED AND AS DIRECTED BY THE SUPERINTENDENT.
- 5. ALL TRENCHES INCLUDING ALL SERVICE TRENCHES AND SWALE EXCAVATION SHALL BE SIDE-CAST TO THE HIGH SIDE AND CLOSED AT THE END OF EACH DAYS WORK.
- THE CONTRACTOR SHALL ENSURE THAT ALL VEGETATION (TREE, SHRUB & GROUND COVER) WHICH IS TO BE RETAINED SHALL BE PROTECTED DURING THE DURATION OF CONSTRUCTION. REFER ARCHITECTS PLANS FOR TREES TO BE KEPT.
- 7. ALL VEGETATION TO BE REMOVED SHALL BE MULCHED ONSITE AND SPREAD/STOCKPILED AS DIRECTED BY THE SUPERINTENDENT.
- 8. STRIP TOPSOIL IN AREAS DESIGNATED FOR STRIPPING AND STOCKPILE FOR RE-USE AS REQUIRED. ANY SURPLUS MATERIAL SHALL BE REMOVED FROM SITE AND DISPOSED OF IN ACCORDANCE
- WITH EPA GUIDELINES. 9. CONSTRUCT AND MAINTAIN ALL MATERIAL STOCKPILES IN ACCORDANCE WITH DETAIL SD4-1 OF THE 'BLUE BOOK' (INCLUDING CUT-OFF SWALES TO THE HIGH SIDE AND SEDIMENT FENCES TO THE
- LOW SIDE). 10. ENSURE STOCKPILES DO NOT EXCEED 2.0m HIGH. PROVIDE WIND AND RAIN EROSION PROTECTION AS REQUIRED IN ACCORDANCE WITH THE
- 'BLUE BOOK'. 11. PROVIDE WATER TRUCKS OR SPRINKLER DEVICES DURING
- CONSTRUCTION AS REQUIRED TO SUPPRESS DUST.
- 12. ONCE CUT/FILL OPERATIONS HAVE BEEN FINALIZED ALL DISTURBED AREAS THAT ARE NOT BEING WORKED ON SHALL BE RE-VEGETATED AS SOON AS IS PRACTICAL.
- 13. THE CONTRACTOR SHALL BE RESPONSIBLE FOR KEEPING A DETAILED WRITTEN RECORD OF ALL EROSION & SEDIMENT CONTROLS ON-SITE DURING THE CONSTRUCTION PERIOD. THIS RECORD SHALL BE UPDATED ON A DAILY BASIS & SHALL CONTAIN DETAILS ON THE CONDITION OF CONTROLS AND ANY/ ALL MAINTENANCE, CLEANING & BREACHES. THIS RECORD SHALL BE KEPT ON-SITE AT ALL TIMES AND SHALL BE MADE AVAILABLE FOR INSPECTION BY THE PRINCIPAL CERTIFYING AUTHORITY AND THE SUPERINTENDENT DURING NORMAL WORKING
- 14. GROUNDWATER SEEPAGE RATES AND QUALITY TO BE MONITORED AND TREATED IF REQUIRED DURING CONSTRUCTION IN ACCORDANCE WITH REQUIREMENTS OF SUPERVISING GEOTECHNICAL ENGINEER.



NOT FOR CONSTRUCTION

FLOWER POWER 277 MONA VALE ROAD, **TERREY HILLS NSW SPECIFICATION NOTES**

CIVIL ENGINEERING PACKAGE

211979 DRAWING NUMBER

DRAWING SHEET SIZE = A1

| REVISION | DESCRIPTION | ISSUED | VER'D | APP'D | DATE | CLIENT |
|----------|------------------------|--------|-------|-------|----------|--------|
| 01 | ISSUED FOR INFORMATION | MM | | AC | 23.05.23 | |
| 02 | ISSUED FOR INFORMATION | MM | | AC | 15.06.23 | |
| | | | | | | |
| | | | | | | |
| | | | | | | |




DRAWING NOT TO BE USED FOR CONSTRUCTION UNLESS VERIFICATION

ARCHITECT


LEFFLER SIMES ARCHITECTS

THE COPYRIGHT OF THIS DRAWING REMAINS WITH NORTHROP

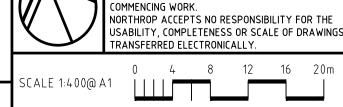


DIMENSIONS TO BE VERIFIED WITH THE ARCHITECT


AND ON SITE BEFORE MAKING SHOP DRAWINGS OF

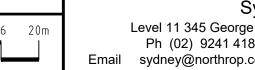





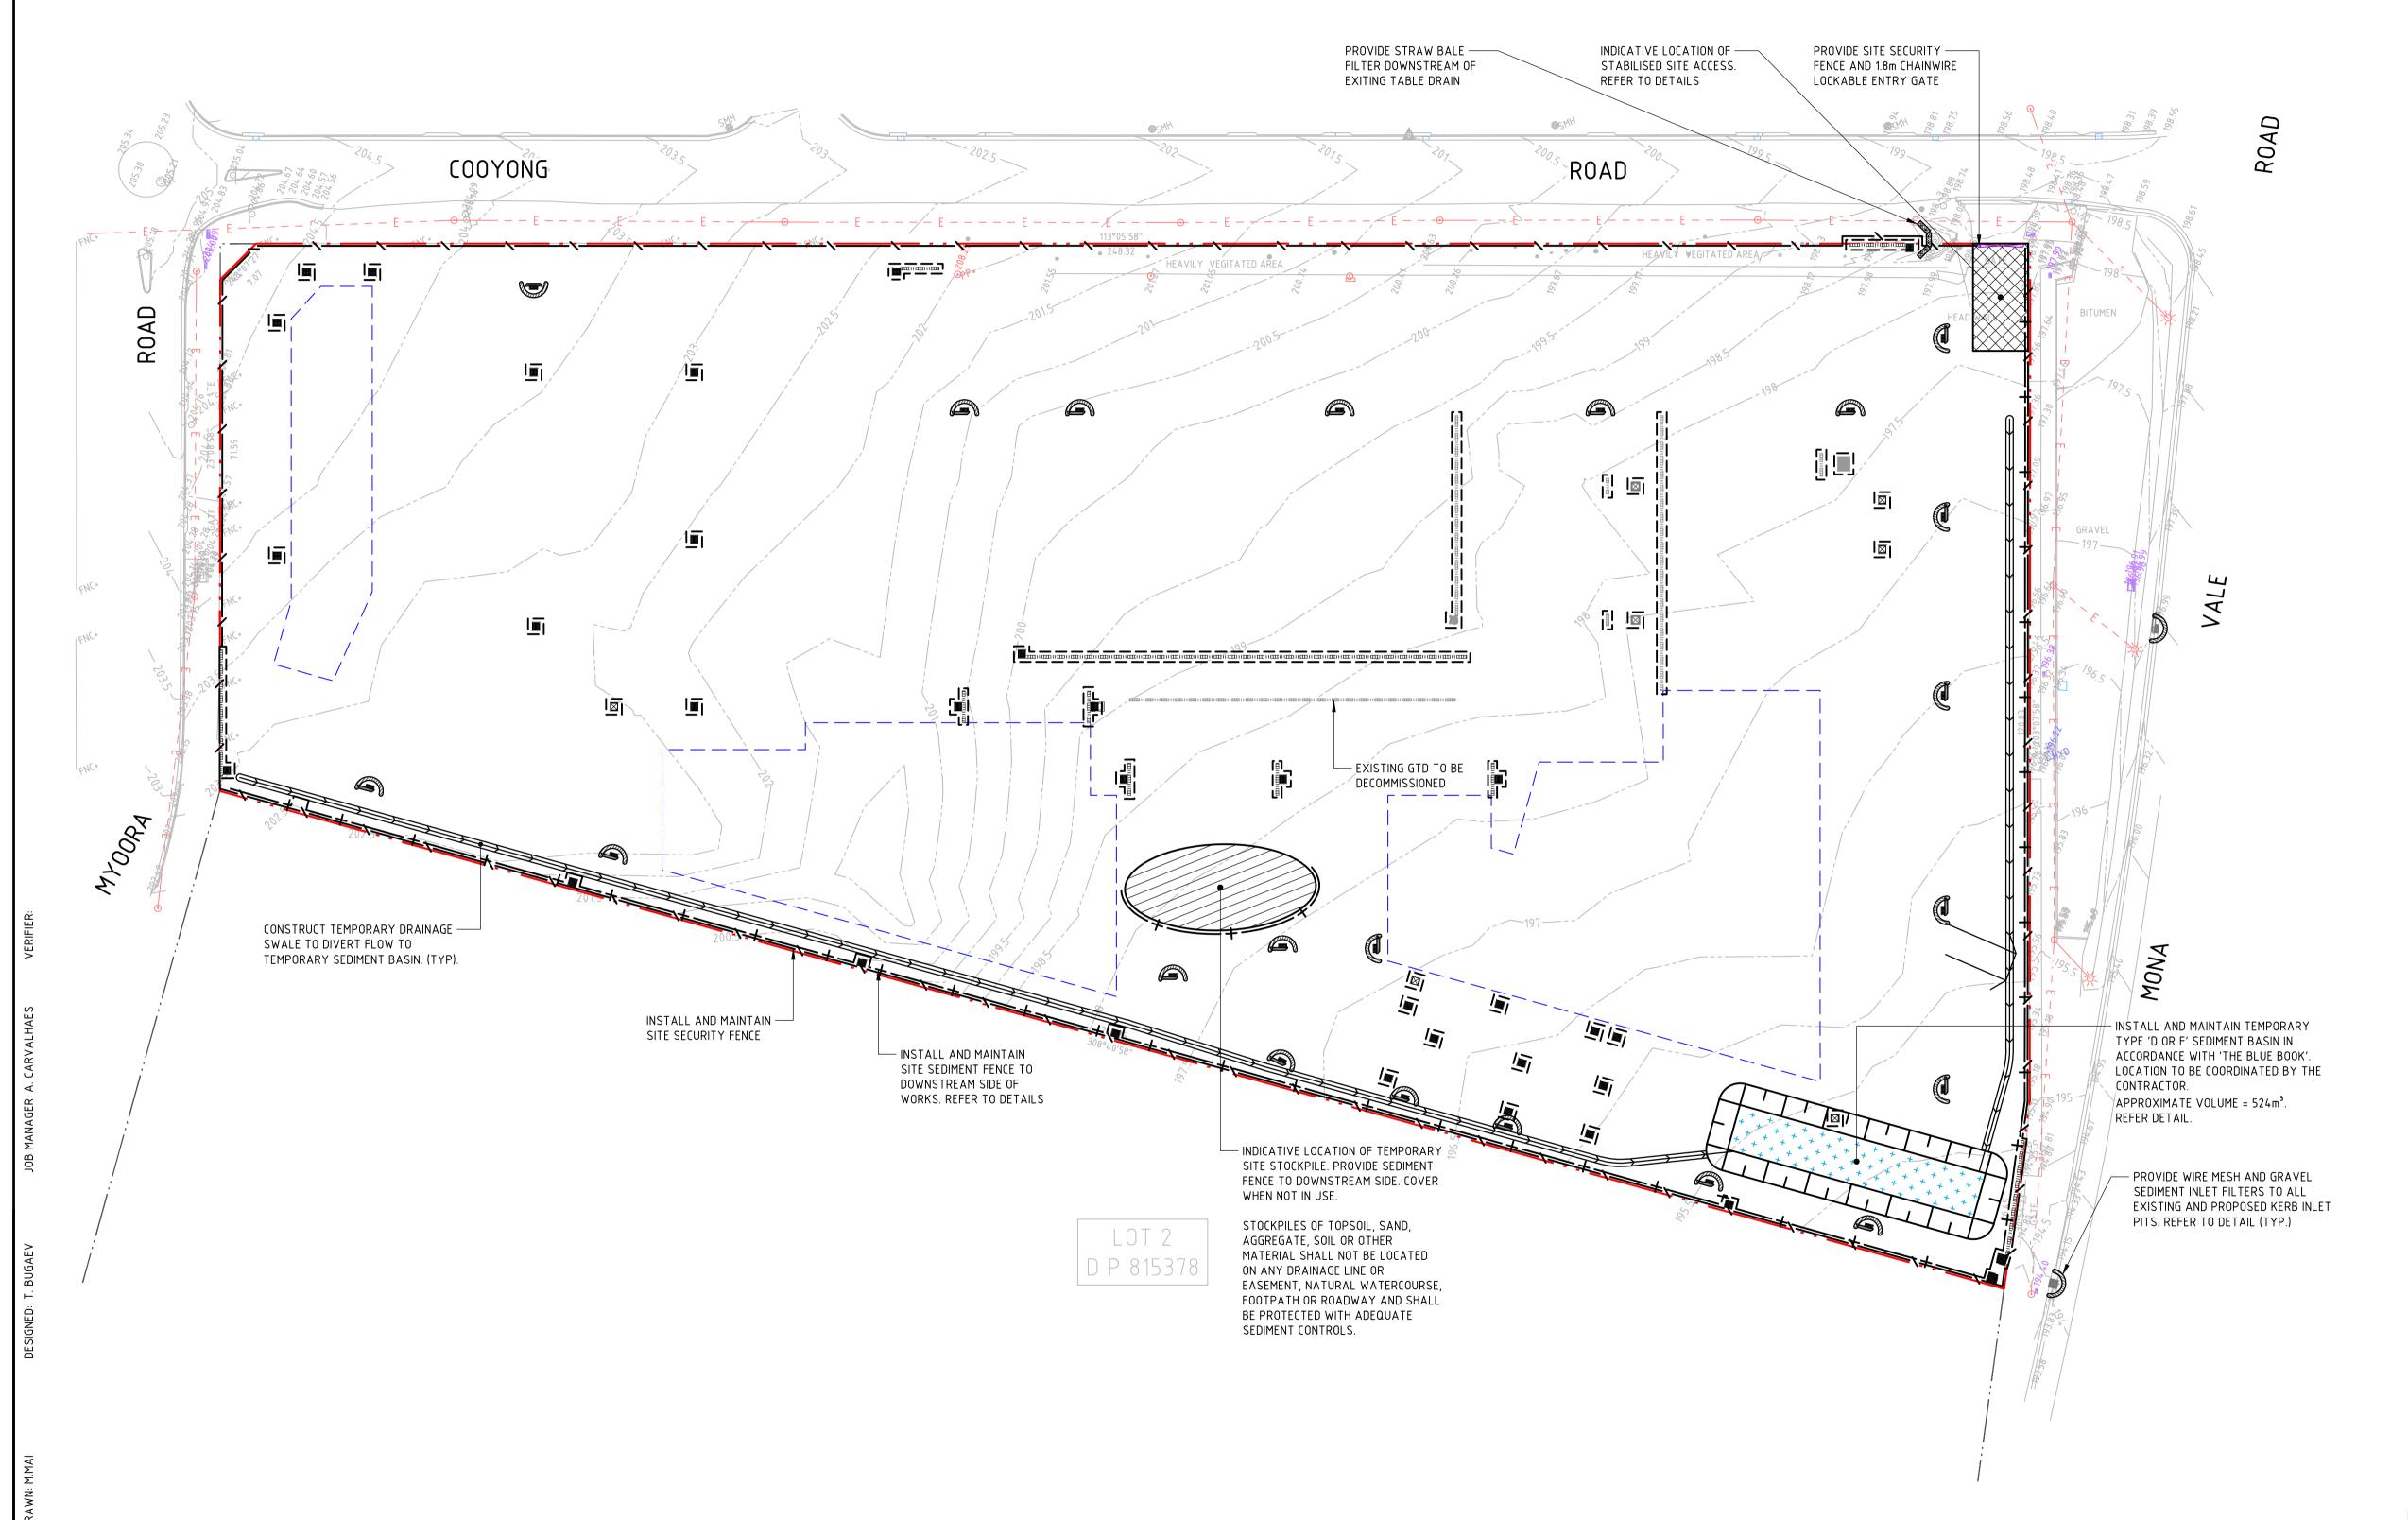

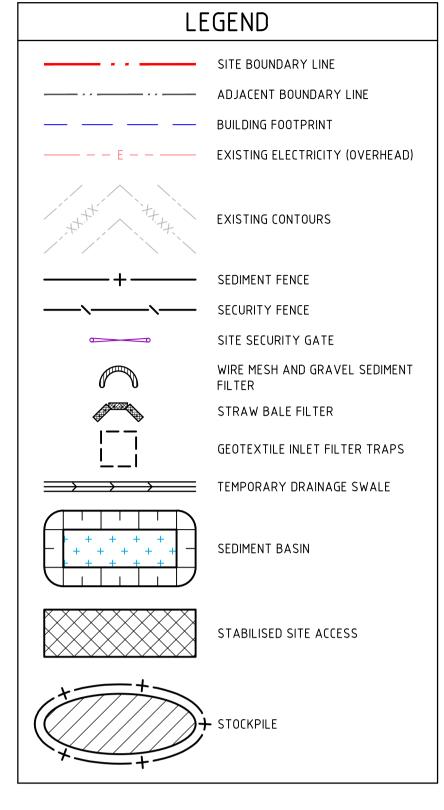

GENERAL NOTES

- ALL WORKS TO BE CARRIED OUT IN ACCORDANCE WITH COUNCIL / RELEVANT AUTHORITY SPECIFICATIONS AND
- 2. ALL SEDIMENT AND SOIL EROSION CONTROL MEASURES TO BE INSTALLED IN ACCORDANCE WITH THE 'BLUE BOOK'. CONTRACTOR TO ENSURE THESE MEASURES ARE IN PLACE AND MAINTAINED AT ALL TIMES DURING CONSTRUCTION
- CONTRACTOR TO PROVIDE 'WIRE MESH AND GRAVEL SEDIMENT FILTER' TO ALL PAVED / ROAD AREAS (BOTH PROPOSED AND EXISTING) IN ACCORDANCE WITH THE 'BLUE
- 4. CONTRACTOR TO PROVIDE 'GEOTEXTILE INLET FILTER TRAPS' TO ALL STORMWATER DRAINAGE INLETS (BOTH PROPOSED AND EXISTING) IN ACCORDANCE WITH THE 'BLUE BOOK'

| SEDIMENT BASIN CALCULATIONS | | | |
|------------------------------------|---------------|--|--|
| PARAMETER | ADOPTED VALUE | | |
| TOTAL DISTURBED AREA (ha) | 2.3644 | | |
| SOIL TEXTURE GROUP | D OR F | | |
| DESIGN RAINFALL DEPTH (DAYS) | 5 | | |
| DESIGN RAINFALL DEPTH (PERCENTILE) | 80% | | |
| x-DAY, y-PERCENTILE RAINFALL EVENT | 35.2 | | |
| Cv | 0.42 | | |
| SETTLING ZONE VOLUME (m³) | 349.550 | | |
| SEDIMENT STORAGE VOLUME (m³) | 174.775 | | |
| TOTAL BASIN VOLUME REQUIRED (m³) | 524.325 | | |


NOT FOR CONSTRUCTION

| 01 | ISSUED FOR INFORMATION | MM | AC | 23.05.23 |
|----|------------------------|----|----|----------|
| 02 | ISSUED FOR INFORMATION | MM | AC | 15.06.23 |
| | | | | |
| | | | | |
| | | | | |
| | | | | |

DESCRIPTION



ARCHITECT LEFFLER SIMES ARCHITECTS

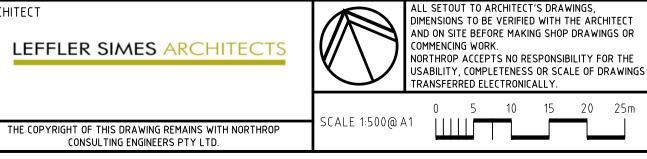



Level 11 345 George Street, Sydney NSW 2000 Ph (02) 9241 4188 Fax (02) 9241 4324 Email sydney@northrop.com.au ABN 81 094 433 100

FLOWER POWER 277 MONA VALE ROAD, **TERREY HILLS NSW**

CIVIL ENGINEERING PACKAGE

SEDIMENT AND SOIL EROSION CONTROL PLAN


| JOB NUMBER | | |
|----------------|------|--|
| 211979 | | |
| DRAWING NUMBER | REVI | |

DRAWING SHEET SIZE = A1

CONSTRUCTION NOTES


- 1. THE TEMPORARY ACCESS SHALL BE MAINTAINED IN A CONDITION THAT PREVENTS TRACKING OR FLOWING OF
- SEDIMENT ONTO PUBLIC RIGHTS OF WAY, • THIS MAY REQUIRE PERIODIC TOP DRESSING WITH ADDITIONAL GRAVEL AS CONDITIONS DEMAND AND REPAIR AND/OR CLEANOUT OF ANY MEASURES USED TO TRAP SEDIMENT,
- 2. ALL SEDIMENT SPILLED, DROPPED, WASHED OR TRACKED ONTO PUBLIC RIGHTS OF WAY MUST BE REMOVED IMMEDIATELY.
- 3. INSTALL BARRIER ON EITHER SIDE OF SHAKER PAD. TO ENSURE VEHICLES ARE GUIDED ON TO THE PAD.
- 4. INVERT OF SHAKER PAD TO BE DRAINED VIA AGRICULTURAL PIPE WRAPPED IN GEOTEXTILE FABRIC.

STABILISED SITE ACCESS

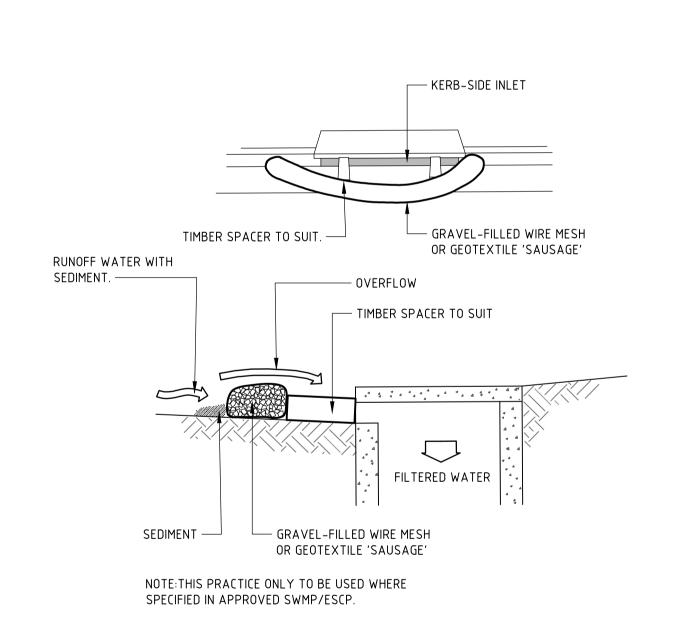

CONSTRUCTION NOTES


- 1. INSTALL FILTERS TO KERB INLETS ONLY AT SAG POINTS.
- 2. FABRICATE A SLEEVE MADE FROM GEOTEXTILE OR WIRE MESH LONGER THAN THE LENGTH OF THE INLET PIT
- AND FILL IT WITH 25mm TO 50mm GRAVEL.
- 3. FORM AN ELLIPTICAL CROSS-SECTION ABOUT 150mm HIGH x 400mm WIDE.
- 4. PLACE THE FILTER AT THE OPENING LEAVING AT LEAST A 100mm SPACE BETWEEN IT AND THE KERB INLET. MAINTAIN THE OPENING WITH SPACER BLOCKS.
- FORM A SEAL WITH THE KERB TO PREVENT SEDIMENT BYPASSING THE FILTER.
- 6. SANDBAGS FILLED WITH GRAVEL CAN SUBSTITUTE FOR THE MESH OR GEOTEXTILE PROVIDING THEY ARE PLACED SO THAT THEY FIRMLY ABUT EACH OTHER AND SEDIMENT-LADEN WATERS CANNOT PASS BETWEEN.
 - WIRE MESH AND GRAVEL SEDIMENT FILTER

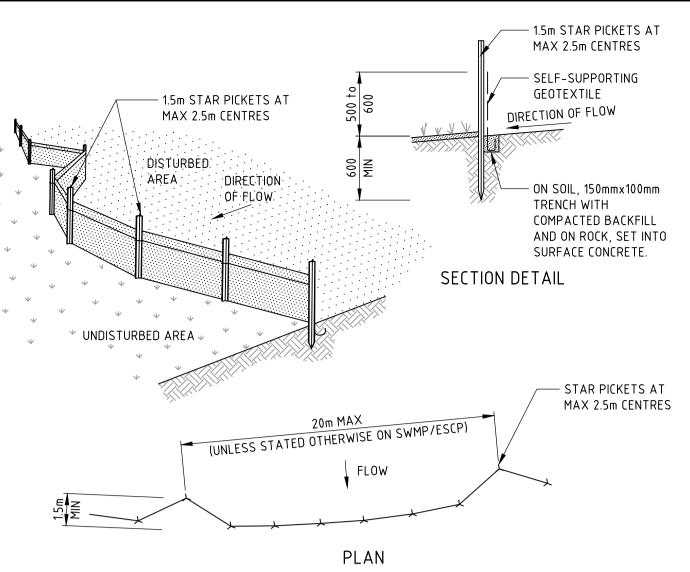

CONSTRUCTION NOTES

- CONSTRUCT SEDIMENT FENCES AS CLOSE AS POSSIBLE TO BEING PARALLEL TO THE CONTOURS OF THE SITE. BUT WITH SMALL RETURNS AS SHOWN IN THE DRAWING TO LIMIT THE CATCHMENT AREA OF ANY ONE SECTION. THE CATCHMENT AREA SHOULD BE SMALL ENOUGH TO LIMIT WATER FLOW IF CONCENTRATED AT ONE POINT TO 50 LITRES PER SECOND IN THE DESIGN STORM EVENT, USUALLY THE 10-YEAR EVENT.
- 2. CUT A 150mm DEEP TRENCH ALONG THE UPSLOPE LINE OF THE FENCE FOR THE BOTTOM OF THE FABRIC TO BE ENTRENCHED.
- 3. DRIVE 1.5 METRE LONG STAR PICKETS INTO GROUND AT 2.5 METRE INTERVALS (MAX) AT THE DOWNSLOPE EDGE OF THE TRENCH. ENSURE ANY STAR PICKETS ARE FITTED WITH SAFETY CAPS.
- 4. FIX SELF-SUPPORTING GEOTEXTILE TO THE UPSLOPE SIDE OF THE POSTS ENSURING IT GOES TO THE BASE OF THE TRENCH. FIX THE GEOTEXTILE WITH WIRE TIES OR AS RECOMMENDED BY THE MANUFACTURER. ONLY USE GEOTEXTILE SPECIFICALLY PRODUCED FOR SEDIMENT FENCING. THE USE OF SHADE CLOTH FOR THIS PURPOSE IS NOT SATISFACTORY.
- 5. JOIN SECTIONS OF FABRIC AT A SUPPORT POST WITH A 150mm OVERLAP.
- 6. BACKFILL THE TRENCH OVER THE BASE OF THE FABRIC AND COMPACT IT THOROUGHLY OVER THE GEOTEXTILE.


SEDIMENT FENCE

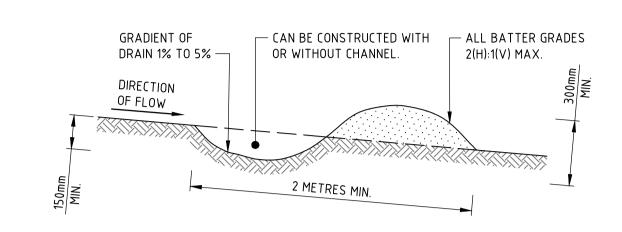


CONSTRUCTION NOTES


- BUILD WITH GRADIENTS BETWEEN 1 AND 5 PERCENT.
- 2. AVOID REMOVING TREES AND SHRUBS IF POSSIBLE WORK AROUND THEM.
- 3. ENSURE THE STRUCTURES ARE FREE OF PROJECTIONS OR OTHER IRREGULARITIES THAT COULD IMPEDE WATER FLOW.
- 4. BUILD THE DRAINS WITH CIRCULAR, PARABOLIC OR TRAPEZOIDAL CROSS SECTIONS, NOT V SHAPED.
- 5. ENSURE THE BANKS ARE PROPERLY COMPACTED TO PREVENT FAILURE.
- 6. COMPLETE PERMANENT OR TEMPORARY STABILISATION WITHIN 10 DAYS OF CONSTRUCTION.

NOTE: ONLY TO BE USED AS TEMPORARY BANK WHERE MAXIMUM UPSLOPE LENGTH IS 80 METRES. TEMPORARY DRAINAGE SWALE

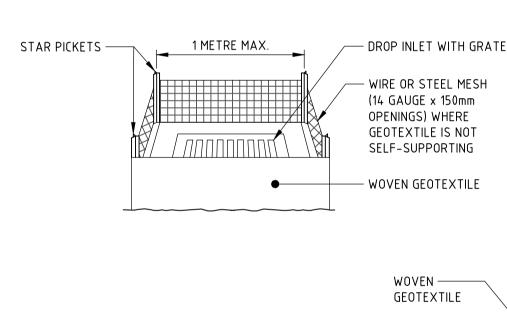



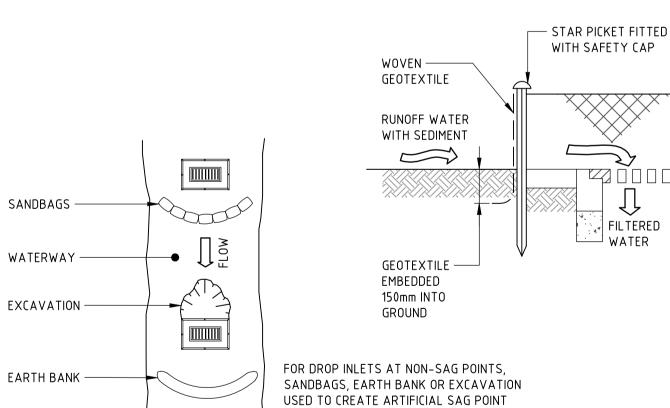

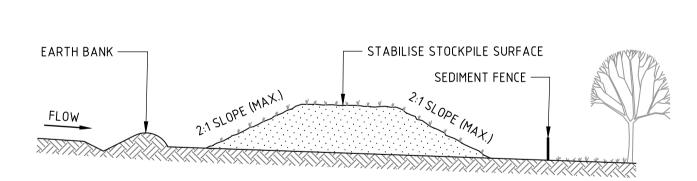

CONSTRUCTION NOTES

1. FABRICATE A SEDIMENT BARRIER MADE FROM GEOTEXTILE OR STRAW BALES.

ARCHITECT


- 2. FOLLOW STANDARD DRAWING 6-7 AND STANDARD DRAWING 6-8 FOR INSTALLATION PROCEDURES FOR THE STRAW BALES OR GEOFABRIC. REDUCE THE PICKET SPACING TO 1 METRE CENTRES.
- 3. IN WATERWAYS, ARTIFICIAL SAG POINTS CAN BE CREATED WITH SANDBAGS OR EARTH BANKS AS SHOWN IN
- THE DRAWING.
- 4. DO NOT COVER THE INLET WITH GEOTEXTILE UNLESS THE DESIGN IS ADEQUATE TO ALLOW FOR ALL WATERS TO BYPASS IT.

GEOTEXTILE INLET FILTER TRAPS

CONSTRUCTION NOTES

- 1. PLACE STOCKPILES MORE THAN 2m (PREFERABLY 5m) FROM EXISTING VEGETATION, CONCENTRATED WATER
- FLOW, ROADS AND HAZARD AREAS.
- 2. CONSTRUCT ON THE CONTOUR AS LOW, FLAT, ELONGATED MOUNDS. 3. WHERE THERE IS SUFFICIENT AREA, TOPSOIL STOCKPILES SHALL BE LESS THAN 2m IN HEIGHT.
- 4. WHERE THEY ARE TO BE IN PLACE FOR MORE THAN 10 DAYS, STABILISE FOLLOWING THE APPROVED ESCP OR SWMP TO REDUCE THE C-FACTOR TO LESS THAN 0.10.
- 5. CONSTRUCT EARTH BANKS (STANDARD DRAWING 5-5) ON THE UPSLOPE SIDE TO DIVERT WATER AROUND STOCKPILES AND SEDIMENT FENCES (STANDARD DRAWING 6-8) 1 TO 2m DOWNSLOPE.

STOCKPILE

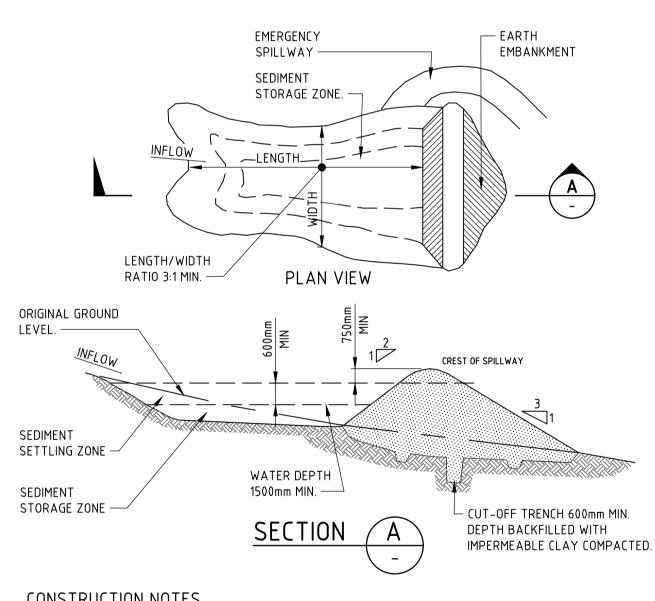

CONSTRUCTION NOTES

- 1. REMOVE ALL VEGETATION AND TOPSOIL FROM UNDER THE DAM WALL AND FROM WITHIN THE STORAGE AREA. 2. CONSTRUCT A CUT-OFF TRENCH 500mm DEEP AND 1200mm WIDE ALONG THE CENTRELINE OF THE EMBANKMENT
- EXTENDING TO A POINT ON THE GULLY WALL LEVEL WITH THE RISER CREST.
- MAINTAIN THE TRENCH FREE OF WATER AND RECOMPACT THE MATERIALS WITH EQUIPMENT AS SPECIFIED IN THE SWMP TO 95 PER CENT STANDARD PROCTOR DENSITY.
- 4. SELECT FILL FOLLOWING THE SWMP THAT IS FREE OF ROOTS, WOOD, ROCK, LARGE STONE OR FOREIGN MATERIAL.
- 5. PREPARE THE SITE UNDER THE EMBANKMENT BY RIPPING TO AT LEAST 100mm TO HELP BOND COMPACTED FILL TO THE EXISTING SUBSTRATE.
- 6. SPREAD THE FILL IN 100mm TO 150mm LAYERS AND COMPACT IT AT OPTIMUM MOISTURE CONTENT FOLLOWING THE
- CONSTRUCT THE EMERGENCY SPILLWAY.
- 8. REHABILITATE THE STRUCTURE FOLLOWING THE SWMP.

(APPLIES TO 'TYPE D' AND 'TYPE F' SOILS ONLY) SEDIMENT BASIN

NOT FOR CONSTRUCTION

DESCRIPTION ISSUED FOR INFORMATION 23.05.23 ISSUED FOR INFORMATION AC 15.06.23

flower

SIGNATURE HAS BEEN ADDED

LEFFLER SIMES ARCHITECTS

LL SETOUT TO ARCHITECT'S DRAWINGS, DIMENSIONS TO BE VERIFIED WITH THE ARCHITECT AND ON SITE BEFORE MAKING SHOP DRAWINGS OF COMMENCING WORK. NORTHROP ACCEPTS NO RESPONSIBILITY FOR THE USABILITY, COMPLETENESS OR SCALE OF DRAWINGS TRANSFERRED ELECTRONICALLY.

Level 11 345 George Street, Sydney NSW 2000

Ph (02) 9241 4188 Fax (02) 9241 4324

FLOWER POWER 277 MONA VALE ROAD, **TERREY HILLS NSW**

CIVIL ENGINEERING PACKAGE

SEDIMENT AND SOIL EROSION **CONTROL DETAILS**

211979


DRAWING NUMBER


DRAWING SHEET SIZE = A1


DRAWING NOT TO BE USED FOR CONSTRUCTION UNLESS VERIFICATION THE COPYRIGHT OF THIS DRAWING REMAINS WITH NORTHROP

CONSULTING ENGINEERS PTY LTD.

NOT TO SCALE Email sydney@northrop.com.au ABN 81 094 433 100

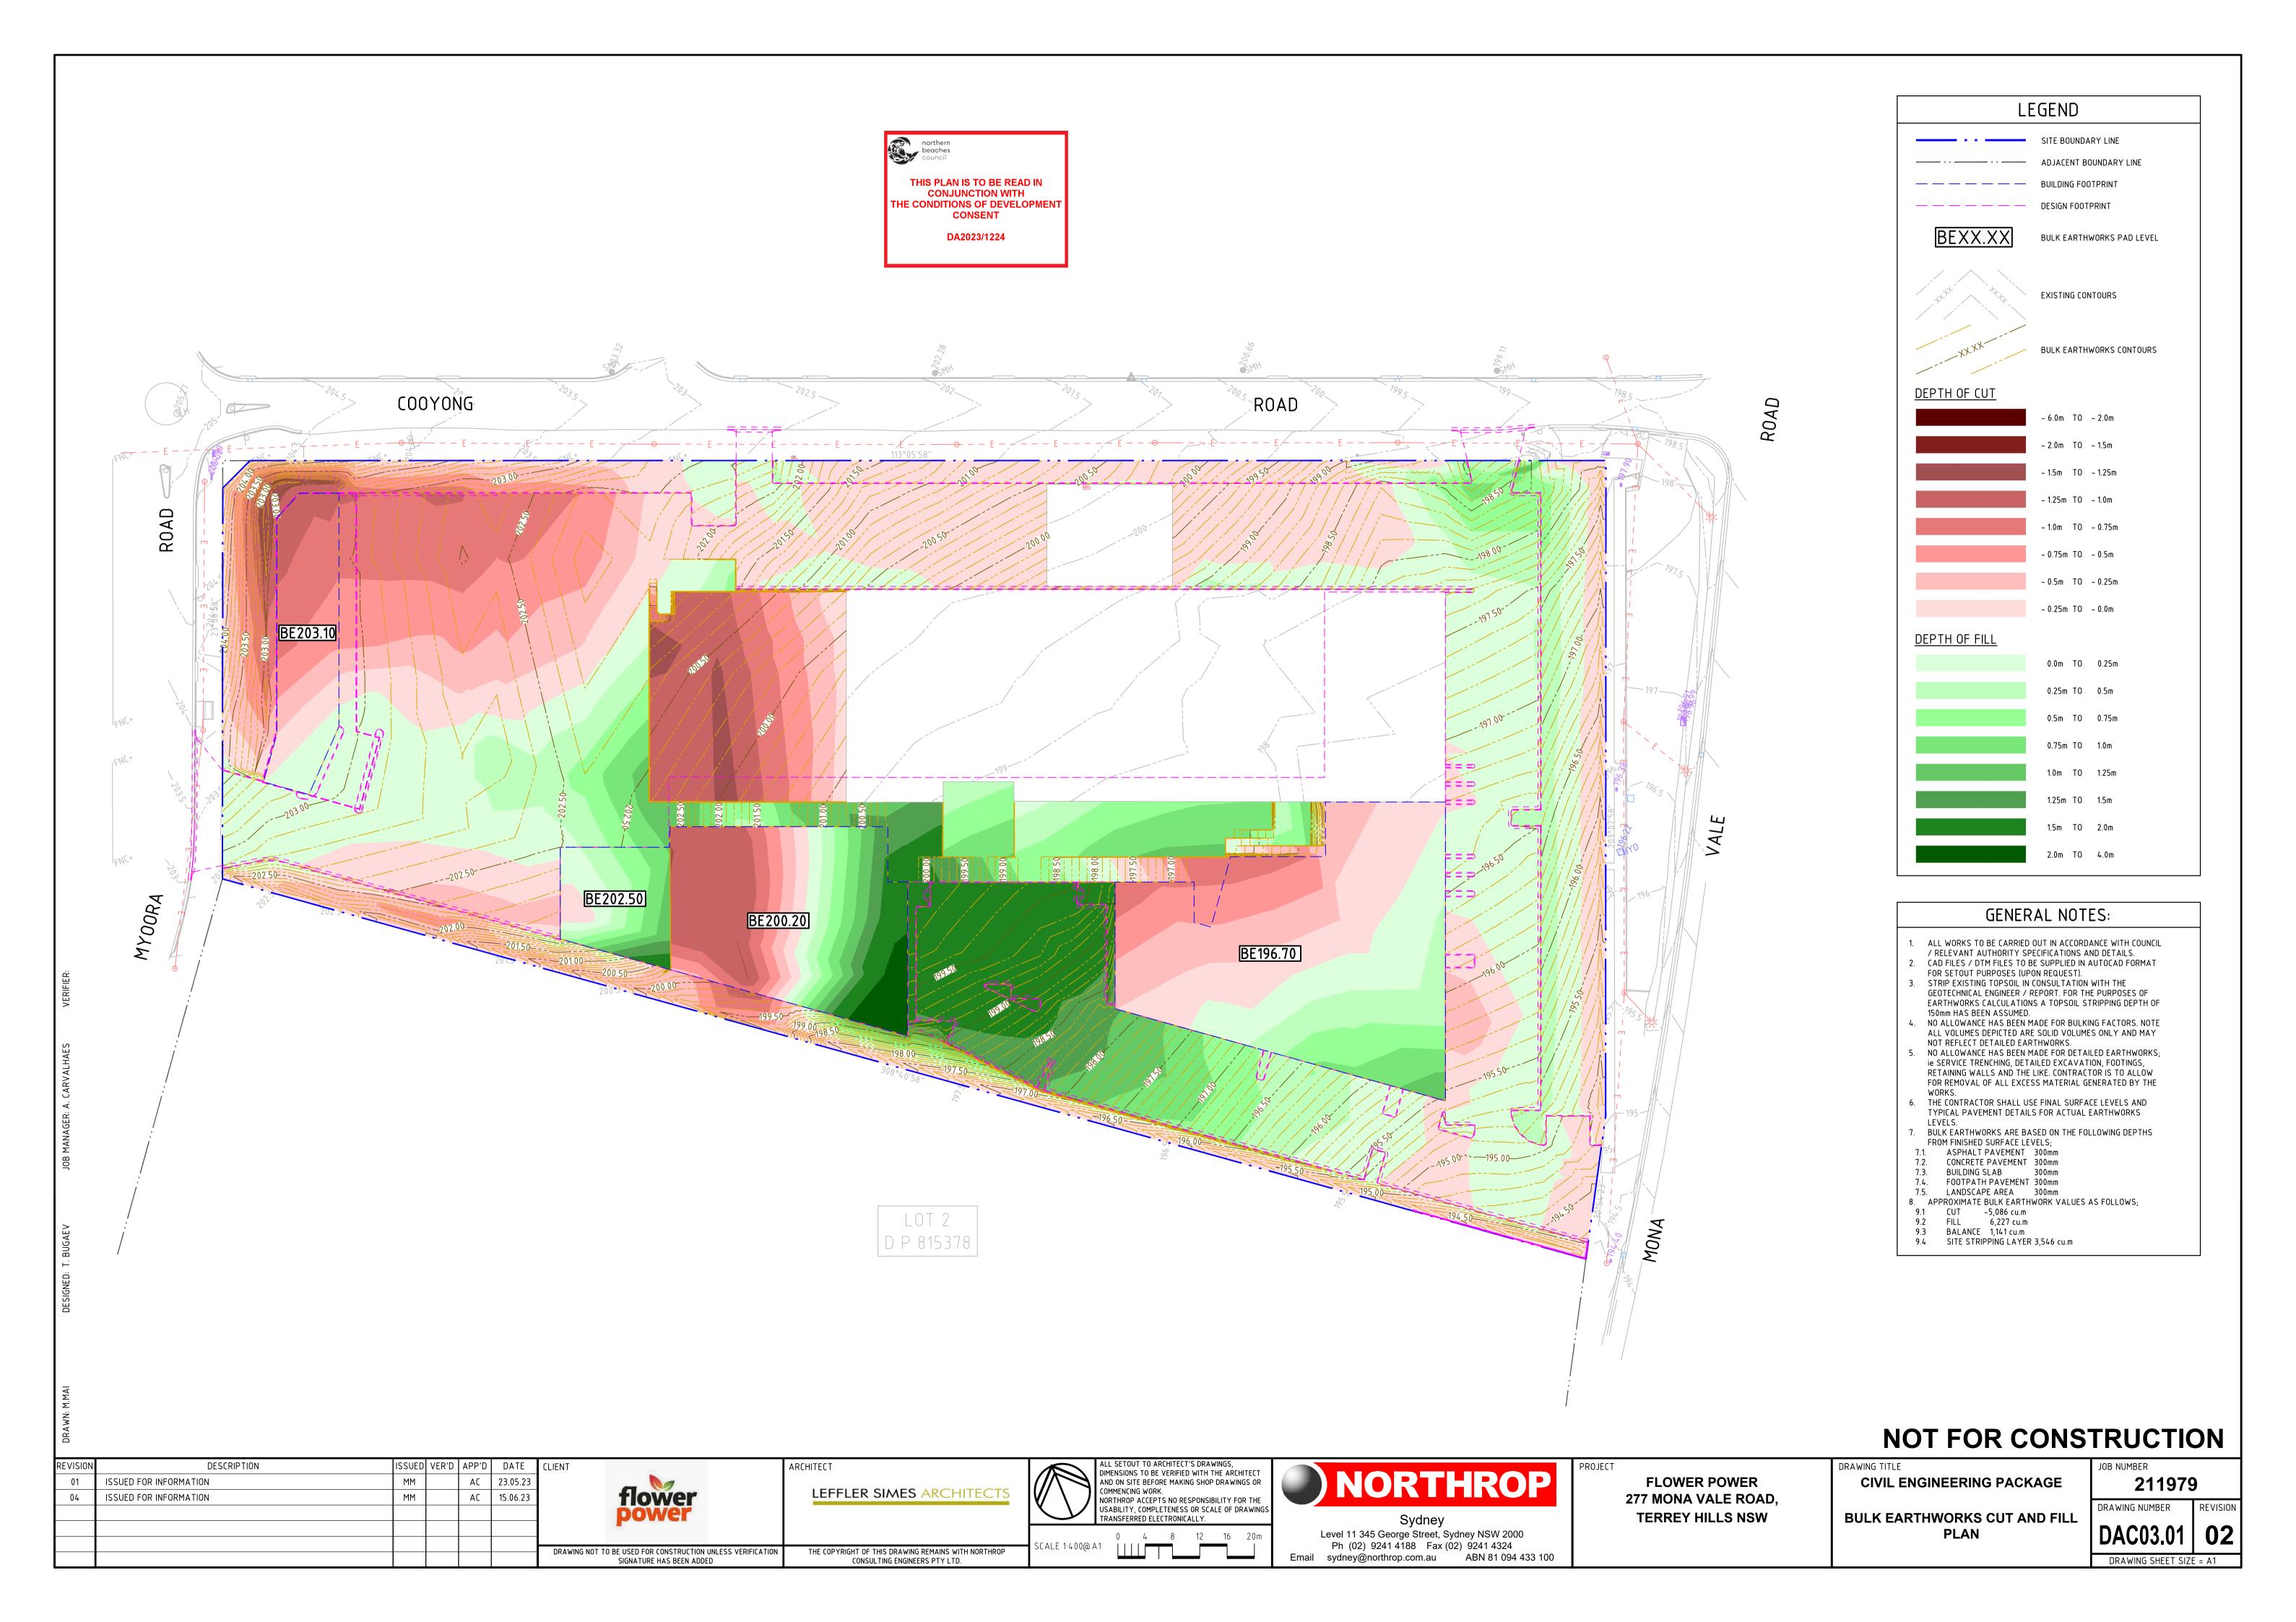

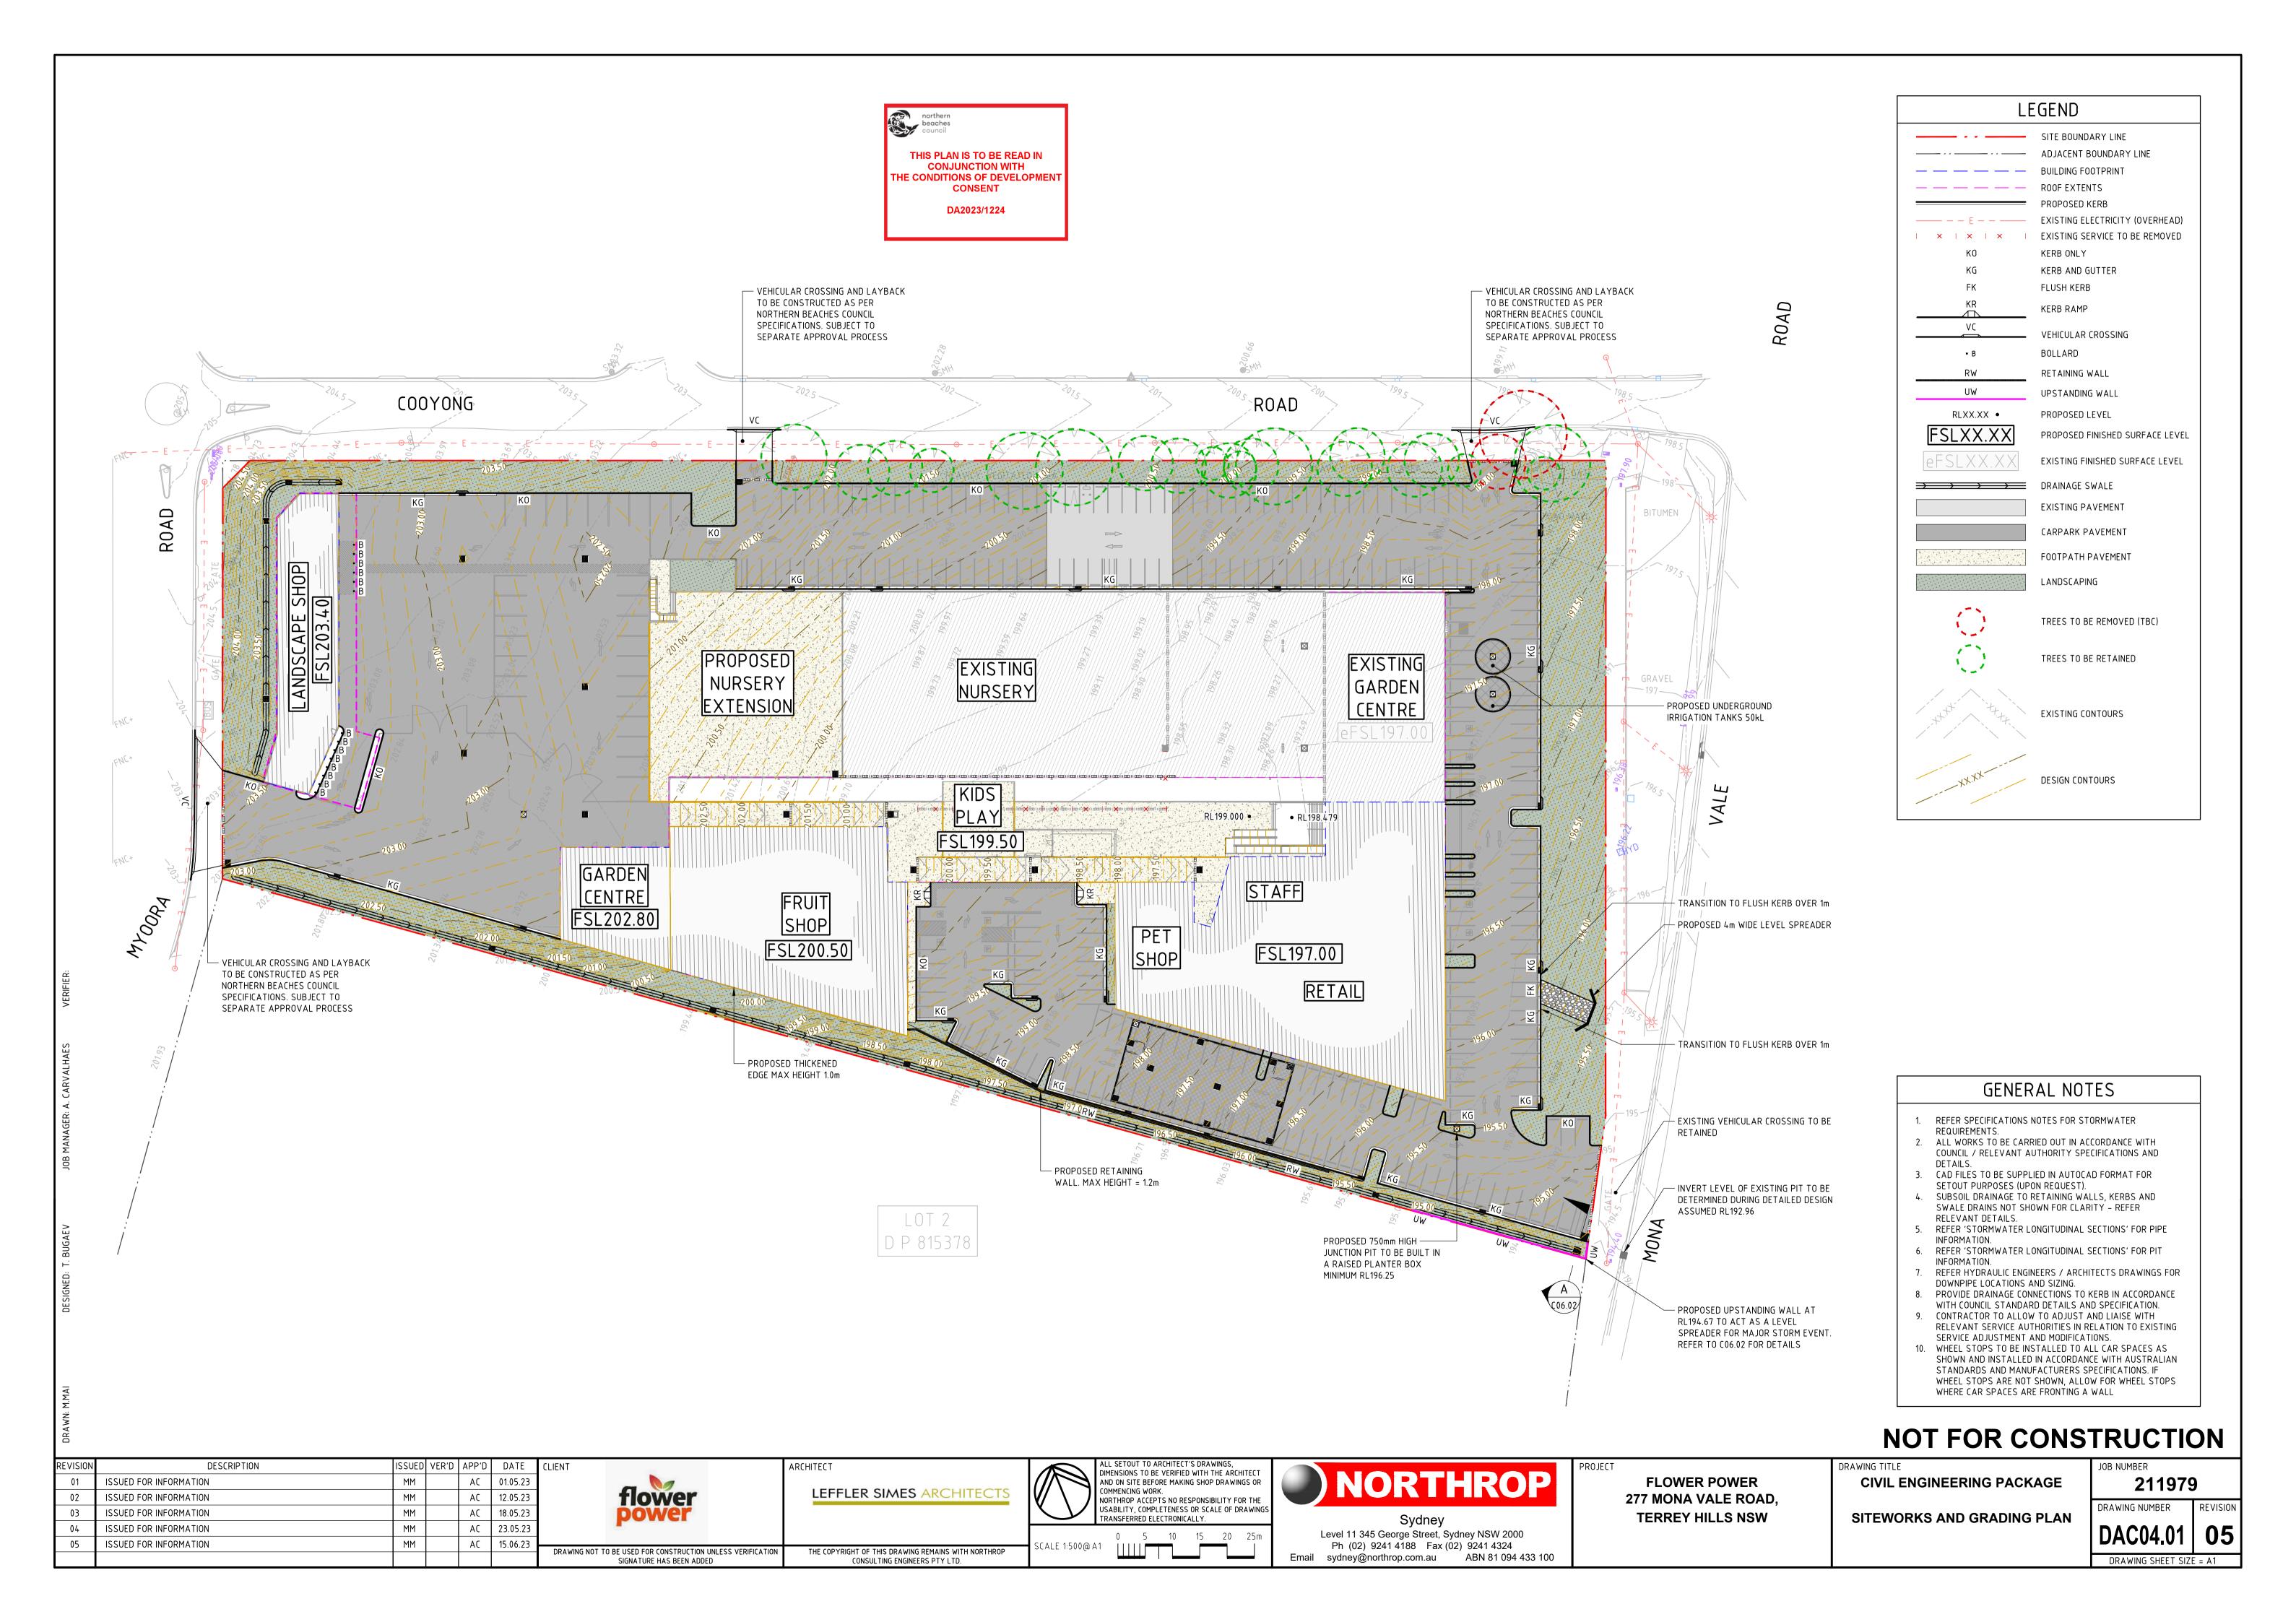

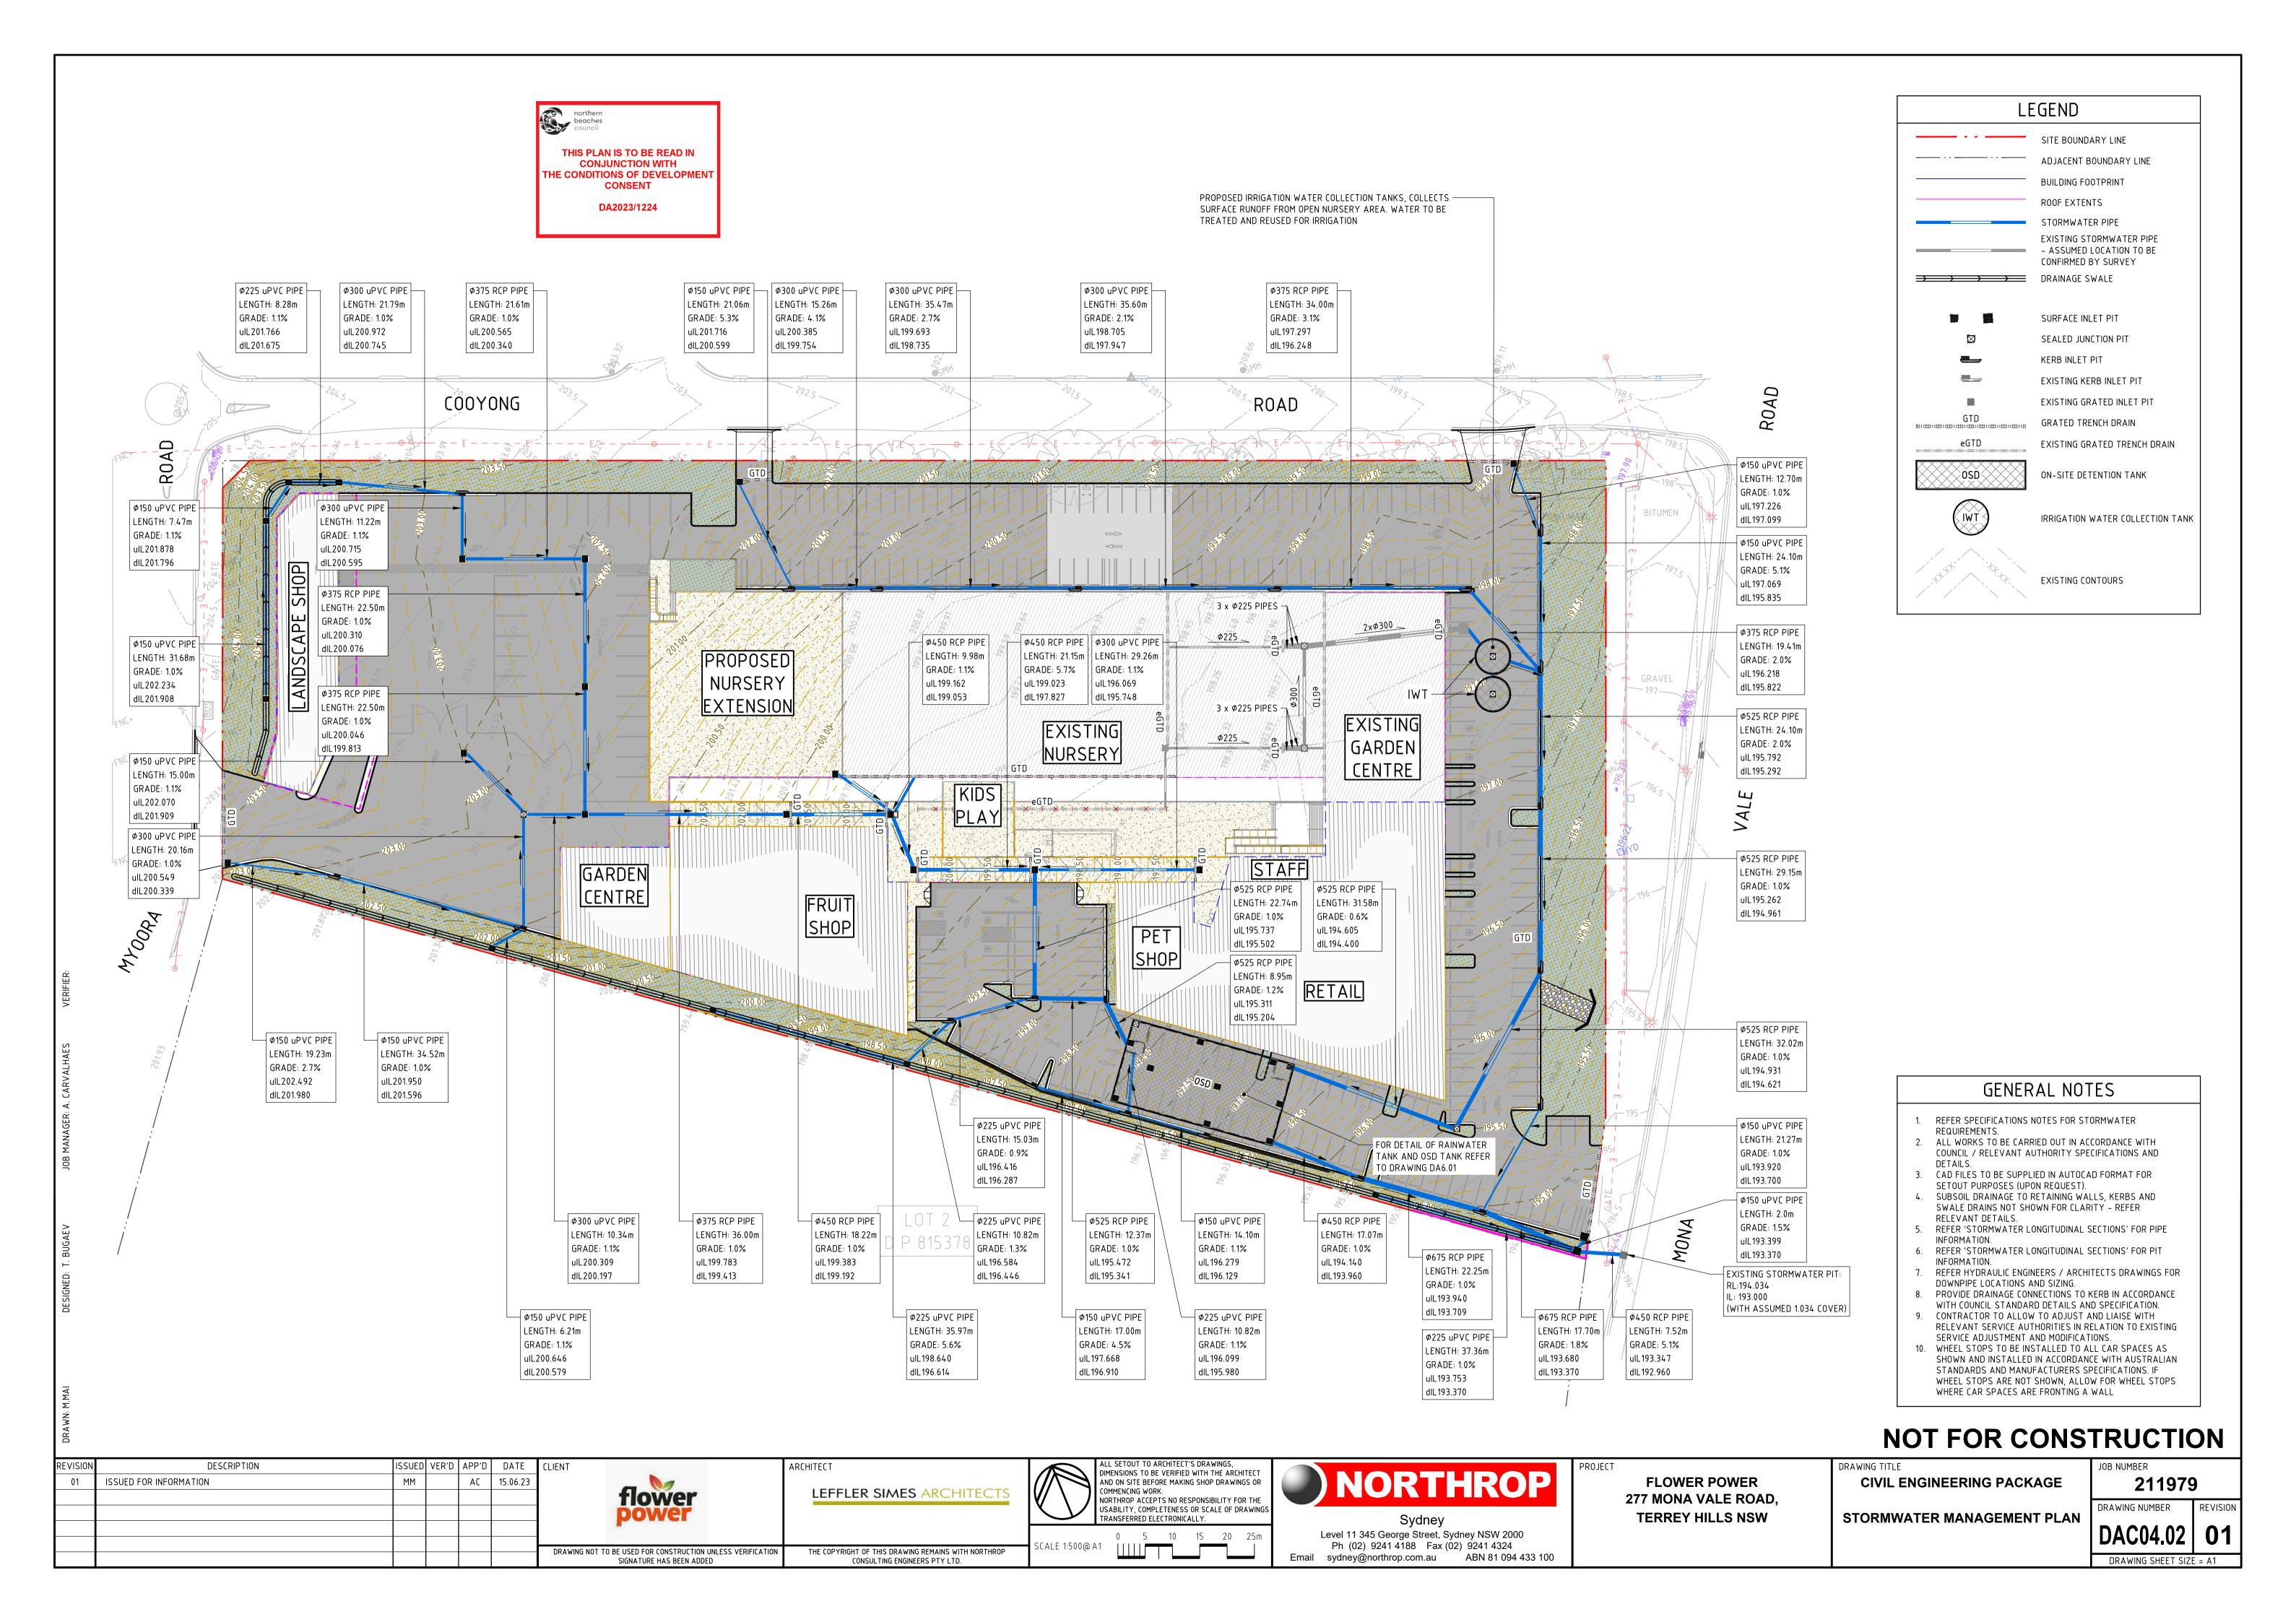





ALL SETOUT TO ARCHITECT'S DRAWINGS, DIMENSIONS TO BE VERIFIED WITH THE ARCHITECT

AND ON SITE BEFORE MAKING SHOP DRAWINGS OR

NOT FOR CONSTRUCTION

COMMENCING WORK. NORTHROP ACCEPTS NO RESPONSIBILITY FOR THE USABILITY, COMPLETENESS OR SCALE OF DRAWINGS TRANSFERRED ELECTRONICALLY. Level 11 345 George Street, Sydney NSW 2000 Ph (02) 9241 4188 Fax (02) 9241 4324 Email sydney@northrop.com.au ABN 81 094 433 100 DRAWING NOT TO BE USED FOR CONSTRUCTION UNLESS VERIFICATION SIGNATURE HAS BEEN ADDED THE COPYRIGHT OF THIS DRAWING REMAINS WITH NORTHROP CONSULTING ENGINEERS PTY LTD. SCALE 1:100 @ A1

NORTHROP

FLOWER POWER 277 MONA VALE ROAD, **TERREY HILLS NSW**


DRAWING TITLE CIVIL ENGINEERING PACKAGE


STORMWATER LONGITUDINAL


SECTIONS - SHEET 01

211979

DRAWING NUMBER DRAWING SHEET SIZE = A1

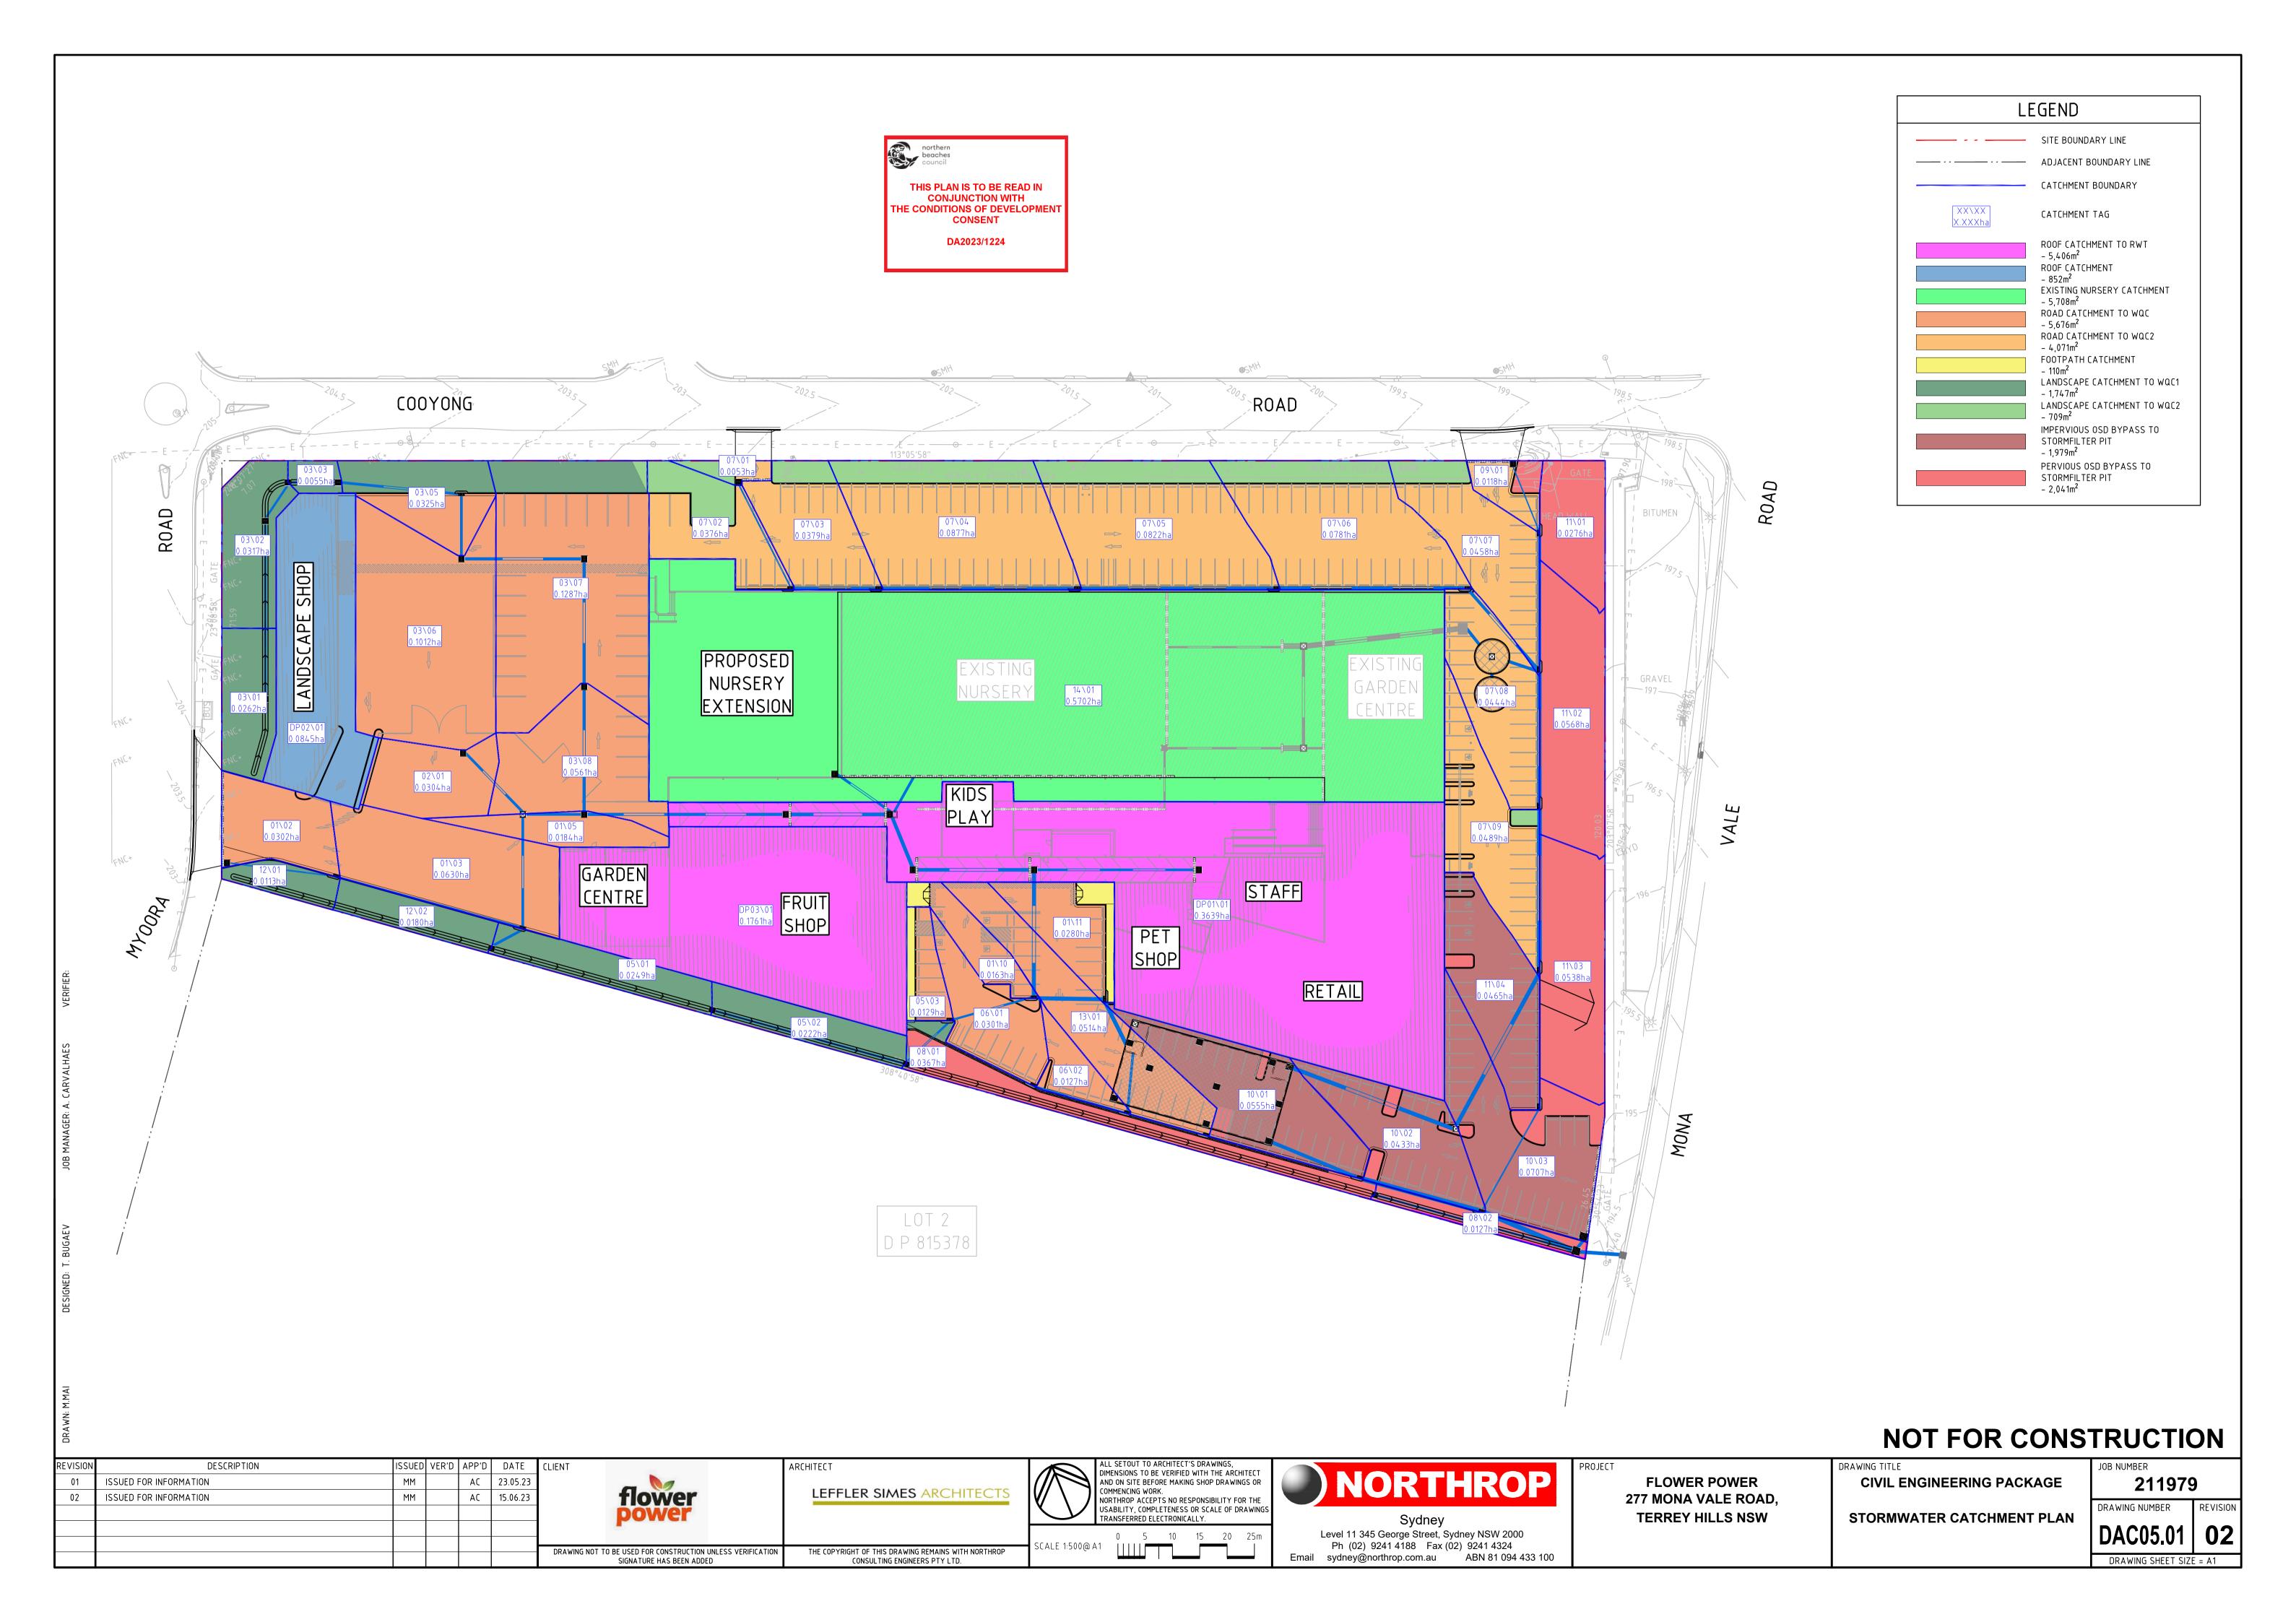

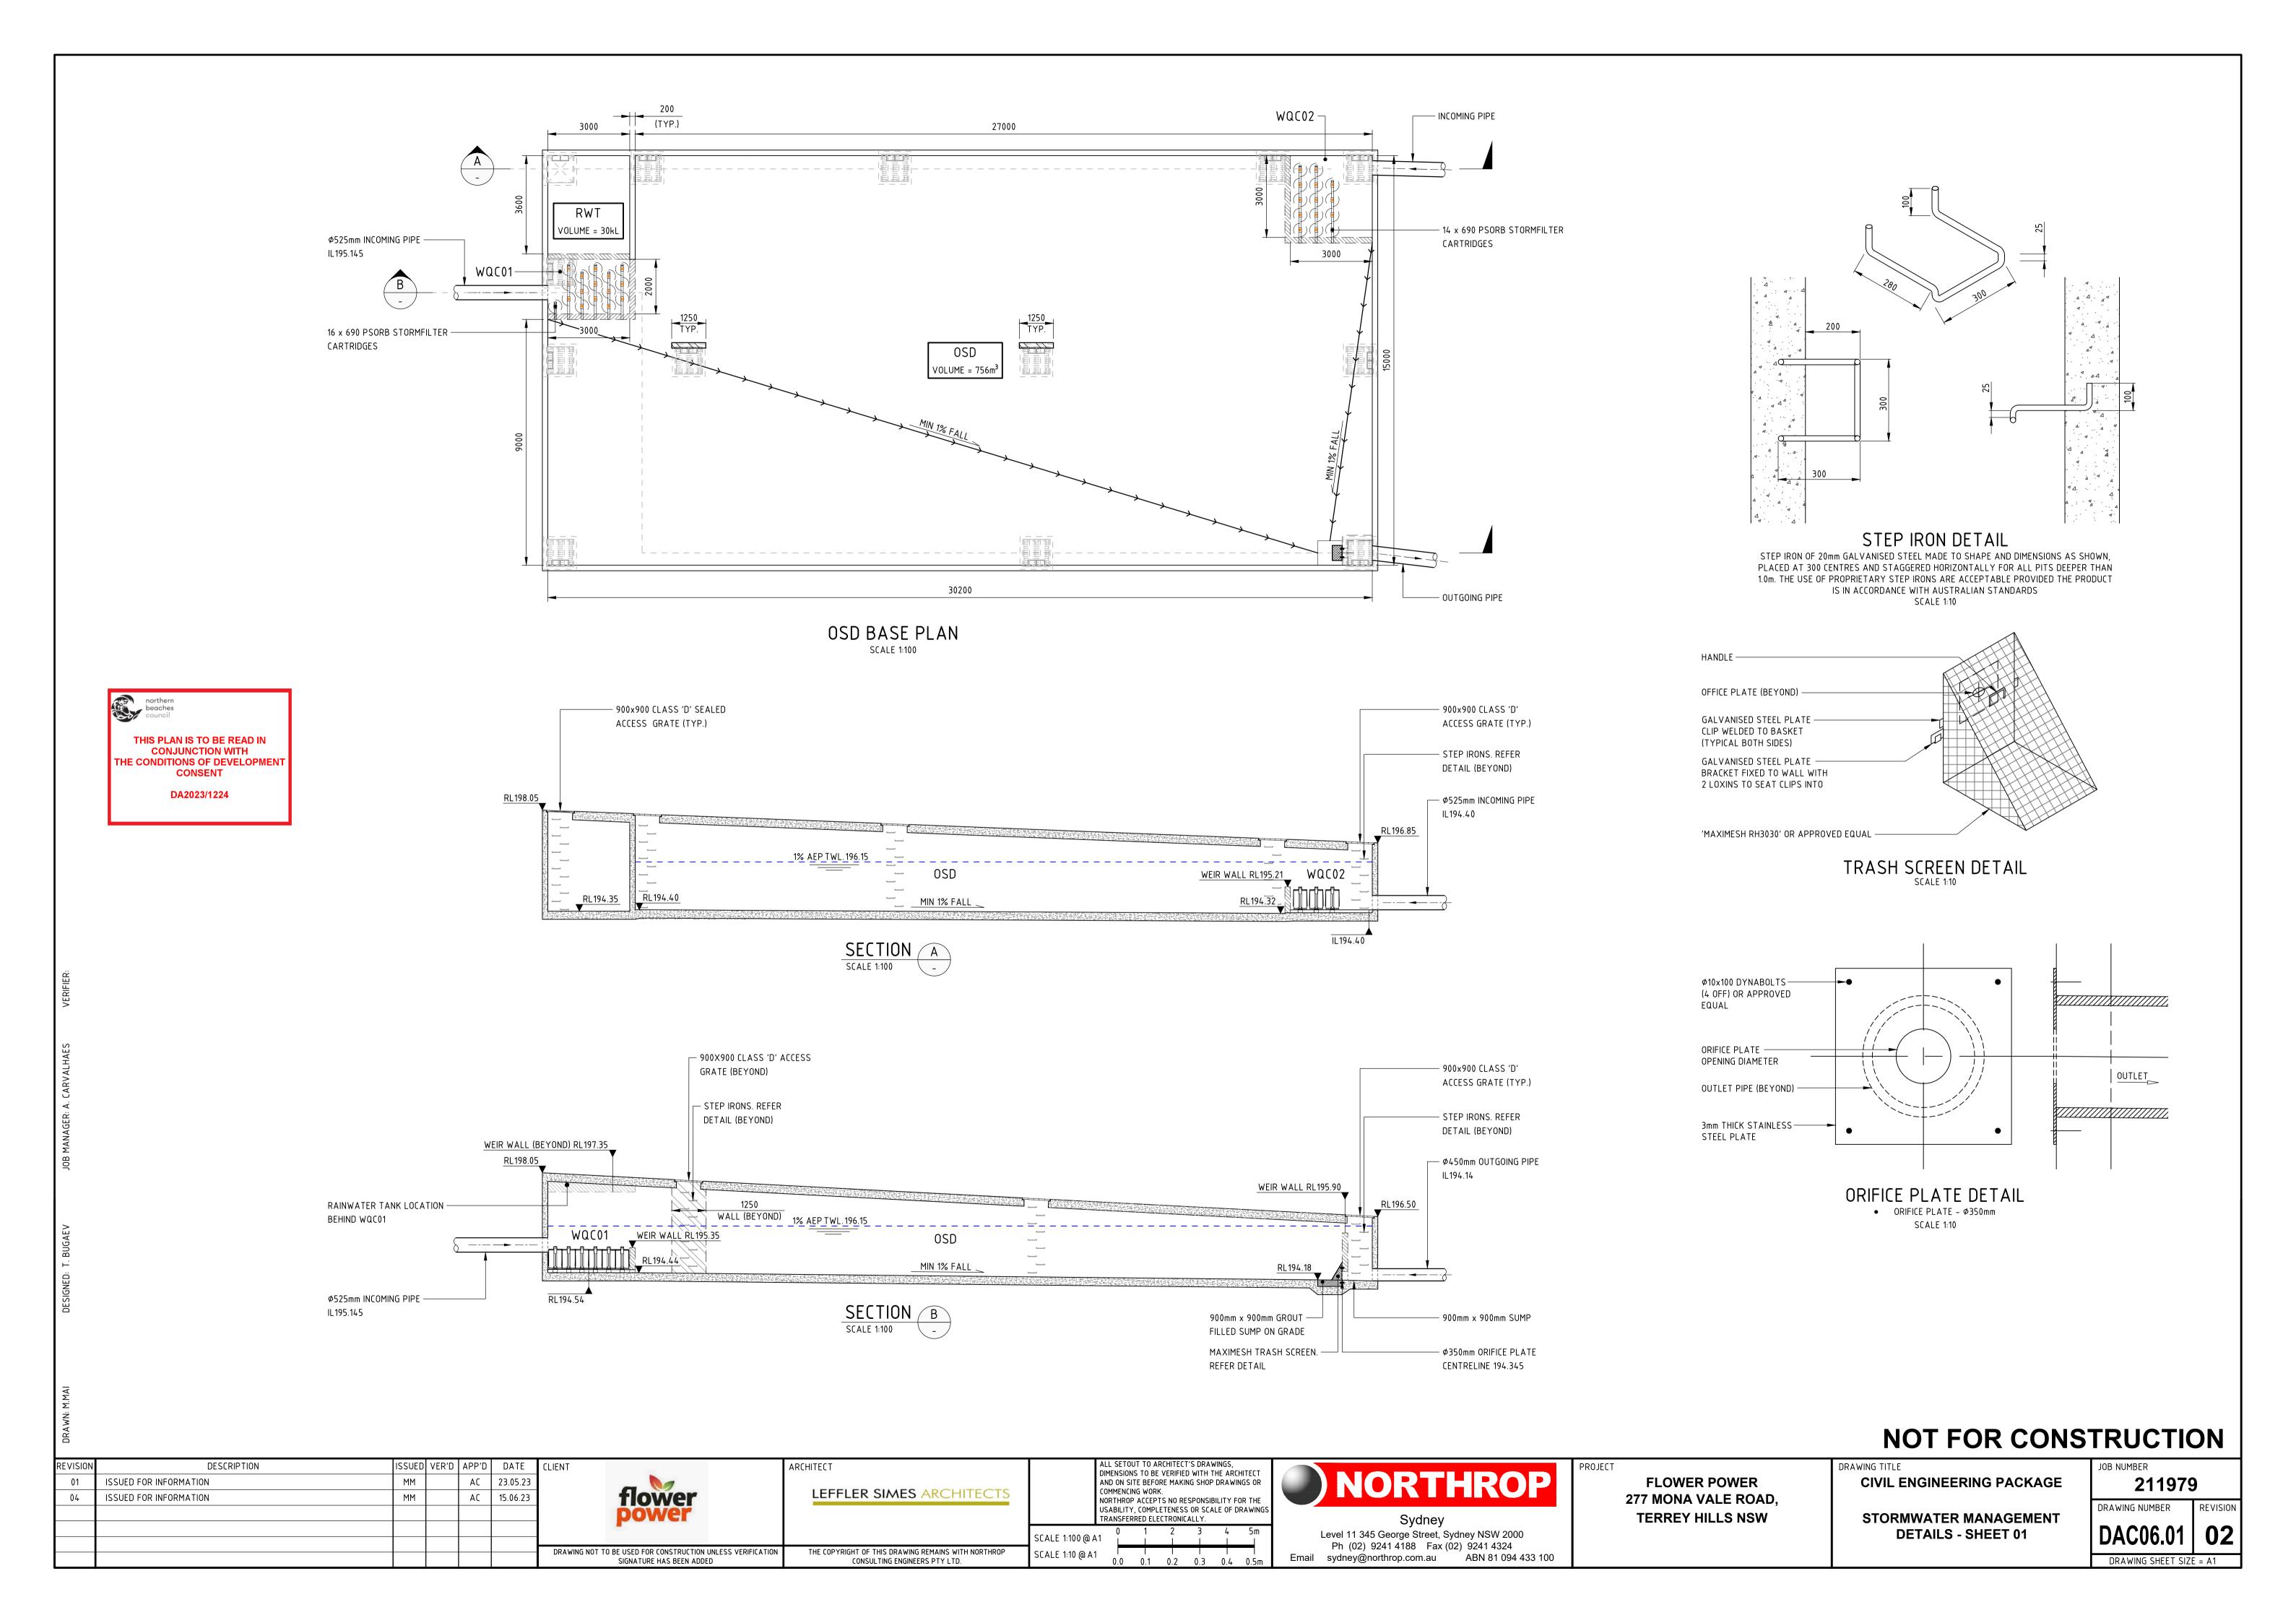


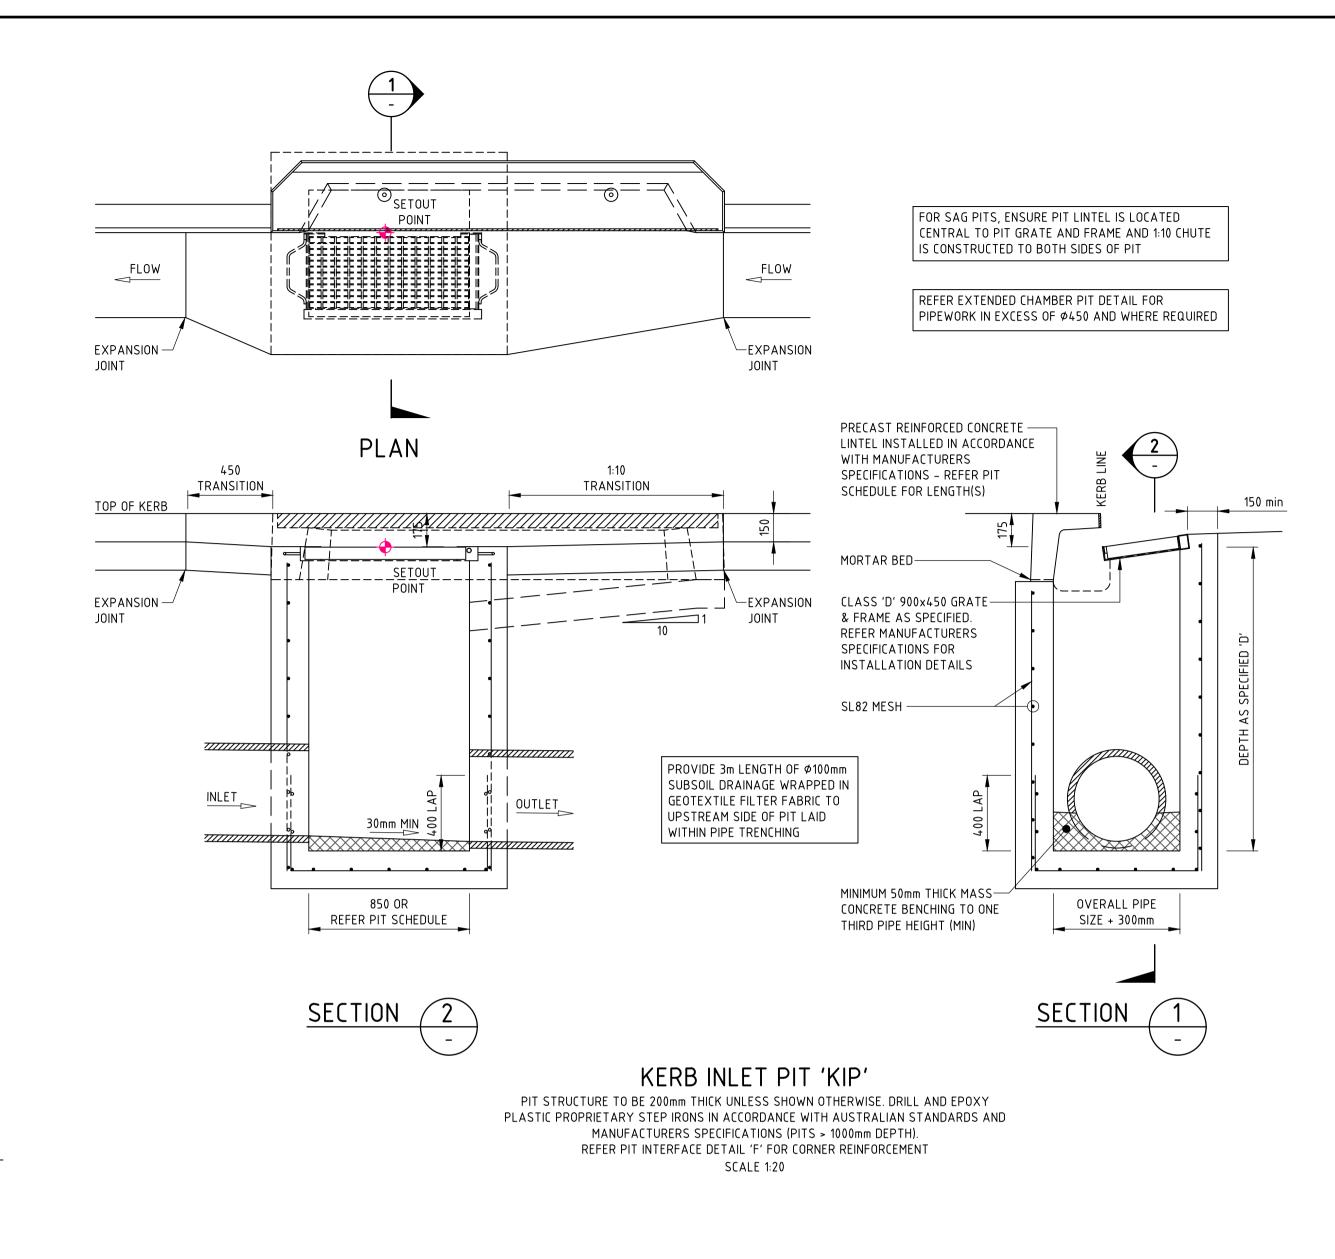

northern beaches council

THIS PLAN IS TO BE READ IN CONJUNCTION WITH THE CONDITIONS OF DEVELOPMENT CONSENT

DA2023/1224

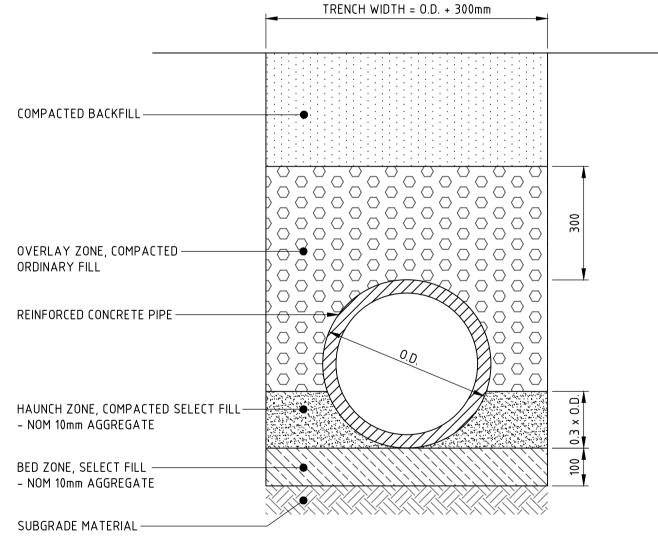


TYPICAL PIPE TRENCH - GENERAL AREAS

- 1. TRENCH WIDTH MAY NEED TO BE INCREASED SUBJECT TO ACHIEVING COMPACTION. ENSURE MINIMUM 300mm CLEARANCE BETWEEN, WHEN USING MULTIPLE PIPES TO ACHIEVE ADEQUATE COMPACTION.
- MINIMUM PIPE COVER NOT UNDER ROADS TO BE 300mm U.N.O.
 THE CONTRACTOR SHALL ENSURE THAT SHORING OF TRENCHES IS INSTALLED AS
- REQUIRED BY STATUTORY REQUIREMENTS.

 4. ENSURE BACKFILLING COMPACTION MEETS THE FOLLOWING STANDARDS;
- 4.1. TRENCHES UNDER PAVED AREAS / BUILDING 100% SMDD
- 4.1. TRENCHES UNDER PAVED AREAS / BUILDING 1009
 4.2. TRENCHES NOT UNDER PAVEMENTS 95% SMDD

SCALE 1:10

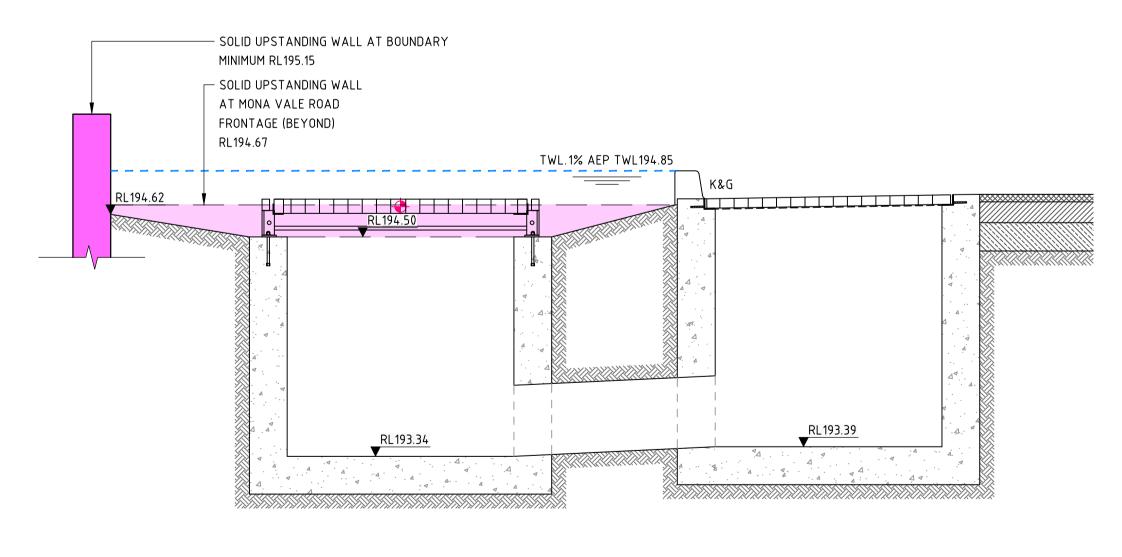

UPSTANDING WALL TYPICAL SECTION A

SCALE 1:20

CO4.01

NOT FOR CONSTRUCTION

DESCRIPTION DATE ARCHITECT DRAWING TITLE DIMENSIONS TO BE VERIFIED WITH THE ARCHITECT **FLOWER POWER** ISSUED FOR INFORMATION 15.06.23 CIVIL ENGINEERING PACKAGE 211979 AND ON SITE BEFORE MAKING SHOP DRAWINGS OR COMMENCING WORK. LEFFLER SIMES ARCHITECTS 277 MONA VALE ROAD, NORTHROP ACCEPTS NO RESPONSIBILITY FOR THE USABILITY, COMPLETENESS OR SCALE OF DRAWINGS
TRANSFERRED ELECTRONICALLY. DRAWING NUMBER **TERREY HILLS NSW** STORMWATER MANAGEMENT Level 11 345 George Street, Sydney NSW 2000 Ph (02) 9241 4188 Fax (02) 9241 4324 **DETAILS - SHEET 02** 0.0 0.2 0.4 0.6 0.8 1.0m DRAWING NOT TO BE USED FOR CONSTRUCTION UNLESS VERIFICATION THE COPYRIGHT OF THIS DRAWING REMAINS WITH NORTHROP Email sydney@northrop.com.au ABN 81 094 433 100 DRAWING SHEET SIZE = A1

