

All dimensions shown are to frame, underside of roof trusses and FFL (concrete) to underside of floor joist

FFL denotes - concrete level floor joist + selected flooring

All construction work to comply with the NCC and all relevant Australian standards

All previous issues are to be discarded only these plans are to be read

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for/client
MR AND MRS WANG

TITLE

location
LOT34/35, 231-233 McCARRS CREEK RD
CHURCH POINT
NORTHERN BEACHES COUNCIL

drawn - S


RTHERN BEACHES COUNCIL drawn - SB date: scale:

DO NOT SCALE DRAWINGS checked - SB date: 16.02.25

dwg no:

00/

SE2501

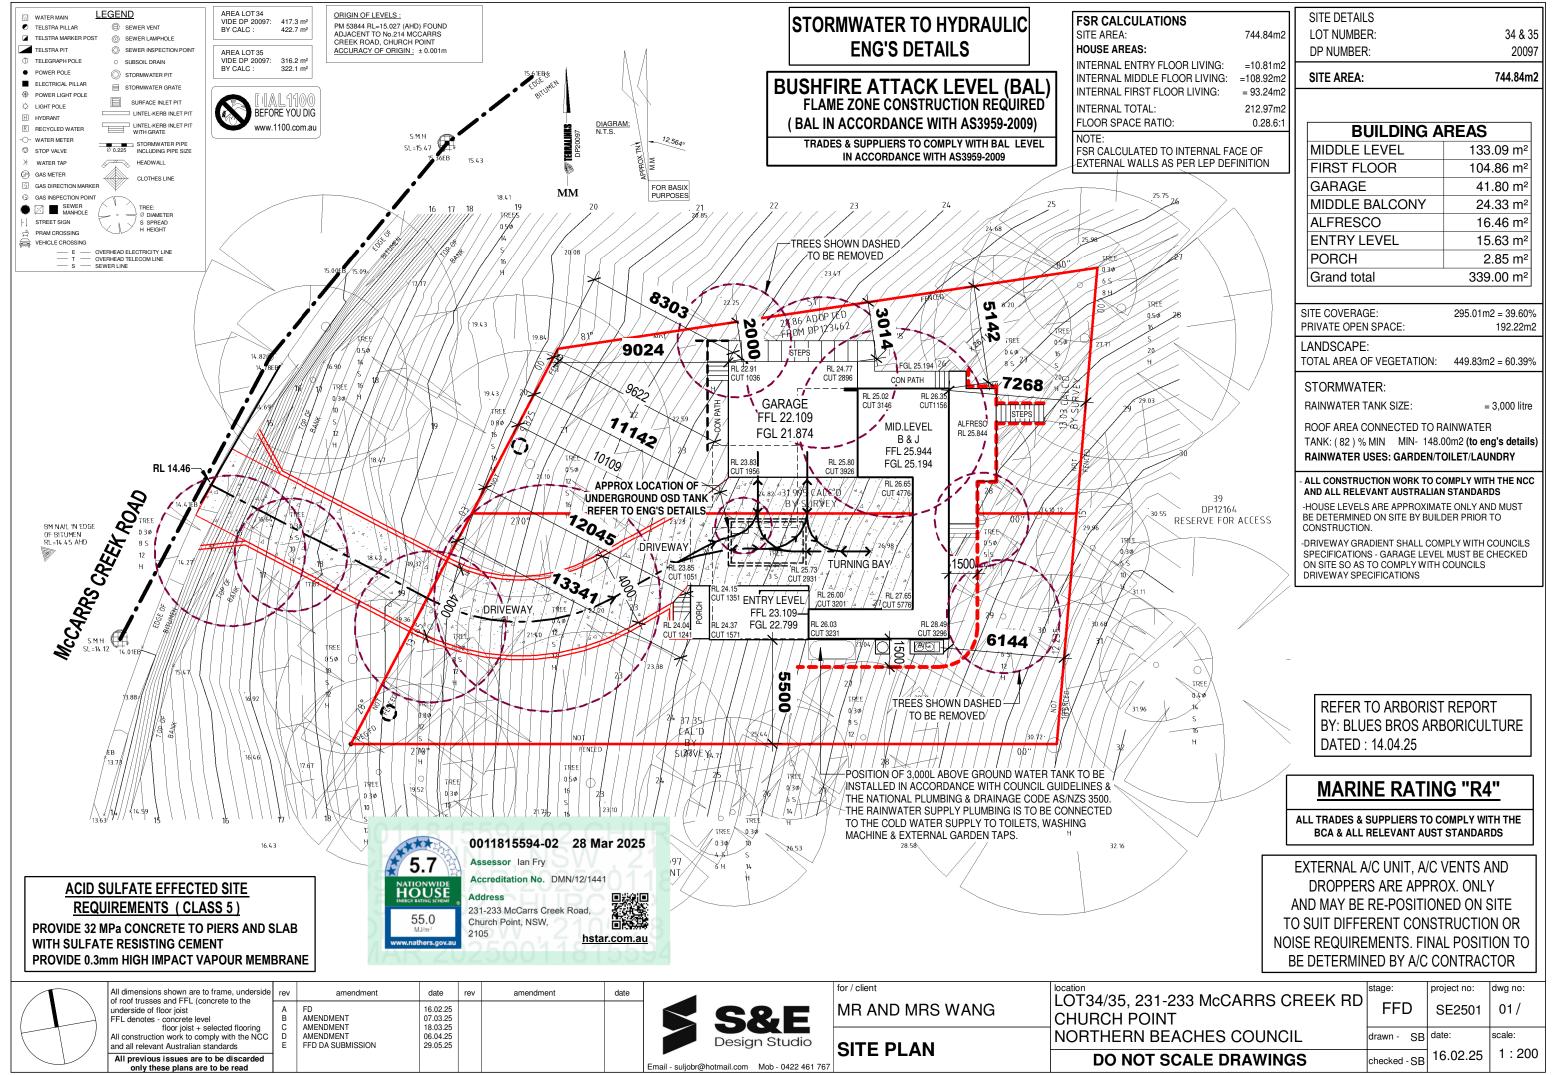

<u>LEGENDS</u> LIFT OFF DOOR HINGE

CJ★ CONTROL BRICK JOINT CEILING MAN HOLE

SA O SMOKE ALARM ●DP DOWN PIPE AC DUCTS

CONCRETE SLABS, FOOTINGS & STEEL BEAM

HEBLE POWERWALL SYSTEM TO BE ERECTED IN ACCORDANCE TO MANUFACTURES DETAILS AND INSTRUCTIONS

2340H INTERNAL DOOR THROUGHOUT

PROVIDE ENG'S DETAILS FOR ALL:

ELEVATION (A)

**ALL EXHAUST FANS TO BE DUCTED EXTERNALY** 

6200 - DINCEL WALLS TO ENG'S DETAILS **GARAGE** 6115 **RL** 22.109 DINCÉL WALLS TO CANTILEVERED FLOOR ENG'S DETAILS ENG'S DETAILS [585], <sup>∰</sup> G.TAP BALCONY STACK 400 5850 6835 2900 9735 CANTILEVERED DINCEL WALLS TO **TURNING** FLOOR ENG'S DETAILS FNG'S DETAILS APPROX LOCATION OF BAY 275~ UNDERGROUND OSD TANK REFER TO ENG'S DETAILS 10735 5500 4735 → BALCONY STACK 1240 PL 23.109 820 **ENTRY** ENG'S DETAILS

VOID OVER

4600

5235

2330 2790

1100

2200

2000

ELEVATION (B)

4845

782 788,7

\*\*\*

7000

<del>275</del>

1275

**ELEVATION** 

13680

6835

SMOKE-ALARMS TO BE INSTALLED IN ACCORDANCE WITH CLAUSE 3.7.2.3 OF THE BCA AND AS 3786-2014.

ALL FLOOR WASTES ARE TO BE PROVIDED WITH DRAINAGE FLANGE IN ACCORDANCE WITH AS 3740-2010 TO ALL WET AREAS
(BATHROOM AND LAUNDRIES). FLANGES TO BE RECESSED IN FLOOR

ALL STAIRS AND STAIR FINISHES ARE TO COMPLY WITH CLAUSE 3.9.

ALL BALUSTRADES ARE TO BE A MINIMUM 1M HIGH AND TO COMPLY WITH CLAUSE 3.9.2.

ALL WINDOW OPENINGS MUST BE PROVIDED WITH PROTECTION, WHERE THE FLOOR BELOW THE WINDOW IS 2M OR MORE ABOVE THE SURFACE BENEATH

# **BASIX**

ALL PLANS TO BE READ IN **CONJUCTION WITH THE BASIX** CERTIFICATE AND ITS SCHEDULE OF COMMITMENTS, WHICH ARE TO BE **COMPLIED WITH IN FULL** 

5.7 HOUS 55.0 MJ/m²

0011815594-02 28 Mar 2025

Assessor Ian Fry

231-233 McCarrs Creek Road, Church Point, NSW. 2105

hstar.com.au

AREAS								
MIDDLE LEVEL	133.09 m²							
FIRST FLOOR	104.86 m²							
GARAGE	41.80 m <sup>2</sup>							
MIDDLE BALCONY	24.33 m²							
ALFRESCO	16.46 m²							
ENTRY LEVEL	15.63 m²							
PORCH	2.85 m <sup>2</sup>							
Grand total	339.00 m <sup>2</sup>							

EXTERNAL A/C UNIT, A/C VENTS AND DROPPERS (IF REQUIRED) ARE APPROX. ONLY AND MAY BE RE-POSITIONED ON SITE TO SUIT DIFFERENT CONSTRUCTION OR NOISE REQUIREMENTS. FINAL POSITION TO BE DETERMINED BY A/C CONTRACTOR

#### ACID SULFATE EFFECTED SITE REQUIREMENTS (CLASS 5)

PROVIDE 32 MPa CONCRETE TO SLAB WITH SULFATE RESISTING CEMENT PROVIDE 0.3mm HIGH IMPACT VAPOUR MEMBRANE

dwg no:

02/

scale:

1:100

**ENSURE THAT RECESSED PUDDLE FLANGES** ARE INSTALLED TO ALL WASTE PIPES AS PER AS.3740

of roof trusses and FFL (concrete to the underside of floor joist FFL denotes - concrete level floor joist + selected flooring
All construction work to comply with the NCC

**MARINE RATING "R4"** 

**ALL TRADES & SUPPLIERS TO COMPLY WITH** 

THE BCA & ALL RELEVANT AUST STANDARDS

**BUSHFIRE ATTACK LEVEL (BAL)** 

FLAME ZONE CONSTRUCTION REQUIRED (BAL IN ACCORDANCE WITH AS3959-2009)

TRADES & SUPPLIERS TO COMPLY WITH BAL LEVEL

IN ACCORDANCE WITH AS3959-2009

All previous issues are to be discarded

date 16.02.25 07.03.25 AMENDMENT AMENDMENT 18 03 25 AMENDMENT 06.04.25 FFD DA SUBMISSION 29.05.25



STORE

for / client MR AND MRS WANG

-SUB FLOOR-

7445

- STACK

DINCEL WALLS TO

ENG'S DETAILS


13680

ELEVATION (D)

**ENTRY FLOOR LEVEL** 

project no: LOT34/35, 231-233 McCARRS CREEK RD **FFD** SE2501 **CHURCH POINT** NORTHERN BEACHES COUNCIL SB date: drawn -16.02.25 DO NOT SCALE DRAWINGS hecked - SB

only these plans are to be read LOCATION: D:\work\WINCREST\17491\_Wang&Ma\Drawings\WORKING DRAWINGS\WORKING 06.04.25\WANG&MA - working - 06.04.25.rvt

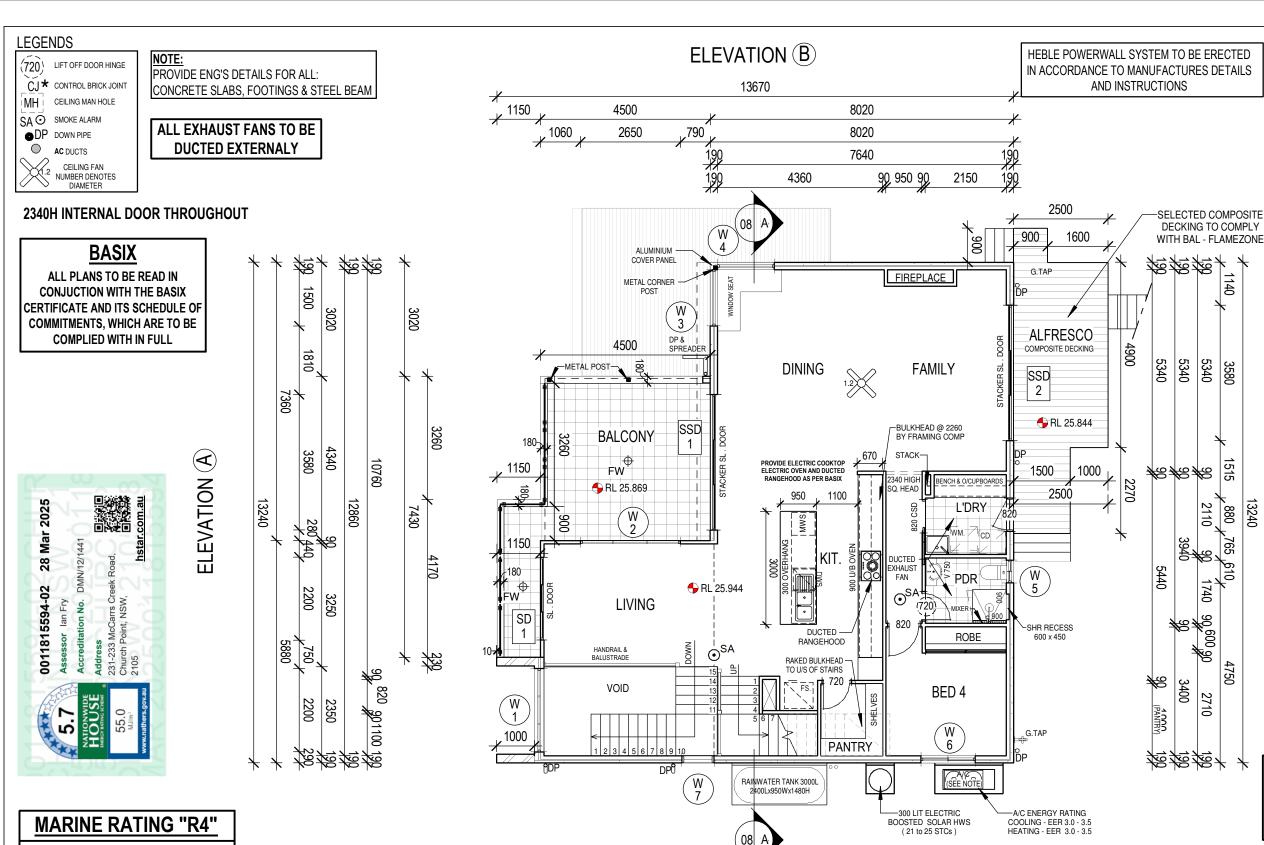

SMOKE-ALARMS TO BE INSTALLED IN ACCORDANCE WITH

ALL BALUSTRADES ARE TO BE A MINIMUM 1M HIGH AND

TO COMPLY WITH CLAUSE 3.9.2.

ALL FLOOR WASTES ARE TO BE PROVIDED WITH DRAINAGE FLANGE IN ACCORDANCE WITH AS 3740-2010 TO ALL WET AREAS

(BATHROOM AND LAUNDRIES). FLANGES TO BE RECESSED IN FLOOP ALL STAIRS AND STAIR FINISHES ARE TO COMPLY WITH CLAUSE 3.9.

ALL WINDOW OPENINGS MUST BE PROVIDED WITH PROTECTION WHERE THE FLOOR BELOW THE WINDOW IS 2M OR MORE ABOVE THE SURFACE BENEATH

# 4600 VOID PLAN

ELEVATION (C)

1140

3580

1515

,88

2110

740

90,600

#### **AREAS** MIDDLE LEVEL 133.09 m<sup>2</sup> FIRST FLOOR 104.86 m<sup>2</sup> GARAGE 41.80 m<sup>2</sup> MIDDLE BALCONY 24.33 m<sup>2</sup> **ALFRESCO** 16.46 m<sup>2</sup> **ENTRY LEVEL** 15.63 m<sup>2</sup> **PORCH** 2.85 m<sup>2</sup> 339.00 m<sup>2</sup> Grand total

EXTERNAL A/C UNIT, A/C VENTS AND DROPPERS (IF REQUIRED) ARE APPROX. ONLY AND MAY BE RE-POSITIONED ON SITE TO SUIT DIFFERENT CONSTRUCTION OR NOISE REQUIREMENTS. FINAL POSITION TO BE DETERMINED BY A/C CONTRACTOR

#### **ACID SULFATE EFFECTED SITE** REQUIREMENTS (CLASS 5)

PROVIDE 32 MPa CONCRETE TO SLAB WITH SULFATE RESISTING CEMENT PROVIDE 0.3mm HIGH IMPACT VAPOUR MEMBRANE

dwg no:

03/

scale:

1:100

**ENSURE THAT RECESSED PUDDLE FLANGES** ARE INSTALLED TO ALL WASTE PIPES AS PER AS.3740

All dimensions shown are to frame, underside of roof trusses and FFL (concrete to the nderside of floor joist FL denotes - concrete level floor joist + selected flooring All construction work to comply with the NCC

date 16.02.25 07.03.25 AMENDMENT AMENDMENT 18 03 25 AMENDMENT 06.04.25 FFD DA SUBMISSION 29.05.25 All previous issues are to be discarded



8960

850

1100 90360901000 90

12680

13680

**ELEVATION D** 

MR AND MRS WANG

90, 950 90

3190

1450

1630

MIDDLE FLOOR PLAN

project no: LOT34/35, 231-233 McCARRS CREEK RD **FFD** SE2501 **CHURCH POINT** NORTHERN BEACHES COUNCIL SB date: 16.02.25 DO NOT SCALE DRAWINGS hecked - SB

only these plans are to be read LOCATION: D:\work\WINCREST\17491\_Wang&Ma\Drawings\WORKING DRAWINGS\WORKING 06.04.25\WANG&MA - working - 06.04.25.rvt

ALL TRADES & SUPPLIERS TO COMPLY WITH THE BCA & ALL RELEVANT AUST STANDARDS

# **BUSHFIRE ATTACK LEVEL (BAL)** FLAME ZONE CONSTRUCTION REQUIRED

( BAL IN ACCORDANCE WITH AS3959-2009) TRADES & SUPPLIERS TO COMPLY WITH BAL LEVEL IN ACCORDANCE WITH AS3959-2009

4600

3910



(720)LIFT OFF DOOR HINGE CJ ★ CONTROL BRICK JOINT MH

CEILING MAN HOLE SA O SMOKE ALARM

●DP DOWN PIPE

AC DUCTS CEILING FAN NUMBER DENOTES DIAMETER

PROVIDE ENG'S DETAILS FOR ALL: CONCRETE SLABS, FOOTINGS & STEEL BEAM

# ALL EXHAUST FANS TO BE **DUCTED EXTERNALY**

HEBLE POWERWALL SYSTEM TO BE ERECTED IN ACCORDANCE TO MANUFACTURES DETAILS AND INSTRUCTIONS

#### 2340H INTERNAL DOOR THROUGHOUT

## **BASIX**

**ALL PLANS TO BE READ IN CONJUCTION WITH THE BASIX** CERTIFICATE AND ITS SCHEDULE OF COMMITMENTS, WHICH ARE TO BE **COMPLIED WITH IN FULL** 




# **MARINE RATING "R4"**

**ALL TRADES & SUPPLIERS TO COMPLY WITH** THE BCA & ALL RELEVANT AUST STANDARDS

# BUSHFIRE ATTACK LEVEL (BAL) FLAME ZONE CONSTRUCTION REQUIRED (BAL IN ACCORDANCE WITH AS3959-2009)


TRADES & SUPPLIERS TO COMPLY WITH BAL LEVEL IN ACCORDANCE WITH AS3959-2009

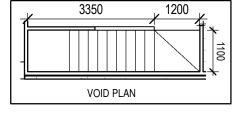

ELEVATION (A)

# **ELEVATION** (B)

7920

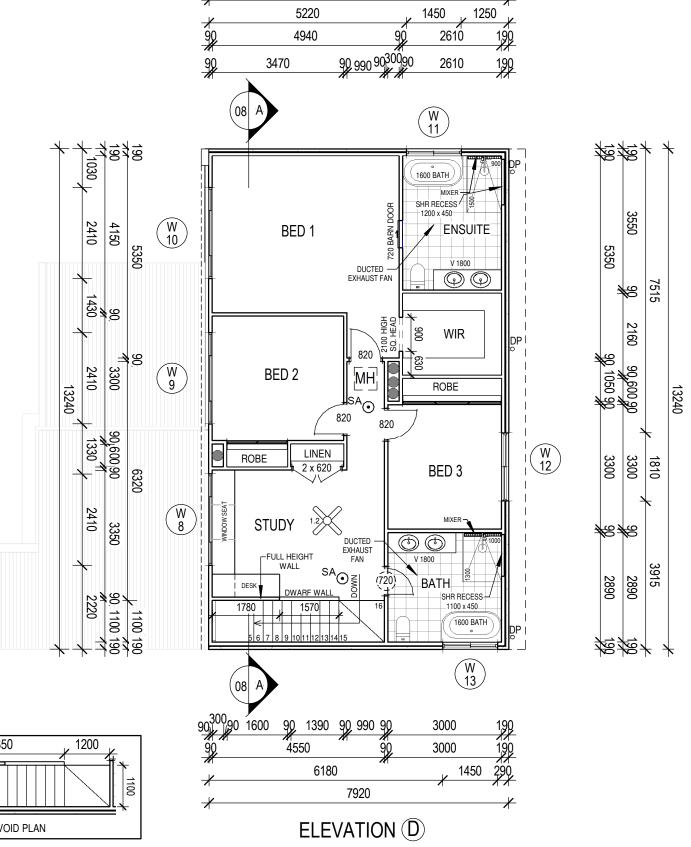

SMOKE-ALARMS TO BE INSTALLED IN ACCORDANCE WITH CLAUSE 3.7.2.3 OF THE BCA AND AS 3786-2014.

ALL FLOOR WASTES ARE TO BE PROVIDED WITH DRAINAGE FLANGES IN ACCORDANCE WITH AS 3740-2010 TO ALL WET AREAS (BATHROOM AND LAUNDRIES). **FLANGES TO BE RECESSED IN FLOOF** 

ALL STAIRS AND STAIR FINISHES ARE TO COMPLY WITH CLAUSE 3.9.1

ALL BALUSTRADES ARE TO BE A MINIMUM 1M HIGH AND TO COMPLY WITH CLAUSE 3.9.2.

ALL WINDOW OPENINGS MUST BE PROVIDED WITH PROTECTION, WHERE THE FLOOR BELOW THE WINDOW IS 2M OR MORE ABOVE THE SURFACE BENEATH

EXTERNAL A/C UNIT, A/C VENTS AND DROPPERS (IF REQUIRED) ARE APPROX. ONLY AND MAY BE RE-POSITIONED ON SITE TO SUIT DIFFERENT CONSTRUCTION OR NOISE REQUIREMENTS. FINAL POSITION TO BE DETERMINED BY A/C CONTRACTOR

### **ACID SULFATE EFFECTED SITE** REQUIREMENTS (CLASS 5)

PROVIDE 32 MPa CONCRETE TO SLAB WITH SULFATE RESISTING CEMENT PROVIDE 0.3mm HIGH IMPACT VAPOUR MEMBRANE

**ENSURE THAT RECESSED PUDDLE FLANGES** ARE INSTALLED TO ALL WASTE PIPES AS PER AS.3740



All dimensions shown are to frame, underside of roof trusses and FFL (concrete to the underside of floor joist

FFL denotes - concrete level floor joist + selected flooring
All construction work to comply with the NCC All previous issues are to be discarded only these plans are to be read

date 16.02.25 07.03.25 FD AMENDMENT AMENDMENT AMENDMENT 18.03.25 06.04.25 FFD DA SUBMISSION 29.05.25




MR AND MRS WANG

**FIRST FLOOR PLAN** 

project no: dwg no: LOT34/35, 231-233 McCARRS CREEK RD **FFD** 04/ SE2501 **CHURCH POINT** NORTHERN BEACHES COUNCIL SB date: scale: 1:100 16.02.25 DO NOT SCALE DRAWINGS hecked - SB

ELEVATION ©

LOCATION: D:\work\WINCREST\17491\_Wang&Ma\Drawings\WORKING DRAWINGS\WORKING 06.04.25\WANG&MA - working - 06.04.25.rvt

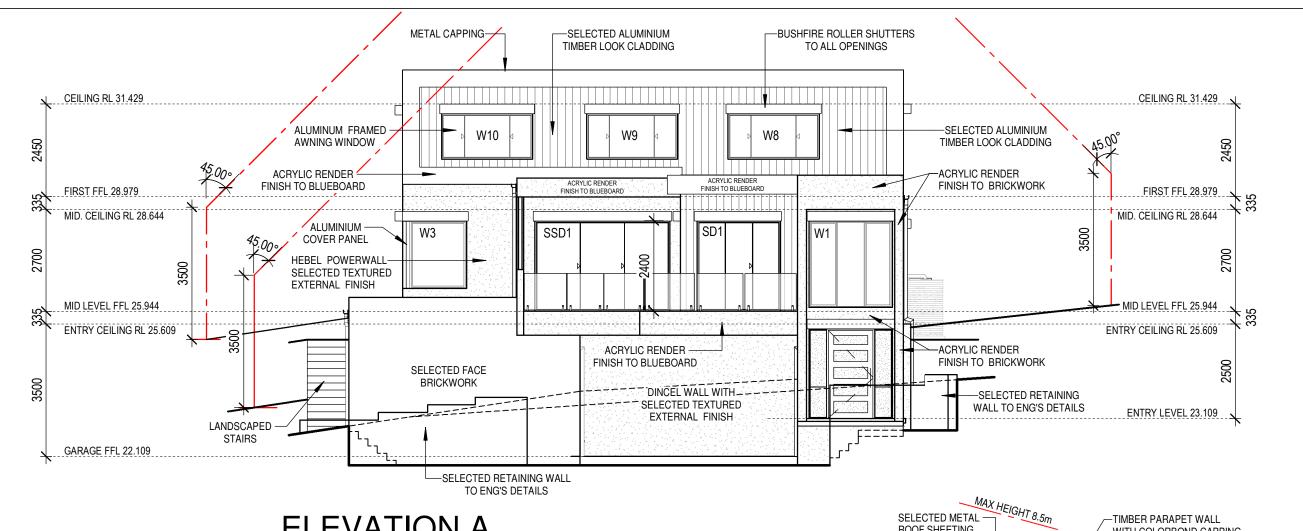


# **ELEVATION A**

1:100



BUSHFIRE ATTACK LEVEL (BAL) FLAME ZONE CONSTRUCTION REQUIRED (BAL IN ACCORDANCE WITH AS3959-2009) TRADES & SUPPLIERS TO COMPLY WITH BAL LEVEL **IN ACCORDANCE WITH AS3959-2009** 

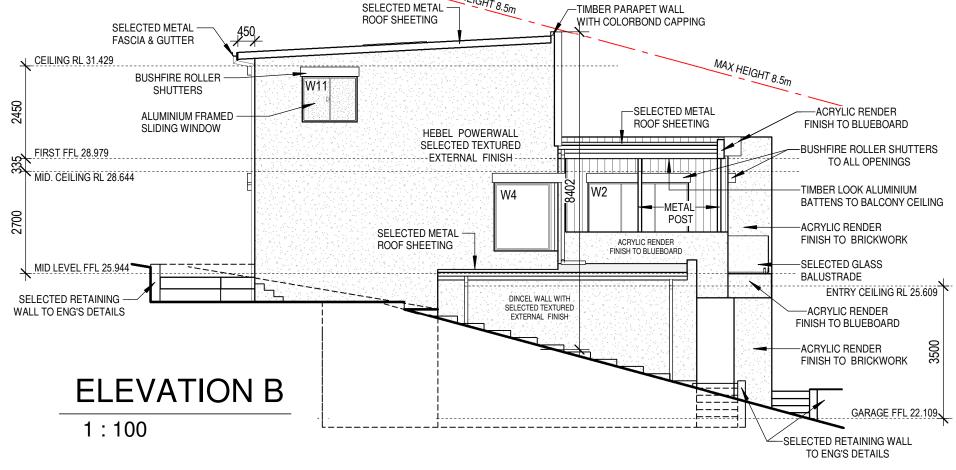

All dimensions shown are to frame, underside of roof trusses and FFL (concrete) to underside of floor joist

FFL denotes - concrete level floor joist + selected flooring


FD AMENDMENT 16.02.25 07.03.25 AMENDMENT AMENDMENT 18 03 25 06.04.25 FFD DA SUBMISSION 29.05.25 All previous issues are to be discarded only these plans are to be read



MR AND MRS WANG **CHURCH POINT ELEVATIONS** 

dwg no: project no: LOT34/35, 231-233 McCARRS CREEK RD FFD SE2501 05/ NORTHERN BEACHES COUNCIL SB date: scale: 1:100 16.02.25 DO NOT SCALE DRAWINGS checked - SB

LOCATION: D:\work\WINCREST\17491\_Wang&Ma\Drawings\WORKING DRAWINGS\WORKING 06.04.25\WANG&MA - working - 06.04.25.rvt

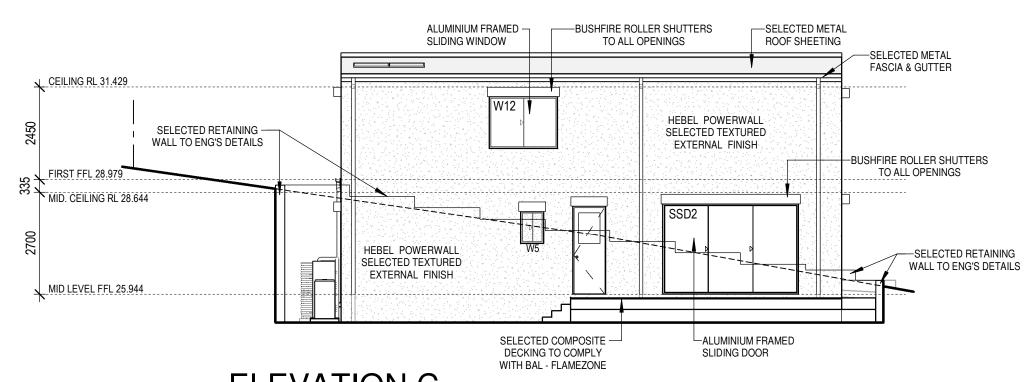


BUSHFIRE ATTACK LEVEL (BAL) FLAME ZONE CONSTRUCTION REQUIRED

(BAL IN ACCORDANCE WITH AS3959-2009)

TRADES & SUPPLIERS TO COMPLY WITH BAL LEVEL
IN ACCORDANCE WITH AS3959-2009

**ELEVATION C** 

1:100

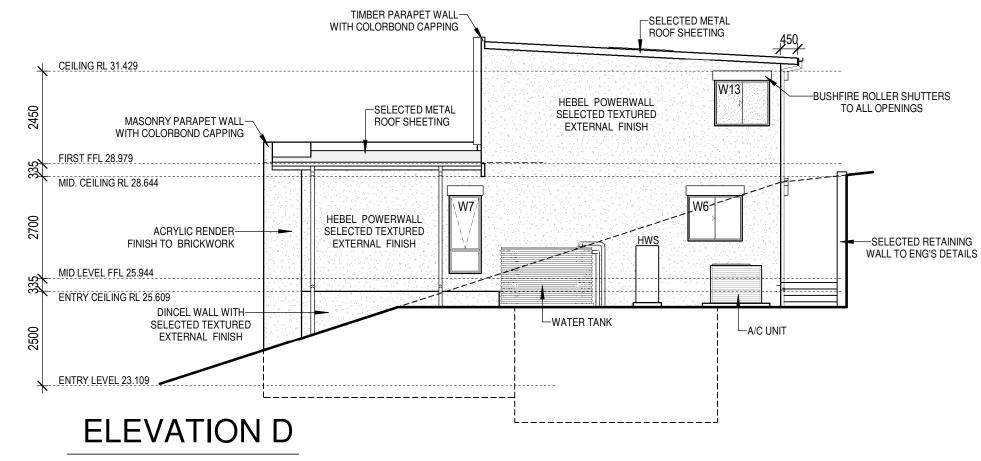

O011815594-02 28 Mar 2025
Assessor lan Fry
Accreditation No. DMN/12/1441
Address
231-233 McCarrs Creek Road,
Church Point, NSW,
2105
hstar.com.au

1:100

All dimensions shown are to frame, underside of roof trusses and FFL (concrete) to underside of floor joist

FFL denotes - concrete level floor joist + selected flooring

All construction work to comply with the NCC and all relevant Australian standards

All previous issues are to be discarded only these plans are to be read

rev amendment date

S&I

Design Stu

for / client
MR AND MRS WANG

ELEVATIONS

location
LOT34/35, 231-233 McCARRS CREEK RD
CHURCH POINT
NORTHERN BEACHES COUNCIL

DO NOT SCALE DRAWINGS

stage:
FFD
SE2501

drawn - SB
checked - SB
16.02.25


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scale:

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TG - DENOTES TOUGHENED GLASS

NOTE: ALL WINDOW FRAMES AND GLASS TO COMPLY WITH BASIX CERTIFICATE

#### NOTE:

ALL BED ROOM WINDOW OPENINGS HIGHER THAN 2.0m FROM FINISHED GROUND LEVEL TO BE PROTECTED IN ACCORDANCE WITH CLAUSE 3.9.2.6 VOLUME 2 OF THE BUILDING CODE OF AUSTRALIA

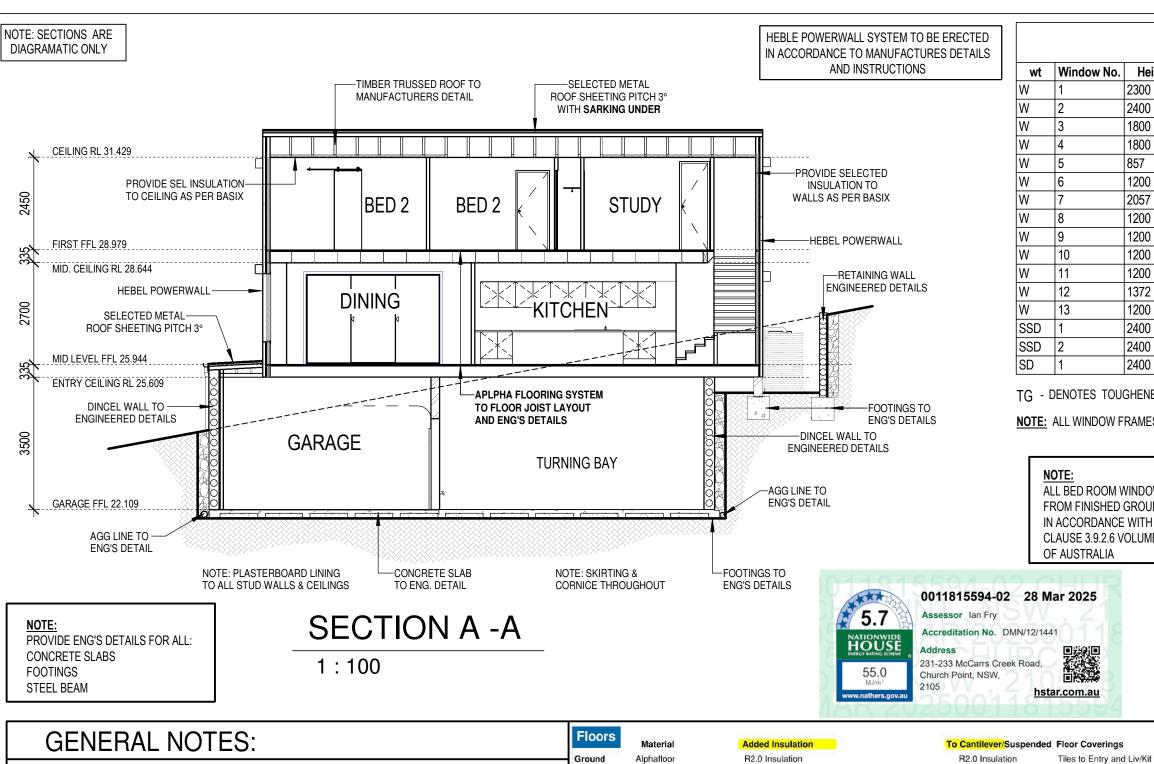0011815594-02 28 Mar 2025 hstar.com.au

# **MARINE RATING "R4"**

THE BCA & ALL RELEVANT AUST STANDARDS

- PROVIDE PEST CONTROL SYSTEM TO PERIMETER OF HOME AS REQUIRED BY CERTIFYING AUTHORITY.
- AS/NZS 3000-2000 ELECTRICAL REQUIREMENTS: SAFETY SWITCH TO FRIDGE & LIGHT CIRCUITS: ISOLATING SWITCH FOR WALL OVEN.
- PROVIDE GLASSWOOL CEILING INSULATION TO ROOF SPACE OF LIVING AREAS, AS PER BASIX
- PROVIDE GLASSWOOL WALL INSULATION TO EXTERNAL WALLS OF LIVING AREAS. AS PER BASIX
- PROVIDE SHOWERHEAD MINIMUM RATING AS PER BASIX
- KITCHEN, LAUNDRY & VANITY BASIN TAPS AS PER BASIX
- TOILET CISTERNS AS PER BASIX
- PROVIDE 3000 LITRE RAIN WATER TANK
- ARTIFICIAL LIGHT REQUIREMENTS TO BE AS PER BASIX
- 300 LIT ELECTRIC BOOSTED SOLAR HWS (21 to 25 STCs
- 75mm GAP BETWEEN FRIDGE & WALL TO BE MAINTAINED
- MANHOLE POSITION IS APPROXIMATE ONLY AND MAY BE RE-POSITIONED ON SITE TO SUIT CONSTRUCTION CONSTRAINTS OR REQUIREMENTS

# Ground 1st Floor Basement Walls Ground 1st Floor Basement ALL PLANS TO BE READ IN **CONJUCTION WITH THE BASIX** CERTIFICATE AND ITS SCHEDULE OF

BASIX

COMMITMENTS, WHICH ARE TO BE

**COMPLIED WITH IN FULL** 

amendment

Default Default Plaster Timber Frame B5.0

Timber

Waffle Pod 225mm

Colour External Material Default ACC Hebel Timber Frame ACC Hebel / F.Cement Timber Frame Dincel wall / Brick veneer No insulation to garage walls

R2.0 Insulation

Ceilings Insulation to Roof Above Ground R5 0 1st Floor Plaster Timber Frame

R2.5, Non Reflective Wrap R2.5, Non Reflective Wrap NIL/R2.5. Non Reflective Wra

> Sarking Ground 1st Floor Sarking

Ventilated Colour Default Metal Yes Metal Default Yes

Garage

**ALL TRADES & SUPPLIERS TO COMPLY WITH** 

# BUSHFIRE ATTACK LEVEL (BAL) FLAME ZONE CONSTRUCTION REQUIRED

(BAL IN ACCORDANCE WITH AS3959-2009) TRADES & SUPPLIERS TO COMPLY WITH BAL LEVEL IN ACCORDANCE WITH AS3959-2009

> ALL BUILDING WORK SHALL BE CARRIED OUT IN ACORDANCE WITH THE NCC AND ALL RELEVANT STANDARDS

ALL WORK TO COMPLY WITH CDC, COUNCIL REQUIREMENTS AND ALL OTHER AUTHORITES

BUILDER TO CHECK ALL DIMENSIONS ON SITE PRIOR TO COMMENCEMENT OF WORK

ALL DIMENSIONS, SIZES ect ARE IN MILIMETERS

All dimensions shown are to frame, underside of roof trusses and FFL (concrete) to underside of floor jois FFL denotes - concrete level

floor joist + selected flooring All construction work to comply with the NCC and all relevant Australian standards All previous issues are to be discarded only these plans are to be read

date FD AMENDMENT 16.02.25 07.03.25 AMENDMENT 18 03 25 AMENDMENT 06.04.25 FFD DA SUBMISSION 29.05.25

MR AND MRS WANG

for / client

SECTION/SCHEDULE

LOT34/35, 231-233 McCARRS CREEK RD **CHURCH POINT** NORTHERN BEACHES COUNCIL

DO NOT SCALE DRAWINGS


R2.0

R2.0

R2.0

dwg no: project no: **FFD** 07/ SE2501 SB date: scale: 16.02.25 1:100 checked - SB

LOCATION: D:\work\WINCREST\17491\_Wang&Ma\Drawings\WORKING DRAWINGS\WORKING 06.04.25\WANG&MA - working - 06.04.25.rvt

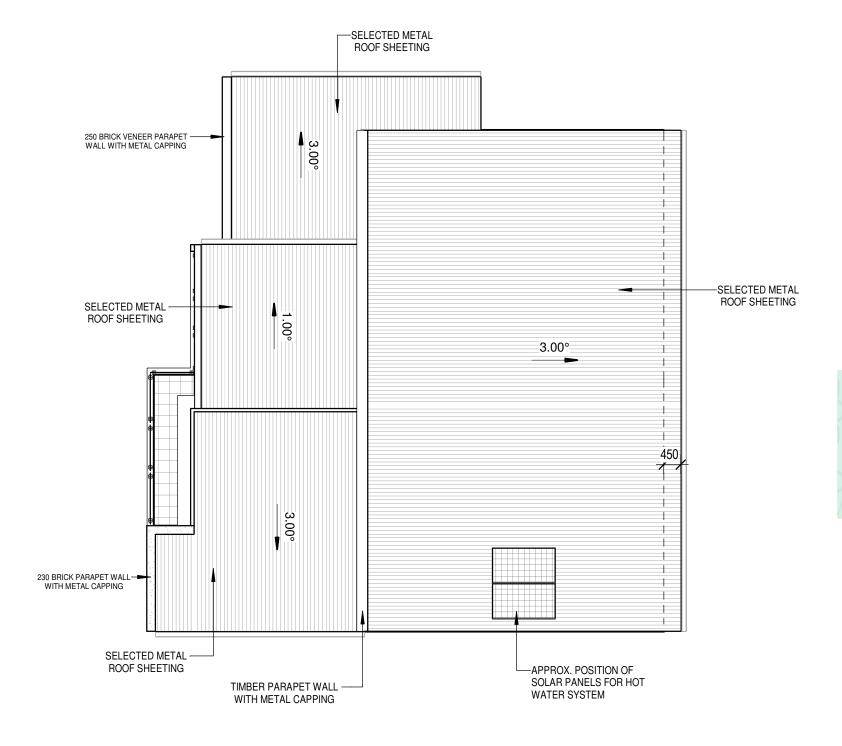



# **MARINE RATING "R4"**

ALL TRADES & SUPPLIERS TO COMPLY WITH THE BCA & ALL RELEVANT AUST STANDARDS

# ACID SULFATE EFFECTED SITE REQUIREMENTS ( CLASS 5 )

PROVIDE 32 MPa CONCRETE TO SLAB WITH SULFATE RESISTING CEMENT PROVIDE 0.3mm HIGH IMPACT VAPOUR MEMBRANE

project no:

SE2501

16.02.25

SB date:

dwg no:

08/


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1:100

# **BUSHFIRE ATTACK LEVEL (BAL)**

FLAME ZONE CONSTRUCTION REQUIRED (BAL IN ACCORDANCE WITH AS3959-2009)

TRADES & SUPPLIERS TO COMPLY WITH BAL LEVEL IN ACCORDANCE WITH AS3959-2009

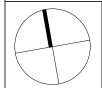

All dimensions shown are to frame, underside of roof trusses and FFL (concrete to the underside of floor joist FFL denotes - concrete level floor joist + selected flooring All construction work to comply with the NCC and all relevant Australian standards

All previous issues are to be discarded only these plans are to be read





#### **BASIX & THERMAL COMMITMENTS**









Date 31/03/25											
	5	Job Number	Wang 17491		Version	2		REQUIRE	ED CH	ANGES HIGHLI	GHTED
nit/Number 31-233	<b>Lot</b> 34/35	<b>DP</b> 20097	Street McCARRS	CREEK RD				uburb CHURCH POINT		Post Code	State NSW
loors	Materi	al	Added Ins	eulation			To Ca	ntilever/Suspende	ed Flo	or Coverings	
ound	Alphaflo		R2.0 Insu					0 Insulation		es to Entry and Liv	′Kit
t Floor	Timber		R2.0 Insu	lation							
asement	Waffle F	od 225mm									
Valls											
	Colour Default	External	<b>Material</b> bel Timber Fran	mo	Insulation R2.5, Nor		tivo Wran	Internal Material Plaster Timber 90		Internal Insulated	R2.0
round st Floor	Default		oel / F.Cement		R2.5, Nor			Plaster Timber 90		L'dry, Pdr Bath	R2.0
asement	Default		all / Brick vene				eflective Wra		J	Datii	112.0
2001110111	Doradii		ation to garage		111211210,			•		Garage	R2.0
ailinga					Do	o.f					
Ceilings	Mate	erial	Insulation to	Roof Above	Ro	OI	Insulation	ı N	<i>l</i> lateria	l Colour	Ventilate
round	Plaster '	Timber Frame	R5.0		Grou	ınd	Sarking	ľ	Metal	Default	Yes
st Floor	Plaster '	Timber Frame	R5.0		1st F	loor	Sarking	ľ	Metal	Default	Yes
indow substit		ere made du <b>e</b> to	o software limit	ations.							
indow substit	ans	ere made due to  Location  Dining/Family a		ations.					an Size 200mm		
Ceiling F	ans	Location Dining/Family a	and Study	Rain Water	Fank, connecte			1: ea to Tank	200mm		eted to.
Ceiling F	andscape 503.72	Location Dining/Family a	and Study	Rain Water 3,000L	Garden, WC, L	aundry	80% of	ea to Tank I	200mm	ed Water, connec	
Ceiling F  Vater La	andscape 503.72	Location Dining/Family a e Area Low V	and Study  Vater Area  m2	Rain Water	-	aundry	80% of	ea to Tank I Roof om Taps	200mm	l	
Ceiling F  Vater  La  Showerhead 3 Star > 7.5 b	andscape 503.72 is but less <	Location  Dining/Family a  e Area Low V  m2  c or = 9.0 litres p	vater Area m2	Rain Water 3,000L Toilets 4 Star	Garden, WC, L Kitchen 1 6 Star	aundry	80% of	ea to Tank I Roof om Taps	200mm Recycl No	ed Water, connec Swimming Po	
Ceiling F  Vater  La  Showerhead 3 Star > 7.5 b	andscape 503.72 is but less <	Location Dining/Family a e Area Low V m2 c or = 9.0 litres p	Vater Area m2 Deer minute	Rain Water 3,000L Toilets 4 Star	Garden, WC, L Kitchen 1 6 Star	aundry 「a <b>ps</b>	80% of Bathroo	ea to Tank I Roof om Taps	200mm Recycl No	ed Water, connec Swimming Po No Other	ool
Ceiling F  Vater La  Showerhead 3 Star > 7.5 b  Energy	andscape 503.72 I Is but less <	Location Dining/Family a e Area Low V m2 c or = 9.0 litres p ster F Boost Solar	vater Area m2	Rain Water 3,000L Toilets 4 Star	Garden, WC, L Kitchen 1 6 Star	aundry 「a <b>ps</b>	80% of <b>Bathroo</b> 6 Sta	ea to Tank I Roof om Taps	200mm Recycl No	ed Water, connect Swimming Po No  Other Air Conditioning Z	ool
Ceiling F  Vater La  Showerhead 3 Star > 7.5 b  Energy  Solar Photor	andscape 503.72 I Is but less <	Location Dining/Family a e Area Low V m2 c or = 9.0 litres p ster F Boost Solar	Vater Area m2 Deer minute	Rain Water 3,000L Toilets 4 Star	Garden, WC, L Kitchen 1 6 Star	aundry 「a <b>ps</b>	80% of Bathroo 6 Sta - 3.5 EER Cooking	ea to Tank I Roof om Taps	Recycl No	ed Water, connec Swimming Po No Other	ool
Ceiling F  Vater La  Showerhead 3 Star > 7.5 tenergy  Solar Photon No	andscape 503.72 is but less < Hot Wa Electric voltaic S	Location Dining/Family a e Area Low V m2 c or = 9.0 litres p ster F Boost Solar	Vater Area m2 Deer minute Stating 21 to 25 STCs	Rain Water 3,000L Toilets 4 Star Air Condition Cooling 3.0	Garden, WC, L Kitchen 1 6 Star	aundry 「a <b>ps</b>	80% of Bathroo 6 Sta - 3.5 EER Cooking	ea to Tank Roof om Taps ar 3 Phase	Recycl No	ed Water, connect Swimming Po No  Other Air Conditioning Z	ool
Ceiling F  Vater La  Showerhead 3 Star > 7.5 b  Energy  Solar Photor No  /entilatio	andscape 503.72 is but less < Hot Wa Electric voltaic S	Location Dining/Family a e Area Low W m2 c or = 9.0 litres p ster R Boost Solar 2 ystem	Vater Area m2 Deer minute Stating 21 to 25 STCs	Rain Water 3,000L Toilets 4 Star Air Condition Cooling 3.0	Garden, WC, L Kitchen 1 6 Star oning - 3.5 EER - Hea	aundry 「a <b>ps</b>	80% of Bathroo 6 Sta - 3.5 EER Cooking	ea to Tank Roof Taps ar 3 Phase Cooktop/ Electric C	Recycl No	ed Water, connect Swimming Po No  Other Air Conditioning Z	ool
Ceiling F  Water La	andscape 503.72 is but less < Hot Wa Electric voltaic S	Location Dining/Family a e Area Low W m2 c or = 9.0 litres p ster R Boost Solar 2 ystem	Vater Area m2 Deer minute Stating 21 to 25 STCs	Rain Water 3,000L Toilets 4 Star Air Condition Cooling 3.0	Garden, WC, L Kitchen 1 6 Star oning - 3.5 EER - Hea	aundry 「a <b>ps</b>	80% of Bathroo 6 Sta - 3.5 EER Cooking	ea to Tank Roof Taps ar 3 Phase Cooktop/ Electric C	Recycl No	ed Water, connect Swimming Po No  Other Air Conditioning Z	ool
Ceiling F  Vater La  Showerhead 3 Star > 7.5 b  Energy  Solar Photor No  /entilatio	andscape 503.72 is but less < Hot Wa Electric voltaic S	Location Dining/Family a e Area Low W m2 c or = 9.0 litres p ster R Boost Solar 2 ystem	Vater Area m2 Deer minute Stating 21 to 25 STCs	Rain Water 3,000L Toilets 4 Star Air Condition Cooling 3.0	Garden, WC, L Kitchen 1 6 Star oning - 3.5 EER - Hea	aundry 「a <b>ps</b>	80% of Bathroo 6 Sta - 3.5 EER Cooking	ea to Tank Roof Taps ar 3 Phase Cooktop/ Electric C	Recycl No	ed Water, connect Swimming Po No  Other Air Conditioning Z	ool
Ceiling F  Vater La  Showerhead 3 Star > 7.5 th  Centilation  Tentilation  Tentilation  Tentilation  Tentilation  Tentilation	andscape 503.72 l Is but less < Hot Wa Electric voltaic S	Location Dining/Family a e Area Low W m2 c or = 9.0 litres p ster F Boost Solar 2 ystem aundry Natural Ventilations	Vater Area m2 Der minute Stating 21 to 25 STCs	Rain Water 3,000L Toilets 4 Star  Air Condition Cooling 3.0  Bandow Direction of the least section of the least se	Garden, WC, L.  Kitchen 1 6 Star  oning - 3.5 EER - Hea  athroom ucted	aundry  Taps  atting 3.0	80% of Bathroo 6 Sta - 3.5 EER Cooking Induction (	ea to Tank Roof Taps Taps Taps Taps Taps Taps Taps Taps	Recycl No	ed Water, connect Swimming Po No  Other Air Conditioning Z	coned s Line




All dimensions shown are to frame, underside of roof trusses and FFL (concrete) to underside of floor joist

FFL denotes - concrete level floor joist + selected flooring

All construction work to comply with the NCC and all relevant Australian standards All previous issues are to be discarded only these plans are to be read

A FD
B AMENDMENT
C AMENDMENT
D AMENDMENT
E FFD DA SUBMISSION

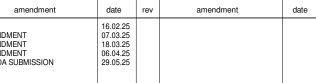



Frys Building Consultancy Pty Ltd Trading as Frys Energywise are Accredited Thermal Energy Assessors ABSA 20856, BDAV 12/1441, COLA 2011291

for / client MR AND MRS WANG

BASIX COMMITMENTS

	stage:	project no:	dwg no:
LOT34/35, 231-233 McCARRS CREEK RD CHURCH POINT	FFD	SE2501	09/
NORTHERN BEACHES COUNCIL	drawn <b>A</b> uthor	date:	scale:
DO NOT SCALE DRAWINGS	cheChecker	16.02.25	