

# **ACTION PLANS**

m: 0426 957 518

e: operations@actionplans.com.au

w: www.actionplans.com.au


# **DEVELOPMENT APPLICATION**

These plans are for Development Approval only.

SHEET NUMBER	SHEET NAME	DATE PUBLISHED
DA00	COVER	30/06/2020
DA01	SITE ANALYSIS	30/06/2020
DA02	SITE / ROOF / SEDIMENT EROSION / WASTE MANAGEMENT / STORMWATER CONCEPT PLAN	30/06/2020
DA03	EXISTING GROUND FLOOR PLAN	30/06/2020
DA04	EXISTING FIRST FLOOR PLAN	30/06/2020
DA05	PROPOSED GARAGE FLOOR PLAN	30/06/2020
DA06	PROPOSED GROUND FLOOR PLAN	30/06/2020
DA07	PROPOSED FIRST FLOOR PLAN	30/06/2020
DA08	NORTH / SOUTH ELEVATION	30/06/2020
DA09	EAST ELEVATION	30/06/2020
DA10	WEST ELEVATION	30/06/2020
DA11	CROSS SECTION	30/06/2020
DA12	LONG SECTION	30/06/2020
DA13	DRIVEWAY PLAN / LONG SECTION	30/06/2020
DA14	AREA CALCULATIONS	30/06/2020
DA15	SAMPLE BOARD	30/06/2020
DA16	WINTER SOLSTICE 9 AM	30/06/2020
DA17	WINTER SOLSTICE 12 PM	30/06/2020
DA18	WINTER SOLSTICE 3 PM	30/06/2020
DA19	BASIX COMMITMENTS	30/06/2020

ITEM DETAILS	DEVELOPMENT APPLICATION				
ADDRESS	15 TANGO AVENUE, DEE WHY NSW 2099				
LOT & DP/SP	LOT 44 SEC B DP 8139				
COUNCIL	NORTHERN BEACHES COUNCIL (WARRINGAH)				
SITE AREA	645m²				
FRONTAGE	15.24m				
CONTROLS	PERMISSIBLE / REQUIRED	EXISTING	PROPOSED	COMPLIANCE	
CONTROLS	m / m² / %	m / m² / %	m / m² / %		
<u>LEP</u>					
LAND ZONING	R2 – LOW DENSITY RESIDENTIAL	R2	R2	YES	
MINIMUM LOT SIZE	600m <sup>2</sup>	645m²	UNCHANGED	YES	
FLOOR SPACE RATIO	NOT IDENTIFEID	N/A	N/A	N/A	
MAXIMUM BUILDING HEIGHT	8.5m	6.6m	UNCHANGED	YES	
HAZARDS					
DEVELOPMENT ON SLOPING LAND	AREA A – SLOPES LESS THAN 5 DEGREES AREA B – SLOPES FROM 5 TO 25 DEGREES			PLEASE READ IN CONJUNCTION WITH STATEMENT OF ENVIRONMENTAL EFFECTS	
DCP					
WALL HEIGHT	7.2m	6.319m	UNCHANGED	YES	
NUMBER OF STOREYS	NOT IDENTIFEID	2	UNCHANGED	N/A	
SIDE BOUNDARY ENVELOPE	5m		UNCHANGED	YES	
SIDE BOUNDARY SETBACKS	0.9m	E: 0.359m W: 0.894m	UNCHANGED	NO (EXISTING)	
FRONT BOUNDARY SETBACK	6.5m	DWELLING: 12.8m	D: UNCHANGED GARAGE: 5.524m	YES NO	
REAR BOUNDARY SETBACK	6.0m	24.642m	17.772m	YES	
LANDSCAPE OPEN SPACE	40% (258m²)	64% (413.05m²)	47% (304.61m²)	YES	
PRIVATE OPEN SPACE	60m²	60m²	UNCHANGED	YES	

# 15 TANGO AVENUE DEE WHY NSW 2099

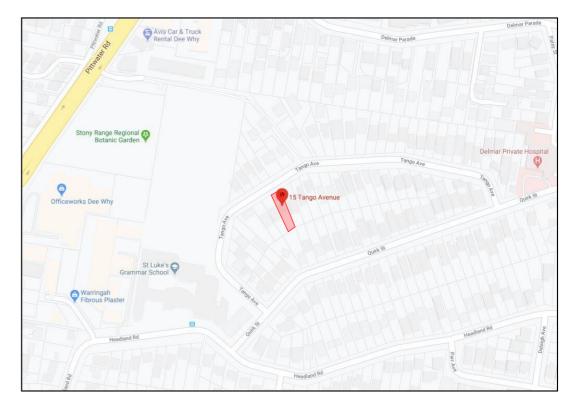

## **NCC & AS COMPLIANCES SPECIFICATIONS**

- EARTHWORKS: METHOD OF EXCAVATIONAND FILL - PART 3.1.1 OF NCC
- SURFACE SUBSOIL-STORMWATER DRAINAGE - PART 3.1.2 OF NCC
- TERMITE-RISK MANAGEMENT - PART 3.1.3 OF NCC
- FOOTINGS & SLAB - PART 3.2 OF NCC INCLUDING AS2870
- MASONRY CONSTRUCTION - PART 3.3 OF NCC INCLUDING AS3700
- SUB FLOOR VENTILATION - PART 3.4.1 OF NCC
- FRAMING - PART 3.4 OF NCC
- ROOF, WALL-CLADDING, GUTTERS & DOWNPIPES - PART 3.5 OF NCC

ROOF, WALL-CLADDING, GUTTERS & DOWNPIPES - PART 3.5 OF NCC -GLAZING - PART 3.6 OF NCC INCLUDING AS1288 -

- FIRE SEPARATION - PART 3.7.1 OF NCC

- SMOKE ALARMS - PART 3.7.2 OF NCC

- HEATING APPLIANCES - PART 3.7.3 OF NCC

- WET AREAS-PROTECTION OF WALLS & FLOORS - PART 3.8.1 OF NCC - MINIMUM ROOF HEIGHTS - PART 3.8.3 OF NCC

- FACILITIES REQUIRRED & SANITARY DOOR CONSTRUCTION - PART 3.8.3 OF NCC

- LIGHT: NATURAL AND ARTIFICIAL - PART 3.8.4 OF NCC - VENTILATION & LOCATION OF TOILETS - PART 3.8.5 OF NCC

SOUND INSULATION - PART 3.8.6 OF NCC - SOUND INSULATION - PART 3.8.6 OF NCC

- STAIR CONSTRUCTION INCLUDING DIMENSIONS - PART 3.9.1 OF NCC

- BALUSTRADES & OTHER BARRIERS - PART 3.9.2 OF NCC

- FENCING & OTHER PROVISIONS - REGS & AS1926

- DEMOLITION WORKS - AS2601-1991 THE DEMOLITION OF STRUCTURES. - ALL WATERPROOF MEMBRANES TO COMPLY WITH WITH AS 3740-2004

- ALL PLUMBING & DRAINAGE WORK TO COMPLY WITH AS 3500 - SITE CLASSIFICATION AS TO AS 2870

- ALL PLASTERBOARD WORK TO COMPLY WITH AS 2588-1998

- ALL STRUCTURAL STEEL WORK TO COMPLY WITH AS 4100 & AS 1554
- ALL CONCRETE WORK TO COMPLY WITH AS 3600

- ALL ROOF SHEETING WORK TO COMPLY WITH AS 1562-1992


- ALL SKYLIGHTS TO COMPLY WITH WITH AS 4285-2007


- ALL CERAMIC TILING TO COMPLY WITH AS 3958.1-2007 & 3958.2-1992

- ALL GLAZING ASSEMBLIES TO COMPLY WITH AS2047 & 1288 - ALL TIMBER RETAINING WALLS ARE TO COMPLY WITH AS 1720.1-2010.

AS 1720.2-2006, AS 1720.4-2006, AS 1170.1-1989 & AS 1170.4-1993 - ALL RETAINING WALLS ARE TO COMPLY WITH 3700 - 2011 & AS 3600 -2001

- ALL CONSTRUCTION TO COMPLY TO AS3959- 1991

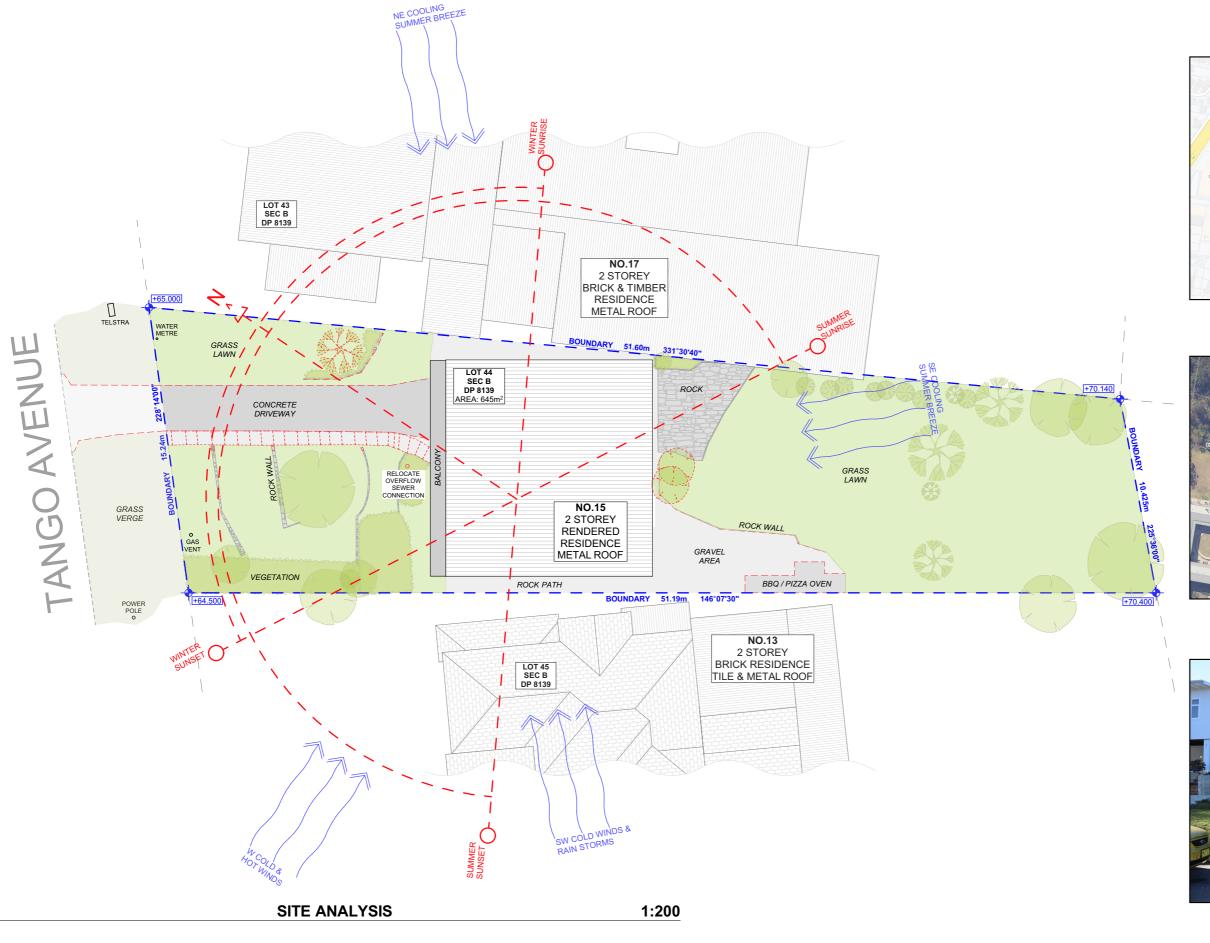

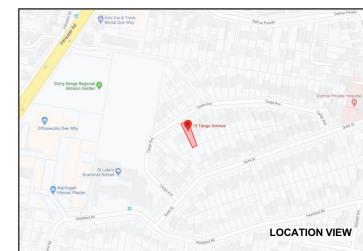






NOTE: ALL DEMOLISHED ELEMENTS TO ENG. SPECIFICATIONS AND AS. 2601 - 2001



	REV.	DATE	COMMENTS	DRWN	NOTES This drawing is the copyright of Action Plans and not be	LI
3	А	30/06/20	DA DOCUMENTATION	EAS	altered, reproduced or transmitted in any form or by any means in part or in whole with the written permission of	
					Action Plans.  Do not scale measure from drawings. Figured dimensions	
					are to be used only.  The Builder/Contractor shall check and verify all levels and	
au					dimensions on site prior to commencement of any work, creation of shop drawings, or fabrication of components.	
					All errors and omissions are to be verified by the Builder/Contractor and referred to the designer prior to the	_
					commencement of works.	

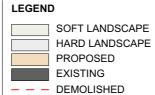

**EXISTING** EX. DOWNPIPE DP. PROPOSED PROP. DP. DOWNPIPE

CLIENT MARK HOPKINS & CATHERINE MANU


PROJECT ADDRESS 15 TANGO AVENUE DEE WHY NSW 2099 DRAWING NO.

**DA01** 

SITE ANALYSIS DATE

DRAWING NAME

SCALE Tuesday, 30 June 2020 1:200 @A3

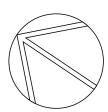



SITE / ROOF / SEDIMENT EROSION / WASTE MANAGEMENT / STORMWATER CONCEPT PLAN

1:200

TO REDUCE DUST GENERATED BY WIND ACTION, THE REMOVAL OF THE TOP SOIL IS TO BE MINIMISED. TO PREVENT DUST GENERATION, WATERING DOWN OF THE SITE, ESPECIALLY DURING THE MOVEMENT OF MACHINERY IS REQUIRED. WHERE EXCAVATING INTO ROCK, KEEP THE SURFACE MOIST TO MINIMISE DUST. CONSTRUCT A GRAVEL ENTRY/EXIT POINT USING BLUE METAL AND RESTRICT ALL VEHICLE MOVEMENTS WITHIN THE SITE TO A MINIMUM. ENSURE WIND BREAKS, SUCH AS EXISTING FENCES ARE MAINTAINED DURING THE CONSTRUCTION PHASE UNTIL NEW LANDSCAPING IS PROVIDED OR REINSTATED. PREVENT DUST BY COVERING STOCKPILES

POSTS DRIVEN 0.6m INTO GROUND

WIRE OR STEEL MESH (WHERE REQUIRED)

> ↓ UNDISTURBED AREA

3m MAX

DETAIL OF OVERLAP

**SEDIMENT FENCE** 

#### **SEDIMENT NOTE:**

1. ALL EROSION AND SEDIMENT CONTROL MEASURES TO BE INSPECTED AND MAINTAINED DAILY BY THE SITE MANAGER.

2. MINIMISE DISTURBED AREAS, REMOVE EXCESS SOIL FROM EXCAVATEDAREA AS SOON AS POSSIBLE. 3. ALL MATERIAL STOCKPILE TO BE CLEAR FROM DRAINS, GUTTERS AND FOOTPATHS, OR WITHIN SEDIMENT FENCE AREA.

4. DRAINAGE TO BE CONNECTED TO STORMWATER AS SOON AS POSSIBLE. IF STORED ON SITE, IT MUST BE FILTERED BEFORE RELEASING INTO STORMWATER SYSTEM OR WATERWAYS

5. ROADS AND FOOTPATHS TO BE SWEPT DAILY.

#### STOCKPILES:

ALL STOCKPILES ARE TO BE KEPT ON-SITE WHERE POSSIBLE. ANY MATERIALS PLACED ON THE FOOTPATHS OR NATURE STRIPS REQUIRE COUNCIL'S PERMISSION.

ALL STOCKPILES ARE TO BE PLACED AWAY FROM THE DRAINAGE LINES AND STREET GUTTERS. IT IS BEST TO LOCATE THESE ON THE HIGHEST PART OF THE SITE IF POSSIBLE. PLACE WATERPROOF COVERING OVER STOCKPILES.

IF REQUIRED PROVIDE DIVERSION DRAIN & BANK AROUND STOCKPILES.

## **GUTTER PROTECTION:**


PROVIDE PROTECTION TO DOWNHILL GRATE IN GUTTER BY MEANS OF SAND BAGS OR BLUE METAL WRAPPED IN GEOTEXTILE FABRIC. WHEN SOIL OR SAND BUILDS UP AROUND THIS SEDIMENT BARRIER, THE MATERIAL SHOULD BE RELOCATED BACK TO THE SITE FOR DISPOSAL

NOTE: ALL PROPOSED STORMWATER TO CONNECT WITH EXISTING

	ACTION PLANS
4	m: 0426 957 518 e:operations@actionplans.com.au

www.actionplans.com.au

REV.	DATE	COMMENTS	DRWN	NOTES This drawing is the copyright of Action Plans and not be
Α	30/06/20	DA DOCUMENTATION	EAS	altered, reproduced or transmitted in any form or by any means in part or in whole with the written permission of
				Action Plans.  Do not scale measure from drawings. Figured dimensions
				are to be used only.  The Builder/Contractor shall check and verify all levels ar
				dimensions on site prior to commencement of any work, creation of shop drawings, or fabrication of components.
				All errors and omissions are to be verified by the Builder/Contractor and referred to the designer prior to the
				commencement of works.

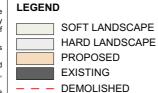

EX. **EXISTING** DP. DOWNPIPE PROP. PROPOSED DP. DOWNPIPE

MARK HOPKINS & **CATHERINE MANU** 

CLIENT

PROJECT ADDRESS 15 TANGO AVENUE DEE WHY NSW 2099

DRAWING NO.

**DA02** 

DATE


Tuesday, 30 June 2020


#### **DRAWING NAME**

SITE / ROOF / SEDIMENT EROSION / WASTE MANAGEMENT / STORMWATER CONCEPT PLAN

**SCALE** 


1:200 @A3

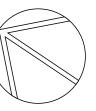

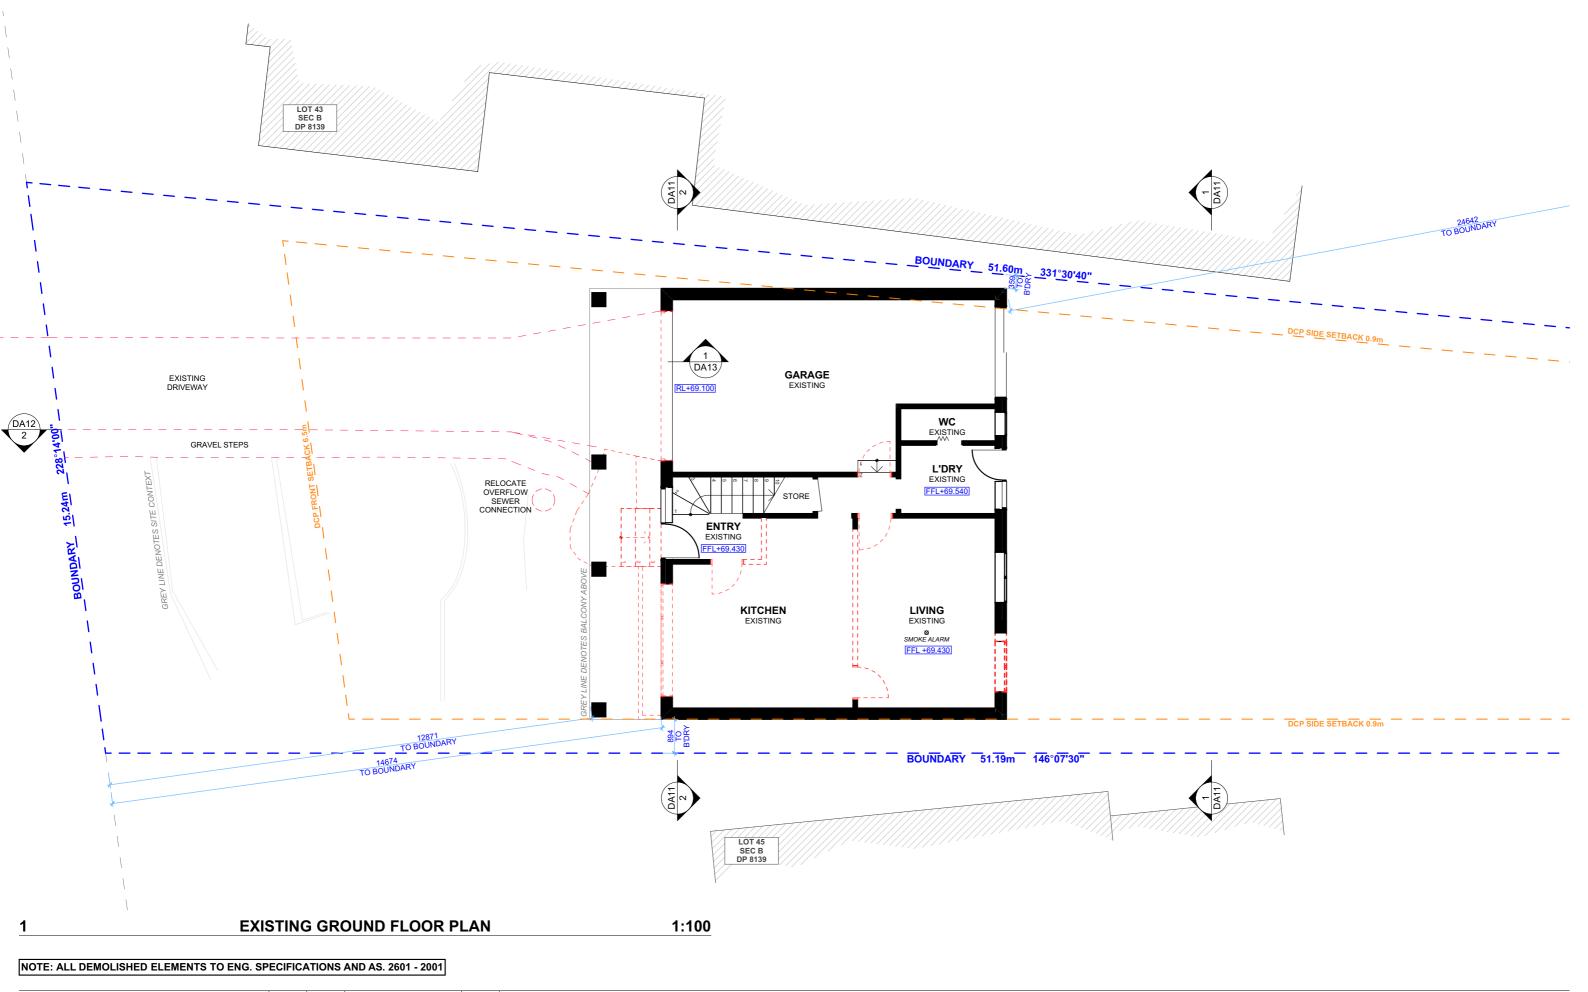



REV.	DATE	COMMENTS	DRWN	NOTES
А	30/06/20	DA DOCUMENTATION	EAS	This drawing is the copyright of Action Plans and not be altered, reproduced or transmitted in any form or by any means in part or in whole with the written permission of
				Action Plans.  Do not scale measure from drawings. Figured dimensions
				are to be used only.  The Builder/Contractor shall check and verify all levels and
				dimensions on site prior to commencement of any work, creation of shop drawings, or fabrication of components.
				All errors and omissions are to be verified by the Builder/Contractor and referred to the designer prior to the

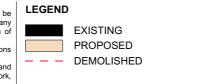

PROJECT ADDRESS 15 TANGO AVENUE DEE WHY NSW 2099 DA03

--


DATE


Tuesday, 30 June 2020

DRAWING NAME
EXISTING GROUND FLOOR

PLAN


SCALE 1:100 @A3

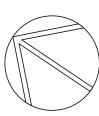

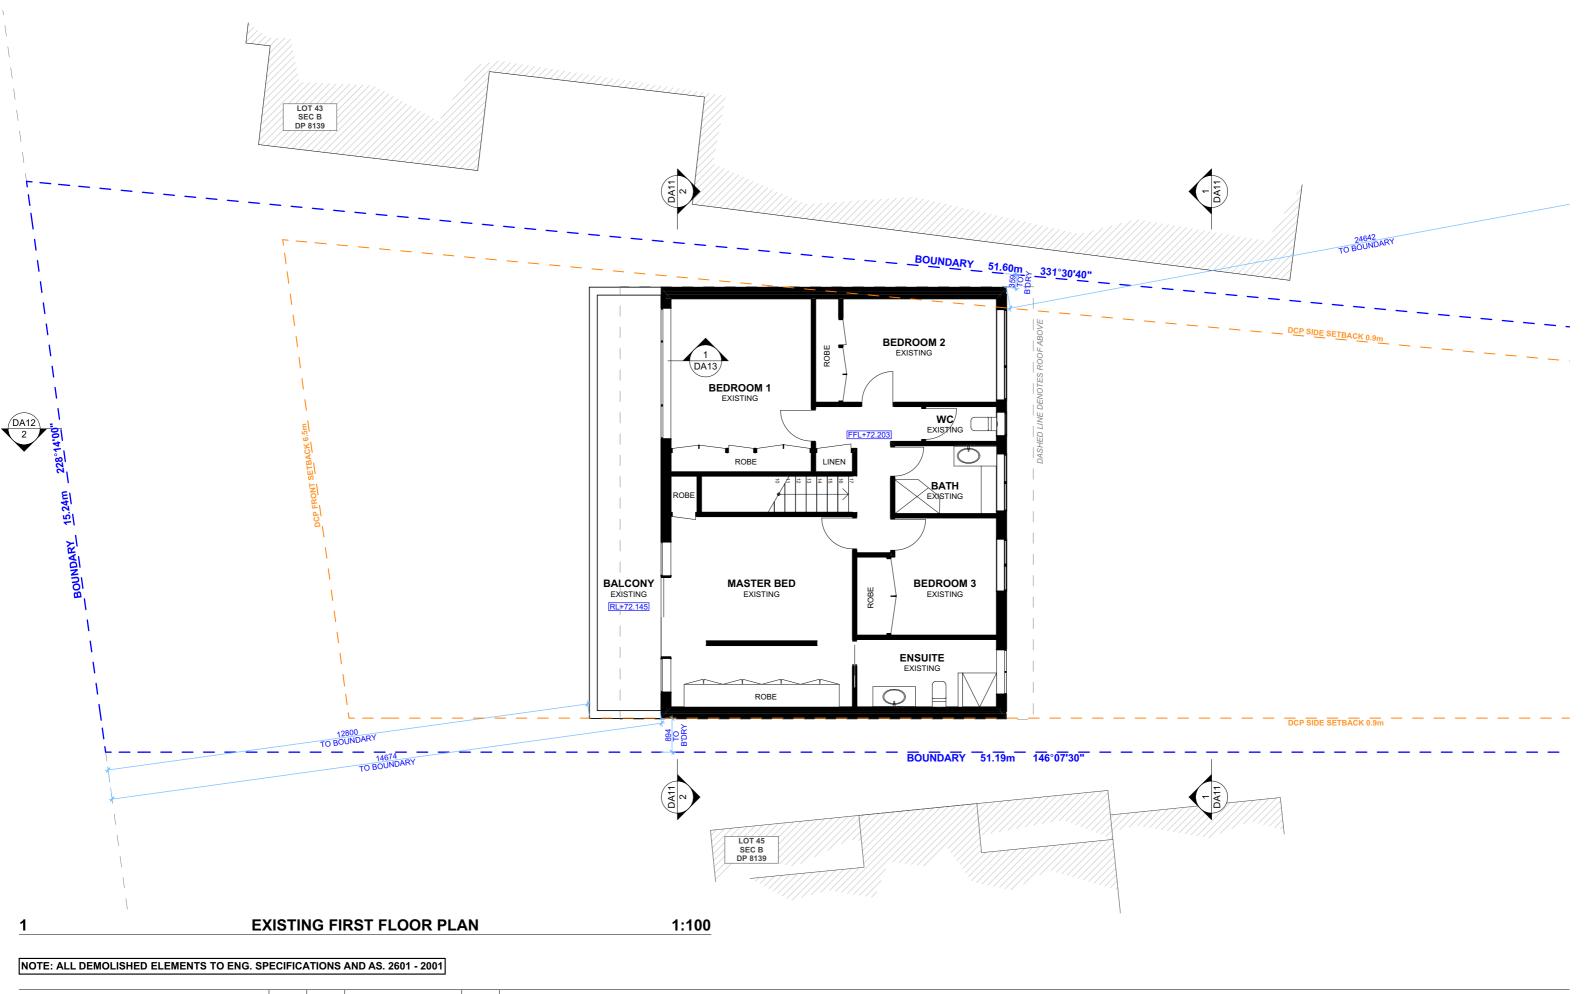



REV.	DATE	COMMENTS	DRWN	NOTES This drawing is the copyright of Action Plans and not be
А	30/06/20	DA DOCUMENTATION	EAS	altered, reproduced or transmitted in any form or by any means in part or in whole with the written permission of
				Action Plans.  Do not scale measure from drawings. Figured dimensions
				are to be used only.  The Builder/Contractor shall check and verify all levels and
				dimensions on site prior to commencement of any work, creation of shop drawings, or fabrication of components.
				All errors and omissions are to be verified by the Builder/Contractor and referred to the designer prior to the
				commencement of works.

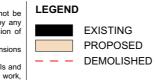


PROJECT ADDRESS 15 TANGO AVENUE DEE WHY NSW 2099 DA04

**)4** EXISTING FIRST FLOOR PLAN

**DATE**Tuesday, 30 June 2020


DRAWING NAME



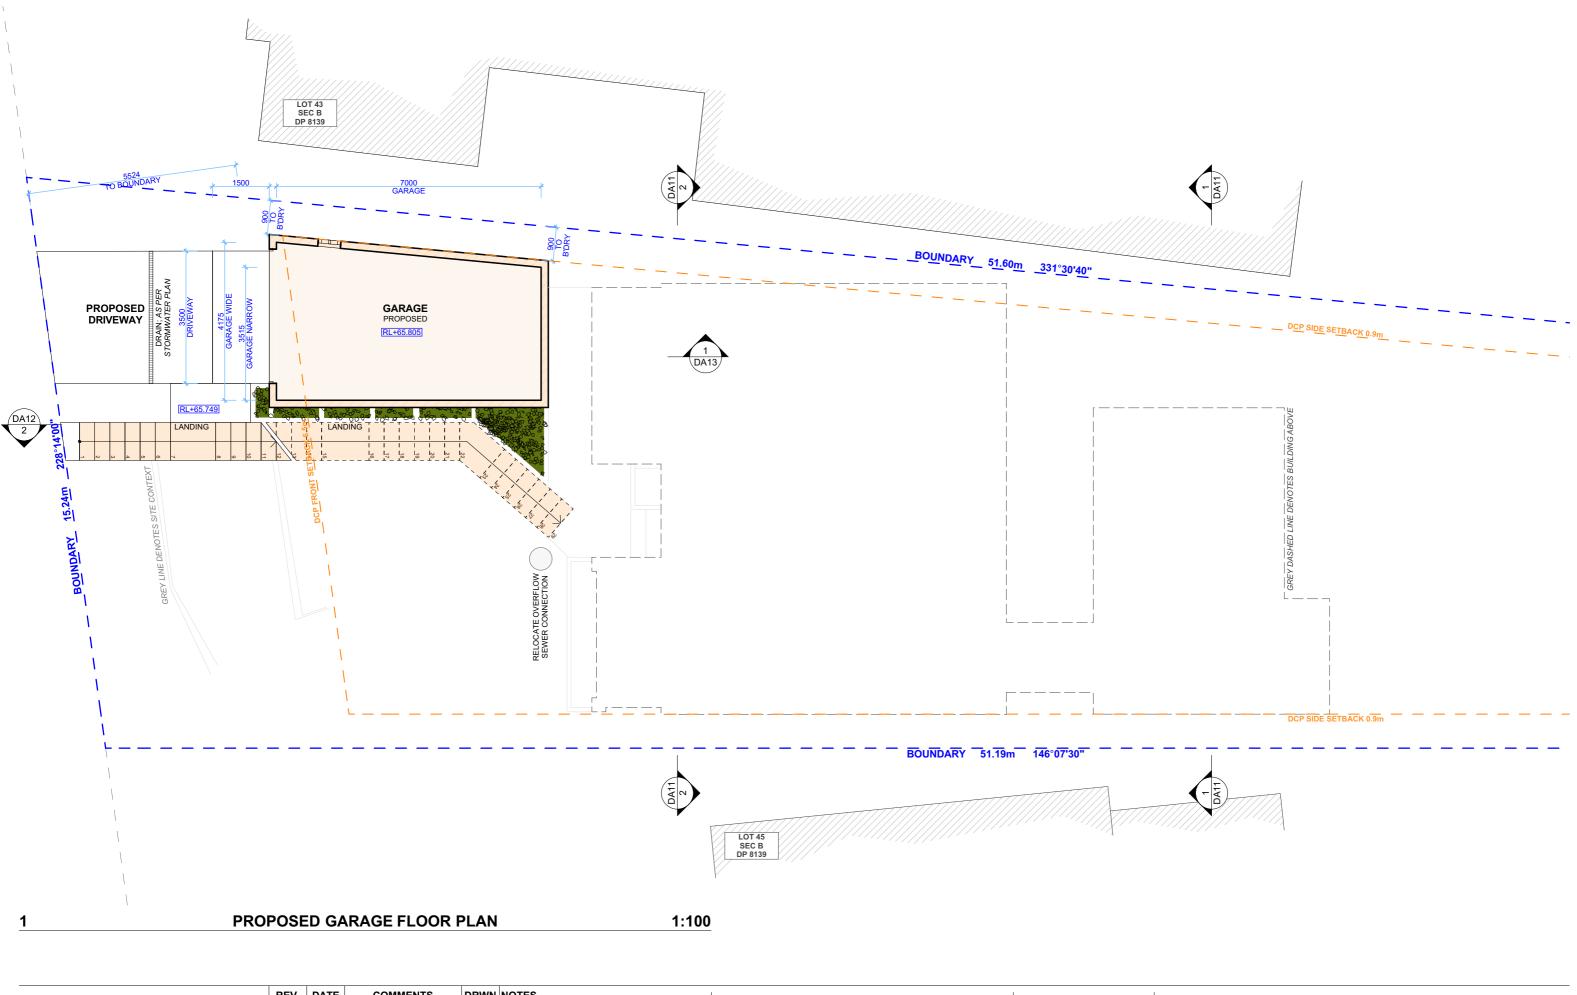



REV.	DATE	COMMENTS	DRWN	This drawing is the copyright of Action Plans and not be	L
А	30/06/20	DA DOCUMENTATION	EAS	altered, reproduced or transmitted in any form or by any means in part or in whole with the written permission of	
				Action Plans.	
				Do not scale measure from drawings. Figured dimensions	L
				are to be used only.	
				The Builder/Contractor shall check and verify all levels and	
				dimensions on site prior to commencement of any work,	
				creation of shop drawings, or fabrication of components.	
				All errors and omissions are to be verified by the	
				Builder/Contractor and referred to the designer prior to the	

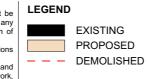


PROJECT ADDRESS 15 TANGO AVENUE DEE WHY NSW 2099 DRAWING NO.


Tuesday, 30 June 2020

DATE

DRAWING NAME
PROPOSED GARAGE FLOOR
PLAN

SCALE 1:100 @A3

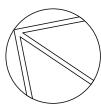


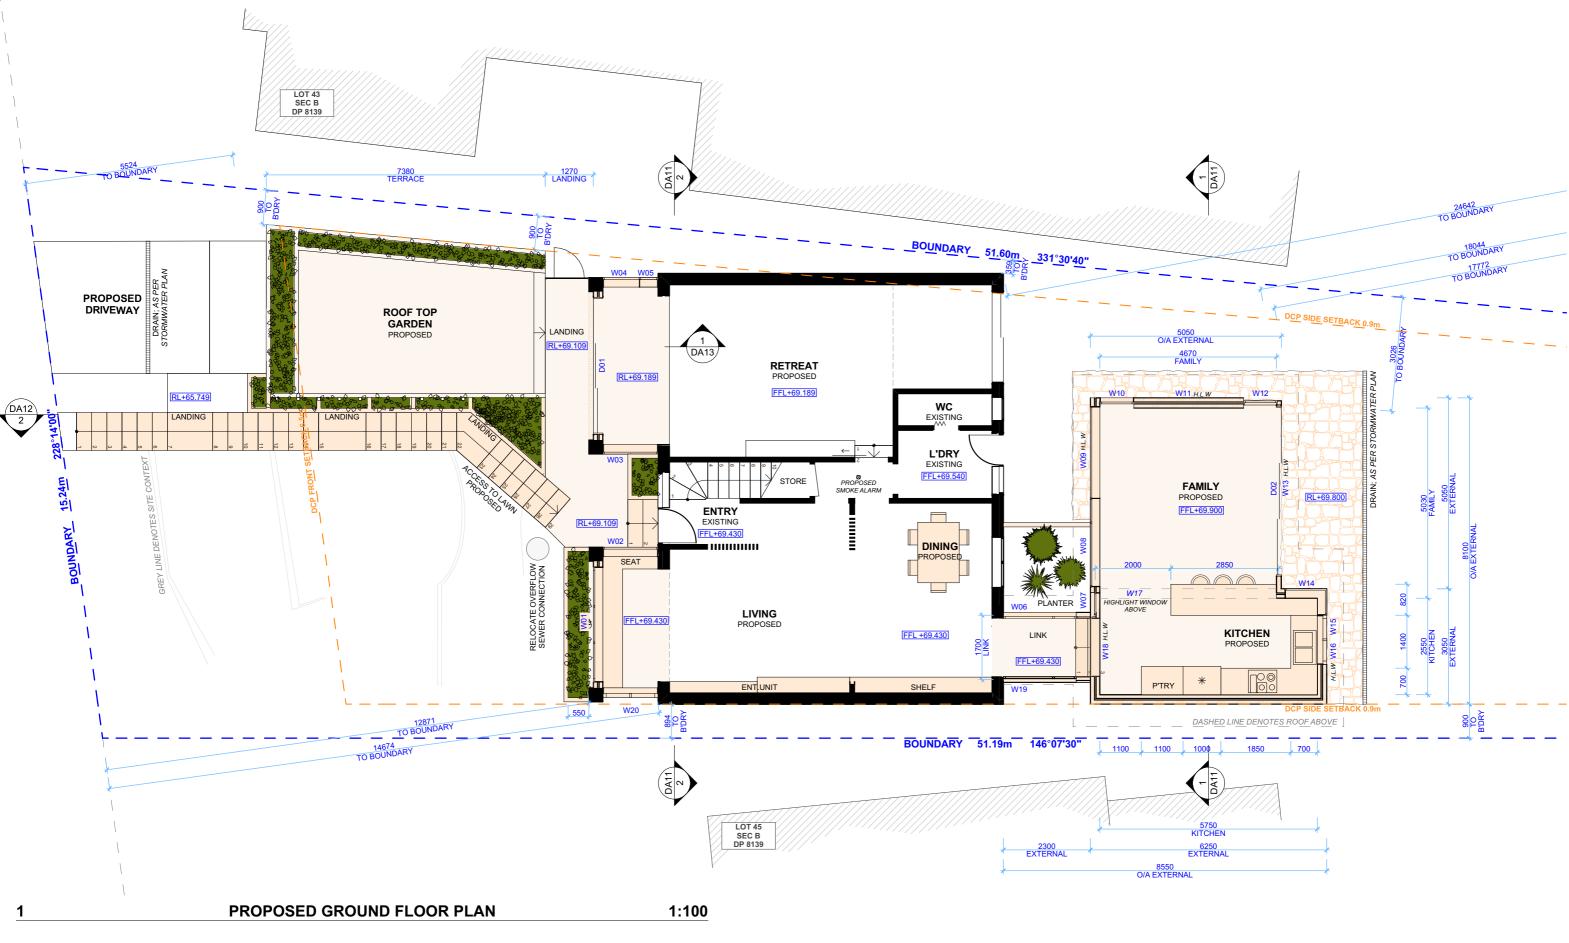

NOTE: SMOKE ALARMS TO COMPLY WITH PART 3.7.2 OF NCC



REV.	DATE	COMMENTS	DRWN	NOTES
А	30/06/20	DA DOCUMENTATION	EAS	This drawing is the copyright of Action Plans and not be altered, reproduced or transmitted in any form or by any means in part or in whole with the written permission of
				Action Plans.  Do not scale measure from drawings. Figured dimensions
				are to be used only.  The Builder/Contractor shall check and verify all levels and
				dimensions on site prior to commencement of any work, creation of shop drawings, or fabrication of components.
				All errors and omissions are to be verified by the Builder/Contractor and referred to the designer prior to the

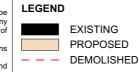

CLIENT

MARK HOPKINS &
CATHERINE MANU

PROJECT ADDRESS 15 TANGO AVENUE DEE WHY NSW 2099 DA06


Tuesday, 30 June 2020


DATE PLAN

SCALE 1:100 @A3

PROPOSED GROUND FLOOR

DRAWING NAME

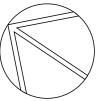

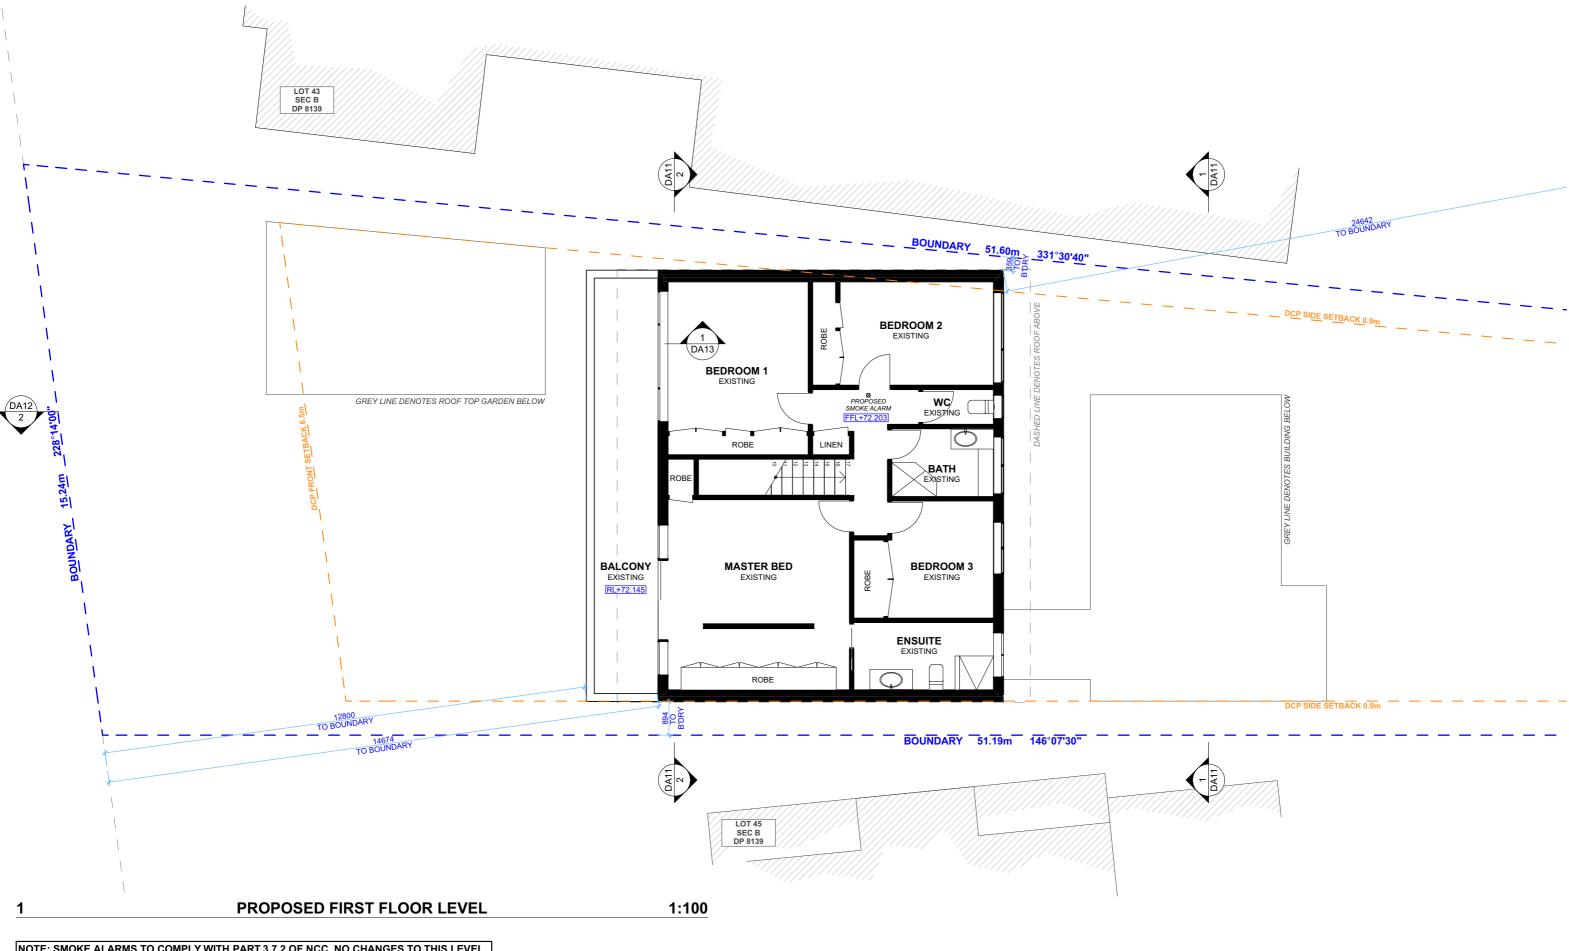


# NOTE: SMOKE ALARMS TO COMPLY WITH PART 3.7.2 OF NCC. NO CHANGES TO THIS LEVEL.



REV.	DATE	COMMENTS	DRWN	NOTES This drawing is the copyright of Action Plans and not be
А	30/06/20	DA DOCUMENTATION	EAS	altered, reproduced or transmitted in any form or by any means in part or in whole with the written permission of
				Action Plans.  Do not scale measure from drawings. Figured dimensions
				are to be used only.  The Builder/Contractor shall check and verify all levels and
				dimensions on site prior to commencement of any work, creation of shop drawings, or fabrication of components.
				All errors and omissions are to be verified by the

commencement of works.

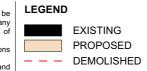

CLIENT MARK HOPKINS & CATHERINE MANU

PROJECT ADDRESS 15 TANGO AVENUE DEE WHY NSW 2099

DRAWING NO. **DA07** 


PROPOSED FIRST FLOOR PLAN


DATE


Tuesday, 30 June 2020


SCALE 1:100 @A3

DRAWING NAME

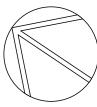

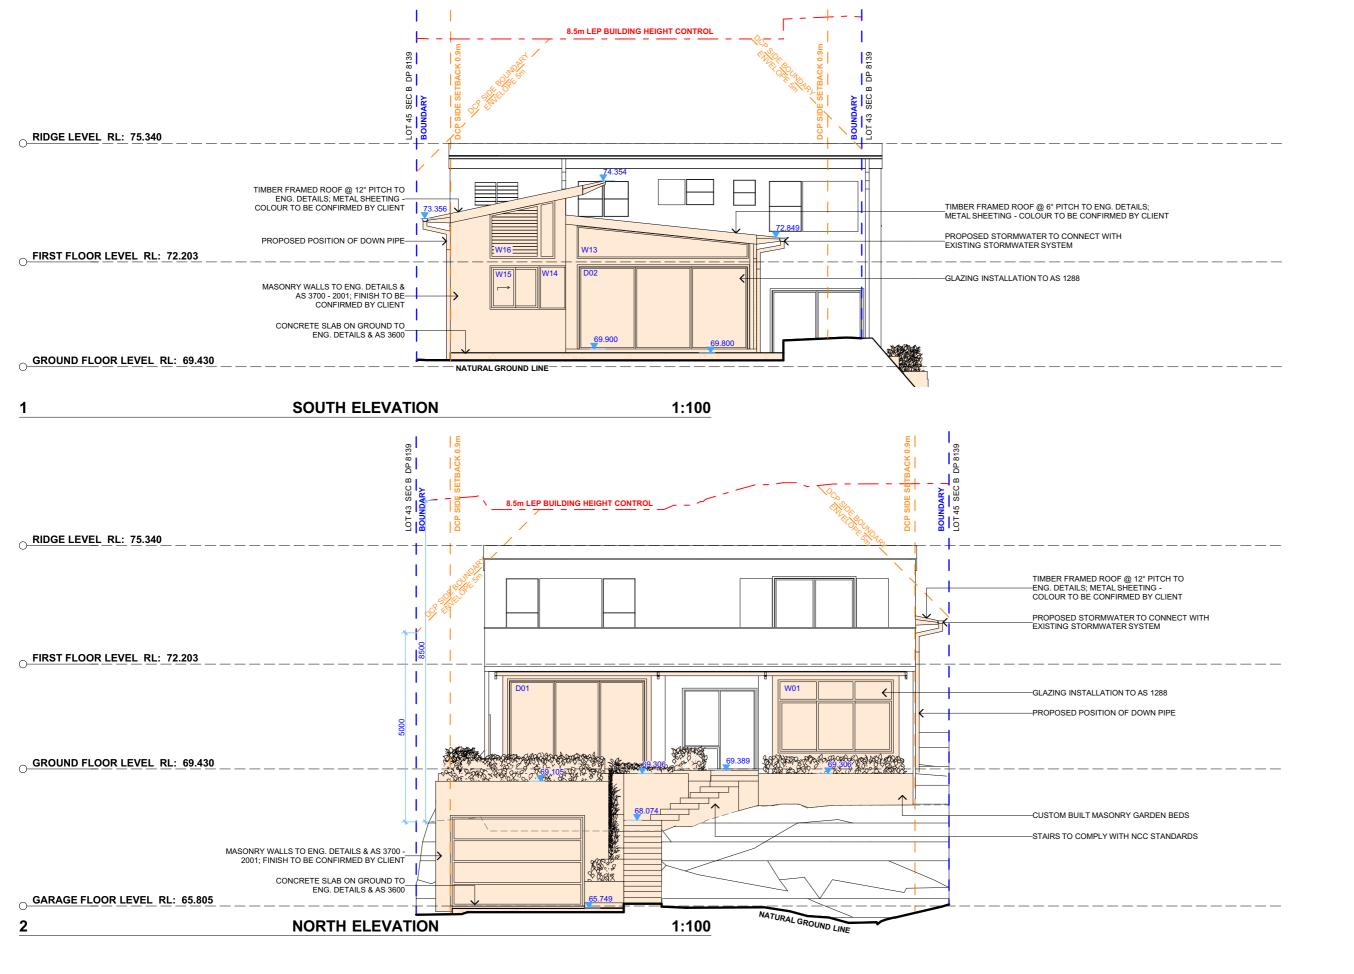

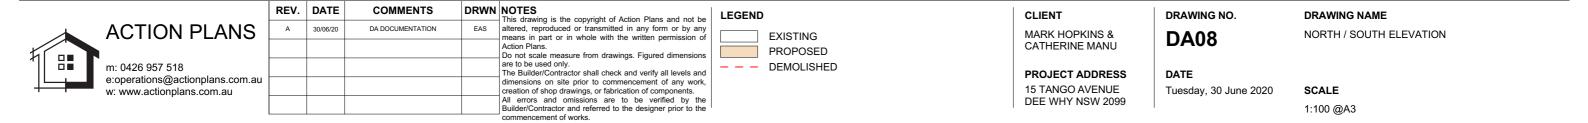

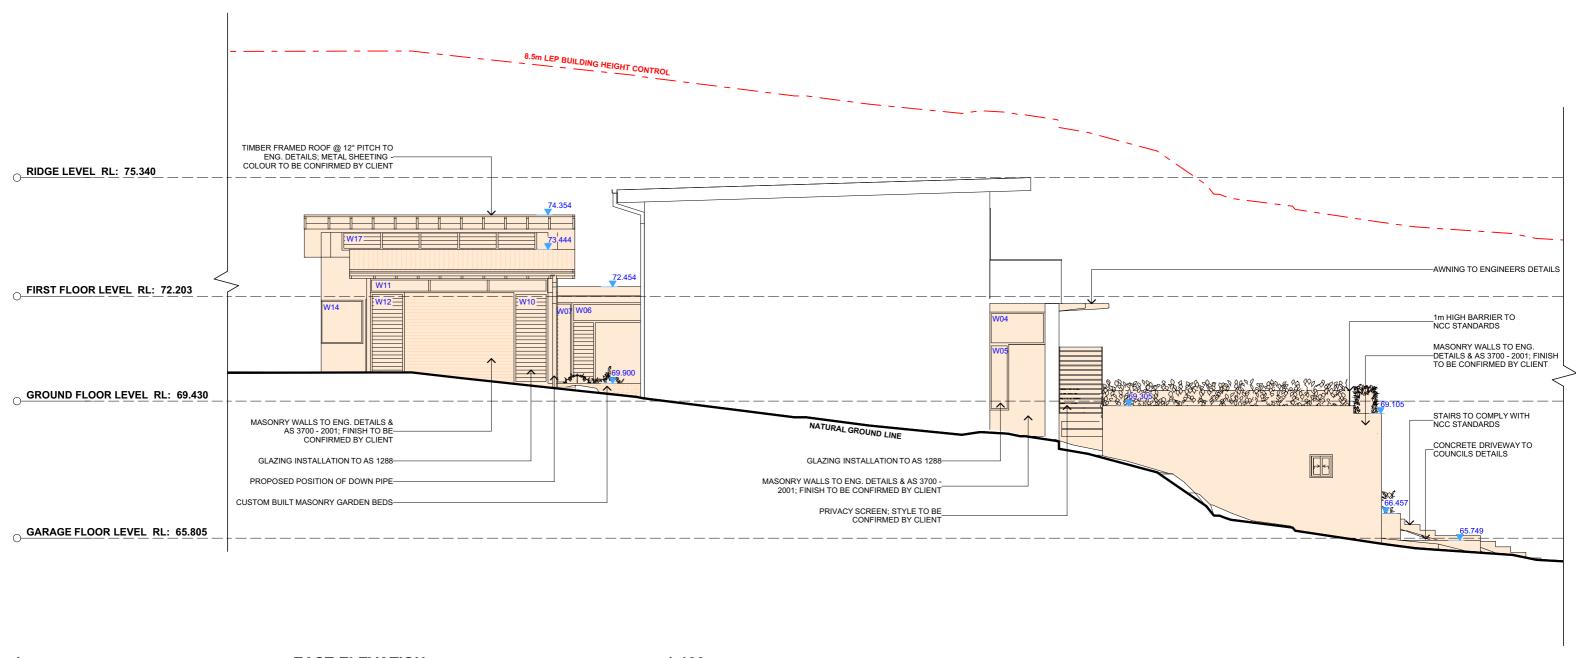

**EAST ELEVATION** 1:100



	REV.	DATE	COMMENTS	DRWN	NOTES
,	Α	30/06/20	DA DOCUMENTATION	EAS	This drawing is the copyright of Action Plans and not be altered, reproduced or transmitted in any form or by any means in part or in whole with the written permission of
					Action Plans.  Do not scale measure from drawings. Figured dimensions are to be used only.
au					The Builder/Contractor shall check and verify all levels and dimensions on site prior to commencement of any work, creation of shop drawings, or fabrication of components.
					All errors and omissions are to be verified by the Builder/Contractor and referred to the designer prior to the commencement of works.




CLIENT	DRAWING NO.
MARK HOPKINS & CATHERINE MANU	DA09
PROJECT ADDRESS	DATE

15 TANGO AVENUE

SCALE Tuesday, 30 June 2020 DEE WHY NSW 2099 1:100 @A3

DRAWING NAME

EAST ELEVATION

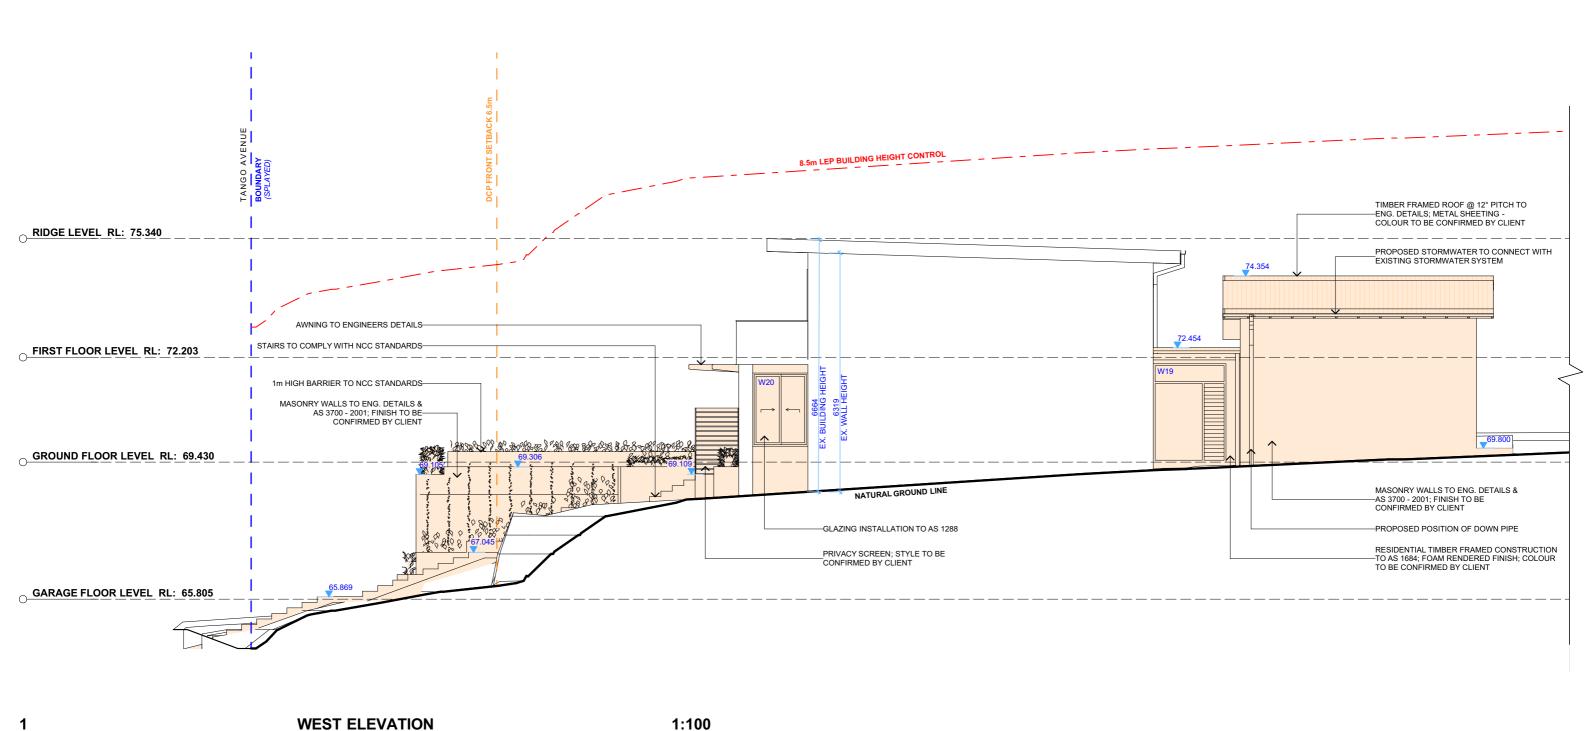

LEGEND

**EXISTING** 

- - - DEMOLISHED

PROPOSED

DRAWING NO.

Tuesday, 30 June 2020

**DA10** 

DATE

DRAWING NAME

WEST ELEVATION

SCALE

1:100 @A3

CLIENT

MARK HOPKINS & CATHERINE MANU

PROJECT ADDRESS

15 TANGO AVENUE

DEE WHY NSW 2099

DRWN

BAS

This drawing is the copyright of Action Plans and not be altered, reproduced or transmitted in any form or by any means in part or in whole with the written permission of Action Plans.

Do not scale measure from drawings. Figured dimensions are to be used only.

Do not scale measure from drawings. Figured dimensions are to be used only.

The Builder/Contractor shall check and verify all levels and dimensions on site prior to commencement of any work, creation of shop drawings, or fabrication of components.

All errors and omissions are to be verified by the Builder/Contractor and referred to the designer prior to the commencement of works.

REV. DATE

30/06/20

**ACTION PLANS** 


e:operations@actionplans.com.au

w: www.actionplans.com.au

m: 0426 957 518

COMMENTS


DA DOCUMENTATION

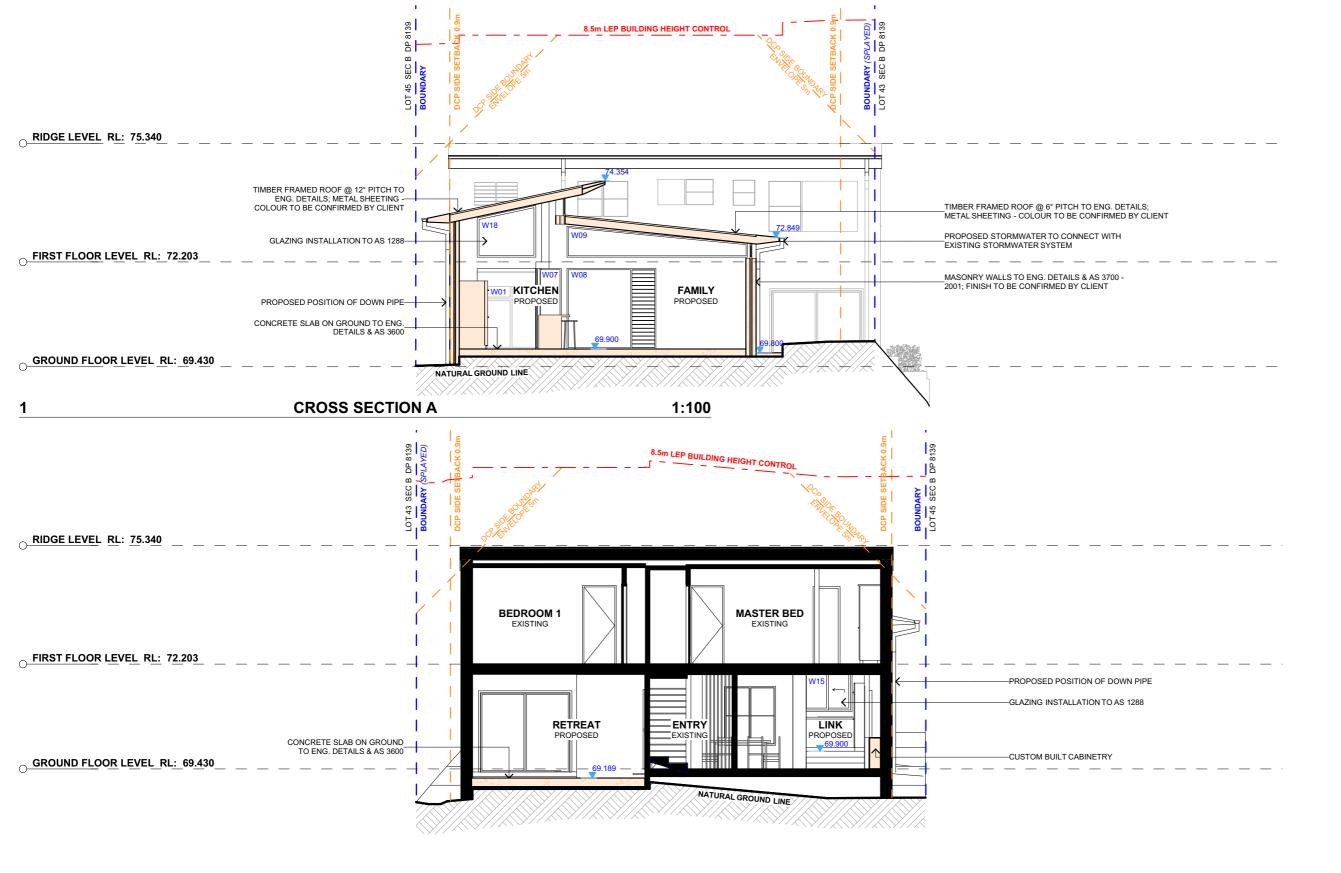

**CROSS SECTION B** 1:100



REV.	DATE	COMMENTS	DRWN	NOTES
А	30/06/20	DA DOCUMENTATION	EAS	This drawing is the copyright of Action Plans and not be altered, reproduced or transmitted in any form or by any means in part or in whole with the written permission of
				Action Plans. Do not scale measure from drawings. Figured dimensions
				are to be used only. The Builder/Contractor shall check and verify all levels and
				dimensions on site prior to commencement of any work, creation of shop drawings, or fabrication of components.
				All errors and omissions are to be verified by the Builder/Contractor and referred to the designer prior to the

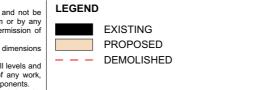


CLIENT	
MARK HOPKINS & CATHERINE MANU	

PROJECT ADDRESS
15 TANGO AVENIJE


PROJECT ADDRESS	DATE
15 TANGO AVENUE DEE WHY NSW 2099	Tuesday


DRAWING NO.	DRAWING NAME
DA11	CROSS SECTION

ATE	
uesday, 30 June 2020	SCALE
	1.100 @∆3

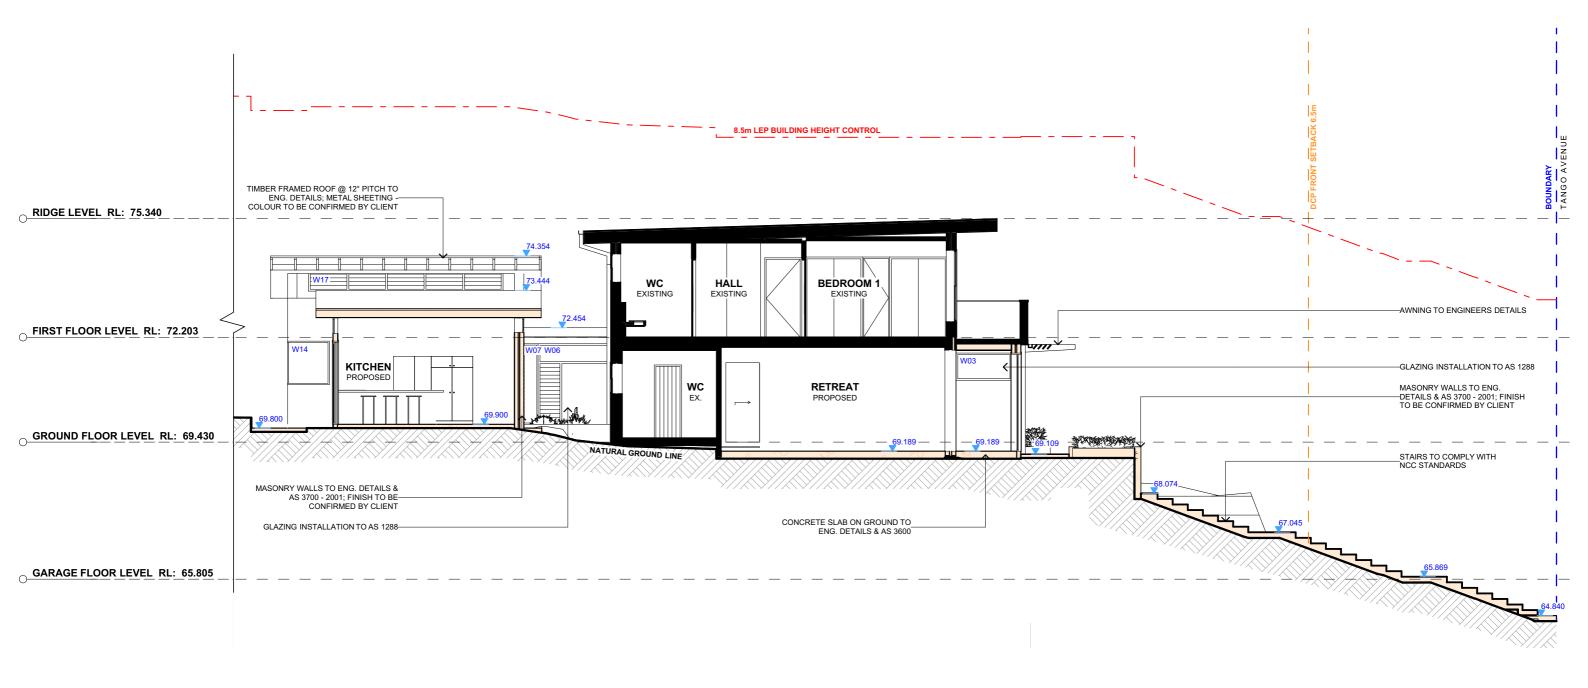


2 LONG SECTION 1:100

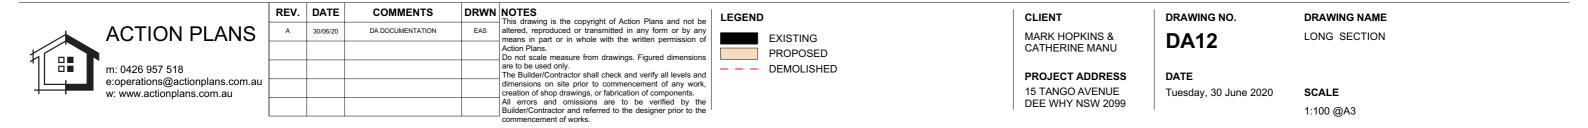

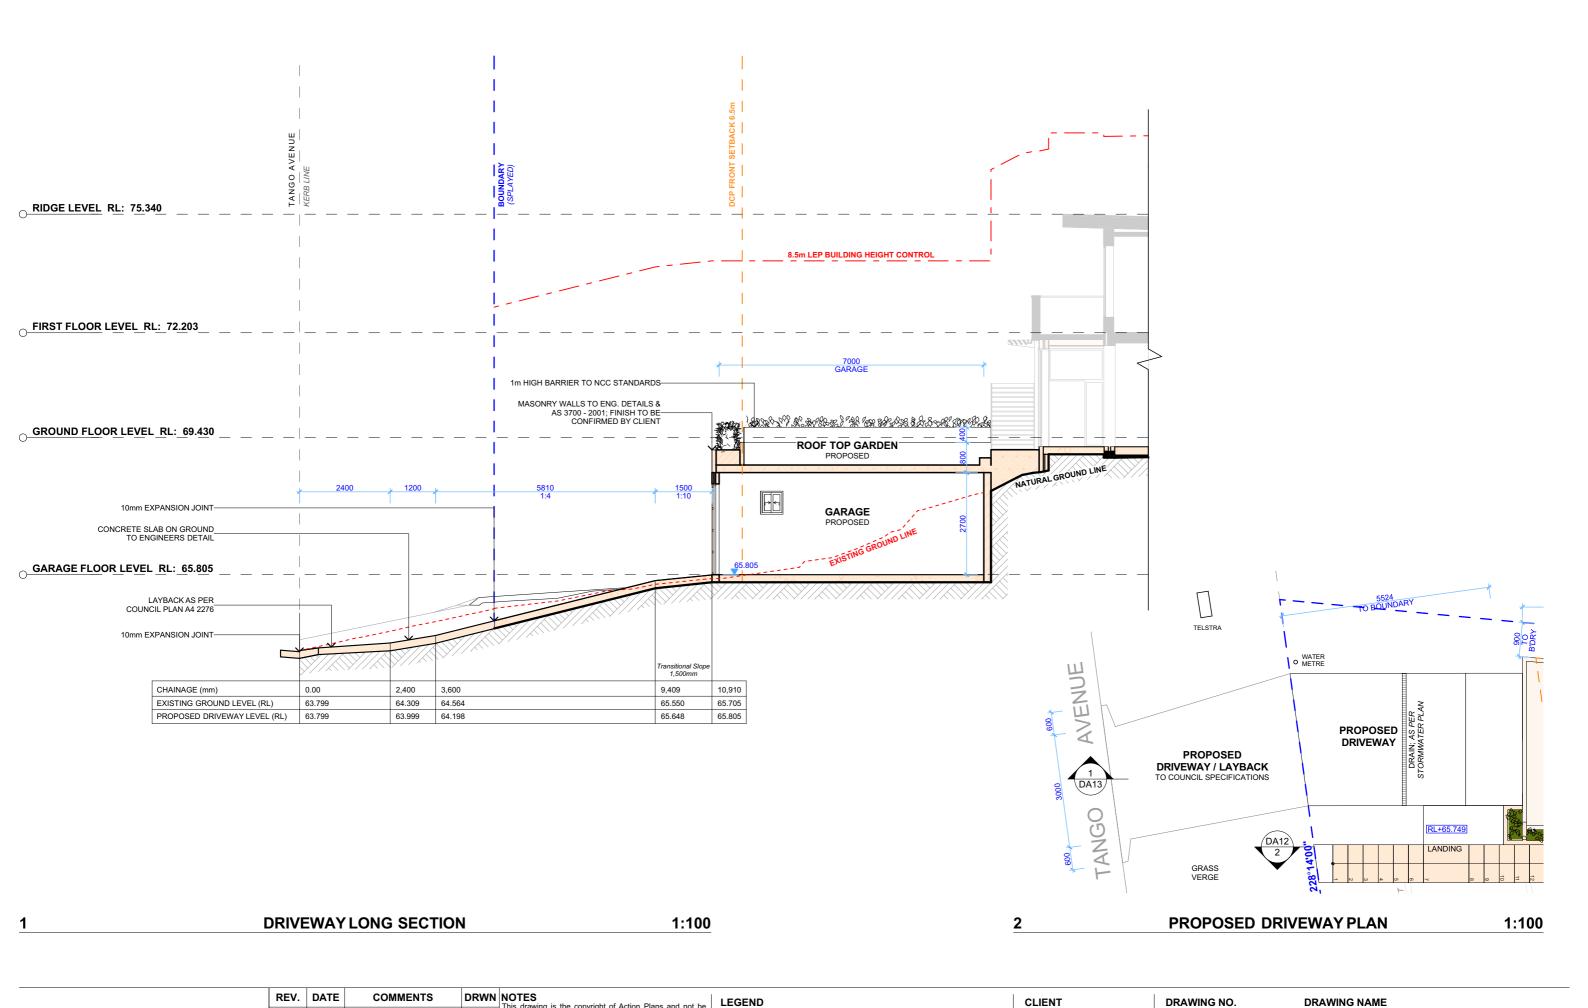



IVE V.	DAIL	COMMENT	DIXIII	This describes in the conscious of Autient Discount and
Α	30/06/20	DA DOCUMENTATION	EAS	This drawing is the copyright of Action Plans and not altered, reproduced or transmitted in any form or by means in part or in whole with the written permission
				Action Plans.  Do not scale measure from drawings. Figured dimensi
				are to be used only. The Builder/Contractor shall check and verify all levels
				dimensions on site prior to commencement of any was creation of shop drawings, or fabrication of components.
				All errors and omissions are to be verified by Builder/Contractor and referred to the designer prior to

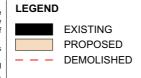

PROJECT ADDRESS 15 TANGO AVENUE DEE WHY NSW 2099 DA13

DRIVEWAY PLAN / LONG SECTION

DATE


Tuesday, 30 June 2020


ECTION

SCALE 1:100 @A3



1 EXISTING AREA CALCULATIONS 1:200

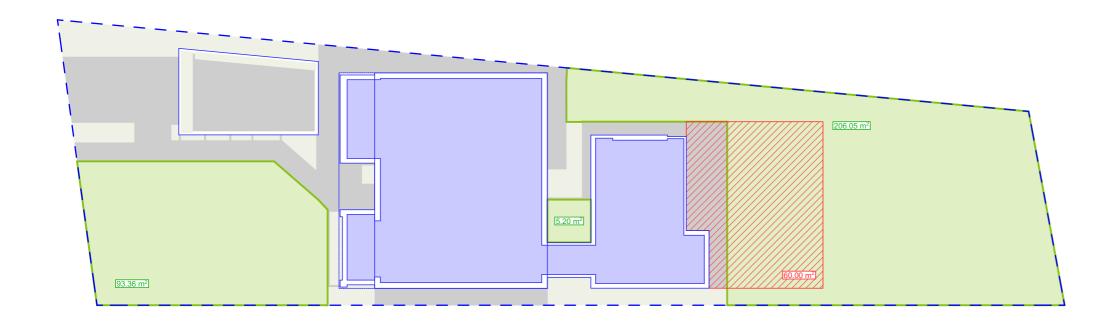

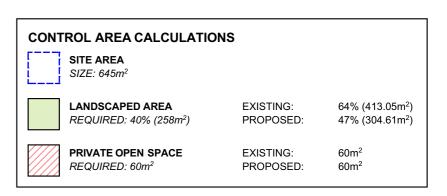

PROPOSED AREA CALCULATIONS 1:200



REV.	DATE	COMMENTS	DRWN	NOTES This drawing is the copyright of Action Plans and not be
А	30/06/20	DA DOCUMENTATION	EAS	altered, reproduced or transmitted in any form or by any means in part or in whole with the written permission of
				Action Plans.  Do not scale measure from drawings. Figured dimensions are to be used only.
				The Builder/Contractor shall check and verify all levels and dimensions on site prior to commencement of any work,
				creation of shop drawings, or fabrication of components.  All errors and omissions are to be verified by the Builder/Contractor and referred to the designer prior to the
		I		commencement of works.

LEGEND

MARK HOPKINS & CATHERINE MANU

CLIENT


PROJECT ADDRESS 15 TANGO AVENUE DEE WHY NSW 2099 DA14

**DRAWING NAME**AREA CALCULATIONS

DATE


Tuesday, 30 June 2020

0 **SCALE** 1:200 @A3

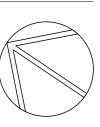




**OPEN EAVE DETAIL**STYLE TO BE CONFIRMED BY CLIENT

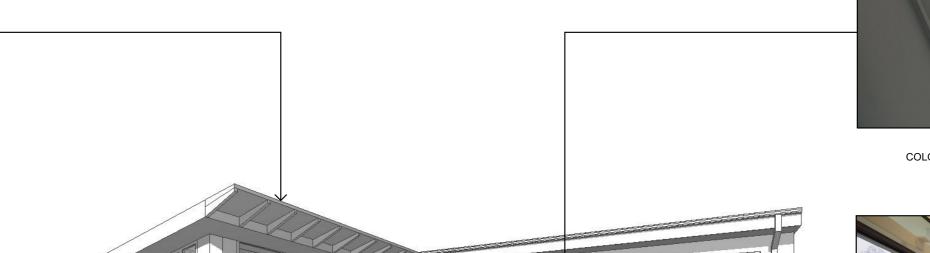

METAL SHEET ROOFING COLOUR TO BE CONFIRMED BY CLIENT



ALUMINIUM FRAMED CORNER WINDOW BY STEGBAR OR OTHER

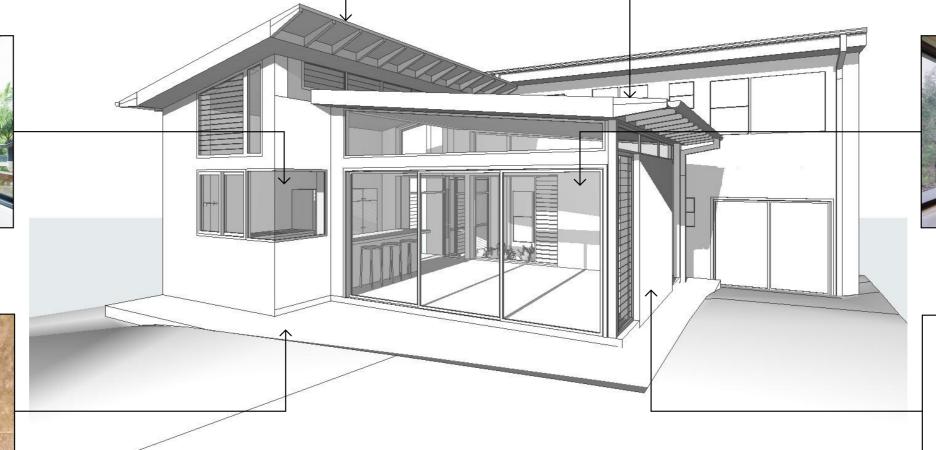

ALUMINIUM FRAMED DOORS BY STEGBAR OR OTHER



PAVED LANDSCAPED AREA
MATERIAL TO BE CONFIRMED BY CLIENT

RENDERED FINISH
COLOUR TO BE CONFIRMED BY CLIENT

# SAMPLE BOARD



	REV.	DATE	COMMENTS	DRWN	NOTES
u	А	30/06/20	DA DOCUMENTATION	EAS	This drawing is the copyright of Action Plans and not be altered, reproduced or transmitted in any form or by any means in part or in whole with the written permission of Action Plans.
					Do not scale measure from drawings. Figured dimensions are to be used only.  The Builder/Contractor shall check and verify all levels and
					dimensions on site prior to commencement of any work, creation of shop drawings, or fabrication of components.  All errors and omissions are to be verified by the Builder/Contractor and referred to the designer prior to the
					commencement of works.

LEGEND

MARK HOPKINS & CATHERINE MANU

CLIENT

PROJECT ADDRESS 15 TANGO AVENUE DEE WHY NSW 2099 DRAWING NO.


**DRAWING NAME**SAMPLE BOARD

DATE

Tuesday, 30 June 2020


SCALE

@A3

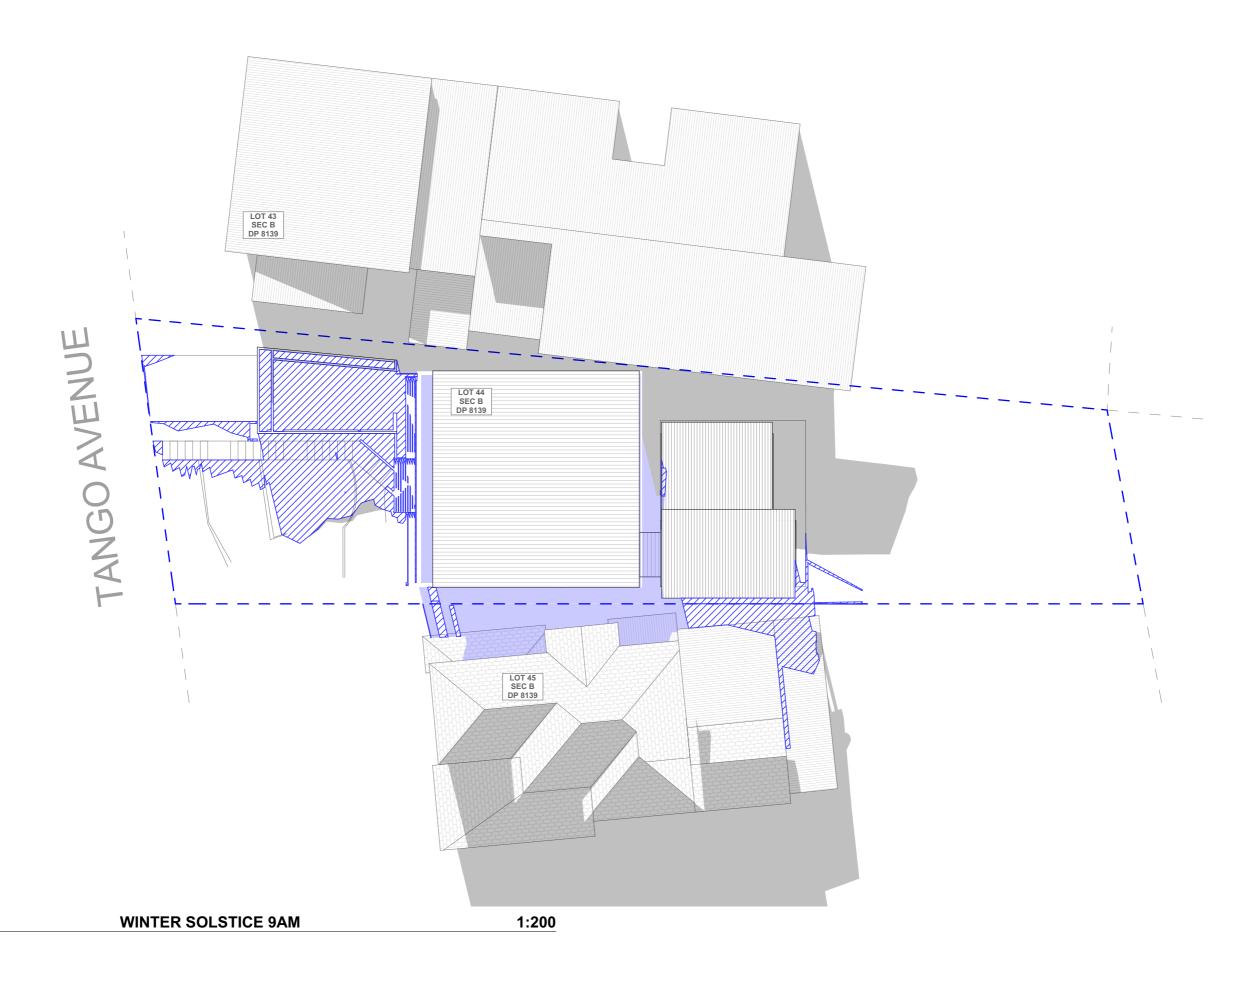



	REV.	DATE	COMMENTS	DRWN	NOTES	п
	А	30/06/20	DA DOCUMENTATION	EAS	This drawing is the copyright of Action Plans and not be altered, reproduced or transmitted in any form or by any means in part or in whole with the written permission of	
					Action Plans.	7
					Do not scale measure nom drawings. I igured dimensions	$\square$
					are to be used only.  The Builder/Contractor shall check and verify all levels and	
u					dimensions on site prior to commencement of any work, creation of shop drawings, or fabrication of components.	
					All errors and omissions are to be verified by the Builder/Contractor and referred to the designer prior to the	
					commencement of works.	

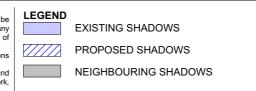


PROJECT ADDRESS 15 TANGO AVENUE DEE WHY NSW 2099 DRAWING NO.


**DA16** 

**DATE**Tuesday, 30 June 2020

DRAWING NAME
WINTER SOLSTICE 9 AM


SCALE 1:200 @A3

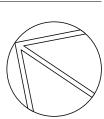

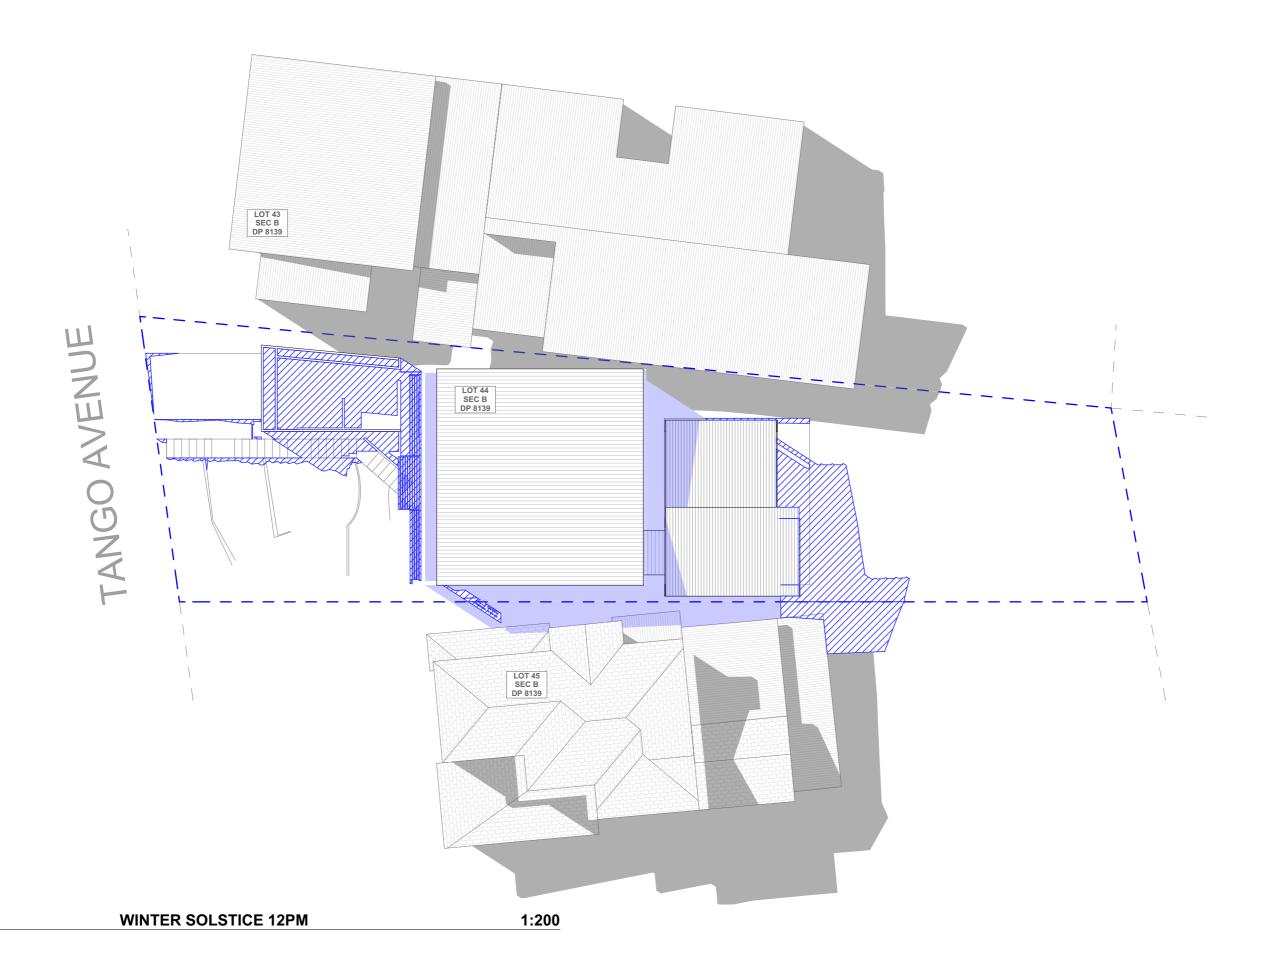



	REV.	DATE	COMMENTS	DRWN	NOTES This drawing is the copyright of Action Plans and not be	_
	Α	30/06/20	DA DOCUMENTATION	EAS	altered, reproduced or transmitted in any form or by any means in part or in whole with the written permission of	
					1	/
					are to be used only. The Builder/Contractor shall check and verify all levels and	
u					dimensions on site prior to commencement of any work, creation of shop drawings, or fabrication of components.	
					All errors and omissions are to be verified by the Builder/Contractor and referred to the designer prior to the	
					commencement of works.	

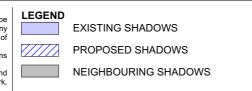

CLIENI
MARK HOPKINS & CATHERINE MANU


PROJECT ADDRESS	
15 TANGO AVENUE	
DEE WHY NSW 2099	


DRAWING NO. DRAWING NAME

DA17 WINTER SOLSTICE 12 PM

DA17 WINTER SOLSTICE

Tuesday, 30 June 2020 **SCALE** 1:200 @A3

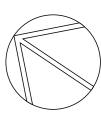


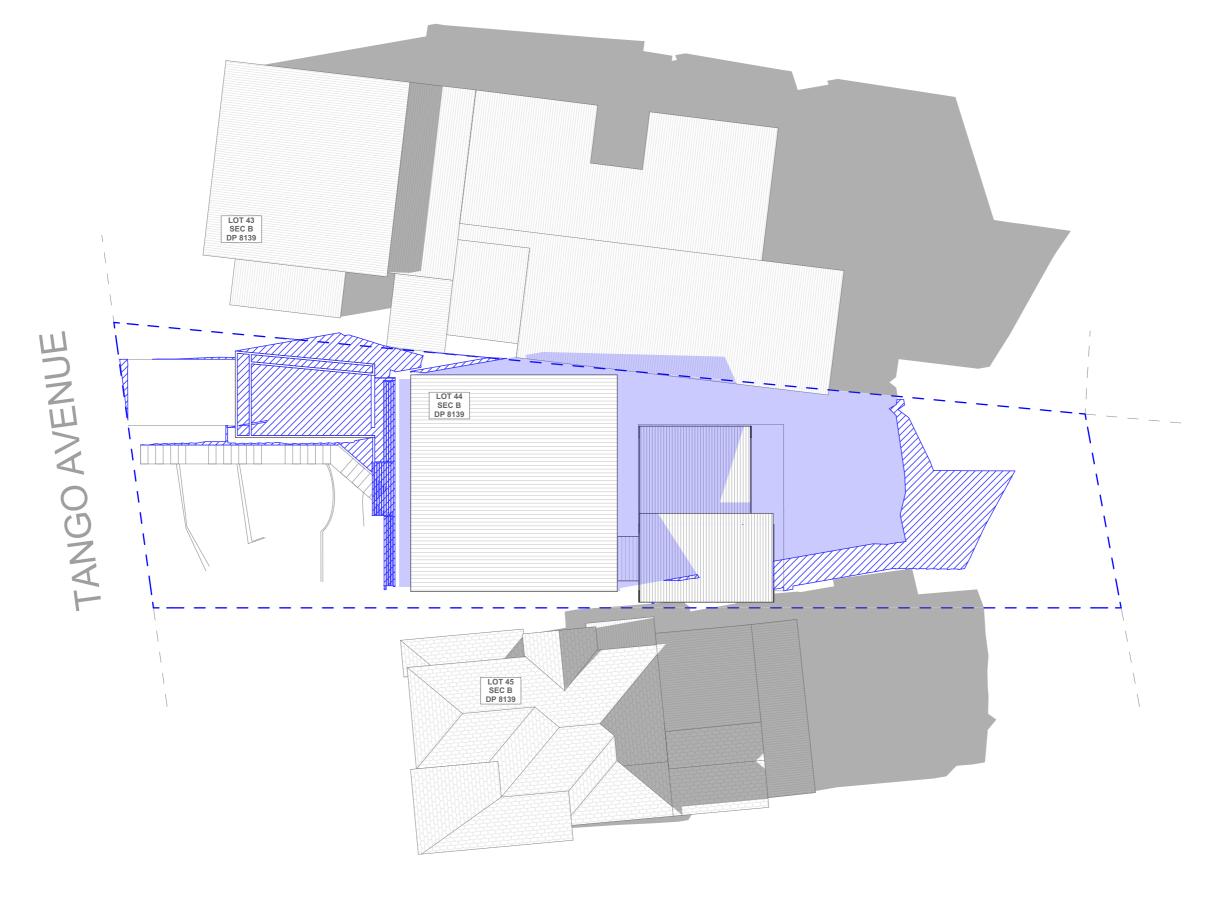

1 WINTER SOLSTICE 3PM 1:200



REV.	DATE	COMMENTS	DRWN	NOTES This drawing is the copyright of Action Plans and not be
А	30/06/20	DA DOCUMENTATION	EAS	altered, reproduced or transmitted in any form or by any means in part or in whole with the written permission of
				Action Plans. Do not scale measure from drawings. Figured dimensions
				are to be used only. The Builder/Contractor shall check and verify all levels and
				dimensions on site prior to commencement of any work, creation of shop drawings, or fabrication of components.
				All errors and omissions are to be verified by the Builder/Contractor and referred to the designer prior to the
				commencement of works.

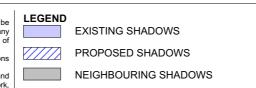

CLIENT

MARK HOPKINS &
CATHERINE MANU

PROJECT ADDRESS 15 TANGO AVENUE DEE WHY NSW 2099 DRAWING NO.

**DA18** 


Tuesday, 30 June 2020

DATE

DRAWING NAME

WINTER SOLSTICE 3 PM

**SCALE** 1:200 @A3

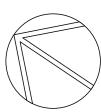



Building Sustainability Index www.basix.nsw.gov.au

### Alterations and Additions

Certificate number: A374260\_02

This certificate confirms that the proposed development will meet the NSW government's requirements for sustainability, if it is built in accordance with the commitments set out below. Terms used in this certificate, or in the commitments, have the meaning given by the document entitled "BASIX Alterations and Additions Definitions" dated 06/10/2017 published by the Department. This document is available at www.basix.nsw.gov.au

Secretary
Date of issue: Monday, 06, April 2020
To be valid, this certificate must be lodged within 3 months of the date of issue.



Project name	15 Tango Avenue Dee Why_02
Street address	15 Tango Avenue Dee Why 2099
Local Government Area	Northern Beaches Council
Plan type and number	Deposited Plan 8139
Lot number	44
Section number	В
Project type	
Dwelling type	Separate dwelling house
Type of alteration and addition	My renovation work is valued at \$50,000 or more and does not include a pool (and/or spa).

Certificate Prepared by (please complete before submitting to Council or PCA)
Name / Company Name: Action Plans
ABN (if applicable): 17118297587

Fixtures and systems  Lighting	Show on DA Plans	Show on CC/CDC Plans & specs	Certifier Check
The applicant must ensure a minimum of 40% of new or altered light fixtures are fitted with fluorescent, compact fluorescent, or light-emitting-diode (LED) lamps.		~	<b>~</b>
Fixtures	•		•
The applicant must ensure new or altered showerheads have a flow rate no greater than 9 litres per minute or a 3 star water rating.		✓	V
The applicant must ensure new or altered toilets have a flow rate no greater than 4 litres per average flush or a minimum 3 star water rating.		✓	✓
The applicant must ensure new or altered taps have a flow rate no greater than 9 litres per minute or minimum 3 star water rating.		<b>✓</b>	

Construction			Show on DA Plans	Show on CC/CDC Plans & specs	Certifier Check
Insulation requirements					
		) in accordance with the specifications listed in truction is less than 2m2, b) insulation specified	<b>~</b>	<b>✓</b>	~
Construction	Additional insulation required (R-value)	Other specifications			
concrete slab on ground floor.	nil				
external wall: brick veneer	R1.16 (or R1.70 including construction)				
external wall: framed (weatherboard, fibro, metal clad)	R1.30 (or R1.70 including construction)				
flat ceiling, pitched roof	ceiling: R2.50 (up), roof: foil/sarking	medium (solar absorptance 0.475 - 0.70)			
raked ceiling, pitched/skillion roof: framed	ceiling: R2.50 (up), roof: foil/sarking	medium (solar absorptance 0.475 - 0.70)			

Glazing re	equirements						Show on DA Plans	Show on CC/CDC Plans & specs	Certifier Check
Windows a	and glazed	doors							
					nading devices, in accordance with reach window and glazed door.	the specifications listed in the table below.	<b>~</b>	<b>~</b>	~
The followin	g requiremen	its must also	be satisfi	ed in relation	to each window and glazed door:			✓	~
have a U-va	alue and a Sol	lar Heat Gair	Coefficie	ent (SHGC) r		ed glass may either match the description, or, le below. Total system U-values and SHGCs s.		~	~
have a U-va must be cal	alue and a Sol culated in acc	lar Heat Gair cordance with	Coefficie National	ent (SHGC) r Fenestration	no greater than that listed in the tab	ear glazing, or toned/air gap/clear glazing must le below. Total system U-values and SHGCs s. The description is provided for information		~	~
					each eave, pergola, verandah, ba than 2400 mm above the sill.	lcony or awning must be no more than 500 mm	<b>✓</b>	<b>✓</b>	~
Pergolas wi	th polycarbon	ate roof or si	milar tran	slucent mate	erial must have a shading coefficier	nt of less than 0.35.		<b>✓</b>	<b>V</b>
External lou	vres and blind	ds must fully	shade the	e window or	glazed door beside which they are	situated when fully drawn or closed.		<b>✓</b>	<b>✓</b>
					e window or glazed door above whi ens must not be more than 50 mm.	ich they are situated, unless the pergola also		~	~
	ving buildings the 'overshad				nt and distance from the centre and	the base of the window and glazed door, as	✓	<b>✓</b>	<b>✓</b>
Windows	and glaze	d doors g	lazing r	equireme	nts		1		
Window / do	oor Orientation	on Area of glass inc. frame (m2)	Oversha Height (m)	Distance (m)	Shading device	Frame and glass type			
W1	N	5.901	0	0	eave/verandah/pergola/balcony >=750 mm	standard aluminium, single clear, (or U-value: 7.63, SHGC: 0.75)			
W2	E	1.049	0	0	eave/verandah/pergola/balcony	standard aluminium, single clear, (or			

Glazing requ	irements						Show on DA Plans	Show on CC/CDC Plans & specs	Certifier Check
Window / door no.	Orientation	Area of glass inc. frame (m2)	Oversha Height (m)	Distance (m)	Shading device	Frame and glass type			
					>=900 mm	U-value: 7.63, SHGC: 0.75)			
W3	W	1.049	0	0	eave/verandah/pergola/balcony >=900 mm	standard aluminium, single clear, (or U-value: 7.63, SHGC: 0.75)			
W4	E	1.248	0.95	1.364	none	timber or uPVC, single pyrolytic low-e, (U-value: 3.99, SHGC: 0.4)			
W5	E	0.868	2.685	1.364	none	standard aluminium, single clear, (or U-value: 7.63, SHGC: 0.75)			
W6	E	4.999	0	0	eave/verandah/pergola/balcony >=450 mm	standard aluminium, single pyrolytic low-e, (U-value: 5.7, SHGC: 0.47)			
W7a	E	1.026	0	0	eave/verandah/pergola/balcony >=900 mm	standard aluminium, single clear, (or U-value: 7.63, SHGC: 0.75)			
W7b	N	1.126	4.776	1.589	eave/verandah/pergola/balcony >=450 mm	standard aluminium, single clear, (or U-value: 7.63, SHGC: 0.75)			
W8	N	5.005	4.776	1.589	eave/verandah/pergola/balcony >=450 mm	standard aluminium, single clear, (or U-value: 7.63, SHGC: 0.75)			
W9	N	2.82	2.346	1.589	eave/verandah/pergola/balcony >=450 mm	standard aluminium, single clear, (or U-value: 7.63, SHGC: 0.75)			
W10	E	2.16	2.8	3.3	eave/verandah/pergola/balcony >=750 mm	standard aluminium, single clear, (or U-value: 7.63, SHGC: 0.75)			
W11	E	1.748	2.8	0.46	eave/verandah/pergola/balcony >=750 mm	standard aluminium, single clear, (or U-value: 7.63, SHGC: 0.75)			
W12	E	2.16	2.8	2.9	eave/verandah/pergola/balcony >=750 mm	standard aluminium, single clear, (or U-value: 7.63, SHGC: 0.75)			
W13	S	2.82	0	0	eave/verandah/pergola/balcony >=450 mm	standard aluminium, single clear, (or U-value: 7.63, SHGC: 0.75)			
W14a	E	1.23	0	0	eave/verandah/pergola/balcony	standard aluminium, single clear, (or			

Glazing requ	Blazing requirements								Certifier Check
Window / door no.	Orientation	Area of glass inc. frame (m2)	Oversha Height (m)	Distance (m)	Shading device	Frame and glass type			
					>=900 mm	U-value: 7.63, SHGC: 0.75)			
W14b	S	0.764	0	0	eave/verandah/pergola/balcony >=450 mm	standard aluminium, single clear, (or U-value: 7.63, SHGC: 0.75)			
W15	S	1.495	0	0	eave/verandah/pergola/balcony >=450 mm	standard aluminium, single clear, (or U-value: 7.63, SHGC: 0.75)			
W16	S	2.31	0	0	eave/verandah/pergola/balcony >=450 mm	standard aluminium, single clear, (or U-value: 7.63, SHGC: 0.75)			
W17	E	2.575	0	0	eave/verandah/pergola/balcony >=900 mm	standard aluminium, single clear, (or U-value: 7.63, SHGC: 0.75)			
W18	N	1.86	2.346	1.589	eave/verandah/pergola/balcony >=450 mm	standard aluminium, single clear, (or U-value: 7.63, SHGC: 0.75)			
W19	W	4.999	2.52	2.09	none	standard aluminium, single pyrolytic low-e, (U-value: 5.7, SHGC: 0.47)			
W20	W	2.825	0	0	external louvre/blind (adjustable)	standard aluminium, single clear, (or U-value: 7.63, SHGC: 0.75)			
D01	N	9.406	0	0	eave/verandah/pergola/balcony >=750 mm	standard aluminium, single clear, (or U-value: 7.63, SHGC: 0.75)			
D02	S	9.9	0	0	eave/verandah/pergola/balcony >=450 mm	standard aluminium, single clear, (or U-value: 7.63, SHGC: 0.75)			

Legenu	
In these commitments, "applicant" means the person carrying out the development.	
Commitments identified with a " $\sqrt{}$ " in the "Show on DA plans" column must be shown on the plans accompanying the development application for the proposed development (i development application is to be lodged for the proposed development).	fa
Commitments identified with a "\" in the "Show on CC/CDC plans & specs" column must be shown in the plans and specifications accompanying the application for a construct certificate / complying development certificate for the proposed development.	tior
Commitments identified with a "\" in the "Certifier check" column must be certified by a certifying authority as having been fulfilled, before a final occupation certificate for the development may be issued.	



REV.	DATE	COMMENTS	DRWN
A	30/06/20	DA DOCUMENTATION	EAS

NOTES

This drawing is the copyright of Action Plans and not be altered, reproduced or transmitted in any form or by any means in part or in whole with the written permission of Action Plans.

Do not scale measure from drawings. Figured dimensions are to be used only.

The Builder/Contractor shall check and verify all levels and dimensions on site prior to commencement of any work, creation of shop drawings, or fabrication of components.

All errors and omissions are to be verified by the Builder/Contractor and referred to the designer prior to the commencement of works.

All window & door dimensions, orientation, glazing materials, opening types, frame types are to be confirmed by a suitably qualified person prior to the ordering of any such materials are to take place.

U value takes precedence over glazing type/colour in all cases.

all new glazing must meet the BASIX specified frame and glass type, <u>OR</u> meet the certified U value and SHGC value.

CLIENT

MARK HOPKINS & CATHERINE MANU

PROJECT ADDRESS 15 TANGO AVENUE DEE WHY NSW 2099 DRAWING NO.

**DA19** 

DRAWING NAME BASIX COMMITMENTS

DATE

Tuesday, 30 June 2020