

GORE STREET

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NEW DRIVEWAY CROSSING

AS PER ENGINEERS DETAILS

(N) SITE AND ROOF PLAN

1:100




DRAWING LIST

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Sheet Name

IT	DESIGN ARCHITECT SURVEYOR R SQUARED STUDIOS CMS SURVEYORS	Rev Date Description Drawn Auth. A 24.06.2025 ISSUE FOR COORDINATION TI RR	Proj. Arch	Drawn T I	Project FRESHWATER HOU	SE	Project Architect	
HSIU-HUI HSU & CHRIS HUDSON	PLANNER STRUCTURAL & HYDR	B 15.07.2025 ISSUE FOR COORDINATION TI RR DA 2004/004 APPROVED C 23.07.2025 ISSUE FOR SUBMITION TI RR ULIC ENGINEER	Date JULY 2025	Scale 1:100	31 Kooloora Avenue, Freshwater			
	VMDC PLANNING VANGUARD ENGINEER			y All dimensions on site. Notify architect of all discre	Drawing Title SITE AND ROOF PLAN		-	
	LANDSCAPE CONSULTANT ENERGY CONSULTAN TCGD GREEN FUTURE GROU				Drawing No.	Revision	R SQUARED STUDIOS Pty Ltd NOMINATED ARCHITECT RENATA RATCLIFFE NSW ARB #8307	
	TCGD GREEN FUTURE GRO				Drawing No. AR.S455. 0000	Revision C	NOMINATED ARCH	HTECT RENATA RATCLIFFE NSW ARB #8307 @r2studios.com.au



3D View 1

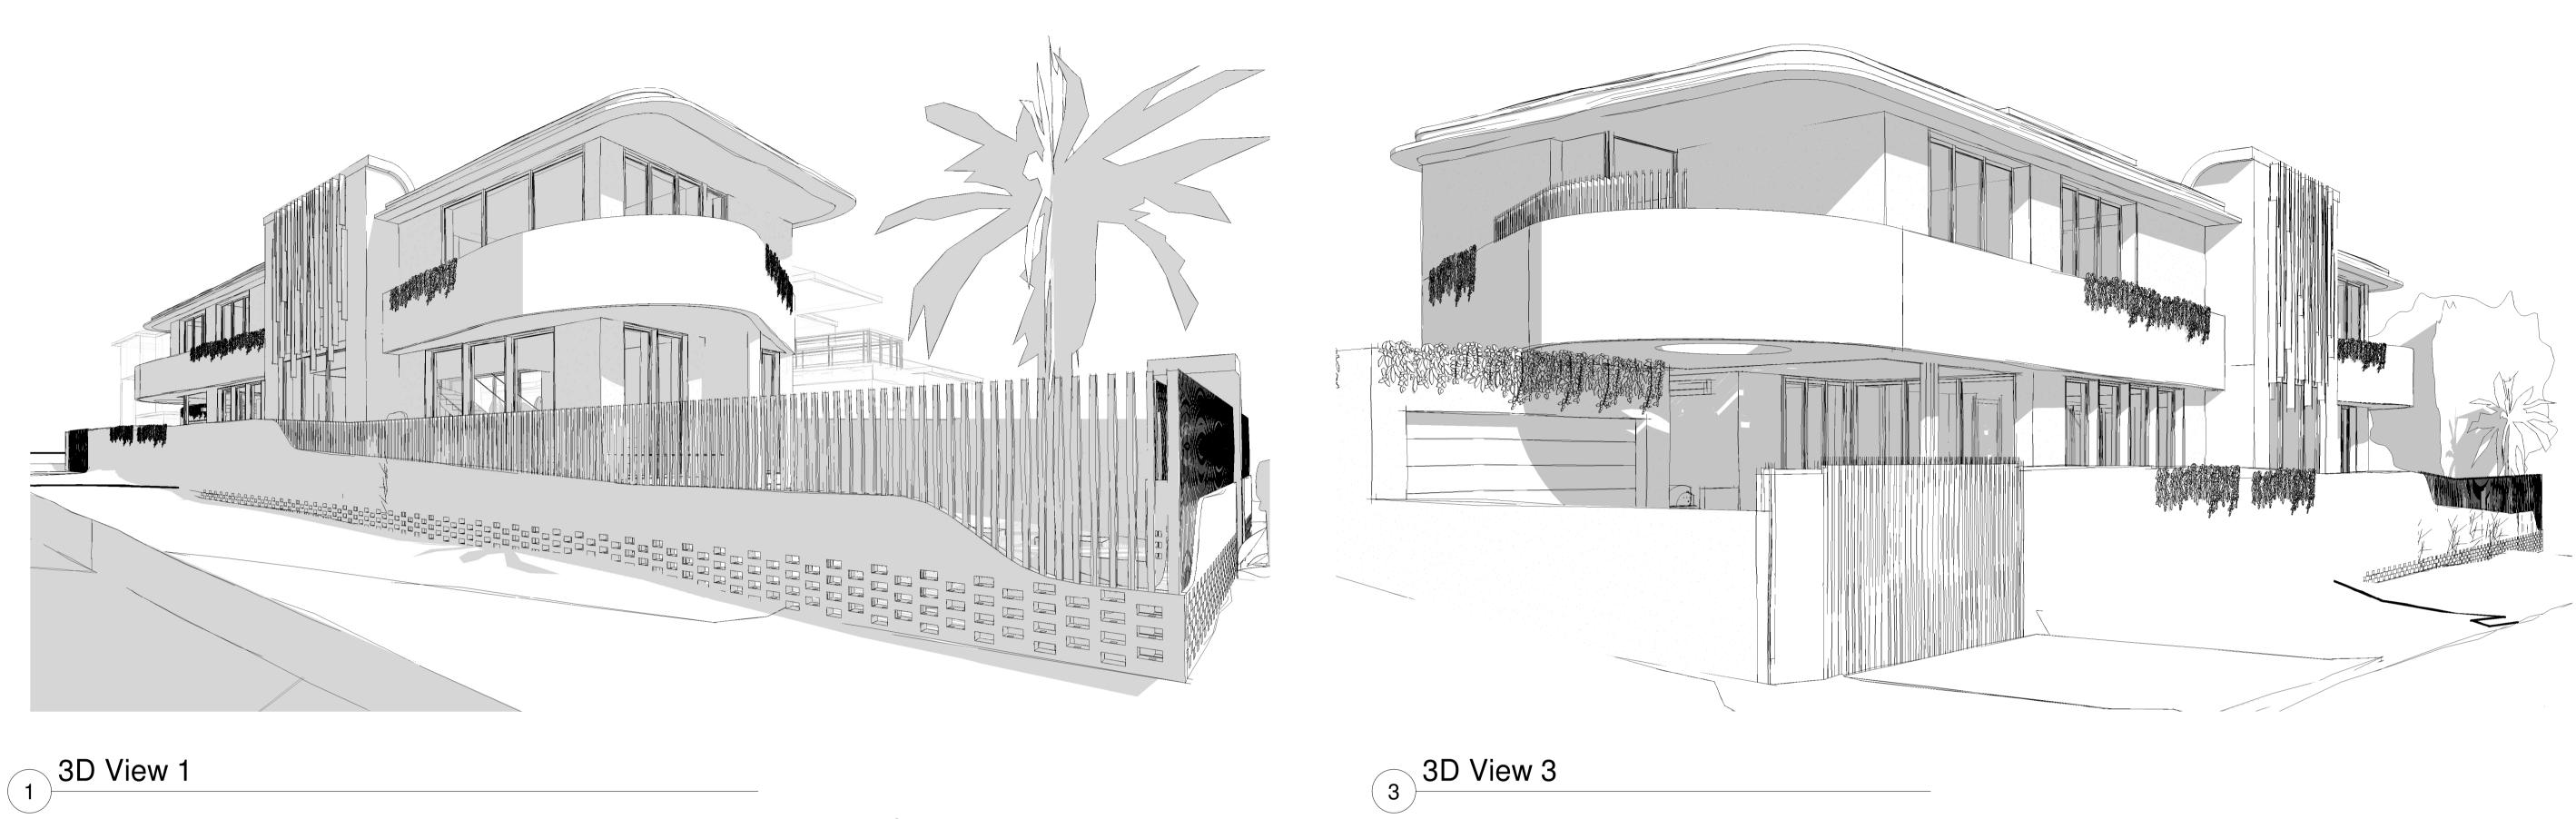	Thermal Comfort Specifications
Glazing: Doors/windows	You can use any brand/manufacturer and type of glass and frame; these are maximum U-values, and there is a flexibility of +/- 5% (as stated below) with the SHGC value. Given values are AFRC, total window system values (glass and frame).
	Fixed windows: Alspec ecoFRAMEplus ALS-043-014: U-Value: 2.6 (equal to or lower than) SHGC: 0.51 (±5%)
	Sliding doors: Reynaers Slimline Patio REY-026-001: U-Value: 2.0 (equal to or lower than) SHGC: 0.48 (±5%)
	Hinged doors: Alspec ALS-045-013: U-Value: 3.1 (equal to or lower than) SHGC: 0.41 (±5%)
Skylights	Double glazed with metal frame
Roof	Concrete roof with waterproof membrane Stair/Access walls and roof/ceiling: Formed concrete with R1.5 insulation (insulation only value) Colour: Medium (SA: 0.475-0.7)
Ceiling	Plasterboard ceiling with R4.0 insulation (insulation only value) where roof above No insulation required to Garage ceiling Ground Floor ceiling is concrete between levels
Ceiling	Sealed LED downlights, modelled; One per 3m ²
penetrations	Exhaust fans to bathrooms and Laundry Fireplace Flue to have damper
External Walls	Cavity brick with R2.5 insulation (insulation only value), or Total wall construction value RT2.86 (wall and insulation total value)
	Stair/Access walls and roof/ceiling: Formed concrete with R1.5 insulation (insulation only value)
	Rammed Earth walls with no insulation
	No insulation required to Garage walls
laternal malla	Default Medium colour modelled (0.475 <sa<0.7)< td=""></sa<0.7)<>
Internal walls Floors	Plasterboard on studs Concrete slab on ground with R1.8 underslab insulation (insulation only value
Tions	Concrete to First Floor (between levels) with R2.0 insulation (insulation only value) to any suspended floor with open subfloor Floor coverings: Tiles to Ground Floor and the wet areas of First Floor, carpet to upstairs bedrooms, timber elsewhere upstairs
Ceiling fans	Three Ceiling Fans: one to Upper Sitting Room, one to Casual Dining Room, and one to either the GF Living/Dining Room
External Shading	Covered Alfresco and Balconies. Shading screens to Bathroom and Study windows. Eaves as shown on drawings
External orlawing	BASIX Water Commitments
Fixtures	Install showerheads minimum rating of 4 stars (>6.0 and <= 7.5 Litres/min)
1 ixtares	Install toilet flushing system with a minimum rating of 4 stars in each toilet
	Install tap with minimum rating of 4 stars in the kitchen
	Install taps with minimum rating of 4 stars in each bathroom
Alternative Water	Install rainwater tank with minimum 10,000L capacity, connected to – At least one outdoor tap and toilets, and used to top up spa and pool
Deal and Con	Rainwater harvest collected from a min. 215m² roof area Volume of Pool: 70kL, Volume of Spa; 4.5kL, Both Pool and Spa are to have a cover.
Pool and Spa	
	BASIX Energy Commitments
Hot water System	Gas Instantaneous with minimum performance of 6 Stars
Cooling system	3 phase air conditioning to living areas and bedrooms: EER 3.0-3.5
Heating system Ventilation	3 phase air conditioning to living areas and bedrooms: EER 3.0-3.5 Kitches - Individual fire externally dupted to reaf or facado, manual or left switch
vendlabori	Kitchen - Individual fan, externally ducted to roof or façade, manual on/off switch Bathrooms - Individual fan, externally ducted to roof or façade, manual on/off switch
	Laundry - Individual fan, externally ducted to roof or façade, manual on/off switch
Pool and Spa	Pool Heating System: solar (electric boosted), controlled by timer, dual speed pool pump with minimum performance of 6
	Stars
	Spa Heating System: solar (electric boosted), controlled by timer
Alternative Energy	Minimum 6.5kW of solar/PV, with panels sloped between >0° to <=10°, and facing Northwest
Other	Gas cooktop & electric oven
	Outdoor clothes drying line

2 3D View 2

Certificate No. 0012075412-03 Avenue,FRESHWATER NSW,2096 hstar.com.au/QR/Generate?p=cfEqIHcLe

CLIENT

HSIU-HUI HSU & CHRIS HUDSON

SURVEYOR DESIGN ARCHITECT R SQUARED STUDIOS **CMS SURVEYORS** STRUCTURAL & HYDRAULIC ENGINEER PLANNER VANGUARD ENGINEERS VMDC PLANNING **ENERGY CONSULTANT** LANDSCAPE CONSULTANT **GREEN FUTURE GROUP**

Drawn Auth. LEGEND
TI RR
TI RR RevDateDescriptionDrawA24.06.2025ISSUE FOR COORDINATIONTI B 15.07.2025 ISSUE FOR COORDINATION TI C 23.07.2025 ISSUE FOR SUBMITION TI

Proj. Arch JULY 2025

Do not scale drawings. Verify All dimensions on site. Notify architect of all discrepancies.

FRESHWATER HOUSE 31 Kooloora Avenue, Freshwater PERSPECTIVE VIEWS

Drawing No.


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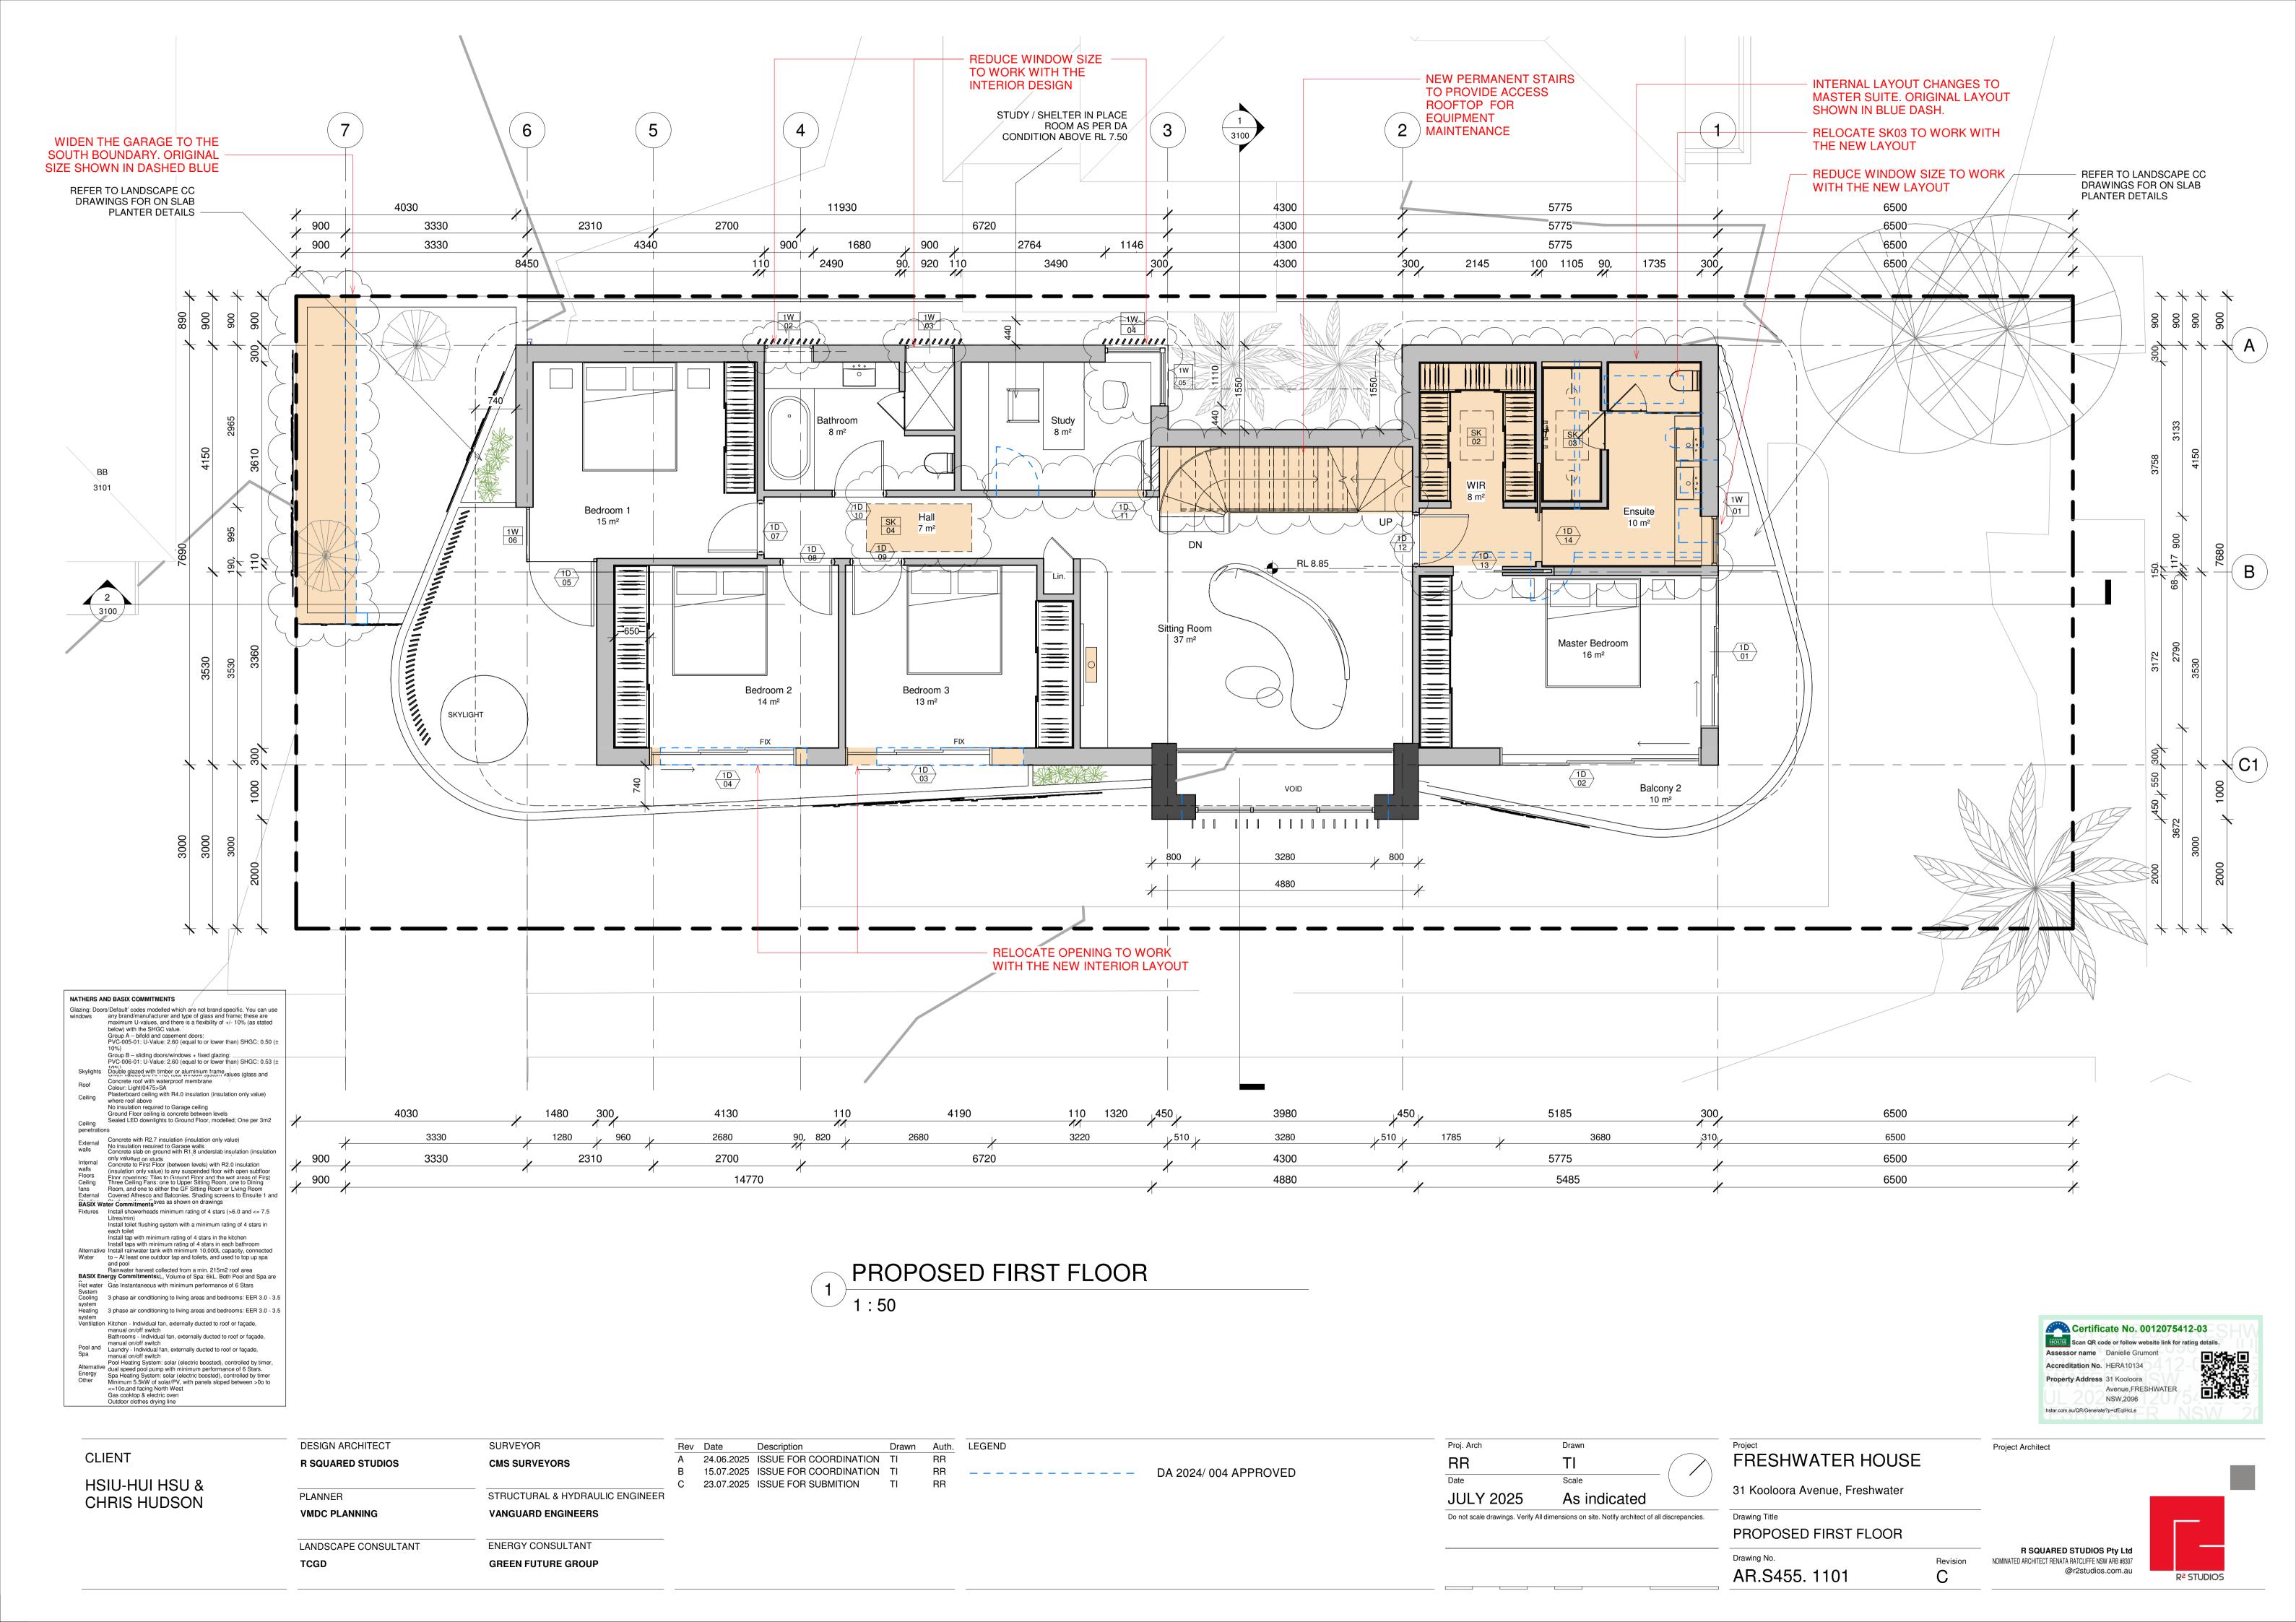
Project Architect


R SQUARED STUDIOS Pty Ltd


NOMINATED ARCHITECT RENATA RATCLIFFE NSW ARB #8307

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East Elevation

Description

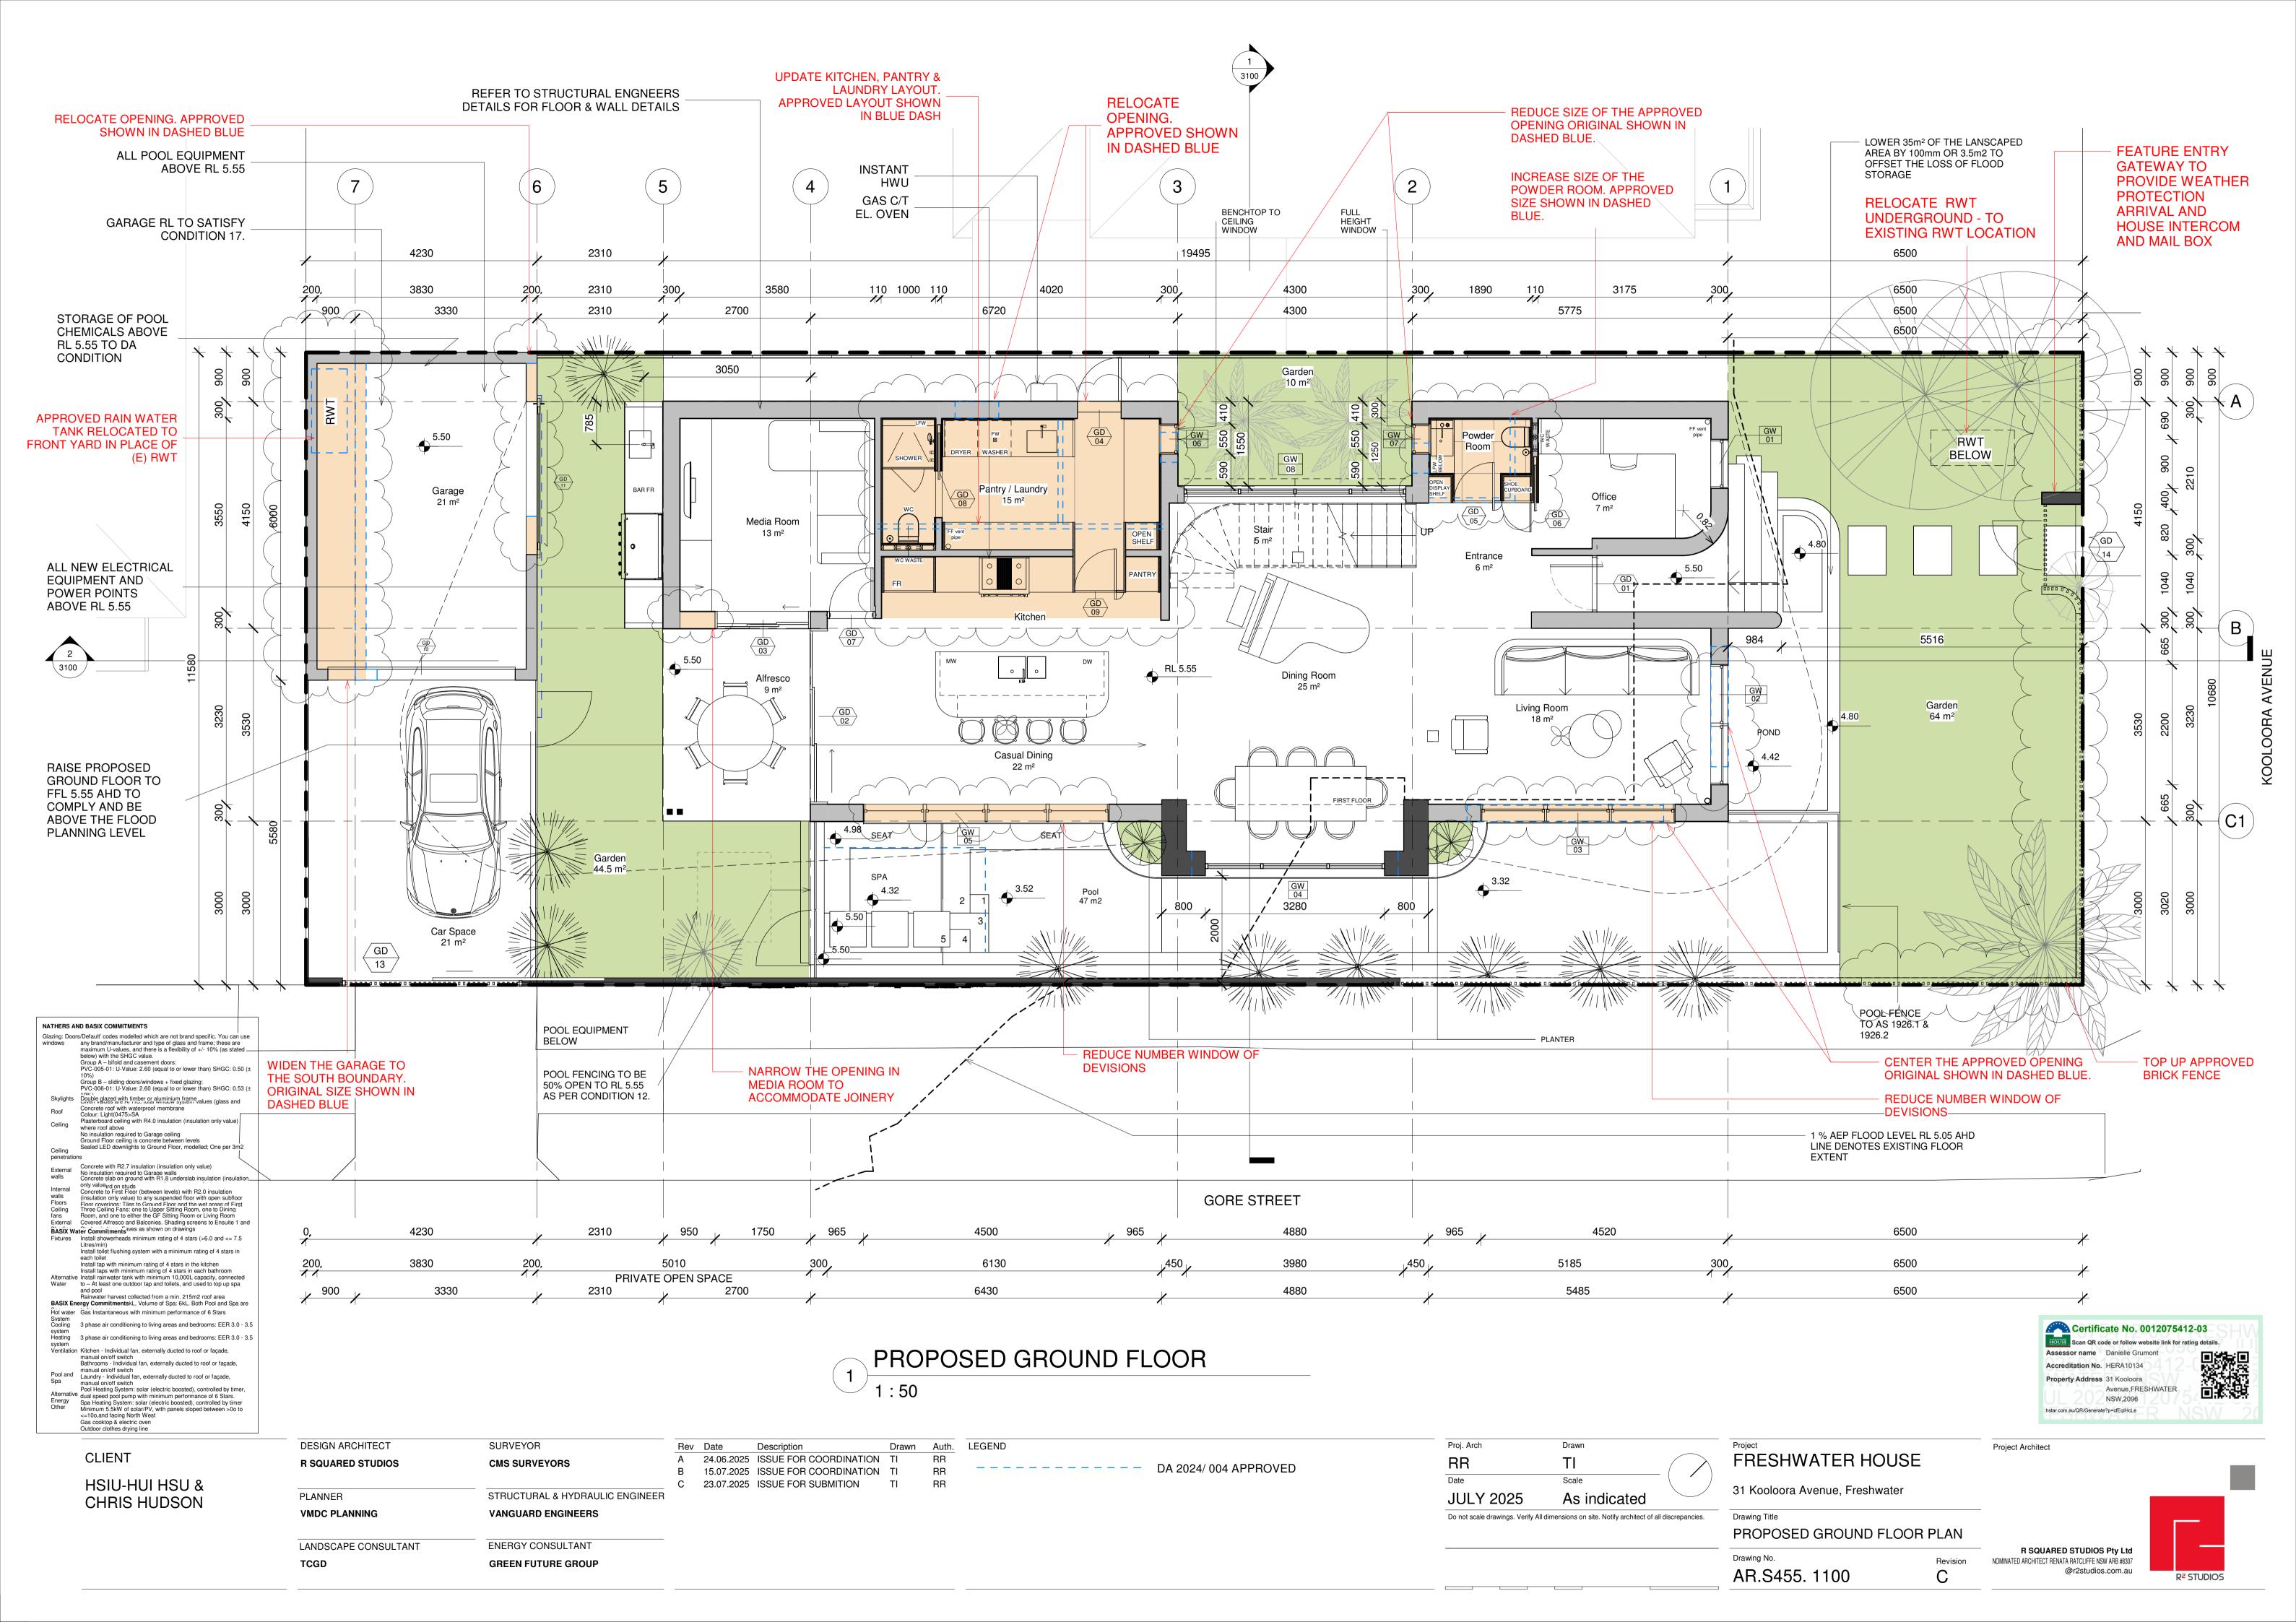CLIENT FRESHWATER HOUSE A 24.06.2025 ISSUE FOR COORDINATION TI R SQUARED STUDIOS **CMS SURVEYORS** 15.07.2025 ISSUE FOR COORDINATION TI RR DA 2004/004 APPROVED HSIU-HUI HSU & Scale 23.07.2025 ISSUE FOR SUBMITION RR ΤI 31 Kooloora Avenue, Freshwater STRUCTURAL & HYDRAULIC ENGINEER **JULY 2025** PLANNER As indicated **CHRIS HUDSON** VMDC PLANNING **VANGUARD ENGINEERS** Do not scale drawings. Verify All dimensions on site. Notify architect of all discrepancies. (N) ELEVATIONS LANDSCAPE CONSULTANT **ENERGY CONSULTANT** R SQUARED STUDIOS Pty Ltd Drawing No. NOMINATED ARCHITECT RENATA RATCLIFFE NSW ARB #8307 **GREEN FUTURE GROUP** AR.S455. 3000 @r2studios.com.au R² STUDIOS

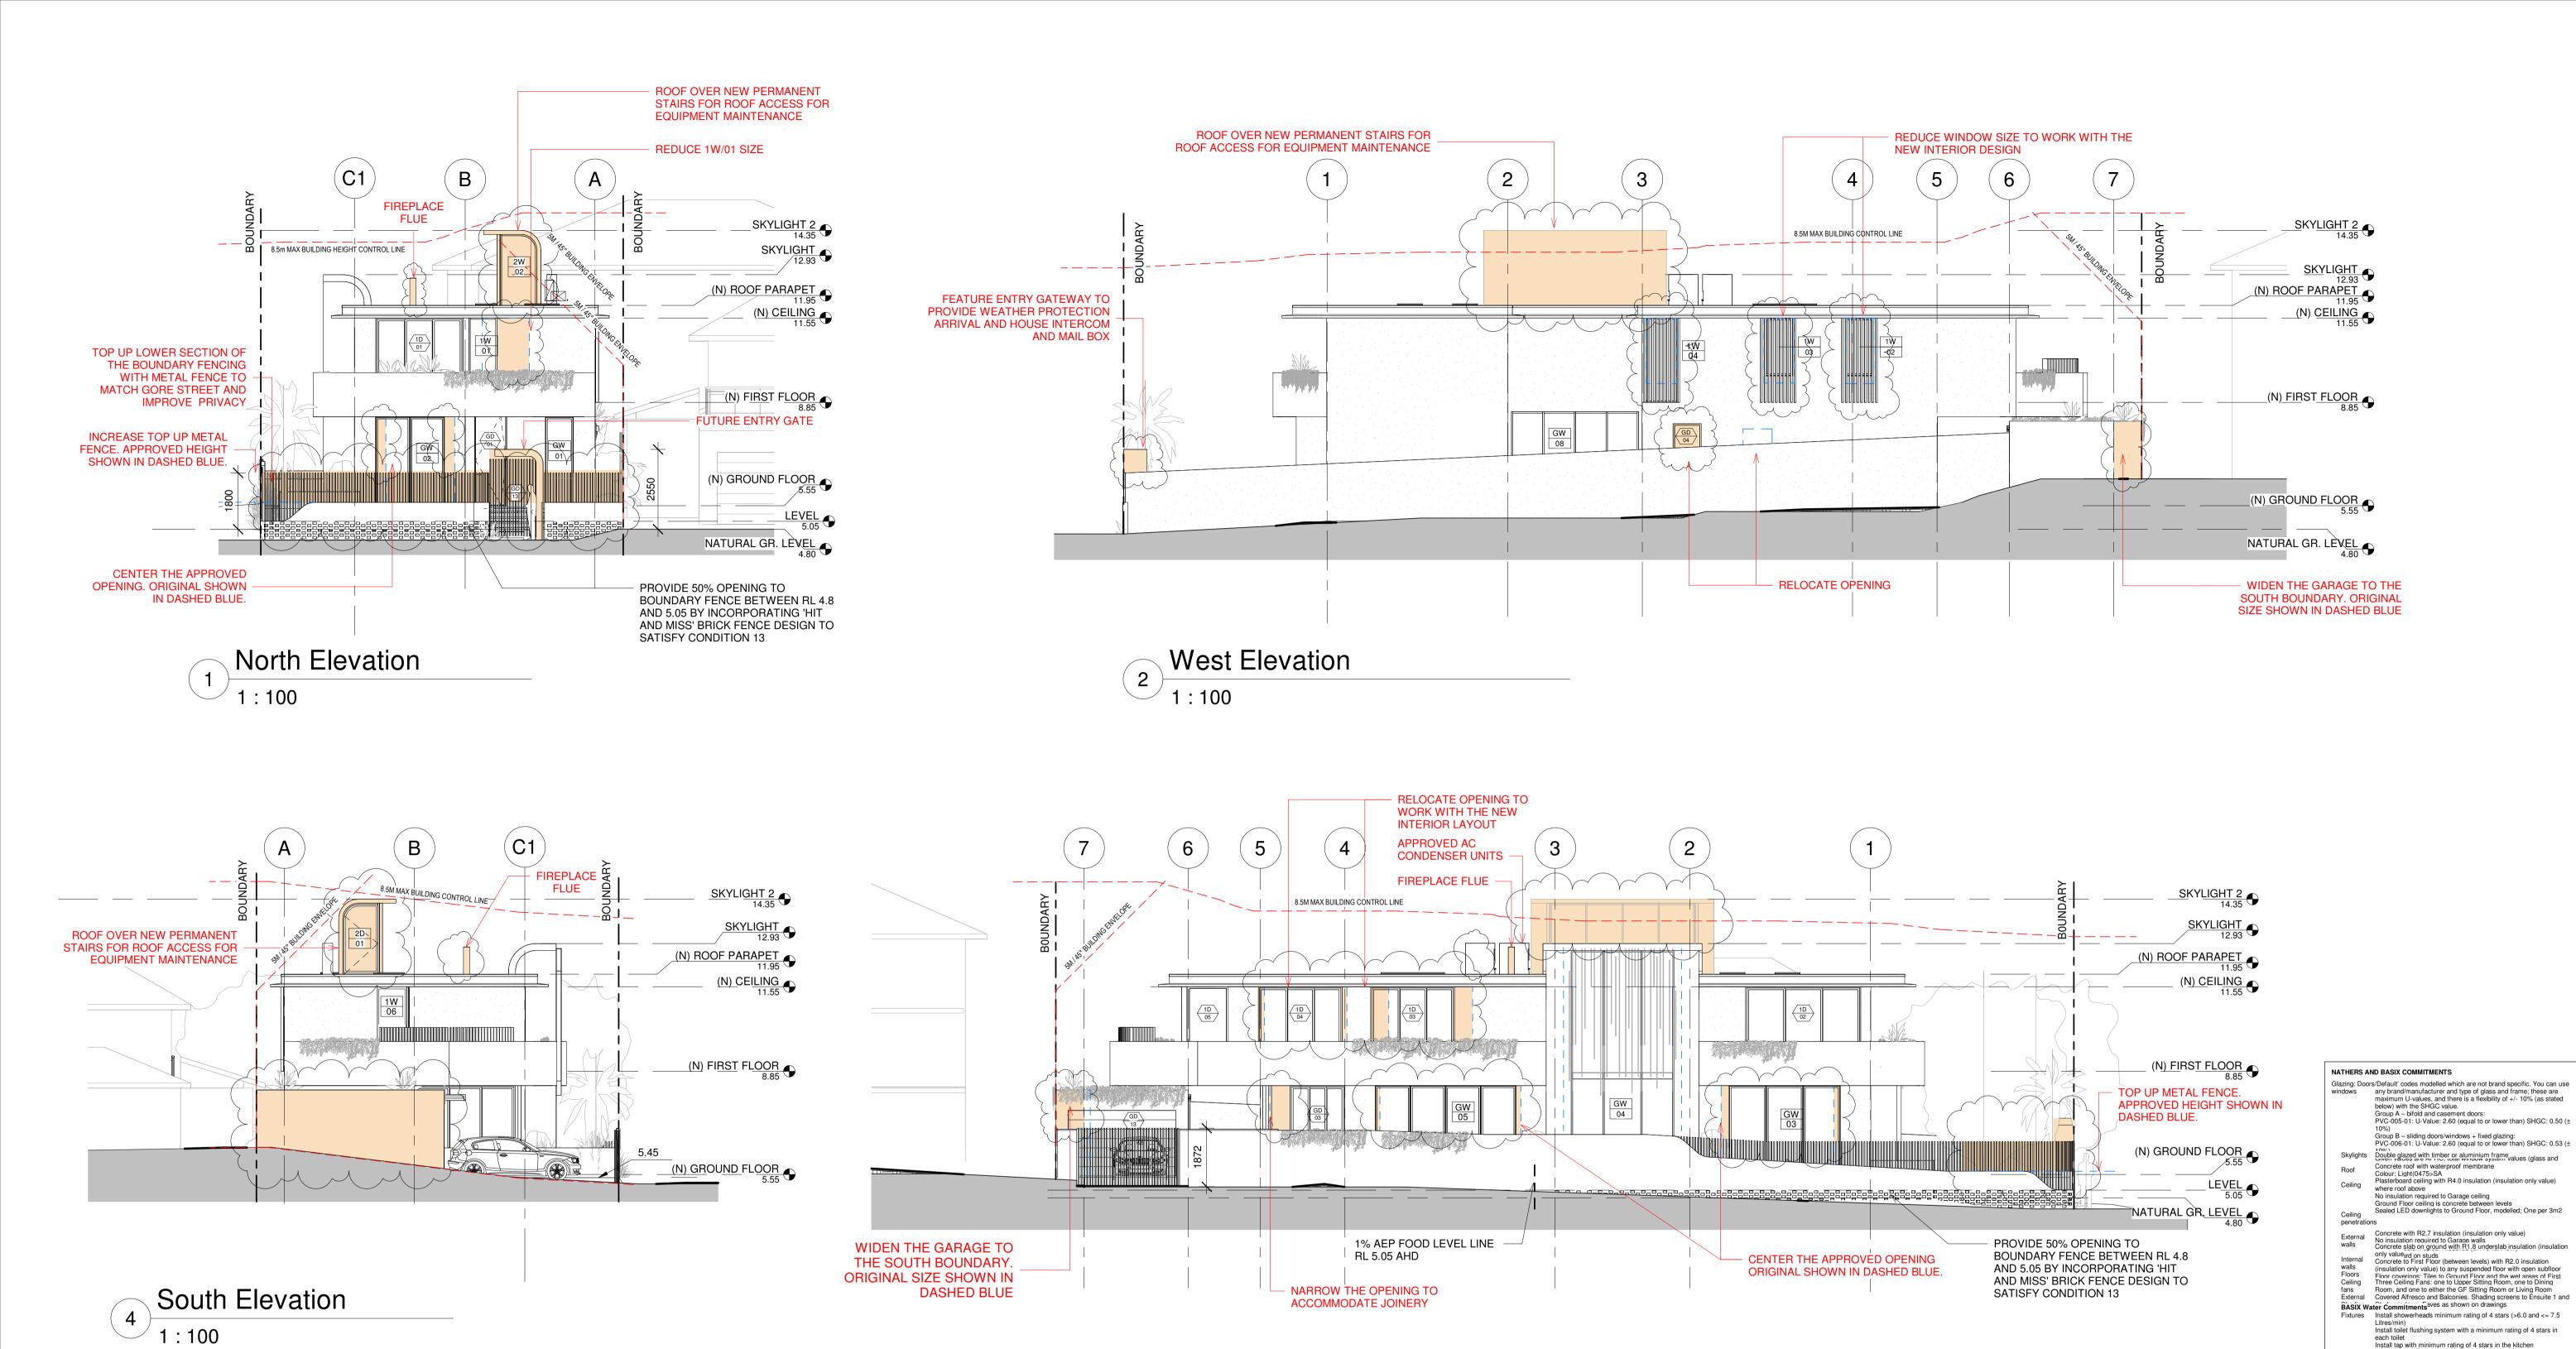
Install taps with minimum rating of 4 stars in each bathroom
Alternative Install rainwater tank with minimum 10,000L capacity, connected
Water to – At least one outdoor tap and toilets, and used to top up spa

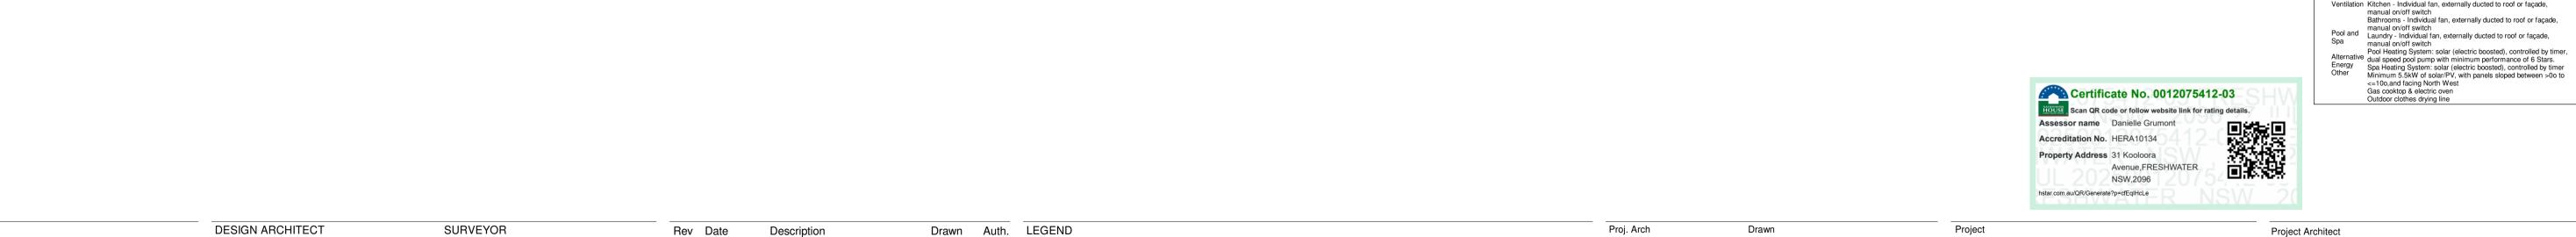
Rainwater harvest collected from a min. 215m2 roof area


BASIX Energy CommitmentskL, Volume of Spa: 6kL. Both Pool and Spa are Hot water Gas Instantaneous with minimum performance of 6 Stars


System
Cooling 3 phase air conditioning to living areas and bedrooms: EER 3.0 - 3.5
system
Heating 3 phase air conditioning to living areas and bedrooms: EER 3.0 - 3.5
system
Ventilation Kitchen - Individual fan, externally ducted to roof or façade,

Project Architect

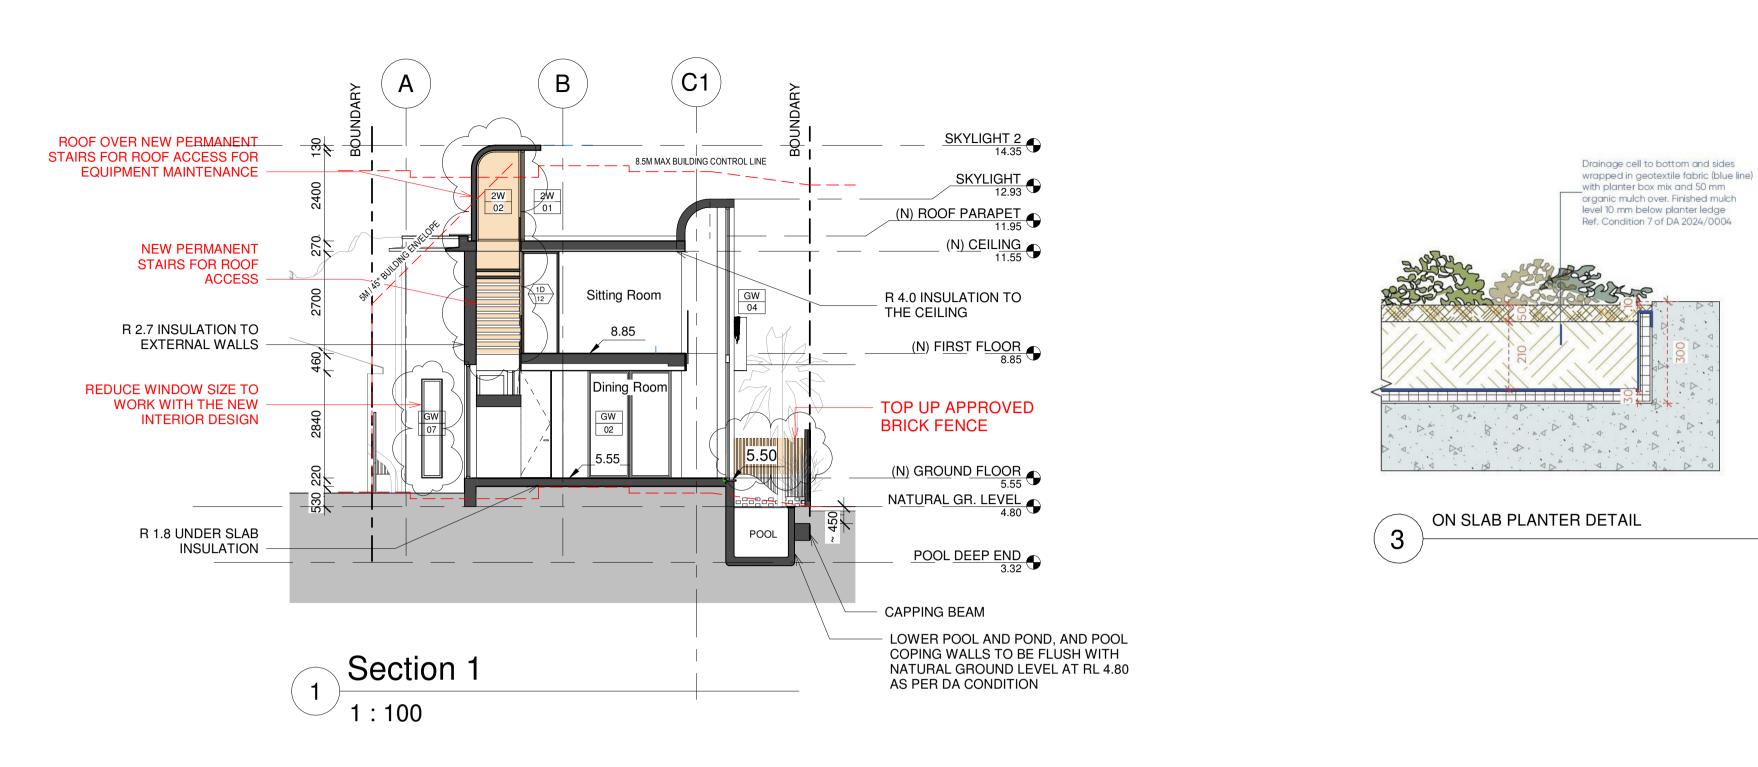

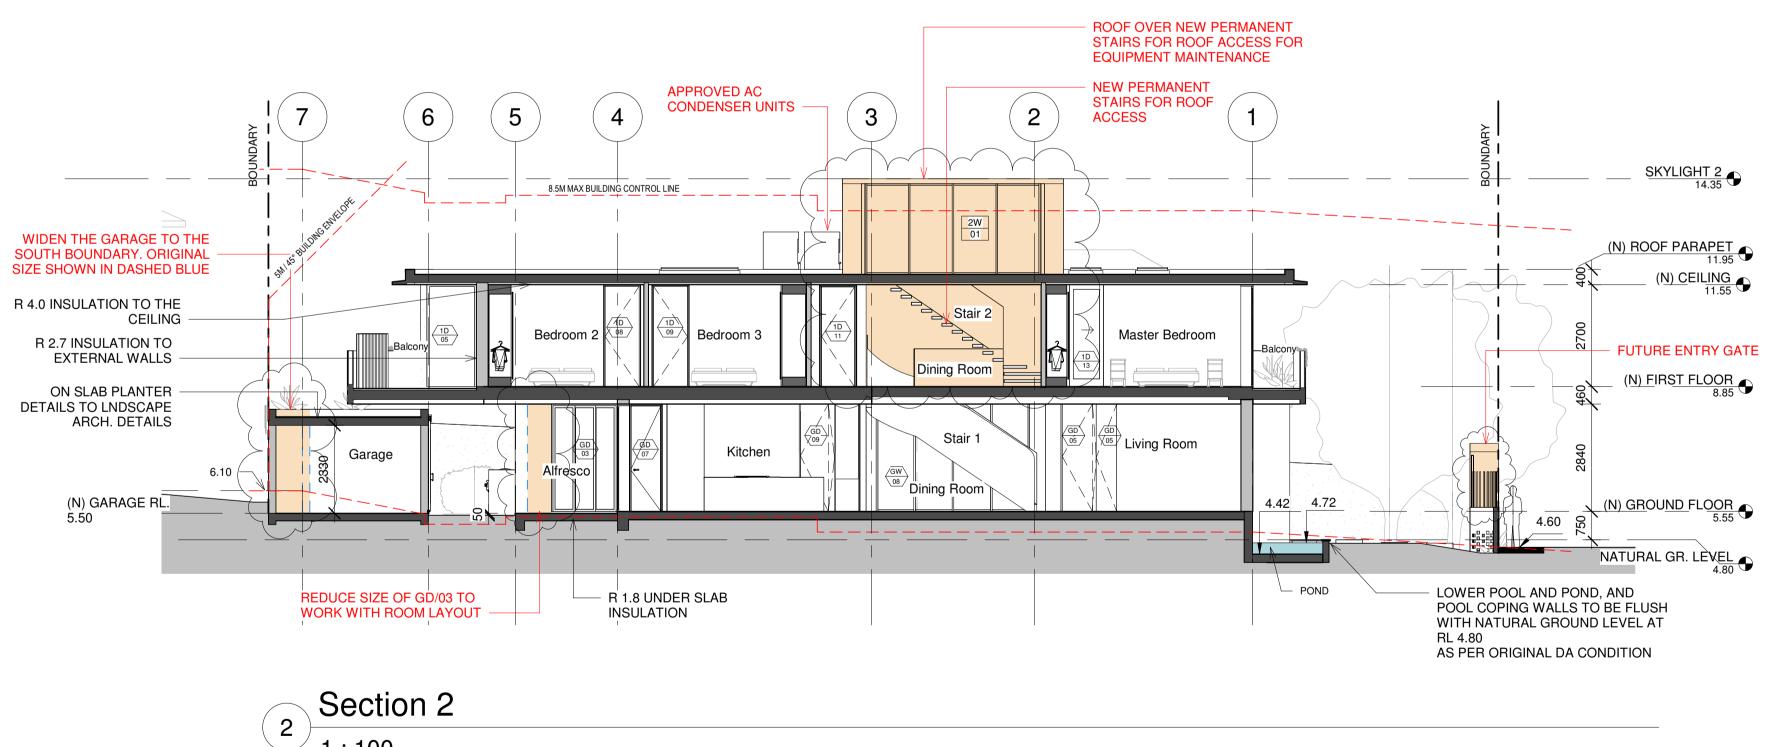

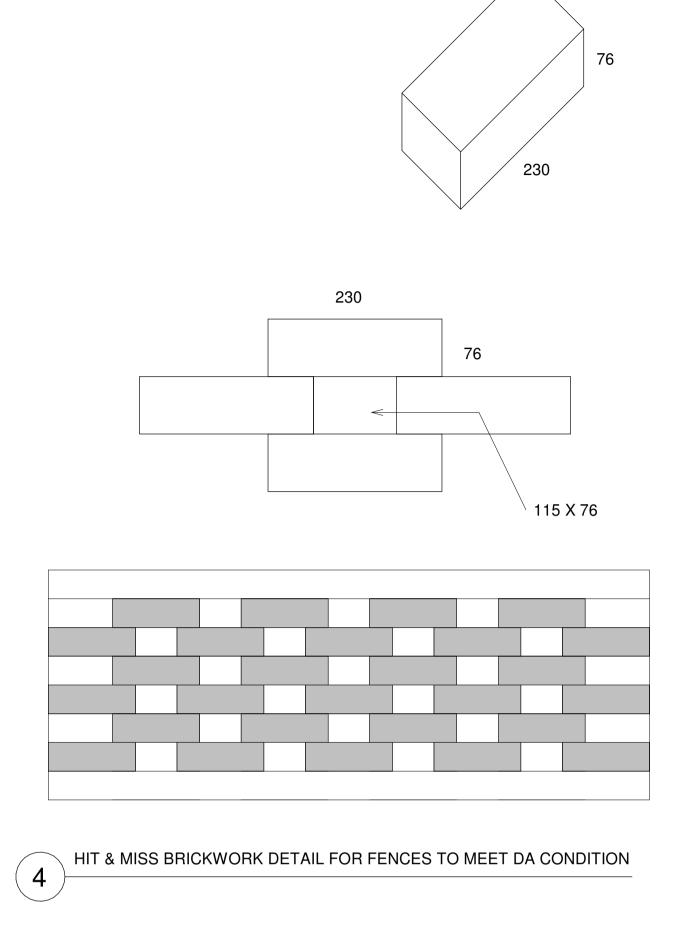

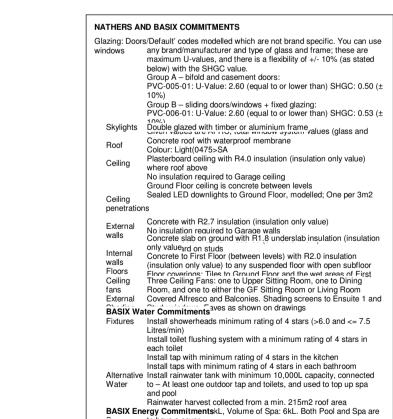

Certificate No. 0012075412-03

HOUSE Scan QR code or follow website link for rating details. Assessor name Danielle Grumont Accreditation No. HERA10134 Property Address 31 Kooloora Avenue,FRESHWATER NSW,2096 hstar.com.au/QR/Generate?p=cfEqIHcLe

Project FRESHWATER HOUSE
31 Kooloora Avenue, Freshwater

(N) SECTIONS Drawing No. AR.S455. 3100

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Hot water Gas Instantaneous with minimum performance of 6 Stars

System
Cooling 3 phase air conditioning to living areas and bedrooms: EER 3.0 - 3.5
system
Heating 3 phase air conditioning to living areas and bedrooms: EER 3.0 - 3.5
system
Ventilation Kitchen - Individual fan, externally ducted to roof or façade,

Ventilation Kitchen - Individual fan, externally ducted to roof or façade, manual on/off switch
Bathrooms - Individual fan, externally ducted to roof or façade, manual on/off switch
Laundry - Individual fan, externally ducted to roof or façade, manual on/off switch
Laundry - Individual fan, externally ducted to roof or façade, manual on/off switch
Pool Heating System: solar (electric boosted), controlled by timer, dual speed pool pump with minimum performance of 6 Stars.
Spa Heating System: solar (electric boosted), controlled by timer Minimum 5.5kW of solar/PV, with panels sloped between >00 to <=10o,and facing North West Gas cooktop & electric oven Outdoor clothes drying line

CLIENT
HSIU-HUI HSU & CHRIS HUDSON

DESIGN ARCHITECT SURVEYOR R SQUARED STUDIOS **CMS SURVEYORS** STRUCTURAL & HYDRAULIC ENGINEER PLANNER VMDC PLANNING **VANGUARD ENGINEERS**

LANDSCAPE CONSULTANT

TCGD

ENERGY CONSULTANT

GREEN FUTURE GROUP

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1. ROOF



2. ROOF TRIM



3. WALLS



4. WINDOWS



5. BALCONY




6. BLADE WALL



7. FENCE



8. HIT AND MISS BRICKWORK

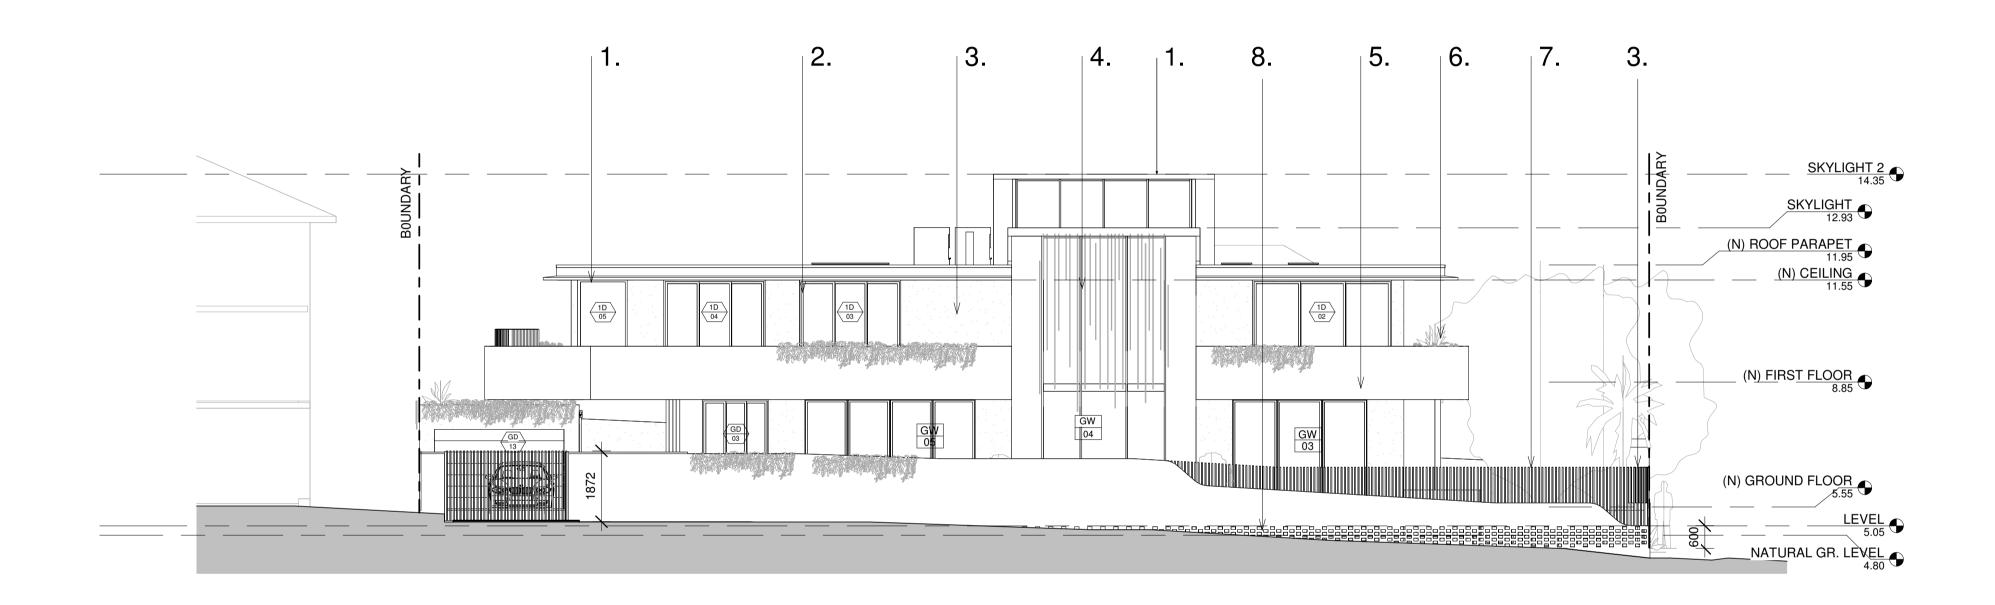

External Finishes

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Drawn FRESHWATER HOUSE Scale As indicated

31 Kooloora Avenue, Freshwater

EXTERNAL FINISHES

NATHERS AND BASIX COMMITMENTS

Ceiling Se penetrations

Glazing: Doors/Default' codes modelled which are not brand specific. You can use windows any brand/manufacturer and type of glass and frame; these are maximum U-values, and there is a flexibility of +/- 10% (as stated below) with the SHGC value.

Group A – bifold and casement doors:

PVC-005-01: U-Value: 2.60 (equal to or lower than) SHGC: 0.50 (± 10%)

Skylights Double glazed with timber or aluminium frame

Roof Concrete roof with waterproof membrane
Colour: Light(0475>SA
Plasterboard ceiling with R4.0 insulation (insulation only value)
where roof above
No insulation required to Garage ceiling
Ground Floor ceiling is concrete between levels
Sealed LED downlights to Ground Floor, modelled; One per 3m2

External walls

Internal walls

Internal walls

Floors

Ceiling fans

External

BASIX Water Commitments avers as shown on drawings

Instruction

Concrete with R2.7 insulation (insulation only value)

No insulation required to Garage walls

Concrete slab on ground with R1.8 underslab insulation (insulation only value) to any suspended floor with open subfloor floor coverings: Tiles to Ground Floor and the wet areas of First

Three Ceiling Fans: one to Upper Sitting Room, one to Dining

Covered Alfresco and Balconies. Shading screens to Ensuite 1 and

BASIX Water Commitments aves as shown on drawings

Fixtures

Fixtures Install showerheads minimum rating of 4 stars (>6.0 and <= 7.5 Litres/min)
Install toilet flushing system with a minimum rating of 4 stars in

each toilet

each toilet

Install tap with minimum rating of 4 stars in the kitchen

Install taps with minimum rating of 4 stars in each bathroom

Alternative Install rainwater tank with minimum 10,000L capacity, connected

Water to — At least one outdoor tap and toilets, and used to top up spa

and pool
Rainwater harvest collected from a min. 215m2 roof area

BASIX Energy CommitmentskL, Volume of Spa: 6kL. Both Pool and Spa are Hot water Gas Instantaneous with minimum performance of 6 Stars

System
Cooling 3 phase air conditioning to living areas and bedrooms: EER 3.0 - 3.5
system
Heating 3 phase air conditioning to living areas and bedrooms: EER 3.0 - 3.5
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Ventilation
Kitchen - Individual fan, externally ducted to roof or façade,

Ventilation

Kitchen - Individual fan, externally ducted to roof or façade, manual on/off switch
Bathrooms - Individual fan, externally ducted to roof or façade, manual on/off switch
Laundry - Individual fan, externally ducted to roof or façade, manual on/off switch
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Spa Heating System: solar (electric boosted), controlled by timer Minimum 5.5kW of solar/PV, with panels sloped between >00 to <=100,and facing North West
Gas cooktop & electric oven
Outdoor clothes drying line

Project Architect

Group B – sliding doors/windows + fixed glazing: PVC-006-01: U-Value: 2.60 (equal to or lower than) SHGC: 0.53 (±

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ENERGY CONSULTANT

GREEN FUTURE GROUP

LANDSCAPE CONSULTANT


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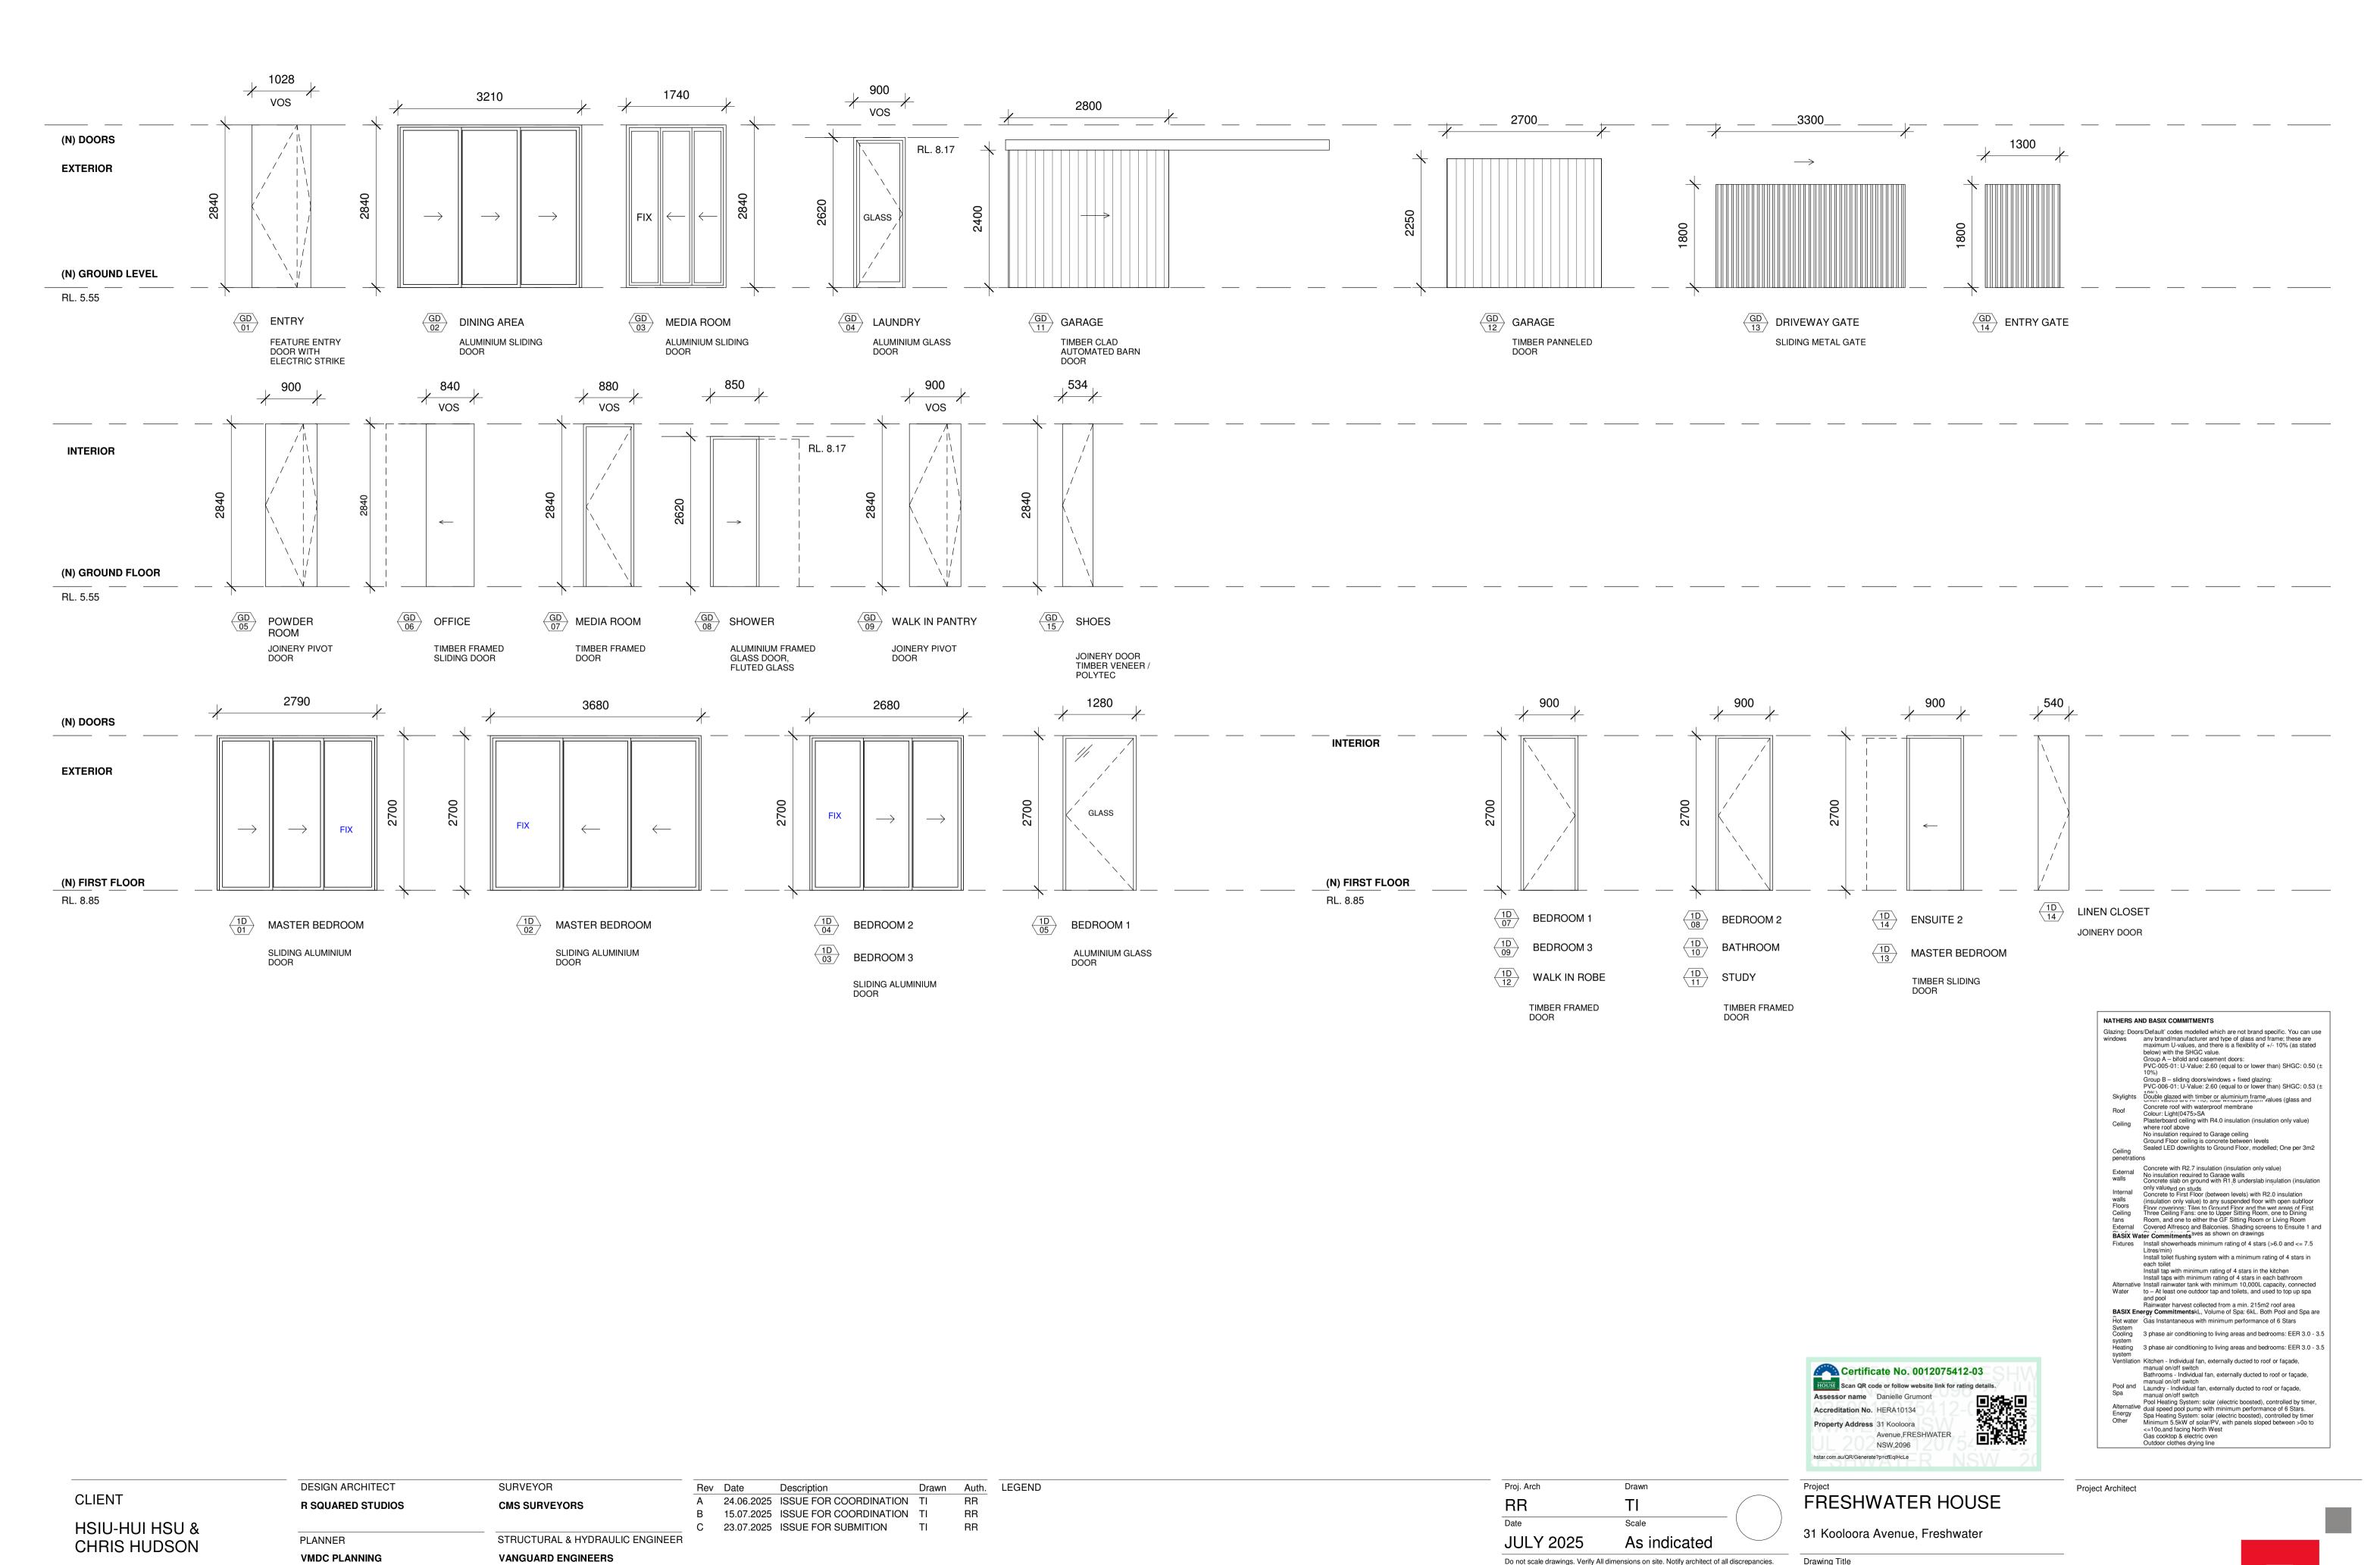
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Proj. Arch

Date

Drawing No. Revision AR.S455. 4000



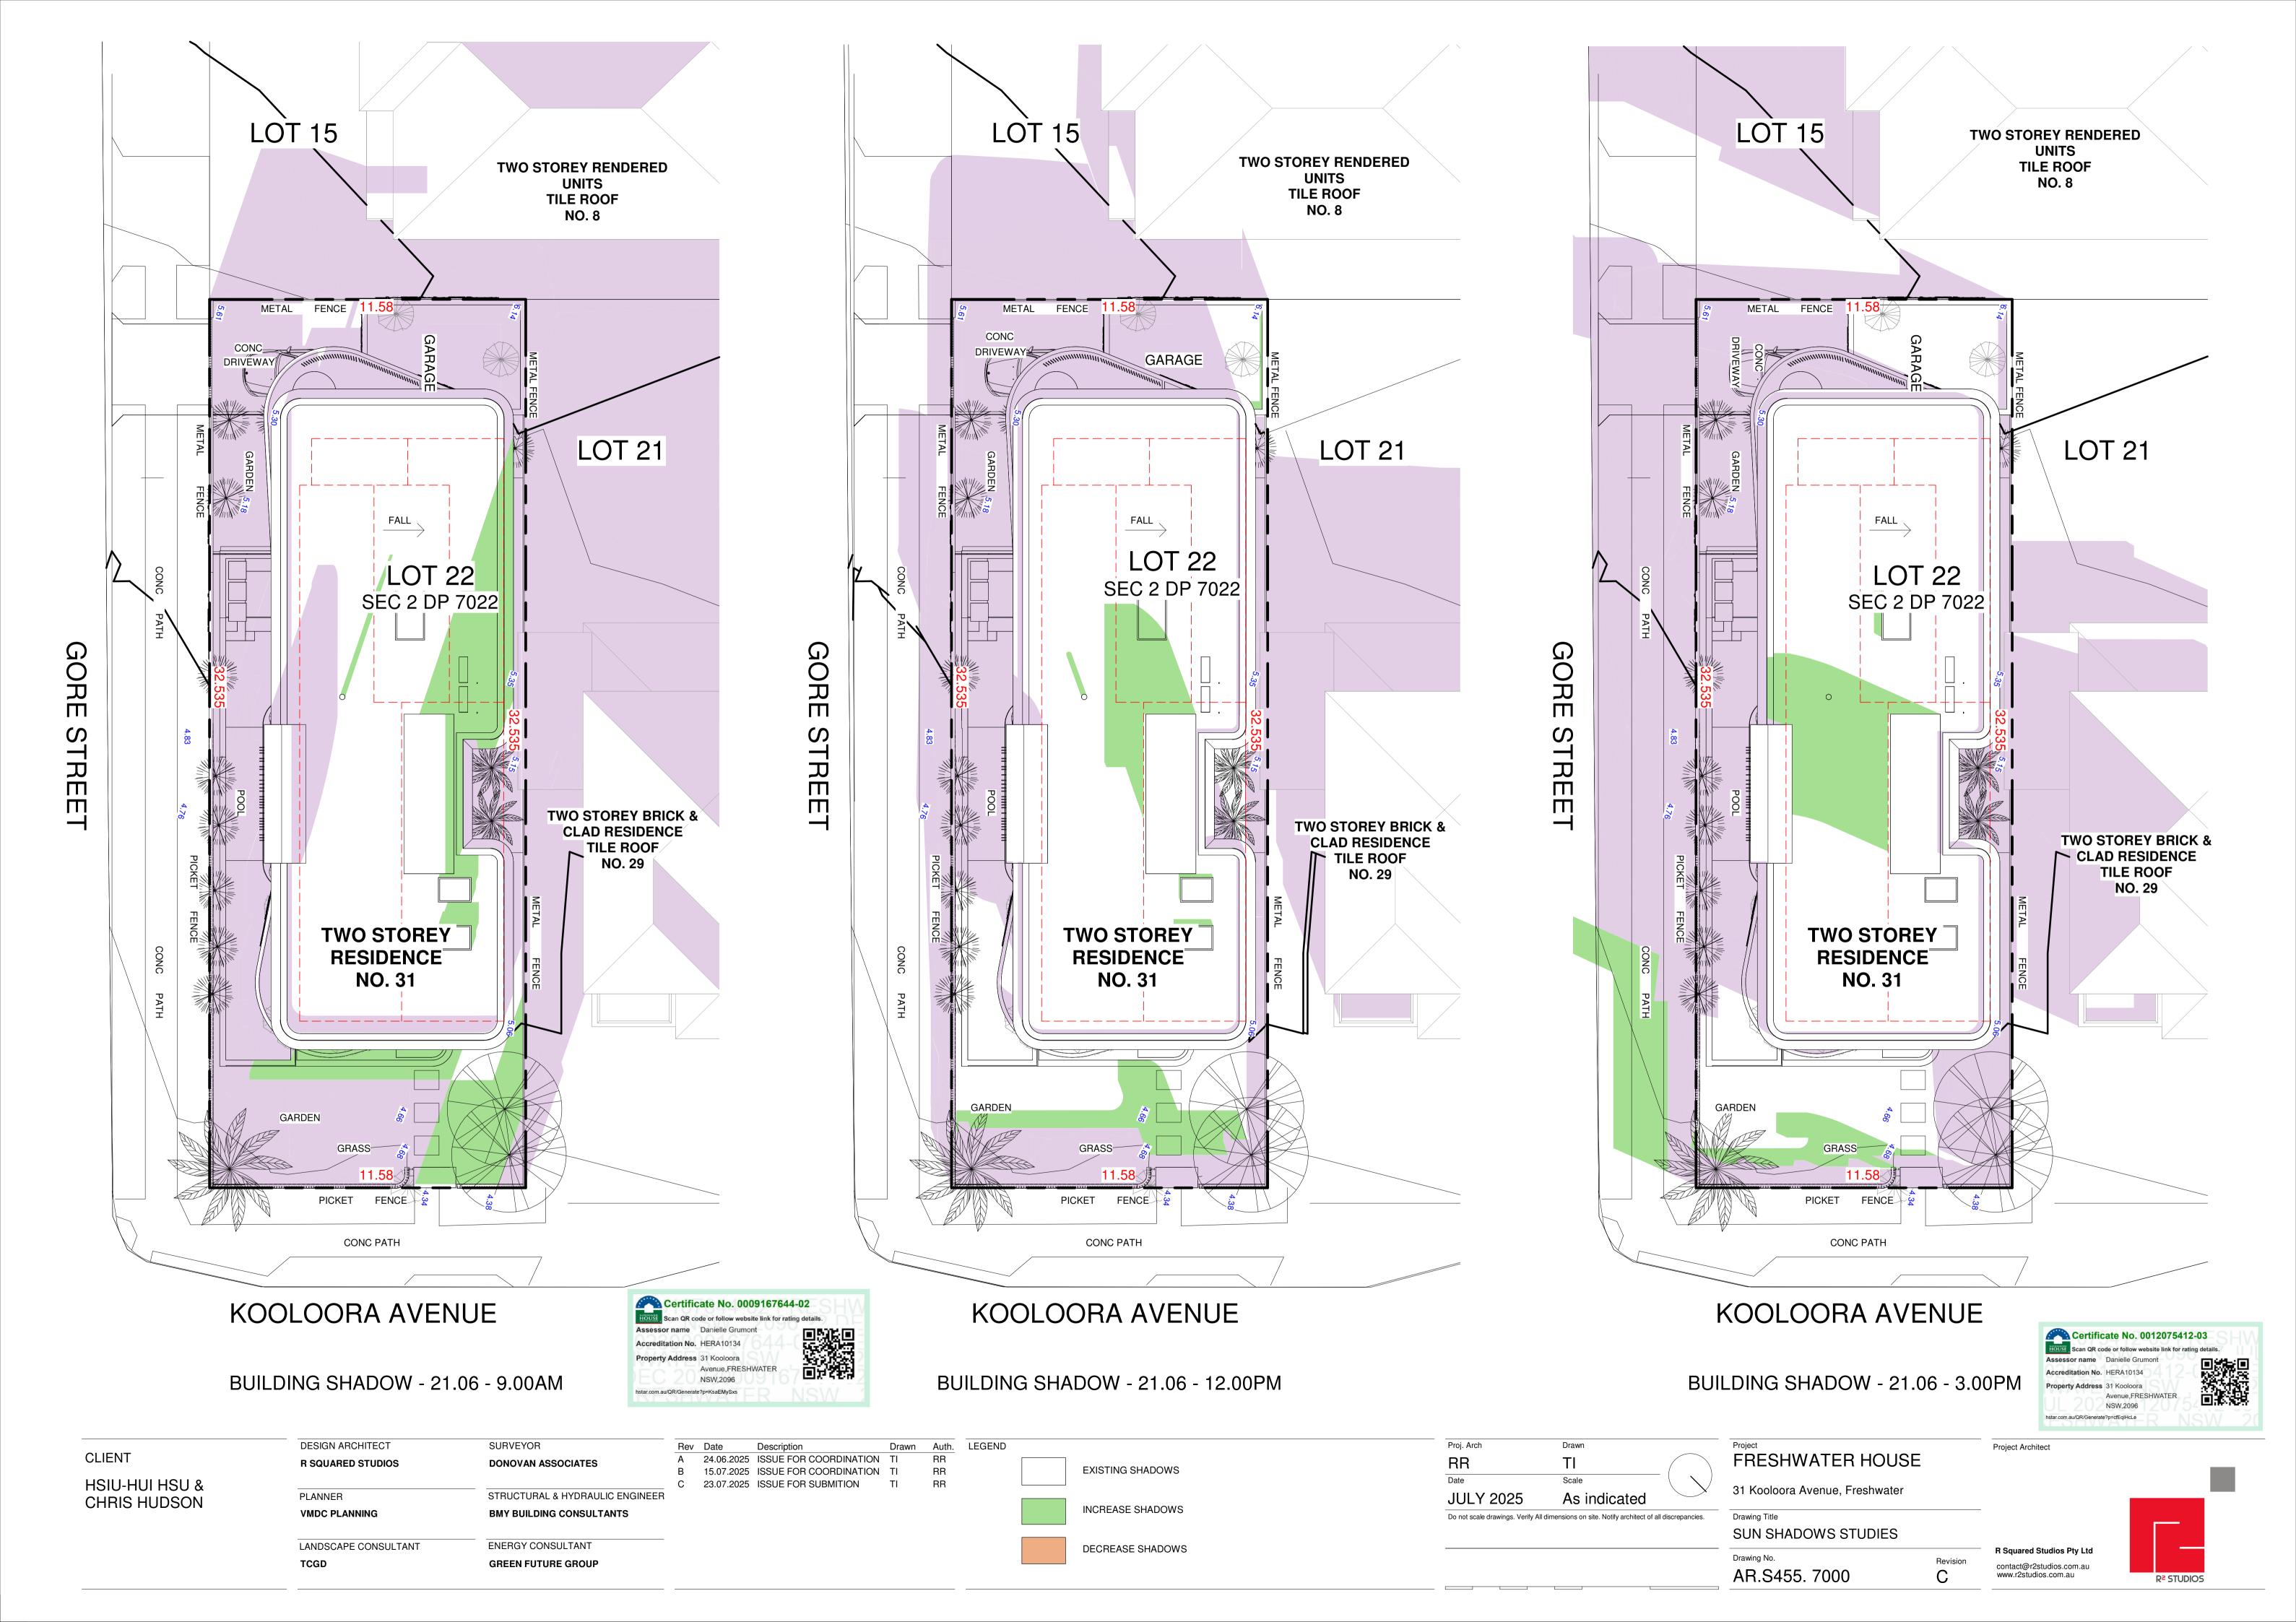

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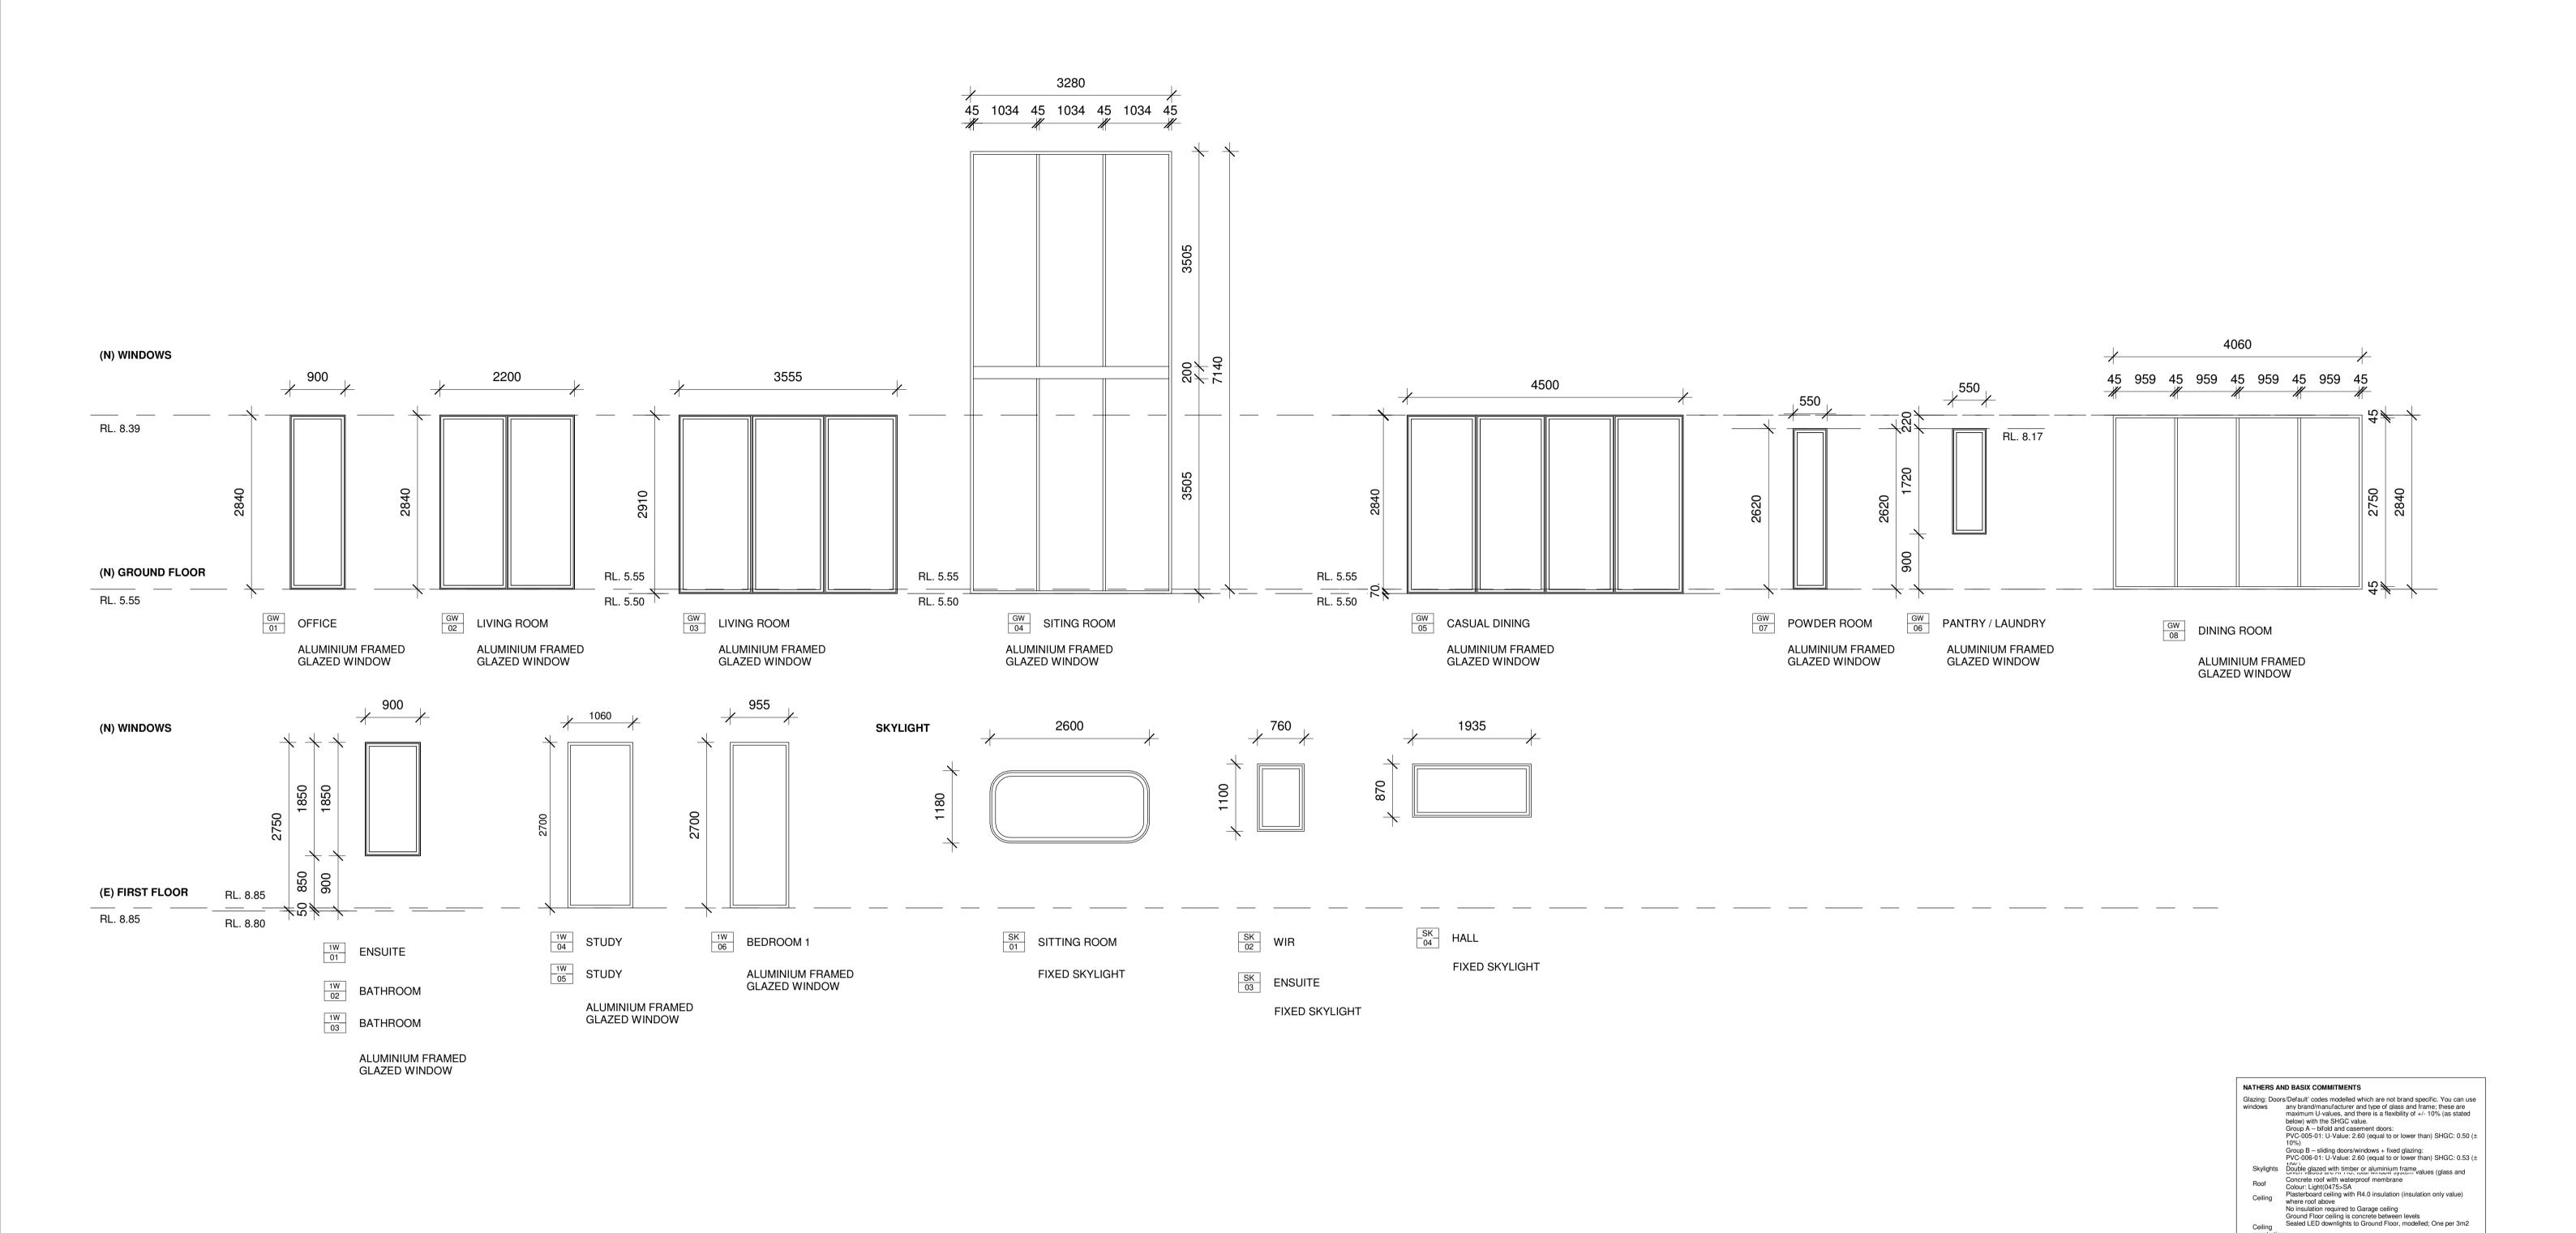
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R≥ STUDIOS

DOOR SCHEDULE

AR.S455. 3200

Drawing No.





Project Architect

FRESHWATER HOUSE Scale 31 Kooloora Avenue, Freshwater As indicated WINDOW SCHEDULE Drawing No.

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Concrete with R2.7 insulation (insulation only value) No insulation required to Garage walls Concrete slab on ground with R1.8 underslab insulation (insulation

Internal walls
Floors
Ceiling fans celling fans cond on the determination of the determinatio

Install taps with minimum rating of 4 stars in each bathroom
Alternative Install rainwater tank with minimum 10,000L capacity, connected to — At least one outdoor tap and toilets, and used to top up spa

and pool
Rainwater harvest collected from a min. 215m2 roof area

BASIX Energy CommitmentskL, Volume of Spa: 6kL. Both Pool and Spa are

Hot water

Gas Instantaneous with minimum performance of 6 Stars
System
Cooling
System
Heating
System
Ventilation

Kitchen - Individual fan, externally ducted to roof or façade,
manual on/off switch

Bathrooms - Individual fan, externally ducted to roof or façade, manual on/off switch Laundry - Individual fan, externally ducted to roof or façade, manual on/off switch Pool Heating System: solar (electric boosted), controlled by timer, dual speed pool pump with minimum performance of 6 Stars. Spa Heating System: solar (electric boosted), controlled by timer Minimum 5.5kW of solar/PV, with panels sloped between >00 to <=10o,and facing North West Gas cooktop & electric oven Outdoor clothes drying line

manual on/off switch Bathrooms - Individual fan, externally ducted to roof or façade,

Litres/min)
Install toilet flushing system with a minimum rating of 4 stars in each toilet
Install tap with minimum rating of 4 stars in the kitchen

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Drawn

Proj. Arch

Date

Revision AR.S455. 3201