

# **GENERAL NOTES:**

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- 6 Roof water & sub-soil drainage to be disposed of in the approved manner or as directed by local council inspectors.
  7 All electrical power & light outlets to be determined by owner.
  8 Make good and repair all existing finishes damaged by new work. Reuse existing material where possible.


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# DESIGN BY: MICHAL KORECKY


21 NALYA ROAD, NARRAWEENA NSW 2099 ABN: 79 393 130 294

Email: koreckym@gmail.com Phone: 99813332, Mob: 0438 148 944

PROJECT: ALTERATIONS AND ADDITIONS No 45 OXFORD FALLS ROAD BEACON HILL JIRI AND MARCELA ALBRECHT DATE: 17/04/24 | SCALE: AS NOTED DRAWN: MK ISSUE: DRAWING Nr SHEET: 2 18080



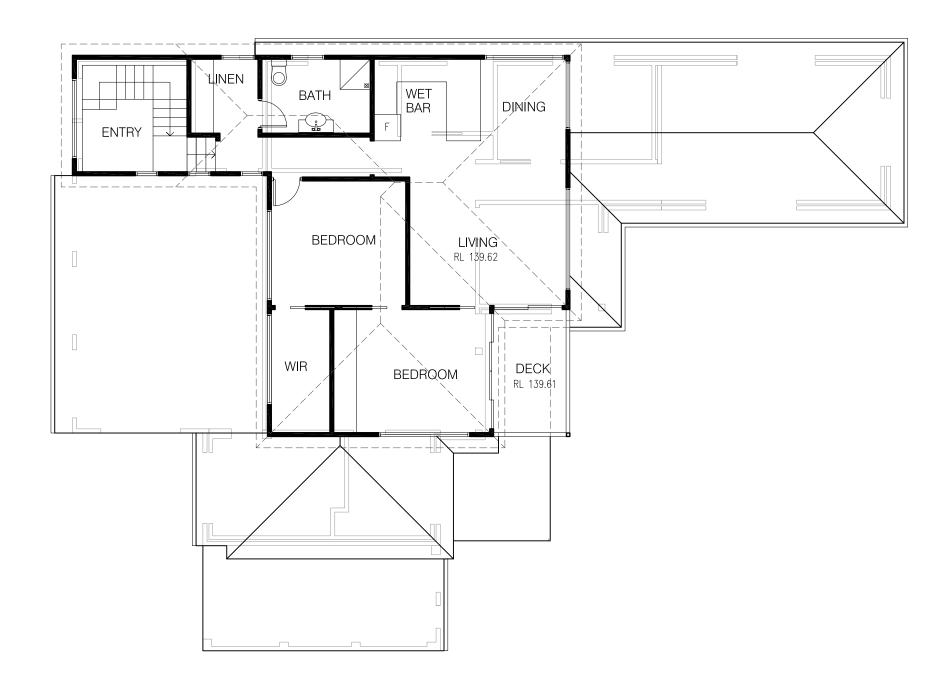

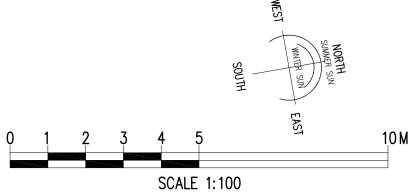

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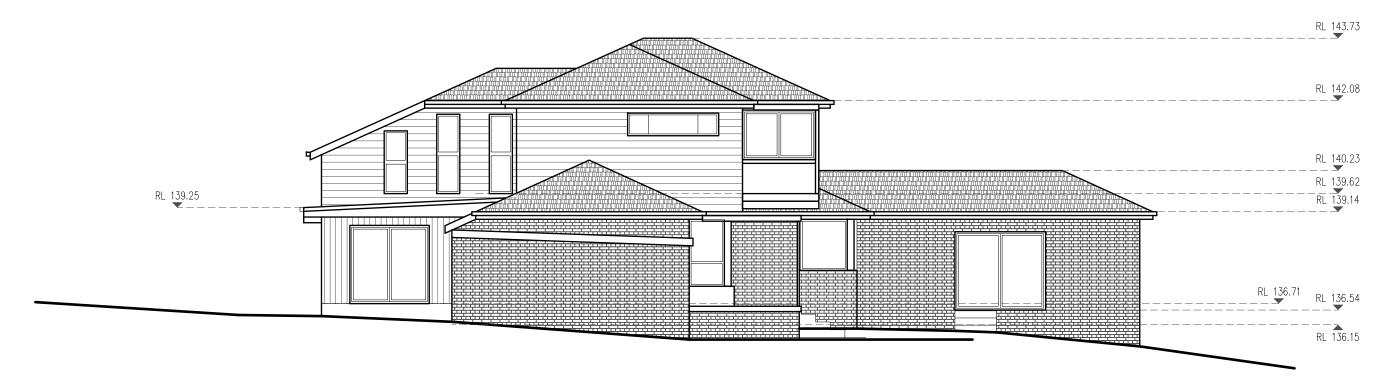
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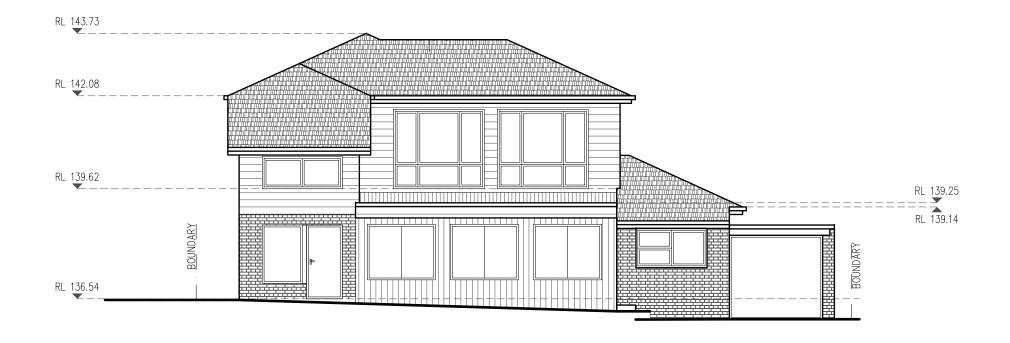
# DESIGN BY: MICHAL KORECKY

	DESIGN BY:  MICHAL KORECKY  21 NALYA ROAD, NARRAWEENA NSW 2099	PROJECT: ALTERATIONS AND ADDITIONS No 45 OXFORD FALLS ROAD
	ABN: 79 393 130 294	BEACON HILL
١	Email: koreckym@gmail.com www.plansdesign.com.au	CLIENT:
	Phone: 99813332, Mob: 0438 148 944	JIRI AND MARCELA ALBRECHT

1	ALE 1:100				
	DATE:	17/04/24	SCALE:	AS NOTED	
	DRAWN:	MK	ISSUE:	1	
	DRAWING	Nr : 8080	SHEET:	3	



# **EXISTING EAST ELEVATION**





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SO	SCALE 1:100					
	DATE: 17/04/24	SCALE:	AS NOTED			
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	DRAWING Nr : 18080	SHEET:	4			



**EXISTING WEST ELEVATION** 



# **EXISTING NORTH ELEVATION** 1:100

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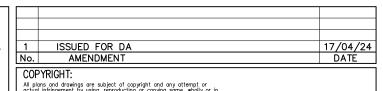
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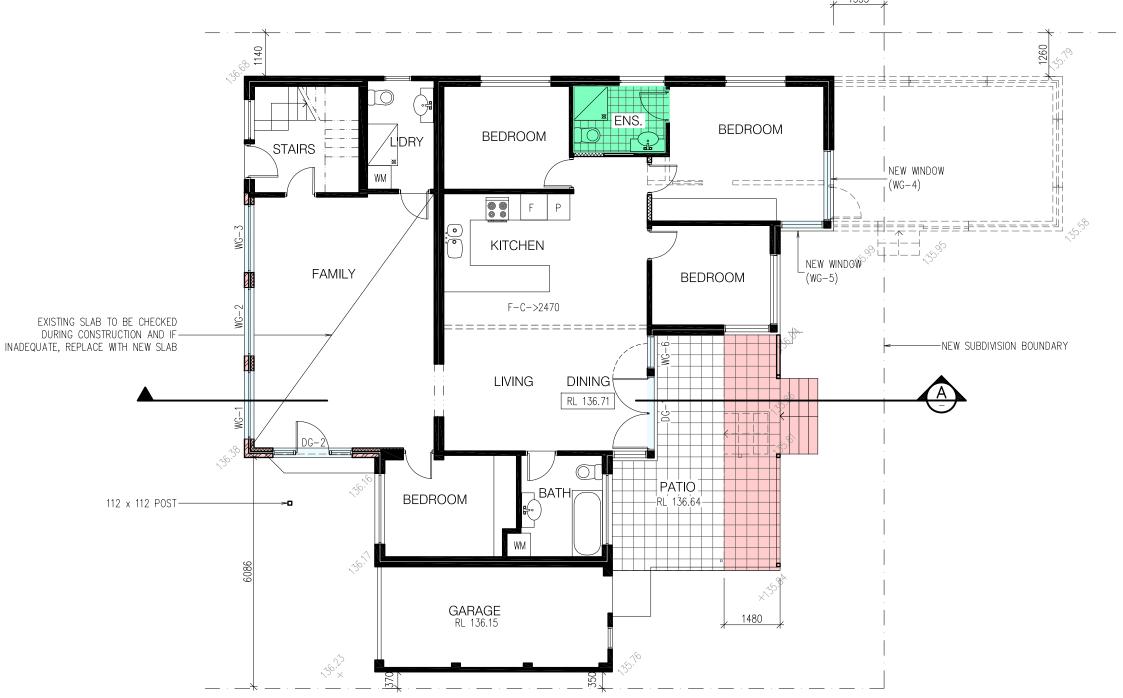
ABN: 79 393 130 294 Email: koreckym@gmail.com Phone: 99813332, Mob: 0438 148 944 PROJECT:

ALTERATIONS AND ADDITIONS No 45 OXFORD FALLS ROAD BEACON HILL

CLIENT:
JIRI AND MARCELA ALBRECHT

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# PROPOSED GROUND FLOOR PLAN

# **NOTES**

ALL DIMENSIONS ARE IN MILLIMETRES U.N.O. AND SHOULD BE VERIFIED ON SITE BY THE BUILDER WHO WILL BE RESPONSIBLE FOR THE ACCURATE SETTING OUT OF THE JOB.

ANY DISCREPANCIES MUST BE RESOLVED PRIOR TO COMMENCEMENT OF WORK.


ALL CONSTRUCTION IS TO COMPLY WITH THE RELEVANT SAA BUILDING CODES AND TO THE LOCAL COUNCIL REQUIREMENTS AND OTHER AUTHORITIES CONCERNED.

ALL DIMENSIONS THAT RELATE TO SITE BOUNDARIES AND EASEMENTS ARE SUBJECT TO VERIFICATION BY A SITE SURVEY. FIGURED DIMENSIONS TAKE PRECEDENCE OVER SCALED READINGS. ALL TIMBER CONSTRUCTION IS TO BE IN ACCORDANCE WITH THE 'NATIONAL TIMBER FRAMING CODE A.S.1684.

ROOF WATER AND SUB SOIL DRAINAGE TO BE DISPOSED OF IN THE APPROVED MANNER OR AS DIRECTED BY LOCAL INSPECTORS. FINAL POSITION OF ALL DOWNPIPES TO BE DECIDED BY

ANY STRUCTURAL DETAILS OR DESIGN IS TO BE SUPPLIED BY A STRUCTURAL ENGINEER.

- ALL LEVELS ARE TO AUSTRALIAN HEIGHT DATUM.
- 10. ALL ELECTRICAL, POWER & LIGHT OUTLETS AS DETERMINED
- 11. MAKE GOOD & REPAIR ALL EXISTING FINISHES AFFECTED BY NEW WORK. RE-USE EXISTING MATERIALS WHERE POSSIBLE.
- 12. ANY DETAILING IN ADDITION TO WHAT IS SUPPLIED ON THIS DRAWING SHALL BE RESOLVED BETWEEN THE OWNER & THE

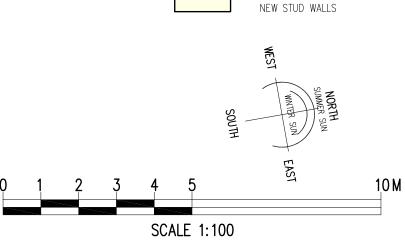

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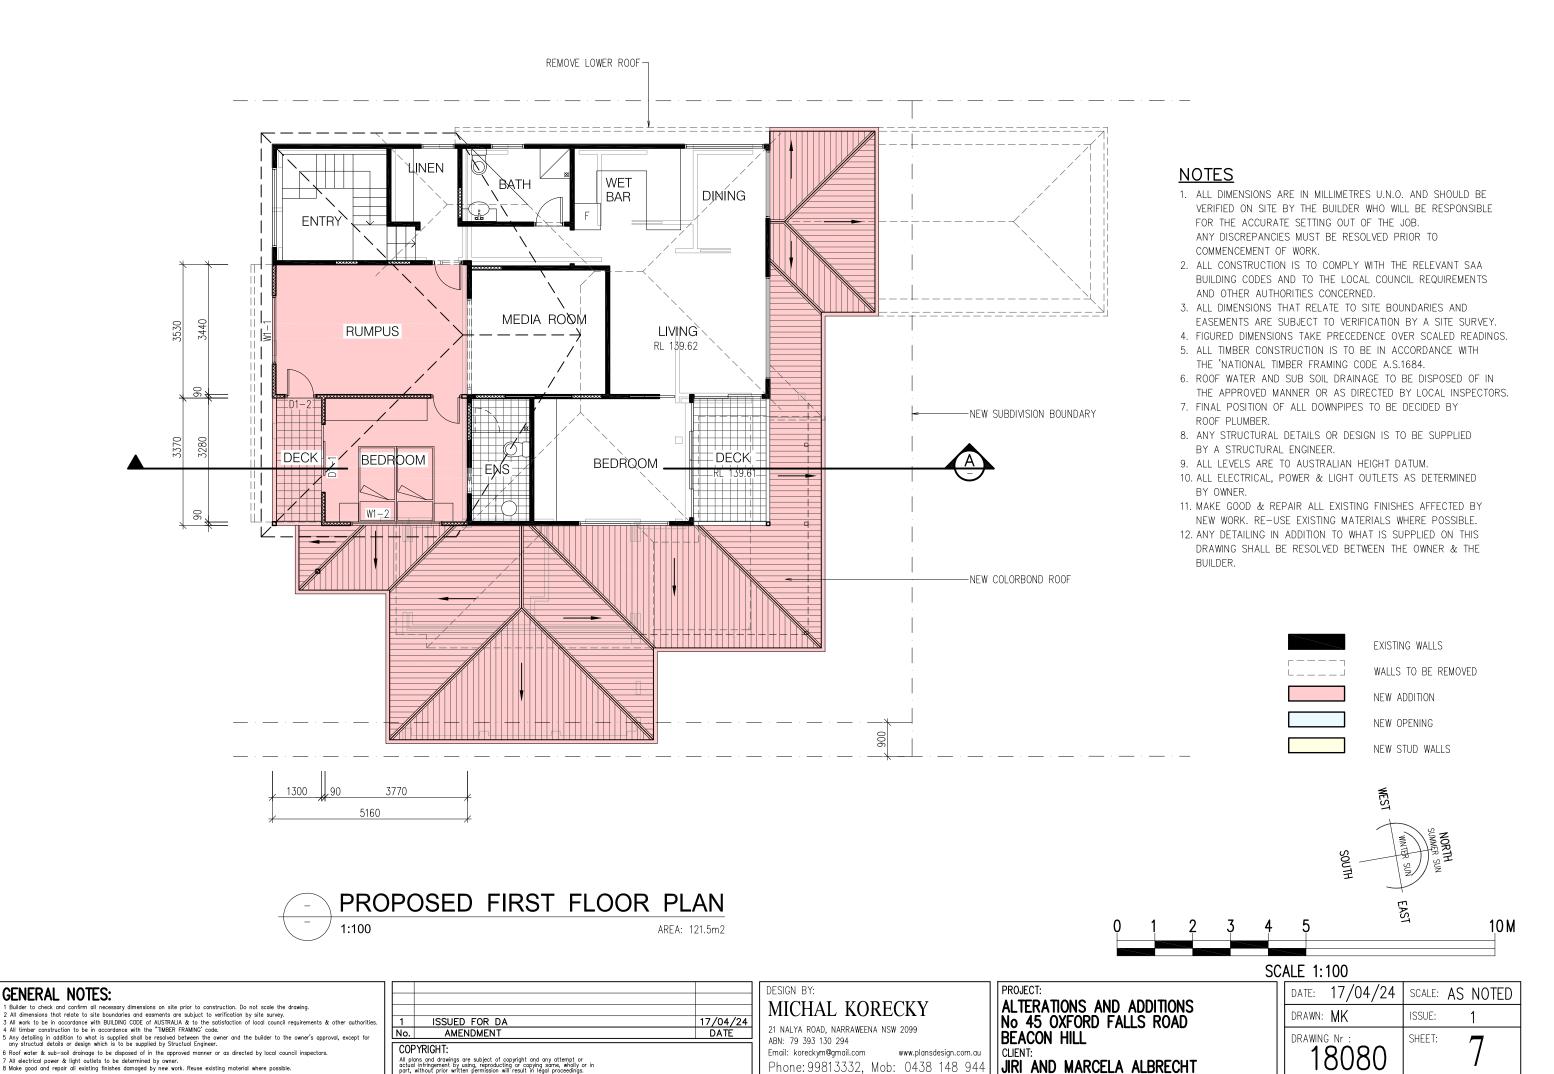
www.plansdesign.com.au Phone: 99813332, Mob: 0438 148 944 **ALTERATIONS AND ADDITIONS** No 45 OXFORD FALLS ROAD BEACON HILL JIRI AND MARCELA ALBRECHT


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DRAWING Nr : 18080	SHEET: 6

EXISTING WALLS


NEW ADDITION NEW OPENING

WALLS TO BE REMOVED



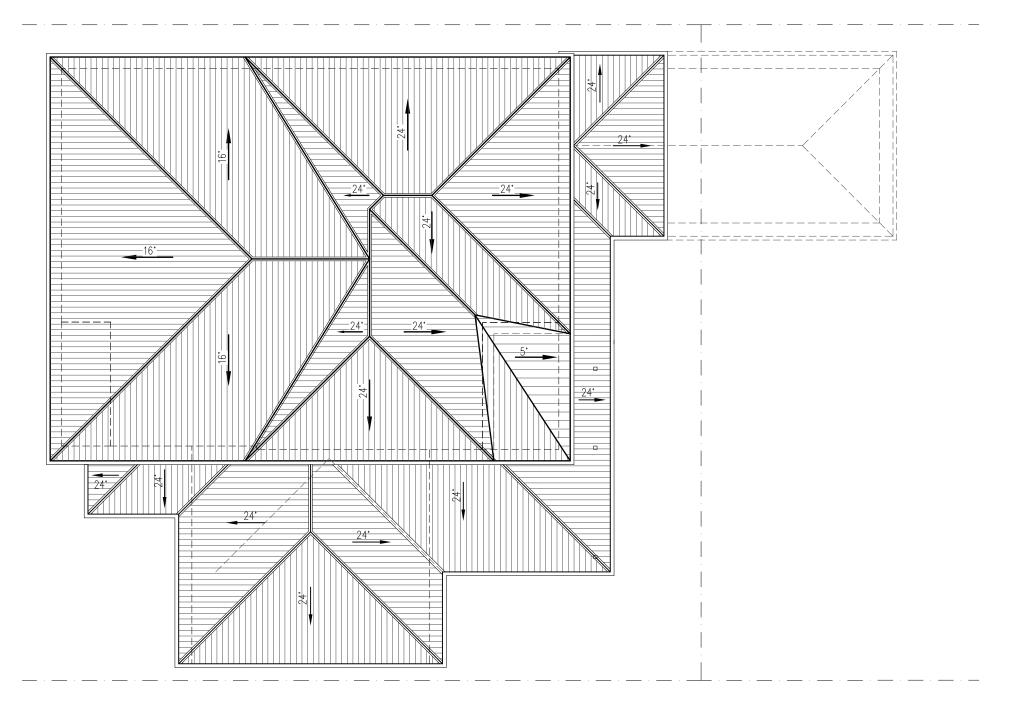



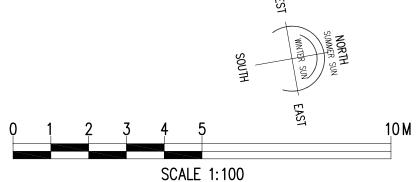

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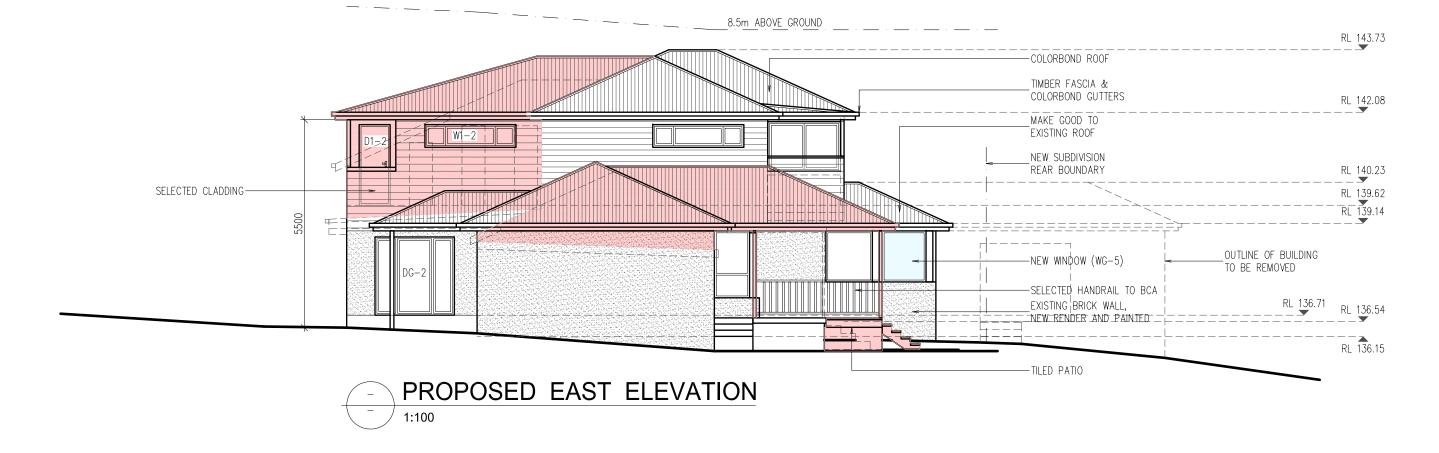
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	VIDIOLIT		ABN: 79 393 1
I COF	YRIGHT:		Email: koreckym

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21 NALYA ROAD, NARRAWEENA NSW 2099
ABN: 79 393 130 294
Email: koreckym@gmail.com www.plansdesign.com.au
Phone: 998133332, Mob: 0438 148 944

PROJECT: ALTERATIONS AND ADDITIONS No 45 OXFORD FALLS ROAD BEACON HILL CLIENT:
JIRI AND MARCELA ALBRECHT

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No 45 OXFORD FALLS ROAD
REACON HILL
CLIENT:
PROJECT: ALTERATIONS AND ADDITIONS No 45 OXFORD FALLS ROAD BEACON HILL CLIENT: JIRI AND MARCELA ALBRECHT

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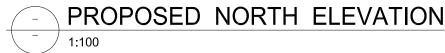


# PROPOSED WEST ELEVATION 1:100



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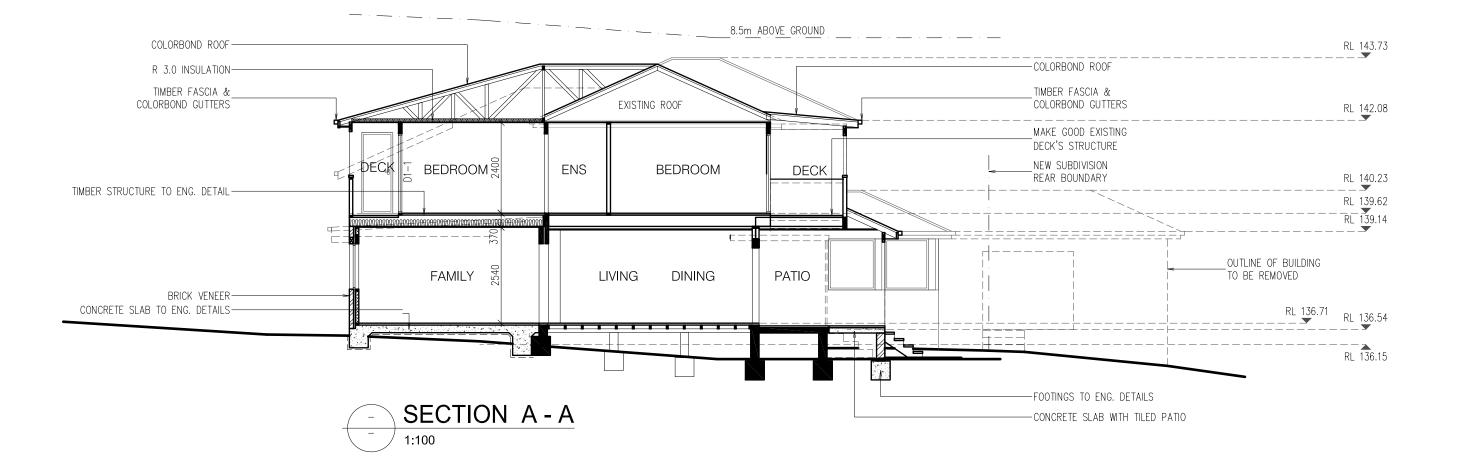
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		W	INDOWS	AND DOOR S	CHEDULE (FOR BASIX PURPOS	ES ONLY)
	ORIENT.	SI	ZE	AREA (m2)	SHADING DEVICE	FRAME AND GLASS TYPE
	WG-1 SOUTH WG-2 SOUTH WG-3 SOUTH WG-4 NORTH WG-5 EAST WG-6 NORTH	W	Н	ANLA (IIIZ)	SHADING DEVICE	MIN. REQUIREMENTS
WG-1	SOUTH	1800	1200	2.16	NONE	standard aluminium single clear
WG-2	SOUTH	1800	1200	2.16	NONE	standard aluminium single clear
WG-3	SOUTH	1800	1200	2.16	NONE	standard aluminium single clear
WG-4			standard aluminium, low—E			
WG-5	EAST	1160	1350 1.57 EAVE/PERGOLA >=450mm		EAVE/PERGOLA >=450mm	standard aluminium, low—E
WG-6	NORTH	900	2230	2.00	EAVE/PERGOLA >=900mm	standard aluminium single clear
DG-1	NORTH	1990	2230	4.44	EAVE/PERGOLA >=900mm	standard aluminium single clear
DG-2	DG-2 EAST 2100 2070 4.35 EAVE/PERG		EAVE/PERGOLA >=900mm	standard aluminium single clear		
W1-1	SOUTH	1810	1100	2.00	NONE	standard aluminium single clear
W1-2	EAST	2410	600	1.45	NONE	standard aluminium single clear
D1-1	SOUTH	1800	2100	3.78	EAVE/PERGOLA >=900mm	standard aluminium single clear
D1-2	EAST	820	2130	1.75	EAVE/PERGOLA >=900mm	standard aluminium single clear

### BASIX COMMITMENTS CERTIFICATE NUMBER A1731377\_02

### NATURAL LIGHTING

THE APPLICANT MUST ENSURE A MINIMUM OF 40% OF NEW OR ALTERED LIGHT FIXTURES ARE FITTED WITH FLUORESCENT, COMPACT FLUORESCENT, OR LIGHT-EMITTING-DIODE (LED) LAMPS.

THE APPLICANT MUST ENSURE NEW OR ALTERED SHOWERHEADS HAVE A FLOW RATE NO GREATER THAN 9 LITRES PER MINUTE OR A 3 STAR WATER RATING.

THE APPLICANT MUST ENSURE NEW OR ALTERED TOILETS HAVE A FLOW RATE NO GREATER THAN 4 LITRES PER AVERAGE FLUSH OR A MINIMUM 3 STAR WATER RATING.

THE APPLICANT MUST ENSURE NEW OR ALTERED TAPS HAVE A FLOW RATE NO GREATER THAN 9 LITRES PER MINUTE OR MINIMUM 3 STAR WATER RATING.

### WINDOWS AND GLAZED DOORS

(SEE WINDOW SCHEDULE)

CONCRETE SLAB ON GROUND FLOOR: NIL

EXTERNAL WALL: FRAMED (WEATHERBOARD, FIBRO, METAL CLAD): R1.30 (OR R1.70 INCLUDING CONSTRUCTION)

EXTERNAL WALL: BRICK VENEER, R1.16 (OR R1.70 INCLUDING CONSTRUCTION)

FLAT CEILING, PITCHED ROOF: CEILING: R3.0 (UP), ROOF: FOIL/SARKING, MEDIUM (SOLAR ABSORPTANCE 0.475 - 0.70)



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JIRI AND MARCELA ALBRECHT

DATE: 17/04/24	SCALE:	AS NOTED
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DRAWING Nr : 18080	SHEET:	11



### Alterations and Additions

Certificate number: A1731377 02

This certificate confirms that the proposed development will meet the NSW government's requirements for sustainability, if a is built in accordance with the continuous set yet ablow. There used in this certificate, or in the commitments, have the meaning given by the document entitled "BASK Definitions" dated 10.090/200 pubsited by the Department. This document is available at www.basix.naw.gov.au

Secretary
Date of Issue: Wednesday, 17 April 2024
To be valid, this certificate must be submitted with a development application or lodged with a complying development certificate application within 3 months of the date of Issue.



BASIX Certificate number:A1731377\_02

Project name	Alterations and additions_02
Street address	45 OXFORD FALLS ROAD - BEACON HILL 2100
Local Government Area	Northern Beaches Council
Plan type and number	Deposted Plan 206629
Lot number	1
Section number	*
Project type	
Dwelling type	Dwelling house (detached)
Type of alteration and addition	The estimated development cost for my renovation work is \$50,000 or more, and does not include a pool (and/or spa).
NA	N/A
Certificate Prepared by	ease complete before autimitting to Council or PCA)
Name / Company Name: Mr Michal	In Albrocht Korocky

Fixtures and systems	Show on DA Plans	Show on CC/CDC Plans & specs	Certifier Check
Lighting			
The applicant must ensure a minimum of 40% of new or altered light fixtures are fitted with fluorescent, compact fluorescent, or light- emitting-diode (LED) lamps.		~	~
Fixtures			
The applicant must ensure new or altered showerheads have a flow rate no greater than 9 litres per minute or a 3 star water rating.		~	~
The applicant must ensure new or altered toilets have a flow rate no greater than 4 litres per average flush or a minimum 3 star water rating.		V	~
The applicant must ensure new or altered taps have a flow rate no greater than 9 litres per minute or minimum 3 star water rating.		~	

~

Show on Show of DA Plans 8 For projections described in millimetres, the leading edge of each eave, pergola, verandah, balcony or awning must be no more than 500 mm above the head of the window or glazed door and no more than 2400 mm above the sill. Pergolas with fixed battens must have battens parallel to the window or glazed door above which they are situated, unless the pergol also shades a perpendicular window. The spacing between battens must not be more than 50 mm.

CC/CDC specs	Certifier Check	
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Blazing requir	ements						Show on DA Plans	Show on CC/CDC Plans & specs	Certifier
/indows and gla	zed doors glazing	requirements							
Window/door number	Orientation	Area of glass including frame (m2)	Overshadowing height (m)	Overshadowing distance (m)	Shading device	Frame and glass type			
WG-4	N	2.56	0	0	eave/ verandah/ pergola/balcony >=450 mm	standard aluminium, single pyrolytic lowe, (U- value: 5.7, SHGC: 0.47)			
WG-5	E	1.57	0	0	eave/ verandah/ pergola/balcony >=450 mm	standard aluminium, single pyrolytic low-e, (U- value: 5.7, SHGC: 0.47)			
WG-1	S	2.16	0	0	none	standard aluminium, single clear, (or U-value: 7.63, SHGC: 0.75)			
WG-2	S	2.16	0	0	none	standard aluminium, single clear, (or U-value: 7.63, SHGC: 0.75)			
WG-3	S	2.16	0	0	none	standard aluminium, single clear, (or U-value: 7.63, SHGC: 0.75)			

lazing requir	ements						Show on DA Plans	Show on CC/CDC Plans & specs	Certifie Check
Window/door number	Orientation	Area of glass including frame (m2)	Overshadowing height (m)	Overshadowing distance (m)	Shading device	Frame and glass type			
WG-6	N	2	0	0	eave/ verandah/ pergola/balcony >=900 mm	standard aluminium, single clear, (or U-value 7.63, SHGC: 0.75)			
DG-1	N	4.44	0	0	eave/ verandah/ pergola/balcony >=900 mm	standard aluminium, single clear, (or U-value: 7.63, SHGC: 0.75)			
DG-2	E	4.35	0	0	eave/ verandah/ pergola/balcony >=900 mm	standard aluminium, single clear, (or U-value: 7.63, SHGC: 0.75)			
W1-1	s	2	0	0	none	standard aluminium, single clear, (or U-value: 7.63, SHGC: 0.75)			
W1-2	E	1.45	0	0	projection/ height above sill ratio >=0.43	standard aluminium, single clear, (or U-value: 7.63, SHGC: 0.75)			

Slazing requir	ements zed doors glazin	g requirements					Show on DA Plans	Show on CC/CDC Plans & specs	Certifier Check
Window/door number	Orientation	Area of glass including frame (m2)	Overshadowing height (m)	Overshadowing distance (m)	Shading device	Frame and glass type			
D1-1	s	3.78	0	0	eave/ verandah/ pergola/balcony >=900 mm	standard aluminium, single clear, (or U-value: 7.63, SHGC: 0.75)			
D1-2	E	1.75	0	0	eave/ verandah/ pergola/balcony >=900 mm	standard aluminium, single clear, (or U-value: 7.63, SHGC: 0.75)			

Le	gend
In t	hese commitments, "applicant" means the person carrying out the development.
	mmitments identified with a 🎺 in the "Show on DA plans" column must be shown on the plans accompanying the development application for the proposed development (if a velopment application is to be lodged for the proposed development).
	mmirments identified with a 💆 in the "Show on CCICDC plans & specis" column must be shown in the plans and specifications accompanying the application for a construction trificate / complying development certificate for the proposed development.
	mmitments identified with a 🏏 in the "Certifier check" column must be certified by a certifying authority as having been fulfilled, before a final occupation certificate for the development by be issued.



DESIGN BY:

1 Builder to check and confirm all necessary dimensions on site prior to construction. Do not scale the drawing.
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6 Roof water & sub-soil drainage to be disposed of in the approved manner or as directed by local council inspectors.
7 All electrical power & light outlets to be determined by owner.
8 Make good and repair all existing finishes damaged by new work. Reuse existing material where possible.

**GENERAL NOTES:** 

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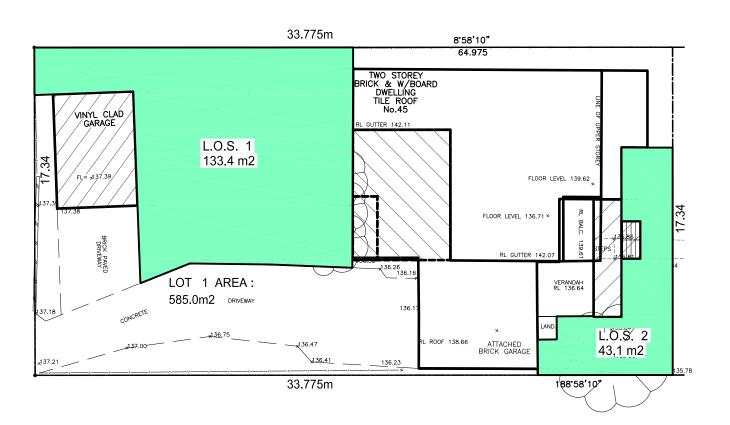
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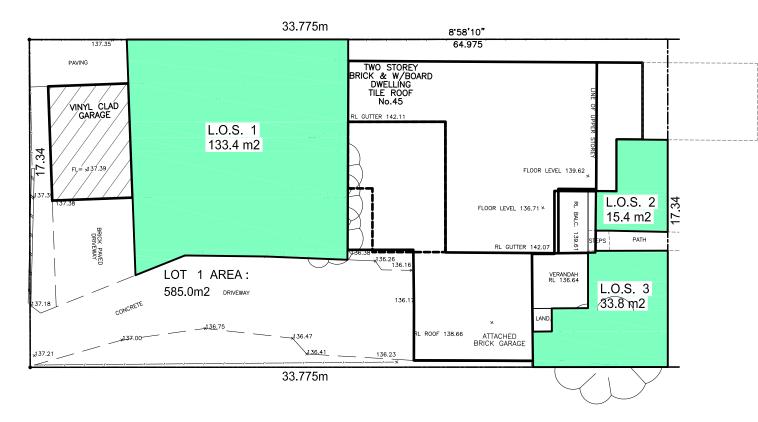
21 NALYA ROAD, NARRAWEENA NSW 2099 ABN: 79 393 130 294

Email: koreckym@gmail.com www.plansdesign.com.au Phone: 99813332, Mob: 0438 148 944

PROJECT: ALTERATIONS AND ADDITIONS No 45 OXFORD FALLS ROAD BEACON HILL JIRI AND MARCELA ALBRECHT

DATE: 17/04/24	SCALE:	AS NOTED
DRAWN: MK	ISSUE:	1
18080	SHEET:	12






PROPOSED L.O.S CALCULATION SHEET

EXISTING L.O.S CALCULATION SHEET

L.O.S. CALCULATIO	N (m2)
SITE AREA	585.00
L.O.S. 1	146.00
L.O.S. 2	43.10
TOTAL L.O.S.	176.5 (32.3%)



L.O.S. CALCULATION	l (m2)
SITE AREA	585.00
L.O.S. 1	133.40
L.O.S. 2	15.40
L.O.S. 3	33.80
TOTAL L.O.S.	182.6 (31.2%)

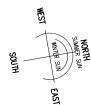

0 1 2 3 4 5

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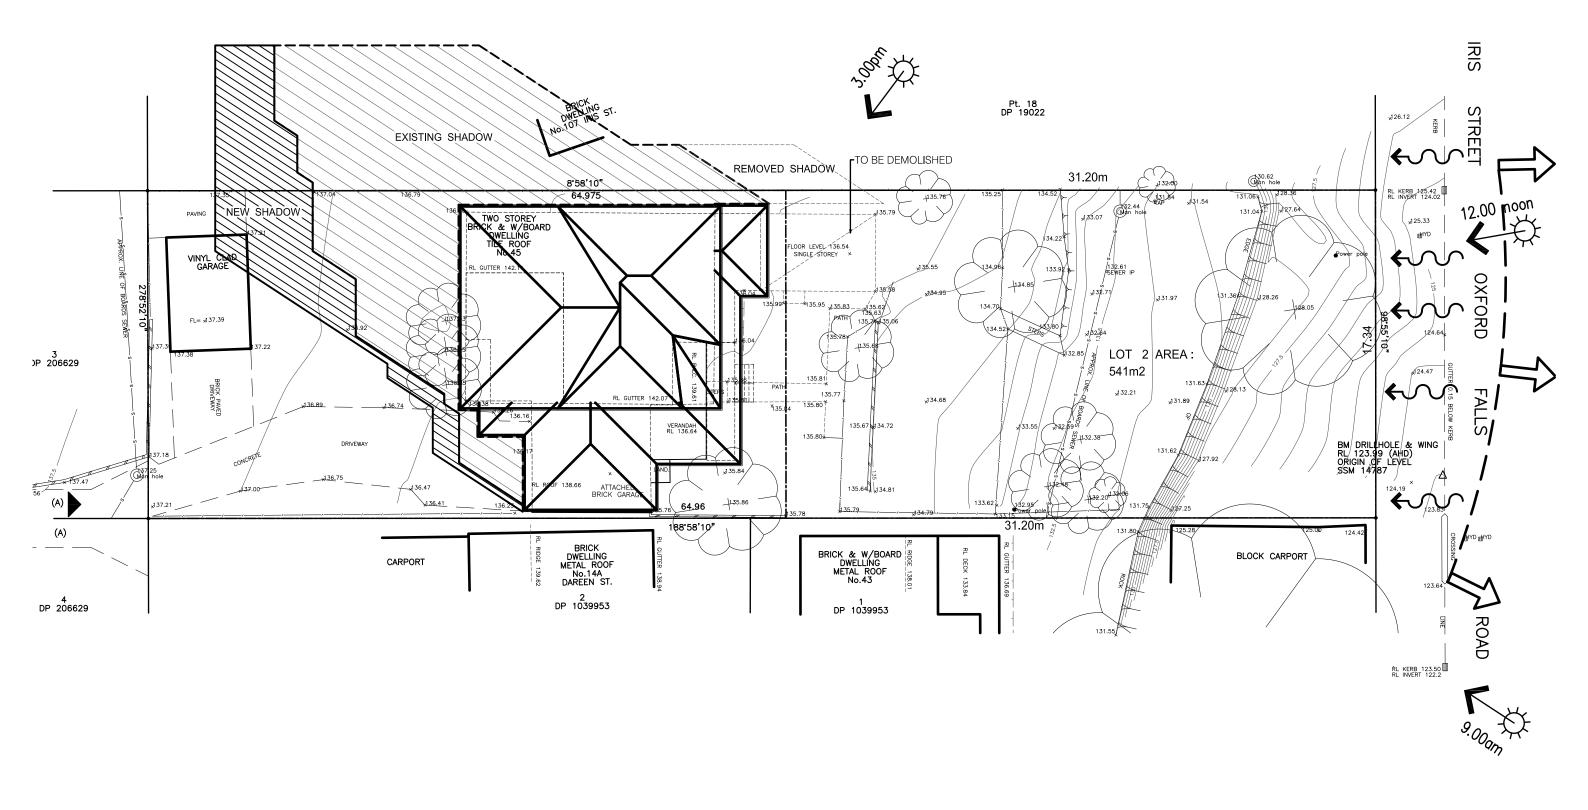
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PROJECT: ALTERATIONS AND ADDITIONS No 45 OXFORD FALLS ROAD BEACON HILL JIRI AND MARCELA ALBRECHT

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DATE: 17/04/24	SCALE: AS NOTED
DRAWN: MK	ISSUE: 1
DRAWING Nr : 18080	SHEET: 13





# SHADOW DIAGRAM AZIMUTH 43° ALTITUDE 20° 21/6 - 9:00

**GENERAL NOTES:** 

Builder to check and confirm all necessary dimensions on site prior to construction. Do not scale the drawing,
2. All dimensions that relate to site boundaries and easments are subjuct to verification by site survey.
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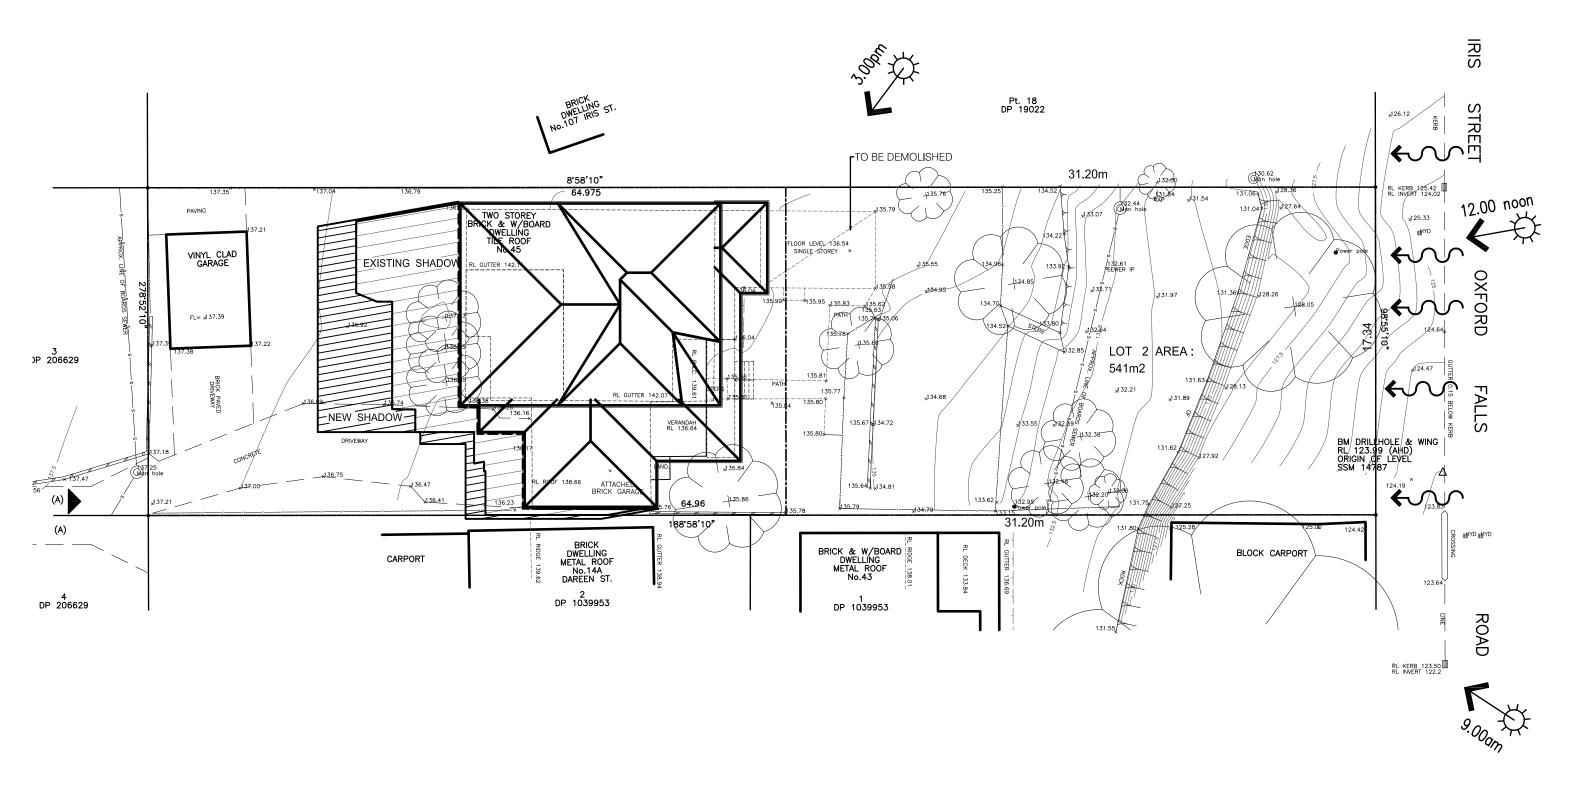
### PROJECT:

ALTERATIONS AND ADDITIONS No 45 OXFORD FALLS ROAD BEACON HILL JIRI AND MARCELA ALBRECHT

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# SHADOW DIAGRAM AZIMUTH 0° ALTITUDE 34° 21/6 - 12:00

17/04/24 DATE ISSUED FOR DA AMENDMENT No.

Builder to check and confirm all necessary dimensions on site prior to construction. Do not scale the drawing. All dimensions that relate to site boundaries and easments are subjuct to verification by site survey. All work to be in accordance with BUILDING CODE of AUSTRALIA & to the satisfaction of local council requirem All timber construction to be in accordance with the "TIMBER FRAMING" code. Any detailing in addition to what is supplied shall be resolved between the owner and the builder to the owner's appr any structual details or design which is to be supplied by Structual Engineer.

Roof water & sub-soil drainage to be disposed of in the approved manner or as directed by local co 7 All electrical power & light outlets to be determined by owner. 3 Make good and repair all existing finishes damaged by new work. Reuse existing material where possil

**GENERAL NOTES:** 

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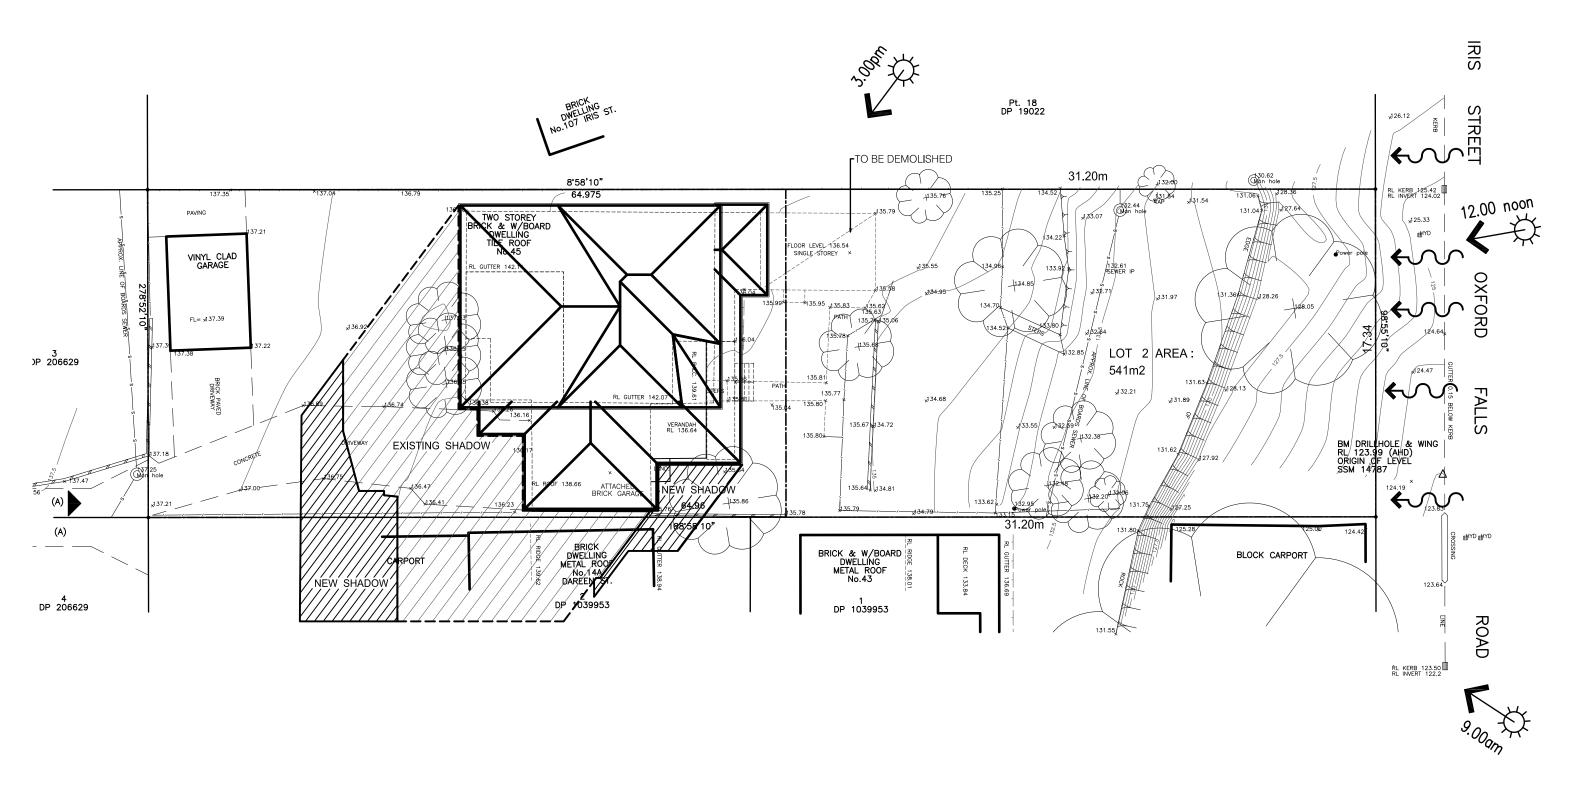
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Email: koreckym@gmail.com Phone: 99813332, Mob: 0438 148 944

PROJECT: ALTERATIONS AND ADDITIONS No 45 OXFORD FALLS ROAD BEACON HILL JIRI AND MARCELA ALBRECHT

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SHADOW DIAGRAM AZIMUTH -43° ALTITUDE 20° 21/6 - 3:00

1:200

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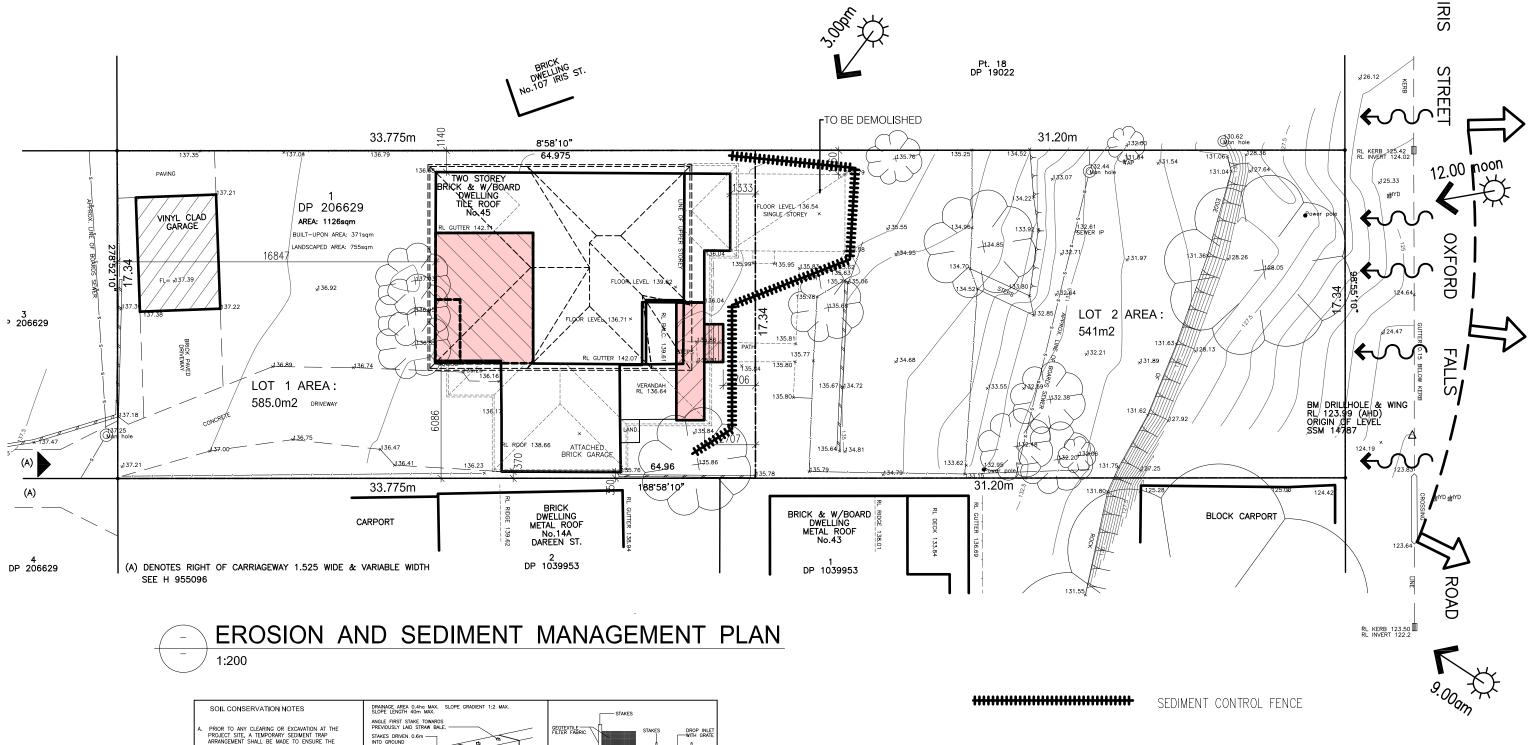
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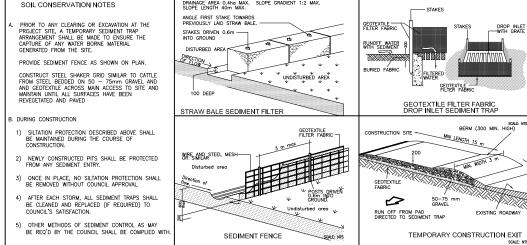
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# **GENERAL NOTES:**

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