

ALL WORKS TO BE IN ACCORDANCE WITH AUSTRALIAN STANDARDS, THE BUILDING CODE OF AUSTRALIA, OTHER RELEVANT CODES, AND WITH MANUFACTURER'S RECCOMENDATIONS AND INSTRUCTIONS. DO NOT SCALE FROM DRAWINGS. VERIFY ALL DIMENSIONS ON SITE PRIOR TO CONSTRUCTION. THIS DRAWING IS COPYRIGHT AND MAY NOT BE USED WITHOUT WRITTEN CONSENT FROM SARAH BLACKER.

PROJECT ADDRESS DOCUMENT DRAWING

LIEBKE RESIDENCE 73 BRIGHTON STREET, CURL CURL DEVELOPMENT APPLICATION PROPOSED SITE PLAN

DRAWING NO. DA.01 REVISION 1:100 / A2 SCALE DATE 09.12.24

THIS PLAN IS TO BE READ IN **CONJUNCTION WITH** THE CONDITIONS OF DEVELOPMENT CONSENT DA2025/0803


INCLUDE A PERMEABLE MEMBRANE SUCH AS GEOTEXTILE FABRIC UNDER LAYER OF MULCH OR CRUSHED ROCK BELOW RUMBLE BOARDS.

SUBFLOOR FRAMING MEMBERS.

SARAH BLACKER

ARCHITECT + INTERIOR DESIGNER

ARCHITECT'S REG NO. 8403

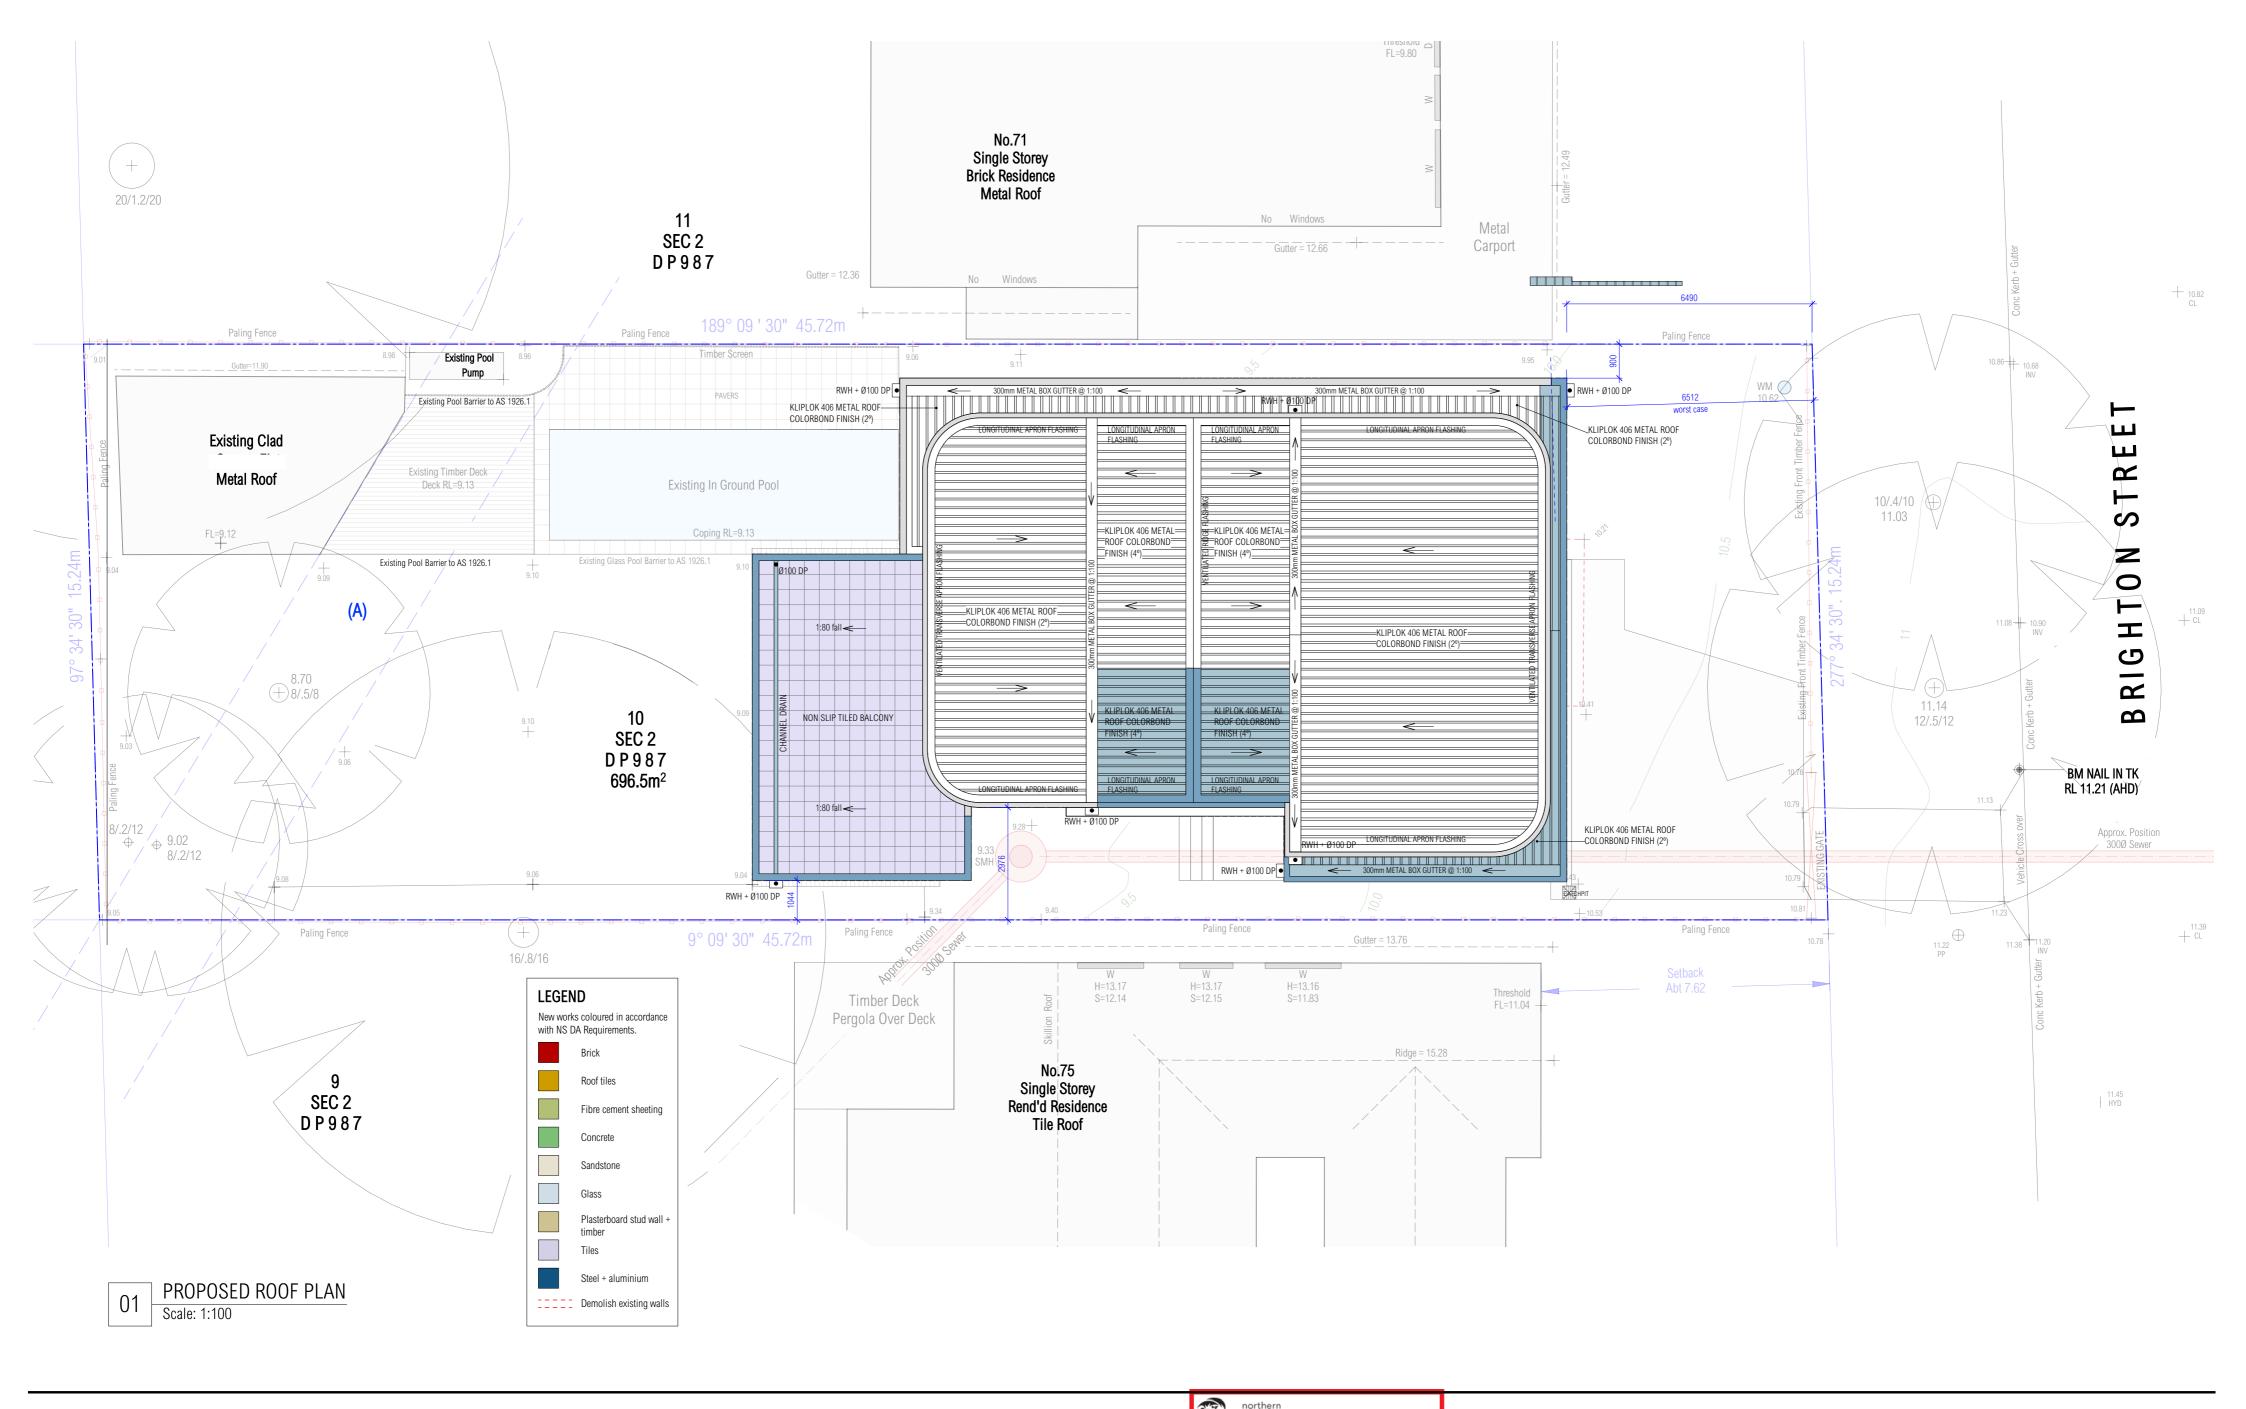

S.B.

DISCLAIMER

ALL WORKS TO BE IN ACCORDANCE WITH AUSTRALIAN STANDARDS, THE BUILDING CODE OF AUSTRALIA, OTHER RELEVANT CODES, AND WITH MANUFACTURER'S RECCOMENDATIONS AND INSTRUCTIONS. DO NOT SCALE FROM DRAWINGS. VERIFY ALL DIMENSIONS ON SITE PRIOR TO CONSTRUCTION. THIS DRAWING IS COPYRIGHT AND MAY NOT BE USED WITHOUT WRITTEN CONSENT FROM SARAH BLACKER.

PROJECT
ADDRESS
DOCUMENT
DRAWING


LIEBKE RESIDENCE
73 BRIGHTON STREET, CURL CURL

DEVELOPMENT APPLICATION

PROPOSED ROOF PLAN


DRAWING NO. DA.02
REVISION .
SCALE 1:100 / A2
DATE 09.12.24

THIS PLAN IS TO BE READ IN
CONJUNCTION WITH
THE CONDITIONS OF DEVELOPMENT
CONSENT
DA2025/0803

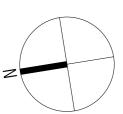

SARAH BLACKER

ARCHITECT + INTERIOR DESIGNER
ARCHITECT'S REG NO. 8403

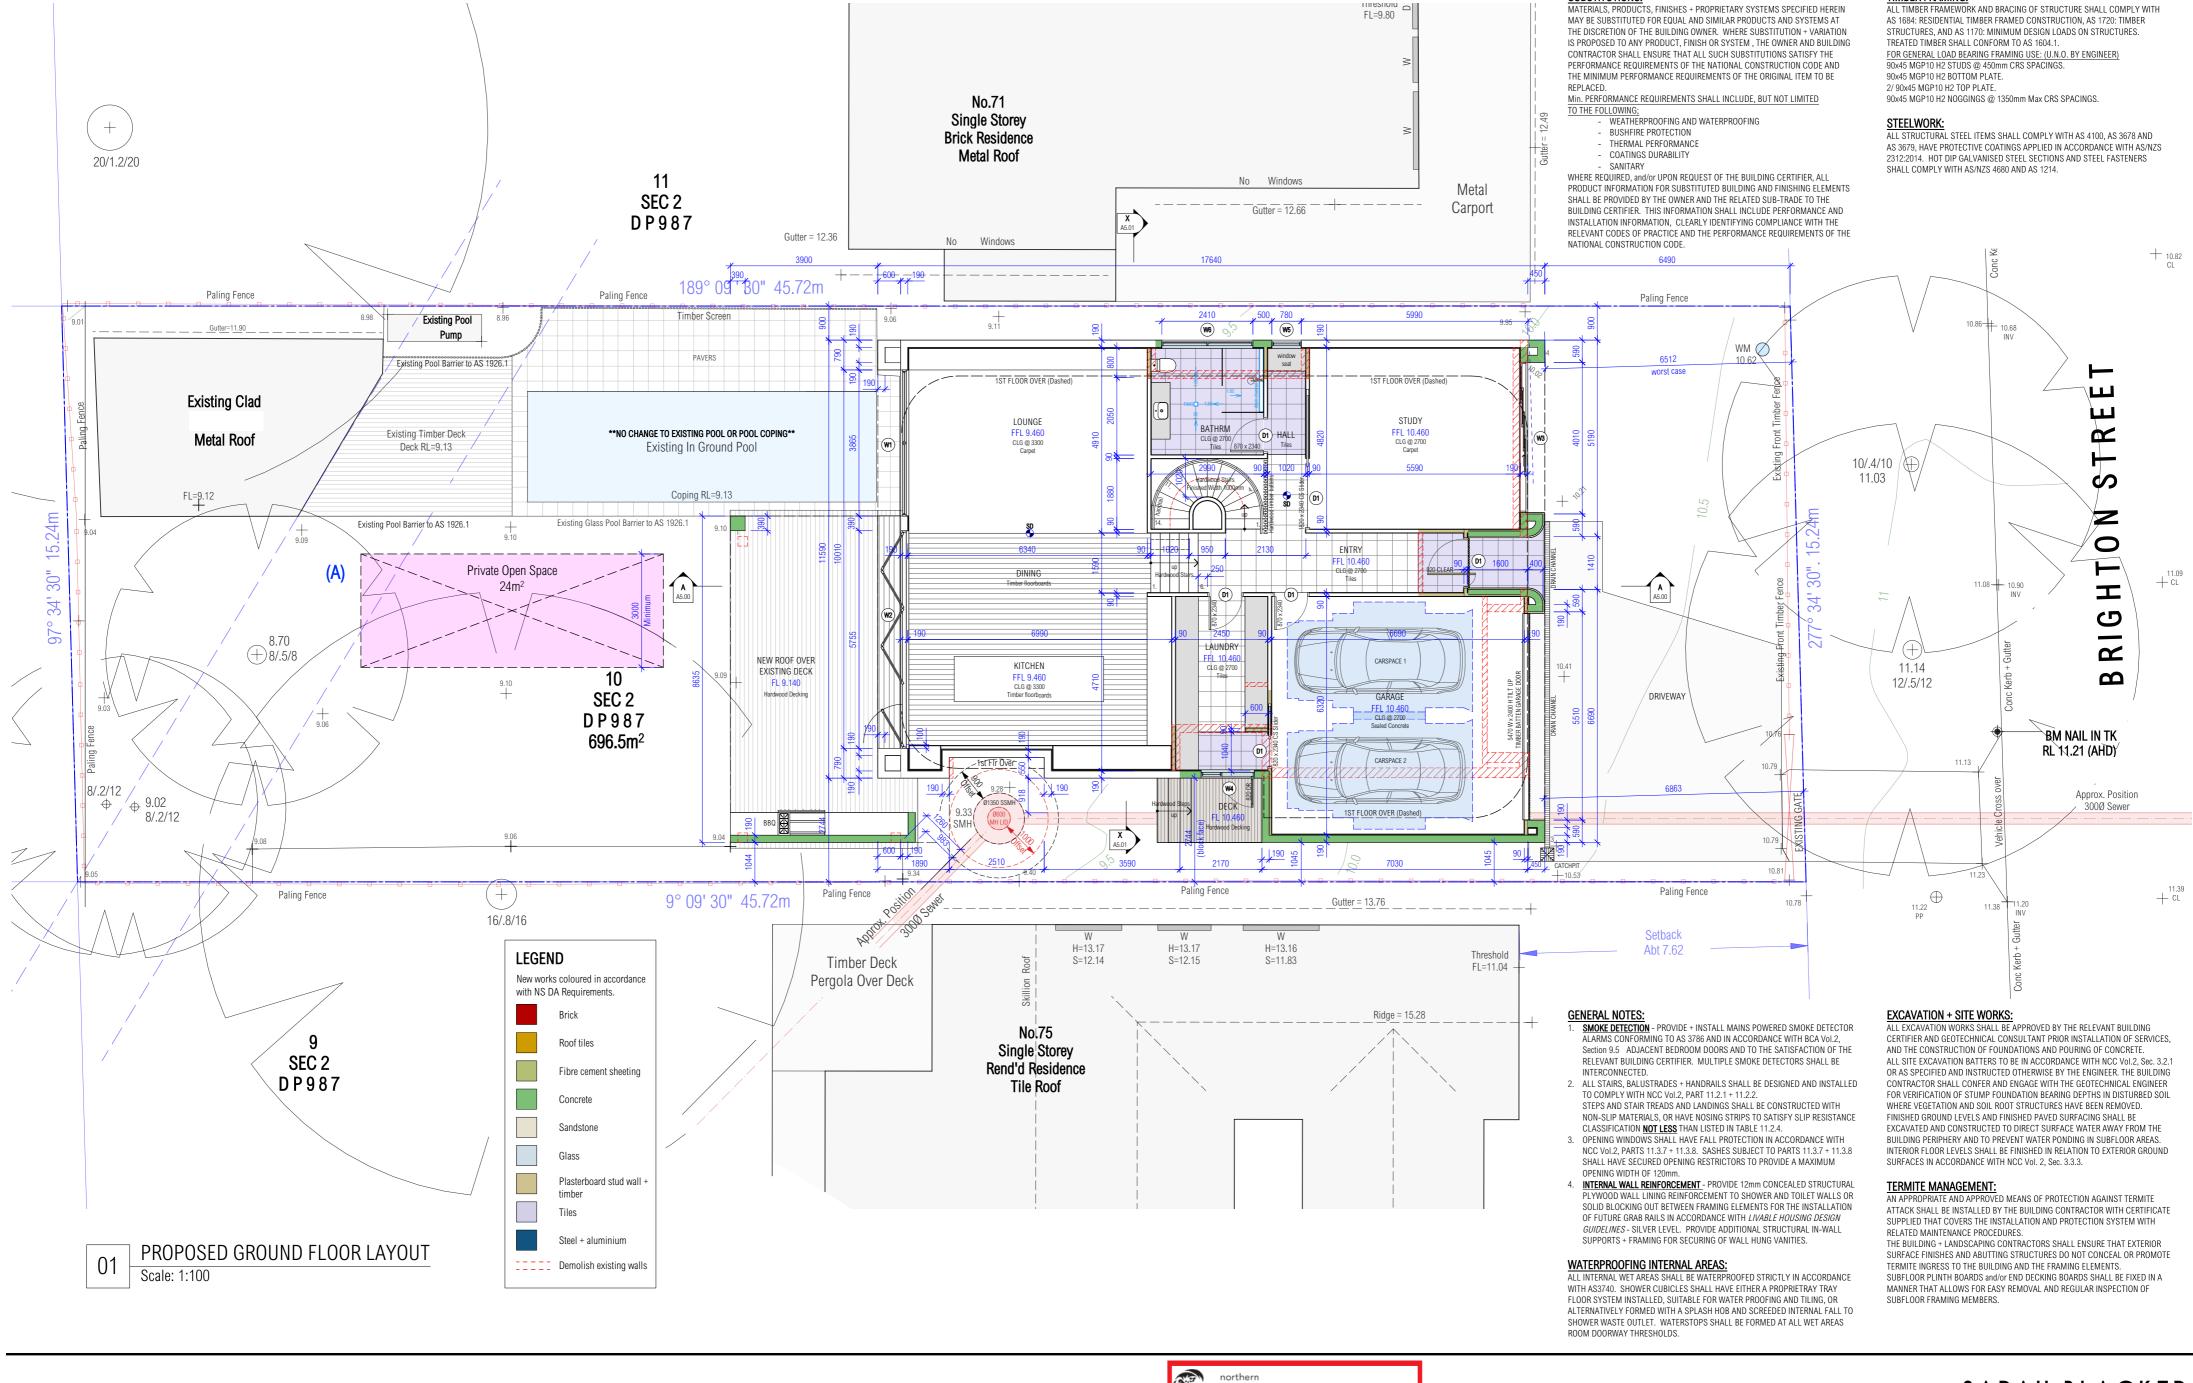

DISCLAIMER

ALL WORKS TO BE IN ACCORDANCE WITH AUSTRALIAN STANDARDS, THE BUILDING CODE OF AUSTRALIA, OTHER RELEVANT CODES, AND WITH MANUFACTURER'S RECCOMENDATIONS AND INSTRUCTIONS. DO NOT SCALE FROM DRAWINGS. VERIFY ALL DIMENSIONS ON SITE PRIOR TO CONSTRUCTION. THIS DRAWING IS COPYRIGHT AND MAY NOT BE USED WITHOUT WRITTEN CONSENT FROM SARAH BLACKER.

PROJECT ADDRESS DOCUMENT

LIEBKE RESIDENCE 73 BRIGHTON STREET, CURL CURL DEVELOPMENT APPLICATION DRAWING PROPOSED GROUND FLOOR LAYOUT DATE

DRAWING NO. DA.06 REVISION 1:100 / A2 SCALE 09.12.24






SARAH BLACKER

ARCHITECT + INTERIOR DESIGNER

ARCHITECT'S REG NO. 8403

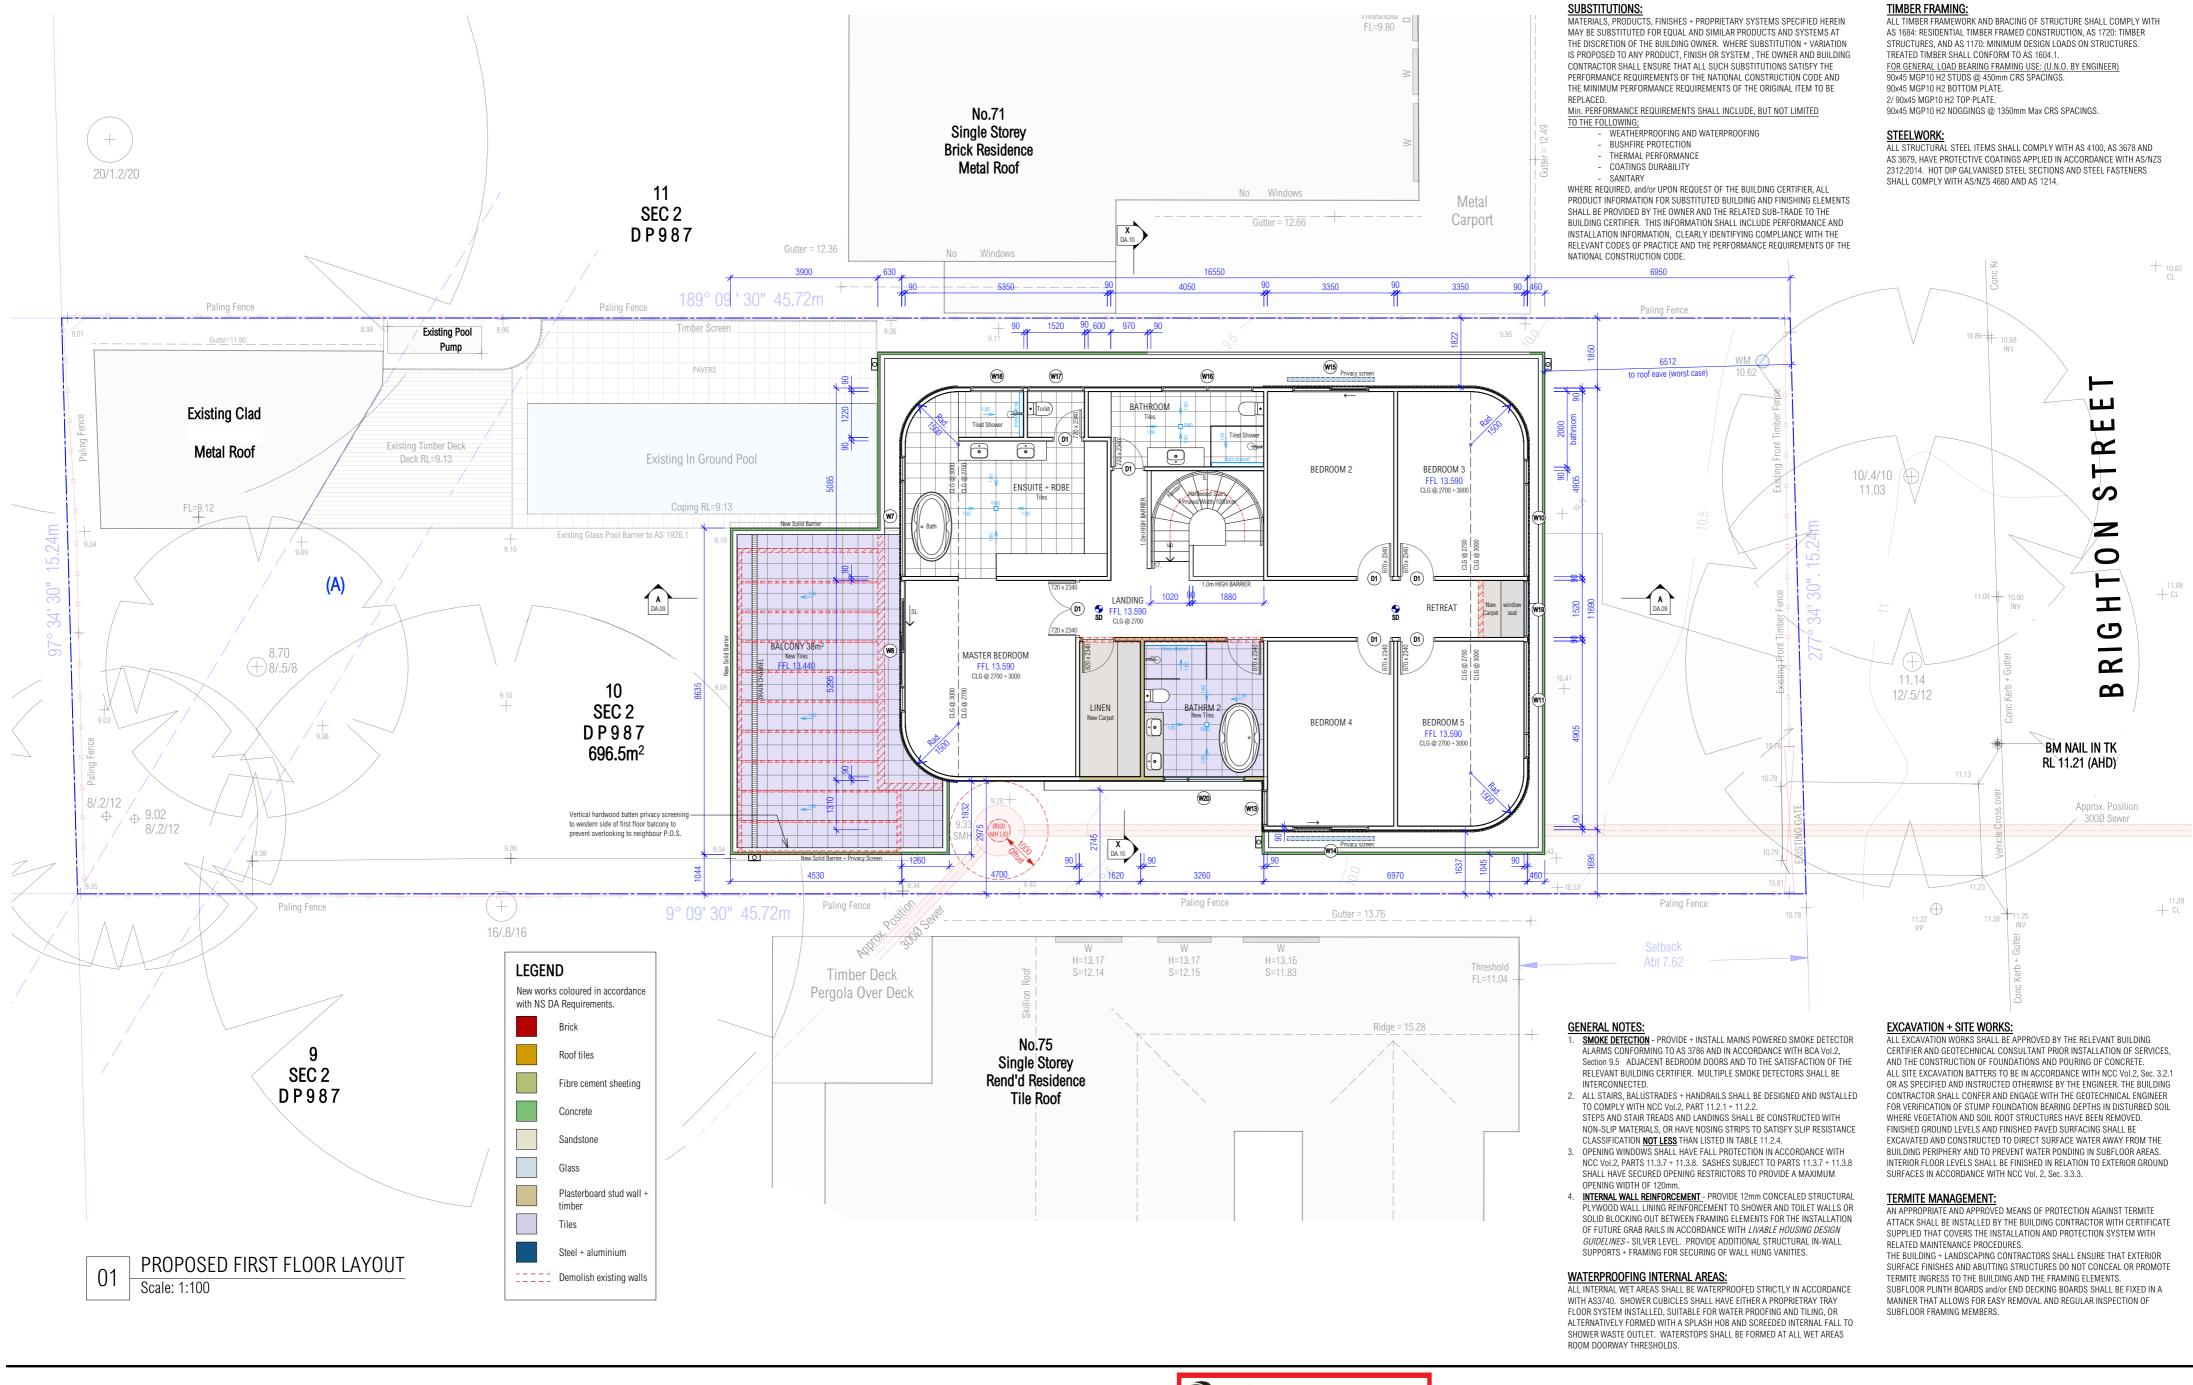

S.B.

DISCLAIMER

ALL WORKS TO BE IN ACCORDANCE WITH AUSTRALIAN STANDARDS, THE BUILDING CODE OF AUSTRALIA, OTHER RELEVANT CODES, AND WITH MANUFACTURER'S RECCOMENDATIONS AND INSTRUCTIONS. DO NOT SCALE FROM DRAWINGS. VERIFY ALL DIMENSIONS ON SITE PRIOR TO CONSTRUCTION. THIS DRAWING IS COPYRIGHT AND MAY NOT BE USED WITHOUT WRITTEN CONSENT FROM SARAH BLACKER.

PROJECT
ADDRESS
DOCUMENT
DRAWING

LIEBKE RESIDENCE
73 BRIGHTON STREET, CURL CURL
DEVELOPMENT APPLICATION
PROPOSED FIRST FLOOR LAYOUT

DRAWING NO. DA.07

REVISION .

SCALE 1:100 / A2

DATE 09.12.24





SARAH BLACKER

ARCHITECT + INTERIOR DESIGNER

ARCHITECT'S REG NO. 8403



SARAH BLACKER

ARCHITECT + INTERIOR DESIGNER

ARCHITECT'S REG NO. 8403

ALL WORKS TO BE IN ACCORDANCE WITH AUSTRALIAN STANDARDS, THE BUILDING CODE OF AUSTRALIA, OTHER RELEVANT CODES, AND WITH MANUFACTURER'S RECCOMENDATIONS AND INSTRUCTIONS. DO NOT SCALE FROM DRAWINGS. VERIFY ALL DIMENSIONS ON SITE PRIOR TO CONSTRUCTION. THIS DRAWING IS COPYRIGHT AND MAY NOT BE USED WITHOUT WRITTEN CONSENT FROM SARAH BLACKER.

PROJECT ADDRESS DOCUMENT

DRAWING

LIEBKE RESIDENCE 73 BRIGHTON STREET, CURL CURL DEVELOPMENT APPLICATION PROPOSED ELEVATIONS


DRAWING NO. DA.08 1:100 / A2 09.12.24

REVISION

SCALE

DATE

THIS PLAN IS TO BE READ IN **CONJUNCTION WITH** THE CONDITIONS OF DEVELOPMENT CONSENT DA2025/0803

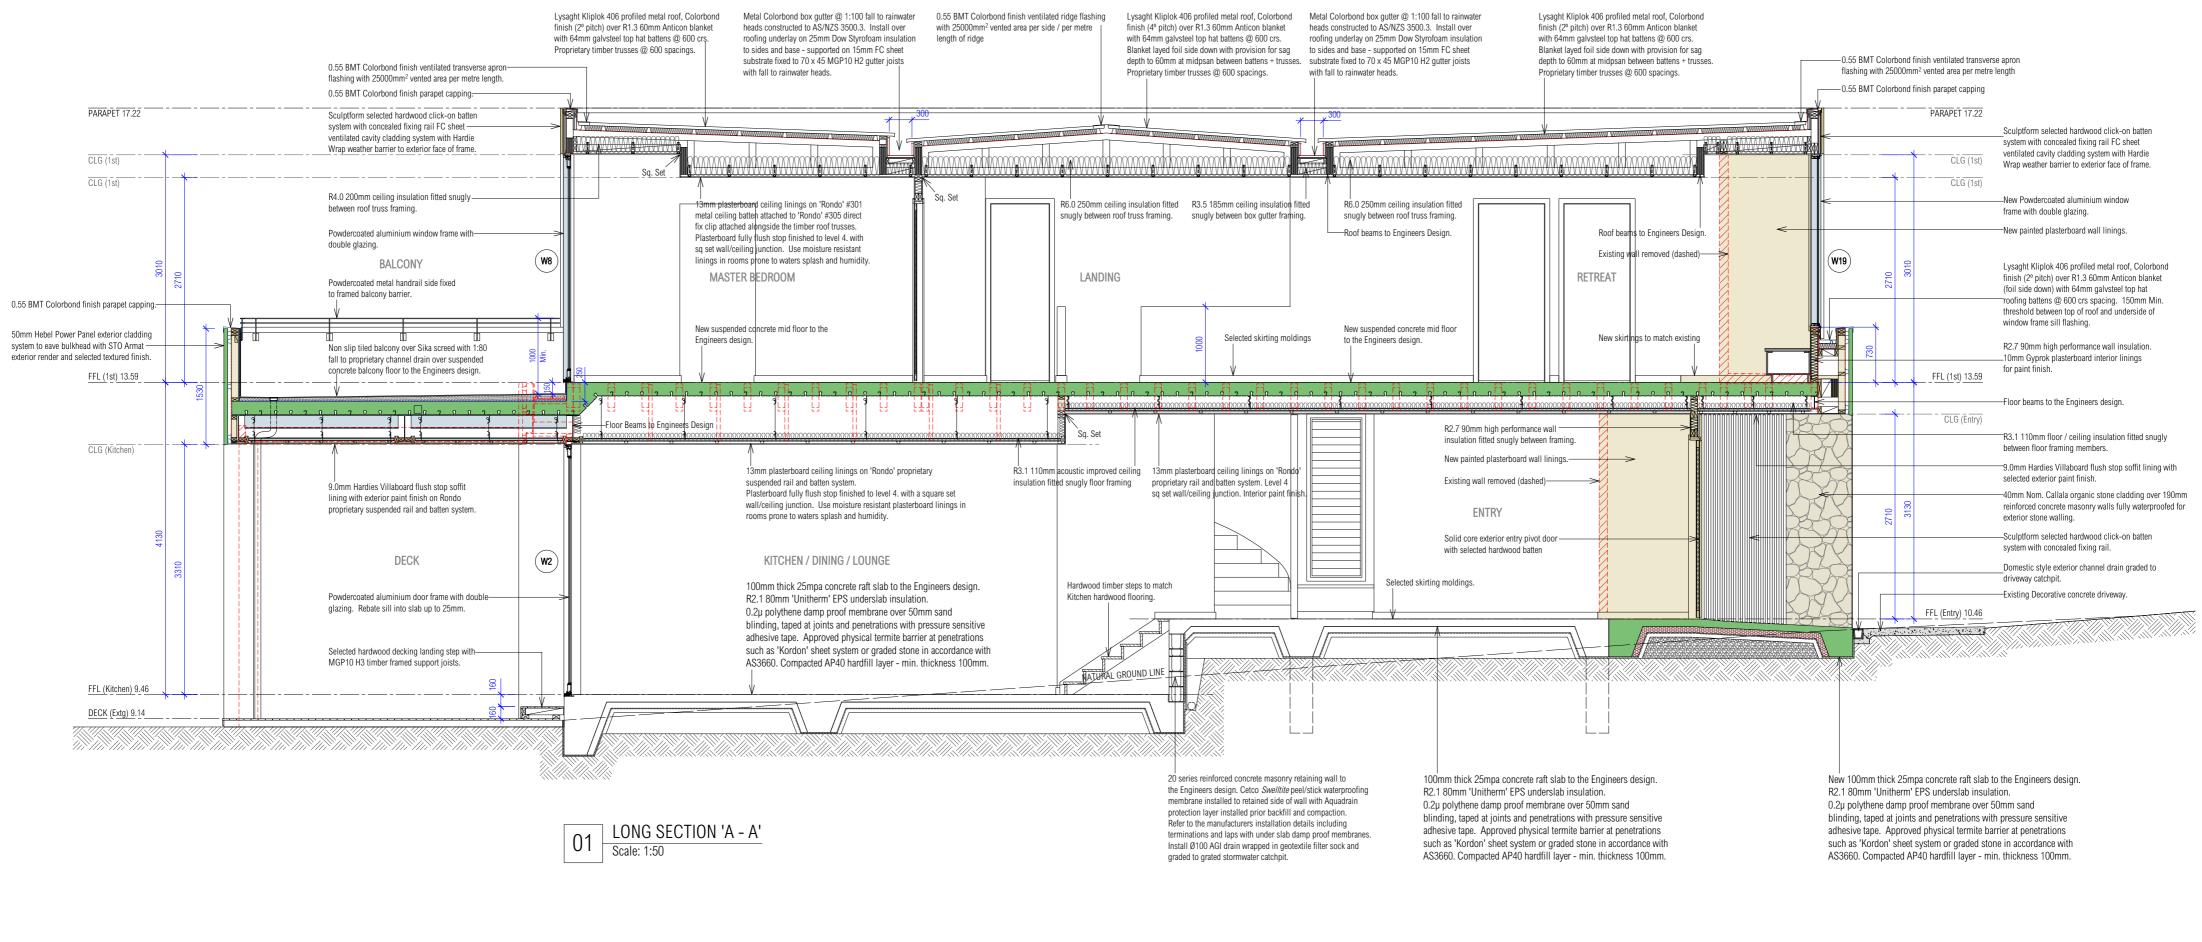

GENERAL NOTES:

SMOKE DETECTION - PROVIDE + INSTALL MAINS POWERED SMOKE DETECTOR ARMS CONFORMING TO AS 3786 AND IN ACCORDANCE WITH BCA Vol.2, Section 9.5 ADJACENT BEDROOM DOORS AND TO THE SATISFACTION OF THE RELEVANT BUILDING CERTIFIER. MULTIPLE SMOKE DETECTORS SHALL BE INTERCONNECTED.

- 2. ALL STAIRS, BALUSTRADES + HANDRAILS SHALL BE DESIGNED AND INSTALLED TO COMPLY WITH NCC Vol.2, PART 11.2.1 + 11.2.2. STEPS AND STAIR TREADS AND LANDINGS SHALL BE CONSTRUCTED WITH NON-SLIP MATERIALS, OR HAVE NOSING STRIPS TO SATISFY SLIP RESISTANCE
- CLASSIFICATION **NOT LESS** THAN LISTED IN TABLE 11.2.4.
 3. OPENING WINDOWS SHALL HAVE FALL PROTECTION IN ACCORDANCE WITH NCC Vol.2, PARTS 11.3.7 + 11.3.8. SASHES SUBJECT TO PARTS 11.3.7 + 11.3.8 SHALL HAVE SECURED OPENING RESTRICTORS TO PROVIDE A MAXIMUM
- 4. INTERNAL WALL REINFORCEMENT PROVIDE 12mm CONCEALED STRUCTURAL PLYWOOD WALL LINING REINFORCEMENT TO SHOWER AND TOILET WALLS OR SOLID BLOCKING OUT BETWEEN FRAMING ELEMENTS FOR THE INSTALLATION OF FUTURE GRAB RAILS IN ACCORDANCE WITH LIVABLE HOUSING DESIGN GUIDELINES - SILVER LEVEL. PROVIDE ADDITIONAL STRUCTURAL IN-WALL SUPPORTS + FRAMING FOR SECURING OF WALL HUNG VANITIES.

TIMBER FRAMING:

ALL TIMBER FRAMEWORK AND BRACING OF STRUCTURE SHALL COMPLY WITH AS 1684: RESIDENTIAL TIMBER FRAMED CONSTRUCTION AS 1720: TIMBER STRUCTURES. AND AS 1170: MINIMUM DESIGN LOADS ON STRUCTURES. TREATED TIMBER SHALL CONFORM TO AS 1604.1. FOR GENERAL LOAD BEARING FRAMING USE: (U.N.O. BY ENGINEER)

90x45 MGP10 H2 STUDS @ 450mm CRS SPACINGS. 90x45 MGP10 H2 BOTTOM PLATE. 2/ 90x45 MGP10 H2 T0P PLATE

90x45 MGP10 H2 NOGGINGS @ 1350mm Max CRS SPACINGS.

ALL STRUCTURAL STEEL ITEMS SHALL COMPLY WITH AS 4100, AS 3678 AND AS 3679, HAVE PROTECTIVE COATINGS APPLIED IN ACCORDANCE WITH AS/NZS 2312:2014. HOT DIP GALVANISED STEEL SECTIONS AND STEEL FASTENERS SHALL COMPLY WITH AS/NZS 4680 AND AS 1214.

EXCAVATION + SITE WORKS:

ALL EXCAVATION WORKS SHALL BE APPROVED BY THE RELEVANT BUILDING CERTIFIER AND GEOTECHNICAL CONSULTANT PRIOR INSTALLATION OF SERVICES, AND THE CONSTRUCTION OF FOUNDATIONS AND POURING OF CONCRETE. ALL SITE EXCAVATION BATTERS TO BE IN ACCORDANCE WITH NCC Vol 2. Sec. 3.2.1. OR AS SPECIFIED AND INSTRUCTED OTHERWISE BY THE ENGINEER. THE BUILDING CONTRACTOR SHALL CONFER AND ENGAGE WITH THE GEOTECHNICAL ENGINEER FOR VERIFICATION OF STUMP FOUNDATION BEARING DEPTHS IN DISTURBED SOIL WHERE VEGETATION AND SOIL ROOT STRUCTURES HAVE BEEN REMOVED. FINISHED GROUND LEVELS AND FINISHED PAVED SURFACING SHALL BE EXCAVATED AND CONSTRUCTED TO DIRECT SURFACE WATER AWAY FROM THE INTERIOR FLOOR LEVELS SHALL BE FINISHED IN RELATION TO EXTERIOR GROUND SURFACES IN ACCORDANCE WITH NCC Vol. 2, Sec. 3.3.3.

TERMITE MANAGEMENT:

AN APPROPRIATE AND APPROVED MEANS OF PROTECTION AGAINST TERMITE ATTACK SHALL BE INSTALLED BY THE BUILDING CONTRACTOR WITH CERTIFICATE SUPPLIED THAT COVERS THE INSTALLATION AND PROTECTION SYSTEM WITH RELATED MAINTENANCE PROCEDURES.

THE BUILDING + LANDSCAPING CONTRACTORS SHALL ENSURE THAT EXTERIOR SURFACE FINISHES AND ABUTTING STRUCTURES DO NOT CONCEAL OR PROMOTE TERMITE INGRESS TO THE BUILDING AND THE FRAMING ELEMENTS SUBFLOOR PLINTH BOARDS and/or END DECKING BOARDS SHALL BE FIXED IN A MANNER THAT ALLOWS FOR EASY REMOVAL AND REGULAR INSPECTION OF SUBFLOOR FRAMING MEMBERS

PLUMBING + DRAINAGE:

PLUMBING AND DRAINAGE CONTRACTORS SHALL THOROUGLY INVESTIGATE ALL SANITARY AND STORMWATER LOCATIONS, PROPOSED CONNECTIONS AND SIZES PRIOR TO WORK COMMENCEMENT, AND VERIFY THAT FALLS CAN BE ACHIEVED TO SANITARY AND STORMWATER DISCHARGE.

ALL UNDER SLAB DRAINAGE SHALL BE CARRIED OUT BY A LICENSED DRAINLAYER, TO THE RELEVANT CODES OF PRACTICE. AN 'AS BUILT' DRAINAGE PLAN SHALL BE ISSUED TO THE PROPERTY OWNER AND BUILDING CERTIFIER ON COMPLETION OF WORK. ALL WORK CARRIED OUT IN STRICT ACCORDANCE WITH AS/NZS 3500.2 AND AS/NZS 3500.3. STORMWATER

CONNECT DOWNPIPES TO EXISTING IN GROUND DRAINAGE, DIRECT TO MAIN DRAIN AND LEGAL POINT OF DISCHARGE

CONNECT SOIL PIPES, PLUMBING FIXTURES, FLOOR WASTES AND GULLIES INTO IN-GROUND DRAINAGE SYSTEM AND EXISTING PUBLIC CONNECTION.

INSULATION + BUILDING SEALING:

READ IN CONJUNCTION WITH THE BASIX REPORT AND SUMMARY. PROVIDE + INSTALL R1 3 60mm ANTICON BLANKET TO NEW METAL ROOFS PROVIDE + INSTALL R6.0 250mm INSULATION BATTS ABOVE CEILING AREAS UNDER ROOFS AND A MINIMUM OF R3.5 185mm INSULATION BATTS TO RESTRICTED ROOF AREAS UNDER BOX GUTTERS AND THE LIKE.

PROVIDE + INSTALL R2 7 90mm INSULATION BATTS TO ALL EXTERIOR FRAMED WALLS AND BULKHEAD PLENUM AREAS OPEN TO ROOF AND BALCONY COVERINGS. PROVIDE AND INSTALL R3.0 110mm CEILING INSULATION AND ACOUSTIC DAMPENING BATTS IN CEILING AREAS BELOW FIRST FLOOR. PROVIDE +INSTALL R2.1 80mm INSULATION TO NEW CONCRETE FLOOR SLABS. SEAL GAPS CRACKS DOWNLIGHTS AND EXHAUST FANS. WEATHER-STRIP. WINDOWS AND ENTRY DOORS, GARAGE DOOR SEAL IS NOT REQUIRED. WINDOW FRAMES TO BE ALUMINIUM DOUBLE GLAZED TYPE OR APPROVED EQUIVALENT.

MATERIALS, PRODUCTS, FINISHES + PROPRIETARY SYSTEMS SPECIFIED HEREIN MAY BE SUBSTITUTED FOR EQUAL AND SIMILAR PRODUCTS AND SYSTEMS AT THE DISCRETION OF THE BUILDING OWNER. WHERE SUBSTITUTION + VARIATION IS PROPOSED TO ANY PRODUCT, FINISH OR SYSTEM, THE OWNER AND BUILDING CONTRACTOR SHALL ENSURE THAT ALL SUCH SUBSTITUTIONS SATISFY THE PERFORMANCE REQUIREMENTS OF THE NATIONAL CONSTRUCTION CODE AND THE MINIMUM PERFORMANCE REQUIREMENTS OF THE ORIGINAL ITEM TO BE

Min. PERFORMANCE REQUIREMENTS SHALL INCLUDE, BUT NOT LIMITED


- WEATHERPROOFING AND WATERPROOFING
- BUSHFIRE PROTECTION THERMAL PERFORMANCE
- COATINGS DURABILITY

SANITARY

WHERE REQUIRED, and/or UPON REQUEST OF THE BUILDING CERTIFIER, ALL SHALL BE PROVIDED BY THE OWNER AND THE RELATED SUB-TRADE TO THE BUILDING CERTIFIER. THIS INFORMATION SHALL INCLUDE PERFORMANCE AND INSTALLATION INFORMATION. CLEARLY IDENTIFYING COMPLIANCE WITH THE RELEVANT CODES OF PRACTICE AND THE PERFORMANCE REQUIREMENTS OF THE NATIONAL CONSTRUCTION CODE.

WATERPROOFING INTERNAL AREAS:

ALL INTERNAL WET AREAS SHALL BE WATERPROOFED STRICTLY IN ACCORDANCE WITH AS3740. SHOWER CUBICLES SHALL HAVE EITHER A PROPRIETRAY TRAY FLOOR SYSTEM INSTALLED, SUITABLE FOR WATER PROOFING AND TILING, OR ALTERNATIVELY FORMED WITH A SPLASH HOB AND SCREEDED INTERNAL FALL TO SHOWER WASTE OUTLET. WATERSTOPS SHALL BE FORMED AT ALL WET AREAS ROOM DOORWAY THRESHOLDS.

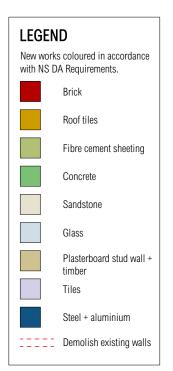

ALL WORKS TO BE IN ACCORDANCE WITH AUSTRALIAN STANDARDS, THE BUILDING CODE OF AUSTRALIA, OTHER RELEVANT CODES, AND WITH MANUFACTURER'S RECCOMENDATIONS AND INSTRUCTIONS. DO NOT SCALE FROM DRAWINGS. VERIFY ALL DIMENSIONS ON SITE PRIOR TO CONSTRUCTION. THIS DRAWING IS COPYRIGHT AND MAY NOT BE USED WITHOUT WRITTEN CONSENT FROM SARAH BI ACKER

PROJECT ADDRESS DOCUMENT DRAWING

LIEBKE RESIDENCE 73 BRIGHTON STREET, CURL CURL DEVELOPMENT APPLICATION PROPOSED SECTION 'A - A'

DRAWING NO. DA.09 REVISION 1:50 / A2 SCALE DATE 09.12.24




DA2025/0803

SARAH BLACKER

ARCHITECT + INTERIOR DESIGNER

ARCHITECT'S REG NO. 8403

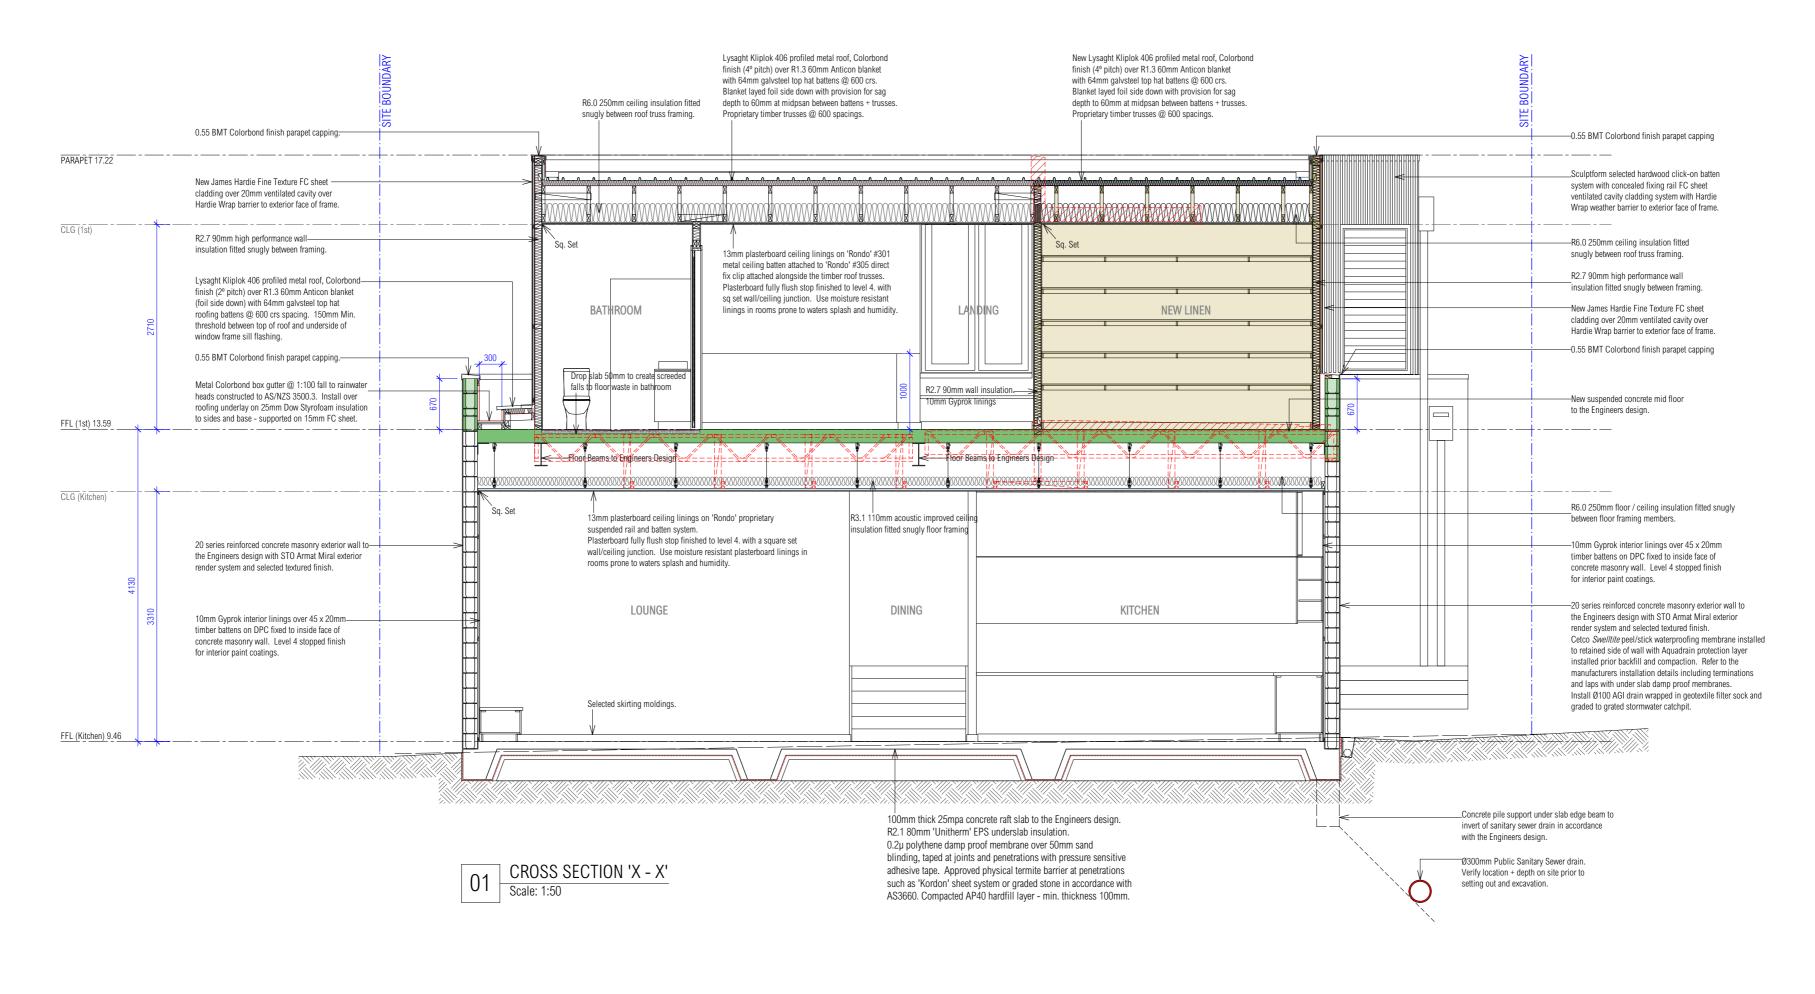

GENERAL NOTES:

SMOKE DETECTION - PROVIDE + INSTALL MAINS POWERED SMOKE DETECTOR LARMS CONFORMING TO AS 3786 AND IN ACCORDANCE WITH BCA Vol.2, Section 9.5 ADJACENT BEDROOM DOORS AND TO THE SATISFACTION OF THE RELEVANT BUILDING CERTIFIER. MULTIPLE SMOKE DETECTORS SHALL BE INTERCONNECTED.

- 2. ALL STAIRS, BALUSTRADES + HANDRAILS SHALL BE DESIGNED AND INSTALLED TO COMPLY WITH NCC Vol.2, PART 11.2.1 + 11.2.2. STEPS AND STAIR TREADS AND LANDINGS SHALL BE CONSTRUCTED WITH NON-SLIP MATERIALS, OR HAVE NOSING STRIPS TO SATISFY SLIP RESISTANCE
- CLASSIFICATION **NOT LESS** THAN LISTED IN TABLE 11.2.4.
 3. OPENING WINDOWS SHALL HAVE FALL PROTECTION IN ACCORDANCE WITH NCC Vol.2, PARTS 11.3.7 + 11.3.8. SASHES SUBJECT TO PARTS 11.3.7 + 11.3.8 SHALL HAVE SECURED OPENING RESTRICTORS TO PROVIDE A MAXIMUM
- 4. <u>INTERNAL WALL REINFORCEMENT</u> PROVIDE 12mm CONCEALED STRUCTURAL PLYWOOD WALL LINING REINFORCEMENT TO SHOWER AND TOILET WALLS OR SOLID BLOCKING OUT BETWEEN FRAMING ELEMENTS FOR THE INSTALLATION OF FUTURE GRAB RAILS IN ACCORDANCE WITH LIVABLE HOUSING DESIGN GUIDELINES - SILVER LEVEL. PROVIDE ADDITIONAL STRUCTURAL IN-WALL SUPPORTS + FRAMING FOR SECURING OF WALL HUNG VANITIES.

TIMBER FRAMING:

ALL TIMBER FRAMEWORK AND BRACING OF STRUCTURE SHALL COMPLY WITH AS 1684: RESIDENTIAL TIMBER FRAMED CONSTRUCTION AS 1720: TIMBER STRUCTURES. AND AS 1170: MINIMUM DESIGN LOADS ON STRUCTURES. TREATED TIMBER SHALL CONFORM TO AS 1604.1. FOR GENERAL LOAD BEARING FRAMING USE: (U.N.O. BY ENGINEER)

90x45 MGP10 H2 STUDS @ 450mm CRS SPACINGS. 90x45 MGP10 H2 BOTTOM PLATE. 2/ 90x45 MGP10 H2 T0P PLATE

90x45 MGP10 H2 NOGGINGS @ 1350mm Max CRS SPACINGS.

ALL STRUCTURAL STEEL ITEMS SHALL COMPLY WITH AS 4100, AS 3678 AND AS 3679, HAVE PROTECTIVE COATINGS APPLIED IN ACCORDANCE WITH AS/NZS 2312:2014. HOT DIP GALVANISED STEEL SECTIONS AND STEEL FASTENERS SHALL COMPLY WITH AS/NZS 4680 AND AS 1214.

EXCAVATION + SITE WORKS:

ALL EXCAVATION WORKS SHALL BE APPROVED BY THE RELEVANT BUILDING CERTIFIER AND GEOTECHNICAL CONSULTANT PRIOR INSTALLATION OF SERVICES, AND THE CONSTRUCTION OF FOUNDATIONS AND POURING OF CONCRETE. ALL SITE EXCAVATION BATTERS TO BE IN ACCORDANCE WITH NCC Vol.2, Sec. 3.2.1 OR AS SPECIFIED AND INSTRUCTED OTHERWISE BY THE ENGINEER. THE BUILDING CONTRACTOR SHALL CONFER AND ENGAGE WITH THE GEOTECHNICAL ENGINEER FOR VERIFICATION OF STUMP FOUNDATION BEARING DEPTHS IN DISTURBED SOIL WHERE VEGETATION AND SOIL ROOT STRUCTURES HAVE BEEN REMOVED. FINISHED GROUND LEVELS AND FINISHED PAVED SURFACING SHALL BE EXCAVATED AND CONSTRUCTED TO DIRECT SURFACE WATER AWAY FROM THE INTERIOR FLOOR LEVELS SHALL BE FINISHED IN RELATION TO EXTERIOR GROUND SURFACES IN ACCORDANCE WITH NCC Vol. 2, Sec. 3.3.3.

TERMITE MANAGEMENT:

AN APPROPRIATE AND APPROVED MEANS OF PROTECTION AGAINST TERMITE ATTACK SHALL BE INSTALLED BY THE BLULDING CONTRACTOR WITH CERTIFICATE SUPPLIED THAT COVERS THE INSTALLATION AND PROTECTION SYSTEM WITH RELATED MAINTENANCE PROCEDURES.

THE BUILDING + LANDSCAPING CONTRACTORS SHALL ENSURE THAT EXTERIOR SURFACE FINISHES AND ABUTTING STRUCTURES DO NOT CONCEAL OR PROMOTE TERMITE INGRESS TO THE BUILDING AND THE FRAMING ELEMENTS. SUBELOOR PLINTH BOARDS and/or END DECKING BOARDS SHALL BE FIXED IN A MANNER THAT ALLOWS FOR EASY REMOVAL AND REGULAR INSPECTION OF SUBFLOOR FRAMING MEMBERS.

PLUMBING + DRAINAGE:

PLUMBING AND DRAINAGE CONTRACTORS SHALL THOROUGLY INVESTIGATE ALL SANITARY AND STORMWATER LOCATIONS, PROPOSED CONNECTIONS AND SIZES PRIOR TO WORK COMMENCEMENT, AND VERIFY THAT FALLS CAN BE ACHIEVED TO SANITARY AND STORMWATER DISCHARGE.

ALL UNDER SLAB DRAINAGE SHALL BE CARRIED OUT BY A LICENSED DRAINLAYER, TO THE RELEVANT CODES OF PRACTICE. AN 'AS BUILT' DRAINAGE PLAN SHALL BE ISSUED TO THE PROPERTY OWNER AND BUILDING CERTIFIER ON COMPLETION OF WORK. ALL WORK CARRIED OUT IN STRICT ACCORDANCE WITH AS/NZS 3500.2 AND AS/NZS 3500.3.
STORMWATER

CONNECT DOWNPIPES TO EXISTING IN GROUND DRAINAGE, DIRECT TO MAIN DRAIN AND LEGAL POINT OF DISCHARGE.

CONNECT SOIL PIPES. PLUMBING FIXTURES. FLOOR WASTES AND GULLIES INTO IN-GROUND DRAINAGE SYSTEM AND EXISTING PUBLIC CONNECTION.

INSULATION + BUILDING SEALING:

READ IN CONJUNCTION WITH THE BASIX REPORT AND SUMMARY. PROVIDE + INSTALL R1.3 60mm ANTICON BLANKET TO NEW METAL ROOFS. PROVIDE + INSTALL R6.0 250mm INSULATION BATTS ABOVE CEILING AREAS UNDER ROOFS AND A MINIMUM OF R3.5 185mm INSULATION BATTS TO RESTRICTED ROOF AREAS UNDER BOX GUTTERS AND THE LIKE.

PROVIDE + INSTALL R2 7 90mm INSULATION BATTS TO ALL EXTERIOR FRAMED WALLS AND BULKHEAD PLENUM AREAS OPEN TO ROOF AND BALCONY COVERINGS. PROVIDE AND INSTALL R3.0 110mm CEILING INSULATION AND ACOUSTIC DAMPENING BATTS IN CEILING AREAS BELOW FIRST FLOOR. PROVIDE +INSTALL R2.1 80mm INSULATION TO NEW CONCRETE FLOOR SLABS. SEAL GAPS CRACKS DOWNLIGHTS AND EXHAUST FANS. WEATHER-STRIP. WINDOWS AND ENTRY DOORS, GARAGE DOOR SEAL IS NOT REQUIRED. WINDOW FRAMES TO BE ALUMINIUM DOUBLE GLAZED TYPE OR APPROVED EQUIVALENT.

MATERIALS, PRODUCTS, FINISHES + PROPRIETARY SYSTEMS SPECIFIED HEREIN MAY BE SUBSTITUTED FOR EQUAL AND SIMILAR PRODUCTS AND SYSTEMS AT THE DISCRETION OF THE BUILDING OWNER. WHERE SUBSTITUTION + VARIATION IS PROPOSED TO ANY PRODUCT, FINISH OR SYSTEM , THE OWNER AND BUILDING CONTRACTOR SHALL ENSURE THAT ALL SUCH SUBSTITUTIONS SATISFY THE PERFORMANCE REQUIREMENTS OF THE NATIONAL CONSTRUCTION CODE AND THE MINIMUM PERFORMANCE REQUIREMENTS OF THE ORIGINAL ITEM TO BE


Min. PERFORMANCE REQUIREMENTS SHALL INCLUDE, BUT NOT LIMITED

- WEATHERPROOFING AND WATERPROOFING
- BUSHFIRE PROTECTION
- THERMAL PERFORMANCE COATINGS DURABILITY
- SANITARY

WHERE REQUIRED, and/or UPON REQUEST OF THE BUILDING CERTIFIER, ALL SHALL BE PROVIDED BY THE OWNER AND THE RELATED SUB-TRADE TO THE BUILDING CERTIFIER. THIS INFORMATION SHALL INCLUDE PERFORMANCE AND INSTALLATION INFORMATION CLEARLY IDENTIFYING COMPLIANCE WITH THE RELEVANT CODES OF PRACTICE AND THE PERFORMANCE REQUIREMENTS OF THE NATIONAL CONSTRUCTION CODE

WATERPROOFING INTERNAL AREAS:

ALL INTERNAL WET AREAS SHALL BE WATERPROOFED STRICTLY IN ACCORDANCE WITH AS3740. SHOWER CUBICLES SHALL HAVE EITHER A PROPRIETRAY TRAY FLOOR SYSTEM INSTALLED, SUITABLE FOR WATER PROOFING AND TILING, OR ALTERNATIVELY FORMED WITH A SPLASH HOB AND SCREEDED INTERNAL FALL TO SHOWER WASTE OUTLET. WATERSTOPS SHALL BE FORMED AT ALL WET AREAS ROOM DOORWAY THRESHOLDS.

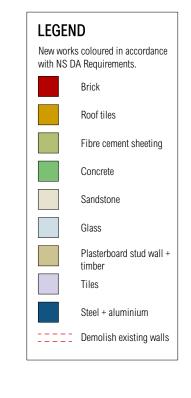

ALL WORKS TO BE IN ACCORDANCE WITH AUSTRALIAN STANDARDS, THE BUILDING CODE OF AUSTRALIA, OTHER RELEVANT CODES, AND WITH MANUFACTURER'S RECCOMENDATIONS AND INSTRUCTIONS. DO NOT SCALE FROM DRAWINGS. VERIFY ALL DIMENSIONS ON SITE PRIOR TO CONSTRUCTION. THIS DRAWING IS COPYRIGHT AND MAY NOT BE USED WITHOUT WRITTEN CONSENT FROM SARAH BLACKER.

PROJECT ADDRESS DOCUMENT DRAWING

LIEBKE RESIDENCE 73 BRIGHTON STREET, CURL CURL DEVELOPMENT APPLICATION PROPOSED SECTION 'X - X'


DRAWING NO. DA.10 REVISION 1:50 / A2 SCALE DATE 09.12.24



SARAH BLACKER

ARCHITECT + INTERIOR DESIGNER

ARCHITECT'S REG NO. 8403

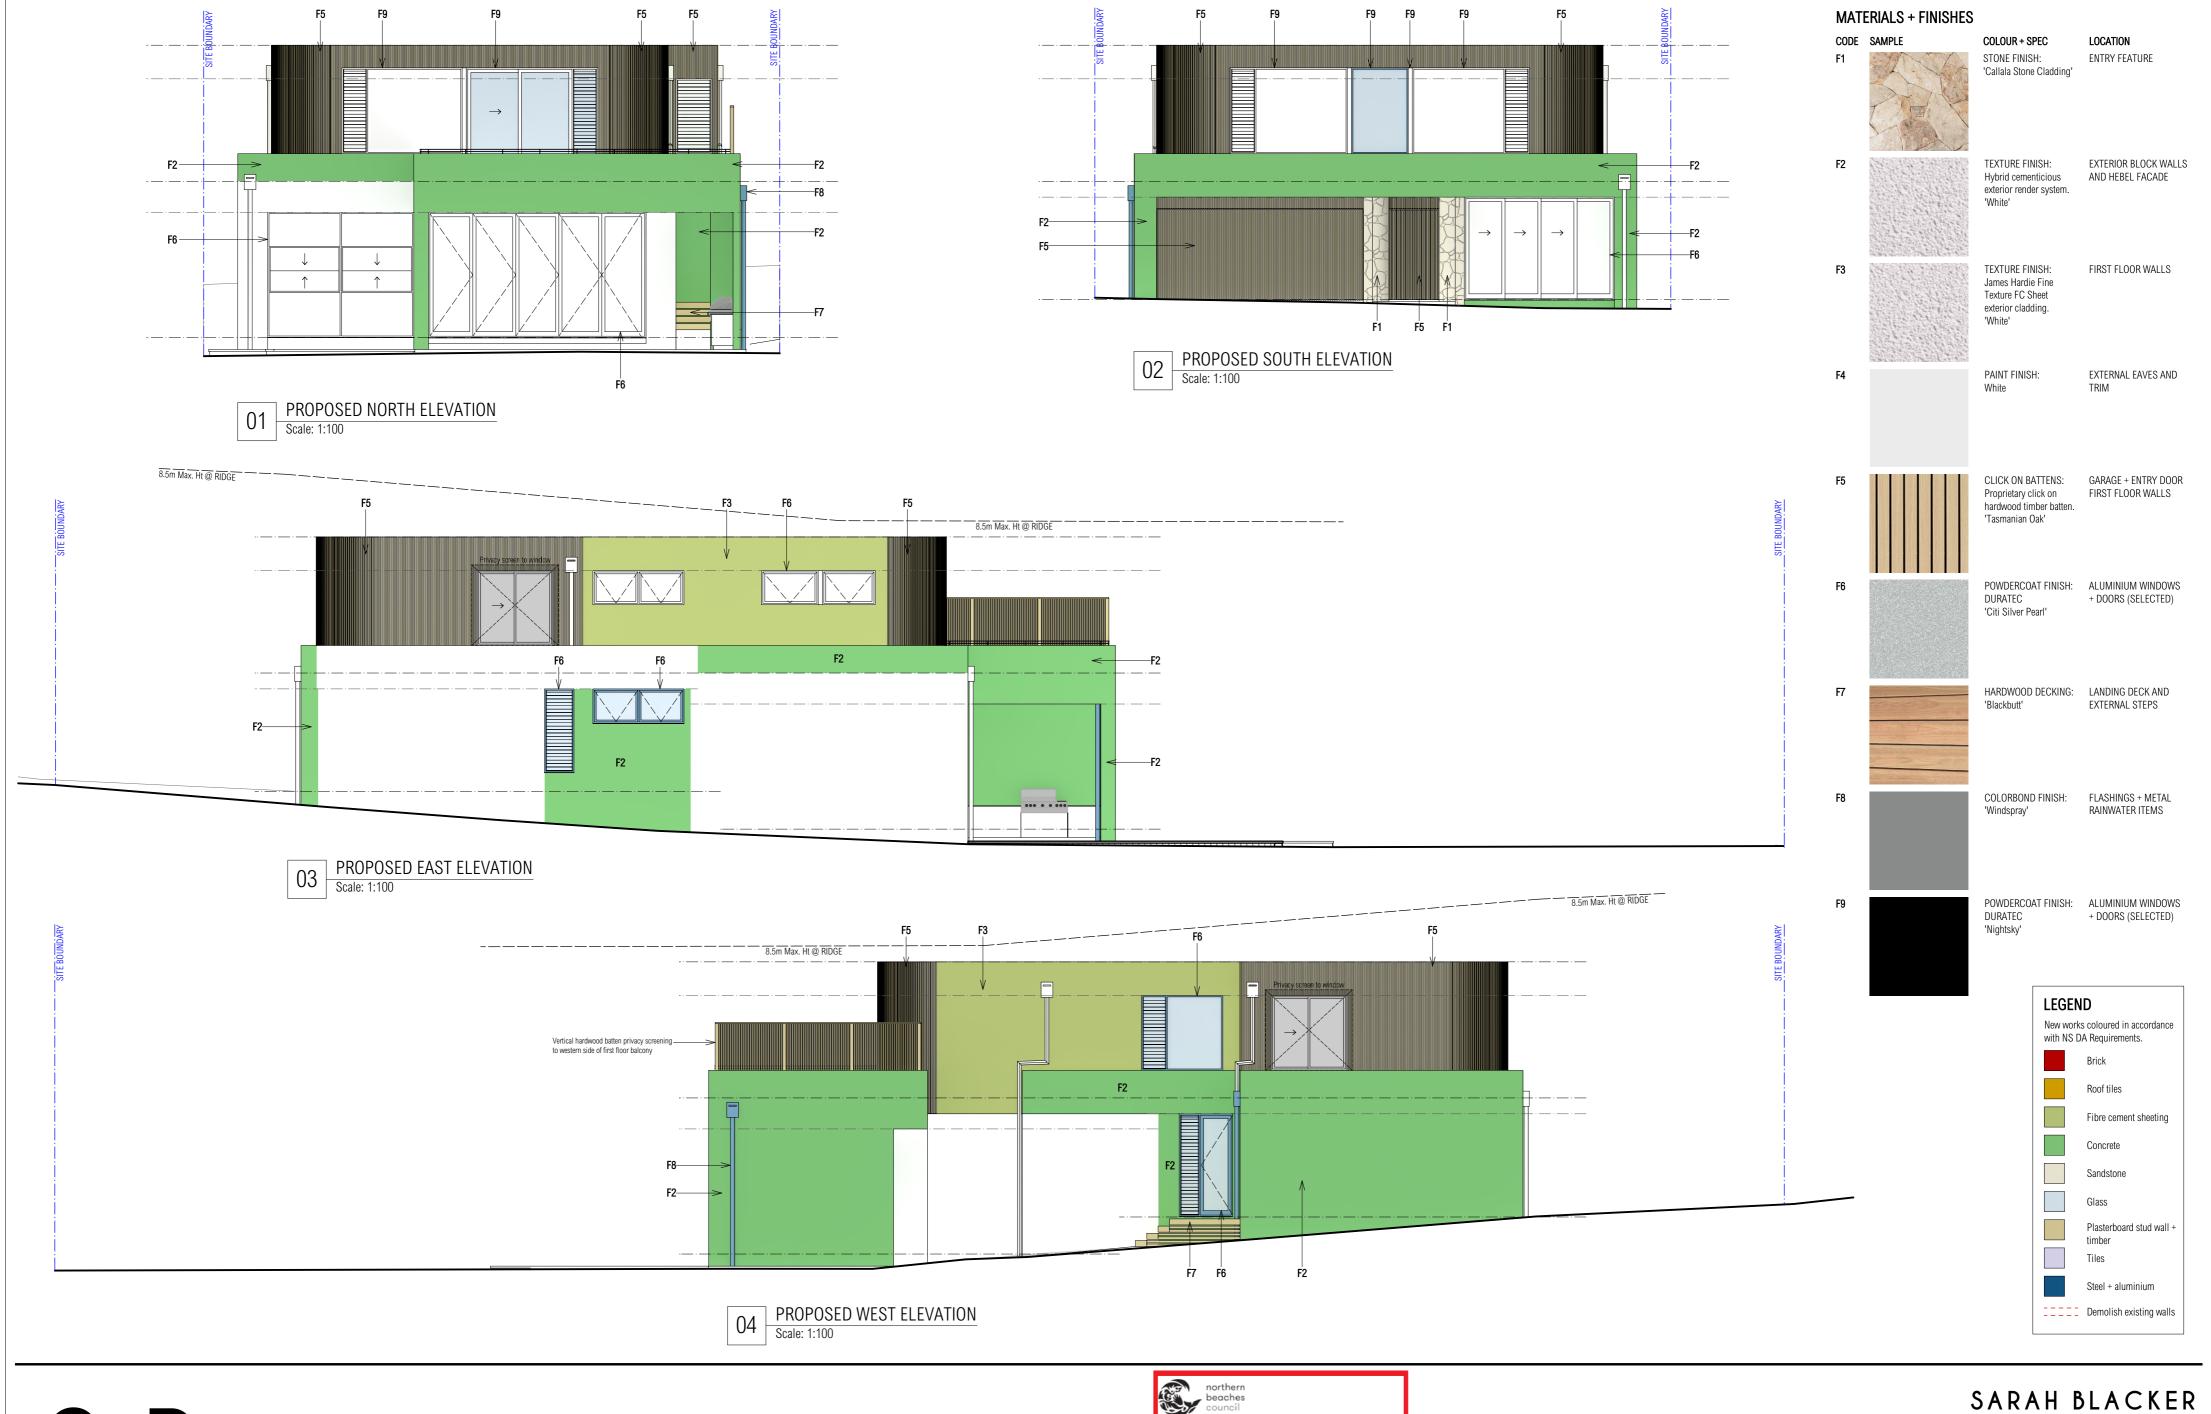

S.B.

DISCLAIMER

ALL WORKS TO BE IN ACCORDANCE WITH AUSTRALIAN STANDARDS, THE BUILDING CODE OF AUSTRALIA, OTHER RELEVANT CODES, AND WITH MANUFACTURER'S RECCOMENDATIONS AND INSTRUCTIONS. DO NOT SCALE FROM DRAWINGS. VERIFY ALL DIMENSIONS ON SITE PRIOR TO CONSTRUCTION. THIS DRAWING IS COPYRIGHT AND MAY NOT BE USED WITHOUT WRITTEN CONSENT FROM SARAH BLACKER.

PROJECT
ADDRESS
DOCUMENT
DRAWING

T LIEBKE RESIDENCE
73 BRIGHTON STREET, CURL CURL
ENT DEVELOPMENT APPLICATION
SAMPLE BOARD

DRAWING NO. DA.11
REVISION .
SCALE 1:100 / A2
DATE 09.12.24

THIS PLAN IS TO BE READ IN
CONJUNCTION WITH
THE CONDITIONS OF DEVELOPMENT
CONSENT
DA2025/0803

ARCHITECT + INTERIOR DESIGNER

ARCHITECT'S REG NO. 8403