STORMWATER MANAGEMENT

GENERAL: UNLESS NOTED OTHERWISE

G1 - DRAWINGS SHALL BE READ IN CONJUNCTION WITHV ALL OTHER WORKING DRAWINGS, SPECIFICATIONS AND ANY OTHER WRITTEN INSTRUCTIONS ISSUED DURING CONSTRUCTION, ALL DISCREPENCIES AND VARIATIONS SHALL BE REFERRED TO THE ENGINEER BEFORE PROCEEDING WITH THE WORK.

G2 - DURING CONSTRUCTION THE STRUCTURE AND ANY ADJACENT STRUCTURE SHALL BE MAINTAINED IN A STABLE CONDITION AND NO OPART SHALL BE OVERSTRESSED. G3 - DIMENSIONS SHALL NOT BE OBTAINED BY SCALING OFF THIS DRAWING. ALL LEVELS AND SETTING OUT DIMENSIONS SHOWN ON THIS DRAWING SHALL BE CHECKED ON-SITE PRIOR TO THE COMMENCEMENT OF THE WORKS.


G4 - THE CONTRACTOR IS RESPONSIBLE TO ESTABLISH THE LOCATION, SIZE AND LEVEL OF ALL EXISTING SERVICES PRIOR TO COMMENCEMENT OF WORKS. G5 - ALL PIPES, JOINTS, VALVES, SUB-SOIL DRAINS ETC SHALL CONFORM, BE INSTALLED AND BACKFILLED IN ACCORDANCE WITH RELEVANT AUSTRALIAN STANDARDS. G6 - ALL BALCONIES AND ROOFS ARE TO INCORPORATE A SAFETY OVERFLOW G7 - NOTWITHSTANDING THE EXTENT AND LAYOUT OF DRAINAGE SHOWN ON THIS DRAWING, ADDITIONAL WORKS OR REMEDIATION MAY BE REQUIRED SHOULD UNDISCLOSED FEATURES OR ALTERED SITE CONDITIONS WARRANT IT.

G8 - ADEQUATE SEDIMENT AND EROSION CONTROL MEASURES ARE TO BE INSTALLED PRIOR TO WORKS BEGINNING ON-SITE. ALL SEDIMENT CONTROL IS TO BE LOCATED WITHIN THE SITE BOUNDARY AND BE MAINTAINED DURING THE PERIOD OF

G9 - ALL DISTURBED AREAS ARE TO BE STABILISED AND RESTORED IN ACCORDANCE WITH ARCHITECTURAL OR LANDSCAPE PLANS WHEN INSIDE THE BOUNDARY, AND IN ACCORDANCE WITH COUNCILS CIVIL WORKS POLICY TO COUNCIL SATISFACTION WHEN OUTSIDE THE SITE BOUNDARY.

G10 - DRIVEWAY CROSSINGS AND FOOTPATHS ARE SHOWN INDICATIVELY AND ARE TO BE CONSTRUCTED TO COUNCIL SPECIFICATIONS.

G11 - ALL PROPOSED DRAINAGE STRUCTURES INCLUDING RETAINING WALLS, PITS, TANKS AND DETENTION BASINS BUILT ADJACENT OR OVER UNDERGROUND SERVICES, EASMEMENTS OR SEWER ARE TO BE CONSTRUCTED TO THE RELEVANT AUTHORITY REQUIREMENTS.

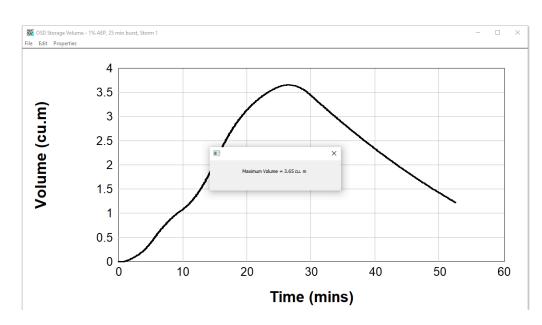

DRAINS MODELLING OUTPUT; 1.0% AEP; OSD REQUIRED 3.65 m3

STORMWATER MANAGEMENT FOR DA ONLY

DA1 - THIS PLAN IS ISSUED FOR THE PURPOSES OF COUNCIL ENGINEER REVIEW AND DEVELOPMENT APPROVAL WITH RESPECT TO COUNCILS STORMWATER MANAGEMENT POLICY.

DA2 - THIS DRAWING IS INTENDED TO BE SCHEMATIC AND NOT FOR USED FOR CONSTRUCTION

DA3 - FINAL LOCATION OF ALL DOWNPIPES, PITS, RAINWATER TANK ELEMENTS AND SUBSOIL PIPES ARE TO BE CONFIRMED DURING CONSTRUCTION CERTIFICATE STAGE (CC) OF THE PROPOSED DEVELOPMENT

DA4 - DIMENSIONS, LOCATION, LEVELS AND VOLUMES OF RAINWATER AND ON-SITE DETENTION TANKS ARE TO BE GENERALLY AS PER THE COUNCIL DA APPROVED DESIGN. ANY CHANGES AT CC STAGE ARE SUBJECT TO ENGINEER APPROVAL AND MAY REQUIRE COUNCIL RESUBMISSION FOR COUNCIL ENGINEERING APPROVAL.

SEEPAGE, LANDSCAPING AND SUBSOIL DRAINAGE

LD1 - ANY EXPOSED CUT TO BE STABILISED AND DRAINED IN ACCORDANCE WITH GEOTECHNICAL ENGINEERING ADVICE AND DRAINAGE INSTALLED IN ACCORDANCE WITH

LD2 - ANY NUISANCE SEEPAGE FLOWS, OVERLAND FLOWS OR WATER TABLE ENCOUNTERED TO BE CAPTURED AND RE-DIRECTED IN ACCORDANCE WITH GEOTECHNICAL, HYDROLOGIC AND HYDRAULIC ENGINEERS REQUIREMENTS. LD3 - ALL LANDSCAPED AREAS LOCATED OVER CONCRETE SLABS OR ADJACENT TO WALLS SERVICING A HABITABLE AREA TO BE EQUIPPED WITH WATERPROOFING MEMBRABE, DRAINAGE CELL, GEOFABRIC AND A SUITABLE MEANS OF OVERFLOW IN THE EVENT OF BLOCKAGE TO THE PRIMARY DRAINAGE SYSTEM.

DESIGN SUMMARY NORTHERN BEACHES COUNCIL (WARRINGAH)

POST DEVELOPMENT IMPERVIOUS AREA

SITE AREA 609.6 m2 (Survey)

73.9 m2 (47%)

DEVELOPMENT DESIGN AREA 187.0 m2 (Rear yard)

PREDEVELOPMENT IMPERVIOUS AREA

THIS IS A LOW LEVEL PROPERTY SITE WITHOUT A STORMWATER EASEMENT EASEMENTS HAVE BEEN REFUSED BY REAR NEIGHBOURS REFER TO SIGNED LETTERS

THIS IS AN ALTERATIONS AND ADDITIONS DEVELOPMENT WITH A SWIMMING POOL AND CABANA TO REAR OF THE SITE THE SWIMMING POOL RUNOFF WILL BE DIRECTED TO SEWER (POOL AREA 32 m2)

OSD IS REQUIRED FOR THIS DEVELOPMENT A MINIMUM OF 144.0 m2 OF ROOF AREA IS TO BE DIRECTED TO THE OSD

DESIGN AREA WITH POOL EXCLUDED 155 m2

PSD 20% AEP (GREENFIELDS) 4 L/s

POST DEVELOPMENT OSD 1.0% AEP DISCHARGE 3 L/s

POST DEVELOPMENT BYPASS 1.0% 1 L/s

PRE DEVELOPMENT 20% AEP MATCHES POST DEVELOPMENT 1.0% AEP


OSD DESIGN 3.65 m3 (3650 L) APPLY RWT TANK OFFSET (BASIX 1662L) 1.62 L (50% OR 1825L MAX) OSD REQUIRED 2.03 L (2030 L)


OSD PROVIDED 3.12 m3 (3120L)

BASIX REQUIREMENTS MIN 1662L (2100L PROVIDED) WITH 140 m2 ROOF AREA DIRECTED TO TANK WITH PLUMBING TO TAP WITH 10m OF SWIMMING POOL

						5	4] 3	7 2	\neg	1	7
LNEWES						Checked - Date Date	by LG Date	40		יין אוניין	AUTIONISATION LUKE GELYENS (ENGINEER) DELLINI) THEAUSI NEK	Ref'Sheet/ 244091 SW01 A
MANAG						BEACHES GROUP		33 MARLBOROUGH ST, FRESHWATER	NCIL SUMMARY	TLA Engineers	Address Email In @laengineers.com.au In @laengineers.com.au	
						Project/Builder/Designer AI TERATIONS & ADDITIONS BY BEACHES GROUP			STORMWATER NOTES & COUNCIL SUMMARY			
				DESCRIPTION				GREGORY AND MELINDA WILL	Sheet Title	Building Designer		Building Designer Contact 02 9940 2229
		- 1/2025	11505	ISSUE DATE	SNOI	Scale 1 Job No.		1⊿∩	Drawir Size	^{ng} A3		
Word_{A}		. <		REV	REVISIONS	Sheet		140 NO			Rev	Δ
				ㄸ	_	Ι '	<u> </u>		•		•	•

5 4 3 2 1

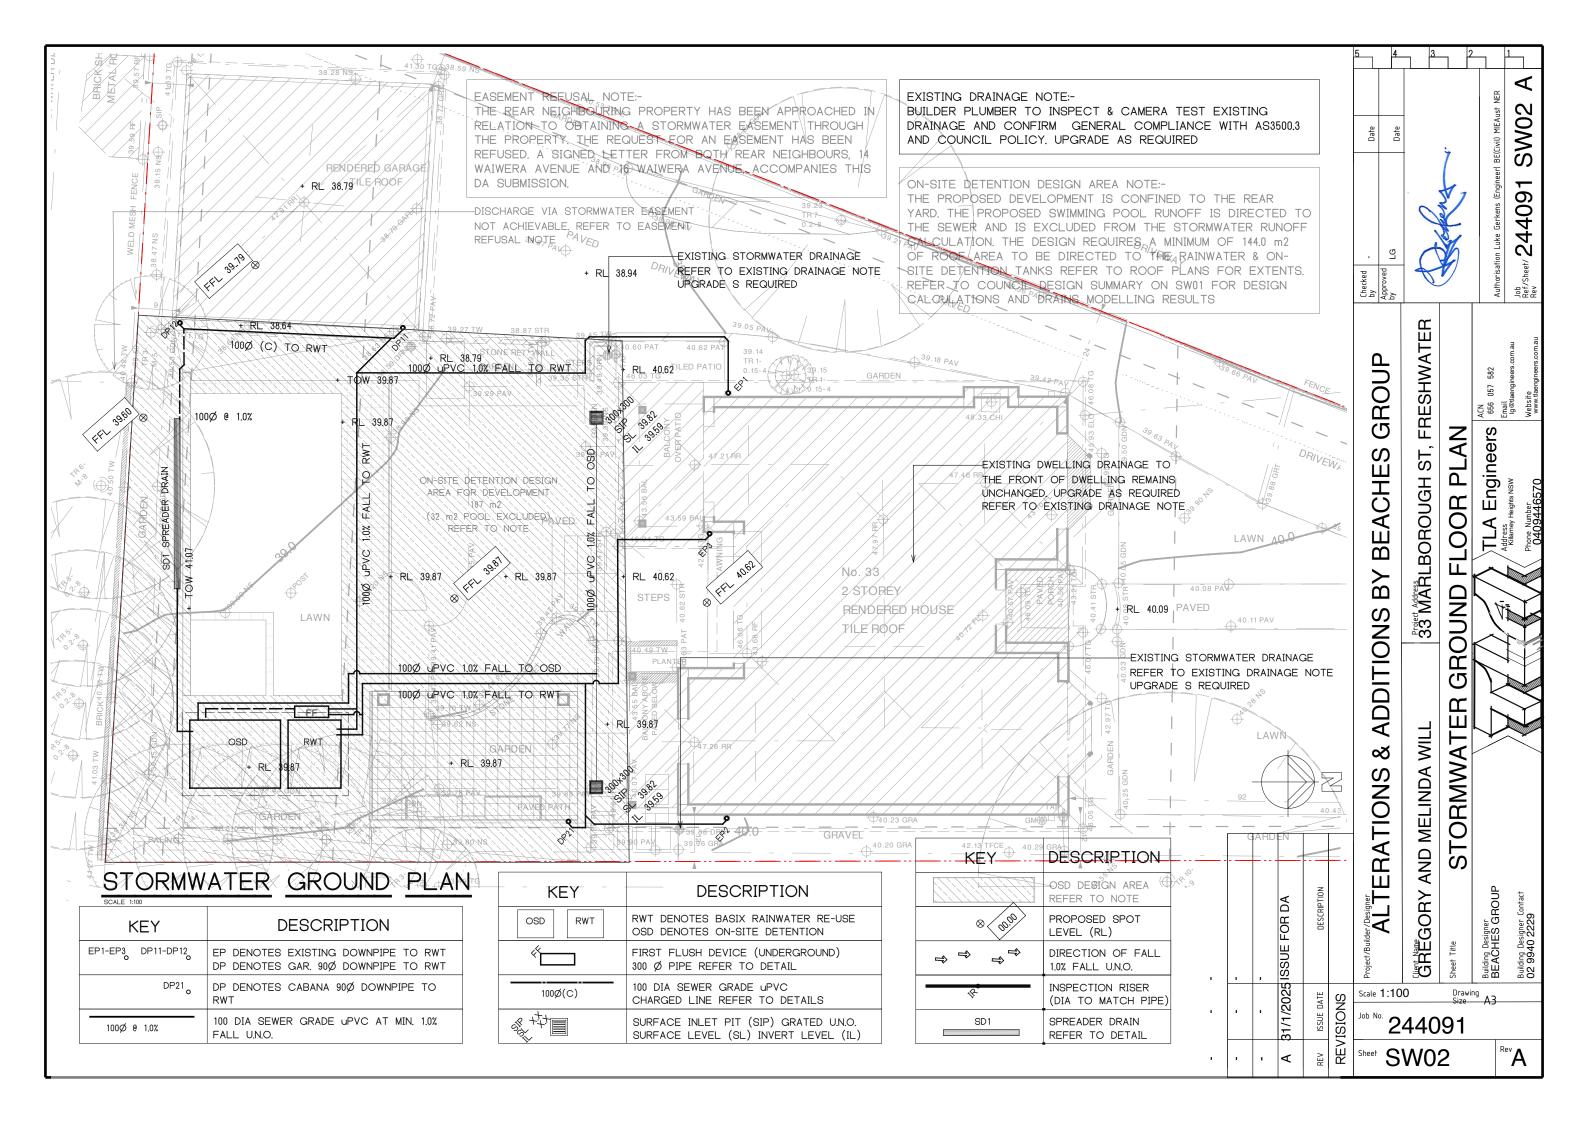

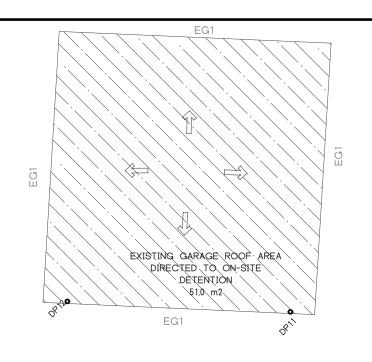

EXISTING DRAINAGE NOTE:-BUILDER PLUMBER TO INSPECT & CAMERA TEST EXISTING DRAINAGE AND CONFIRM GENERAL COMPLIANCE WITH AS3500.3 AND COUNCIL POLICY. UPGRADE AS REQUIRED

ON-SITE DETENTION DESIGN AREA NOTE:-THE PROPOSED DEVELOPMENT IS CONFINED TO THE REAR YARD. THE PROPOSED SWIMMING POOL RUNOFF IS DIRECTED TO THE SEWER AND IS EXCLUDED FROM THE STORMWATER RUNOFF CALCULATION. THE DESIGN REQUIRES A MINIMUM OF 144.0 m2 OF ROOF AREA TO BE DIRECTED TO THE RAINWATER & ON-SITE DETENTION TANKS REFER TO ROOF PLANS FOR EXTENTS. REFER TO COUNCIL DESIGN SUMMARY ON SW01 FOR DESIGN CALCULATIONS AND DRAINS MODELLING RESULTS

-EXISTING DWELLING DRAINAGE TO

THE FRONT OF DWELLING REMAINS

UNCHANGED. UPGRADE AS REQUIRED REFER TO EXISTING DRAINAGE NOTE FRESHWAT

GROUP

S

BEACHE

ΒY

ADDITIONS

∞

ST,

Date

244091 Job Ref.

⋖

SW03

 \square

Project Address 33 MARLBOROUGH

STORMWA

AND MELINDA WILL

EXISTING ROOF AREA DIRECTED

INSPECTION RISER (DIA TO MATCH PIPE)

DESCRIPTION KEY OSD DESIGN AREA REFER TO NOTE PROPOSED SPOT LEVEL (RL) DIRECTION OF FALL 1.0% FALL U.N.O.

_) 2	3	LIONS 8	
•		31/1/2025 ISSUE FOR DA	DESCRIPTION		Project/Builder/Designer ALTERATIONS	
	ı	/1/2025	ISSUE DATE	SNOISIA	Scale 1:10 Job No. 2	0
		3	<u> </u>	EVIS		_

GREGORY

<u>0</u>	Scale 1:100	Drawing Size A3
10101	Job No. 2440	91
> ∐	Sheet ONAIO	1

· | · | < | ≥ | ₩ | Sheet SW03

STORMWATER ROOF PLAN

SCALE 1:100	
KEY	DESCRIPTION
EP1-EP2 DP11-DP12 o	EP DENOTES EXISTING DOWNPIPE TO RWT DP DENOTES GAR. 900 DOWNPIPE TO RWT
DP21 _o	DP DENOTES CABANA 90Ø DOWNPIPE TO RWT
100Ø @ 1.0%	100 DIA SEWER GRADE uPVC AT MIN. 1.0% FALL U.N.O.

K	EY	DESCRIPTION			
OSD	RWT	RWT DENOTES BASIX RAINWATER RE-USE OSD DENOTES ON-SITE DETENTION			
₹ □		FIRST FLUSH DEVICE (UNDERGROUND) 300 Ø PIPE REFER TO DETAIL			
1000	S(C)	100 DIA SEWER GRADE UPVC CHARGED LINE REFER TO DETAILS			
EC	3 1	EAVES GUTTER MIN CROSS SECTION AREA 9000 mm2			
		,			

EG1


TO ON-SITE DETENTION


75.0 m2

PROPOSED CABANA ROOF AREA

DIRECTED TO ON-SITE

DETENTION 19.5 m2

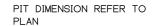


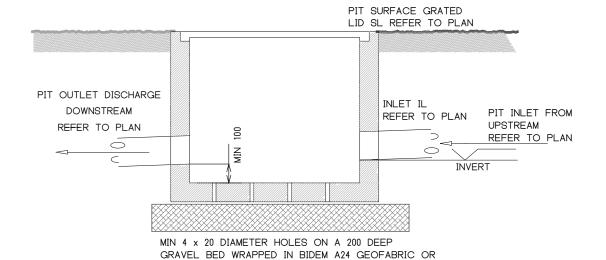

PRECAST OR CAST INSITU PIT REFER STORMWATER NOTES


ALTERNATE POLYPROPYLENE PIT BY MANUFACTURER

TYPICAL PIT DETAIL

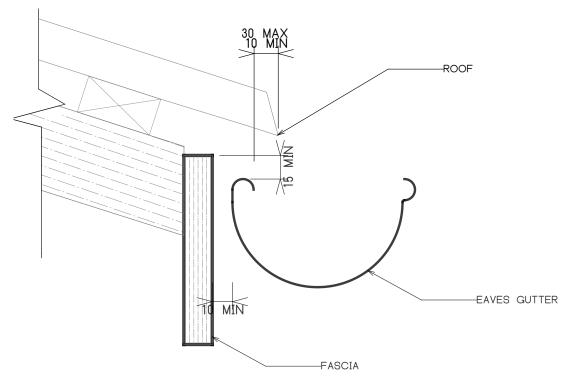

PROPRIETARY SPACER OFF FASCIA OPTION

EAVES GUTTER EG1 OVERFLOW

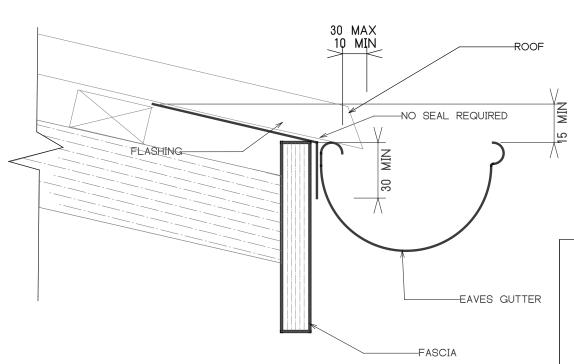

FLASHING FITTED UNDERSIDE OF ROOFING OPTION

EAVES GUTTER EG1 OVERFLOW

	-	-	31/1/2025 ISSUE FOR DA	DESCRIPTION		Project/Builder/Designer
	-	ı	1/1/2025	ISSUE DATE	SIONS	Scale Job 1
	ı			REV	REVI	Shee

e 1:20 Drawing A3

244091 **SW05**

 $^{\mathsf{Rev}}\!\mathsf{A}$

GREGORY

⋖

SW05

244091

Job Ref.

Date

FRESHWAT

33 MARLBOROUGH ST,

STORMWA

AND MELINDA WILL

GROUP


BEACHES


BY

ADDITIONS

∞


ALTERATIONS

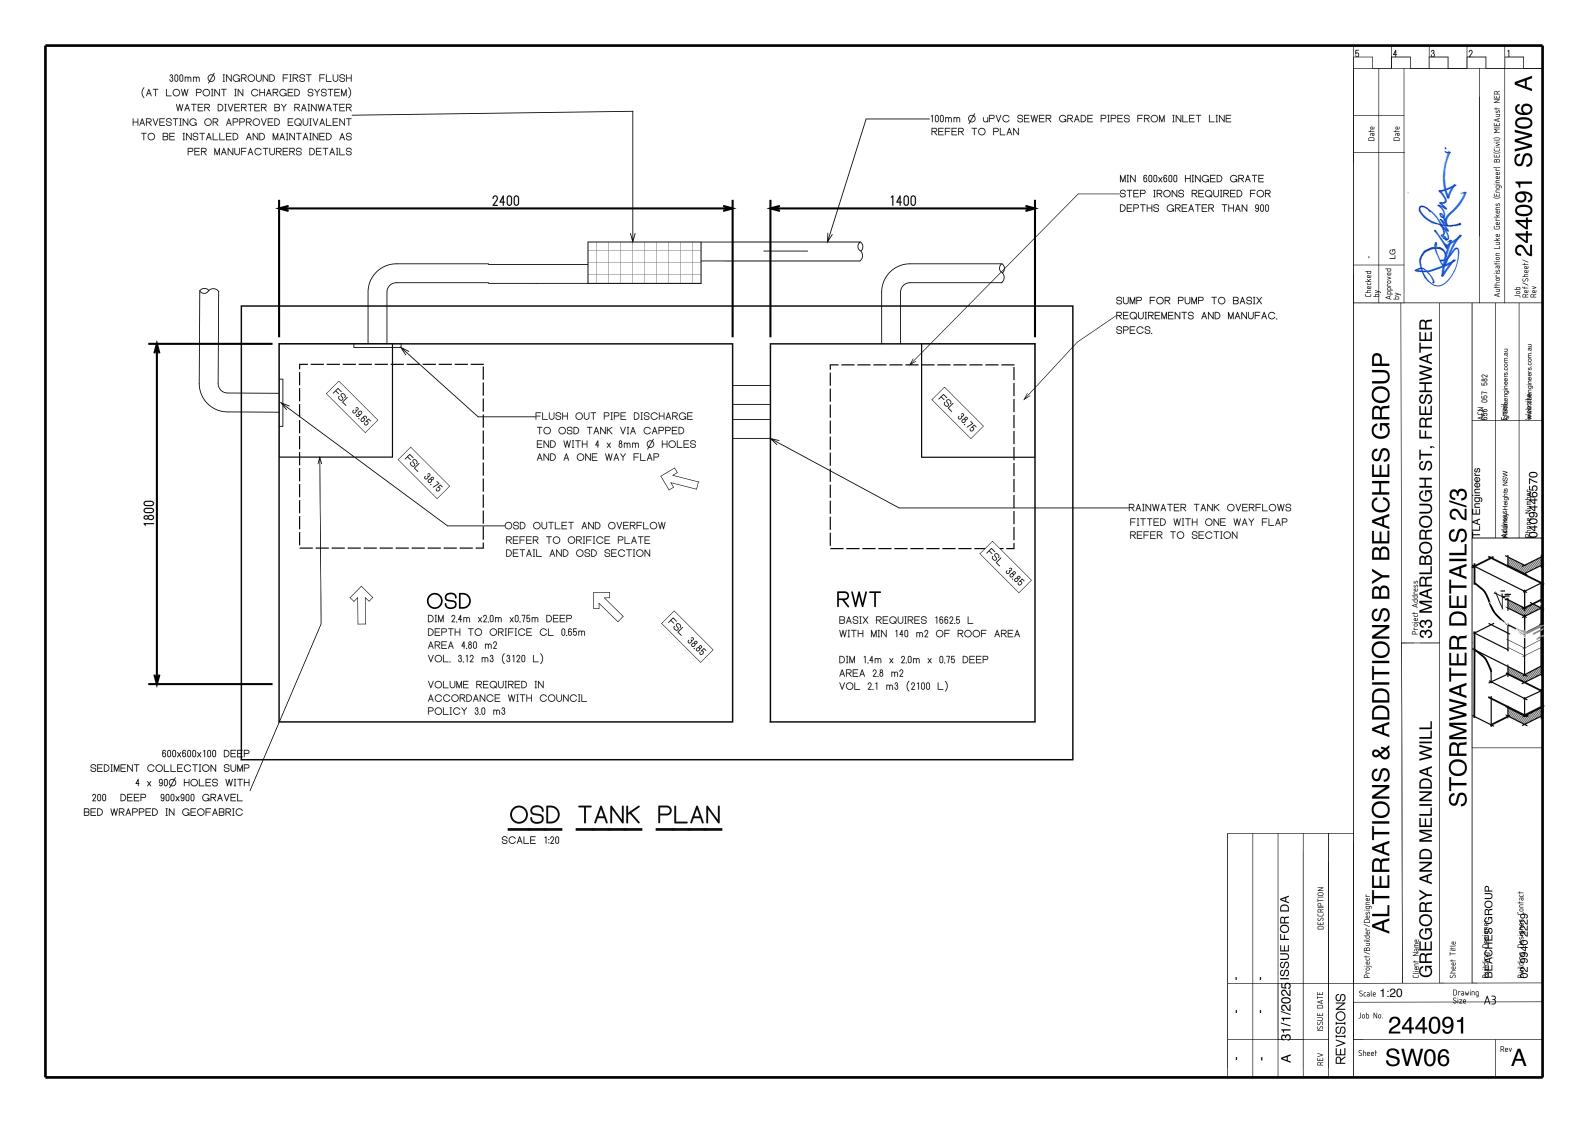

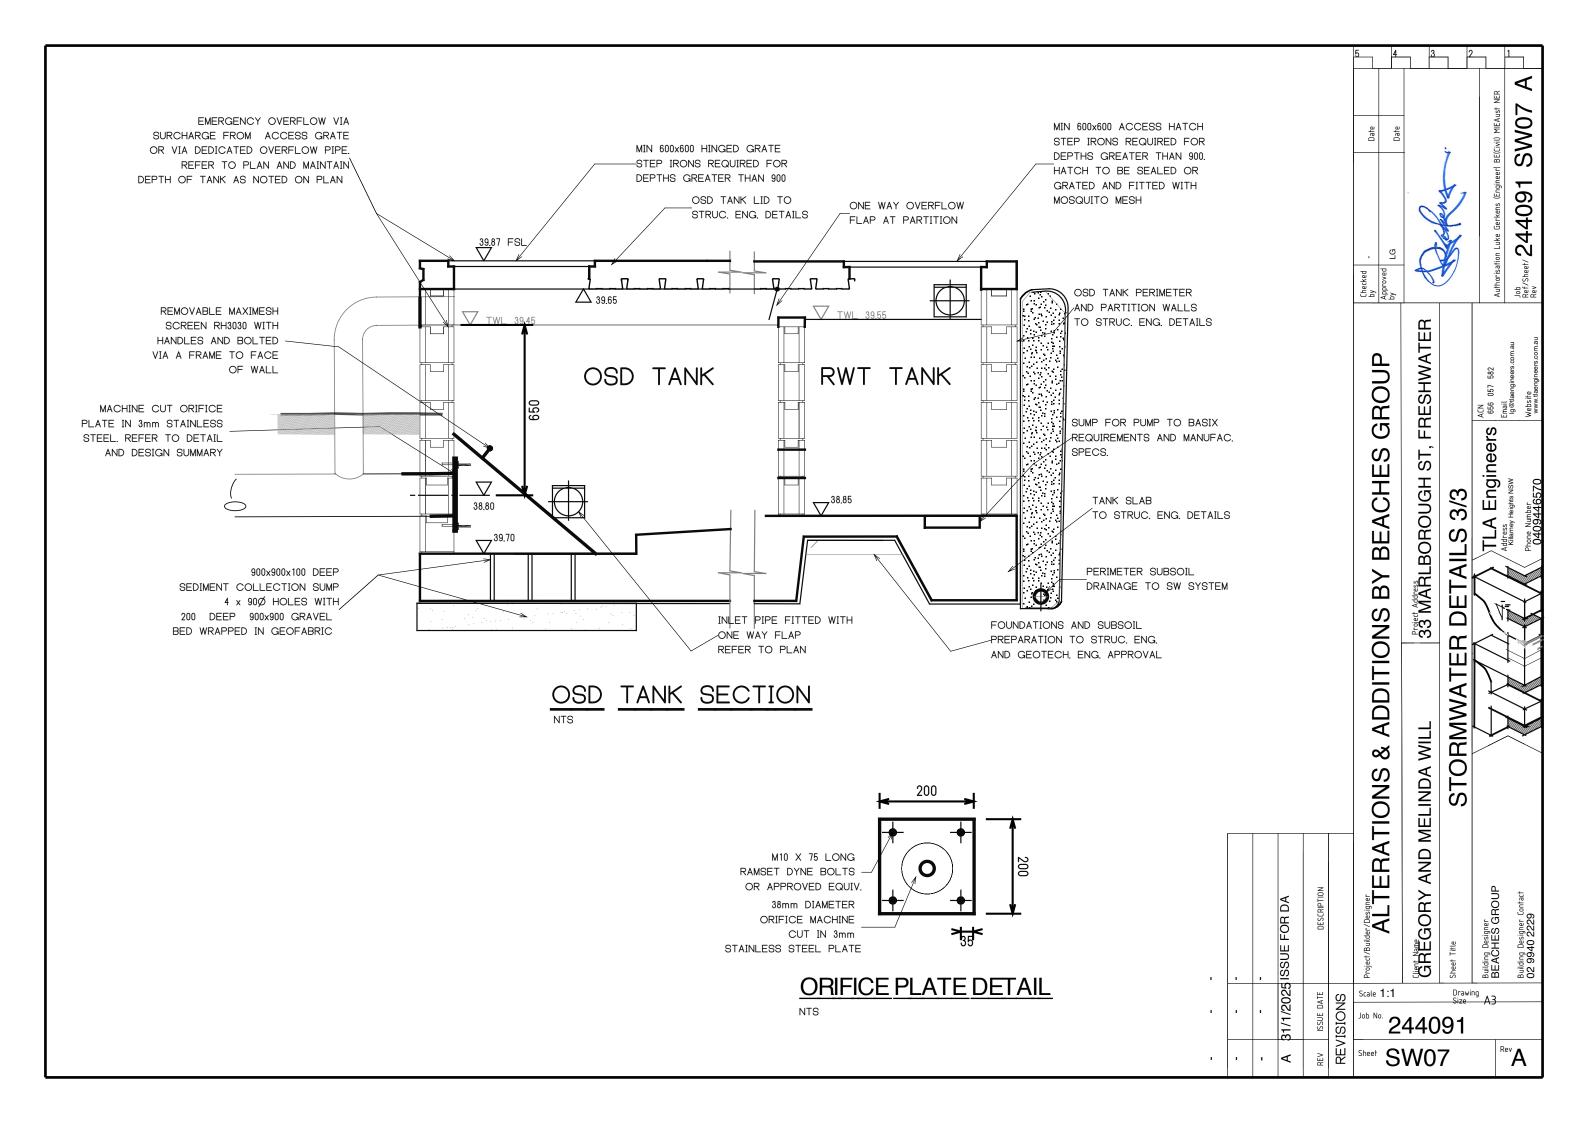


NOTE: SPREADER TRENCH

LOCATION OF TRENCH TO BE SUCH THAT DONWSTREAM NUISANCE FLOWS DO NOT OCCUR TO NEIGHBOURING PROPERTIES AND THAT THE TRENCH GRATE IS EXACTLY HORIZONTAL SUCH THAT DISCHARGE FLOW OCCURS ACROSS THE FULL WIDTH OF THE TRENCH. CONTACT THIS OFFICE SHOULD THE SURROUNDING SOILS BE PRONE TO EROSION (SANDY OR VEGETATED) OR NEARBY TREES AND VEGETATION MAY BE AFFECTED BY THE FLOW OF WATER.

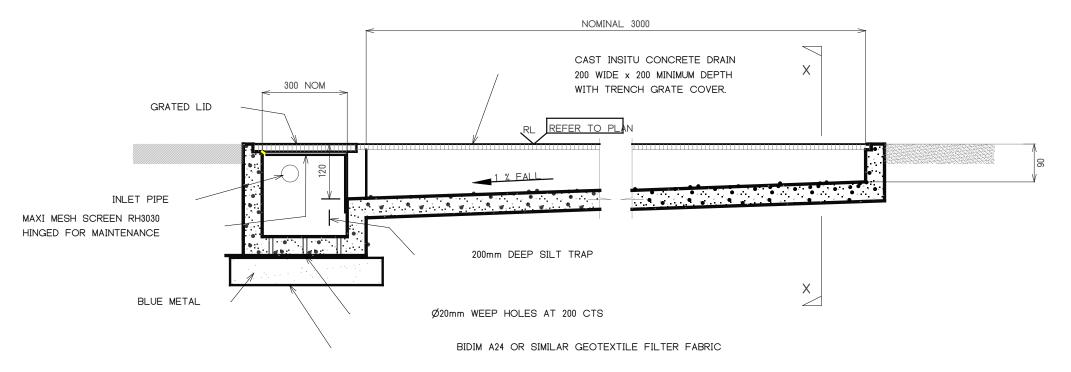

SPREADER TRENCH LONGITUDINAL SECTION

NOT TO SCALE

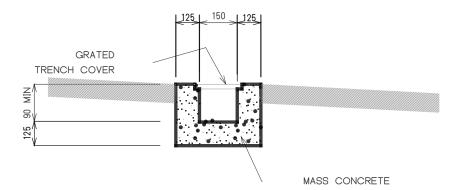

OR PRECAST GRATED DRAIN ALTERNATE POLYPROPYLENE DRAIN BY MANUFACTURER

SECTION X-X

		_	
NOT	TO	SCA	ΙF

		MAXI HINC		Y BEACH	333 WARLBOROUGH ST, FRESHWATER	AILS 4/4	TLA Engineers 656 057 582	Address Kilamey Heights NSW Phone Number 0409446570
				IONS B	Project Address	ER DET		
				ERATIONS & ADDITIONS BY BEACHES GROUP	AND MELINDA WILL	STORMWATER DETAILS 4/4		
	31/1/2025 ISSUE FOR DA	DESCRIPTION		Project/Builder/Designer ALTERA	GEREGORY AND N	Sheet Title	Building Designer BEACHES GROUP	Building Designer Contact 02 9940 2229
1	1/1/2025	ISSUE DATE	REVISIONS	Scale 1:20	440	Drawi Size	ng A3	
1	Α		I >	Sheet C	WO		F	Rev

Date

 \triangleleft

SW08

244091