STORWATER DRAINAGE PLANS PROPOSED HOUSE AT 31 KOOLOORA AVENUE, FRESHWATER

	DRAWING REGISTER
NUMBER	NAME
SW00	COVER SHEET
SW01	DRAINAGE PLAN
SW02	SEDIMENT & EROSION CONTROL PLAN

MINIMUM PIPE COVER (from finished surface to top of pipe)							
						millimet	
				Location	Cast iron, ductile iron, galvanized steel	Other authorized products	
					Minimun	n cover	
1	Not	subje	ect to v	ehicular loading:			
	(a)	with	out pa	vement—			
		(i)	for si	ngle dwellings	Nil	100	
		(ii)	for o	ther than Item (i)	Nil	300	
	(b)	with		nent of brick or unreinforced	Nil†	50†	
2	Subj	ject to	vehic	ular loading:			
	(a)	othe	r than	roads—			
		(i)	witho	out pavement	300	450	
		(ii)	with	pavement of—			
			(A)	reinforced concrete for heavy vehicular loading	Nil†‡	100†‡	
			(B)	brick or unreinforced concrete for light vehicular loading	Nil†‡	75†‡	
	(b)	road	s				
		(i)	seale	d	300	500‡	
		(ii)	unsea	iled	300	500‡	
3				struction equipment loading or	300	500‡	

AS3500.3

Subject to compliance with AS 1762, AS 2033, AS/NZS 2566.1, AS 3725 or AS 4060.

MINIMUM GRADIENT OF SITE STORMWATER DRAINS						
Nominal size	Minimun	n gradient	Nominal size	Minimum gradien		
DN	Aust.	NZ	DN	Aust.	NZ	
90	1:100	1:90	225	1:200	1:350	
100	1:100	1:120	300	1:250	1:350	
150	1:100	1:200	375	1:300	1:350	

<u>AS3500.3</u>

GENERAL

- ANY DEVIATIONS FROM LEVELS AND DETAILS SHOWN WITHIN THIS PACKAGE TO BE CONSULTED WITH THE ENGINEER CONSULTANT PRIOR TO ON-SITE CHANGES BEING MADE.
- ALL WORK TO BE CARRIED OUT IN ACCORDANCE WITH LOCAL COUNCIL ENGINEERING SPECIFICATIONS.
- FINAL LOCATION OF NEW DOWNPIPES TO BE DETERMINED BY BUILDER/ARCHITECT AT TIME OF CONSTRUCTION.
- THESE DRAWINGS ARE TO BE READ IN CONJUNCTION WITH THE ARCHITECTS AND OTHER CONSULTANT DRAWINGS. ANY DISCREPANCIES MUST BE REFEREED TO THE ENGINEER BEFORE
- INSPECTIONS BY THE CERTIFIEING AUTHORITY SHALL BE CARRIED OUT FOR ALL THE CIVIL WORKS PRIOR TO RELEASE OF THE HOLD POINTS INCLUDING THE FOLLOWING STAGES: 5.1. PRIOR TO INSTALLATION OF EROSION AND SEDIMENT CONTROL
- STRUCTURES 5.2. FINAL INSPECTION AFTER ALL WORKS ARE COMPLETED AND 'WORK

AS EXECUTED' PLANS HAVE BEEN SUBMITTED TO COUNCIL

- MAKE SMOOTH JUNCTIONS WITH EXISTING WORKS.
- NO WORK TO BE CARRIED OUT ON COUNCIL PROPERTY OR ADJOINING PROPERTIES WITHOUT THE WRITTEN PERMISSION FROM
- VEHICULAR ACCESS AND ALL SERVICES TO BE MAINTAINED AT ALL TIMES TO ADJOINING PROPERTIES AFFECTED BY CONSTRUCTION.
- . ALL RUBBISH, BUILDINGS, SHEDS AND FENCES TO BE REMOVED TO SATISFACTION OF COUNCIL'S ENGINEER.
- 10. THE CONTRACTOR SHALL OBTAIN ALL LEVELS FROM ESTABLISHED BENCH MARKS ONLY.

WARNING BEWARE OF UNDERGROUND SERVICES

The locations of underground services are approximate only and their exact position should be proven on site. No guarantee is given that all existing services are shown. ocate all underground services before commencement of works

MINIMUM INTERNAL DIMENSIONS FOR STORMWATER AND INLET PITS							
Minimum internal dimensions Depth to invert mm							
of outlet		Recta	ingular	Circular			
		Width	Length	Diameter			
	≤600	450	450	600			
>600	≤900	600	600	900			
>900	≤1200	600	900	1 000			
> 1 200)	900	900	1 000			

AS3500.3

EXISTING UNDERGROUND SERVICES NOTES

CONTRACTORS SHALL TAKE DUE CARE WHEN EXCAVATING ONSITE INCLUDING HAND EXCAVATION WHERE NECESSARY. CONTRACTORS ARE TO CONTACT THE RELEVANT SERVICE AUTHORITY PRIOR TO COMMENCEMENT OF EXCAVATION WORKS. CONTRACTORS ARE TO UNDERTAKE A SERVICES SEARCH, PRIOR TO COMMENCEMENT OF WORKS ON SITE. SEARCH RESULTS ARE TO BE KEPT ON SITE AT ALL TIMES.

SITEWORKS NOTES

- ORIGIN OF LEVELS:- REFER SURVEY NOTES.
- CONTRACTOR MUST VERIFY ALL DIMENSIONS AND EXISTING LEVELS ON SITE PRIOR TO COMMENCEMENT OF WORK. ANY DISCREPANCIES TO BE REPORTED TO THE CIVIL CONSULTANT.
- MAKE SMOOTH CONNECTION WITH EXISTING WORKS.
- ALL TRENCH BACKFILL MATERIAL SHALL BE COMPACTED TO THE SAME DENSITY AS THE ADJACENT MATERIAL.
- BASE AND SUB-BASE LAYERS ARE TO BE INSPECTED AND TESTED BY AN INDEPENDENT GEOTECHNICAL TESTING AUTHORITY TO LEVEL 1 RESPONSIBILITY AS DEFINED IN AS3798.
- ALL BASECOURSE MATERIAL SHALL BE IGNEOUS ROCK QUARRIED MATERIAL TO COMPLY WITH RMS FORM 3051, COMPACTED TO MINIMUM 98% MODIFIED DENSITY IN ACCORDANCE WITH AS 1289 5.2.1 FREQUENCY OF COMPACTION TESTING SHALL NOT BE LESS THAN 1 TEST PER 50m³ OF BASECOURSE MATERIAL PLACED.
- ALL SUB-BASE COURSE MATERIAL SHALL BE IGNEOUS ROCK QUARRIED MATERIAL TO COMPLY WITH RMS FORM 3051, AND COMPACTED TO MINIMUM 95% MODIFIED DENSITY IN ACCORDANCE WITH A.S 1289 5.2.1 FREQUENCY OF COMPACTION TESTING SHALL NOT BE LESS THAN 1 TEST PER 50m³ OF SUB-BASE COURSE MATERIAL PLACED.
- SHOULD THE CONTRACTOR WISH TO USE A RECYCLED PRODUCT THIS SHALL BE CLEARLY INDICATED IN THEIR TENDER AND THE PRICE DIFFERENCE BETWEEN AN IGNEOUS PRODUCT AND A RECYCLED PRODUCT SHALL BE CLEARLY INDICATED.
- WHERE NOTED ON THE DRAWINGS THAT WORKS ARE TO BE CARRIED BY OTHERS, (eg. ADJUSTMENT OF SERVICES), THE CONTRACTOR SHALL BE RESPONSIBLE FOR THE CO-ORDINATION OF THESE WORKS.

STORMWATER DRAINAGE NOTES

- 1. ALL PIPES ON DRAWINGS TO BE MIN 1% GRADE UNLESS NOTED OTHERWISE.
- 2. ALL DOWNPIPES TO BE 100Ø PVC UNLESS NOTED OTHERWISE.
- 3. PIPES 375 DIA. AND LARGER TO BE REINFORCED CONCRETE CLASS '2'

APPROVED SPIGOT AND SOCKET WITH RUBBER RING JOINTS. U.N.O.

- 4. PIPES 300 DIA AND LESS SHALL BE DWV GRADE (CLASS SN8) uPVC WITH SOLVENT WELDED JOINTS.
- 5. EQUIVALENT STRENGTH FRC PIPES MAY BE USED.
- 6. ALL PIPES ARE TO BE UNIFORMLY SUPPORTED ALONG THE LENGTH OF THE BARREL BY SUITABLE FILL MATERIAL. REFER TO BEDDING SUPPORT
- . PIPES WITH SOCKETS SHALL BE LAID IN BEDDING WHERE SUITABLE RECESSES HAVE BEEN PROVIDED TO ENSURE PIPES DO NOT BEAR ON THEIR SOCKETS.
- 8. ALL STORMWATER DRAINAGE LINES UNDER PROPOSED BUILDING SLABS TO BE uPVC PRESSURE PIPE GRADE 6. ENSURE ALL VERTICALS AND DOWNPIPES ARE uPVC PRESSURE PIPE, GRADE 6 FOR A MIN OF 3.0m IN
- PIPES TO BE INSTALLED TO TYPE HS1 SUPPORT IN ACCORDANCE WITH AS 3725 (2007) IN ALL CASES BACKFILL TRENCH WITH SAND TO 300mm ABOVE PIPE. WHERE PIPE IS UNDER PAVEMENTS BACKFILL REMAINDER OF TRENCH TO UNDERSIDE OF PAVEMENT WITH SAND OR APPROVED GRANULAR MATERIAL COMPACTED IN 150mm LAYERS TO MINIMUM 98% STANDARD MAXIMUM DRY DENSITY IN ACCORDANCE WITH AS 1289 5.2.1 (OR A DENSITY INDEX OF NOT LESS THAN 75).
- 10. REFER TO AS/NRS 3725:2007 TABLE B1 FOR REQUIRED FILL DEPTHS ABOVE PIPE BARREL PRIOR TO USE OF COMPACTION MACHINERY OR TRAVERSING OF PIPES BY GENERAL SITE EQUIPMENT.
- 11. WHERE WORKING METHODS REQUIRE HIGHER CLASS PIPE, THE CONTRACTOR SHALL REFER TO AS 3725 (2007) TO DETERMINE THE APPROPRIATE PIPE CLASS.
- 12. ALL INTERNAL WORKS WITHIN PROPERTY BOUNDARIES ARE TO COMPLY WITH THE REQUIREMENTS OF AS 3500 3.1 (2018) AND AS/NZS 3500 3.2
- 13. ENLARGERS, CONNECTIONS AND JUNCTIONS TO BE PREFABRICATED FITTINGS WHERE PIPES ARE LESS THAN 300 DIA.
- 14. WHERE SUBSOIL DRAINS PASS UNDER FLOOR SLABS AND VEHICULAR PAVEMENTS, UNSLOTTED uPVC SEWER GRADE PIPE IS TO BE USED.
- 15. CARE IS TO BE TAKEN WITH LEVELS OF STORMWATER LINES. GRADES SHOWN ARE NOT TO BE REDUCED WITHOUT APPROVAL.
- 16. GRATES AND COVERS SHALL CONFORM TO AS 3996.
- 17. ALL BOX CULVERTS SHALL BE STRUCTURALLY DESIGNED BY THE MANUFACTURER AND DELIVERED TO SITE AS FIT FOR PURPOSE.
- 18. AT ALL TIMES DURING CONSTRUCTION OF STORMWATER PITS, ADEQUATE SAFETY PROCEDURES SHALL BE TAKEN TO ENSURE AGAINST THE POSSIBILITY OF PERSONNEL FALLING DOWN PITS.
- 19. ALL EXISTING STORMWATER DRAINAGE LINES AND PITS THAT ARE TO REMAIN ARE TO BE INSPECTED AND CLEANED. DURING THIS PROCESS ANY PART OF THE STORMWATER DRAINAGE SYSTEM THAT WARRANTS REPAIR SHALL BE REPORTED TO THE SUPERINTENDENT/ENGINEER FOR FURTHER DIRECTIONS.

BMY CONSULTANTS Pty Ltd OFFICE 3.07 LEVEL 3, 14-16 LEXINGTON DR, BELLA VISTA, 2154 ABN 33 629 286 522 Phone: (02) 9145 0253 Website: www.bmyconsultants.com.au Email: admin@bmyconsultants.com.au This drawing remains the property of BMY Consultants and must not be reproduced or used without written consent.



REV	DESCRIPTION	DATE	ISSUED	CHECKED
Α	ISSUE FOR DA	13.12.2023	M.Y	M.Y



PROPOSED HOUSE AT 31 KOOLOORA AVENUE, FRESHWATER

JUDY HSU & CHRIS HUDSON

COVER SHEET

PROJECT NO. DRAWING NO.

230784 SW00

SCALE @ A1

1:100

REVISION

DRAWN

D.Y


13.12.2023


AUTHORISED

M.Y

MOUSSA YOUSSEF B.E (Civil - Structures), Dip. Eng. Prac



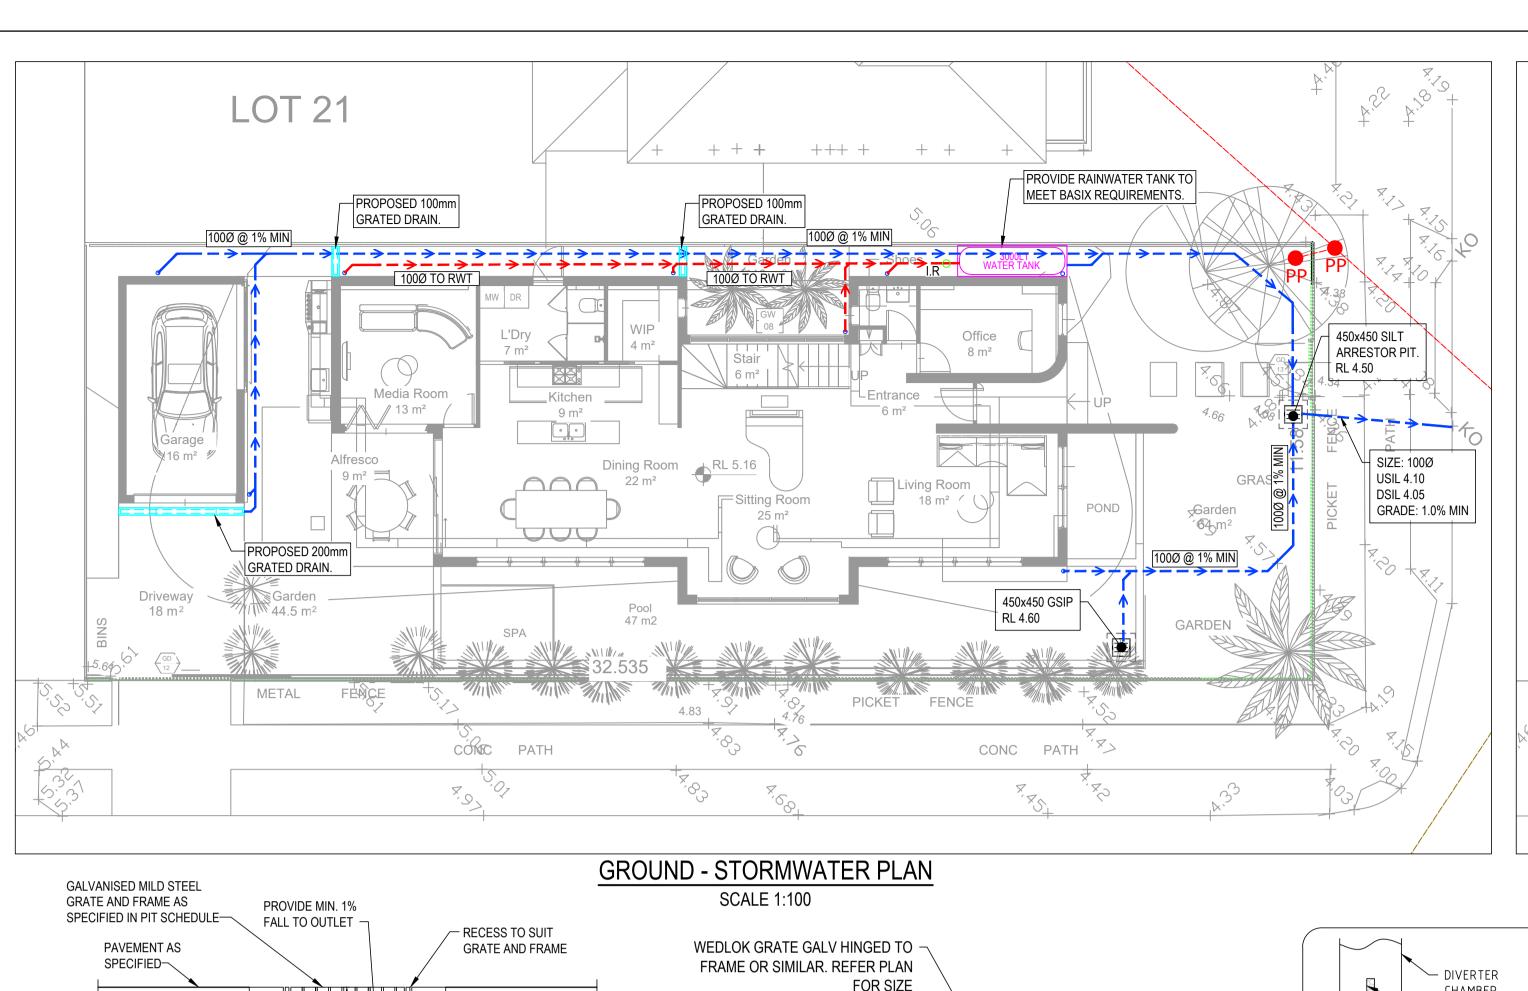

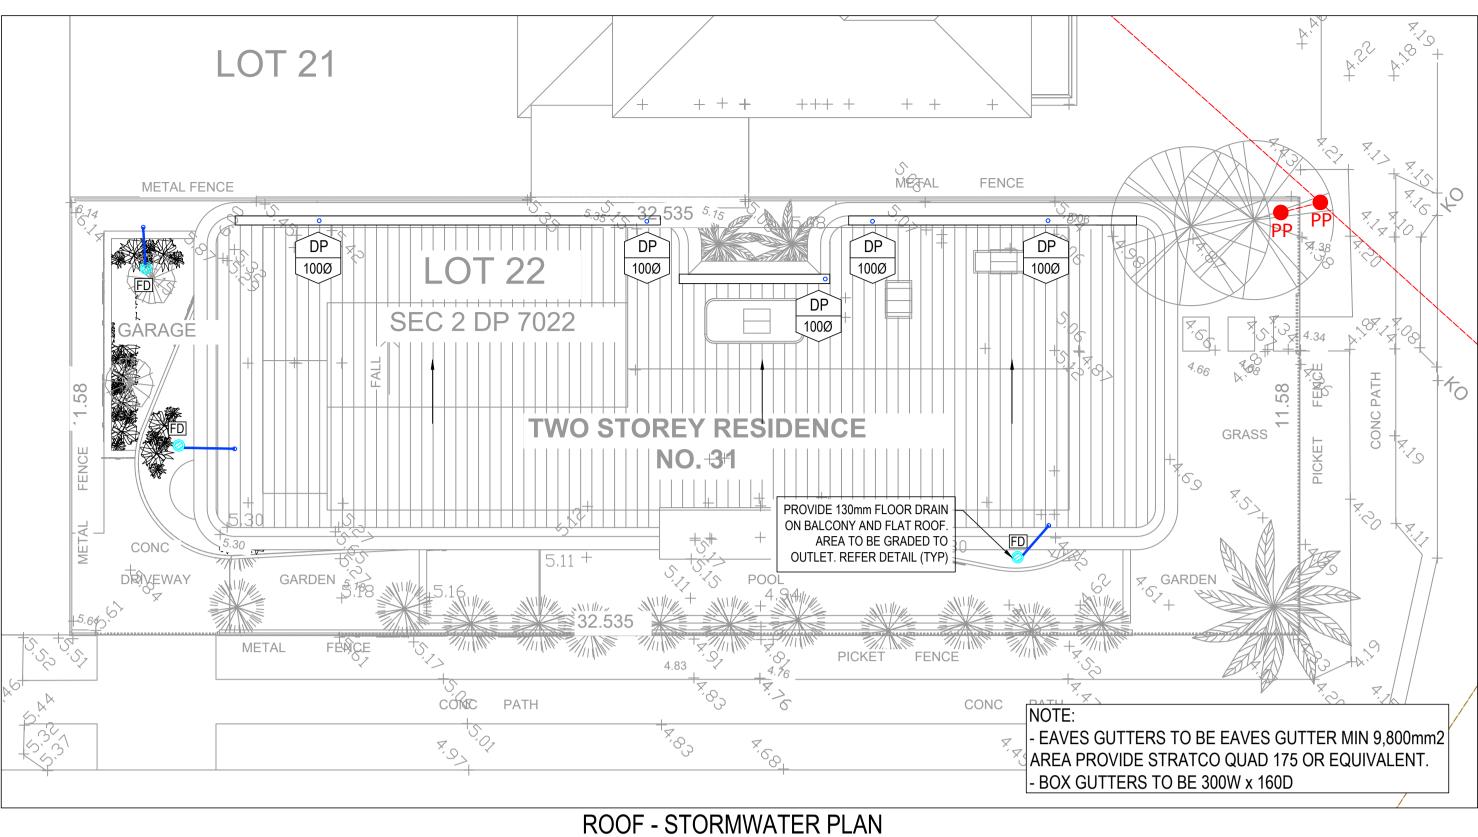

SCALE 1:100

- LIGHT DUTY AIR TIGHT


NEW 100¢ PVC OUTLET TO SILT PIT AND KERB OUTLET

DRAWING

SCREW DOWN CAP

100mm DIA PVC 'CHARGED LINE'

INSPECTION RISER DETAIL 1

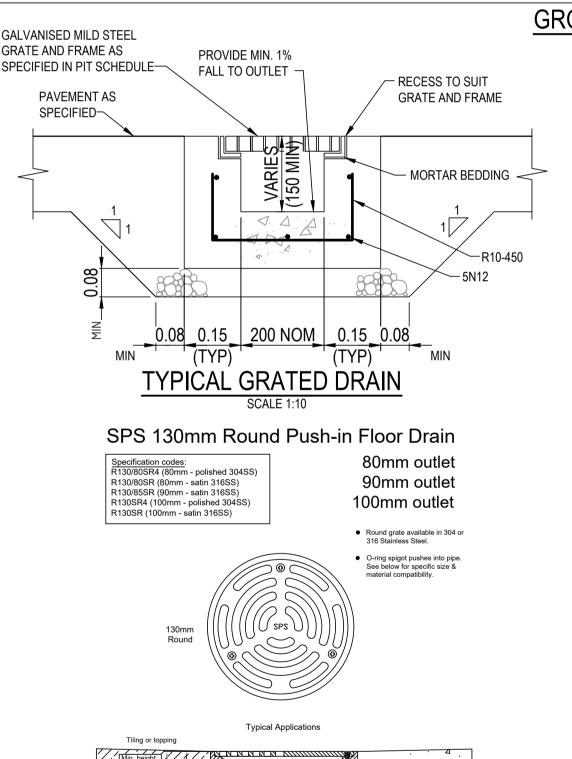


 80mm
 20
 49
 64
 72
 PVC and copper

 90mm
 20
 49
 75
 85.5
 PVC stormwater only


Speciality Plumbing Supplies Pty Ltd
Tel: (02) 9417 1900 Fax: (02) 9417 0108 E-mail: info@spsdrains.com.au 2.04

FLOOR DRAIN (FD) DETAIL NTS

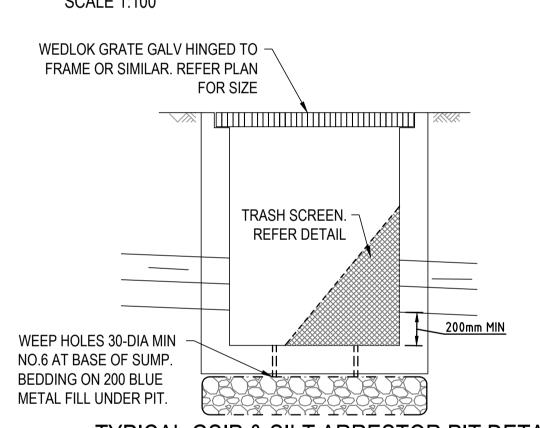


TYPICAL GSIP & SILT ARRESTOR PIT DETAIL


ADD STEP IRONS IN ACCORDANCE WITH DETAILS FOR ANY PITS DEEPER THAN 900mm

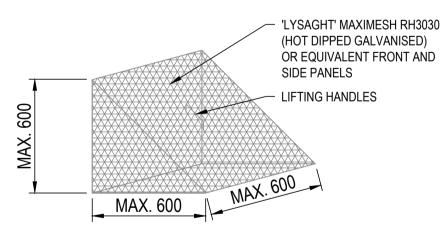

TRASH SCREEN DETAIL

- NOTES: 1. MAXIMESH SCREENS MUST BE PLACED SUCH THAT THE LONG AXIS OF THE OVAL SHAPED HOLES ARE ORIENTATED HORIZONTALLY WITH THE PORTRUDING LIP ANGLED UPWARDS AND FACING TOWARDS THE OUTLET.
- 2. THE SCREEN IS TO BE FORMED BY WELDING TWO TRIANGULAR MAXIMESH (OR EQUIVALENT) PANELS TO A RECTANGULAR FRONT MAXIMESH PANEL (OR **EQUIVALENT**)

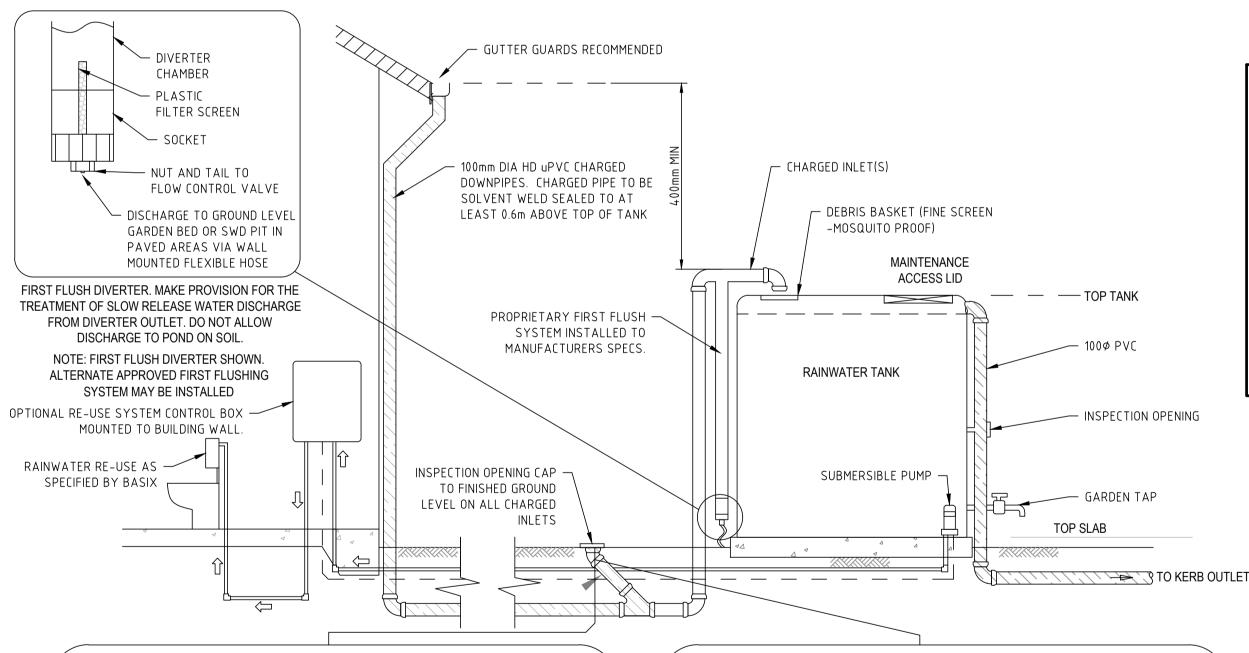

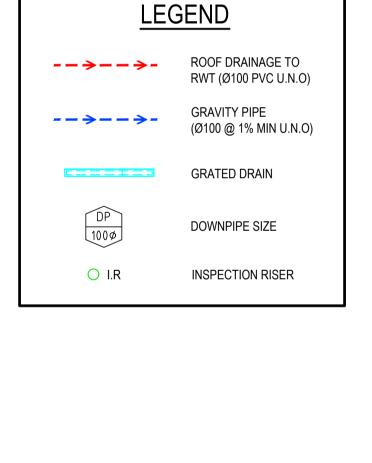

DESIGN SUMMARY COUNCIL AREA: NORTHERN BEACHES COUNCIL

OSD REQUIREMENT: NO OSD REQUIRED, SITE <450m²

LEGAL POINT OF DISCHARGE: DISCHARGE VIA KERB OUTLET

RAINWATER RE-USE TANK - ABOVE GROUND

CAP TO BE SECURED WITH —

CONCRETE SURROUND

BMY CONSULTANTS Pty Ltd OFFICE 3.07 LEVEL 3, 14-16 LEXINGTON DR, BELLA VISTA, 2154 ABN 33 629 286 522 Phone: (02) 9145 0253 Website: www.bmyconsultants.com.au Email: admin@bmyconsultants.com.au This drawing remains the property of BMY Consultants and must not

be reproduced or used without written consent.

Structural Slab

L _ _ _ ✓ · · · · _ With topping/tiling



REV	DESCRIPTION	DATE	ISSUED	CHECKED
А	ISSUE FOR DA	13.12.2023	M.Y	M.Y



- LIGHT DUTY AIR TIGHT

NEW 100¢ PVC

CHARGED LINE

SCREW DOWN CAP

100mm DIA PVC 'CHARGED LINE'

INSPECTION RISER DETAIL 2

CAP TO BE SECURED WITH -

CONCRETE SURROUND

PROPOSED HOUSE AT 31 KOOLOORA AVENUE, FRESHWATER


JUDY HSU & CHRIS HUDSON

DRAINAGE PLAN

MOUSSA YOUSSEF B.E (Civil - Structures), Dip. Eng. Prac

PROJECT NO. 230784	DRAWING NO. SW01	revision A	DATE 13.12.2023
SCALE @ A1 1:100		drawn D.Y	AUTHORISED M.Y



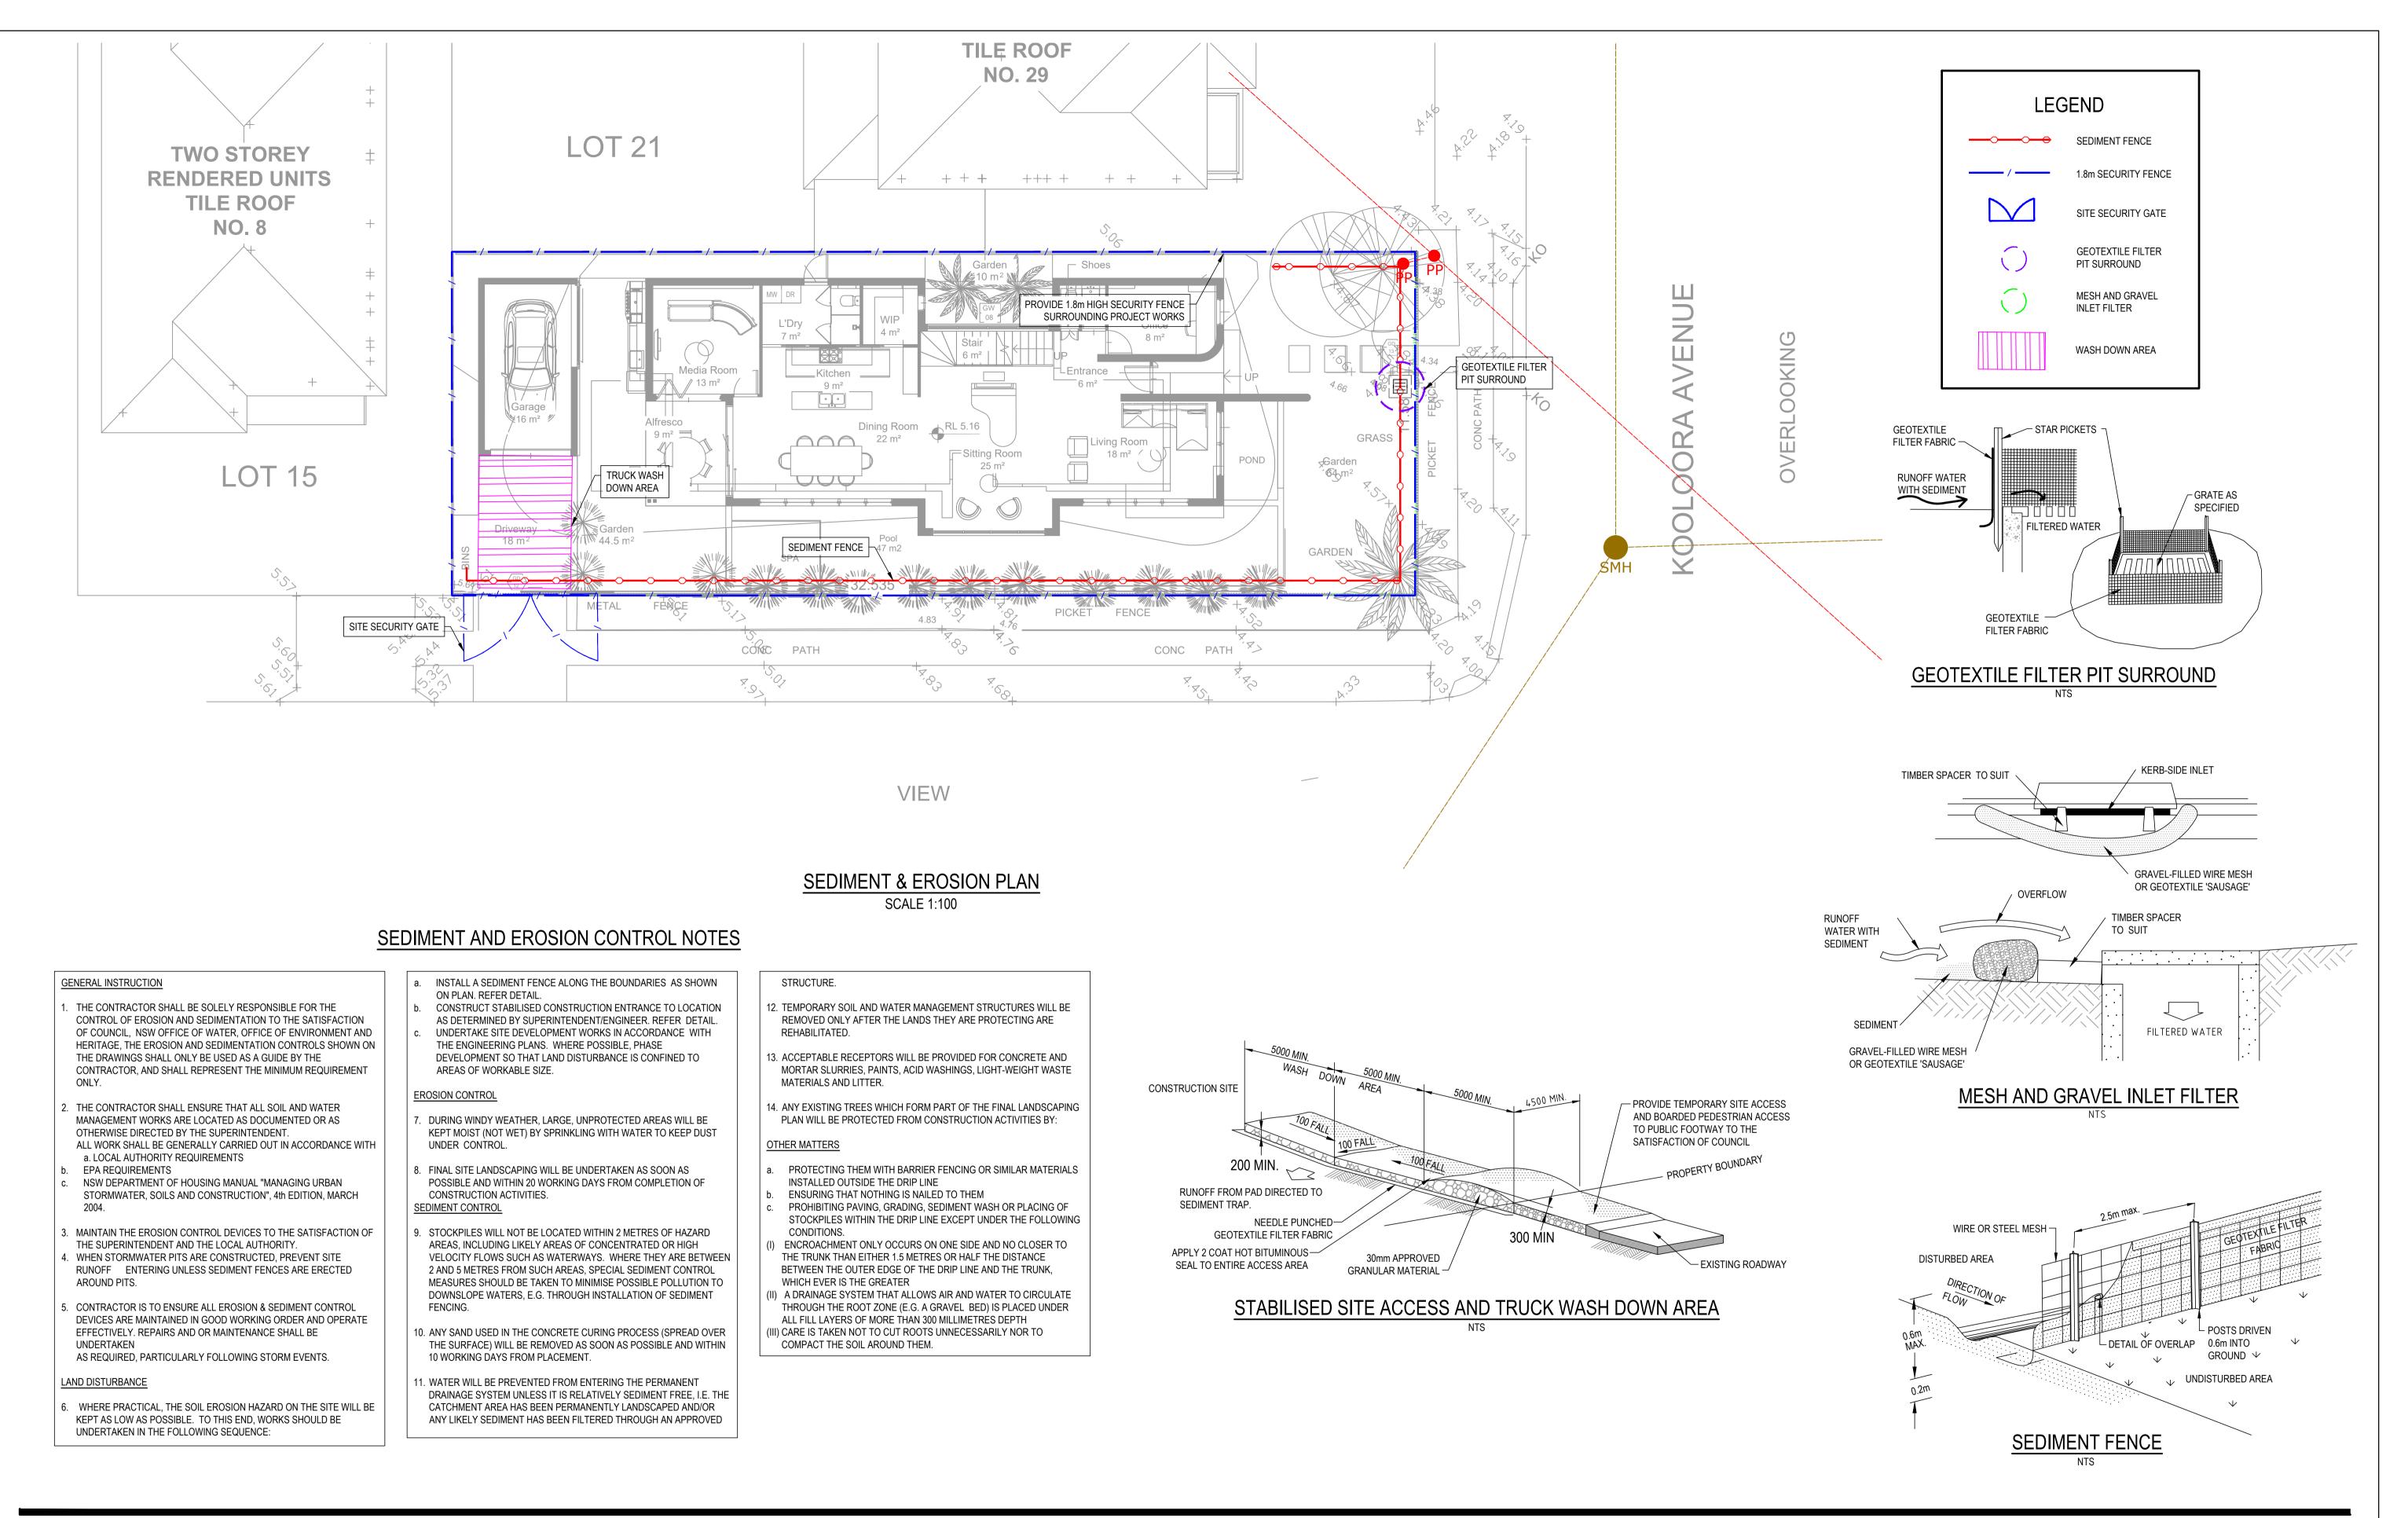

BMY CONSULTANTS Pty Ltd
OFFICE 3.07 LEVEL 3, 14-16
LEXINGTON DR, BELLA VISTA, 2154
ABN 33 629 286 522
Phone: (02) 9145 0253
Website: www.bmyconsultants.com.au
Email: admin@bmyconsultants.com.au
This drawing remains the property of
BMY Consultants and must not

be reproduced or used without written consent.

BUILDING CONSULTANTS

REV	DESCRIPTION	DATE	ISSUED	CHECKED
А	ISSUE FOR DA	13.12.2023	M.Y	M.Y



PROPOSED HOUSE AT 31 KOOLOORA AVENUE, FRESHWATER

JUDY HSU & CHRIS HUDSON

SEDIMENT & EROSION CONTROL PLAN

MOUSSA YOUSSEF B.E (Civil - Structures), Dip. Eng. Prac

PROJECT NO. DRAWING NO. 230784 SW02 A DATE 13.12.2023

SCALE @ A1 DRAWN AUTHORISED D.Y M.Y

