

DRAWING LIST	
DRAWING NO.	DRAWING LIST
000	COVER PAGE
005	BASIX COMMITMENT
010	LOCATION PLAN
020	CUT&FILL PLAN
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200	ELEVATION
210	ELEVATION
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500	SHADOW DIAGRAM
510	SHADOW DIAGRAM
600	AREA CALCULATION
700	EXTERNAL FINISH SCHEDULE



DEVELOPMENT APPLICATION PROPOSED DWELLING AT LOT 03, 10 FERN CREEK ROAD, WARRIEWOOD

PREPARED FOR

SKYCORP AUSTRALIA

BASIX COMMITMENTS SUMMERY NOTES (TO BE READ IN CONJUNCTION WITH BASIX CERTIFICATE)				
BASIX Certificate # 1266847S				
WATER	No hot water reticulation required			
Fixtures	All shower heads	All toilets	All kitchen taps	All bathrooms taps
Rating	3 Star(>4.5 But<=6L/Min)	4 star	5 star	5 star
Alternate water source				
Rain Water Tank	Type	Size	Roof area connected	Connections
	Individual RWT	2000L	100 m2	Outdoor tap for landscape only
Swimming pool				
	Volume	Heated	Cover	Shaded

ENERGY				
Hot water	Type	Rating		
	Individual, gas instantaneous	5 star		
Mech. Ventilation	System	Operation Control		
Bath	Indiv. fan, ducted to facade or roof	Manual Switch On/Off		
L'dry	Indiv. fan, ducted to facade or roof	Manual Switch On/Off		
Kitchen	Indiv. fan, ducted to facade or roof	Manual Switch On/Off		
Cooling System	Type	Living areas	Bed rooms	
	1 Phase Air conditioning: Day / Night Zoned	2.5 star (average zone)	2.5 star (average zone)	
Heating System	Type	Living areas	Bed rooms	
	1 Phase Air conditioning: Day / Night Zoned	2.5 star (average zone)	2.5star (average zone)	
Artificial Lighting	Primary type of artificial lighting is fluorescent or light emitting diode (LED)			
	No. of Bed rms & study	No. of Living	Each Kitchen, Bath / Toilet	L'dry & Hallway
	All	All	Yes	Yes
Others	Indoor private Cloth Line		Not Required	
	Outdoor or sheltered Cloth Line		Yes	
	Well ventilated Fridge space		Yes	
	Kitchen Cook top / Oven		Gas Cook top + Electric Oven	
THERMAL	As per thermal simulation carried out by assessor			
(refer assessor's stamped drawings)	External Wall Insulation: R2.8			
	Ceiling Insulation: R4.5			
	Roof type / colour : Metal roof, Medium Colour (SA 0.475 - 0.7) + SS Foil (R1.3)			
	ALM-002-01 A: Aluminium B SG Clear / tint U=6.6 SHGC =0.441 - 0.539			
	All External doors & windows to be weather sealed			
	Eaves / shading as per drawings			



1 LOCATION PLAN




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NOTE
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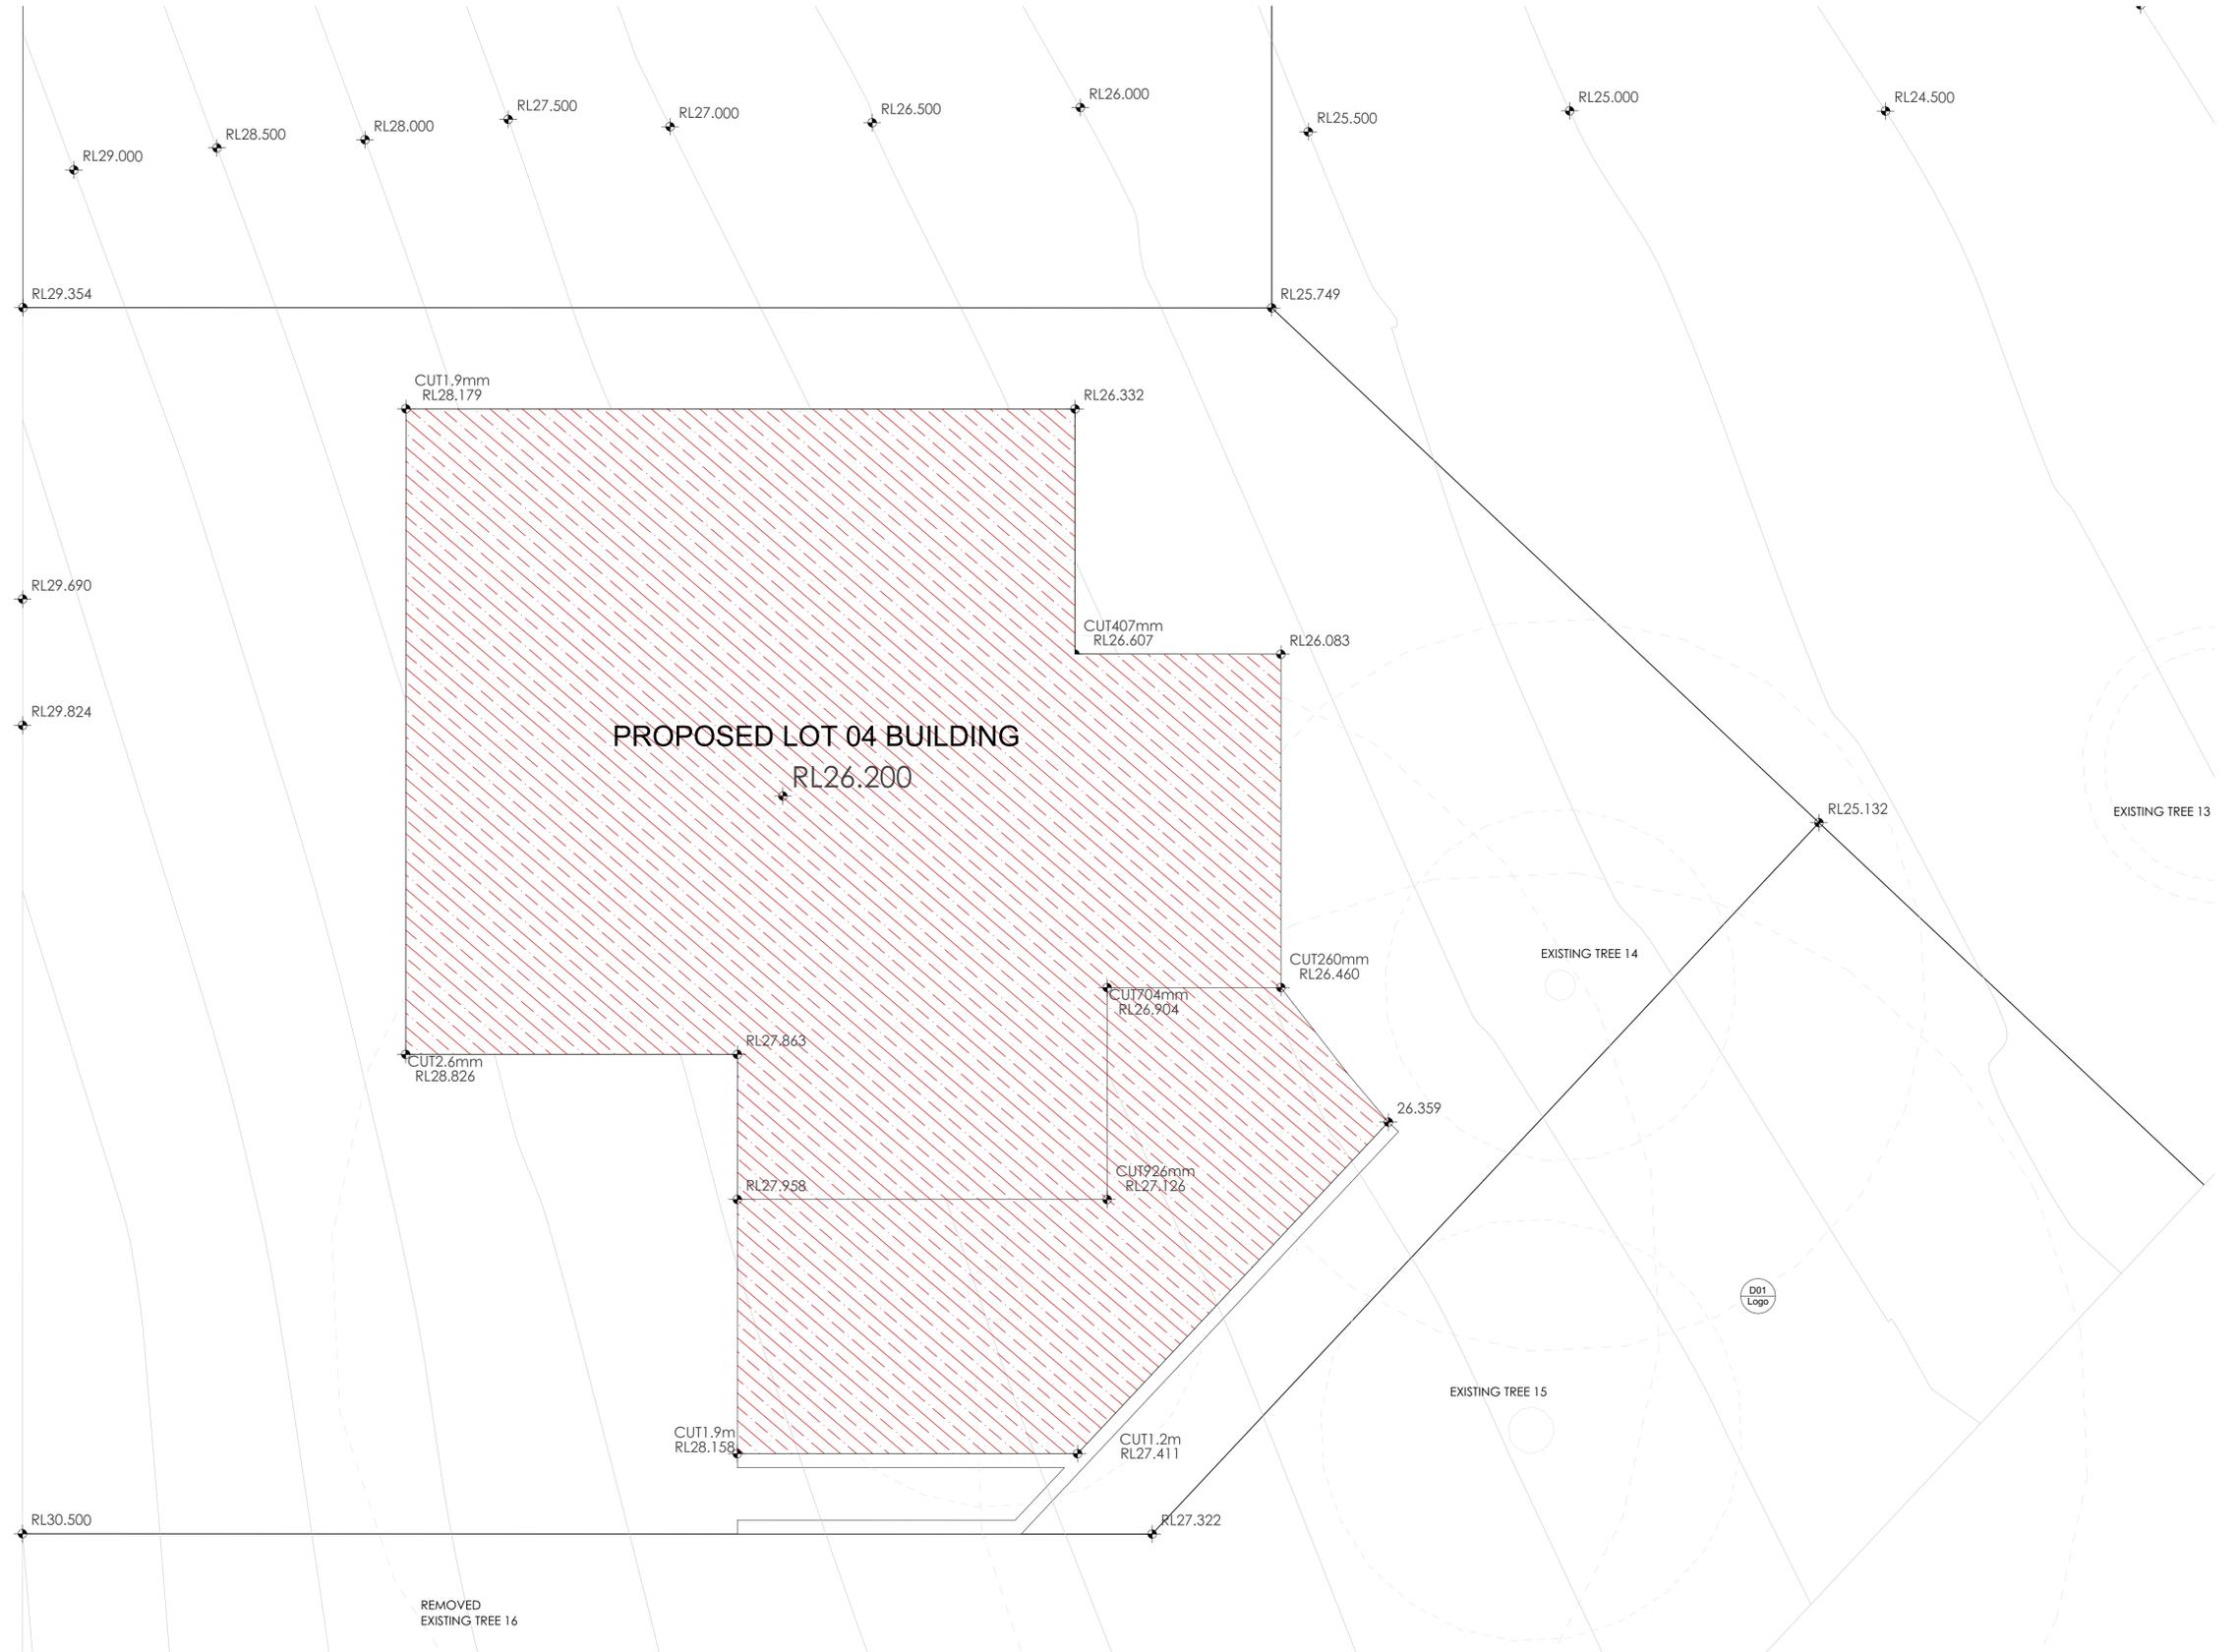
REV	DESCRIPTION	BY	CHK	DATE	REV	DESCRIPTION	BY	CHK	DATE
A	DEVELOPMENT APPLICATION				DL	KC/PI	08.11.21		
B	SURVEY ISSUE				DL	GF/PI	11.11.21		

CLIENT
SKYCORP AUSTRALIA

PROJECT
LOT03, 10 FERN CREEK ROAD, WARRIWOOD
 DRAWING
LOCATION PLAN



DRAWN	DL, KC	CHECKED	PI / KC
PROJECT No	P563	SCALE	1:1000@A1
B	DA	010	B
disc	stage	chwg no.	revision

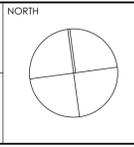

1 CUT & FILL PLAN
1:50



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 A/N 60 050 071 022


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A	DEVELOPMENT APPLICATION	DL	KC/PI	08.11.21	CLIENT
B	SURVEY ISSUE	DL	GF/PI	11.11.21	SKYCORP AUSTRALIA

PROJECT	NORTH
LOT03, 10 FERN CREEK ROAD, WARRIEWOOD	
DRAWING	
CUT & FILL PLAN	

DRAWN	DL, KC	CHECKED	PI / KC
PROJECT No	P563	SCALE	1:50@A1
B	DA	020	B
dsc	stage	chwg no.	revision



0 SITE ANALYSIS PLAN
1:100

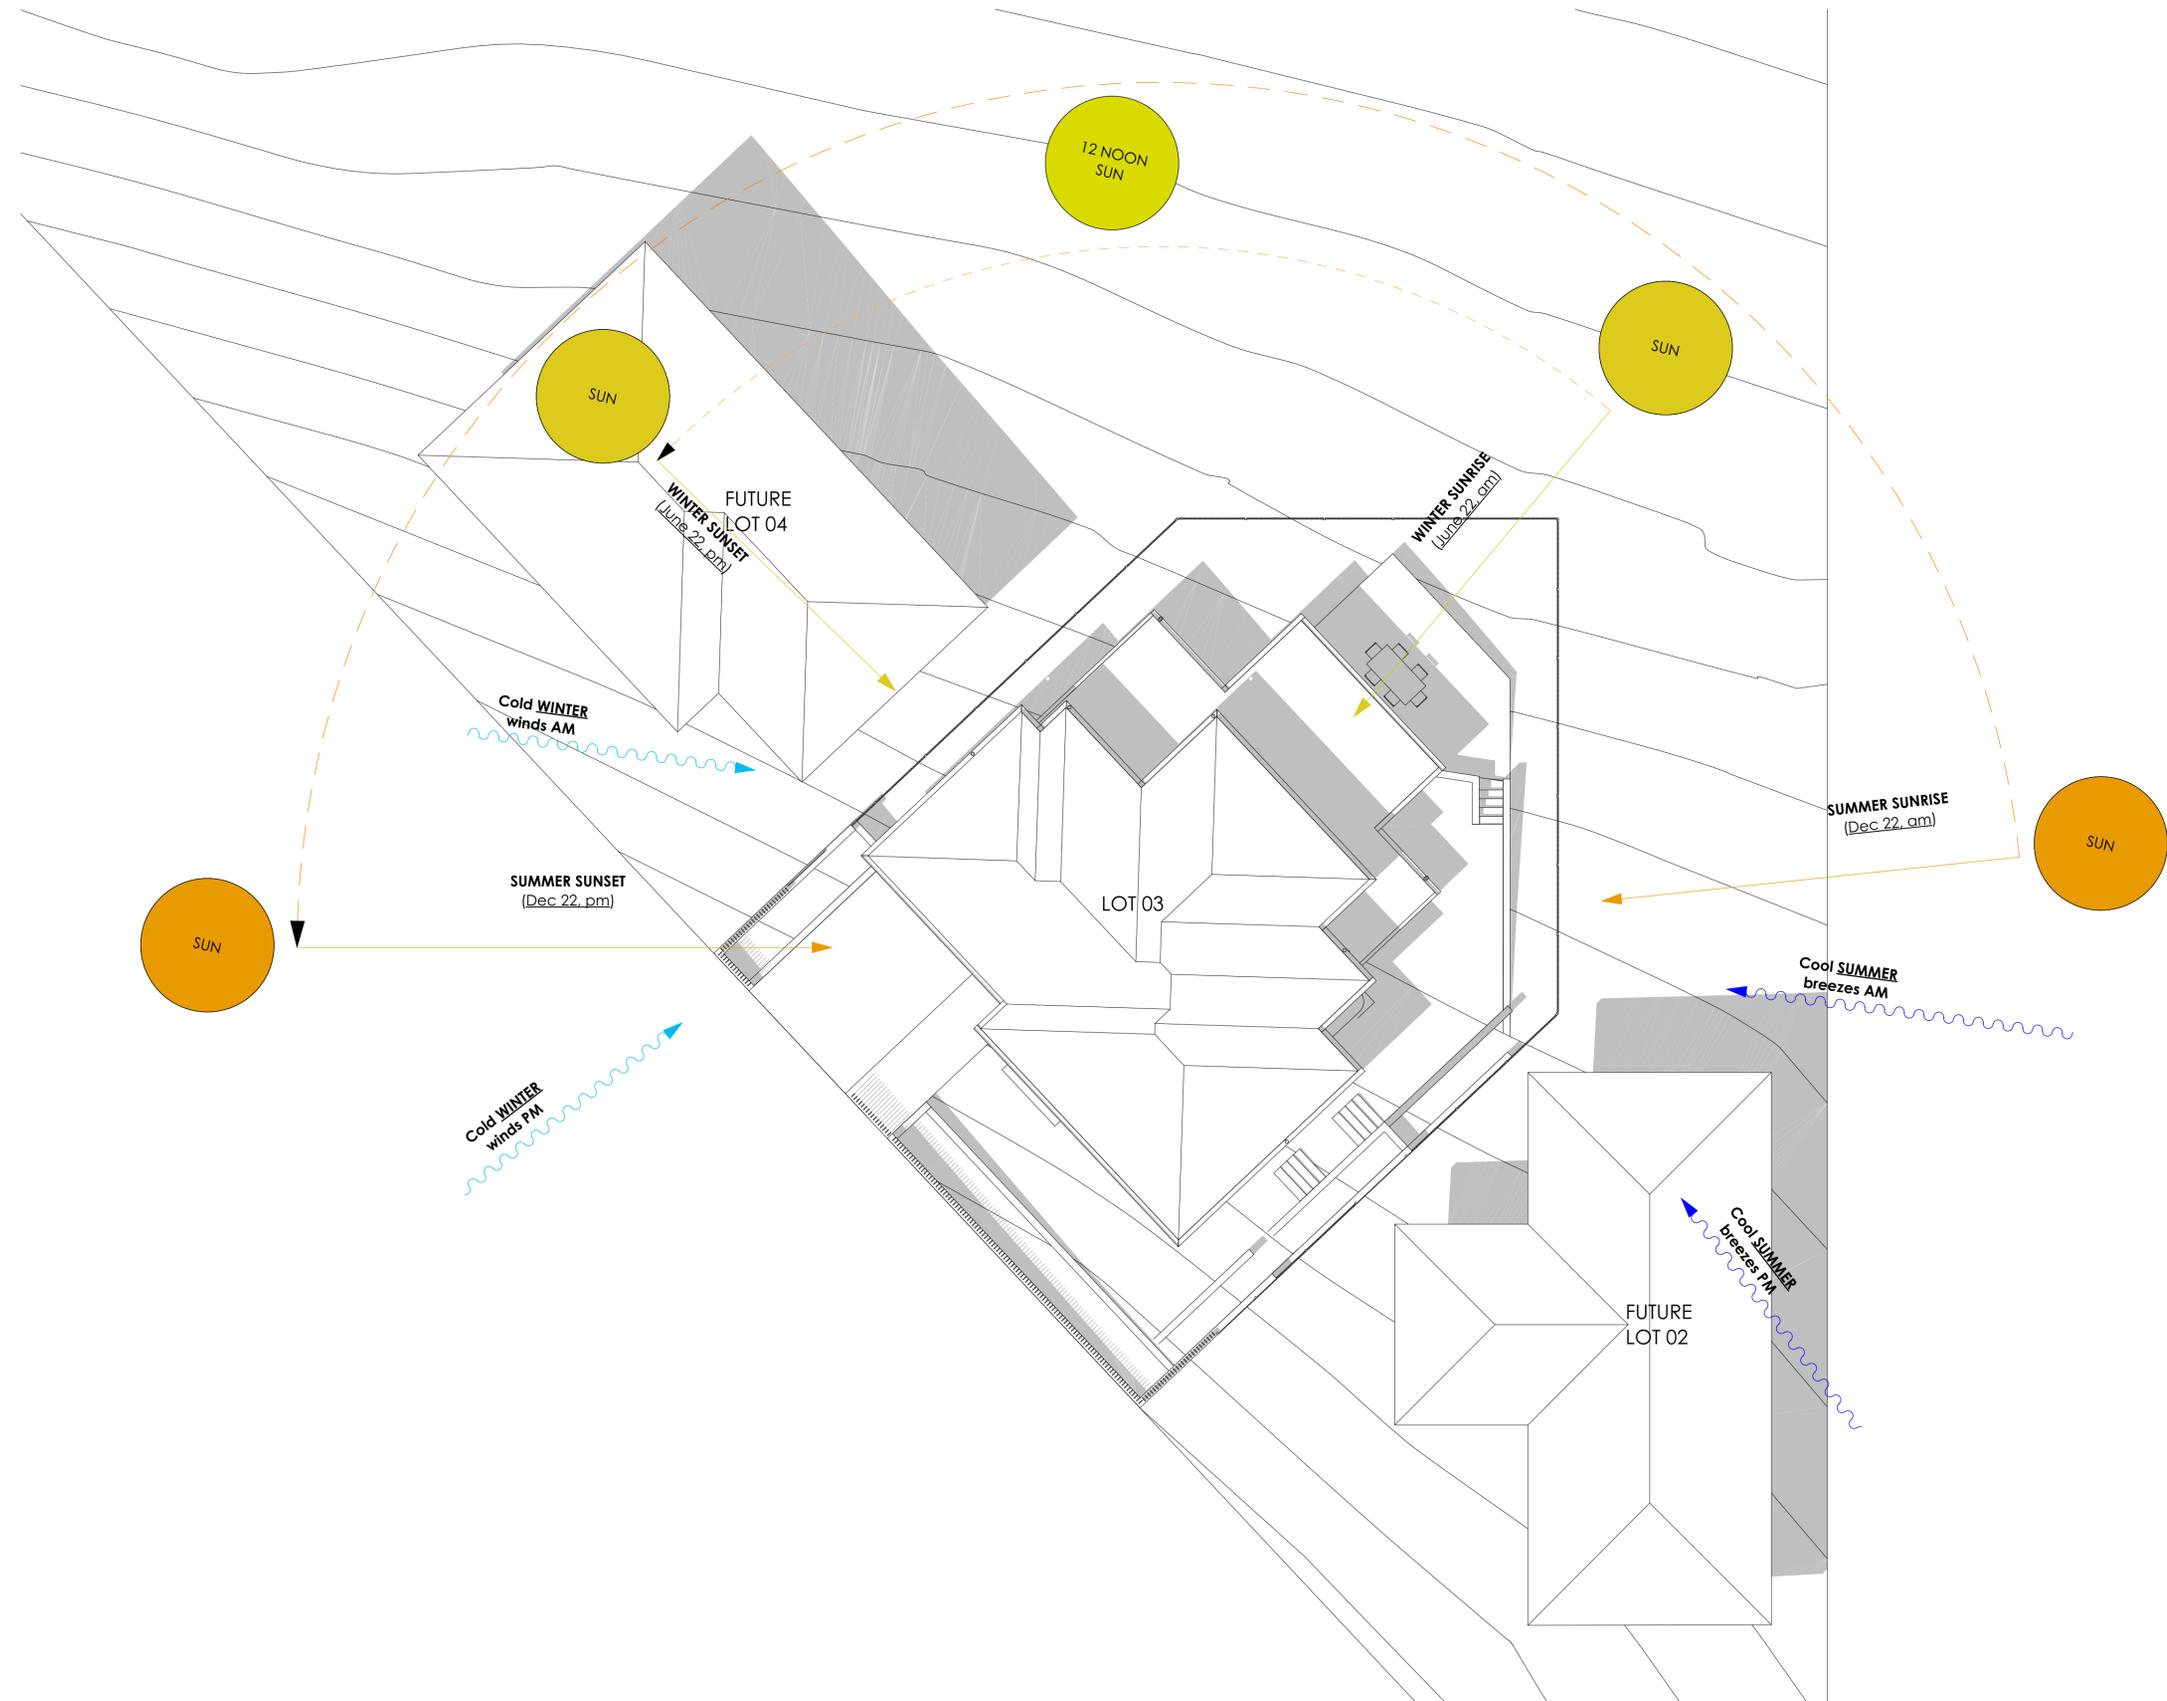pt ARCHITECTURE
Tourism • Residential

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ABN 60 050 071 022

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PROJECT	NORTH
LOT03, 10 FERN CREEK ROAD, WARRIEWOOD	
DRAWING	
SITE ANALYSIS	

DRAWN	DL, KC	CHECKED	PI / KC
PROJECT No	P563	SCALE	1:100@A1
B	DA	050	B
disc	stage	chwg no.	revision




1 LOWER GROUND PLAN
1:50

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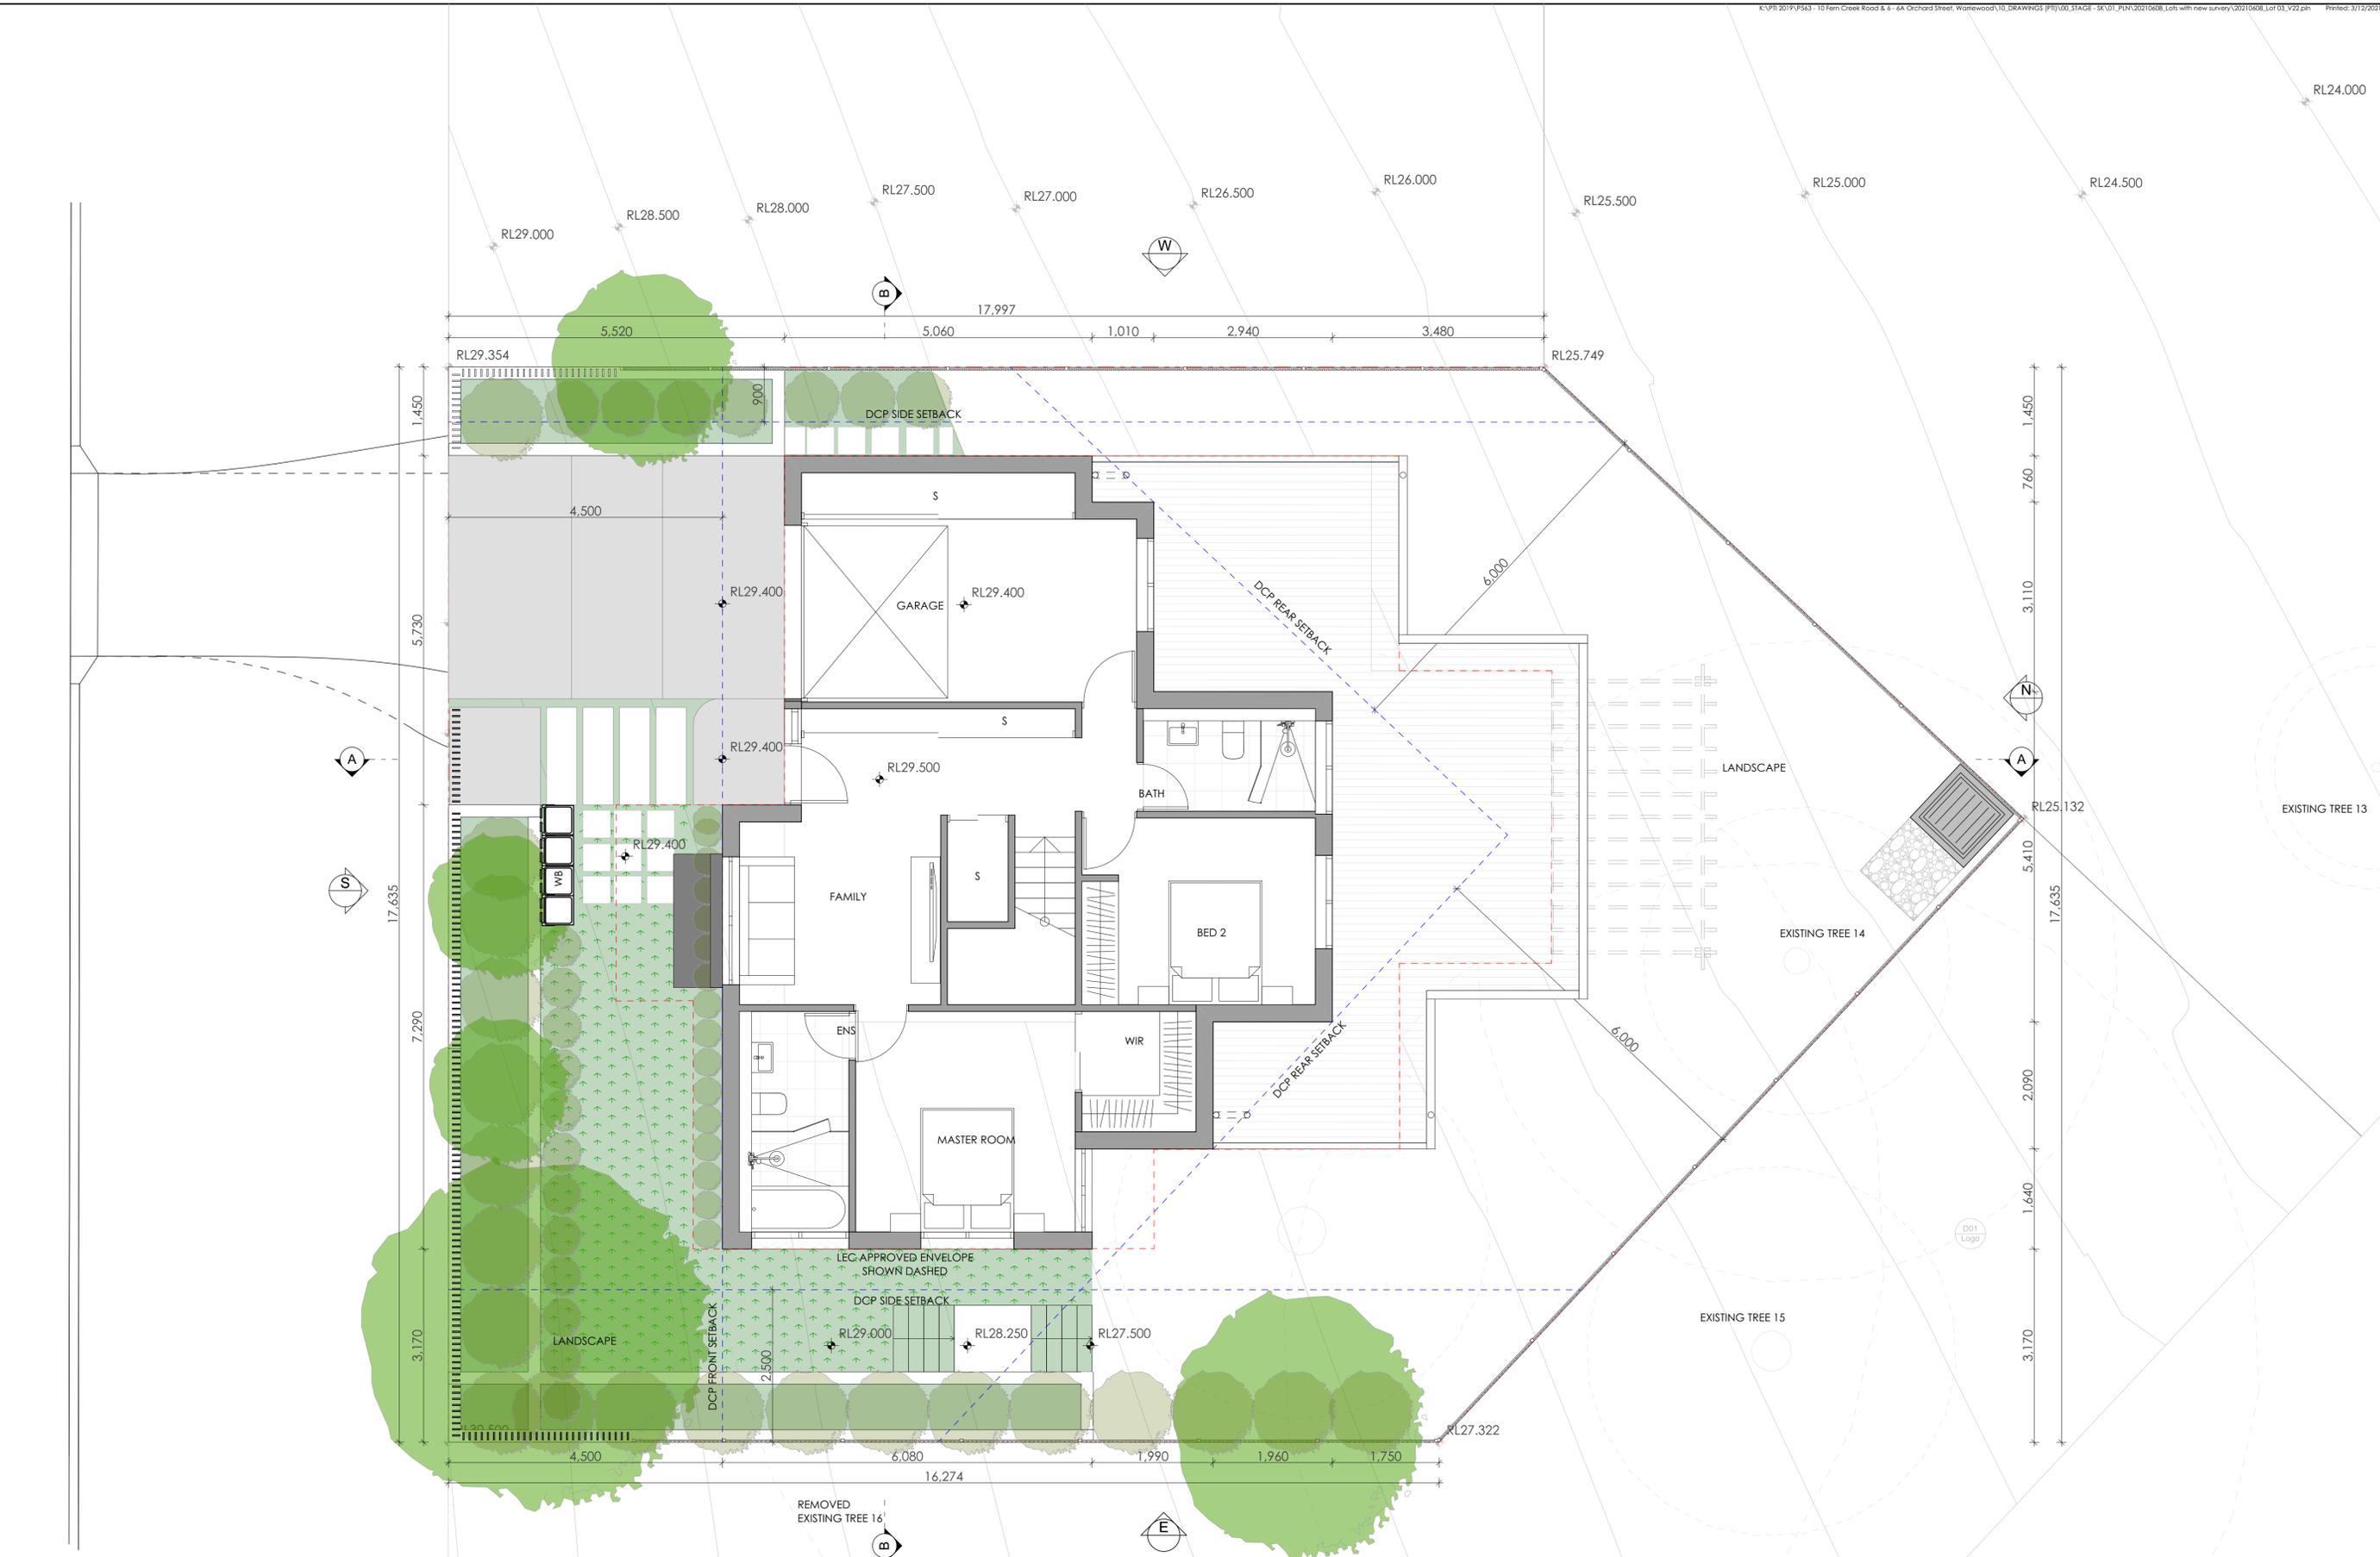
PROJECT
LOT03, 10 FERN CREEK ROAD, WARRIEWOOD
 DRAWING
LOW GROUND FLOOR PLAN



DRAWN	DL, KC	CHECKED	PI / KC
PROJECT No	P563	SCALE	1:50@A1
B	DA	120	B
dsc	stage	chng no.	revision

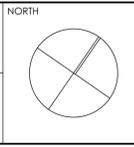

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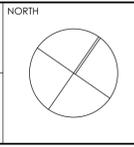
1 GROUND FLOOR PLAN
1:50

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B	SURVEY ISSUE								

DL	KC/PI	08.11.21	CLIENT
DL	GF/PI	11.11.21	SKYCORP AUSTRALIA

PROJECT
LOT03, 10 FERN CREEK ROAD, WARRIWOOD
 DRAWING
GROUND FLOOR PLAN



DRAWN	DL, KC	CHECKED	PI / KC
PROJECT No	P563	SCALE	1:50@A1
B	DA	130	B
dsc	stage	chwg no.	revision



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10.5m DCP MAX. HEIGHT OF BUILDING

K:\PI\2019\P563 - 10 Fern Creek Road & 6 - 6A Orchard Street, Warriewood\10_DRAWINGS (PI)\00_STAGE - SK\01_PLM\20210608_Lots with new survey\20210608_Lot 03_V22.ph Printed: 3/12/2021



W WESTELEVATION 1:50



E EAST ELEVATION 1:50




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B	SURVEY ISSUE	DL	GF/PI	11.11.21		

PROJECT	LOT03, 10 FERN CREEK ROAD, WARRIWOOD
DRAWING	ELEVATION



DRAWN	DL, KC	CHECKED	PI / KC
PROJECT No	P563	SCALE	1:100@A1
B	DA	200	B
disc	stage	chg no.	revision

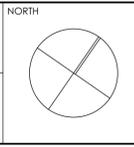

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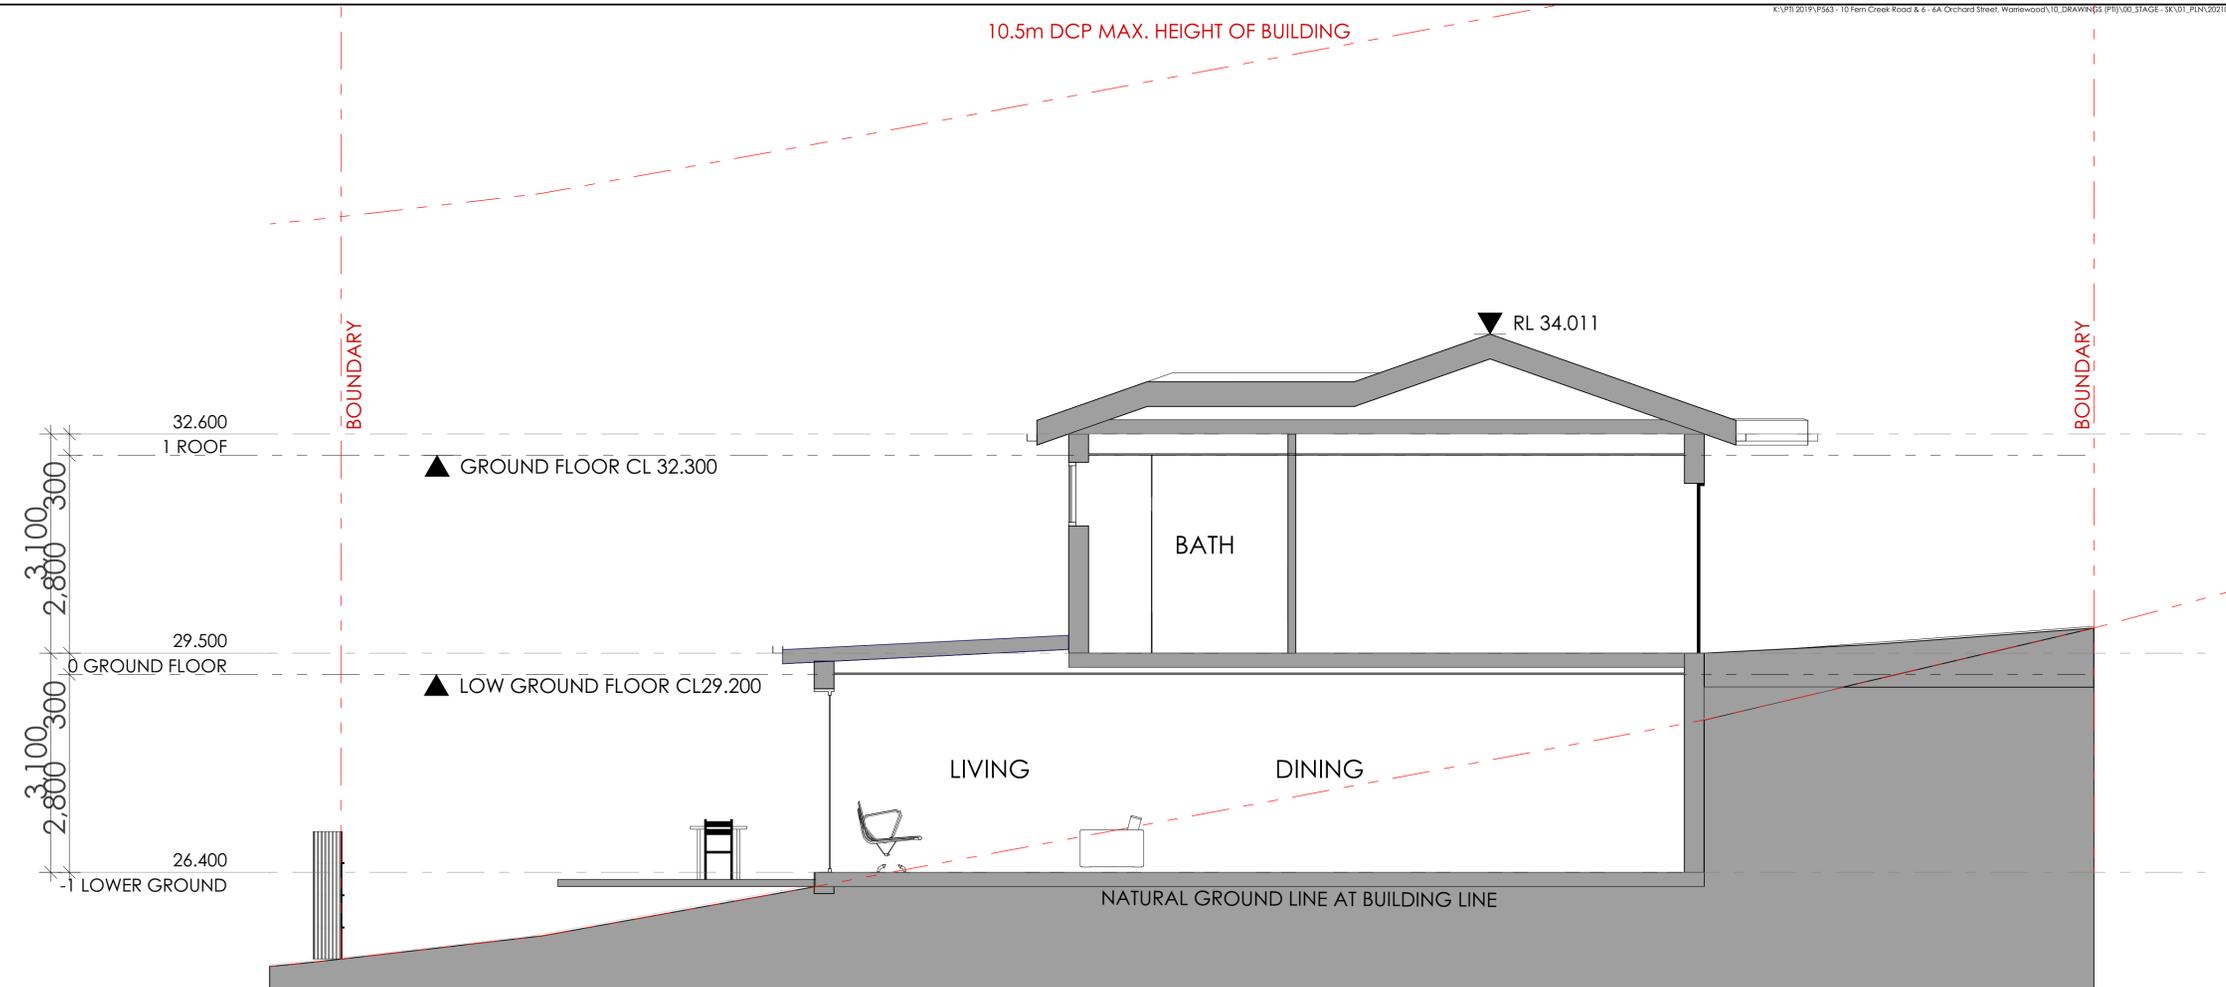
REV	DESCRIPTION	BY	CHK	DATE	REV	DESCRIPTION	BY	CHK	DATE

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B	SURVEY ISSUE	DL	GF/PI	11.11.21	SKYCORP AUSTRALIA


PROJECT	NORTH
LOT03, 10 FERN CREEK ROAD, WARRIEWOOD	
DRAWING	
ELEVATION	

DRAWN	DL, KC	CHECKED	PI / KC
PROJECT No	P563	SCALE	1:100@A1
B	DA	210	B
dsc	stage	chwg no.	revision

10.5m DCP MAX. HEIGHT OF BUILDING



A SECTION A
1:50

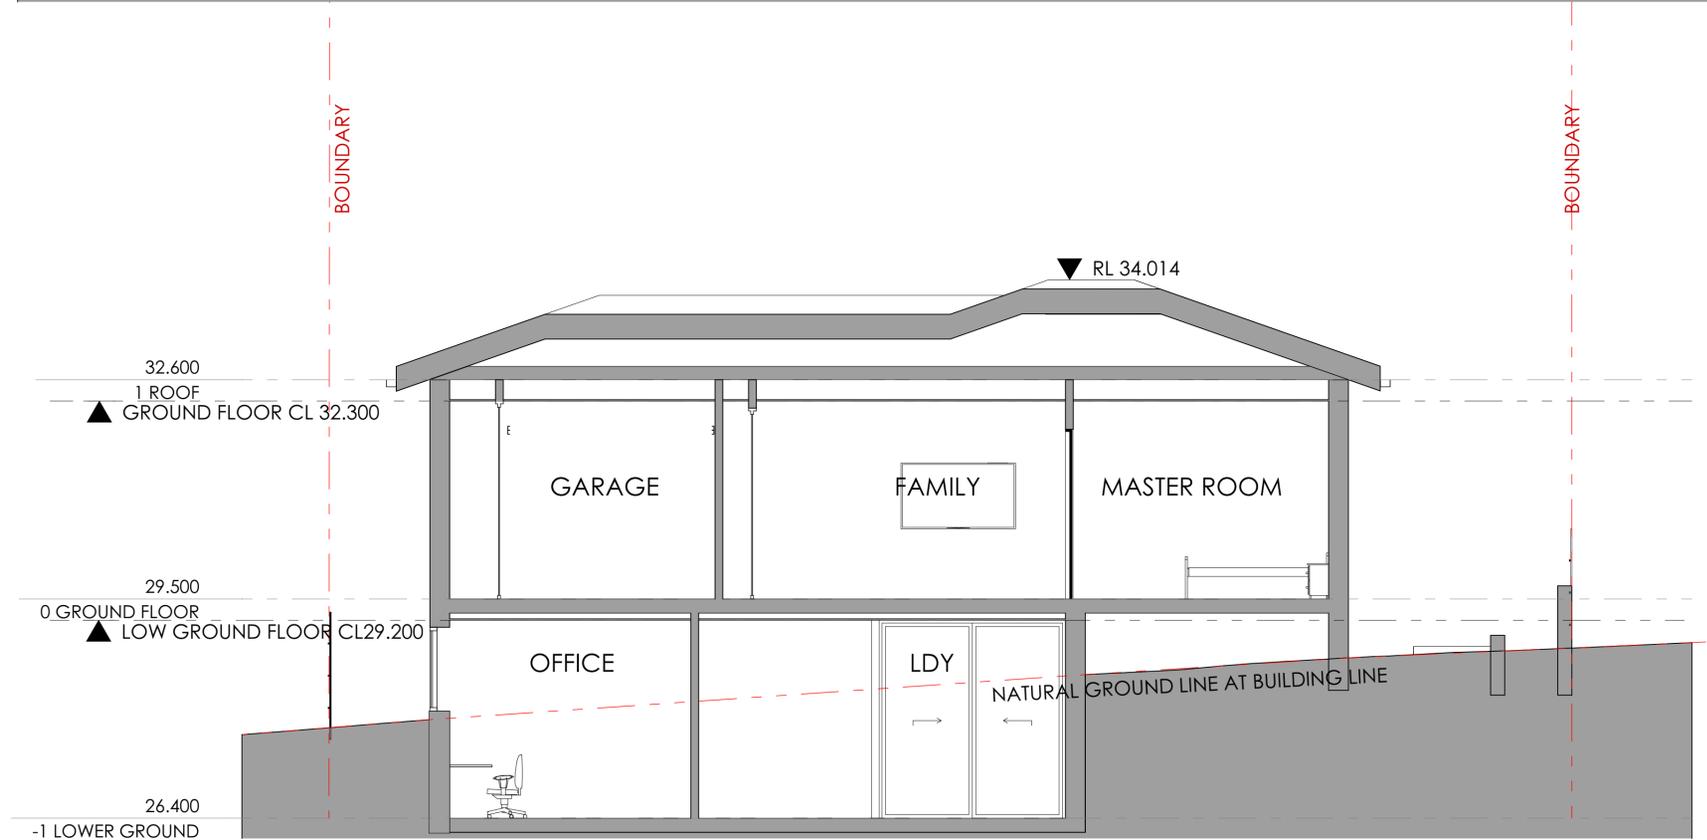

B SECTION B
1:50



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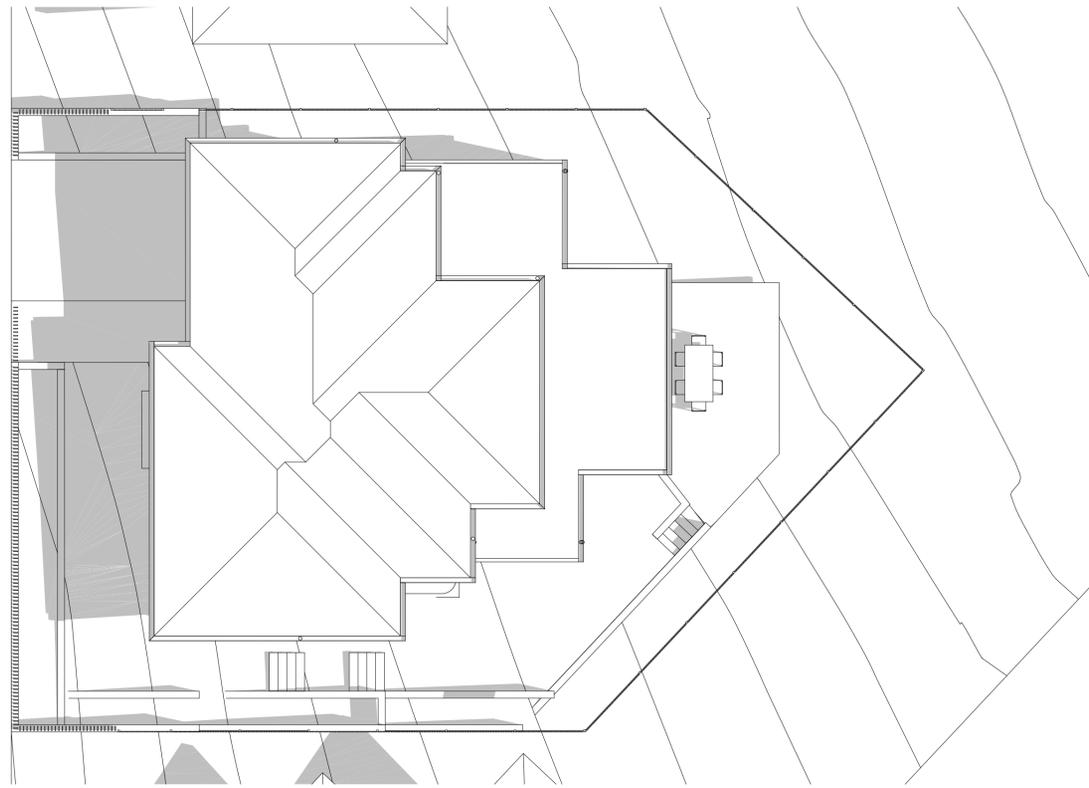
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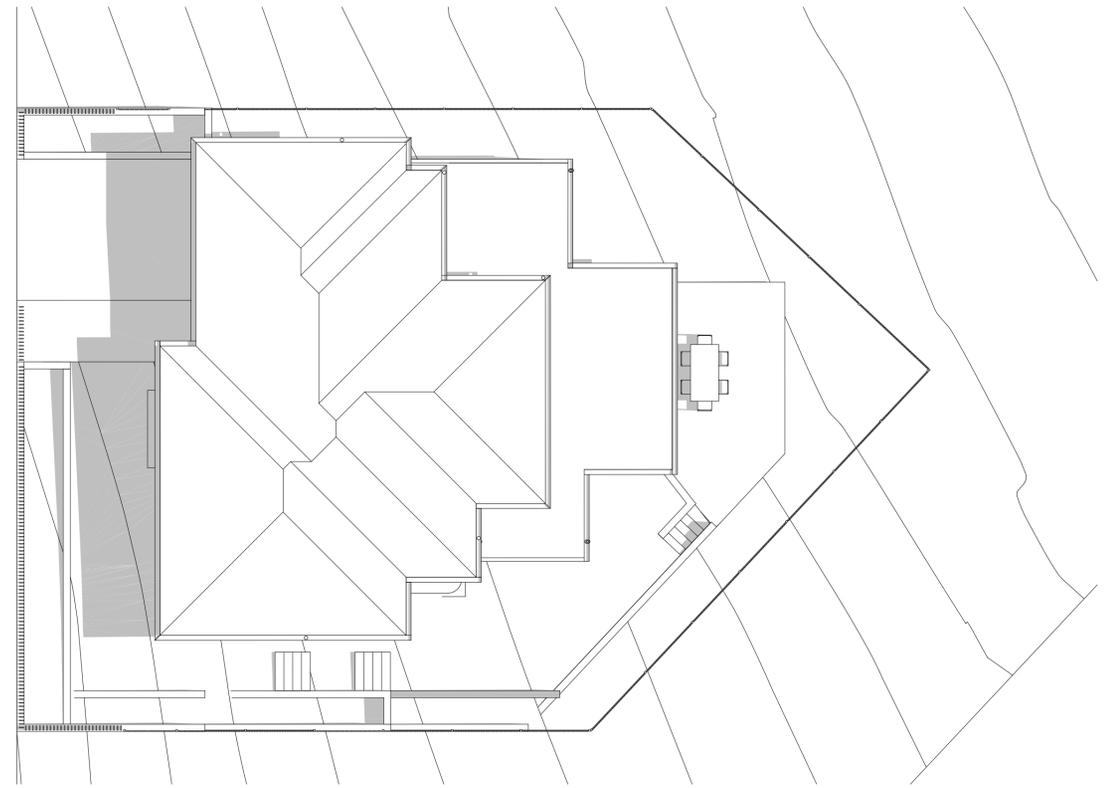
DEVELOPMENT APPLICATION SURVEY ISSUE	DL DL	KC/PI GF/PI	08.11.21 11.11.21	CLIENT SKYCORP AUSTRALIA
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PROJECT LOT03, 10 FERN CREEK ROAD, WARRIWOOD	NORTH
DRAWING SECTION	

DRAWN DL, KC	CHECKED PI / KC
PROJECT No P563	SCALE 1:100@A1
B DA 300 B	
disc	stage
chwg no.	revision



1 SHADOW DIAGRAM JUNE 21 9AM
1:100



2 SHADOW DIAGRAM JUNE 21 10AM
1:100



3 SHADOW DIAGRAM JUNE 21 11AM
1:100



4 SHADOW DIAGRAM JUNE 21 12PM
1:100




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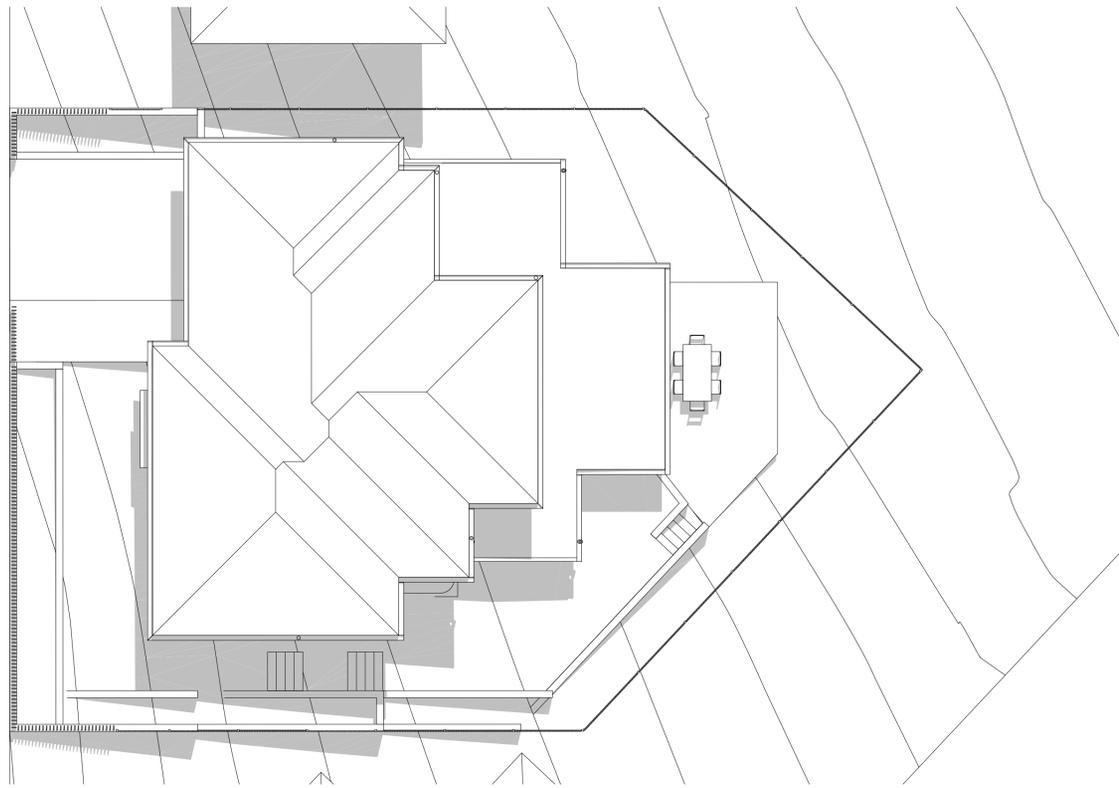
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A	DEVELOPMENT APPLICATION				DL	KC/PI	08.11.21		
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CLIENT
SKYCORP AUSTRALIA


PROJECT
**LOT03, 10 FERN CREEK ROAD,
 WARRIEWOOD**
 DRAWING
SHADOW DIAGRAM




DRAWN	DL, KC	CHECKED	PI / KC
PROJECT No	P563	SCALE	1:100@A1
B	DA	500	B
disc	stage	chwg no.	revision

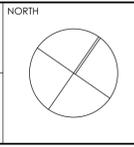

5 SHADOW DIAGRAM JUNE 21 1PM
1:100

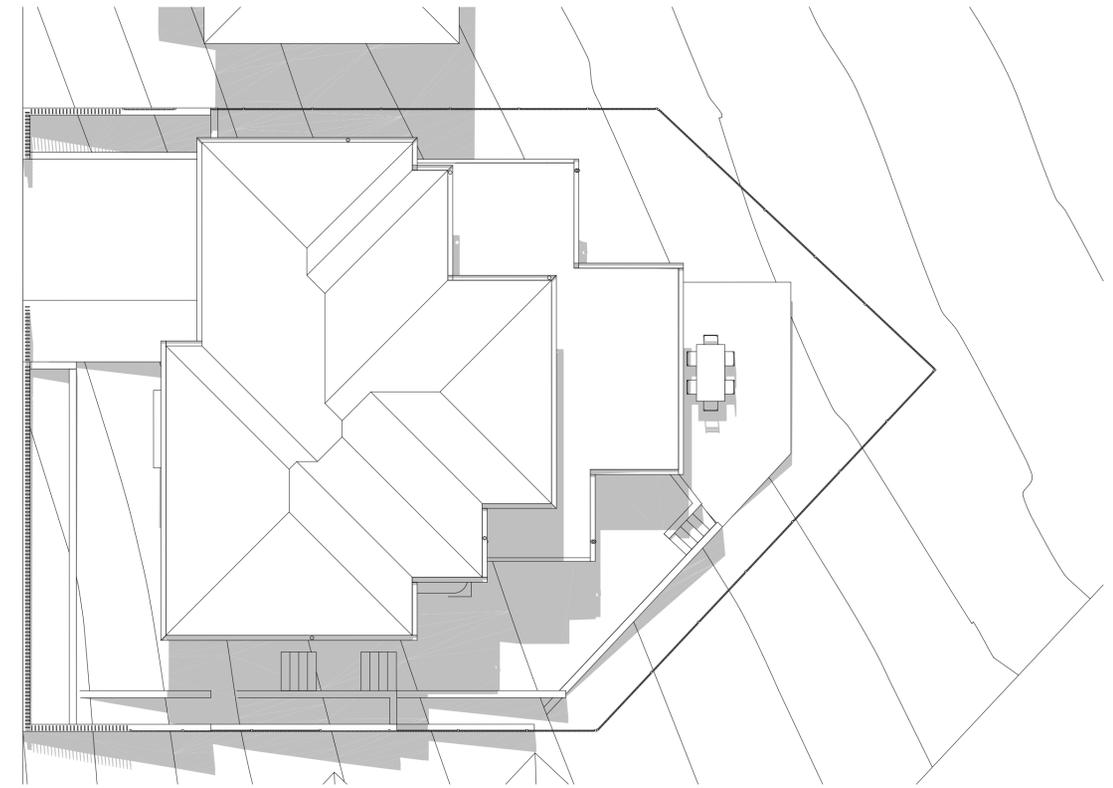

6 SHADOW DIAGRAM JUNE 21 2PM
1:100

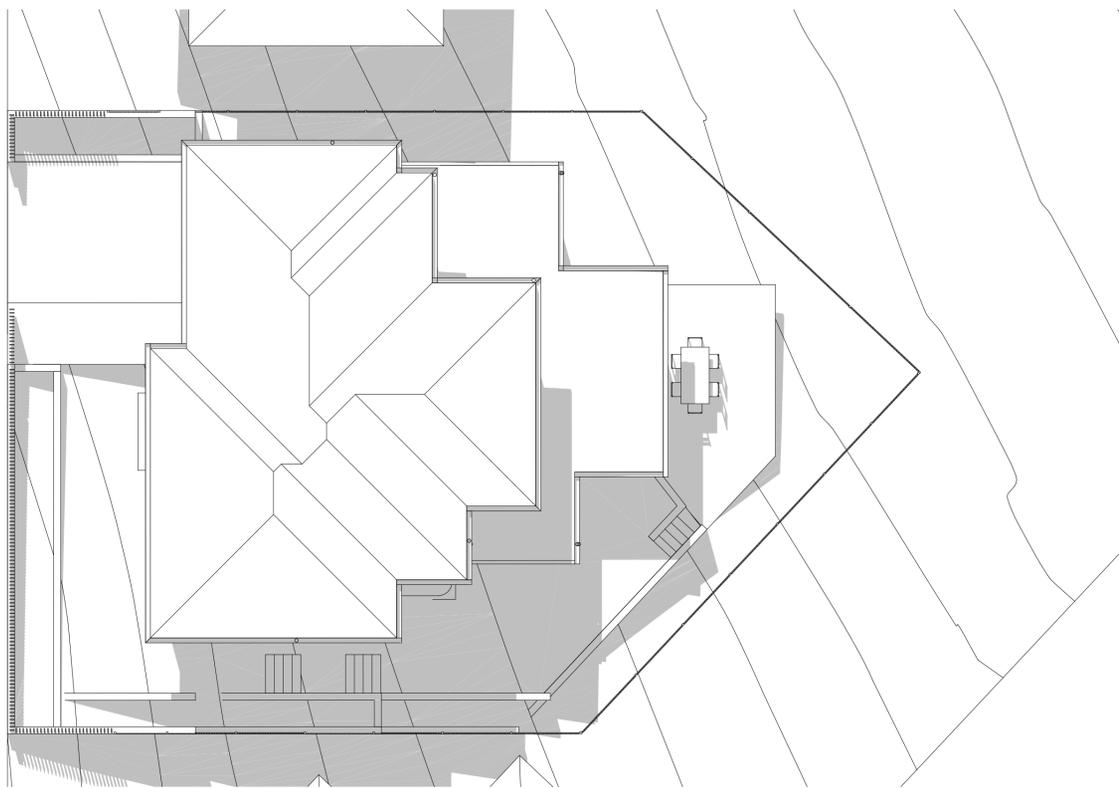

7 SHADOW DIAGRAM JUNE 21 3PM
1:100



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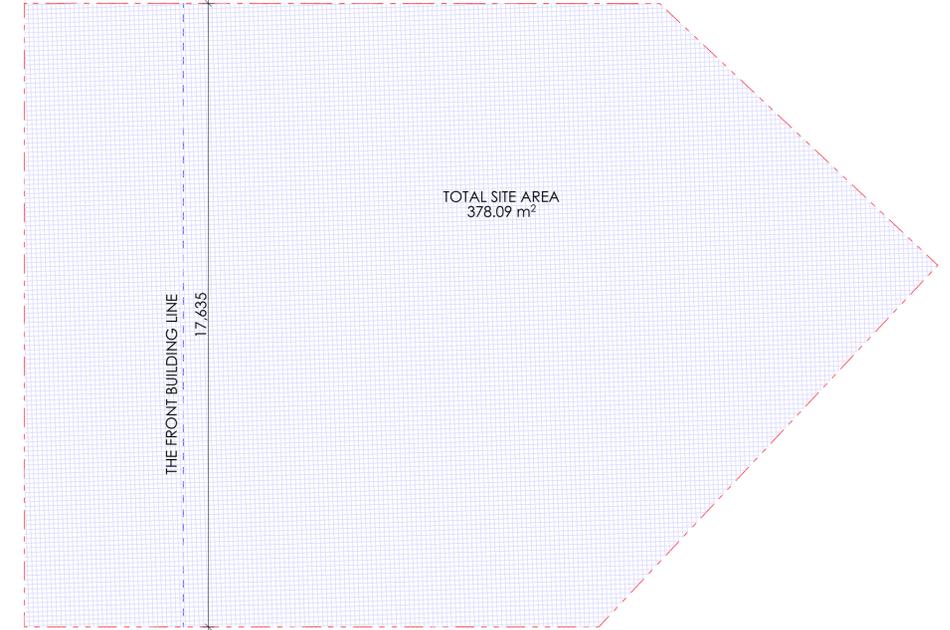
DL	KC/PI	08.11.21	CLIENT
DL	GF/PI	11.11.21	SKYCORP AUSTRALIA

PROJECT	NORTH
LOT03, 10 FERN CREEK ROAD, WARRIEWOOD	
DRAWING	
SHADOW DIAGRAM	


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PROJECT No	P563	SCALE	1:100@A1
B	DA	510	B
dsc	stage	chwg no.	revision

PROJECT INFORMATION - DEVELOPMENT APPLICATION		
SITE AREA (LOT 04) 378.1m ²	m/m ²	COMPLIANCE
PERMISSIBLE GFA	N/A	Y
PROPOSED GFA	165.78m ²	
LOT WIDTH AT FRONT BUILDING LINE	17.6m	Y
LANDSCAPE		
REQUIRED LANDSCAPING AREA (45% OF SITE AREA)	170.1m ²	Y
PROPOSED LANDSCAPING TOTAL AREA	188.83m ²	
PROPOSED COMPLIANT LANDSCAPE AREA	157.28m ²	
PROPOSED NON COMPLIANT LANDSCAPE AREA	31.55m ²	
PRIVATE OPEN SPACE		
REQUIRED PRIVATE OPEN SPACE	24m ²	Y
PROPOSED PRIVATE OPEN SPACE	24.02m ²	


-  PROPOSED SITE AREA
-  PROPOSED GROSS FLOOR AREA
-  PROPOSED ARTICULATION ZONE
-  PROPOSED PRIVATE OPEN SPACE
-  PROPOSED COMPLIANT LANDSCAPE AREA
-  PROPOSED NON COMPLIANT LANDSCAPE AREA
-  PROPOSED AREA EXCLUDED



0 SITE AREA PLAN
1:100

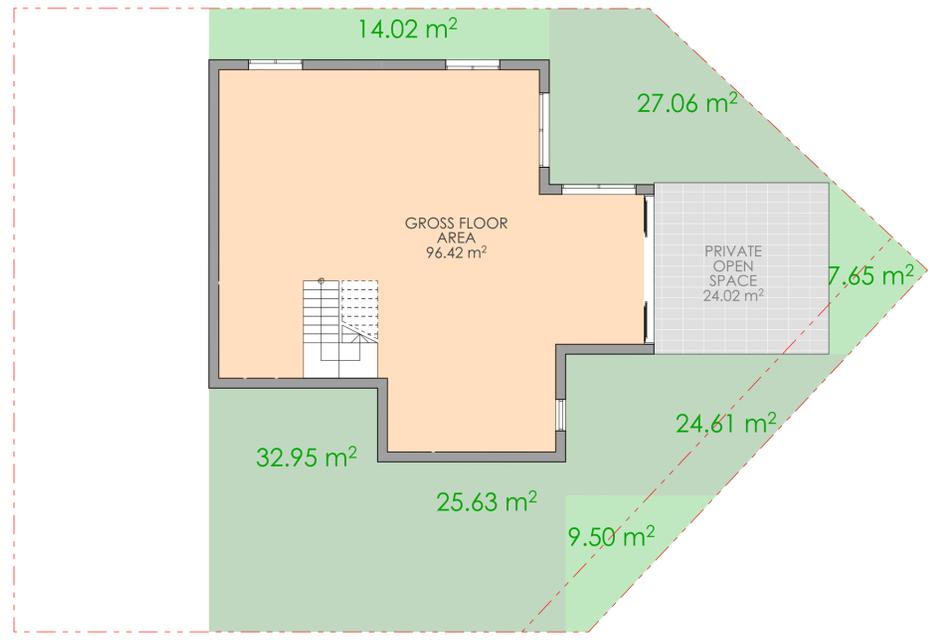


1 LOW GROUND FLOOR AREA PLAN
1:100

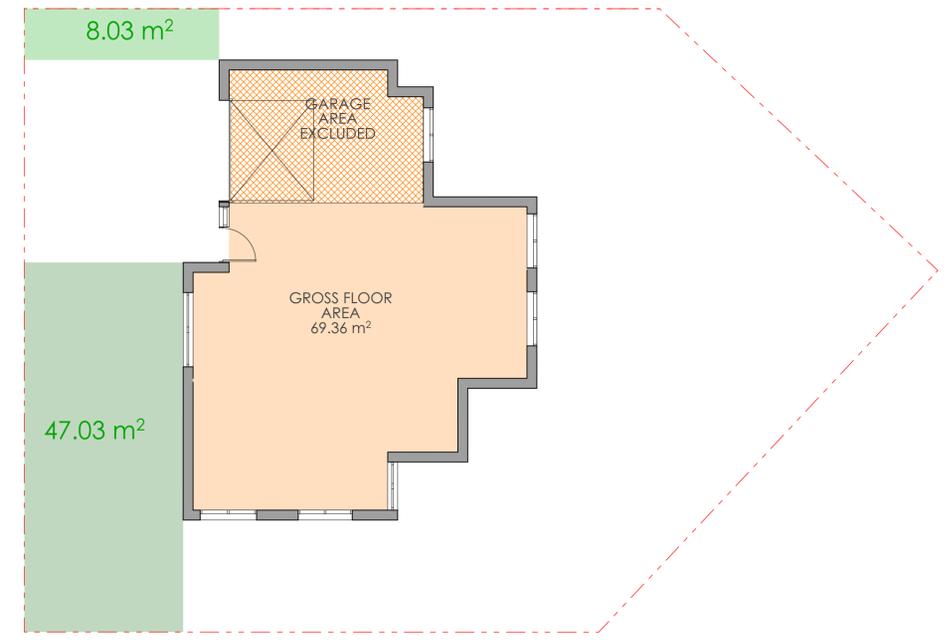

2 GROUND FLOOR AREA PLAN
1:100

REV	DESCRIPTION	BY	CHK	DATE	REV	DESCRIPTION	BY	CHK	DATE

DEVELOPMENT APPLICATION SURVEY ISSUE				CLIENT	
DL	KC/PI	08.11.21	DL	GF/PI	11.11.21
				SKYCORP AUSTRALIA	

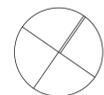PROJECT		NORTH	
LOT03, 10 FERN CREEK ROAD, WARRIWOOD			
DRAWING: AREA CALCULATION			

DRAWN		CHECKED	
DL, KC	PI / KC		
PROJECT No P563	SCALE 1:100@A1		
B	DA 600	B	
disc	stage	chwg no.	revision



1. AUSTRAL BRICKS BRAHMA GRANITE



2. POWDER COATED ALUMINIUM FRAMED GLAZING



3. COLORBOND MONUMENT METAL ROOF



4. AUSTRAL BRICKS MAJESTIC GREY



5. RENDER & PAINT - DULUX WAYWARD GREY

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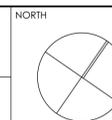
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					B	SURVEY ISSUE	DL	GF/PI	11.11.21

CLIENT
SKYCORP AUSTRALIA

PROJECT
**LOT03, 10 FERN CREEK ROAD,
WARRIWOOD**

DRAWING
EXTERNAL FINISH SCHEDULE



DRAWN	DL, KC	CHECKED	PI / KC
PROJECT No	P563	SCALE	1:100, 1:500@A1
B	DA	700	B
disc	stage	dwg no.	revision


NOTE: FOR OWNER/BUILDER/PLUMBER
REGULAR 2 MONTHLY MAINTENANCE IS REQUIRED
TO ALL PITS. OWNER/BUILDER/TENANT TO ENSURE
ALL PITS ARE CLEANED.

NOTE: BASIX REQUIREMENTS
ENSURE MINIMUM ROOF CATCHMENT
AREA DRAINS TO ABOVE GROUND
RAINWATER TANK. REFER BASIX
REPORT AND REQUIREMENTS

NOTE: BASIX REQUIREMENTS
MINIMUM RAINWATER TANK CAPACITY = 2000L
PROVIDED RAINWATER TANK CAPACITY = 3000L
MINIMUM COLLECTED ROOF RUNOFF = 100sqm
PROVIDED COLLECTED ROOF RUNOFF = 106sqm

NOTE SERVICES
APPROXIMATE LOCATIONS OF
EXISTING SERVICES SHOWN EXACT
LOCATIONS & DEPTHS TO BE
ACCURATELY LOCATED BY BUILDER
CONTRACTOR BY CONTACTING THE
RELEVANT AUTHORITIES BEFORE
COMMENCEMENT OF ANY WORKS

NOTE:
ANY PUMP INSTALLED
FOR THE RAINWATER
TANKS IS TO BE NO
LOUDER THAN 5dB(A)
ABOVE BACKGROUND
NOISE LEVELS

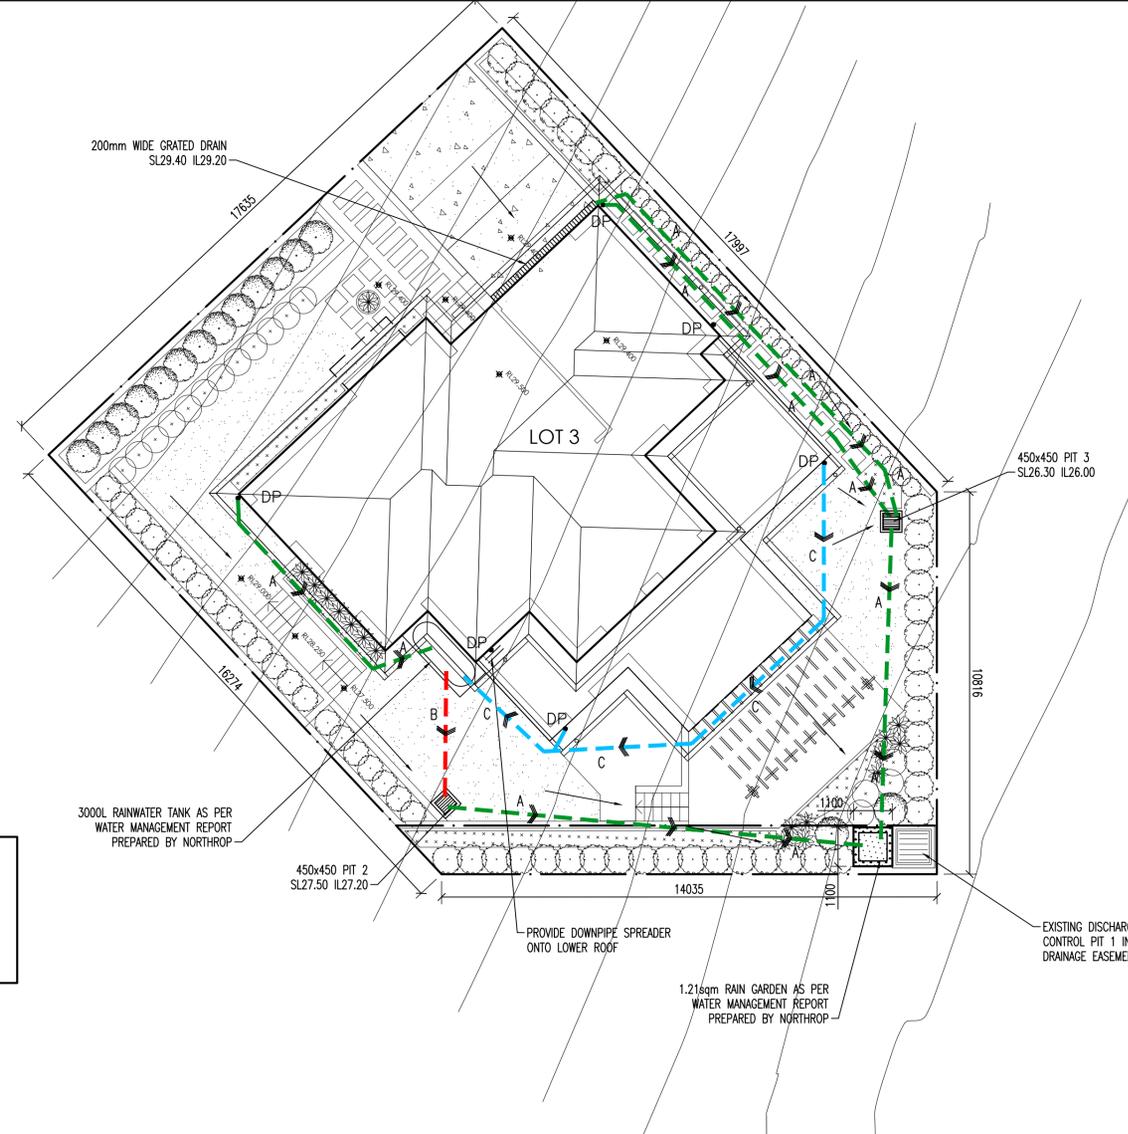

DRAINAGE LAYOUT PLAN
SCALE : 1:100

* NEW LEVEL
• EXISTING LEVEL

PLEASE NOTE
AN IMPERMEABLE LINER SUCH AS BIDIM A44 GEO-FABRIC MUST BE
INSTALLED AT THE BASE
(AND UP THE EDGES) OF THE RAIN GARDEN TO STOP GROUND WATER
FILTERING INTO SURROUNDING SOIL
NOTING THE LANDSLIDE RISK EVIDENT PRIMARILY LINKED TO
GROUNDWATER.

WATER SENSITIVE URBAN DESIGN ELEMENTS FORM PART OF THIS PROJECT
- RAIN GARDEN AND RAINWATER REUSE TANK
- REUSE OF TANK IN ACCORDANCE WITH BASIX REQUIREMENTS OR AS PER
COUNCIL REQUIREMENTS

RAIN GARDEN:
PROVIDED RAIN GARDEN AREA: 1.21m²



LEGEND

RL 00.000	NEW REDUCED LEVEL
GFL 00.00	GROUND FLOOR LEVEL
FFL 00.00	FINISH FLOOR LEVEL
A,B,C,D, etc.	REFER TO PIPE SCHEDULE
L1	PIPE LABEL
PIT P1	SURFACE INLET PIT
● DP	DOWNPIPE
□ RWH	RAIN WATER HEAD
[Symbol]	PIT: SIZE AS MARKED
[Symbol]	SEALED PIT: SIZE AS MARKED
[Symbol]	W:200mm x D:200mm GRATED DRAIN
[Symbol]	GROUND FALL
[Symbol]	OVERLAND FLOW
[Symbol]	100mm UPVC CHARGED LINE
[Symbol]	DRAINAGE PIPE IN GROUND
[Symbol]	RAINWATER TANK OVERFLOW PIPE

- NOTES**
- THESE DRAWINGS ARE TO BE READ IN CONJUNCTION WITH THE ARCHITECTURAL DRAWINGS, STRUCTURAL DRAWINGS AND THE SPECIFICATION.
 - PRIOR TO COMMENCEMENT OF WORKS THE CONTRACTOR SHALL SATISFY HIMSELF OF THE CORRECT LOCATION OF EXISTING SERVICES WHETHER INDICATED OR NOT ON THE PLANS. ANY DAMAGE TO EXISTING SERVICES SHALL BE RECTIFIED AT THE CONTRACTOR'S EXPENSE.
 - TRAFFIC MANAGEMENT MEASURES HAVE TO BE IMPLEMENTED AND MAINTAINED DURING CONSTRUCTION, ALL IN ACCORDANCE WITH COUNCIL'S REQUIREMENTS. THE CONTRACTOR SHALL MAINTAIN SAFE PEDESTRIAN ACCESS ALONG THE FOOTPATH.
 - THE CONTRACTOR SHALL EFFECT TEMPORARY DRAINAGE MEASURES TO AVOID LOCALISED PONDING OF SURFACE RUN-OFF.
 - REFER TO ARCHITECT'S DRAWINGS FOR ALL DETAILS (LEVELS, GRADING ETC.) OF DRIVEWAYS, CONCRETE AND PAVED AREAS, AND RETAINING WALL TYPES AND LOCATIONS.
 - REFER TO LANDSCAPE ARCHITECT'S DRAWINGS FOR DETAILS AND EXTENT OF ALL LANDSCAPED AREAS.
 - ALL SWD PIPES ARE UPVC AT 1.0% MINIMUM GRADE (UNO).
 - SWD PITS CAN BE PRE-CAST SIZED AS FOLLOWS:
450mm SQ. UP TO 600mm DEEP
600mm SQ. UP TO 1000mm DEEP
 - ALL PITS LOCATED IN TRAFFICABLE AREAS, (IE, DRIVEWAYS) TO HAVE MEDIUM DUTY GRATED COVERS SUITABLE FOR WITHSTANDING LOADS ASSOCIATED WITH SMALL TRUCKS.
 - PROVIDE STEP IRONS TO ALL PITS GREATER THAN 1.2m DEEP.
 - THE CONTRACTOR SHALL IMPLEMENT ALL SOIL EROSION AND SEDIMENT CONTROL MEASURES PRIOR TO COMMENCEMENT OF WORKS.
 - TOPSOIL SHALL BE STRIPPED DN STOCKPILED OUTSIDE HAZARD AREAS SUCH AS DRAINAGE LINES. THIS TOPSOIL IS TO BE RESPREAD LATER ON AREAS TO BE REVEGETATED.
 - THE CONTRACTOR SHALL REGULARLY MAINTAIN ALL SEDIMENT AND EROSION CONTROL DEVICES AND REMOVE ACCUMULATED SILT FROM SUCH DEVICES. ALL SILT REMOVED SHALL BE DISPOSED OF AS DIRECTED BY THE SUPERINTENDENT. THE PERIOD FOR MAINTAINING THESE DEVICES SHALL BE AT LEAST UNTIL ALL DISTURBED AREAS ARE REVEGETATED AND FURTHER AS MAY BE DIRECTED BY THE SUPERINTENDENT OR COUNCIL.
 - THE CONTRACTOR SHALL MAINTAIN DUST CONTROL UNTIL FINAL COMPLETION OF WORKS.

PIPE SCHEDULE
TO ALL GUTTERS

TAG	PIPE Ø	MATERIAL	Min. GRADE
A	100	PVC	1%
B	100 OVERFLOW	PVC	1%
C	100 CHARGED	PVC	-
DP	100	PVC	-

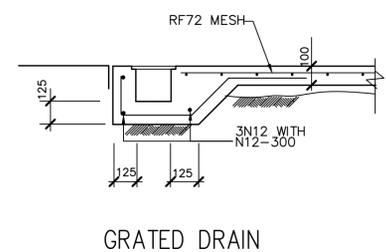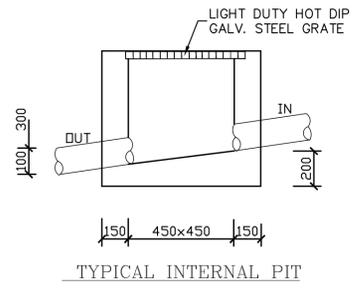

DANGER


WHEN EXCAVATING WITHIN ANY SITE, FOOTPATH AND ROADWAY, ALL SERVICES SHALL BE LOCATED PRIOR TO COMMENCEMENT OF THE EXCAVATION WORKS.

CONTACT "DIAL BEFORE YOU DIG" ON PHONE No. 1100 OR GO TO THE WEB SITE


"www.dialbeforeyoudig.com.au"

RAINWATER TANK NOTES:
RAINWATER TANK AND PIPE WORK IS TO BE PAINTED IN COLOURS MATCHING THE EXTERNAL FINISHES OF THE DWELLING AND IS TO BE NON-REFLECTIVE FINISH.

NOTE:
1. TANK WATER IS NOT RECOMMENDED FOR HUMAN CONSUMPTION.
2. A SIGN STATING NOT FOR DRINKING MUST BE AFFIXED TO THE TANK AND OR TAP FIXTURE

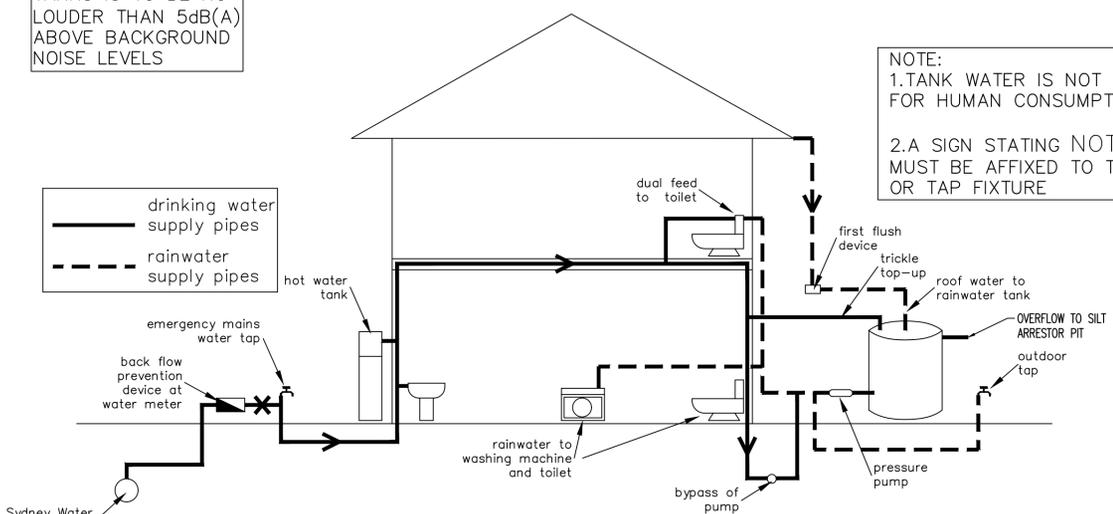

RAINWATER TANK EXPLANATORY DIAGRAM (not to scale)

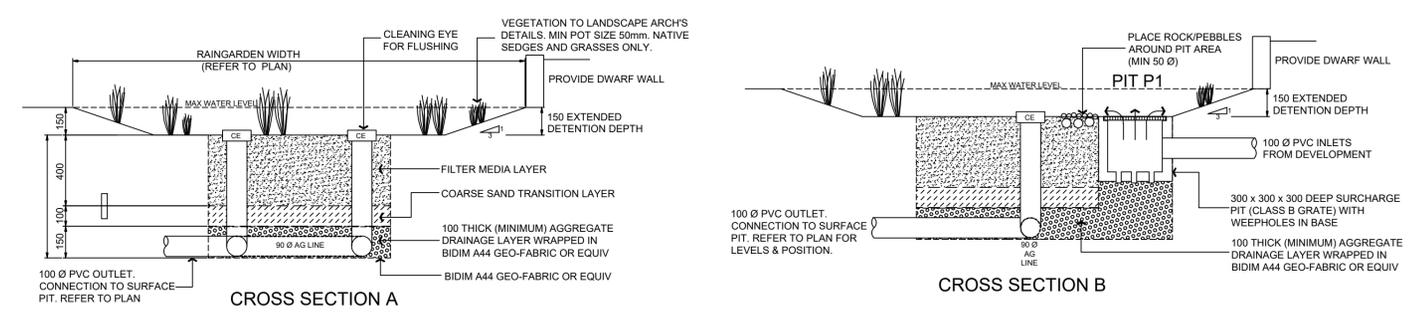

RAIN GARDEN DETAILS

REVISION	AMENDMENT	ISSUE DATE	ISSUE	ISSUED TO	ISSUE DATE
B	ISSUED FOR DA APPROVAL	16/12/2021			
A	PRELIMINARY DESIGN	21/09/2021			

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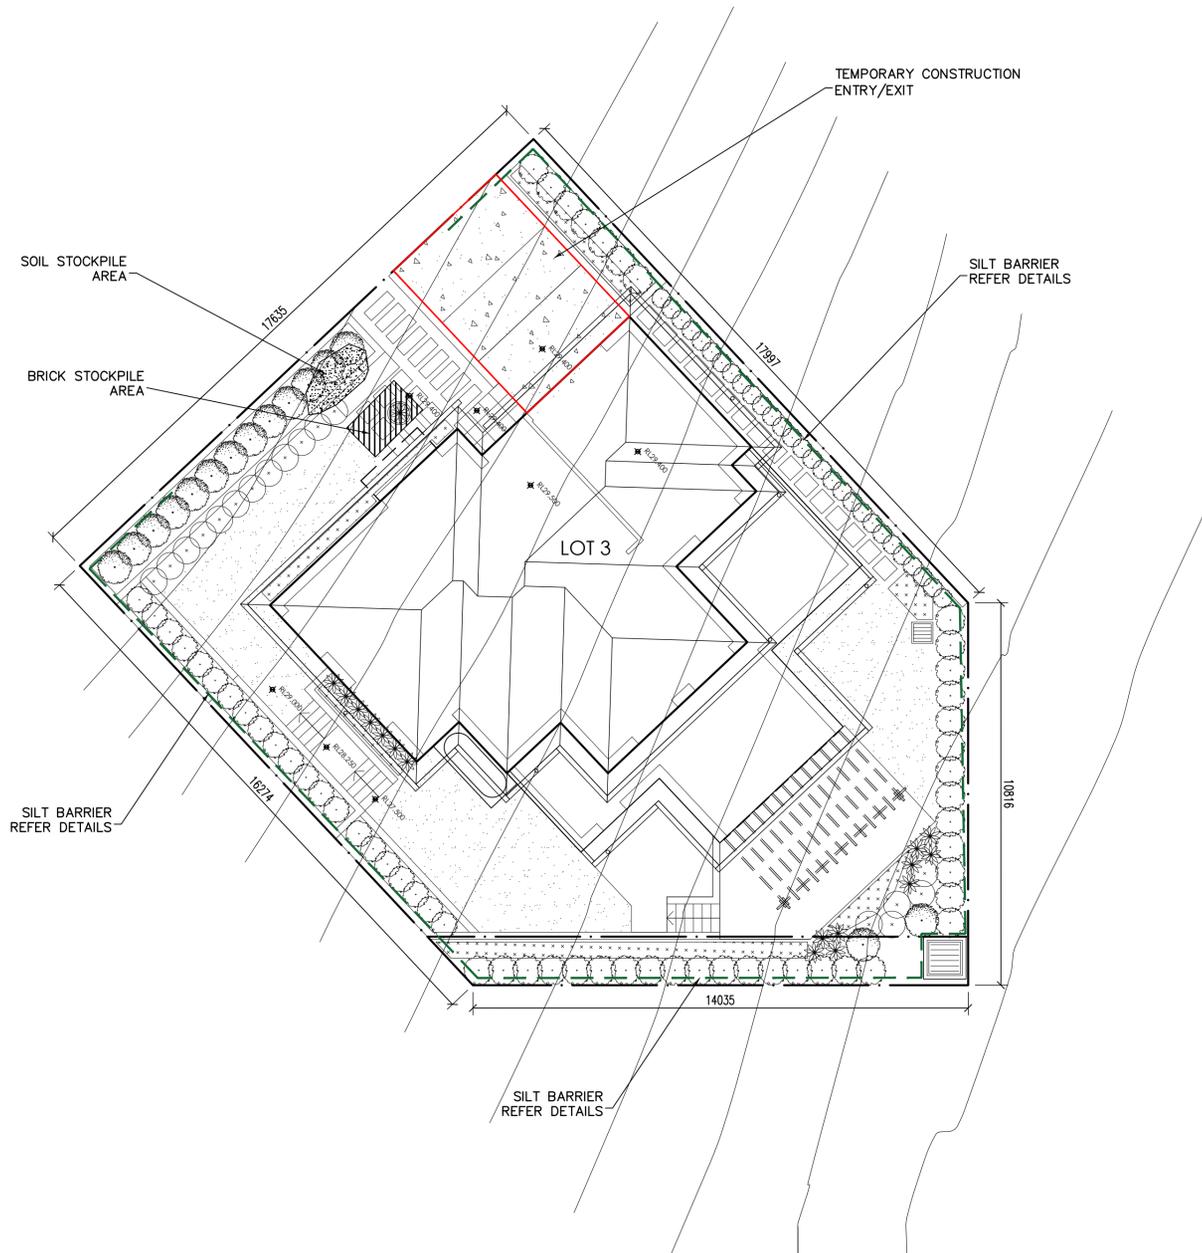
PROJECT
**PROPOSED DEVELOPMENT
LOT 3, 10 FERN CREEK ROAD,
WORRIEWOOD, NSW**

CLIENT
SKYCORP





ARCHITECT / PROJECT MANAGER
KAE CHAN

DRAWING TITLE
DRAINAGE LAYOUT PLAN

SCALE	DESIGNED	DRAFTED
A1 - 1:100	A.C.	M.W.
DRAWING NO.	APPROVED	REVISION
C21187-SW01	A.C.	B



SM SOIL MANAGEMENT PLAN
SCALE : 1:100

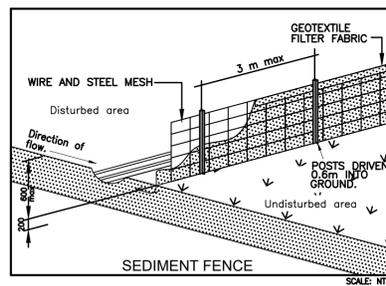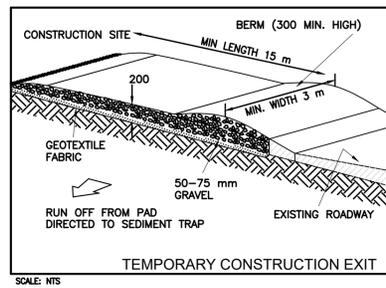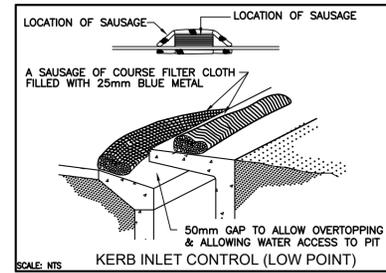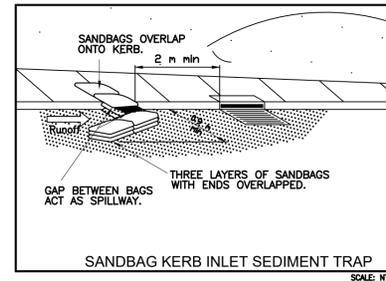


SOIL EROSION CONTROL INSTRUCTIONS

- EARTH BATTERS WILL BE CONSTRUCTED WITH AS LOW AS A GRADIENT AS PRACTICABLE BUT NO STEEPER, UNLESS OTHERWISE NOTED, THAN:
 - 2(H):1(V) WHERE SLOPE LENGTH LESS THAN 12 METRES
 - 2.5(H):1(V) WHERE SLOPE LENGTH BETWEEN 12 & 16 METRES
 - 3(H):1(V) WHERE SLOPE LENGTH BETWEEN 16 & 20 METRES
 - 4(H):1(V) WHERE SLOPE LENGTH GREATER THAN 20 METRES
- ALL WATERWAYS, DRAINS, SPILLWAYS AND THEIR OUTLETS WILL BE CONSTRUCTED TO BE STABLE IN AT LEAST THE 1:20 YEAR ARI, TIME OF CONCENTRATION STORM EVENT.
- WATERWAYS AND OTHER AREAS SUBJECT TO CONCENTRATED FLOWS AFTER CONSTRUCTION ARE TO HAVE A MAXIMUM GROUND COVER C-FACTOR OF 0.05 (70% GROUND COVER) WITHIN 10 WORKING DAYS FROM COMPLETION OF FORMATION. FLOW VELOCITIES ARE TO BE LIMITED TO THOSE SHOWN IN TABLE 5-1 OF "MANAGING URBAN STORMWATER - SOILS AND CONSTRUCTION DEPT OF HOUSING 1998 (BLUE BOOK). FOOT AND VEHICULAR TRAFFIC WILL BE PROHIBITED IN THESE AREAS.
- STOCKPILES AFTER CONSTRUCTION ARE TO HAVE A MAXIMUM GROUND COVER C-FACTOR OF 0.1 (60% GROUND COVER) WITHIN 10 WORKING DAYS FROM COMPLETION OF FORMATION.
- ALL LANDS, INCLUDING WATERWAYS AND STOCKPILES, DURING CONSTRUCTION ARE TO HAVE A MAXIMUM GROUND COVER C-FACTOR OF 0.15 (50% GROUND COVER) WITHIN 20 WORKING DAYS FROM INACTIVITY EVEN THOUGH WORKS MAY CONTINUE LATER.
- FOR AREAS OF SHEET FLOW USE THE FOLLOWING GROUND COVER PLANT SPECIES FOR TEMPORARY COVER: JAPANESE MILLET 20KG/HA AND OATS.
- PERMANENT REHABILITATION OF LANDS AFTER CONSTRUCTION WILL ACHIEVE A GROUND COVER C-FACTOR OF LESS THAN 0.1 AND LESS THAN 0.05 WITHIN 60 DAYS. NEWLY PLANTED LANDS WILL BE WATERED REGULARLY UNTIL AN EFFECTIVE COVER IS ESTABLISHED AND PLANTS ARE GROWING VIGOROUSLY FOLLOW-UP SEED AND FERTILISER WILL BE APPLIED AS 20KG/HA
- REVEGETATION SHOULD BE AIMED AT RE-ESTABLISHING NATURAL SPECIES. NATURAL SURFACE SOILS SHOULD BE REPLACED AND NON-PERSISTANT ANNUAL COVER CROPS SHOULD BE USED.

DUST CONTROL INSTRUCTIONS

- ALL STOCKPILED MATERIAL OR SEDIMENT COLLECTION TO BE SPRAYED BY LIGHTLY WIDE ANGLED WATER
- THIS TEMPORARY MECHANICAL METHOD CONFINES AND SETTLES THE DUST FROM THE AIR BY DUST AND WATER PARTICLE ADHESION. WATER IS SPRAYED THROUGH NOZZELS OVER THE PROBLEM AREA.

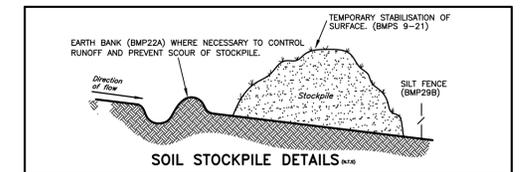

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PROPOSED DEVELOPMENT
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WORRIEWOOD, NSW

CLIENT
SKYCORP

ARCHITECT / PROJECT MANAGER
KAE CHAN

DRAWING TITLE SOIL MANAGEMENT PLAN			
SCALES A1 - 1:100	DESIGNED A.C.	DRAFTED M.W.	
DRAWING NO. C21187-SW02	APPROVED A.C.	REVISION B	