COVER PAGE

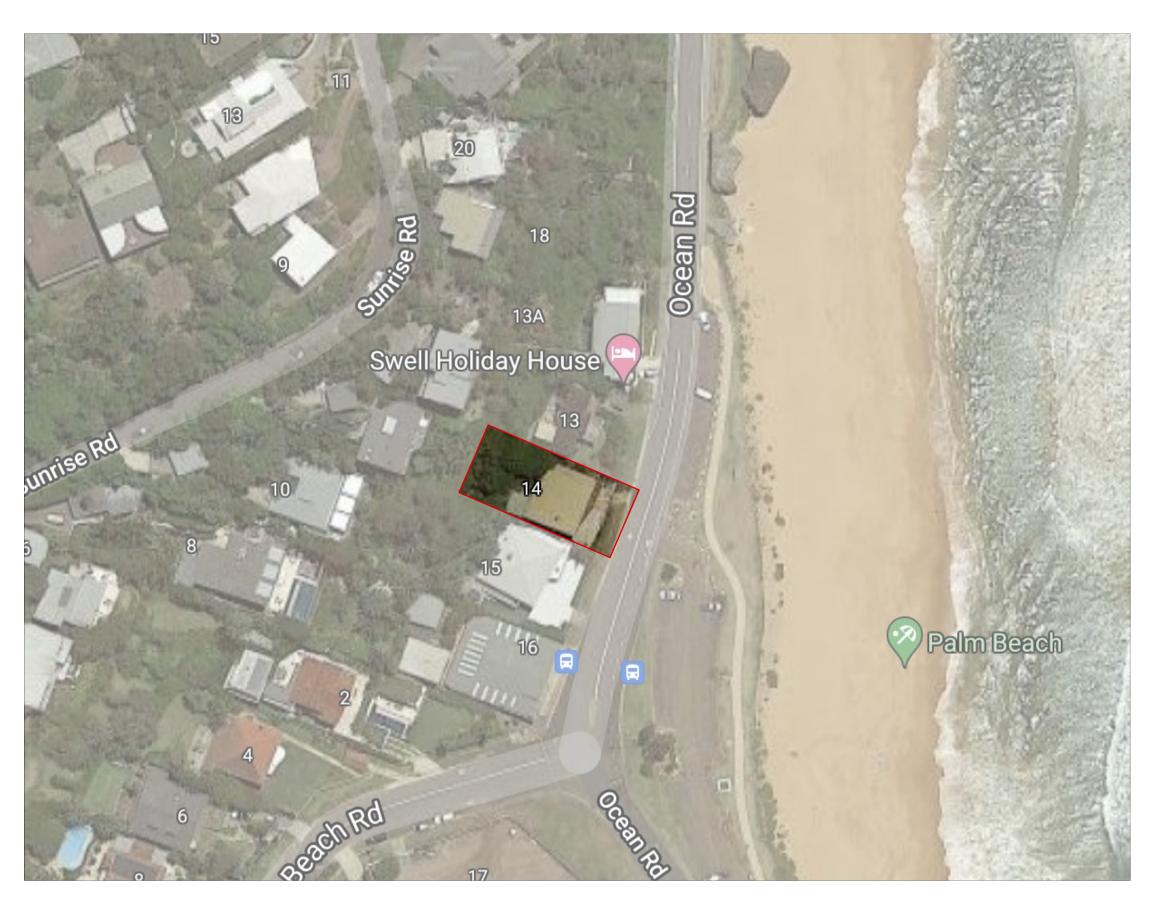
DA.00	Cover Page and Location Plan
DA.01	Site Plan and Site Analysis
DA.02	Lower Ground Level Plan
DA.03	Groundfloor Plan
DA.04	Level 1 Plan
DA.05	Level 2 Plan
DA.06	Roof Plan
DA.07	East and West Elevation
DA.08	North and South Elevation
DA.09	Sections AA BB
DA.10	Height Plane Diagram (8.5m)
DA.11	Height Plane Diagram (10m)
DA.12	Building Envelope Diagram
DA.13	Demolition Plan
DA.14	Contour Modification Plan
DA.15	Landscape Calculation Plan
DA.16	Excavation Plan
DA.17	Schedule of Finishes
DA.18	Streetscape Visualisation
DA.19	Solar Diagrams

'BASIX' COMMITMENTS CERTIFICATE NO. 0006687636

NATER COMMITMENTS:	
FIXTURES	The applicant must install showerheds with a minimum rating of 4 star (>4.5 but $<=6$ L/min plu sspray force and/or coverage tests) in all showers in the development.
	The applicant must install a toilet flushing system with a minimum rating of 4 stars in each toilet in the development
	The applicant must install taps with a minimum rating of 6 star in the kitchen in the development.
	The applicant must install basin taps with a mimum rating of 6 star in each bathroom in the development.
ALTERNATIVE WATER	Rainwater Rank The applicant must install a rainwater tank of at least 10000L on the site. This rainwater tank must meet, and be installed in accordance with, the requirements of all applicable regulatory authorities.
	The applicant must configure the rainwater tank to collect rain runoff from at least 56 square metres of the roof area of the development (exclusing the area of the roof which drains to any stormwater tank or private dam.
	The applicant must connect the rainwater tank to: - Landscape - Laundary Tap + Pool Tap
SWIMMING POOL	The swimming pool must not have a volume greater than 45KL w
	The swimming pool must have a permanent retractable pool cover.
	The swimming pool must be outdoors.

THERMAL COMMITMENTS:	
SIMULATION METHOD	The applicant must construct the development in accordance with all the thermal performance specifications set out in the Assessor Certificate, and in accordance with those aspects of the development application or application for a complying development certificate which were used to calculate those specifications.
	The applicant must construct the floors and walls of the dwelling in accordance with the specifications listed in the associated BASIX Report.

HOT WATER	The applicant must install the following hot water system in the development, or a system with a higher energy rating: gas instanteous with a performance of 6 stars.
COOLING SYSTEM	The applicant must install the following cooling system, or a system with a higher energy rating, in at least 1 living area: 1-phase airconditioning; Energy rating: EER 3.0 - 3.5
	The applicant must install the following cooling system, or a system with a higher energy rating, in at least 1 bedroom: 1-phase airconditioning; Energy rating: EER 3.0 - 3.5
HEATING SYSTEM	The applicant must install the following heating system, or a system with a higher energy rating, in at least 1 living area: 1-phase airconditioning; Energy rating: EER 3.0 - 3.5
	The applicant must install the following heating system, or a system with a higher energy rating, in at least 1 bedroom: 1-phase airconditioning; Energy rating: EER 3.0 - 3.5
VENTILIATION	The applicant must install the following exhaust systems in the development: At least 1 Bathroom: individual fan, ducted to façade or roof; Operation control: manual switch on/off. Kitchen: individual fan, ducted to façade or roof; Operation control: manual switch on/off Laundry: individual fan, ducted to façade or roof; Operation control: manual switch on/off
NATURAL LIGHTING	The applicant must install a window and/or skylight in 1 bathroom(s)/toilet(s) in the development for natural lighting.
SWIMMIING POOL	The applicant must install the following heating system for the swimming pool in the development (or alternatively must not install any heating system for the swimming pool): gas
	The applicant must install a timer for the swimming pool pump in the development.
ALTERNATIVE ENERGY	The applicant must install a photovoltaic system with the capacity to generate at least 2 peak kilowate of electricity as part of the development. The applicant must connect this system to the development's electrical system.
OTHER	The applicant must install a gas cooktop & electric oven in the kitchen of the dwelling.
	The applicant must construct each refrigerator space in the development so that it is "well ventilated" as defined in the BASIX definitions.
	The applicant must install a fixed outdoor clothes drying line as part of the development.





U-value 5.40 SHGC 0.49 (± 10%) (Single Glazed, Low-e)

THERMAL COMFORT:

elopment, or a system with a	PASS				
n with a higher energy rating, in at - 3.5	GLAZI	ING	Location	Sliding/Fixed/Louvre	G01
n with a higher energy rating, in at 3.5			Ground + Level 1 (Except Rumpus)	U-value 4.50 SHGC 0.52 (± 10%) (Single Glazed, Low-e)	U-value 5.40 SHGC 0.49 (Single Glaz
n with a higher energy rating, in at - 3.5			Level 2 + Rumpus	U-value 3.55 SHGC 0.48 (± 10%) (Double Glazed, Low-e)	
n with a higher energy rating, in at 3.5	WALL	S		Cavity Brick - min R1.1 insulation w aft (All Levels): Min R1.0 insulation	
elopment:			Internal walls within Dwelling: No	insulation Modelled.	
tion control:	FLOOF	RS Concrete Slab on Ground (All Levels): No insulation mode			
manual switch on/off Laundry: switch on/off			Intermediate floors (Conditioned to	o Conditioned): No insulation model	led.
s)/toilet(s) in the development for			Suspended Floors to Open or Sub	floor below: Min R1.5 insulation.	
	ROOF		Ceiling Cavity to Exposed (Level G	and 2): Additional R3.0 bulk insula	tion.
			Ceiling Cavity to Exposed (Level O	1): Additional 50mm R2.3 rigid inst	ılation.
nming pool in the development (or pool): gas			Concrete Roof: Ceiling insulation o	unly.	
ne development.			Metal Roof: Ceiling insulation + n	nin R1.30 reflective blanket.	



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NOTES

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A	24.08.21	Issue for Consultant Coordination	DB	ES
В	22.09.21	Issue for Consultant Coordination	DB	ES
С	22.10.21	DA Issue	DB	ES
D	25.10.21	DA Issue	DB	ES
	·			

drawing no.	DA.00	REV NO.	D
DRAWN	ES	project no.	21006
DATE	25.10.21	SCALE	NTS
	BASIX/LOCATI	ON PLAN	
DRAWING	COVER PAGE		
Document	DEVELOPMEN	t applicatioi	N
	PALM BEACH	2108	
ADDRESS	14 OCEAN RO	AD	
PROJECT	OCEAN ROAD	RESIDENCE	

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Dense vegetation to Northern boundary of site.



Dense vegetation to steep embankment at rear of site. Existing palm clumps to rear of site recommended for removal.



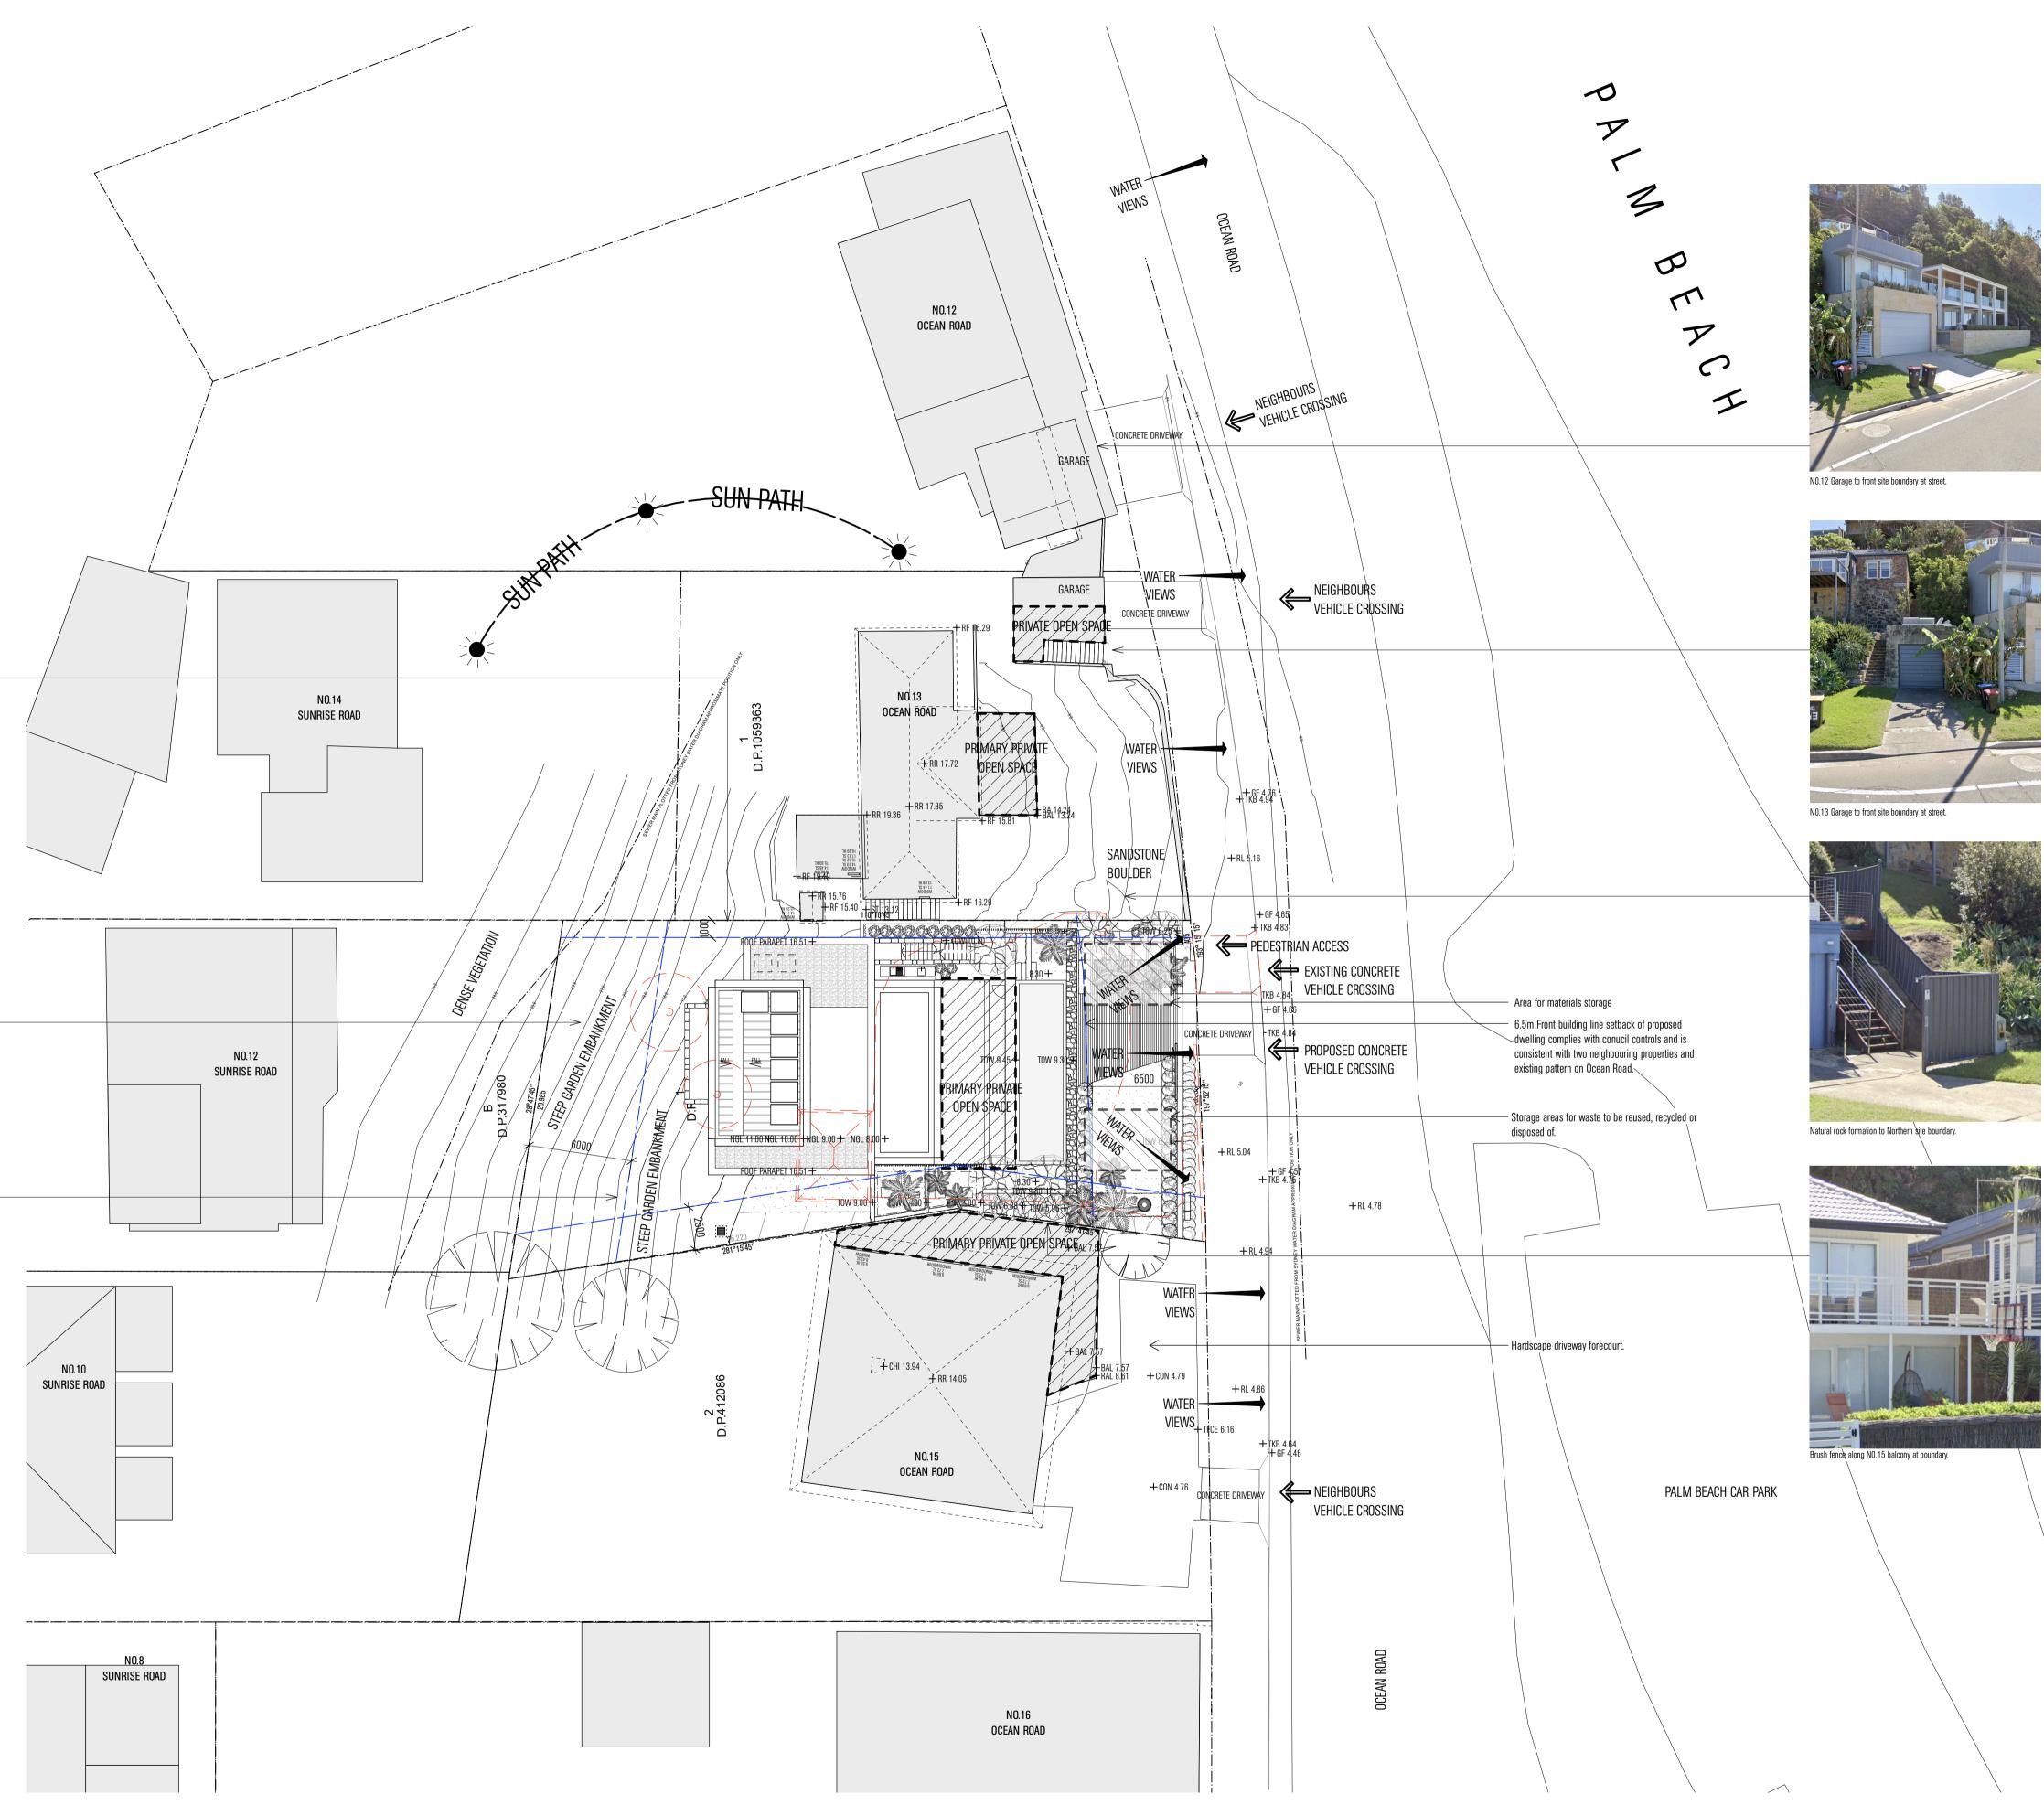
Dense vegetation to steep embankment at rear of site.

SITE PLAN / ANALYSIS

PLAN

Scale 1:200

01





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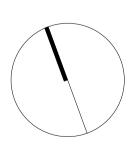


NOTES

REV NO.	DATE	REVISIONS	BY	СНК
A	12.07.21	Issue for Consultant Coordination	ES	ES
В	16.07.21	Pre-DA Package	ES	ES
С	24.08.21	Issue for Consultant Coordination	ES	ES
D	22.09.21	Issue for Consultant Coordination	ES	ES
E	11.10.21	Issue for Consultant Coordination	DB	ES
F	15.10.21	DA Issue	DB	ES
G	19.10.21	DA Issue	DB	ES
Н	22.10.21	DA Issue	DB	ES
I	06.04.22	DA Amendment	DB	ES
		·		

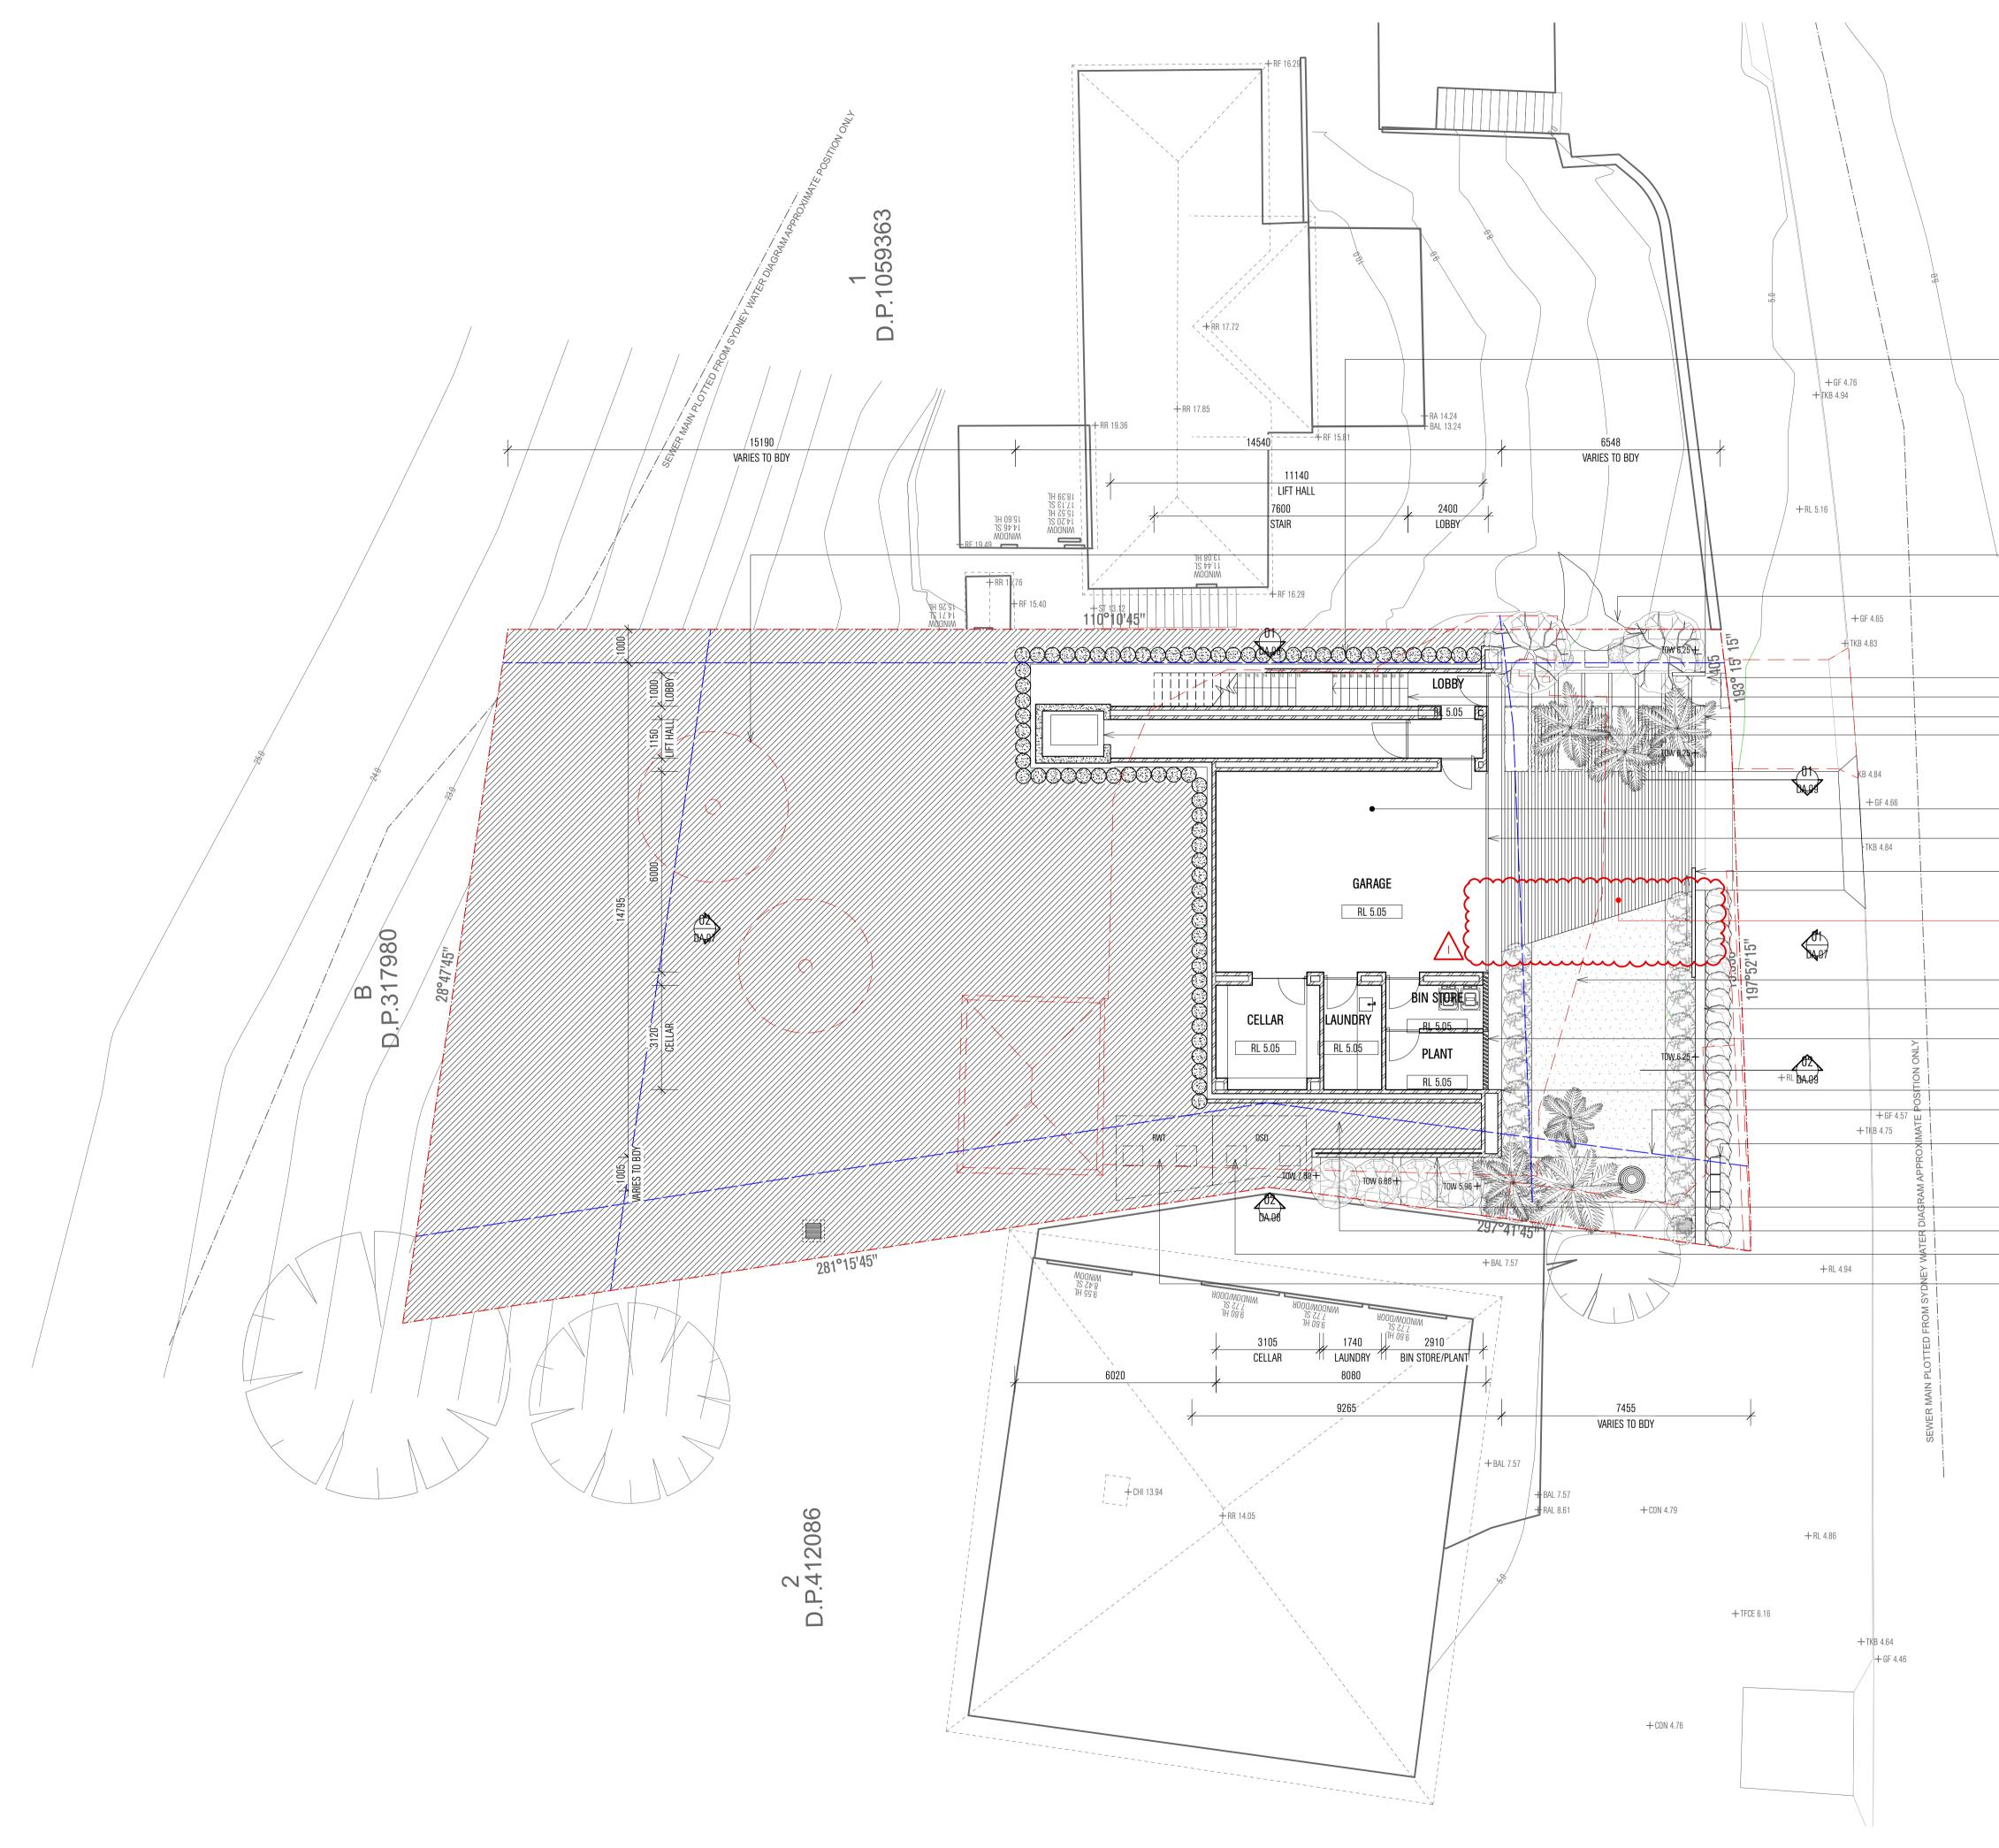
PROJECT	ocean road) residence		
ADDRESS	14 OCEAN R	OAD		
	Palm Beach	1 2108		
DOCUMENT	DEVELOPME	nt applicati	ON	
DRAWING	PLAN			
	SITE PLAN /	ANALISIS		

DRAWING NO.	DA.01	REV NO.			
DRAWN	ES	project no.	21006		
DATE	06.04.22	SCALE	1:200		



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Site Boundary

New glazing

LEGEND



Council setbacks / Height requirements Brick wall 110mm + 10mm render Blockwork wall Concrete structure Stone clad masonry wall 600mm Lightweight walls 110mm + 10mm lining Timber structure 130mm

HWU - Hot Water Unit CU - Condenser Unit PV - Photovoltaic Panels RWT - Rainwater Tank



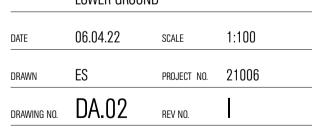
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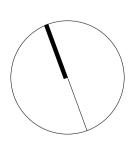
REV NO. DATE REVISIONS BY CHK 12.07.21 Issue for Consultant Coordination ES ES 16.07.21 Pre-DA Package ES ES 24.08.21 Issue for Consultant Coordination ES ES 22.09.21 Issue for Consultant Coordination DB ES 11.10.21 Issue for Consultant Coordination DB DB ES 15.10.21 DA Issue 22.10.21 DA Issue DB ES
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 11.11.21 DA Issue Н 06.04.22 DA Amendment _____ ____ _____ _ __ __ ____ ___ ____ _ __ __ _____ _ ___ __

PROJECT	ocean road) RESIDENCE		
ADDRESS	14 Ocean R	DAD		
	PALM BEACH	12108		
DOCUMENT	DEVELOPME	NT APPLICAT	ION	
DRAWING	PLAN			
	LOWER GROU	JND		
DATE	06.04.22	SCALE	1:100	





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 Below ground piling system to Structural Engineer's detail.

New timber clad pedestrian entry gate.

 Existing site trees removed as per Arborist Report recommendation.

 Natural rock formation to Northern site boundary to be retained.

New timber clad pedestrian entry gate to be designed to resist wave forces — as advised by a Coastal Engineer. — Stairs to Ground level. — New mailbox.

– New lift to floors above.

 New garage and concrete vehicle layover.
 Vertical timber board cladding to

Garage door.

 Timber clad driveway gate to be designed to resist wave forces as advised by a Coastal Engineer.

 Pervious concrete strip driveway revised with splay increasing landscaped area.

 Existing house to be demolished shown red dashed.
 1200mm high solid front fence to prevent wave inundation.
 Vertical timber louvres to front of Plant Room & Bin Store.

New masonry wall clad in stone.
 Council setback's shown dashed in blue.

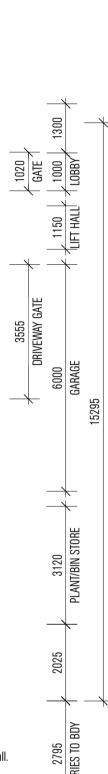
 Sydney Water authority cold water meter. Site containment RPZD.
 Jemena authority Gas regulator and HRL 4.78 meter.

- Render and paint finish to masonry wall.

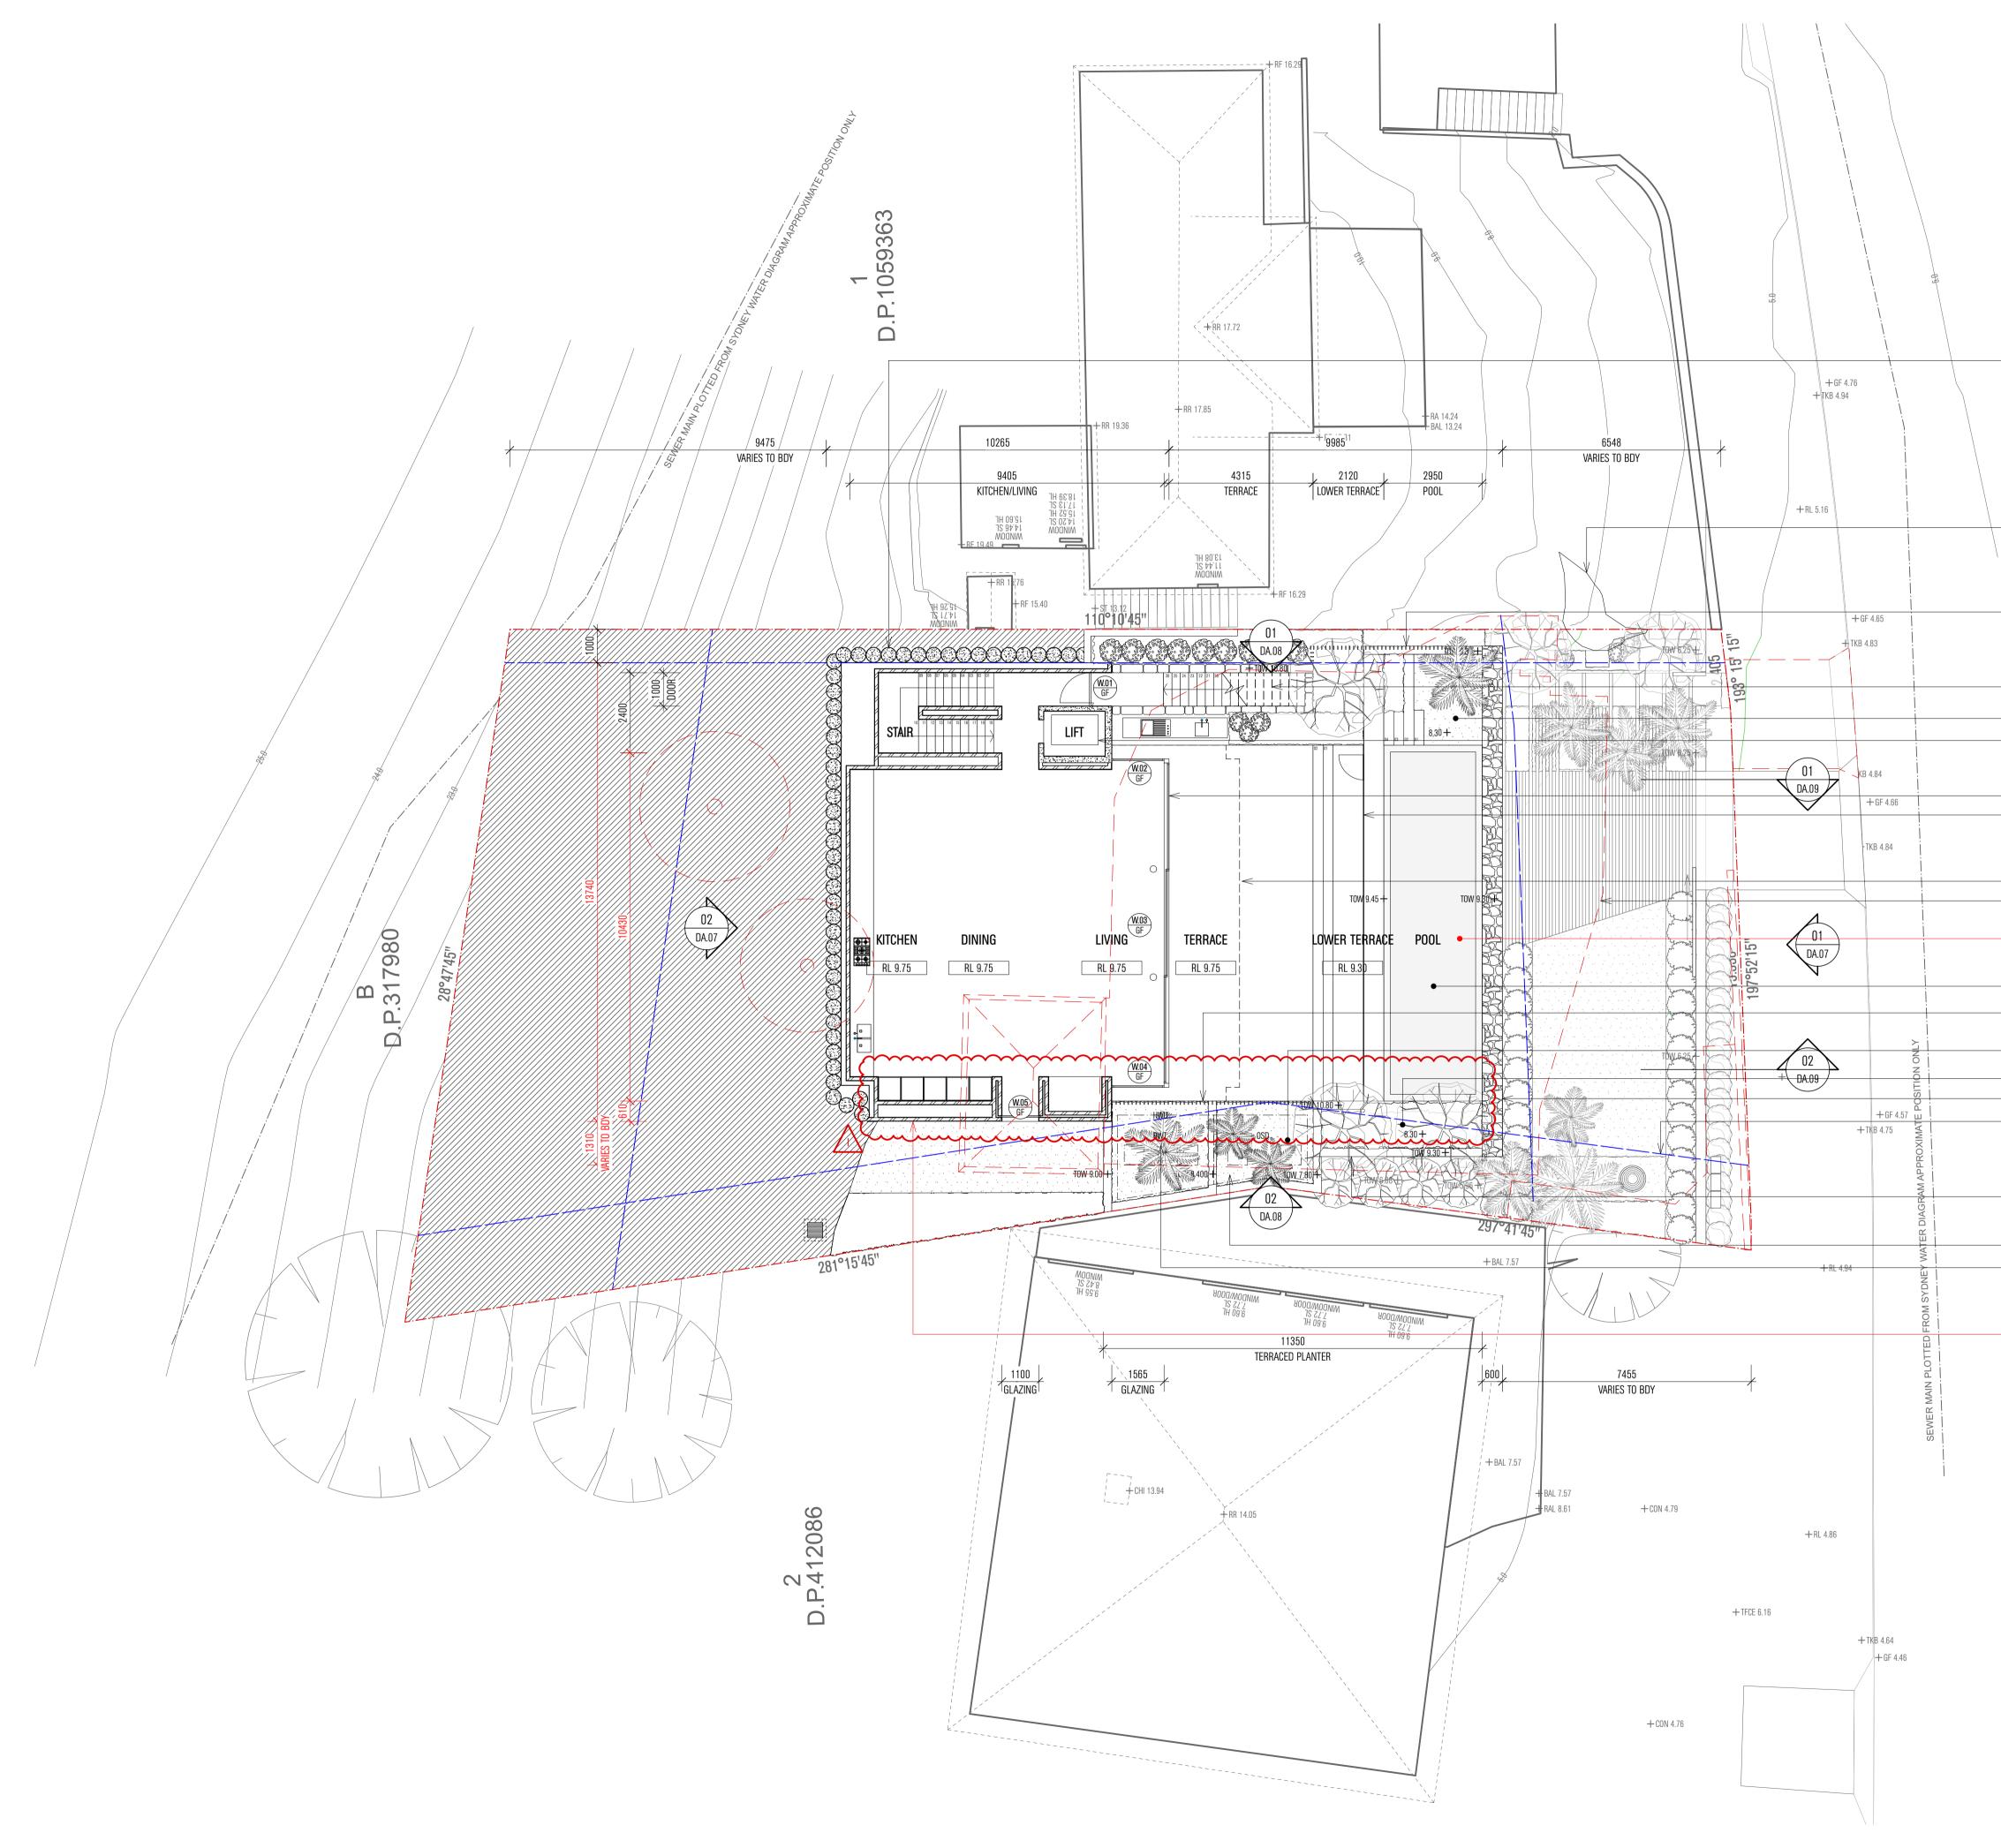
- Ground fill.

– OSD + Water quality chamber. – 10KL cast in-situ rainwater reuse tank to

BASIX requirement adjacent Civil OSD tank.





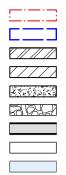




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Site Boundary

LEGEND

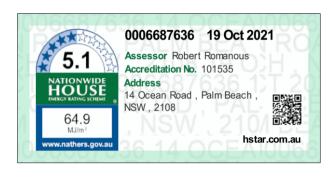


Council setbacks / Height requirements Brick wall 110mm + 10mm render Blockwork wall Concrete structure

Stone clad masonry wall 600mm

Lightweight walls 110mm + 10mm lining Timber structure 130mm New glazing

HWU - Hot Water Unit CU - Condenser Unit PV - Photovoltaic Panels RWT - Rainwater Tank



NOTES

– 1200mm high vertical blade Pool fence to terrace to comply with all relevant swimming pool laws and codes.

Natural rock formation to Northern

site boundary to be retained.

- Below ground piling system to Structural Engineer's detail.

– Stairs from garage.

-Sunken courtyard adjacent to pool. - New lift.

– New glazing.

1200mm high frameless glass Pool fence and gates to comply with all relevant swimming pool laws and codes.

– Floor above shown dashed. Existing house to be demolished shown red dashed.

- Pool length reduced to suit revised building envelope.

– Proposed infinity edge Swimming Pool.

1050mm high vertical blade fence to terrace.

- Terraced planting to Southern boundary.

 Non trafficable sunken planter box. - New masonry wall clad in stone. - Council setback's shown dashed in

blue. + RL 4.78

- Render and paint finish to masonry wall.

OSD + Water quality chamber. - 10KL cast in-situ rainwater reuse tank to BASIX requirement adjacent Civil OSD tank.

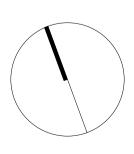
- Southern building envelope across all levels reduced and brought in from the Southern Boundary reducing overall building footprint.



rev no.	DATE	REVISIONS	BY	СНК
A	12.07.21	Issue for Consultant Coordination	ES	ES
В	16.07.21	Pre-DA Package	ES	ES
С	24.08.21	Issue for Consultant Coordination	ES	ES
D	14.09.21	Issue for Consultant Coordination	DB	ES
E	22.09.21	Issue for Consultant Coordination	DB	ES
F	11.10.21	Issue for Consultant Coordination	DB	
G	15.10.21	DA Issue	DB	ES
Н	22.10.21	DA Issue	DB	ES
	06.04.22	DA Amendment	DB	ES
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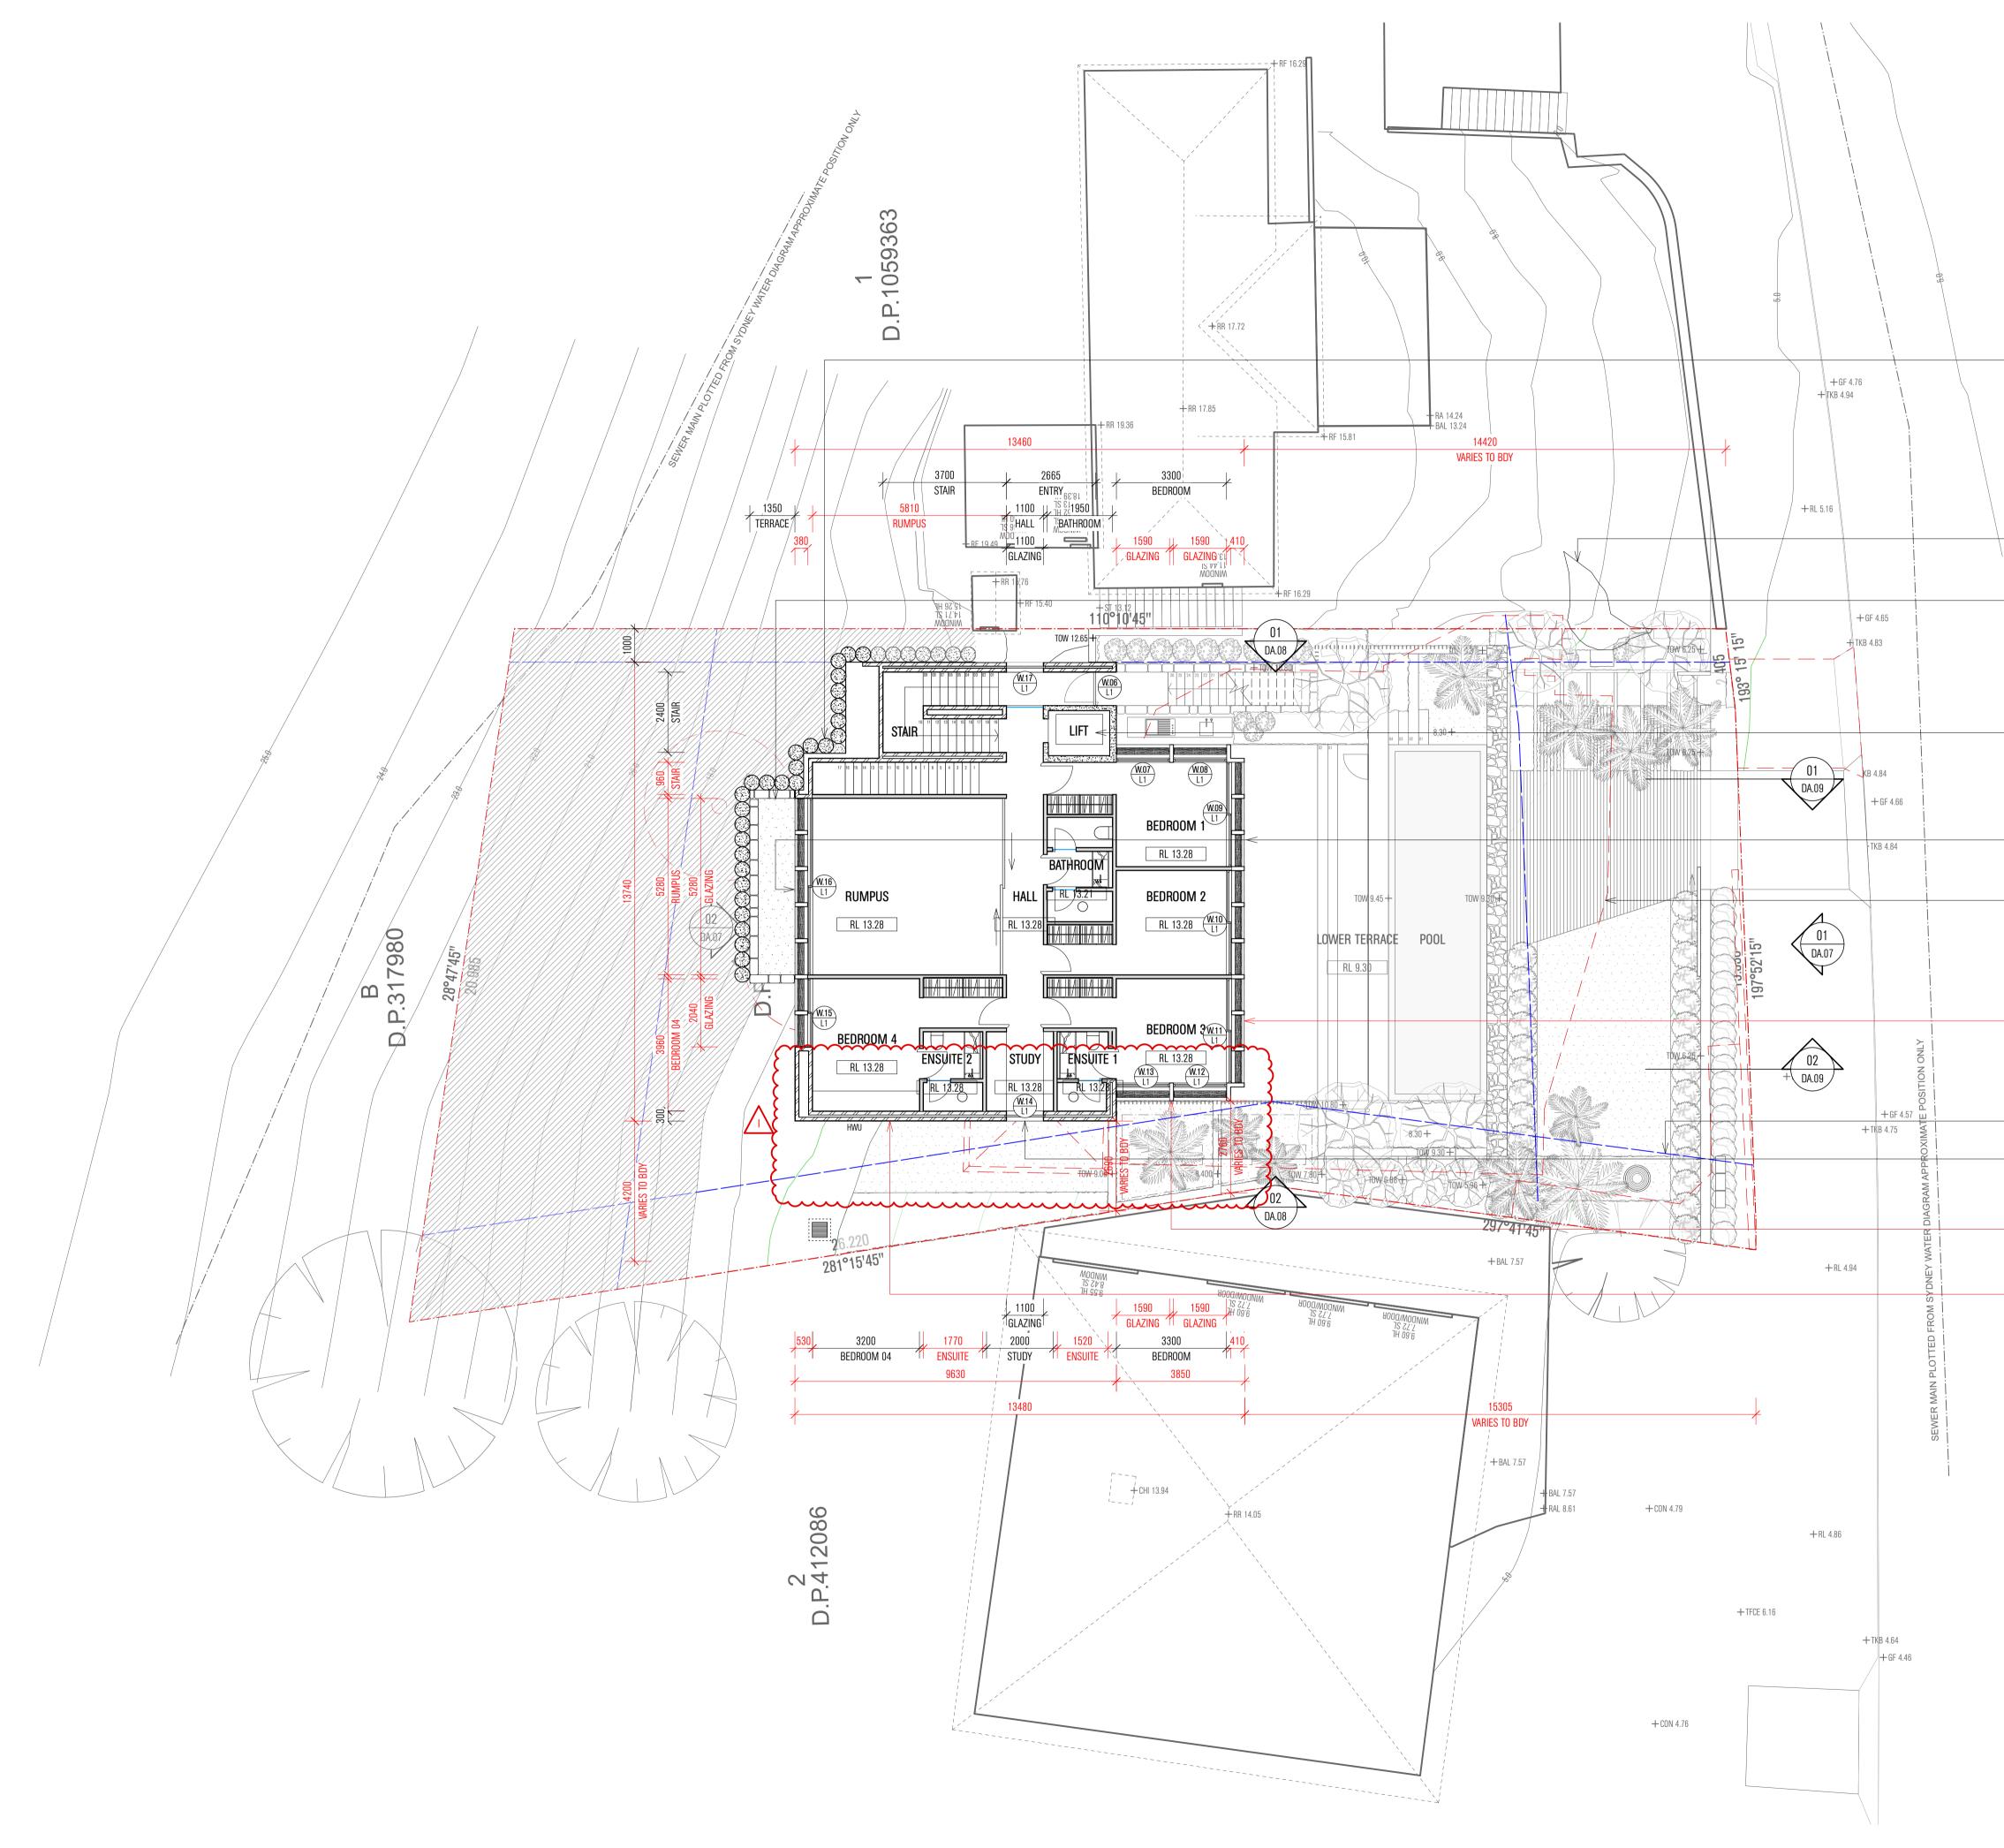
PROJECT	OCEAN ROAD RESIDENCE
ADDRESS	14 OCEAN ROAD
	PALM BEACH 2108
DOCUMENT	DEVELOPMENT APPLICATION
DRAWING	PLAN
	GROUND

	uncond		
DATE	06.04.22	SCALE	1:100
DRAWN	ES	project no.	21006
drawing no.	DA.03	REV NO.	



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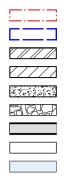




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Site Boundary

LEGEND



Council setbacks / Height requirements Brick wall 110mm + 10mm render Blockwork wall Concrete structure Stone clad masonry wall 600mm Lightweight walls 110mm + 10mm lining

Timber structure 130mm New glazing

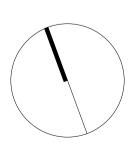
HWU - Hot Water Unit CU - Condenser Unit PV - Photovoltaic Panels RW - Rainwater Tank



NOTES

REV NO. DATE REVISIONS BY CHK 12.07.21 Issue for Consultant Coordination ES ES 16.07.21 Pre-DA Package ES ES 24.08.21 Issue for Consultant Coordination ES ES 22.09.21 Issue for Consultant Coordination DB ES 11.10.21 Issue for Consultant Coordination DB DB ES 15.10.21 DA Issue DB ES 22.10.21 DA Issue DB ES DB ES 30.03.22 DA Amendment 06.04.22 DA Amendment _ ___ ___ _ __ __ _____ _____ ___ _ __ __ _____ _____

PROJECT	ocean road) Residence		
ADDRESS	14 Ocean R	DAD		
	Palm Beach	1 2108		
DOCUMENT	DEVELOPME	NT APPLICATION	N	
DRAWING	PLAN			
	LEVEL 1			
DATE	06.04.22	SCALE	1:100	
DRAWN	ES	project no.	21006	



drawing no. DA.04 rev no. I

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- Below ground piling system to Structural Engineer's detail.

- Natural rock formation to Northern site boundary to be retained.

- New masonry wall clad in stone to rear courtyard.

- New lift.

- Horizontal timber louvres to front of sliding aluminium window.

 Existing house to be demolished shown red dashed.

— East Elevation moved away from East + South Boundary setbacks

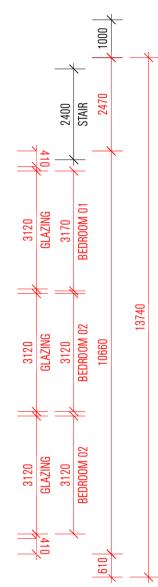
 Council setback's shown dashed in blue.

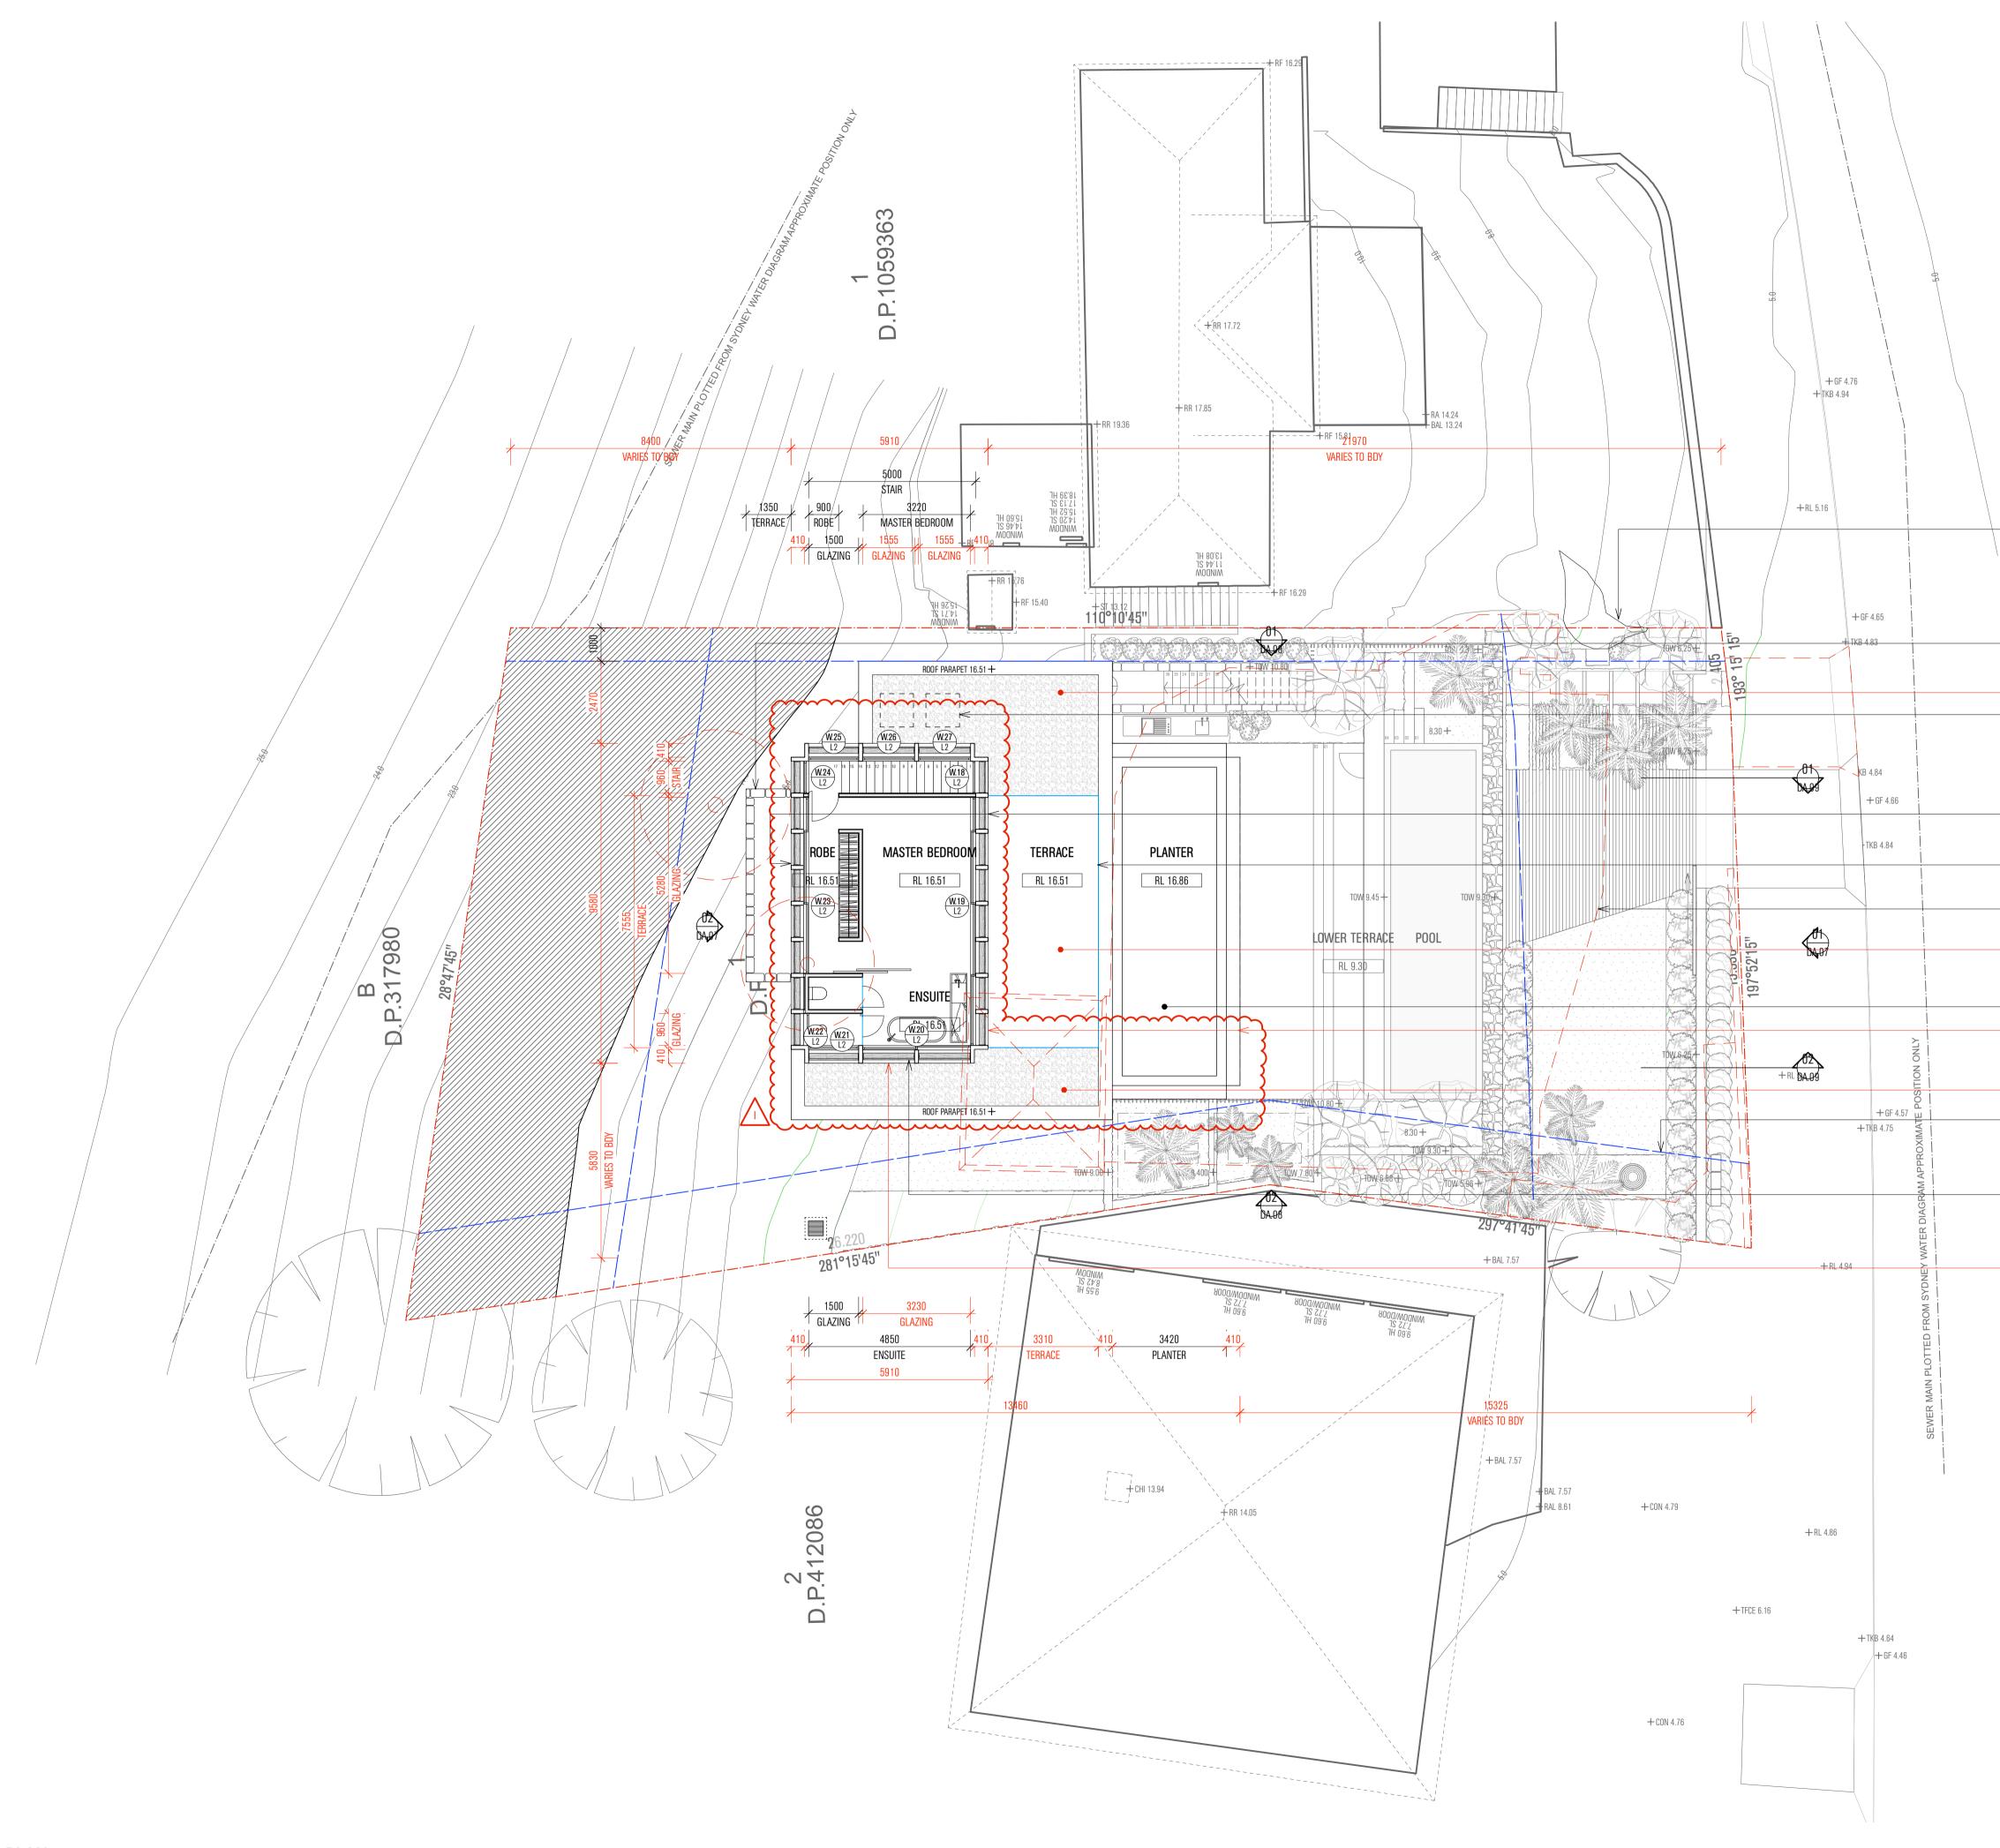
New glazing.

+RL 4.78

- Southern building envelope across all levels reduced and brought in from the Southern Boundary reducing overall building footprint.

- Level 01 building envelope amended to allow masonry wall to return and catch glazing to suit changes to Level 02 and roof above.







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LEGEND

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Brick wall 110mm + 10mm render Blockwork wall

Concrete structure

Site Boundary

394

Stone clad masonry wall 600mm Lightweight walls 110mm + 10mm lining Timber structure 130mm New glazing

Council setbacks / Height requirements

HWU - Hot Water Unit CU - Condenser Unit PV - Photovoltaic Panels RW - Rainwater Tank



NOTES

- New masonry wall clad in stone to

– Natural rock formation to Northern

site boundary to be retained.

— New pebbled roof above stair.

rear courtyard.

– MATV/PAYTV Antenna located on roof.

- Horizontal timber louvres to front of sliding aluminium window.

1000mm high frameless glass balustrade.

 Existing house to be demolished shown red dashed.

– Level 02 Terrace trafficable area reduced and brought in from both North + South boundary's.

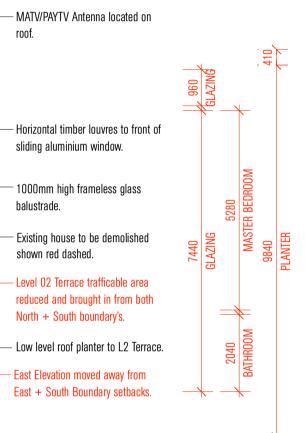
– Low level roof planter to L2 Terrace. East Elevation r /ed away from

- New pebbled roof above Bedroom 04 and Ensuite's. – Council setback's shown dashed in blue.

+ RL 4.78

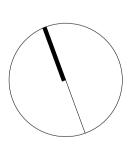
- Horizontal timber louvres to front of sliding aluminium window.

- Level 02 building envelope reduced and brought in from the Southern boundary by 1300mm.



REV NO.	DATE	REVISIONS	BY	СНК
A	12.07.21	Issue for Consultant Coordination	ES	ES
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G	22.10.21	DA Issue	DB	ES
Н	30.03.22	DA Amendment	DB	ES
1	06.04.22	DA Amendment	DB	ES
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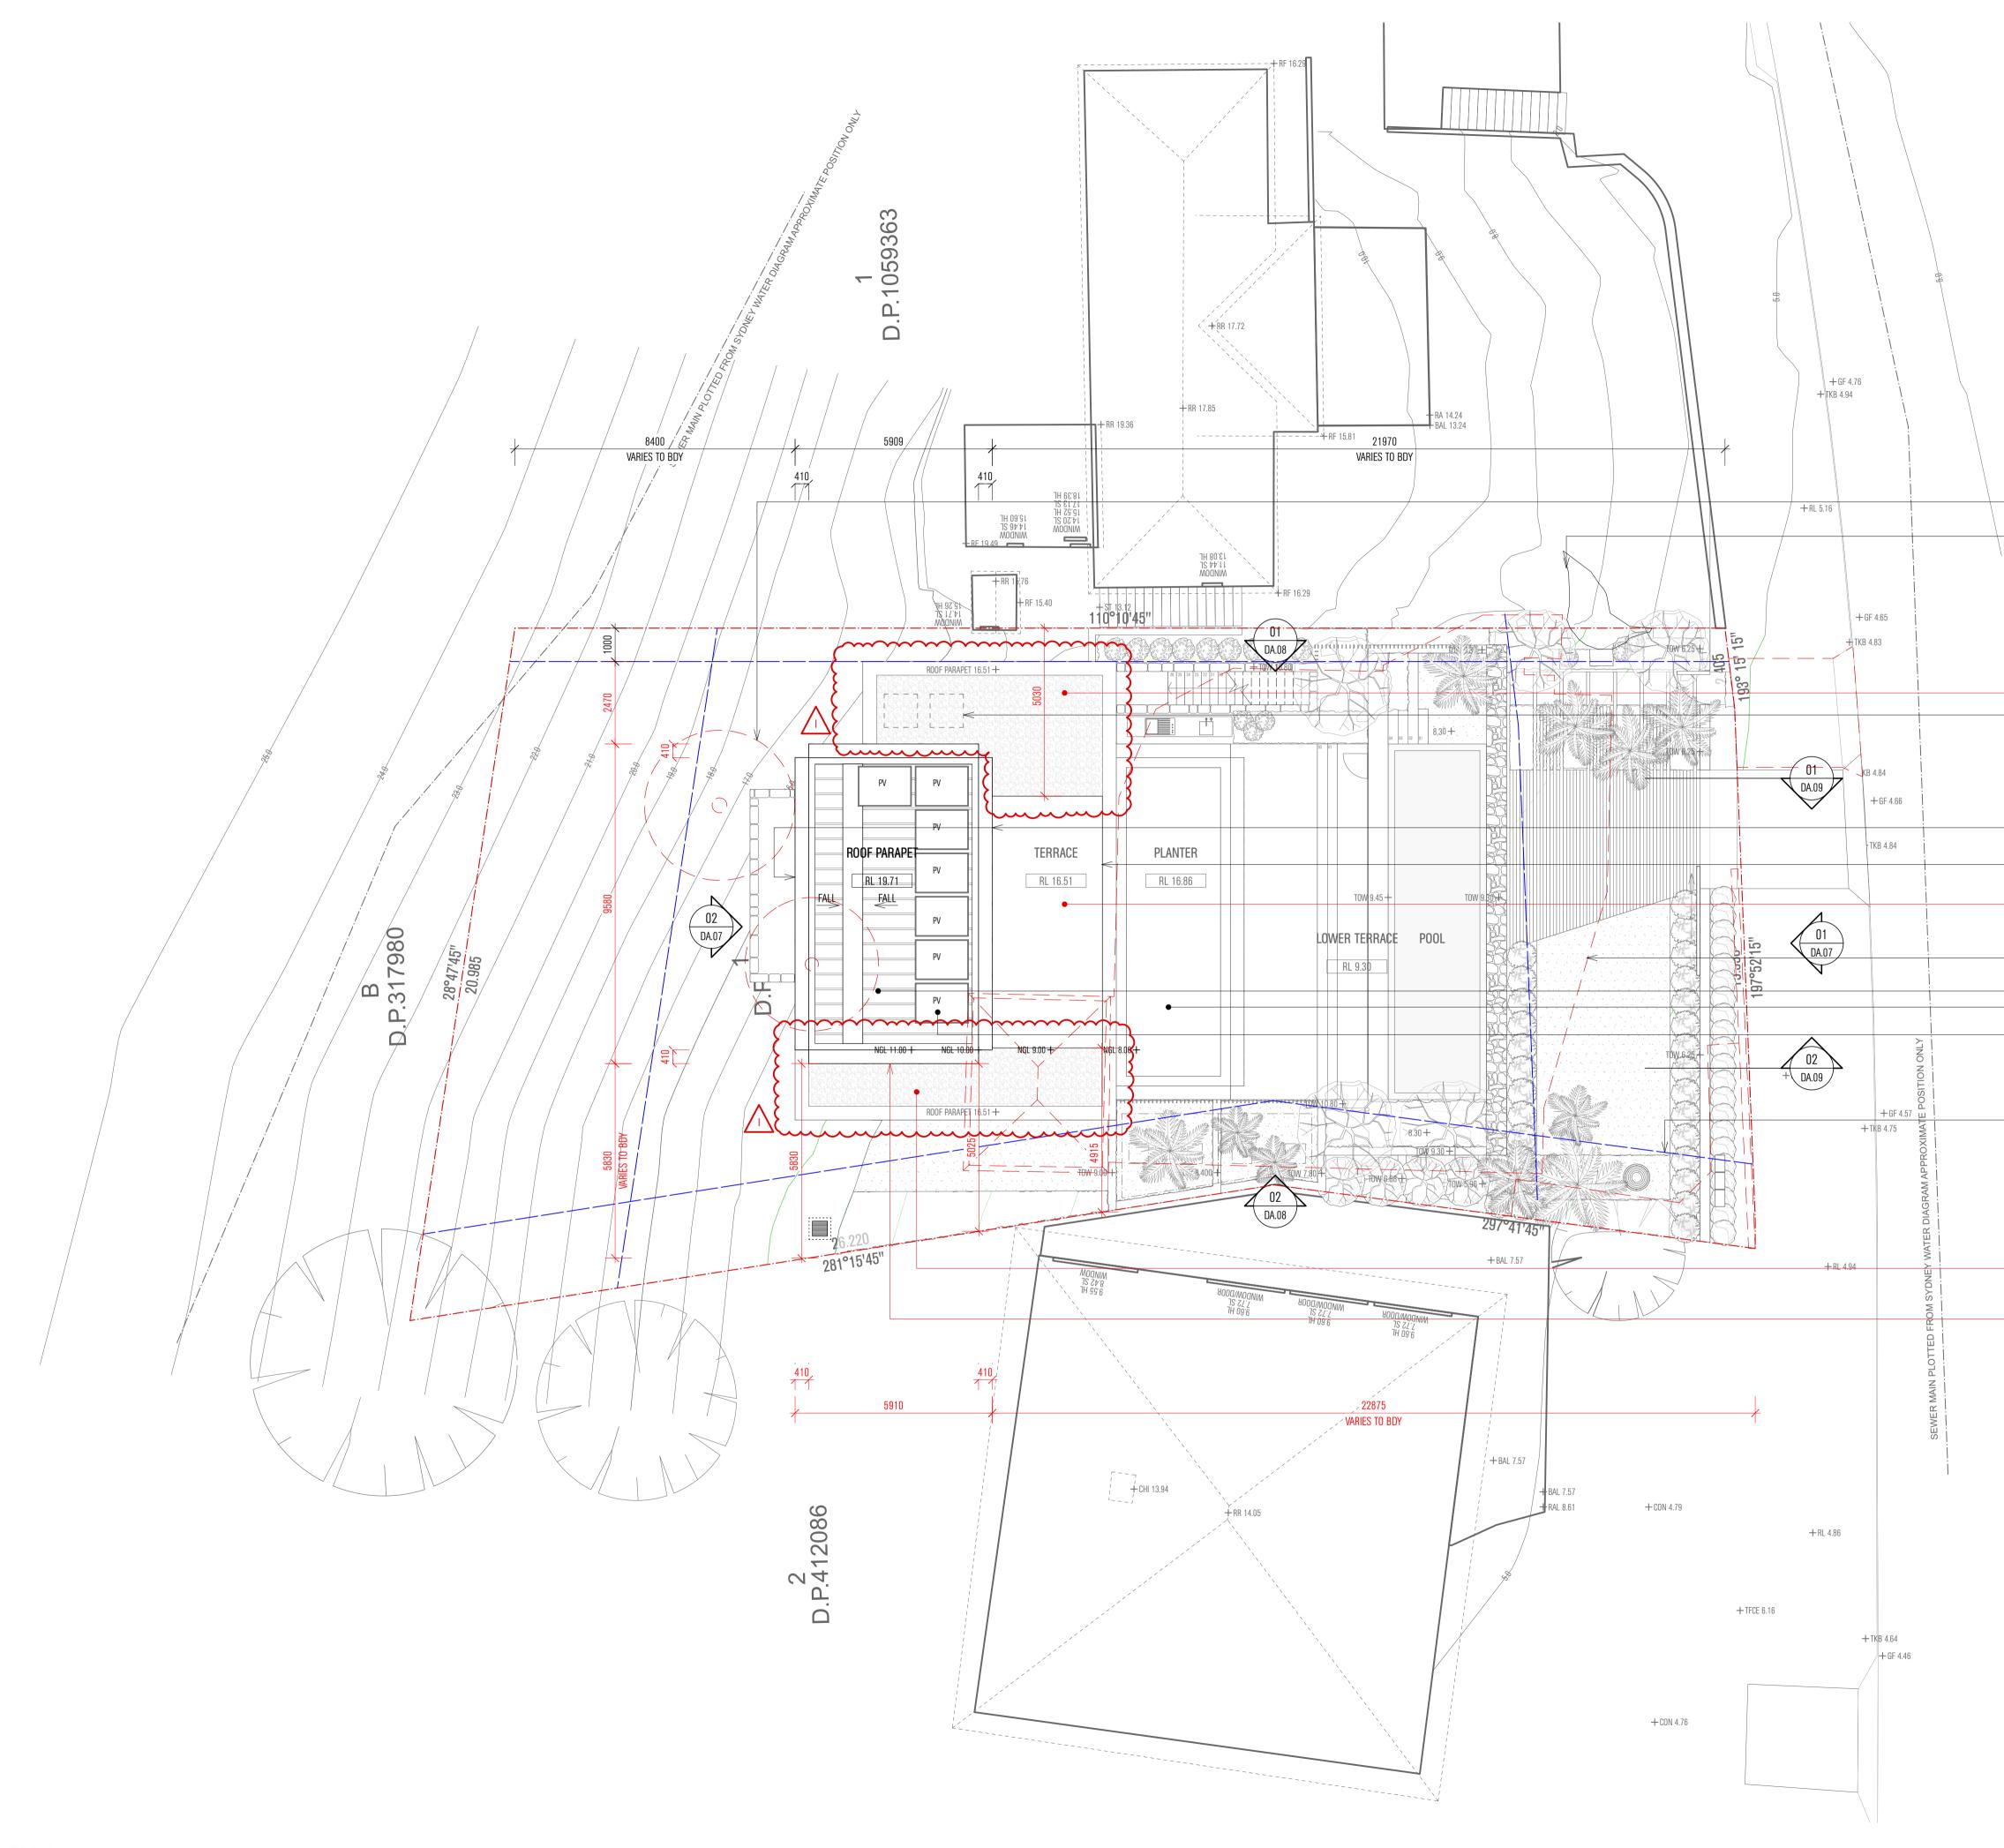
PROJECT	ocean road) residence		
ADDRESS	14 Ocean R	OAD		
	Palm Beach	1 2108		
DOCUMENT	DEVELOPME	NT APPLICATIO	N	
DRAWING	PLAN			
DRAWING	PLAN LEVEL 2			
DRAWING DATE		SCALE	1:100	



DRAWING NO. DA.05 REV NO.

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Site Boundary

LEGEND

(///)

Council setbacks / Height requirements Brick wall 110mm + 10mm render

Blockwork wall



Concrete structure Stone clad masonry wall 600mm Lightweight walls 110mm + 10mm lining Timber structure 130mm

New glazing

HWU - Hot Water Unit CU - Condenser Unit PV - Photovoltaic Panels RW - Rainwater Tank



NOTES

– New pebbled roof above stair.

- Existing site trees removed as per

Arborist Report recommendation.

- Natural rock formation to Northern

site boundary to be retained.

– MATV/PAYTV Antenna located on roof.

- Horizontal timber louvres to front of sliding aluminium window.

– 1000mm high frameless glass balustrade.

- Level 02 Terrace trafficable area reduced and brought in from both North + South boundary's.

 Existing house to be demolished shown red dashed. – Metal deck roof.

Low level roof planter to L2 Terrace.

– Solar PV system to suit energy requirements to roof.

- Council setback's shown dashed in blue.

+RL 4.78

- New pebbled roof above Bedroom 04 and Ensuite's.

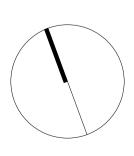
- Level 02 building envelope reduced and brought in from the Southern boundary by 1300mm.



rev no.	DATE	REVISIONS	BY	СНК
A	12.07.21	Issue for Consultant Coordination	ES	ES
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C	24.08.21	Issue for Consultant Coordination	ES	ES
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F	15.10.21	DA Issue	DB	ES
G	22.10.21	DA Issue	DB	ES
Н	30.03.22	DA Amendment	DB	ES
	06.04.22	DA Amendment	DB	

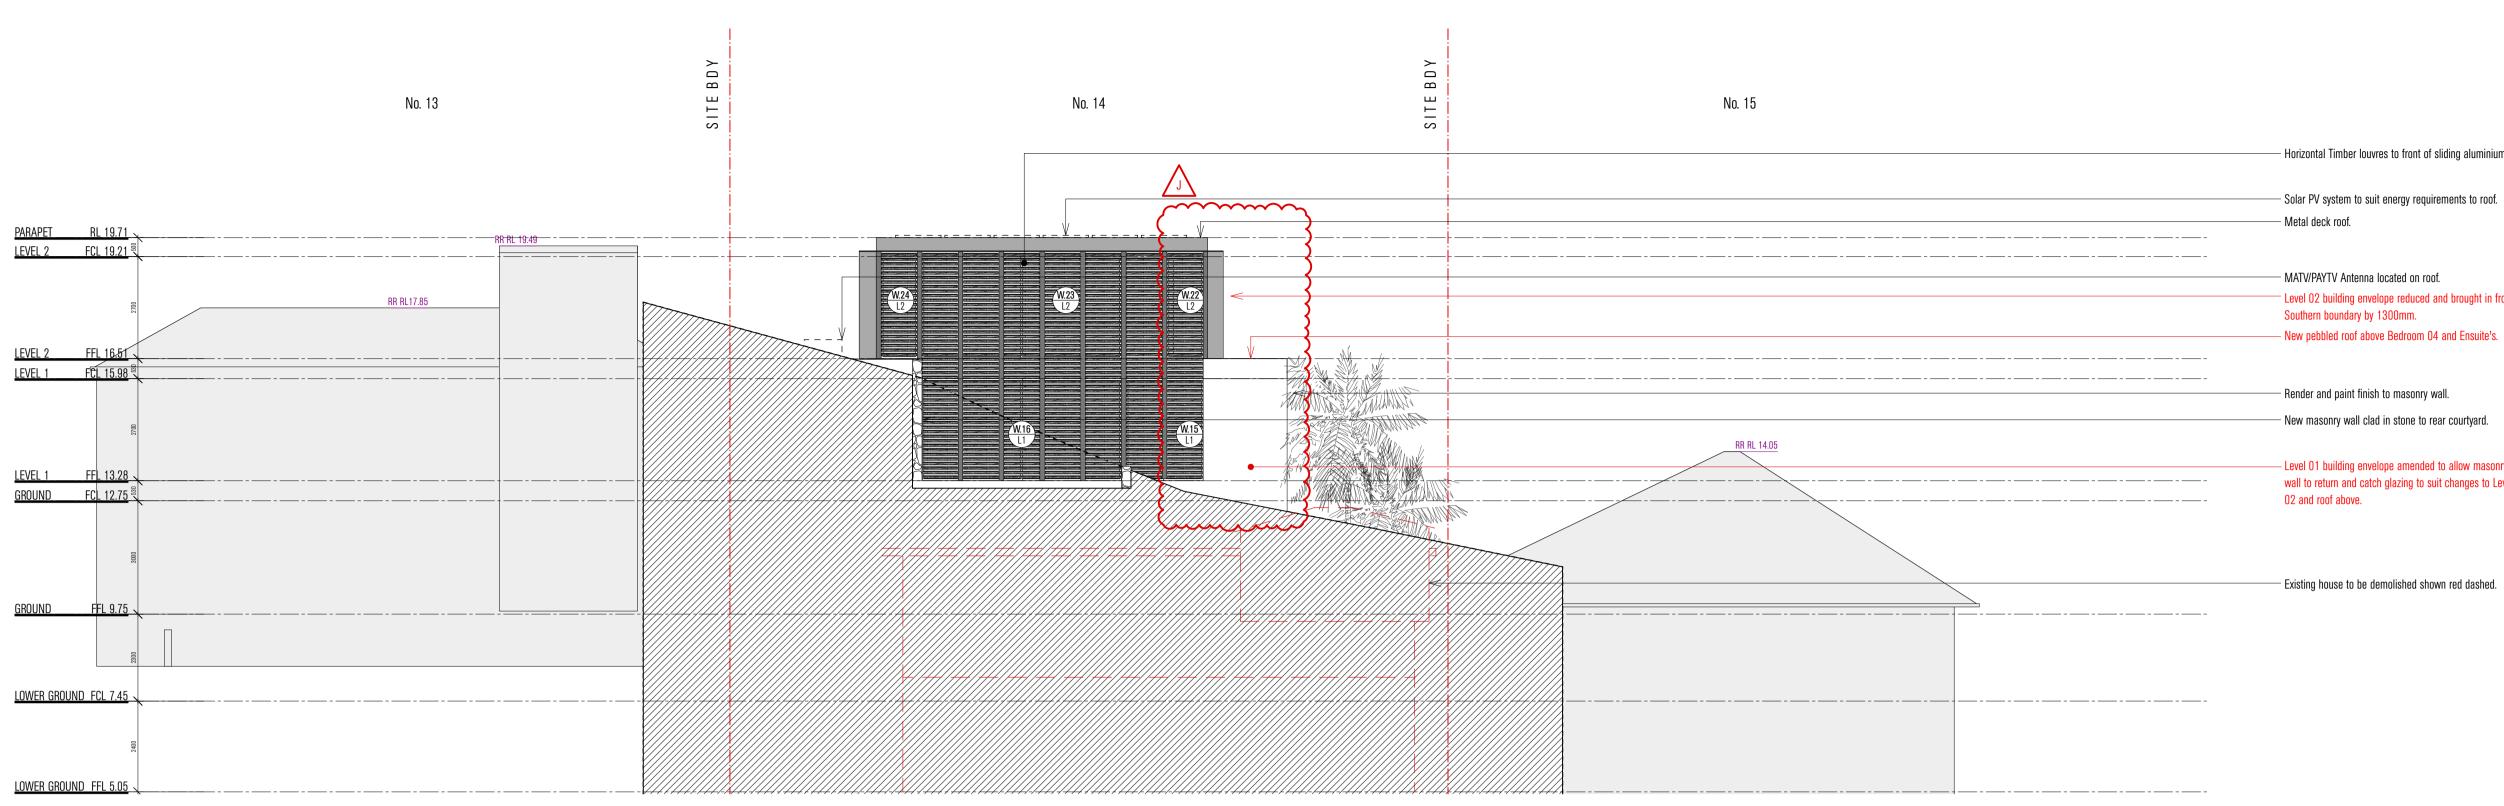
PROJECT OCEAN ROAD RESIDENCE ADDRESS 14 OCEAN ROAD PALM BEACH 2108 DOCUMENT DEVELOPMENT APPLICATION DRAWING PLAN

	ROOF		
DATE	06.04.22	SCALE	1:100
DRAWN	ES	project no.	21006
DRAWING NO.	DA.06	rev no.	

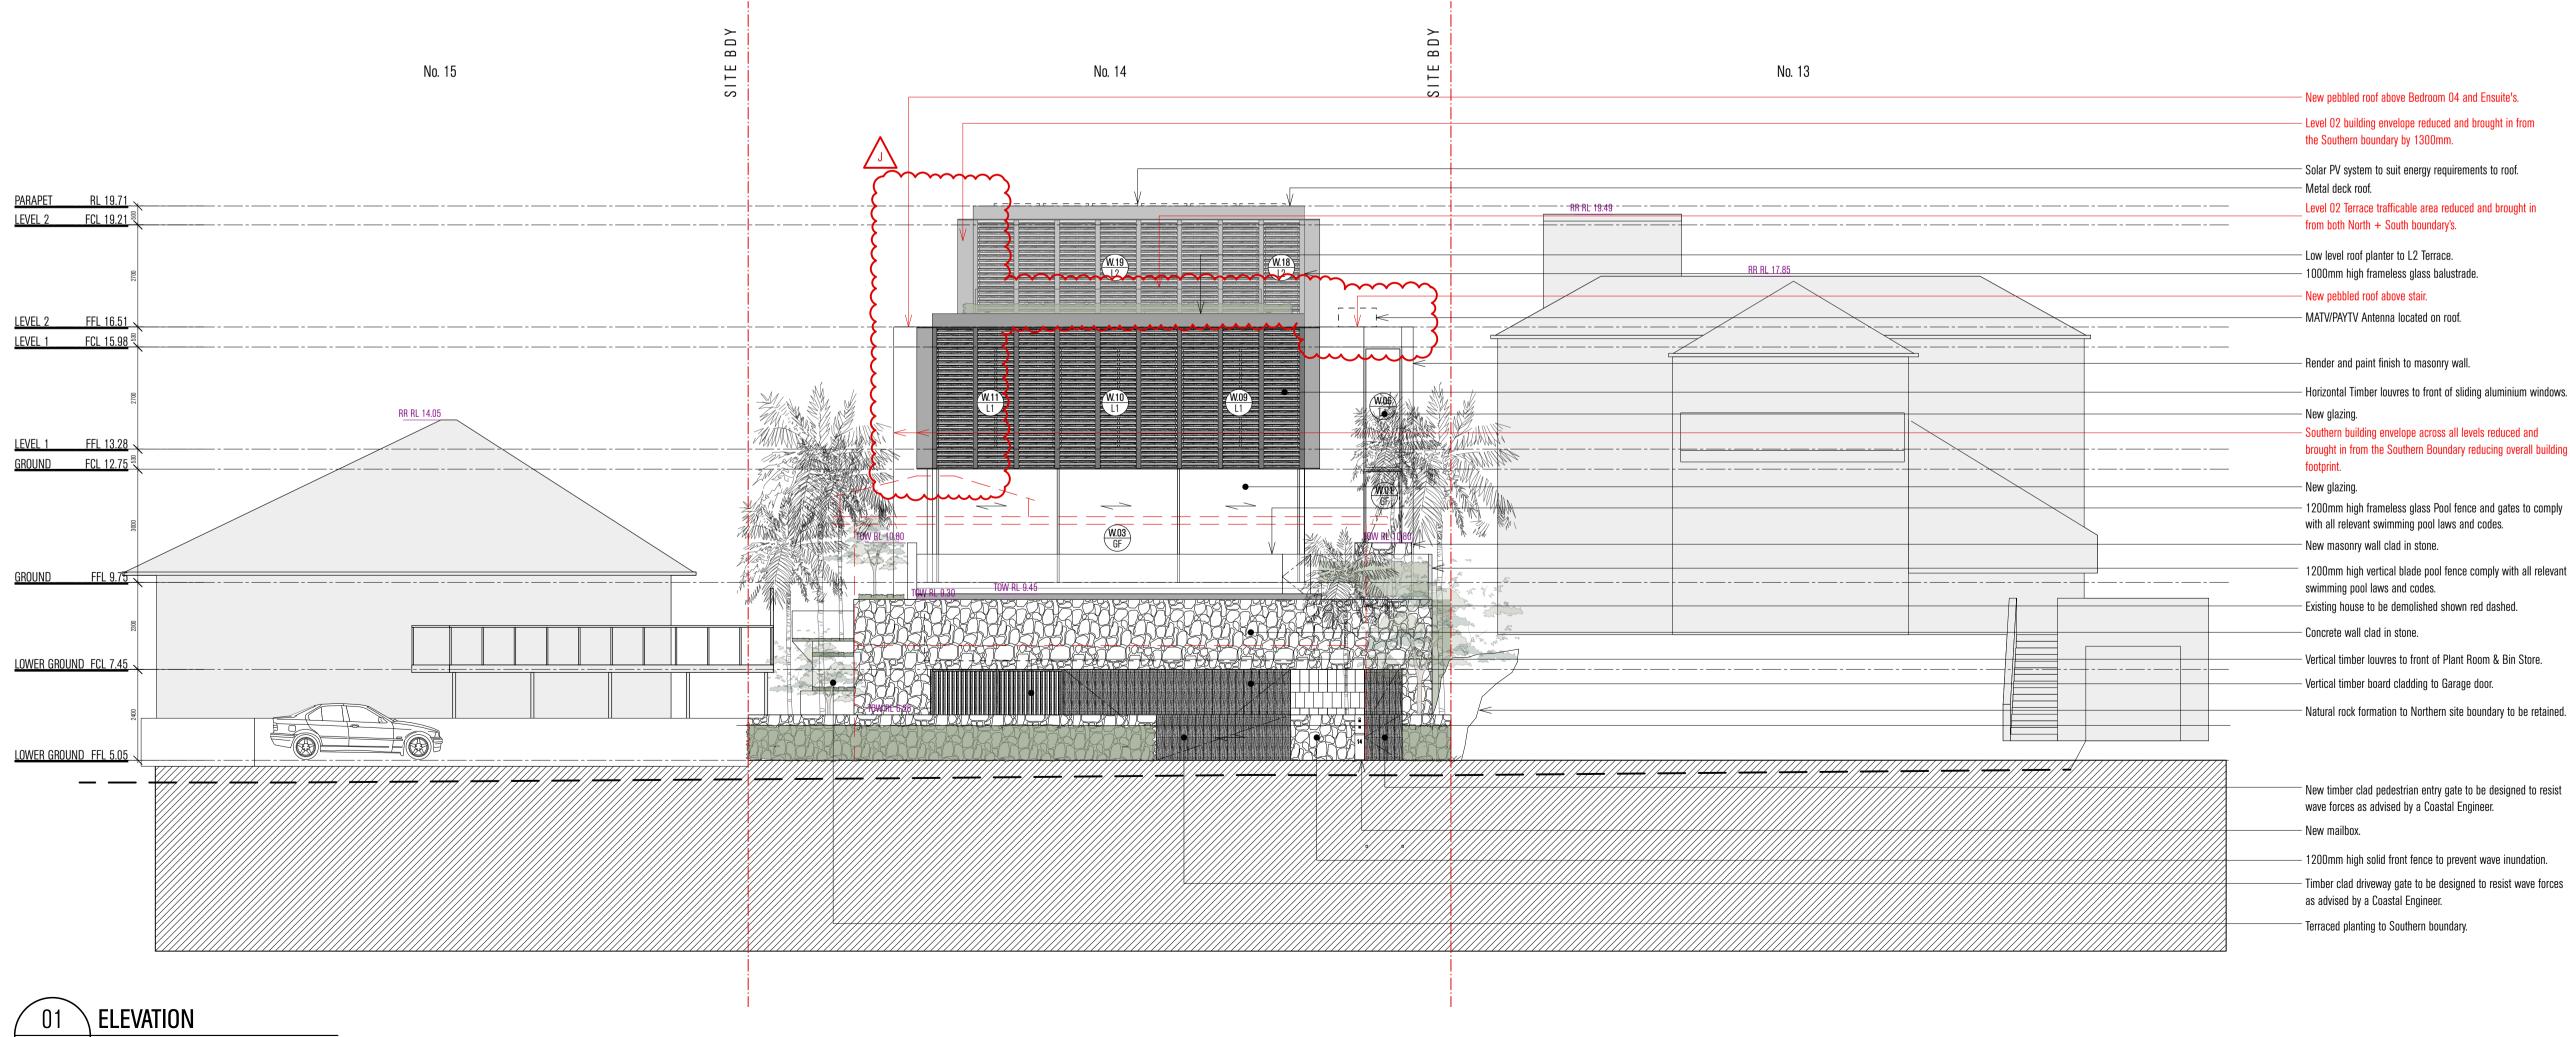


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[/]East Scale 1:100

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Site Boundary

LEGEND

	:	:二
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С		

Architect's interpretation of natural ground line.

Council setbacks / Height requirements from Architect's interpretation of natural ground line. Section cut taken from site contours modified for the existing house.

- Horizontal Timber louvres to front of sliding aluminium windows.

– Solar PV system to suit energy requirements to roof.

– MATV/PAYTV Antenna located on roof. $^-$ Level O2 building envelope reduced and brought in from the $^-$ Southern boundary by 1300mm.

- Render and paint finish to masonry wall.

- New masonry wall clad in stone to rear courtyard.

- Level 01 building envelope amended to allow masonry wall to return and catch glazing to suit changes to Level

- Existing house to be demolished shown red dashed.

- Level 02 building envelope reduced and brought in from the Southern boundary by 1300mm.

- Solar PV system to suit energy requirements to roof.

Level 02 Terrace trafficable area reduced and brought in from both North + South boundary's.

— Low level roof planter to L2 Terrace. – 1000mm high frameless glass balustrade. — New pebbled roof above stair.

— MATV/PAYTV Antenna located on roof.

– Horizontal Timber louvres to front of sliding aluminium windows.

- Southern building envelope across all levels reduced and brought in from the Southern Boundary reducing overall building

– 1200mm high frameless glass Pool fence and gates to comply with all relevant swimming pool laws and codes.

1200mm high vertical blade pool fence comply with all relevant swimming pool laws and codes.

– Existing house to be demolished shown red dashed.

- Vertical timber louvres to front of Plant Room & Bin Store.

[–] New timber clad pedestrian entry gate to be designed to resist

wave forces as advised by a Coastal Engineer.

– 1200mm high solid front fence to prevent wave inundation. - Timber clad driveway gate to be designed to resist wave forces



7 M

NOTES

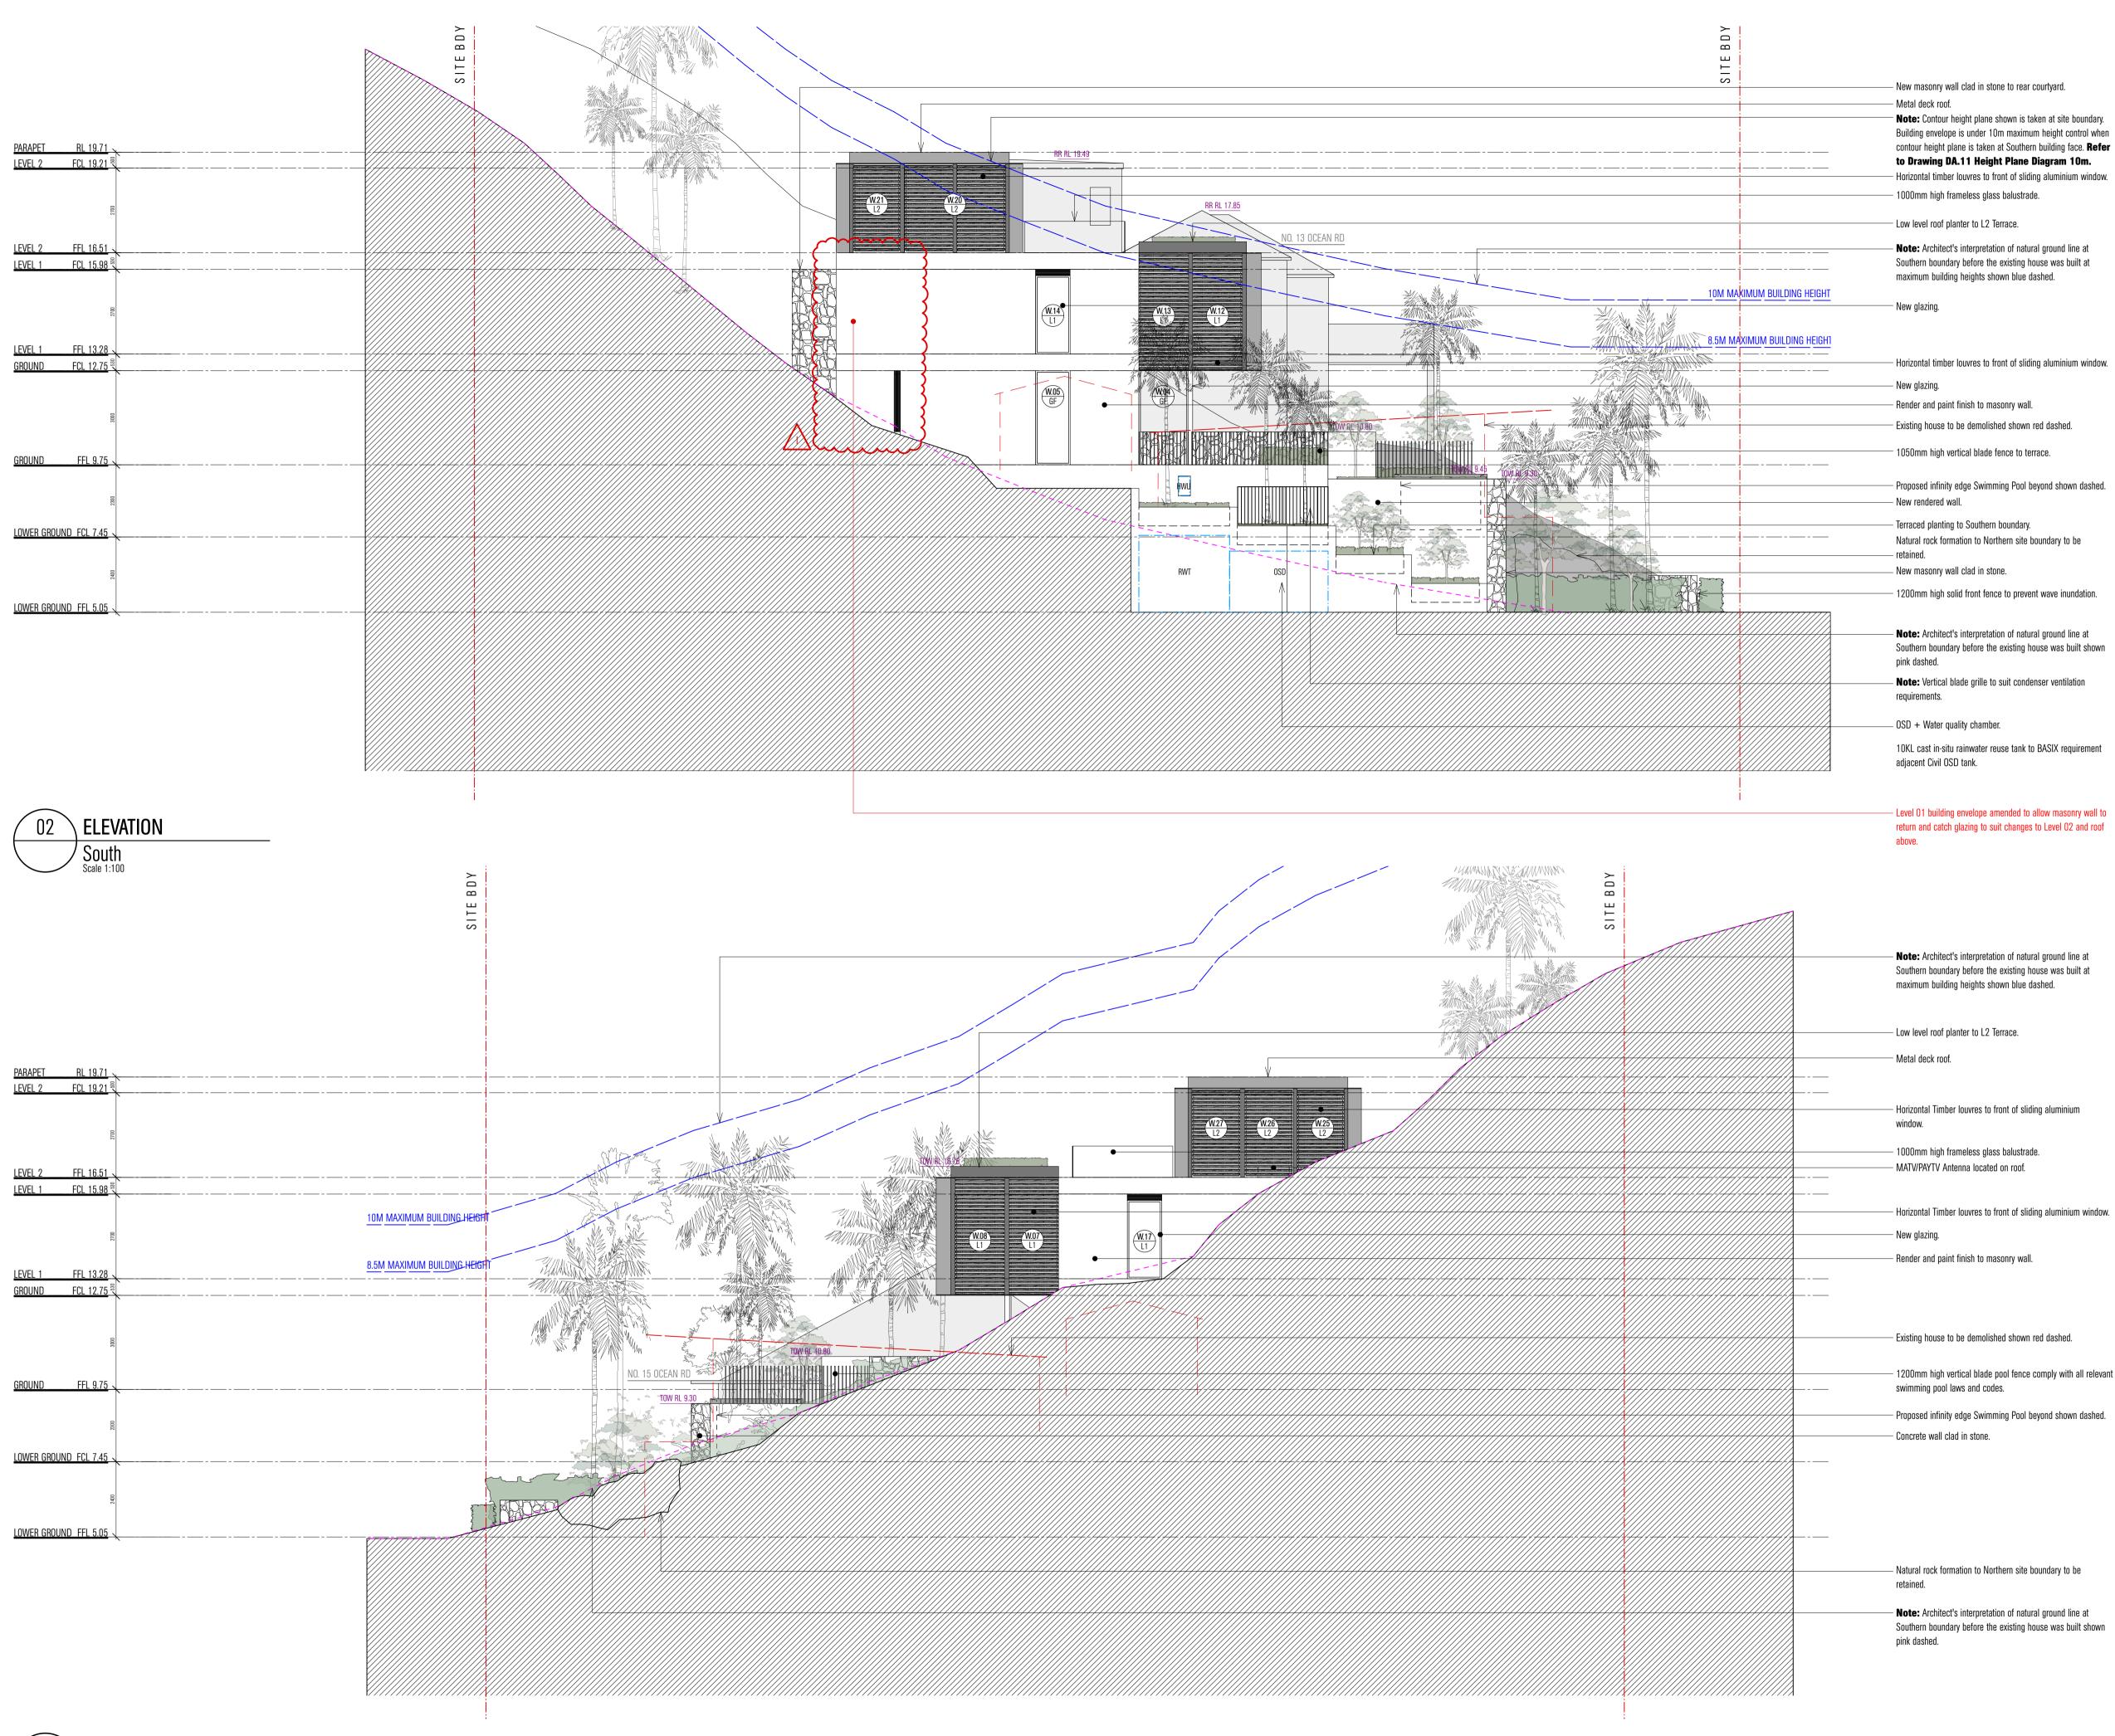
rev no.	DATE	REVISIONS	BY	СНК
A	12.07.21	Issued for Consultant Coordination	DB	ES
В	16.07.21	Pre-DA Package	DB	ES
С	24.08.21	Issue for Consultant Coordination	DB	ES
D	22.09.21	Issue for Consultant Coordination	DB	ES
E	11.10.21	Issue for Consultant Coordination	DB	
F	15.10.21	DA Issue	DB	ES
G	22.10.21	DA Issue	DB	ES
Н	11.11.21	DA Issue	DB	ES
I	30.03.22	DA Amendment	DB	ES
J	08.04.22	Revised DA Issue	ES	

PROJECT	ocean road	RESIDENCE	
ADDRESS	14 Ocean Ro	DAD	
	PALM BEACH	I 2108	
DOCUMENT	DEVELOPMEI	NT APPLICATION	N
DRAWING	ELEVATIONS		
	EAST AND W	EST	
DATE	08.04.22	SCALE	1:100@A1
DRAWN	DB	PROJECT NO.	21006

drawing no. DA.07 rev no. J

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ELEVATION 01 North Scale 1:100

– New masonry wall clad in stone to rear courtyard.

Note: Contour height plane shown is taken at site boundary. Building envelope is under 10m maximum height control when contour height plane is taken at Southern building face. Refer to Drawing DA.11 Height Plane Diagram 10m. – Horizontal timber louvres to front of sliding aluminium window. - 1000mm high frameless glass balustrade.

 Note: Architect's interpretation of natural ground line at Southern boundary before the existing house was built at maximum building heights shown blue dashed.

– Horizontal timber louvres to front of sliding aluminium window.

- Render and paint finish to masonry wall.

[–] 1050mm high vertical blade fence to terrace.

- Proposed infinity edge Swimming Pool beyond shown dashed.

– Terraced planting to Southern boundary. Natural rock formation to Northern site boundary to be

- 1200mm high solid front fence to prevent wave inundation.

 Note: Architect's interpretation of natural ground line at Southern boundary before the existing house was built shown

- **Note:** Vertical blade grille to suit condenser ventilation

10KL cast in-situ rainwater reuse tank to BASIX requirement

return and catch glazing to suit changes to Level 02 and roof

- Note: Architect's interpretation of natural ground line at Southern boundary before the existing house was built at

– Horizontal Timber louvres to front of sliding aluminium

- 1000mm high frameless glass balustrade.

– Horizontal Timber louvres to front of sliding aluminium window.

– Render and paint finish to masonry wall.

- Existing house to be demolished shown red dashed.

- 1200mm high vertical blade pool fence comply with all relevant

- Proposed infinity edge Swimming Pool beyond shown dashed.

– Natural rock formation to Northern site boundary to be

 Note: Architect's interpretation of natural ground line at Southern boundary before the existing house was built shown MATHIESON ARCHITECTS

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Site Boundary

LEGEND ----

Council setbacks / Height requirements from Architect's interpretation of natural ground line. Section cut taken from site contours modified for the existing house.

Architect's interpretation of natural ground line.

XXXXXXX	0006687636 19 Oct 2021
5.1	Assessor Robert Romanous Accreditation No. 101535 Address
HOUSE ENERGY RATING SCHEME	14 Ocean Road, Palm Beach,
64.9	NSW , 2108
www.nathers.gov.au	hstar.com.au

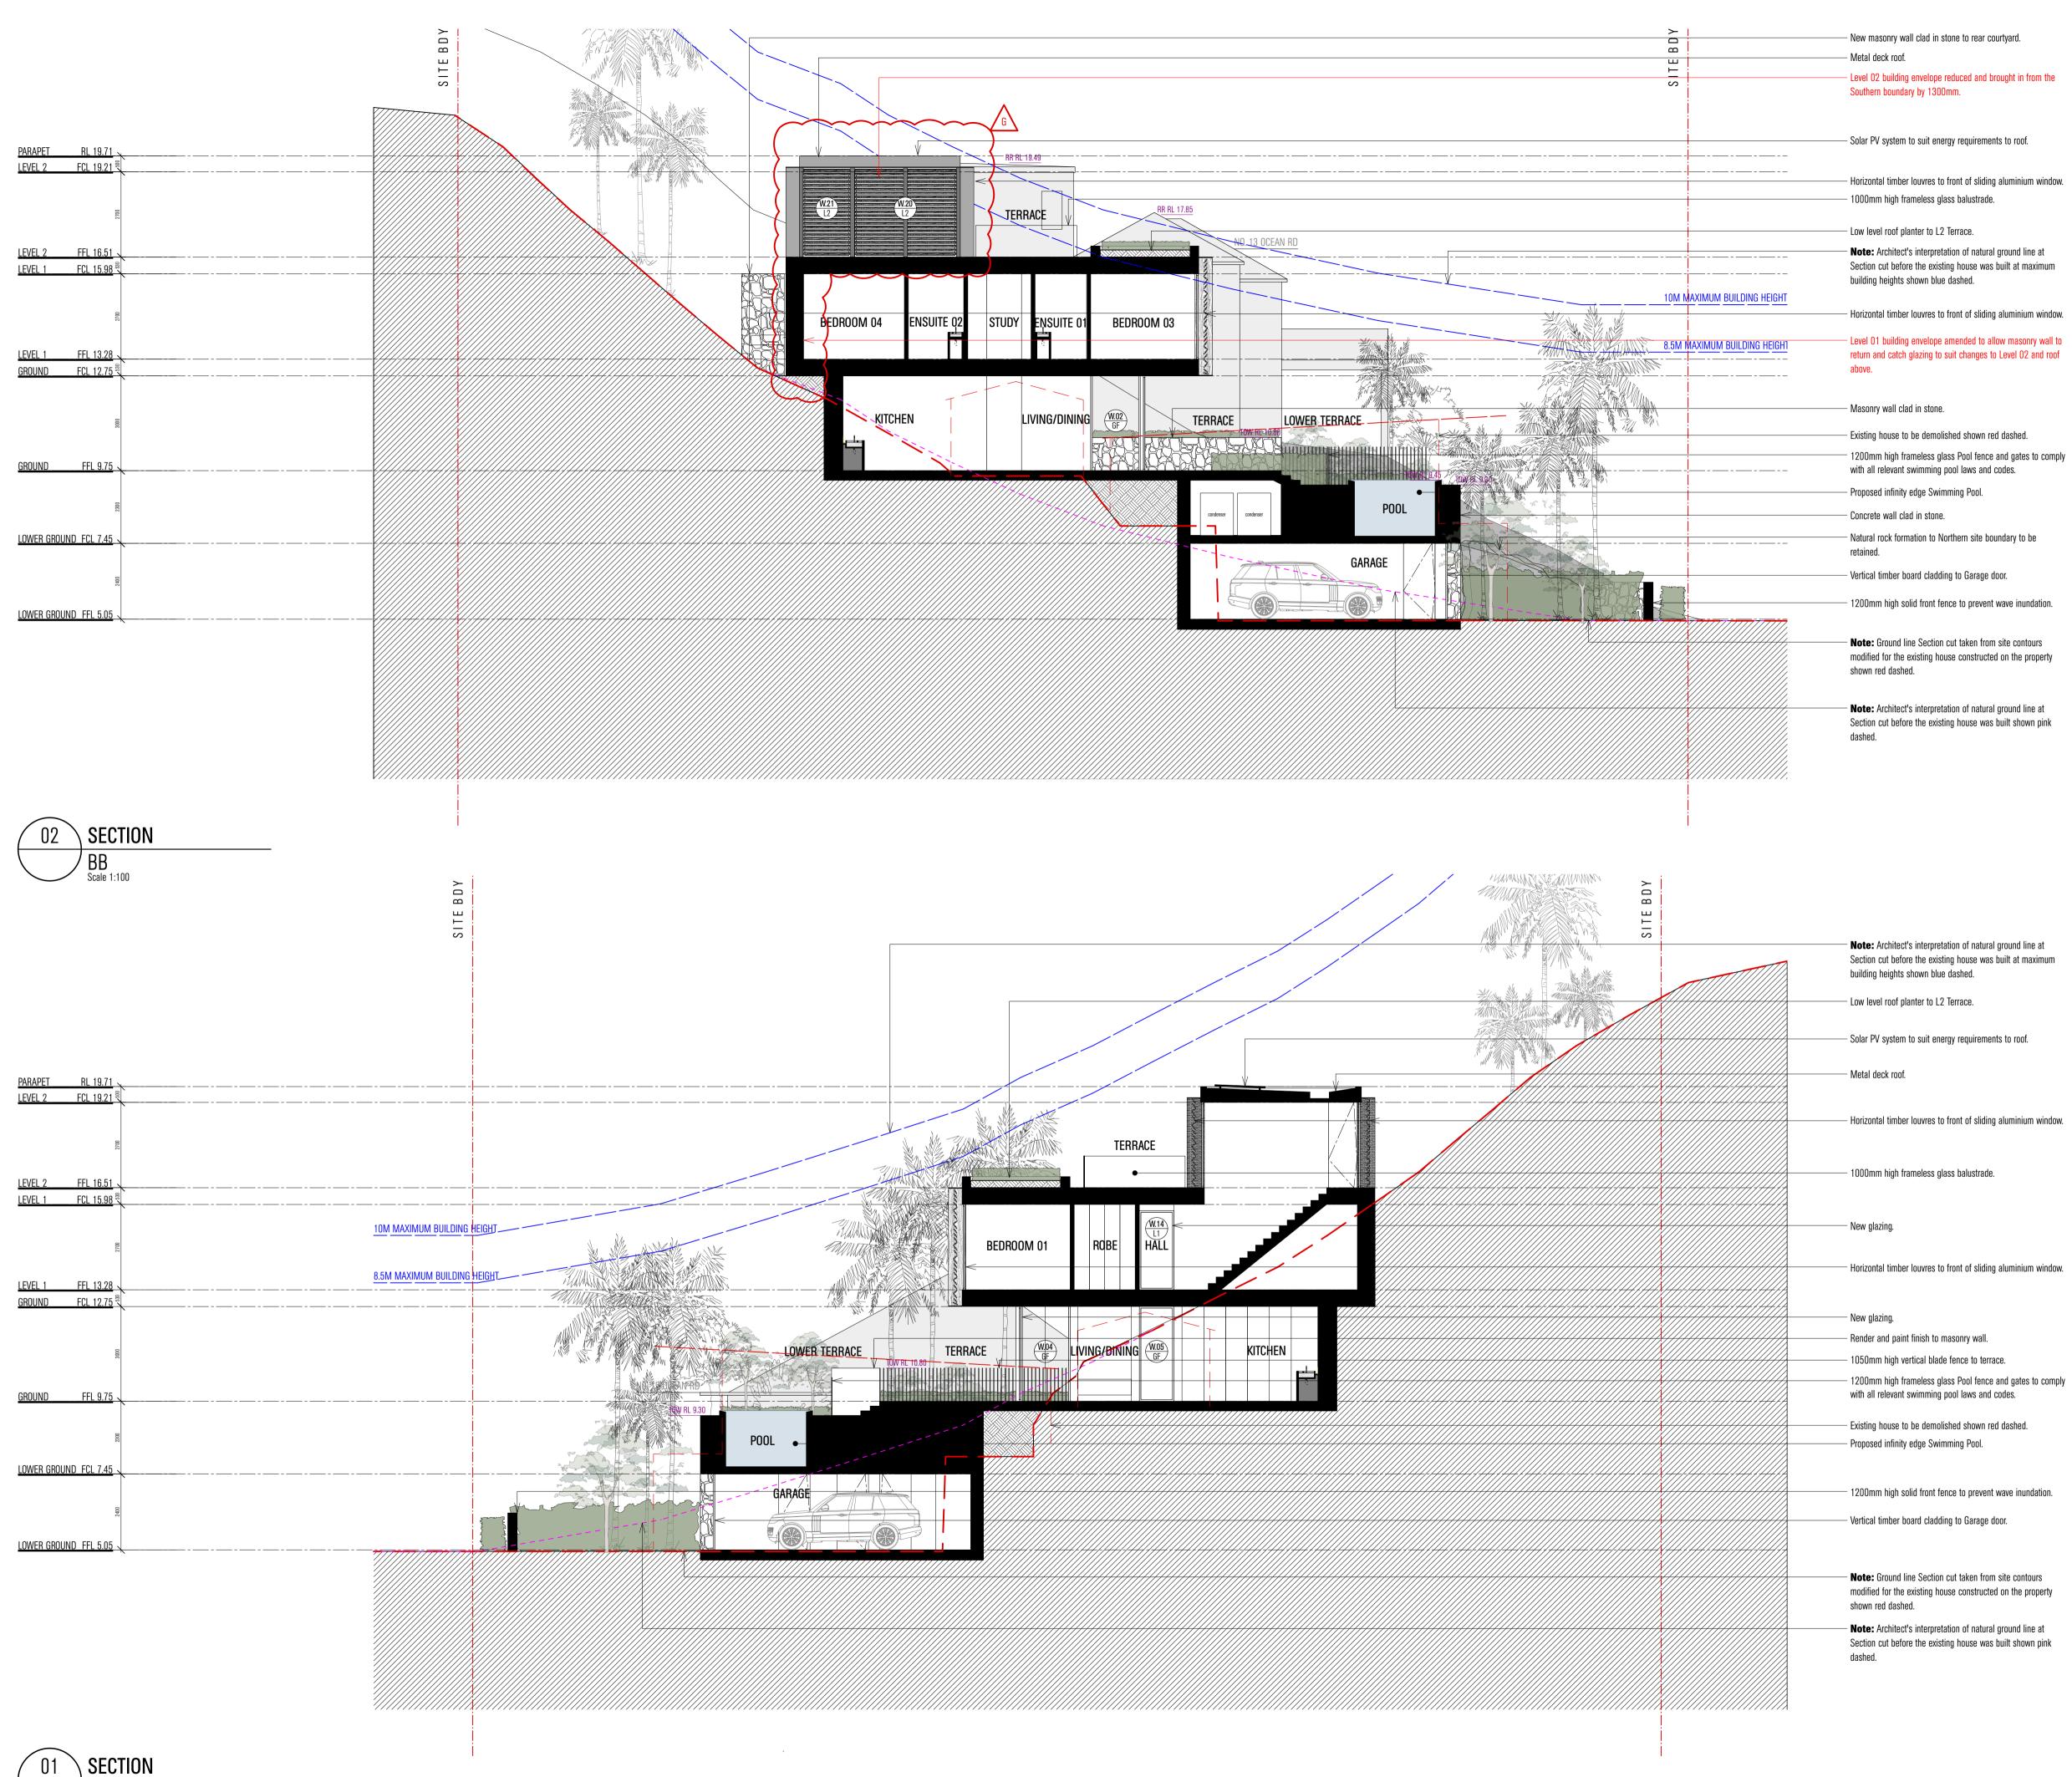
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rev no.	DATE	REVISIONS	BY	СНК
A	12.07.21	Issued for Consultant Coordination	DB	ES
В	16.07.21	Pre-DA Package	DB	ES
С	24.08.21	Issue for Consultant Coordination	DB	ES
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F	15.10.21	DA Issue	DB	ES
G	22.10.21	DA Issue	DB	ES
Н	30.03.22	DA Amendment	DB	ES
	08.04.22	Revised DA Issue	ES	
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PROJECT	OCEAN ROAD	RESIDENCE	
ADDRESS	14 OCEAN RO	٩D	
	PALM BEACH	2108	
DOCUMENT	DEVELOPMEN	T APPLICATION	N
DRAWING	ELEVATIONS		
DRAWING	elevations North and S	OUTH	
DRAWING		OUTH	1:100@A1
	NORTH AND S		1:100@A1 21006

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Site Boundary

LEGEND ----

Council setbacks / Height requirements from Architect's interpretation of natural ground line. Section cut taken from site contours modified for the existing house.

Architect's interpretation of natural ground line.

A A A A A	0006687636 19 Oct 2021
5.1	Assessor Robert Romanous
	Accreditation No. 101535
NATIONWIDE	Address
HOUSE ENERGY RATING SCHEME	14 Ocean Road , Palm Beach , NSW , 2108
64.9	
MJ/m ²	. NOW . ZIUNES
www.nathers.gov.au	hstar.com.au
www.nathers.gov.au	hstar.com.au

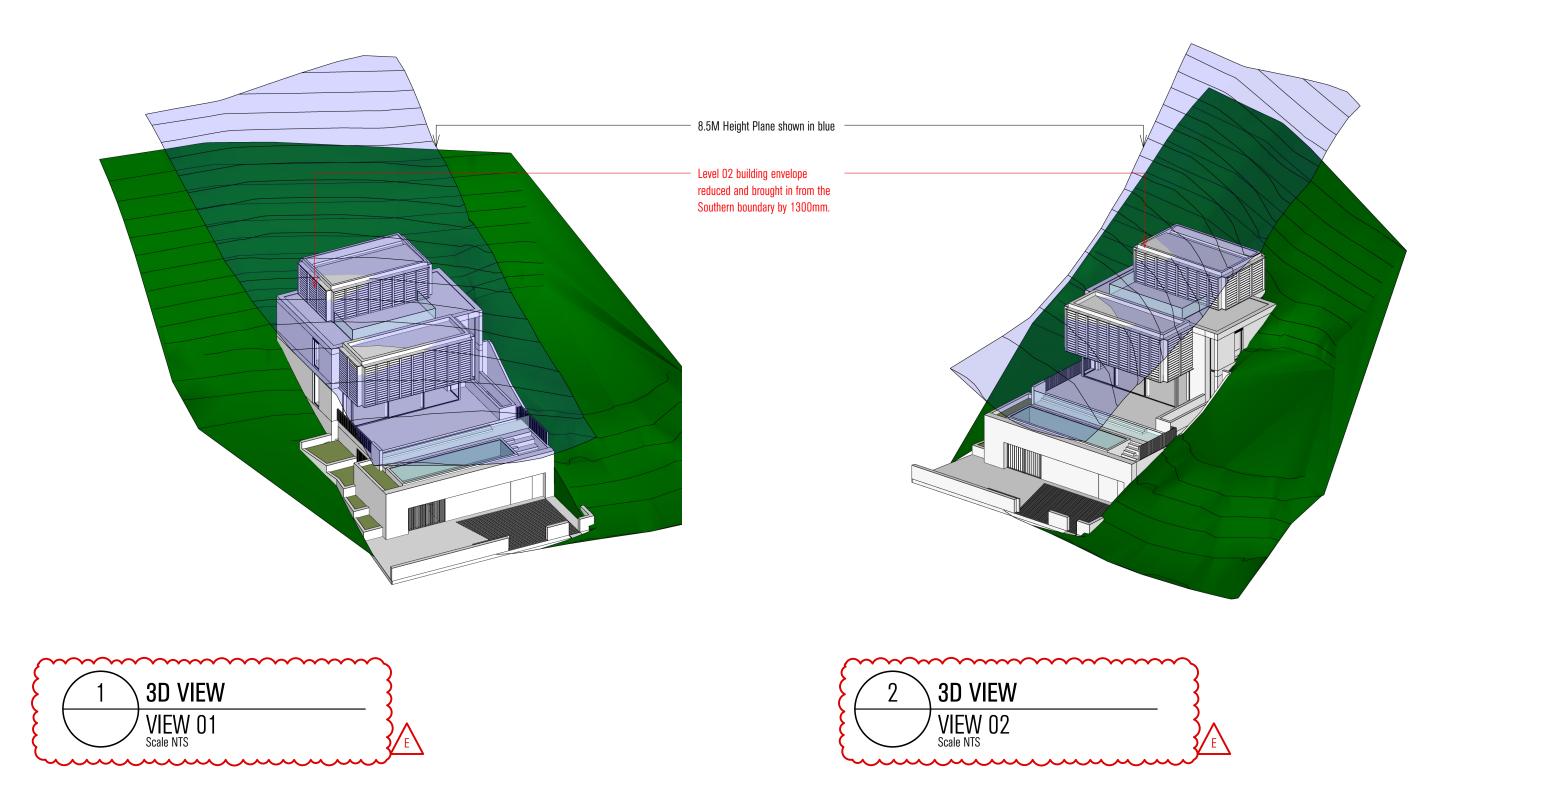
NOTES

REV NO. DATE REVISIONS BY CHK 12.07.21 Issued for Consultant Coordination DB ES 16.07.21 Pre-DA Package DB ES 24.08.21 Issue for Consultant Coordination DB ES 22.09.21 Issue for Consultant Coordination DB 11.10.21 Issue for Consultant Coordination DB DB ES 15.10.21 DA Issue G 08.04.22 Revised DA Issue FS _____ _ _ _ ____ ____ _____ _ ___ __ _____ _____ _____ _ __ __ _____ _____ _____ _____

PROJECT	ocean road	RESIDENCE	
ADDRESS	14 OCEAN RC)AD	
	Palm Beach	2108	
DOCUMENT	DEVELOPMEN	IT APPLICATION	N
DRAWING	SECTIONS		
DRAWING	Sections Aa Bb		
DRAWING		SCALE	1:100@A1
	AA BB	SCALE PROJECT NO.	04000

DISCLAIMER

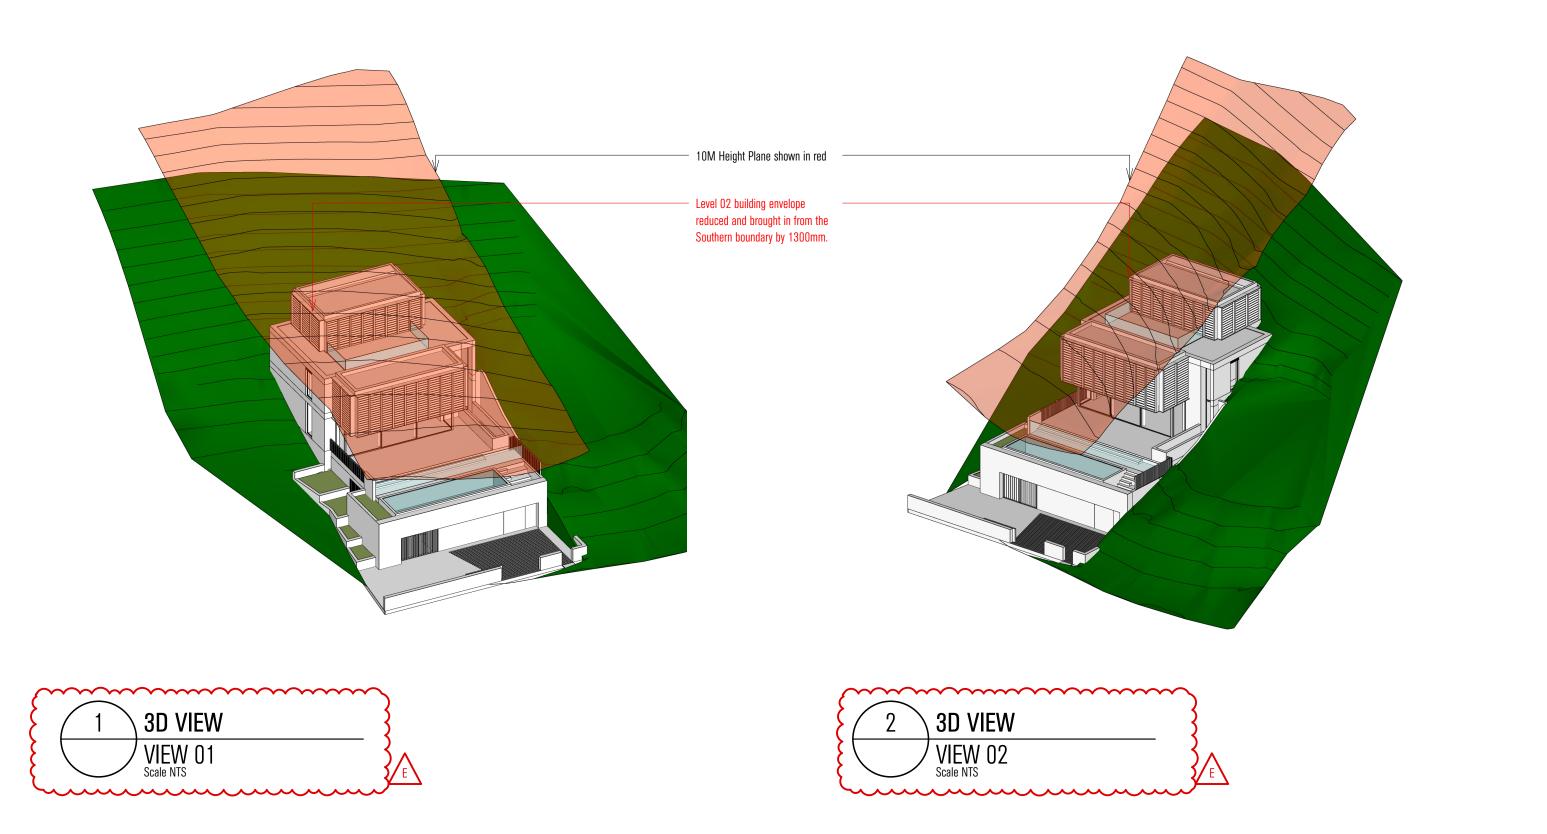
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PROJECT	OCEAN ROAD RESIDENCE	DRAWING	3D VIEW		
ADDRESS	14 OCEAN ROAD		HEIGHT PLA	NE DIAGRAM ((8.5M)
	PALM BEACH 2108	DATE	08.04.22	SCALE	NTS
DOCUMENT	DEVELOPMENT APPLICATION	DRAWING NO.	DA.10	REV NO.	E

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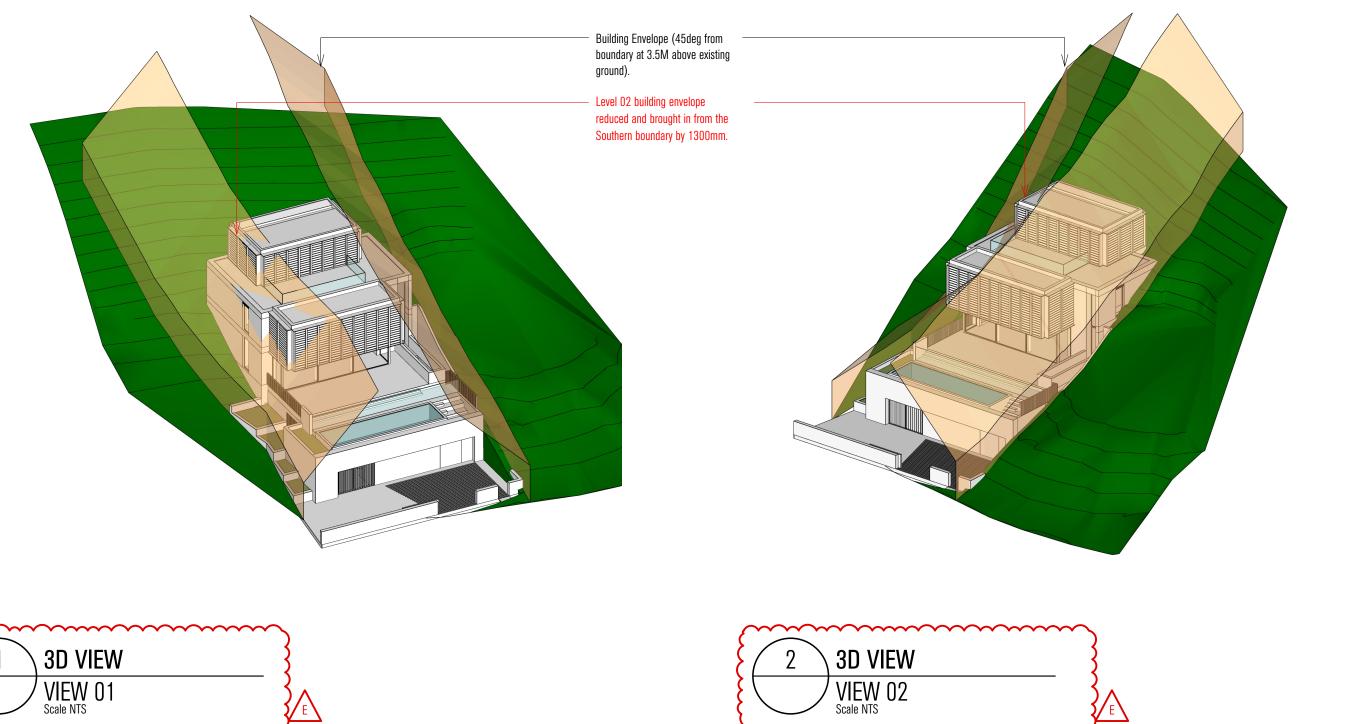


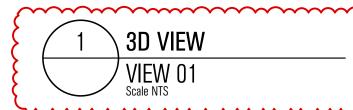


PROJECT	OCEAN ROAD RESIDENCE	DRAWING	3D VIEW		
ADDRESS	14 OCEAN ROAD		HEIGHT PLA	NE DIAGRAM (10M)
	PALM BEACH 2108	DATE	08.04.22	SCALE	NTS
DOCUMENT	DEVELOPMENT APPLICATION	DRAWING NO.	DA.11	REV NO.	E

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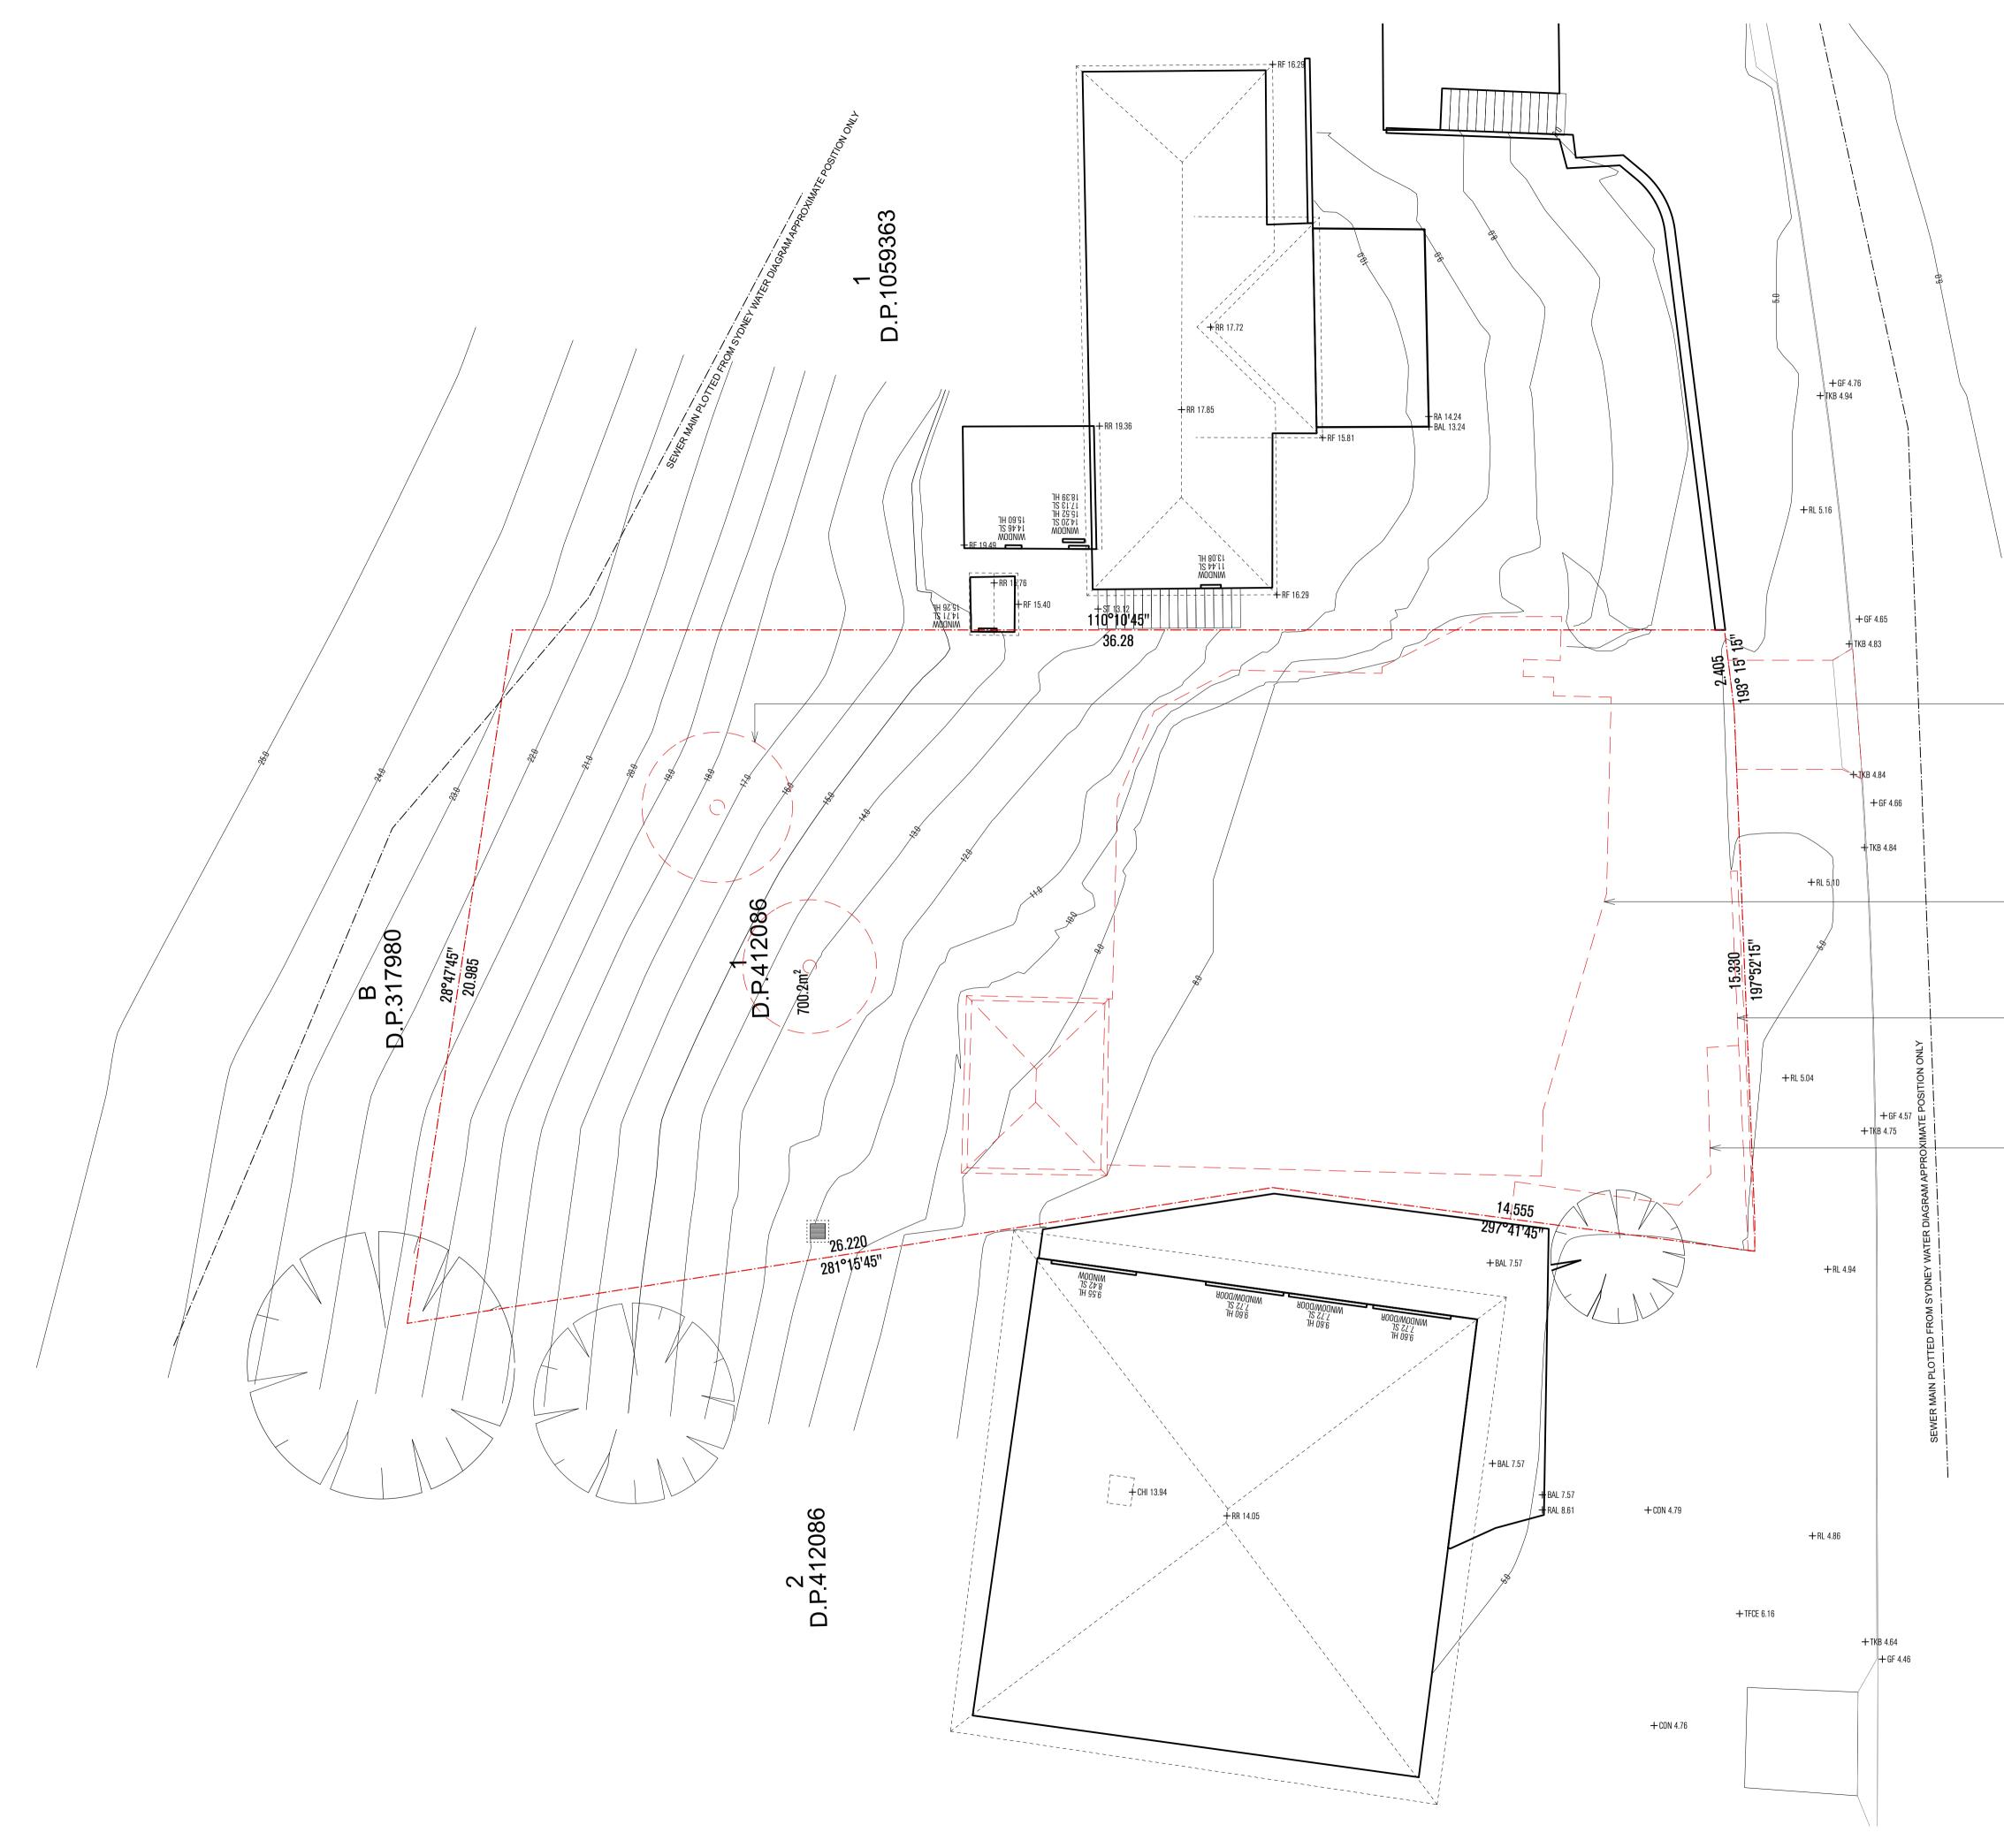




PROJECT	OCEAN ROAD RESIDENCE	DRAWING	3D VIEW		
ADDRESS	14 OCEAN ROAD		BUILDING E	NVELOPE DIAG	RAM
	PALM BEACH 2108	DATE	08.04.22	SCALE	NTS
DOCUMENT	DEVELOPMENT APPLICATION	DRAWING NO.	DA.12	REV NO.	E

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LEGEND

Existing house to be Demolished



NOTES

- Existing site trees removed as per Arborist Report recommendation.

 Existing house to be demolished shown red dashed.

 Existing front fence to be demolished shown red dashed.

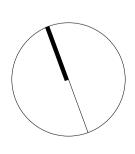
Existing concrete retaining wall to be demolished shown red dashed. + RL 4.78

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rev no.	DATE	REVISIONS	BY	СНК
A	22.09.21	Issue for Consultant Coordination	DB	ES
В	15.10.21	DA Issue	DB	ES

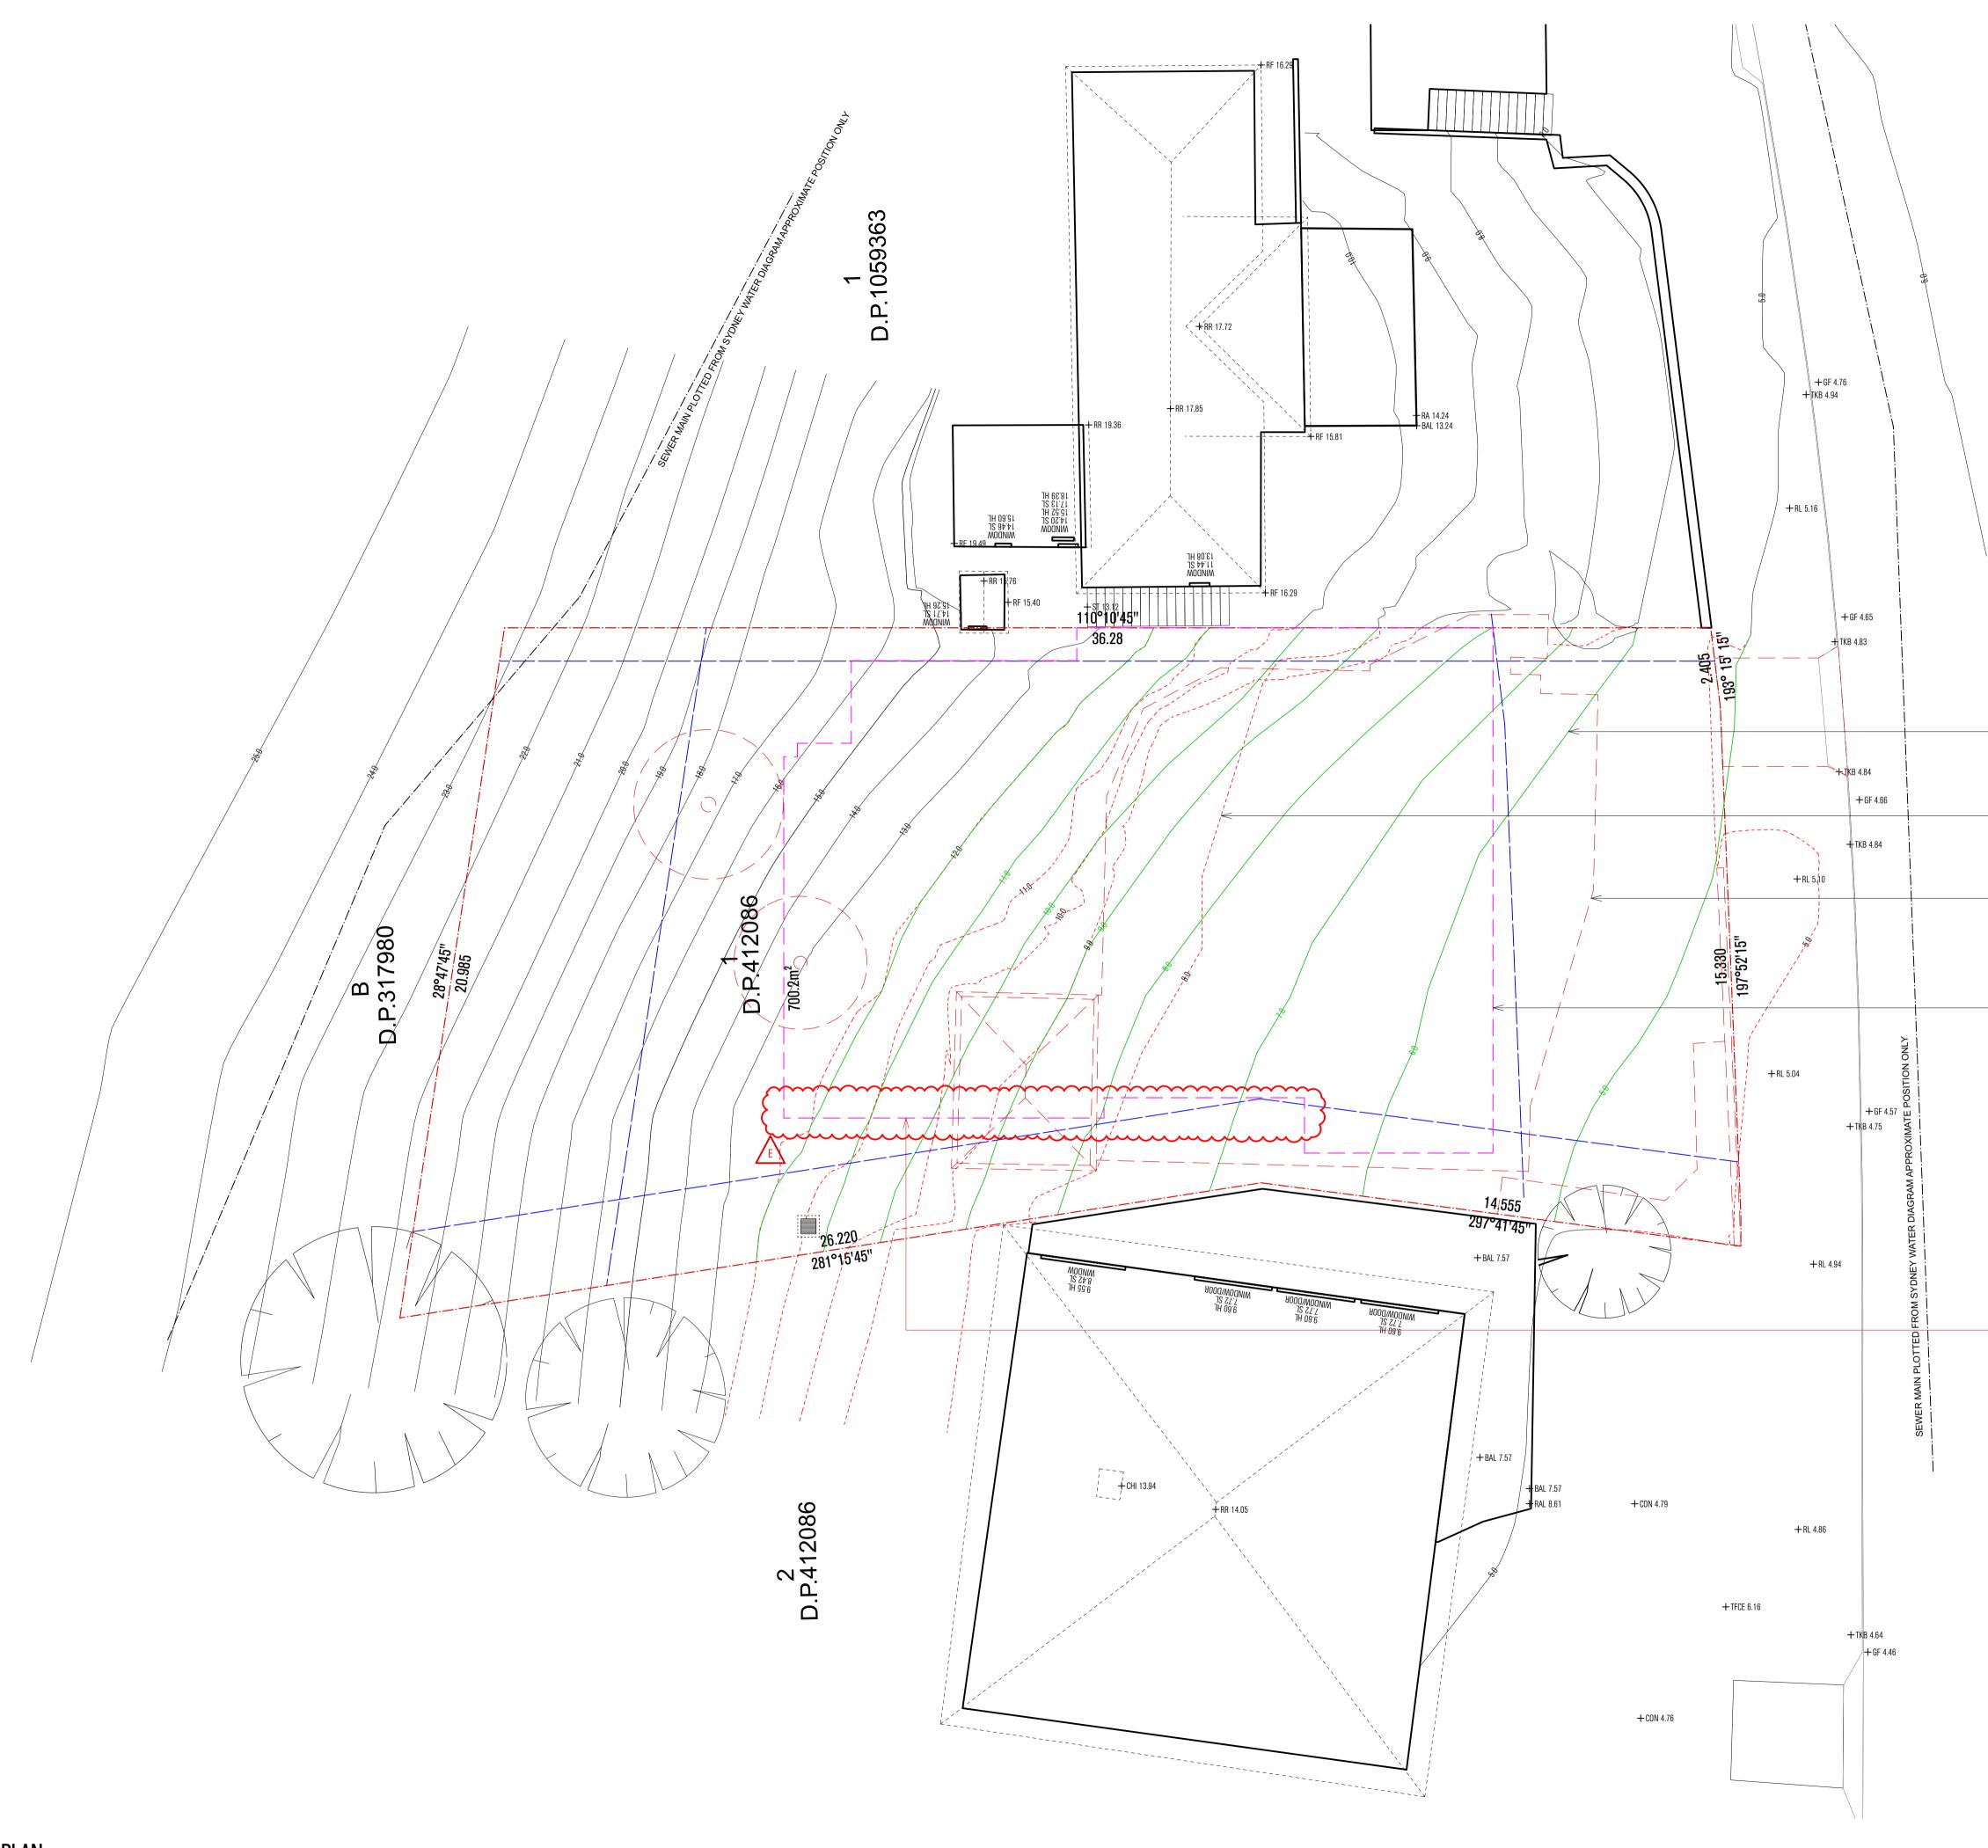
PROJECT OCEAN ROAD RESIDENCE ADDRESS 14 OCEAN ROAD PALM BEACH 2108 DOCUMENT DEVELOPMENT APPLICATION

DRAWING	PLAN		
	DEMOLITION		
DATE	15.10.21	SCALE	1:100
DRAWN	DB	project no.	21006
DRAWING NO.	DA.13	REV NO.	В



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LEGEND

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 _	_	_	_	_

Site Boundary Council setbacks / Height requirements Existing house to be Demolished

New House footprint

Existing modified site contours
 Architects interpretation of natural site contours



NOTES

• **Note:** Architect's interpretation of the natural site contours before the existing house was built shown green dashed.

 Note: Site contours modified for the existing house constructed on the property shown red dashed.

- Existing house to be demolished shown red dashed.

– New house building footprint shown pink dashed.

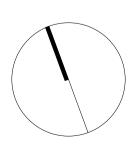
+RL 4.78

 New house building footprint across all levels reduced and brought in from the Southern Boundary to suit revised layout.

rev no.	DATE	REVISIONS	BY	СНК
A	14.09.21	Issue for Consultant Coordination	DB	ES
В	22.09.21	Issue for Consultant Coordination	DB	ES
С	11.10.21	Issue for Consultant Coordination	DB	
D	15.10.21	DA Issue	DB	ES
E	06.04.22	DA Amendment	DB	ES

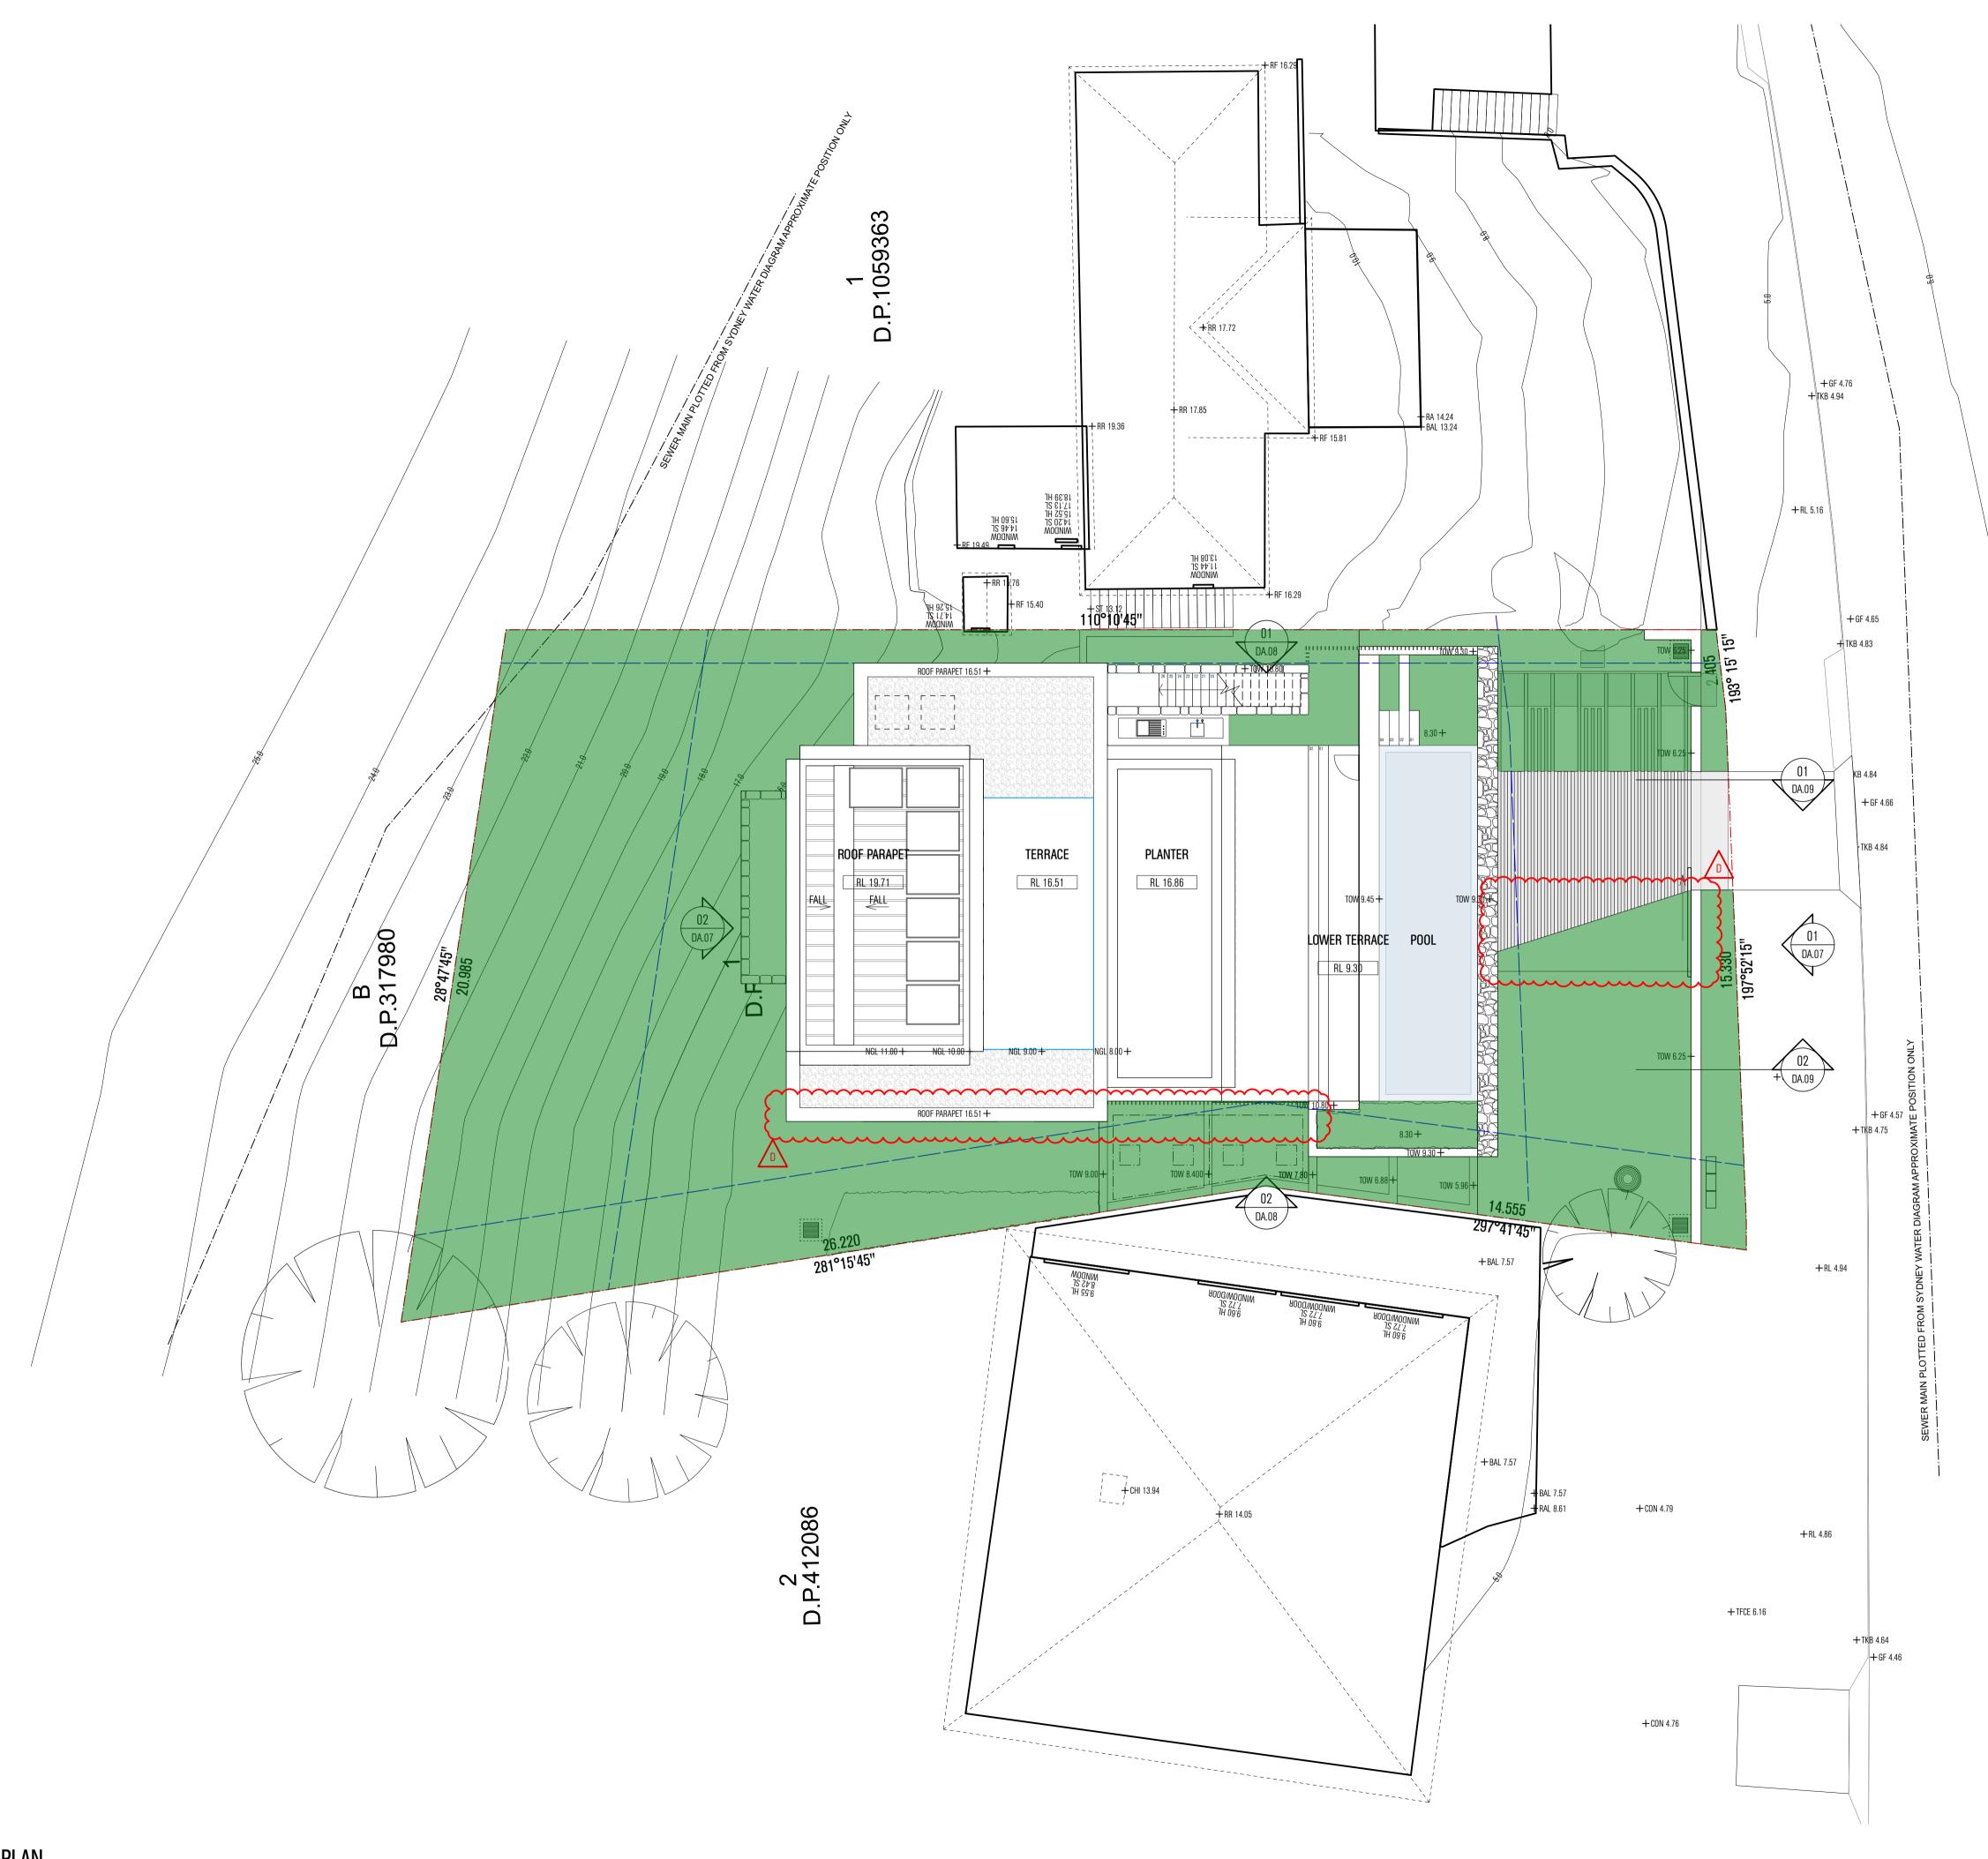
PROJECT	OCEAN ROAD RESIDENCE	
ADDRESS	14 OCEAN ROAD	
	PALM BEACH 2108	
DOCUMENT	DEVELOPMENT APPLICATION	

Drawing No.	DA.14	REV NO.	Е
DRAWN	DB	project no.	21006
DATE	06.04.22	SCALE	1:100
	CONTOUR MO	DIFICATION DI	AGRAM
DRAWING	PLAN		



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	LEGEND	•••
	Council setbacks / height requirements Landscaped area	
	SITE COVERAGE CALCULATIONS	Proposed
	Landscaped Area	392sqm
	Site Area	700 sqm
	TOTAL LANDSCAPED %	56%
	Including 6% allowance for hardscaping within landscaped zone.	
	Refer to Landscape Architect's drawings for landscape design and	d planting
	schedule.	
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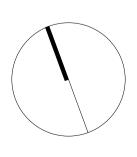


NOTES

rev no.	DATE	REVISIONS	BY	СНК
Ą	22.09.21	Issue for Consultant Coordination	DB	ES
3	11.10.21	Issue for Consultant Coordination	DB	
2	15.10.21	DA Issue	DB	ES
)	06.04.22	DA Amendment	DB	ES
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				·

PROJECT	OCEAN ROAD RESIDENCE	
ADDRESS	14 OCEAN ROAD	
	PALM BEACH 2108	
DOCUMENT	DEVELOPMENT APPLICATION	

DRAWING	PLAN		
	Landscape (CALCULATION	
DATE	06.04.22	SCALE	1:100
DRAWN	DB	project no.	21006
DRAWING NO.	DA.15	rev no.	D

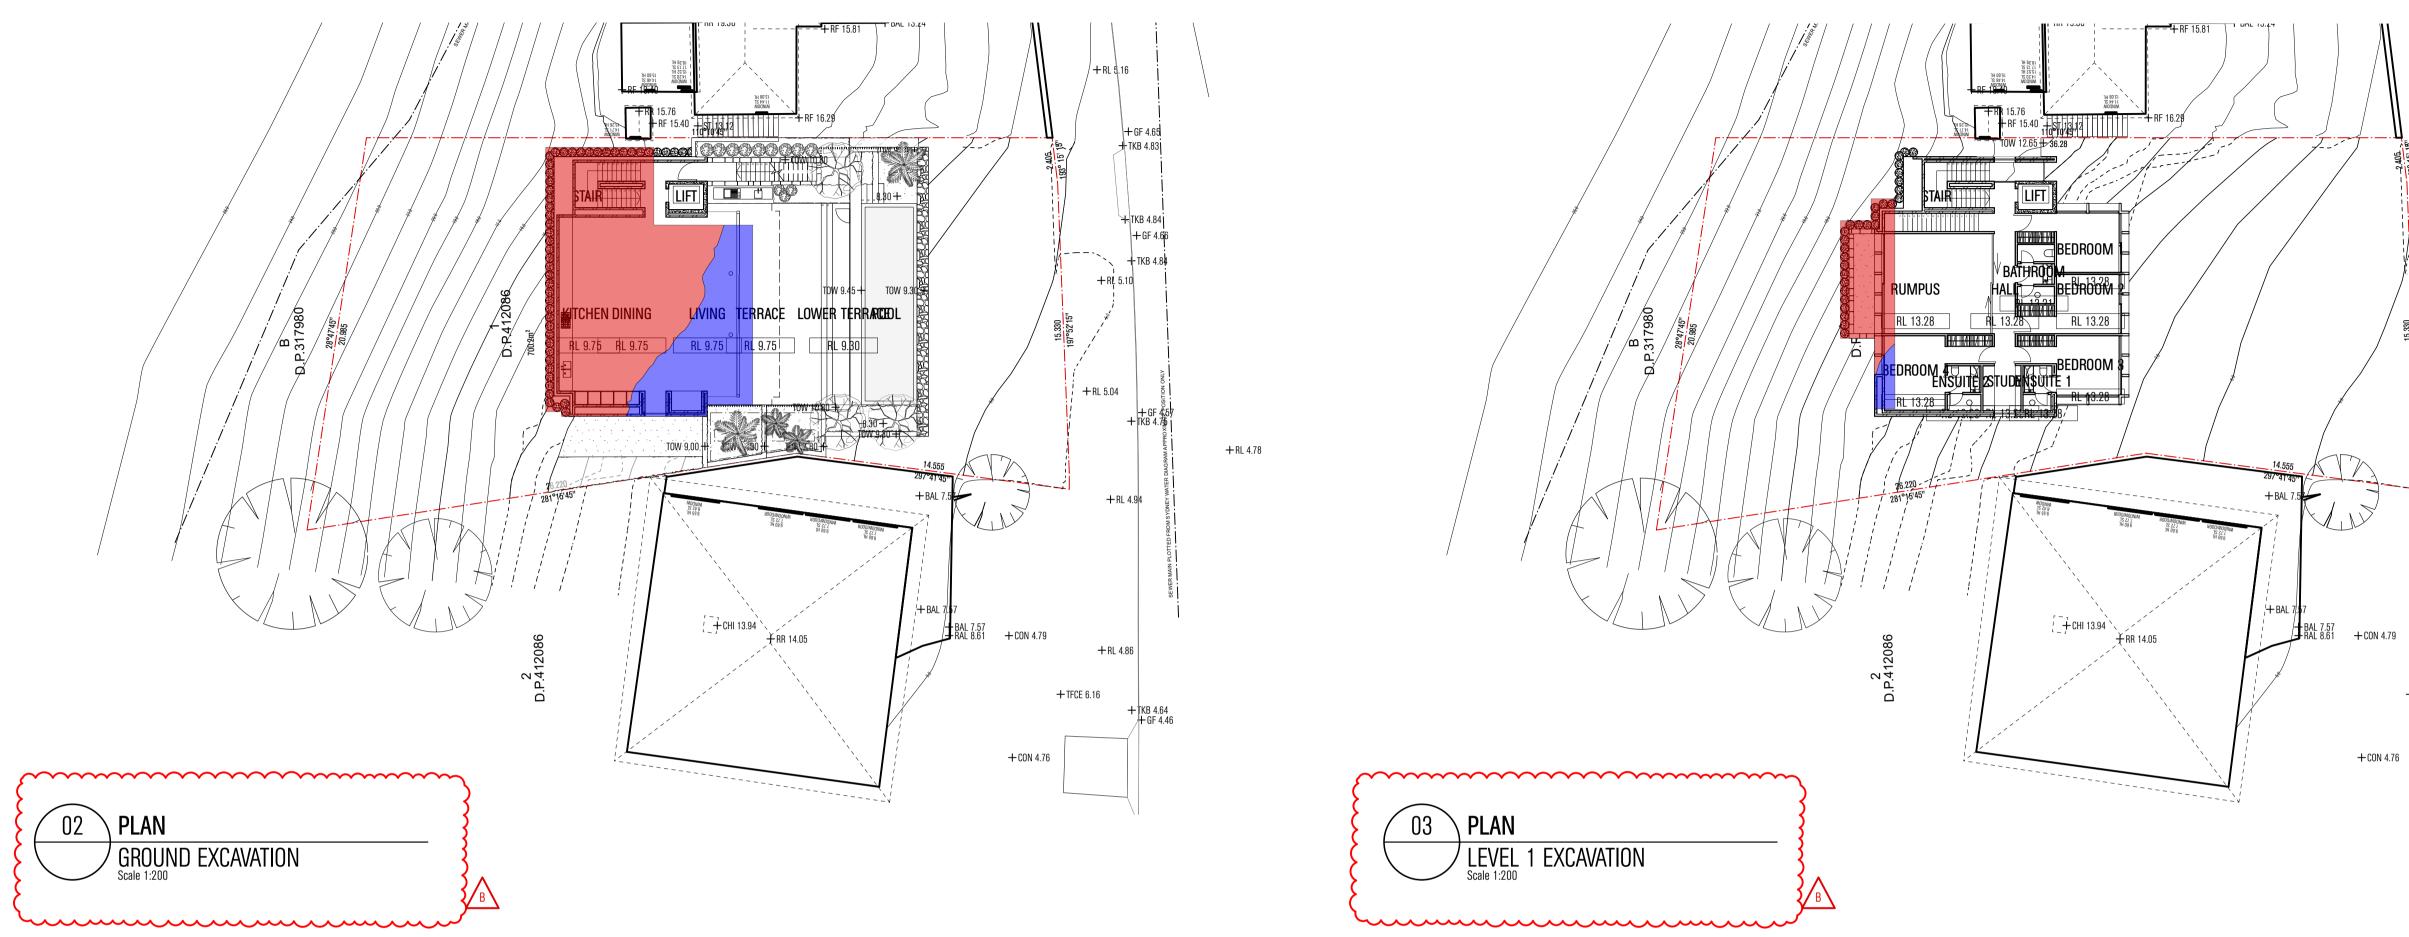


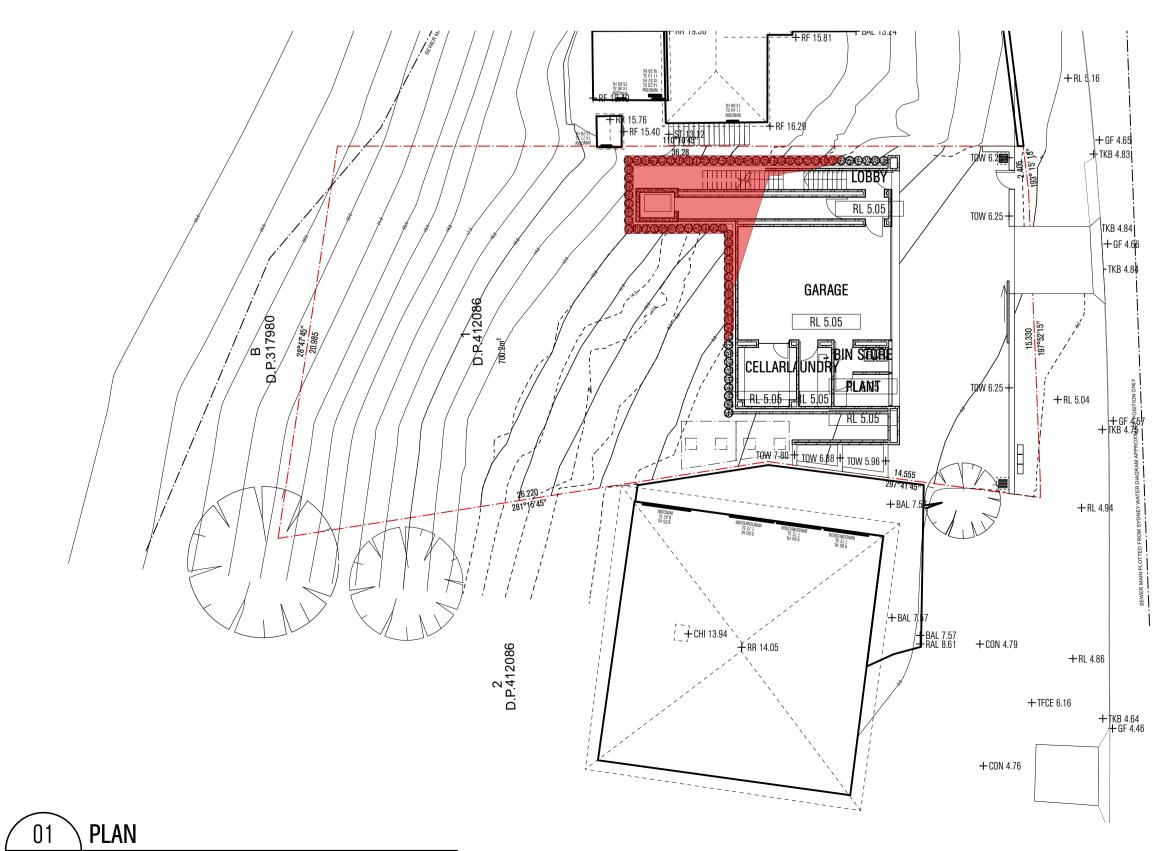
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MATHIESON

+ RL 4.78





+ RL 4.78

MATHIESON ARCHITECTS

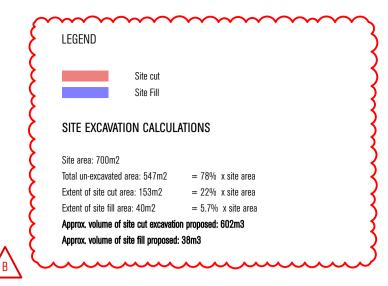
5.1

HOUSE ENERGY RATING SCHEMI

64.9

NOTES

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0006687636 19 Oct 2021

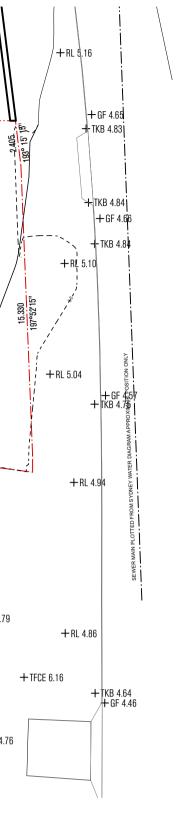
Assessor Robert Romanous

14 Ocean Road , Palm Beach , NSW , 2108

hstar.com.au

Accreditation No. 101535

Address

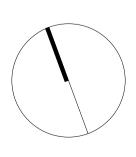


+RL 4.78

REV NO. DATE REVISIONS BY CHK ____ 15.10.21 DA Issue DB ES DB ES 06.04.22 DA Amendment _____ _____ ____ _____ _ __ __ _____ _ __ __ _____ _ _ _ _____ _____ ____ _____ _____ _ __ __ _____ - ___ ___ _____ ____ _____ _ ___ ___

PROJECT	OCEAN ROAD RESIDENCE
ADDRESS	14 OCEAN ROAD
	PALM BEACH 2108
DOCUMENT	DEVELOPMENT APPLICATION
DRAWING	PLAN
	EXCAVATION

DRAWING NO.	DA.16	REV NO.	В
DRAWN	DB	project no.	21006
DATE	06.04.22	SCALE	1:100
	EXCAVATION		



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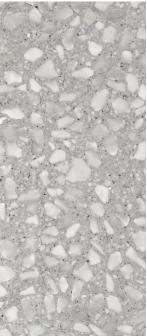


PROJECT	OCEAN ROAD RESIDENCE	DRAWING
ADDRESS	14 OCEAN ROAD	
	PALM BEACH 2108	DATE
DOCUMENT	DEVELOPMENT APPLICATION	DRAWING NO.

DRAWING NO.	DA.17	REV NO.	А
DATE	22.10.21	SCALE	NTS
	SCHEDULE (of Finishes	
DRAWING			

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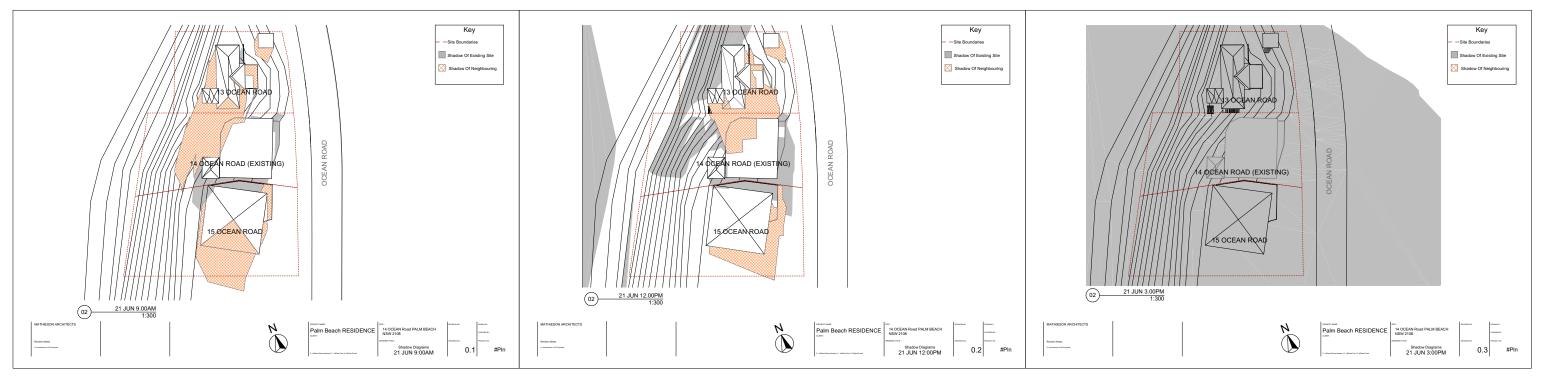




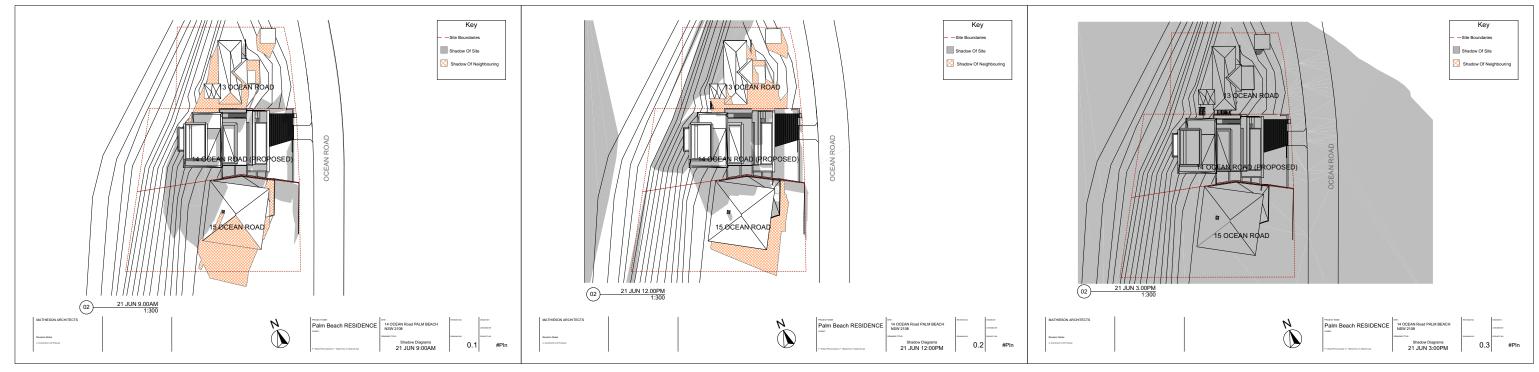
PROJECT	OCEAN ROAD RESIDENCE	DRAWING			
ADDRESS	14 OCEAN ROAD		STREETSCAL	PE VISUALISATI	ION
	PALM BEACH 2108	DATE	22.10.21	SCALE	NTS
DOCUMENT	DEVELOPMENT APPLICATION	DRAWING NO.	DA.18	REV NO.	A

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PROPOSED BUILDING

PROJECT	ocean road residence	DRAWING				
ADDRESS	14 OCEAN ROAD		SOLAR DIAGRAMS			
	PALM BEACH 2108	DATE	08.04.22	SCALE	NTS	
DOCUMENT	DEVELOPMENT APPLICATION	DRAWING NO.	DA.19	REV NO.	С	

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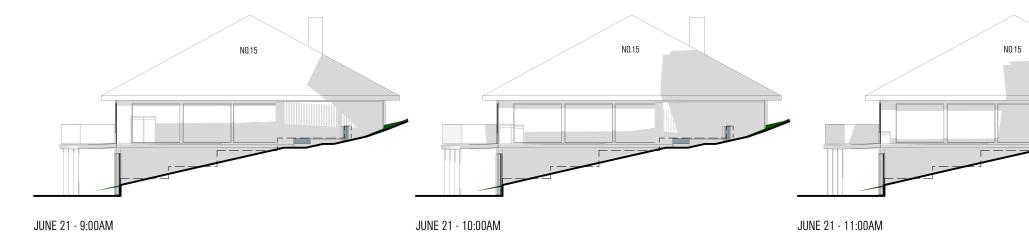




JUNE 21 - 9:00AM

JUNE 21 - 10:00AM

JUNE 21 - 11:00AM



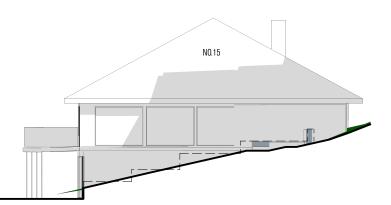
JUNE 21 - 12:00PM

PROJECT	OCEAN ROAD RESIDENCE	DRAWING				
ADDRESS	14 OCEAN ROAD	PROPOSED SOLAR DIAGRAMS				
	PALM BEACH 2108	DATE	08.04.22	SCALE	NTS	
DOCUMENT	DEVELOPMENT APPLICATION	DRAWING NO.	DA.20	REV NO.	С	

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JUNE 21 - 12:00PM

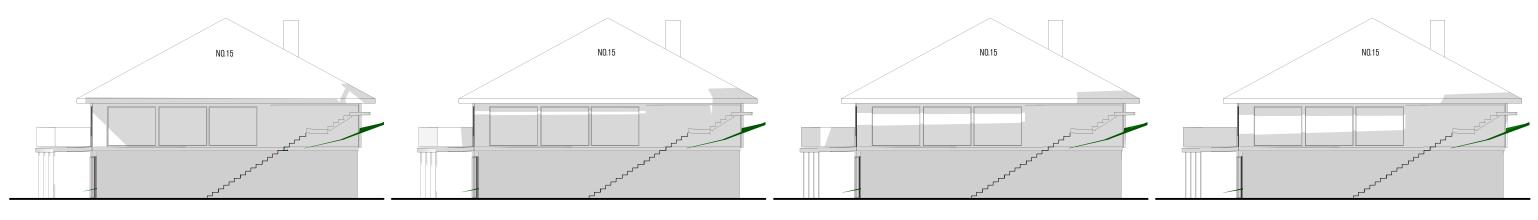




JUNE 21 - 9:00AM

JUNE 21 - 10:00AM

JUNE 21 - 11:00AM



JUNE 21 - 9:00AM

JUNE 21 - 10:00AM

JUNE 21 - 11:00AM

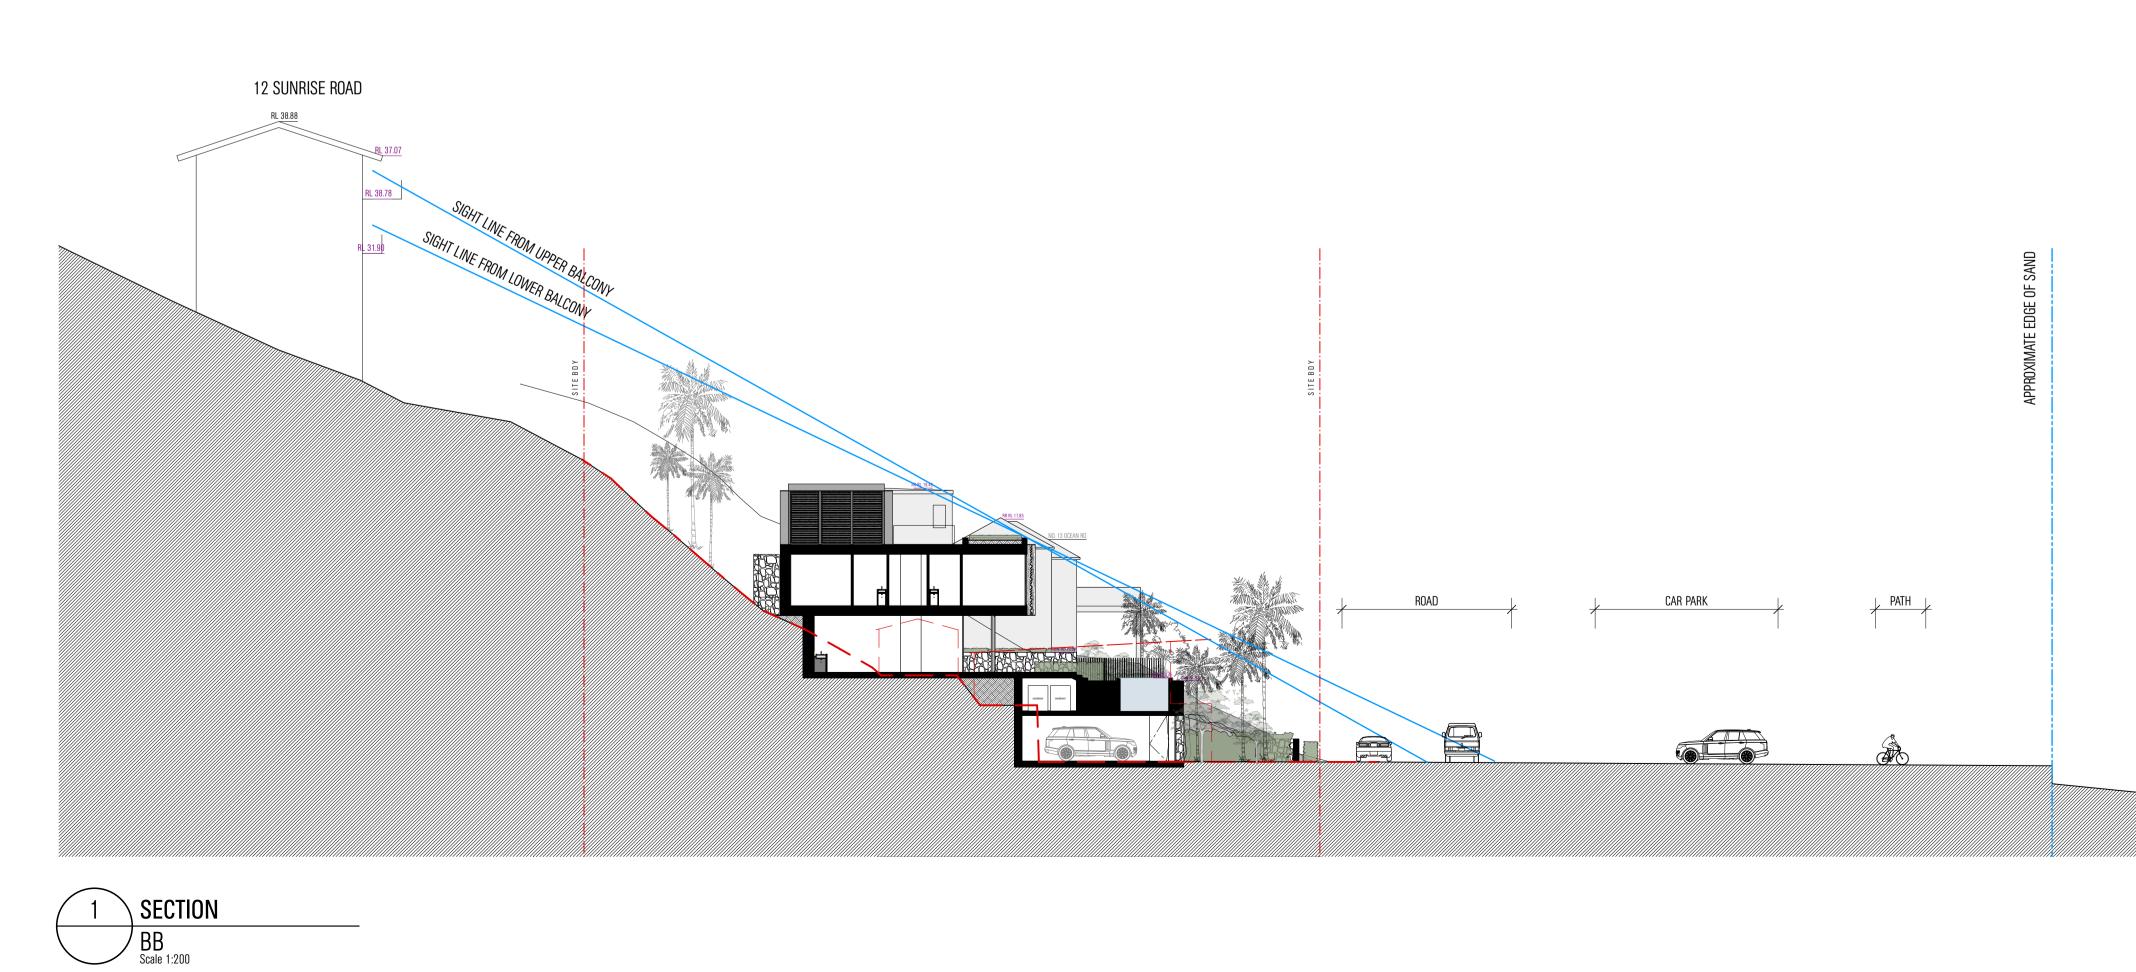
PROJECT	OCEAN ROAD RESIDENCE	DRAWING				
ADDRESS	14 OCEAN ROAD	EXISTING SOLAR DIAGRAMS				
	PALM BEACH 2108	DATE	08.04.22	SCALE	NTS	
DOCUMENT	DEVELOPMENT APPLICATION	DRAWING NO.	DA.21	REV NO.	А	

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JUNE 21 - 12:00PM

JUNE 21 - 12:00PM



NOTES

102/16-28 FOSTER ST SURRY HILLS NSW 2010 AUSTRALIA T: +61 2 9280 4100 INFO@MATHIESONARCHITECTS.COM



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DRAWING NO.	DA.30	REV NO.	А	
DRAWN	ES	project no.	21006	
DATE	08.04.22	SCALE	1:100@A1	
	VIEW ANALYS	IS		
DRAWING	SECTIONS			
DOCUMENT DEVELOPMENT APPLICATION				
	Palm Beach	2108		
ADDRESS	14 OCEAN RO	AD		
PROJECT	OCEAN ROAD RESIDENCE			

DISCLAIMER

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PROXIMATE WATER LINI



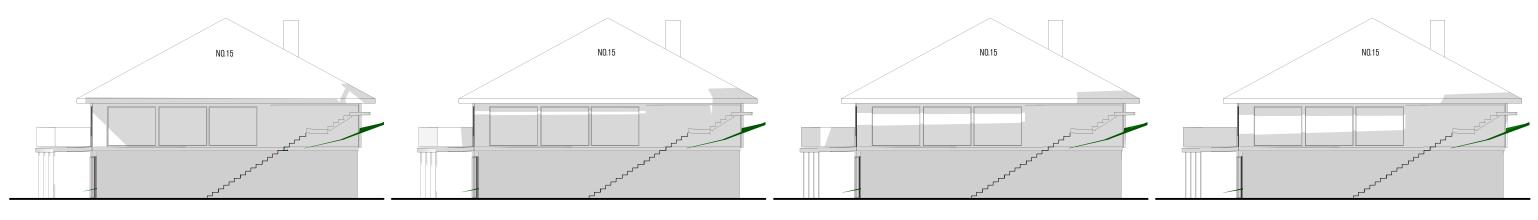
CONCEPT DESIGN PACKAGE - DA: 14 OCEAN RD, PALM BEACH OCTOBER 2021



JUNE 21 - 9:00AM

JUNE 21 - 10:00AM

JUNE 21 - 11:00AM



JUNE 21 - 9:00AM

JUNE 21 - 10:00AM

JUNE 21 - 11:00AM

PROJECT	OCEAN ROAD RESIDENCE	DRAWING				
ADDRESS	14 OCEAN ROAD	EXISTING SOLAR DIAGRAMS				
	PALM BEACH 2108	DATE	08.04.22	SCALE	NTS	
DOCUMENT	DEVELOPMENT APPLICATION	DRAWING NO.	DA.21	REV NO.	А	

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JUNE 21 - 12:00PM

JUNE 21 - 12:00PM





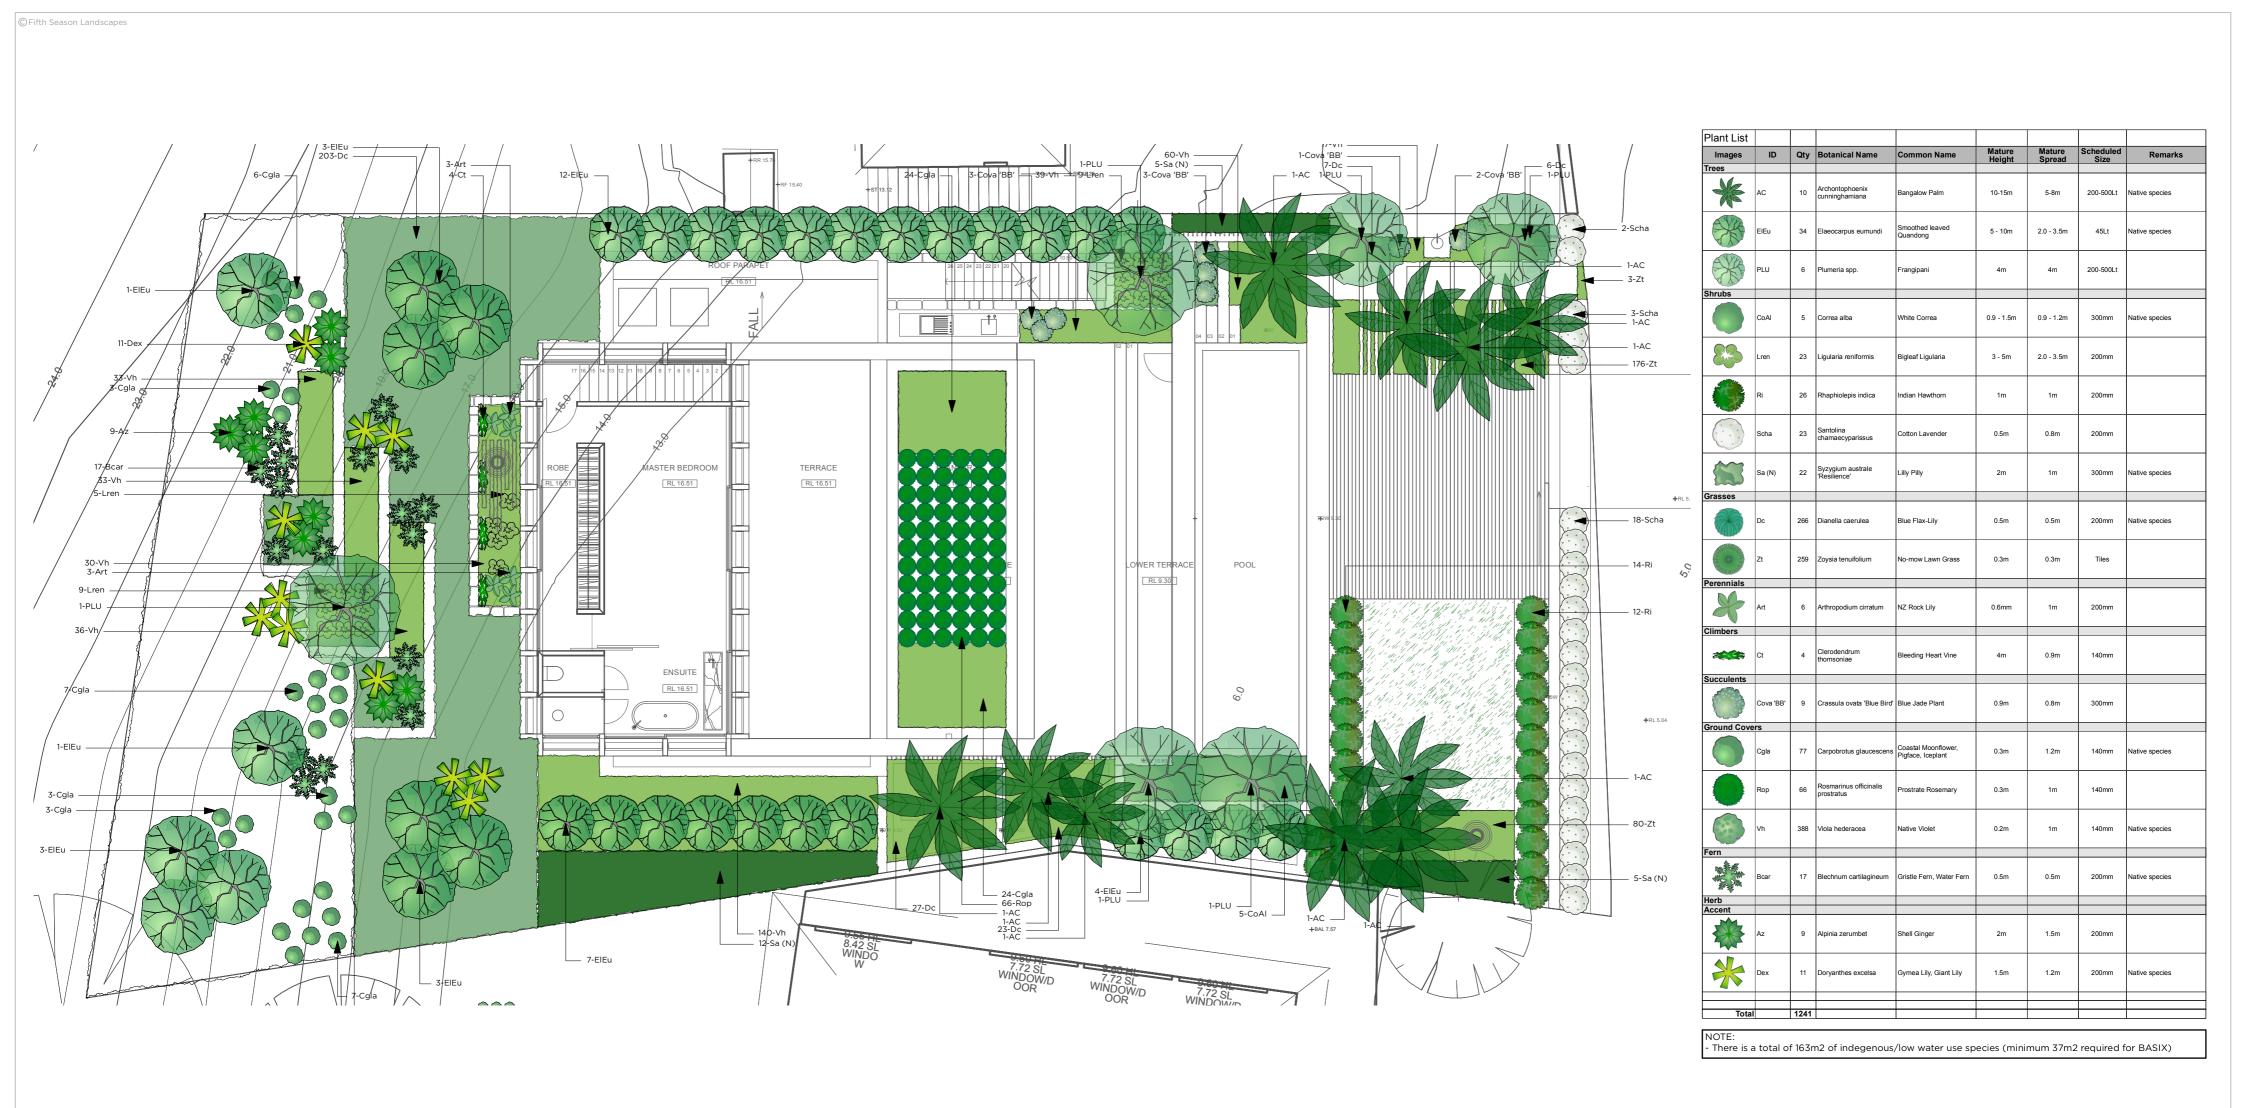
LANDSCAPE CONCEPT PLAN 14 OCEAN RD, PALM BEACH

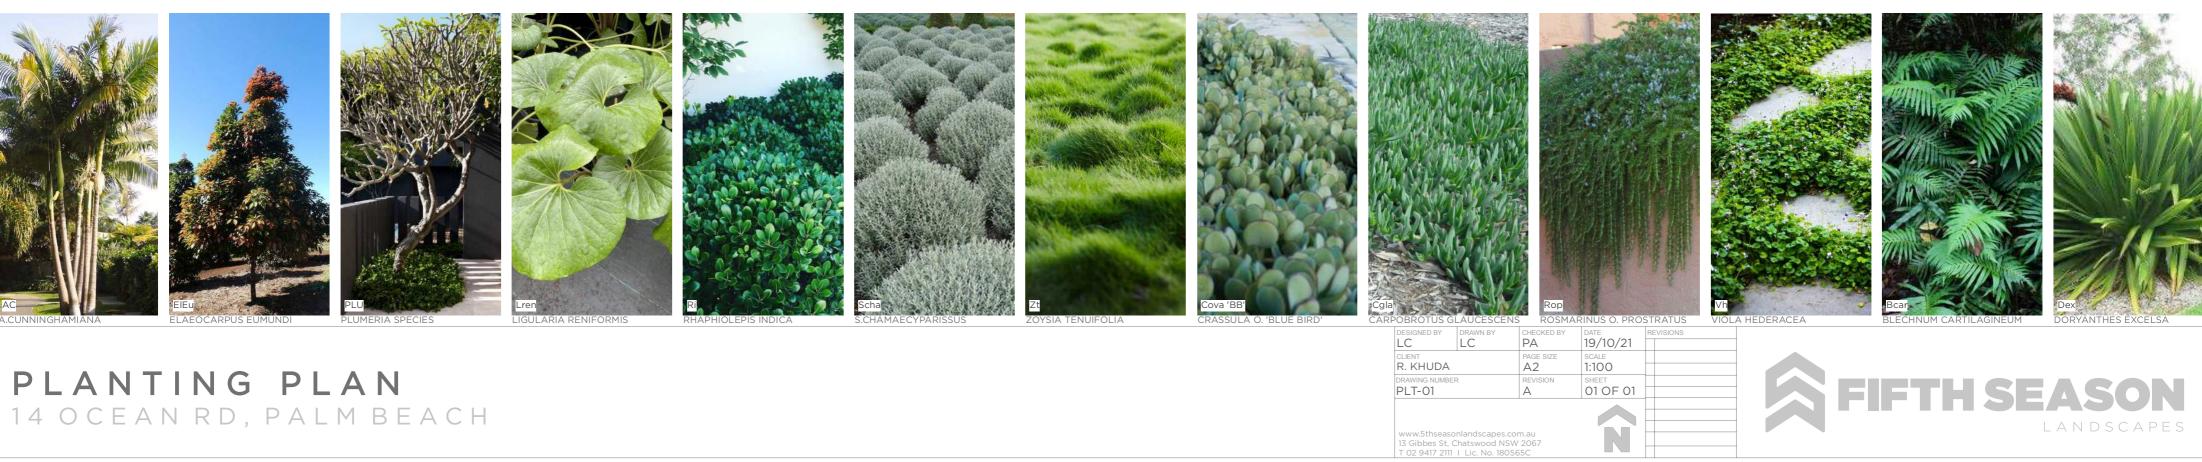


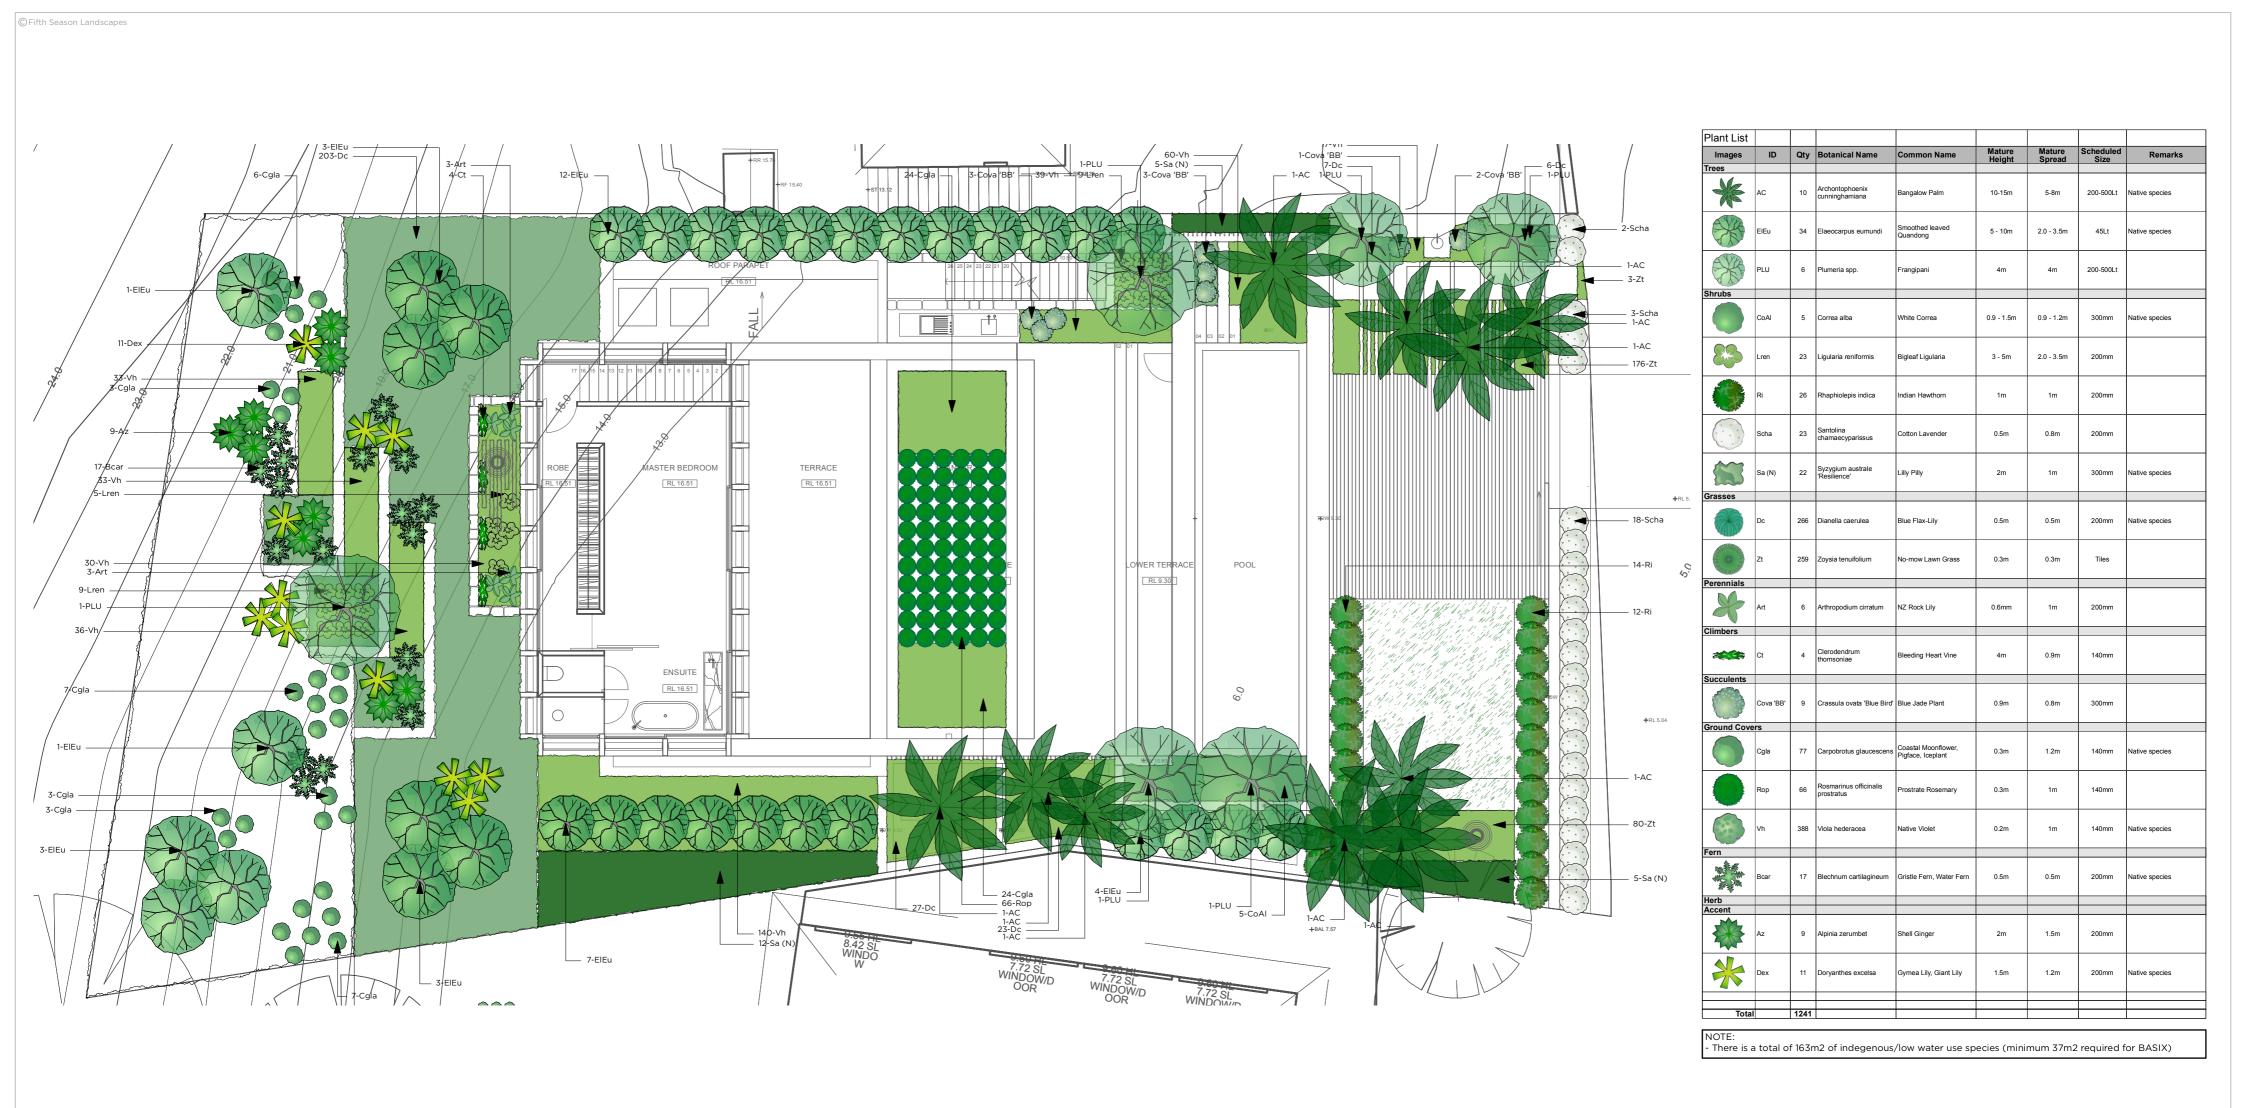


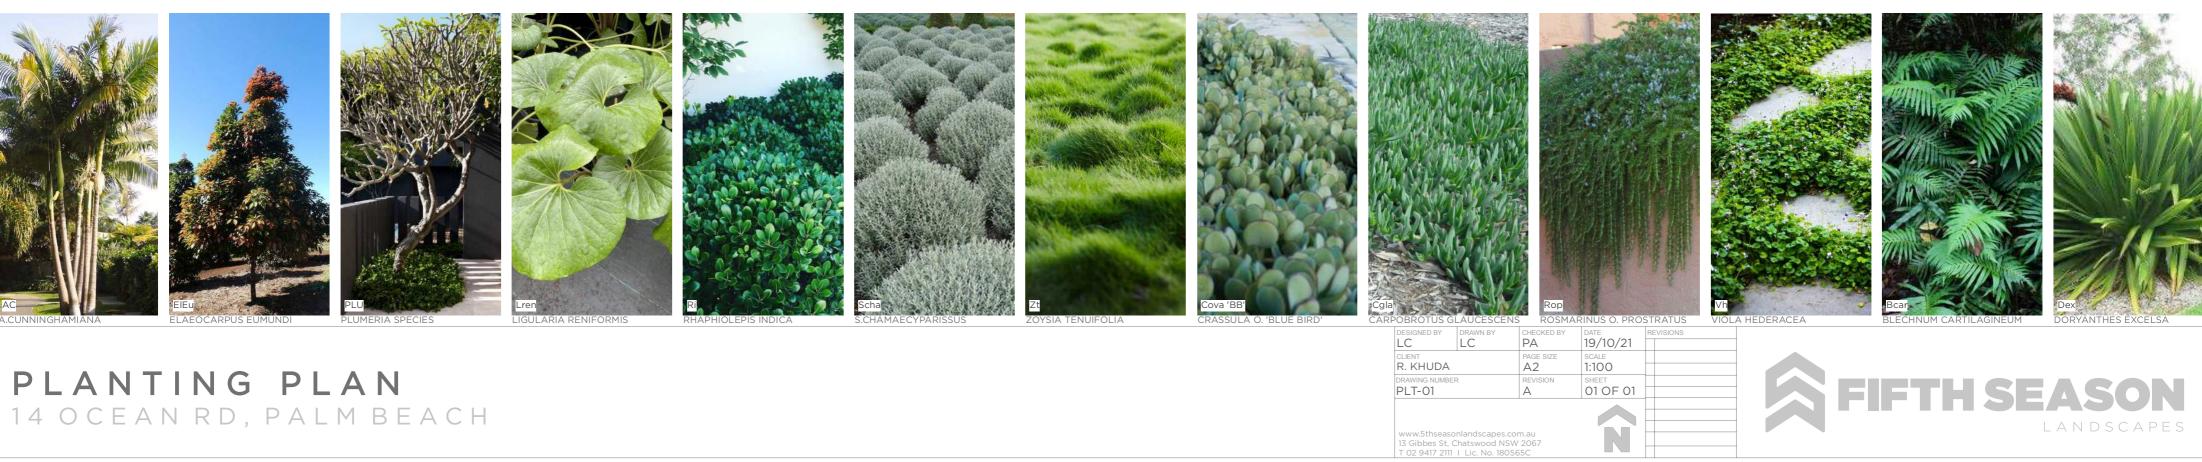
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LANDSCAPE CONCEPT PLAN 14 OCEAN RD, PALM BEACH





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FIFTH SEASON