Thermal Performance Specifications

These are the Specifications upon which the Certified Assessment is based. If details included in these Specifications vary from other drawings or written specifications, these Specifications shall take precedence. If only one specification option is detailed for a building element, that specification must apply to all instances of that element for the project. If alternate specifications are detailed for a building element, the location and extent of alternate specifications must be detailed below and / or clearly indicated on referenced documents

Windows	Product ID	Glass	Frame	U value	SHGC	Area M²	Detail	
Unit 47		Double Toned	Aluminium	5.2	0.35		Awning	
		Double Toned	Aluminium	5.2	0.39		Sliding, Fixed	
Unit 47A		Double Low-E	Timber	2.9	0.33		Awning	
		Double Low-E	Timber	2.9	0.42		Sliding, Fixed	

Skylights	Product ID	Glass	Frame	U value	SHGC	Area Mº L	Detail
-----------	------------	-------	-------	---------	------	-----------	--------

Window and skylight U and SHGC values, if specified, are according to AFRC. Alternate products or specifications may be used if their U value is lower, and the SHGC value is less than 5% higher or lower, than the U and SHGC values of the product specified above.

External walls	Construction	Insulation	Colour – solar abs.	Detail
Cavity Brick		None	Medium – SA 0.475 – 0.7	Garages
Cavity Brick		15mm Foilboard	Medium – SA 0.475 – 0.7	Ground Floor
Cavity Brick / Re	ender	15mm Foilboard	Medium - SA 0.475 - 0.7	First Floor

Internal walls Construction	n Insulation	Detail
Brick Plasterboard	R2.0 XPS	Garages
Brick Plasterboard	None	As per plan
Cavity Brick	None	Party Walls

Floors	Construction	Insulation	Covering	Detail
Concrete		None	None	Garages
Concrete		R1.0 XPS	Tiles / Carpet / Timber	All Slab on Ground
Concrete		None	Tiles / Carpet / Timber	As per plan
Concrete		R2.0 XPS	Carpet	Outdoor Air Below

Ceilings	Construction	Insulation	Detail
Concrete Pla	sterboard	R2.0 XPS	Garage Ceiling
Concrete Pla	sterboard	R3.0 XPS	Concrete Roof Above
Concrete Pla	sterboard	None	As per plan
Plasterboard	•	R3.0 Bulk	Metal Roof Above

Roof	Construction	Insulation	Colour – solar abs.	Detail	
Concrete		**	Light – SA < 0.475	** Insulation in Ceiling Below	
Metal		R1.0 Anticon	Light – SA < 0.475	As per plan	

Overshadowing	Overshadowing structures
45 Blackbutts Rd	

Orientation,	Exposure,	Ventilation and	Infiltration

Orientation of nominal north:	8
Terrain category:	Suburban
Seals to windows and doors:	Yes
Lighting plan provided:	No
Recessed downlights:	DEFAULTS MODELLED
Ceiling exhaust fans	DEFAULTS MODELLED

PROPOSED TWO-STOREY DUPLEX 47 BLACKBUTTS RD. FRENCHES FOREST | LOT 1 | DP 229315

THE VAN-DUO HOUSES

A000	COVERSHEET	30/06/2025	Е
A001	DRAWING CONVENTIONS	24/06/2025	С
A101	DEMOLITION PLAN	24/06/2025	С
A102	SITE PLAN / PLAN OF STRATA SUBDIVISION	30/06/2025	Е
A103	GROUND FLOOR	30/06/2025	Е
A104	FIRST FLOOR	30/06/2025	Е
A105	ROOF PLAN	24/06/2025	С
A107	AREA CALCULATION	30/06/2025	Е
A200	FRONT AND REAR ELEVATION	30/06/2025	Е
A201	SIDE ELEVATION	30/06/2025	Е
A300	SECTION	30/06/2025	Е
A701	EXTERNAL DOORS & WINDOW SCHEDULE	24/06/2025	С
A702	EXTERNAL DOORS & WINDOW SCHEDULE	24/06/2025	С
A810	SHADOW DIAGRAMS	24/06/2025	С
A820	3D BUILDING HEIGHT PLANE	24/06/2025	С
A900	3D RENDER	24/06/2025	С



DESCRIPTION

47 BLACKBUTTS RD. FRENCHES FOREST 47 BLACKBUTTS RD. FRENCHES FOREST

DRAWING TITLE: COVERSHEET

@ A3

CARL VAN SELM DRAWN BY: DM CHECKED BY: SS 25014 REV DATE:


30/06/2025

STATUS: PRELIMINARY FOR COORDINATION REV A000 Ε




GENERAL ANNOTATION LEGEND

15°	FALL ARROW
	SPAN DIRECTION
SSL. + 18.800m	STRUCTURAL SLAB LEVEL
FFL. + 18.800m	FINISH FLOOR LEVEL
CH + 2700 AFL	CEILING HEIGHT ABOVE FINISH FLOOR LEVEL
RL. + 18.800	SPOT ELEVATION MARKER
WT01	WALL TYPE
300	STEP DOWN
G0-91)	DOOR TYPE
[cm:e]	WINDOW TYPE
(TILES)	FLOOR FINISH MATERIAL
(HB185)	FURNITURE NUMBER

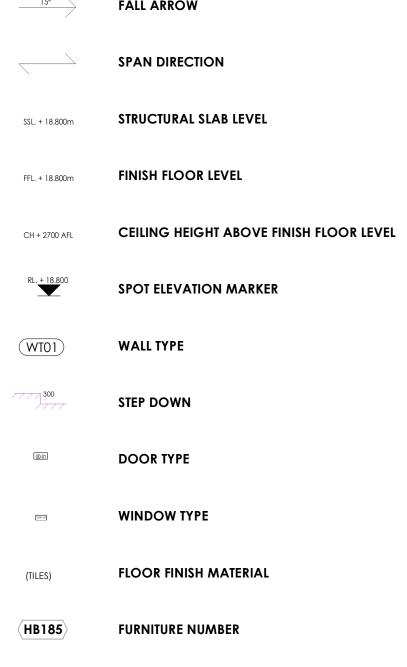


$\begin{bmatrix} \mathbf{0} \end{bmatrix}$


GRID NUMBER

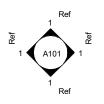

INTERNAL ELEVATIONS

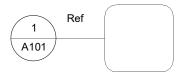

DETAIL CALLOUT

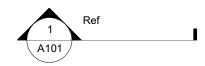


BUILDING SECTION



DETAIL SECTION

DRAWING TITLES

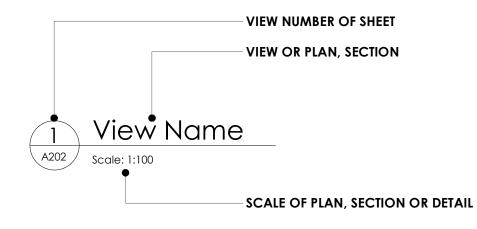

ABBREVIATION

AP APPR AFFL	ACCESS PANEL APPROVED ABOVE FINISHED FLOOR LEVEL	MAX MH MIN MISC	MAXIMUM MAN HOLE MINIMUM MISCELLANEOUS
BI-ORG BLDG BLK	BACK INLET OVERFLOW RELIEF GULLY BUILDING BLOCK	MM MS	MILLIMETRE MILD STEEL
BM	BENCH MARK	NB NO	NOMINAL BORE NUMBER
CAD CB c/c	COMPUTER AIDED DRAFTING COACH BOLT CENTRE TO CENTRE	nom nts	OMUNAL NOT TO SCALE
CCTV CHS CJ CL CNR CN	CLOSED CIRCUIT TELEVISION CIRCULAR HOLLOW SECTION CONSTRUCTION JOINT CENTRE LINE CORNER CONTRACT NOTE	O/A OF OFO O/H OD ORG	OVERALL OVER FLOW OVERFLOW OUTLET OVER HEAD OUTSIDE DIAMETER OVERFLOW RELIEF GULLY
CODE	BUILDING CODE COLUMN	PC	PRECAST CONCRETE
CON COR COS	CONCRETE CORRUGATED CHECK ON SITE	PFC PLY PTN	PARALLEL FLANGE CHANNEL PLYWOOD PARTITION
CP CRS	CESSPIT CENTRES	QT	QUALITY
CS	CAVITY SLIDER	R	RADIUS
CSK C/W	COUNTERSUNK COMPLETE WITH	RC REF REQD	REINFORCED CONCRETE REFERENCE REQUIRED
DB	DISTRIBUTION BOARD	RH	RIGHT HAND
DHS	DIMOND HI-SPAN (METAL PURLIN)	RHS	ROLLED HOLLOW SECTION
DIA DIA	DIAMETER DIAGONAL	RL RO	REDUCED LEVEL ROUGH OPENING
DIM	DIMENSION	ROW	RIGHT OF WAY
DP	DOWNPIPE BANKS PROOF COURSE	RSA	ROLLED STEEL ANGLE
DPC DPM DWG	DAMP PROOF COURSE DAMP PROOF MEMBRANE DRAWING	RSC RSJ	ROLLED STEEL CHANNEL ROLLED STEEL JOIST
EJ	TIMINI IMPIRATE	SCJ SCHED	SAW CUT JOINT SCHEDULE
EXTG	EXPANSION JOINT EXISTING	SCP SCP	SATIN CHROME PLATE
27.10	2,40,11,10	SED	SMALL END DIAMETER
FA	FIRE ALARM	SHS	SQUARE HOLLOW SECTION
FAP FCL	FIRE ALARM PANEL FINISHED CEILING LEVEL	SHT SK	SHEET SKETCH
FEX	FIRE EXTINGUISHER	SL	STRUCTURAL LEVEL
FFL	FINISHED FLOOR LEVEL	SP	SOIL PIPE
FG FH	FIXED GLASS FIRE HYDRANT	SPEC SQ/M	SPECIFICATION SQUARE METER
гн FHR	FIRE HOSE REEL	SQ/M SQ	SQUARE METER SQUARE
FIP	FIRE INDICATOR PANEL	SS	STAINLESS STEEL
FW	FLOOR WASTE	SWBD	SWITCH BOARD
FWG	FLOOR WASTE GULLY	SW	STORMWATER PIPE
HDB	HOLDING DOWN BOLT	TFC	TAPERED FLANGE CHANNEL
HDG HORZ	HOT DIPPED GALVANISED HORIZONTAL	TGV TV	TONGUE, GROOVE & VEE JOINT TERMINAL VENT
H.P.	HIGH POINT	TYP	TYPICAL
HT	HOSE TAP	UB	UNIVERSAL BEAM
IB	INSPECTION BEND	UC	UNIVERSAL BEAW
ID	INSIDE DIAMETER	U/S	UNDERSIDE
IJ	INSPECTION JUNCTION	VERT	VERTICAL
IL	INVERT LEVEL	VP W	VENT PIPE WATT
kW	KILOWATT	WRD	WALL BOARD

sions are to be checked by the builder on site and any	

Name _

Elevation

FLOOR LEVEL

NORTH POINT MARKER

47 BLACKBUTTS RD. FRENCHES FOREST

@ A3


KILOWATT

STATUS: PRELIMINARY FOR COORDINATION REV A001 C

WBD

WALL BOARD



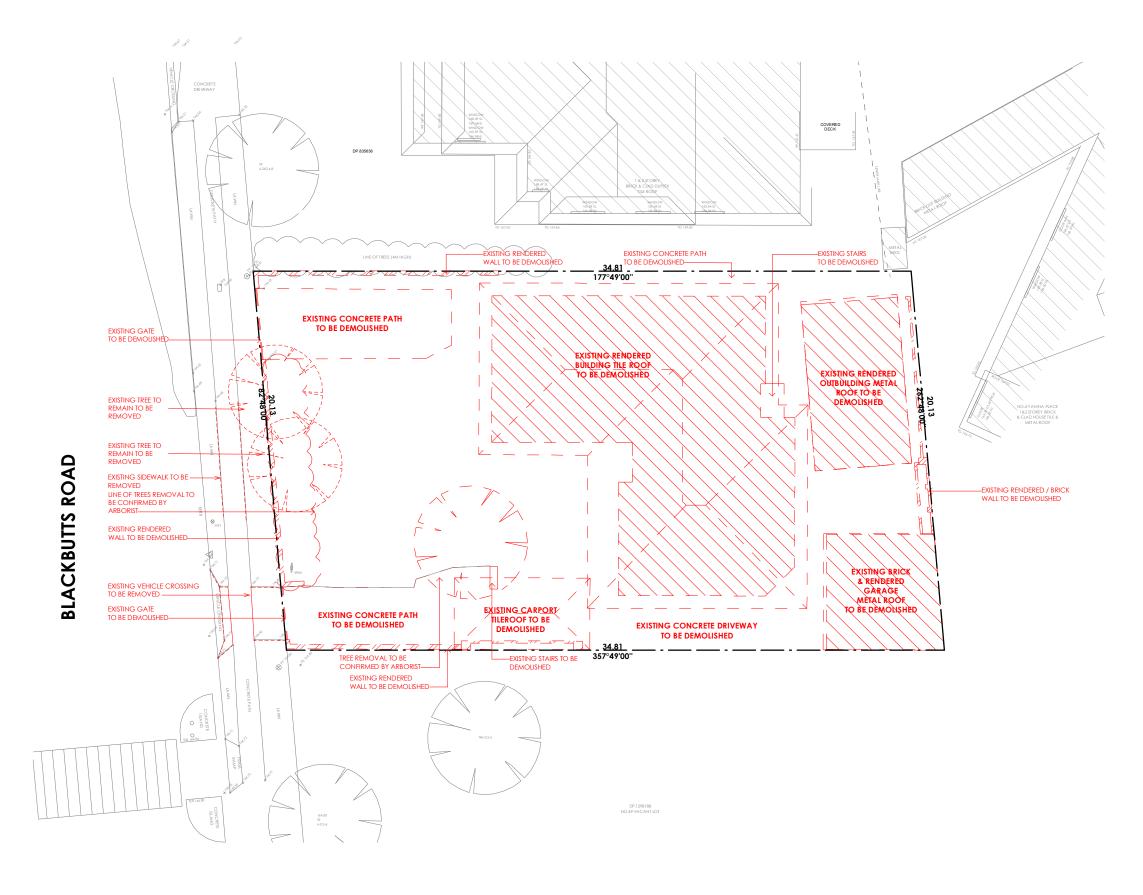

DEMOLITION PLAN

Scale: 1 : 200


All dimensions are to be checked by the builder on site and any discrepancies brought to the attention of Tesserarch Pty Ltd prior to construction. When a dimension is not clear is the builder's responsibility to clarify the dimension with the architect. It is the builder's responsibility to cross reference working drawings with authority endorsed documents. These drawings are not to be scaled. This design is dependent on approval by relevant authorities and companison with client budget requirements. At time of design, confirmation of these approvals has not been reclieved.

© Tesserarch Pty Ltd. This confidential design and any accompanying documentation is and remains the exclusive property of Tesserarch Pty Ltd. and is to be used soely for the purpose of evaluating our design unless permitted otherwise under a licensity arrangement with Tesserarch Pty Ltd. Design is schematic only and subject to council and other requisite approvals.

ISSUE A C	DATE 30/05/25 18/06/25	DESCRIPTION FOR DA FOR REVIEW	PROJECT: 47 BLACKBUTTS RD. FRENCHES FOREST	DEMOLITIO		CLIENT: CARL VAN SELM	STATUS: PRELIMINARY FOR COORDINATION	
			ADDRESS:	SCALE:		DRAWN BY: DM CHECKED BY: SS	DRAWING NO:	REV
			47 BLACKBUTTS RD. FRENCHES FOREST	1 : 200	@ A3	PROJECT NO: 25014 REV DATE: 24/06/2025	— A101	C



ER — 31 Woodstock Road Carlingford NSW 2151 info@lesserarch.com.au T 0488 22 1234

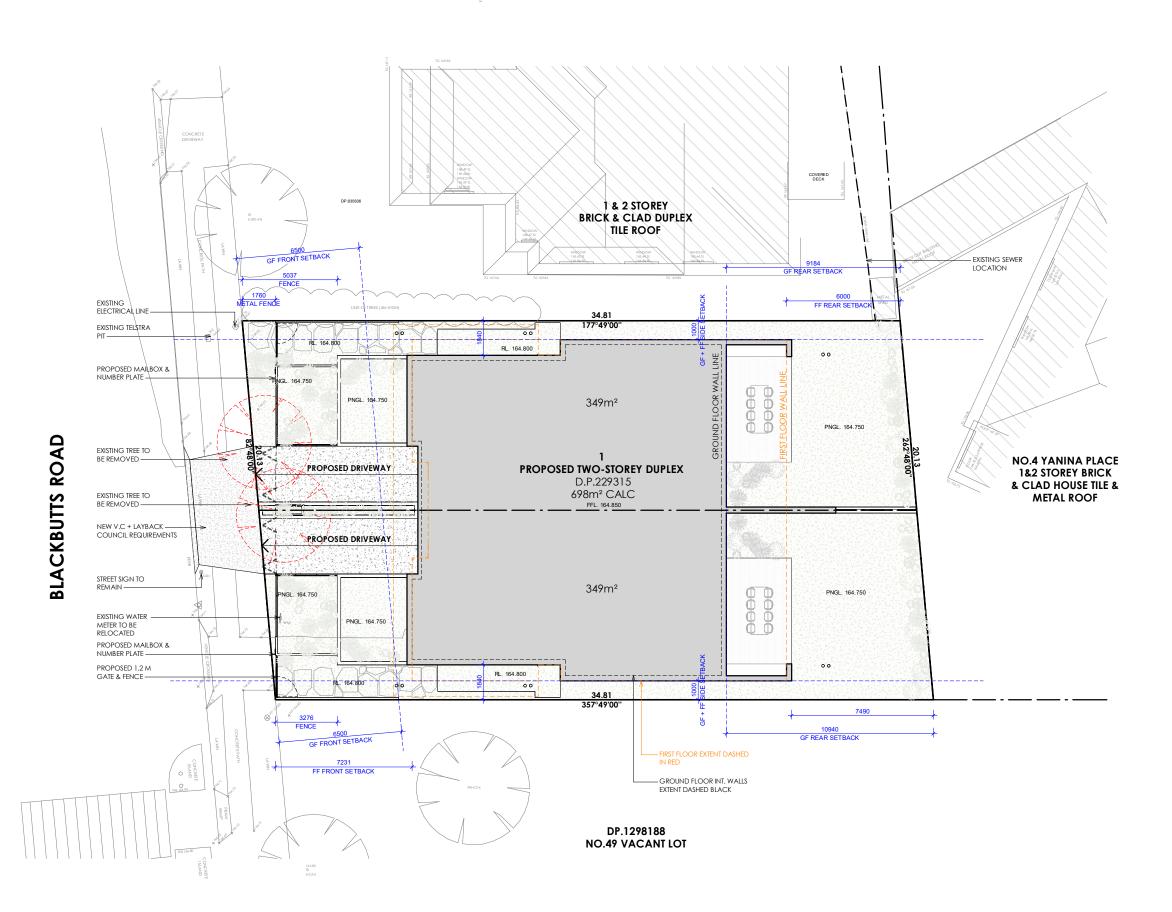

LOT 1 DP 229315 SITE COMPLIANCE TABLE: LOT AREA 698m² CONTROL PROPOSED MAX.BUILDING HEIGHT 8.5m 8.5m GROUND FLOOR AREA N/A 224.64m² FIRST FLOOR AREA N/A 285 88m² TOTAL FLOOR AREA 510.52m² N/A FRONT SETBACK 6.5m AS PER PLAN 0.9m AS PER PLAN SIDE SETBACK REAR SETBACK AS PER PLAN 6.0m PRIVATE OPEN SPACE 5m x 5m min. 25m² 25m² LANDSCAPE OPEN SPACE 40% or (279.2m²) 280.13m²

Certificate No. 0012020590-01 Scan QR code or follow website link for rating details.

Assessor name Raymond Sleiman

Accreditation No. DMN/12/1472

Property Address 47 Blackbutts

Road, Frenchs Forest NSW,2086

www.hstar.com.au/QR/Generate?p=cJUoZGKsR

DESCRIPTION

47 BLACKBUTTS RD. FRENCHES FOREST ADDRESS:

47 BLACKBUTTS RD. FRENCHES FOREST

DRAWING TITLE: SITE PLAN / PLAN OF STRATA SUBDIVISION SCALE:

@ A3

1:200



CARL VAN SELM

DRAWN BY: DM CHECKED BY: PROJECT NO: 25014 REV DATE: 30/06/2025


STATUS: PRELIMINARY FOR COORDINATION

A102

DRAWING NO:

TESS

arlingford NSW 2151

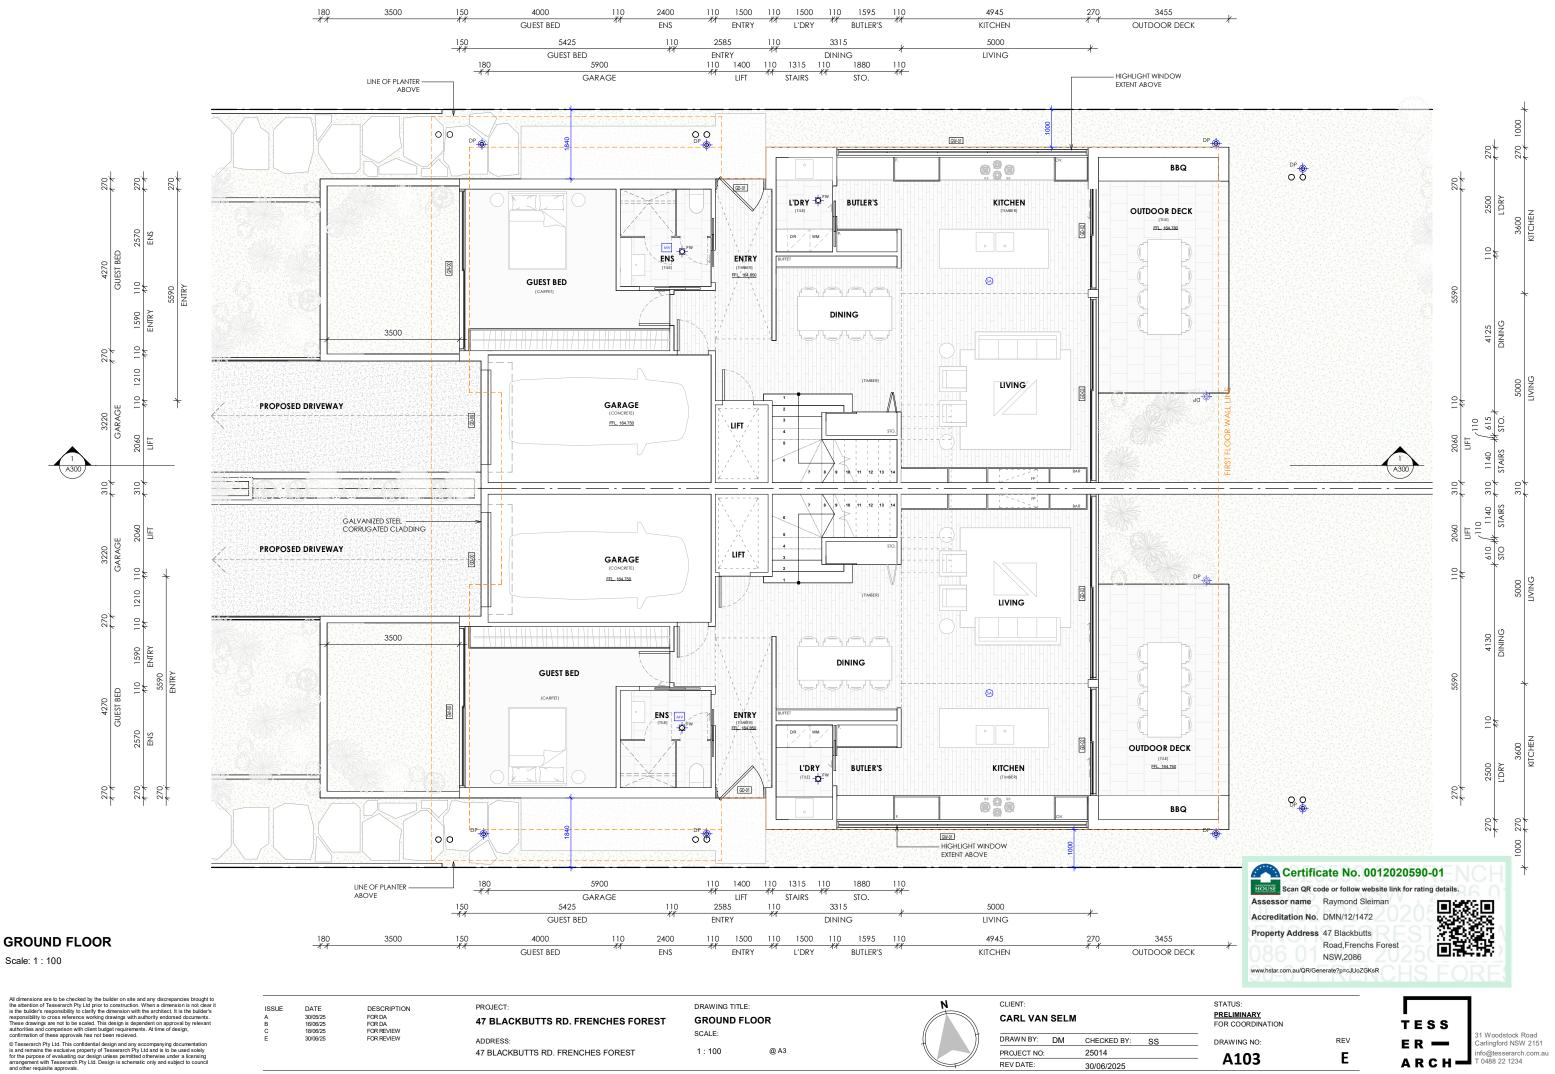

A103

REV DATE:

30/06/2025

Ε



All dimensions are to be checked by the builder on site and any discrepancies brought the attention of Tesserarch Ply Ltd prior to construction. When a dimension is not des is the builder's responsibility to darry the dimension with the architect. It is the builder responsibility to cross reference working drawings with authority endorsed documents. These drawings are not to be scaled. This design is dependent on approval by relevan authorities and comparison with client budget requirements. At time of design, confirmation of these approvals has not been recleived.

ADDRESS: 47 BLACKBUTTS RD. FRENCHES FOREST


1:100

@ A3

CLIENT:				
CARL VAN	SELM	l		
DRAWN BY:	DM	CHECKED BY:	SS	
PROJECT NO:		25014		
REV DATE:		20/06/2025		

DRAWING NO: REV Ε A104

ER — Carlingford NSW 2151 info@tesserarch.com.au T 0488 22 1234

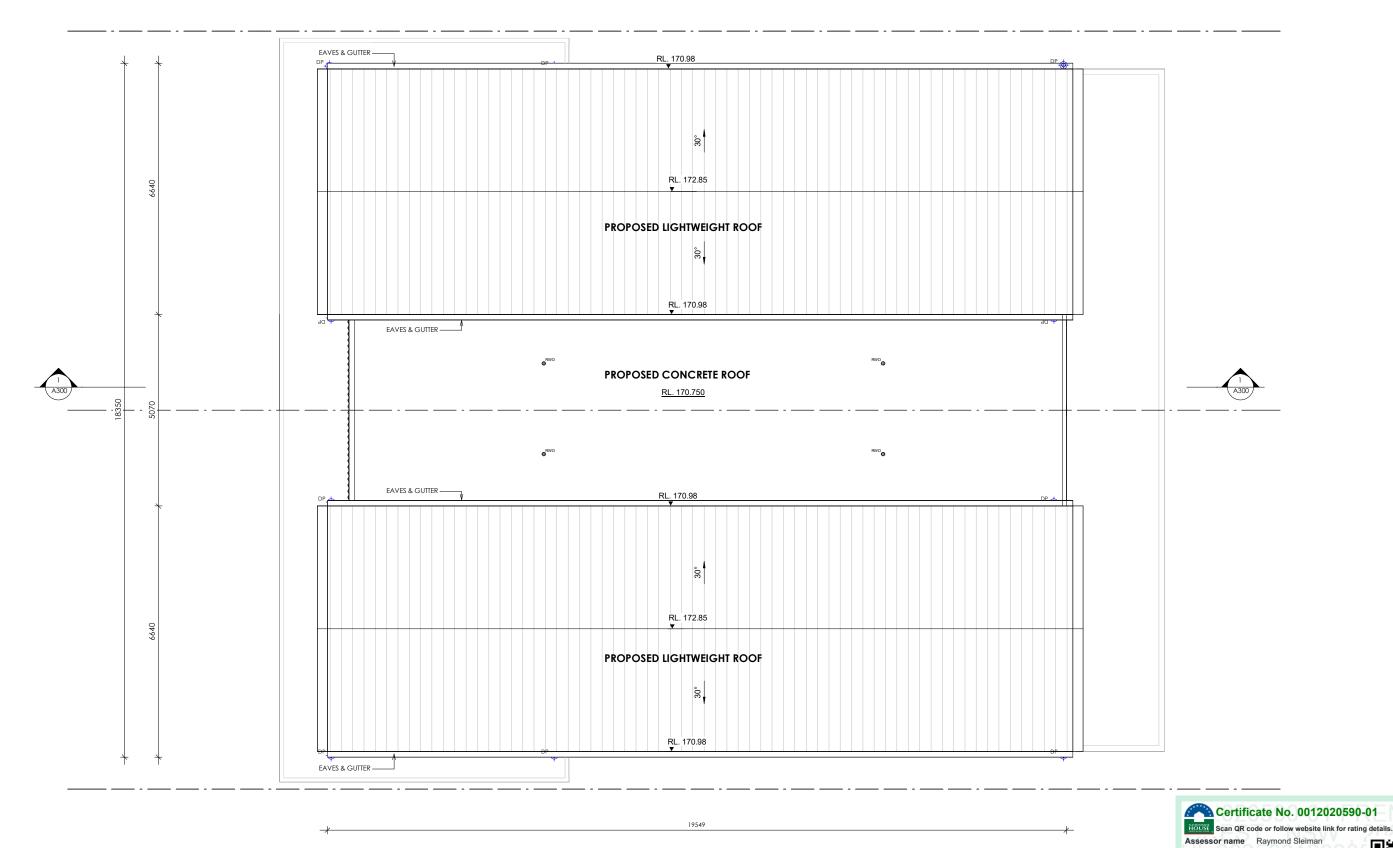

ROOF PLAN

Scale: 1 : 100

Accreditation No. DMN/12/1472 Property Address 47 Blackbutts Road,Frenchs Forest NSW,2086 www.hstar.com.au/QR/Generate?p=cJUoZGKsR CLIENT: STATUS:

ISSUE	DATE	DESCRIPTION	PROJECT:
A B C	30/05/25 16/06/25 18/06/25	FOR DA FOR DA FOR REVIEW	47 BLACKBUTTS RD. FRENCHES FOREST
			ADDRESS: 47 BLACKBUTTS RD. FRENCHES FOREST


DRAWING TITLE:			
ROOF PLAN			
SCALE:			
1 : 100	@ A3		

OLILITI.		0171100.		
CARL VAI	I SEL M	PRELIMINARY		
CARL VAI	N SELIV	FOR COORDINATION		
DRAWN BY:	DM	DRAWING NO:		
PROJECT NO:				
REV DATE:		— A105		

TESS ARCH — 31 Woodstock Road Carlingford NSW 2151 info@lesserarch.com.au T 0488 22 1234


REV

C

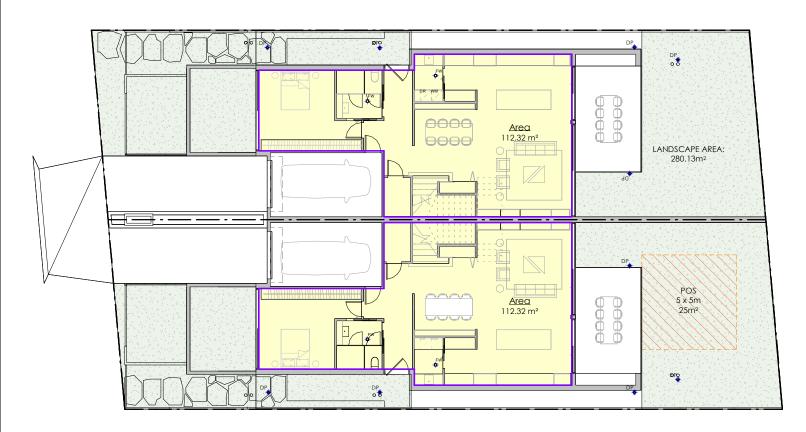

GF

Scale: 1 : 200

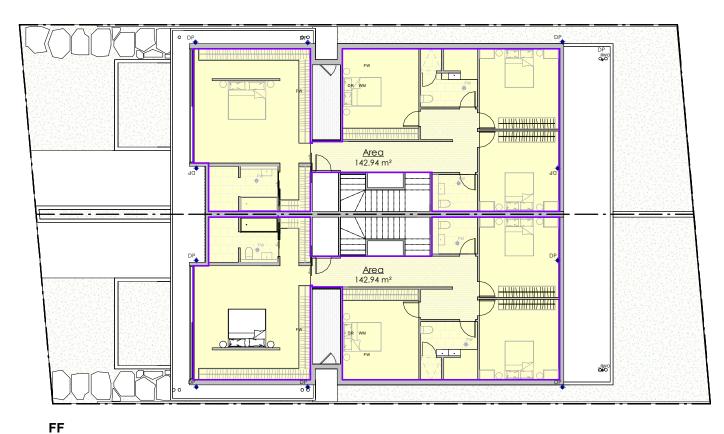

Scale: 1 : 200

All dimensions are to be checked by the builder on site and any discrepancies brought to the attention of Tesserarch Ply Ltd prior to construction. When a dimension is not clear is the builder's responsibility to clarify the dimension with the architect. It is the builder's responsibility to cross reference working drawings with authority endorsed documents. These drawings are not to be scaled. This design is dependent on approval by relevant authorities and comparison with client budget requirements. At time of design, confirmation of these approvals has not been received.

© Tesserarch Pty Ltd. This confidential design and any accompanying documentation is and remains the exclusive property of Tesserarch Pty Ltd. and is to be used solely for the purpose of evaluating our design unless permitted otherwise under a licensity arrangement with Tesserarch Pty Ltd. Design is schematic only and subject to council and other requisite approvals.

ISSUE	DATE	DESCRIPTIO
A	30/05/25	FOR DA
В	16/06/25	FOR DA
С	18/06/25	FOR REVIEW
E	30/06/25	FOR REVIEW

47 BLACKBUTTS RD. FRENCHES FOREST ADDRESS: 47 BLACKBUTTS RD. FRENCHES FOREST

DRAWING TITLE: AREA CALCULATION @ A3

SCALE:

1:200



SITE COMPLIANCE TABLE:

MAX.BUILDING HEIGHT

GROUND FLOOR AREA

FIRST FLOOR AREA

TOTAL FLOOR AREA

PRIVATE OPEN SPACE

LANDSCAPE OPEN SPACE

FRONT SETBACK

SIDE SETBACK REAR SETBACK

LOT AREA

CLIENT: CARL VAN SELM

DRAWN BY: DM CHECKED BY: SS PROJECT NO: 25014 REV DATE:

30/06/2025

PRELIMINARY FOR COORDINATION DRAWING NO: A107

REV

TESS ER — Carlingford NSW 2151 info@tesserarch.com.au T 0488 22 1234



LOT 1 DP 229315

PROPOSED

224.64m²

285.88m²

510.52m²

AS PER PLAN

AS PER PLAN

AS PER PLAN

25m²

280.13m²

8.5m

CONTROL

8.5m

N/A

N/A

N/A


6.5m 0.9m

6.0m

5m x 5m min. 25m²


40% or (279.2m²)

698m²

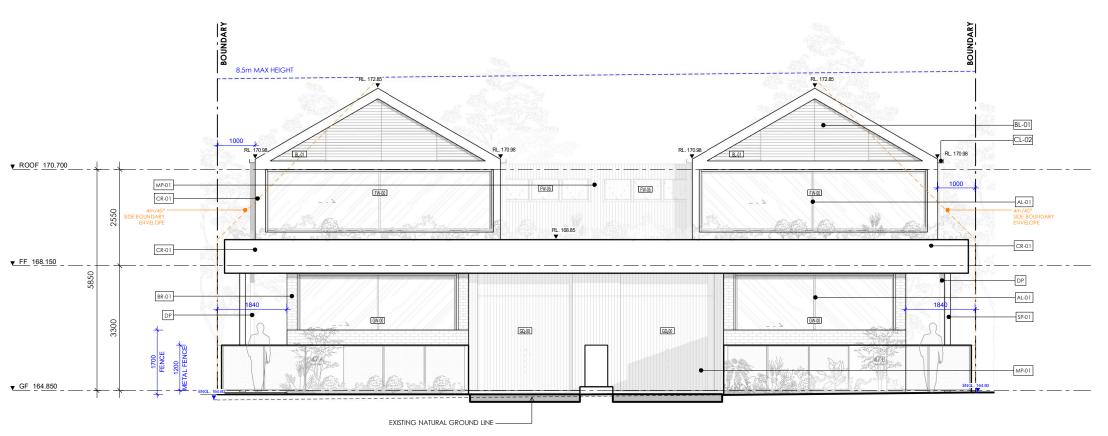

FRONT ELEVATION (NORTH)

Scale: 1 : 100

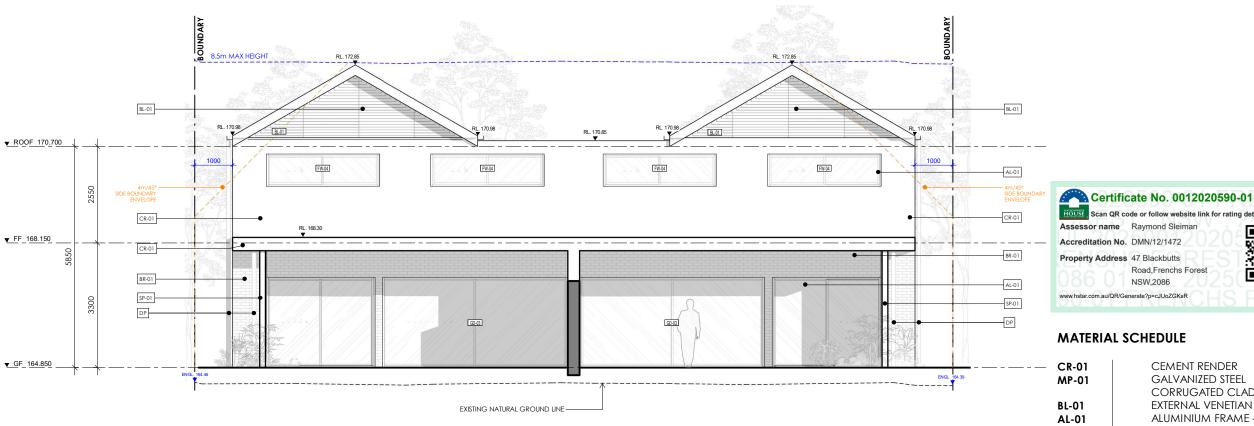

MATERIAL SCHEDULE

Road, Frenchs Forest

NSW,2086

CR-01 MP-01 BL-01 AL-01 RF-01 SP-01

BR-01

REV

Ε

CEMENT RENDER GALVANIZED STEEL CORRUGATED CLADDING - GREY EXTERNAL VENETIAN BLINDS ALUMINIUM FRAME - WHITE COLORBOND ROOF GALVANIZED STEEL POSTS NATURAL BRICK - TERRACOTTA

ISSUE	DA
A	30/
В	16/
С	18/
E	30/

DESCRIPTION 47 BLACKBUTTS RD. FRENCHES FOREST 47 BLACKBUTTS RD. FRENCHES FOREST

Scale: 1 : 100


REAR ELEVATION (SOUTH)


DRAWING TITLE: FRONT AND REAR ELEVATION As indicated

CARL VAN SELM DRAWN BY: DM

STATUS: PRELIMINARY FOR COORDINATION CHECKED BY: DRAWING NO: 25014 A200 REV DATE: 30/06/2025



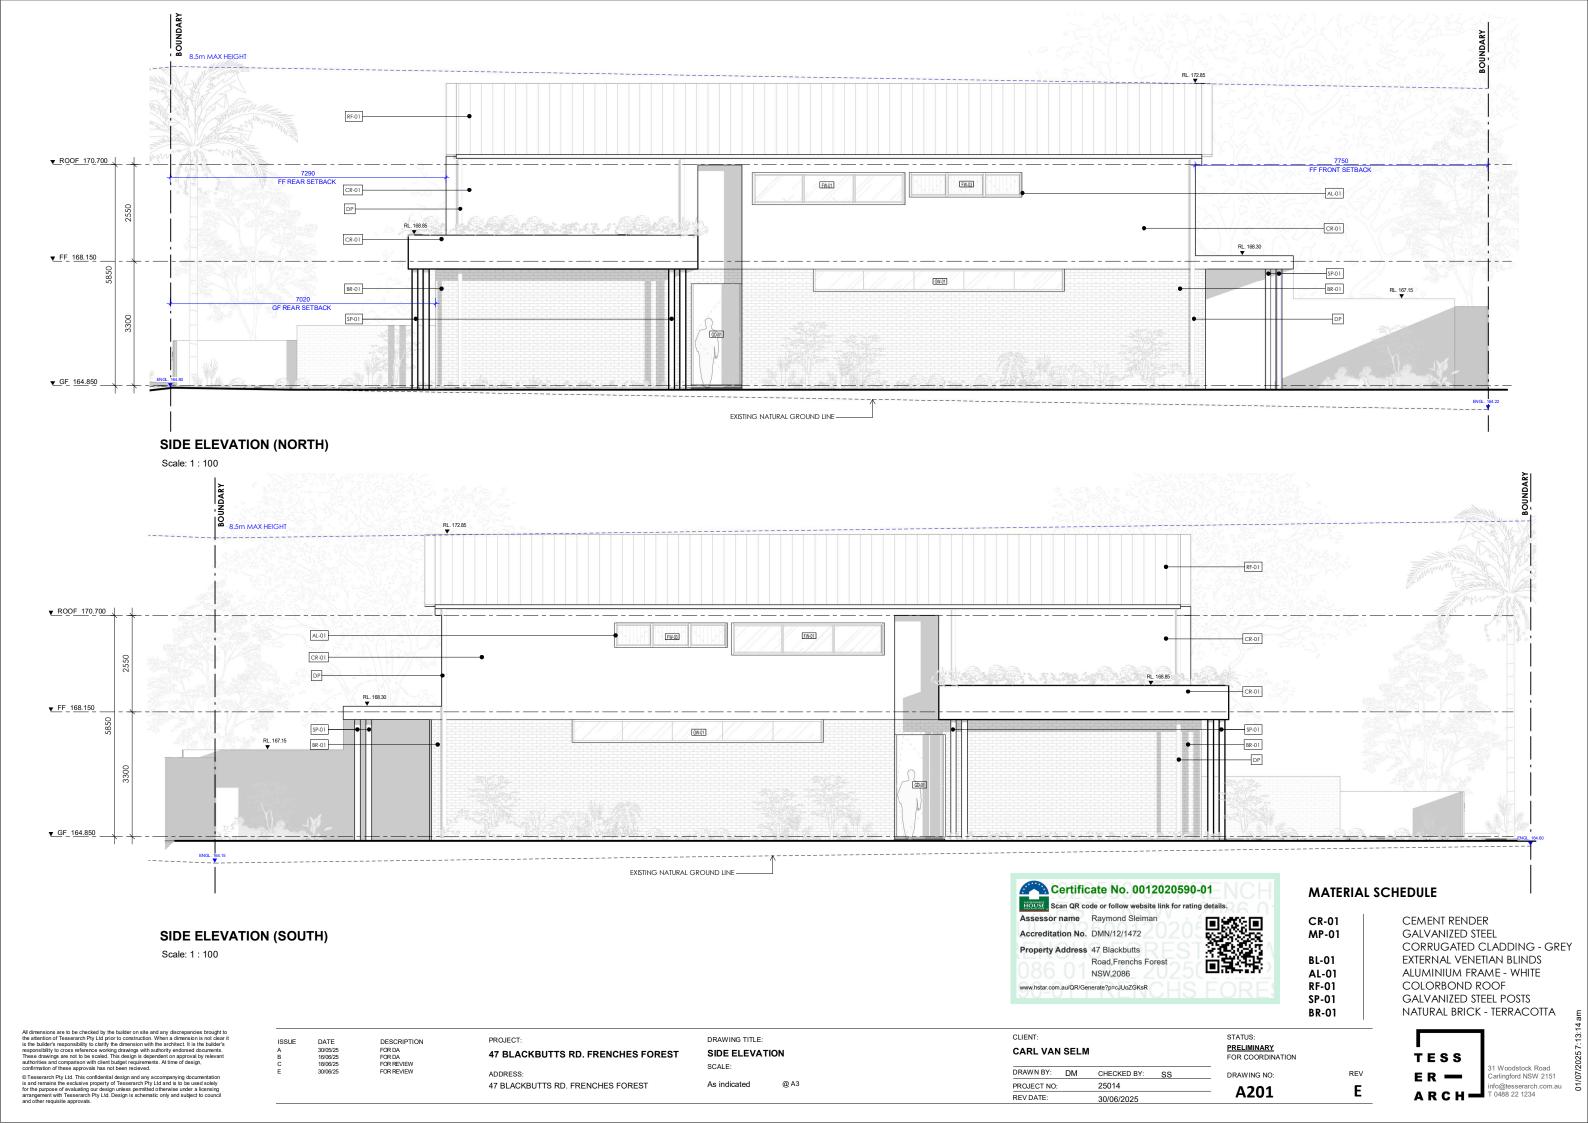

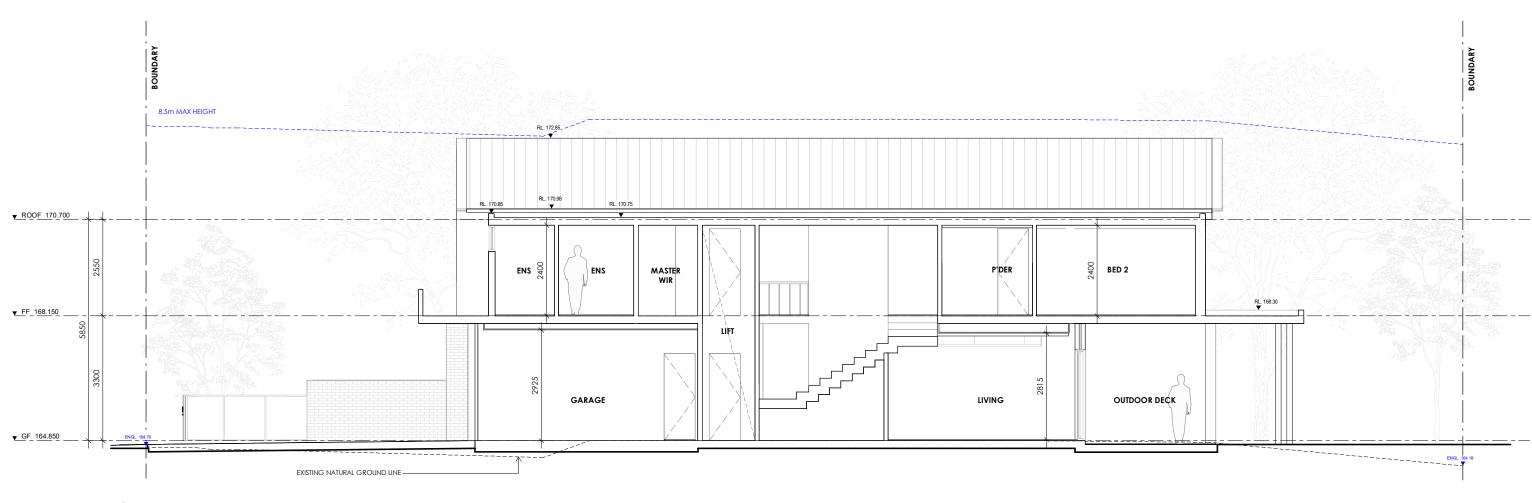

Section 1 Scale: 1 : 100

> Certificate No. 0012020590-01
>
> EXECUTE: Scan QR code or follow website link for rating details. Assessor name Raymond Sleiman

Accreditation No. DMN/12/1472

Property Address 47 Blackbutts Road, Frenchs Forest

NSW,2086



47 BLACKBUTTS RD. FRENCHES FOREST ADDRESS:

DRAWING TITLE: SECTION 1:100

CARL VAN SELM DRAWN BY: Author CHECKED BY: Checker STATUS: PRELIMINARY
FOR COORDINATION

A300




DESCRIPTION FOR DA FOR DA FOR REVIEW FOR REVIEW

47 BLACKBUTTS RD. FRENCHES FOREST

@ A3

25014 REV DATE: 30/06/2025 REV Ε

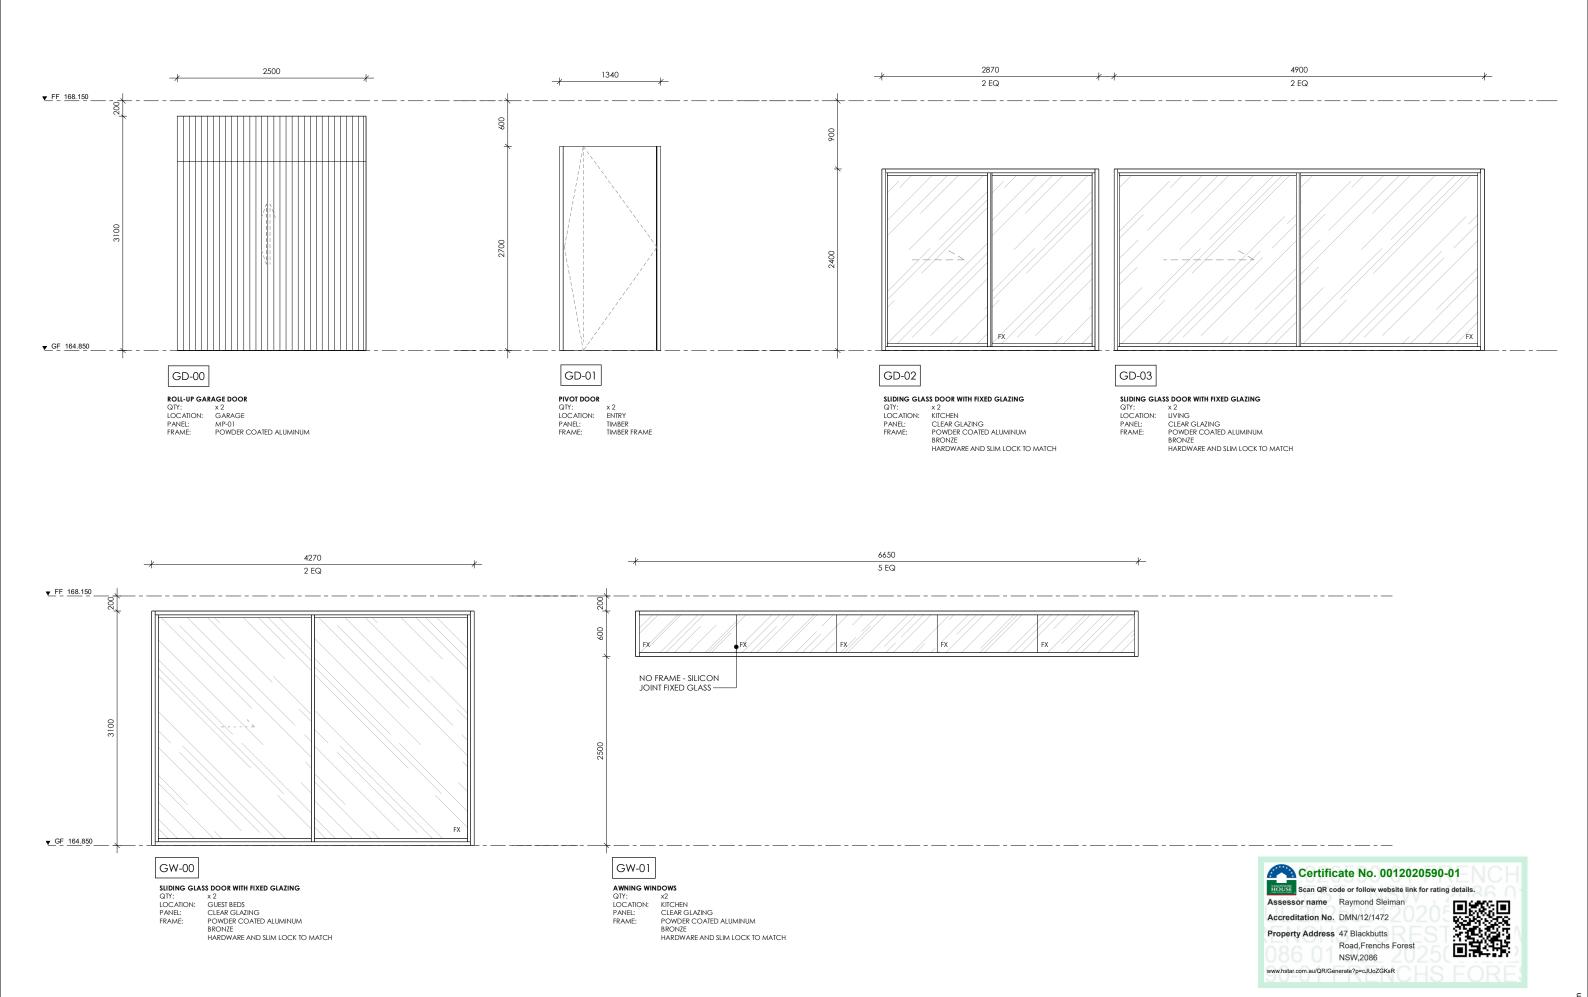

DESCRIPTION FOR DA FOR REVIEW ADDRESS:

47 BLACKBUTTS RD. FRENCHES FOREST 47 BLACKBUTTS RD. FRENCHES FOREST

DRAWING TITLE: **EXTERNAL DOORS & WINDOW SCHEDULE**

@ A3

1:50


CARL VAN SELM

DRAWN BY: DM CHECKED BY: SS 25014 REV DATE: 24/06/2025

STATUS: PRELIMINARY
FOR COORDINATION

DRAWING NO: REV C A701



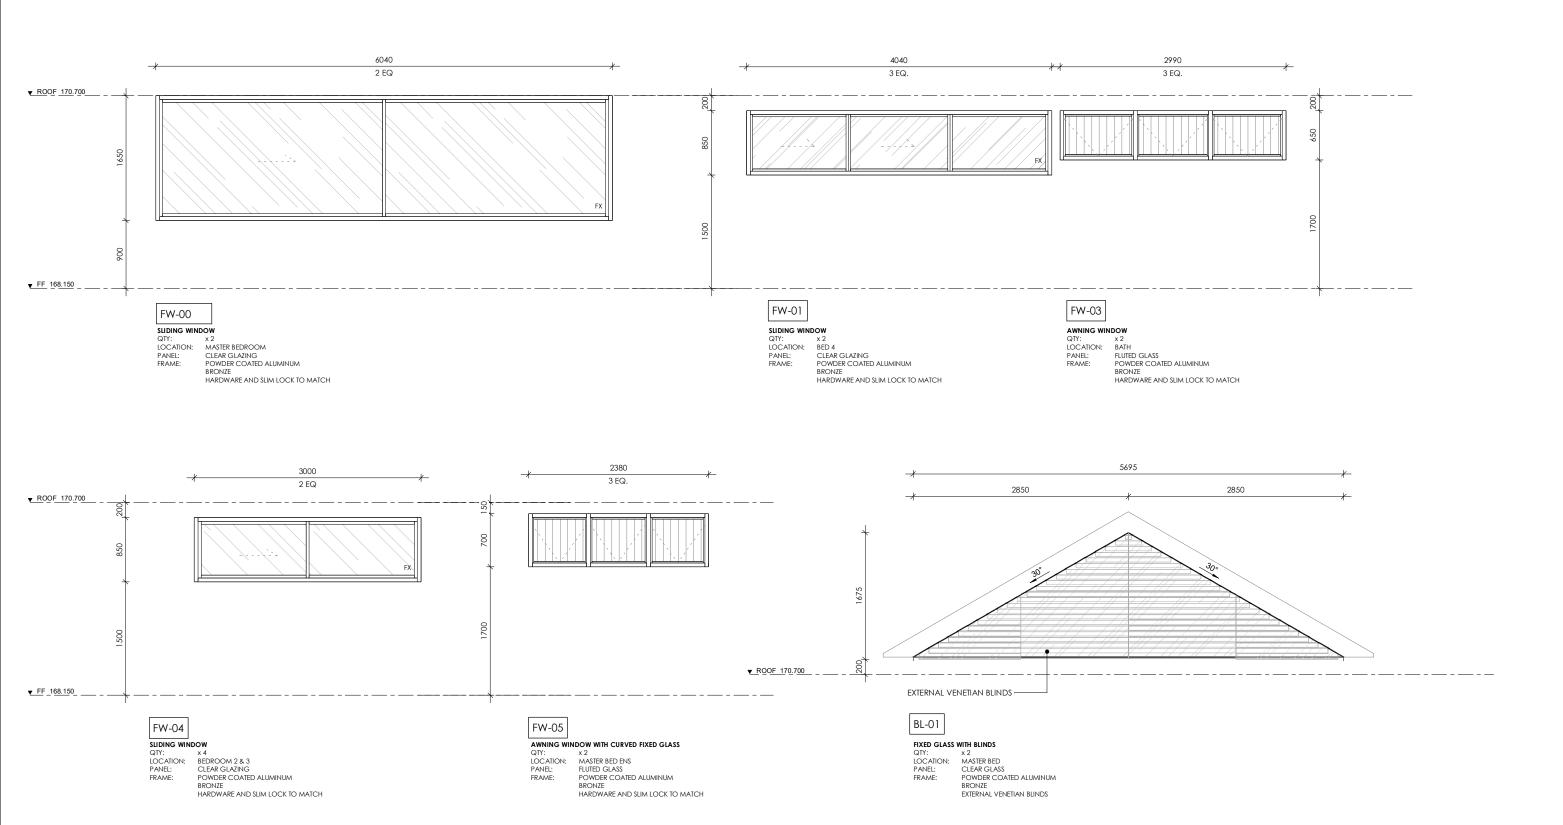



DESCRIPTION FOR DA FOR REVIEW 47 BLACKBUTTS RD. FRENCHES FOREST ADDRESS:

47 BLACKBUTTS RD. FRENCHES FOREST


DRAWING TITLE: **EXTERNAL DOORS & WINDOW SCHEDULE** 1:50 @ A3


CARL VAN SELM DRAWN BY: DM CHECKED BY: SS 25014 REV DATE: 24/06/2025


STATUS: PRELIMINARY FOR COORDINATION

REV C A702



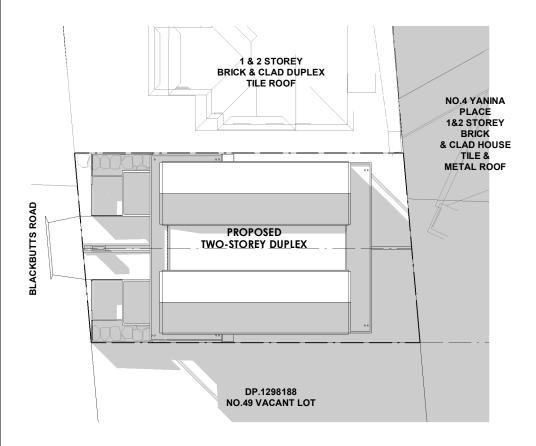

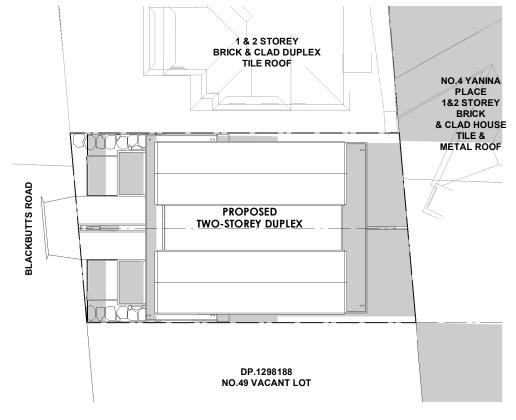

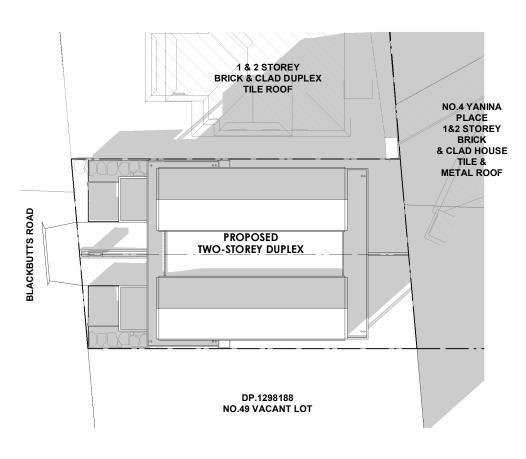

JUNE 21 12PM JUNE 21 3PM JUNE 21 9AM

Scale:1:400 Scale:1:400 Scale:1:400

All dimensions are to be checked by the builder on site and any discrepancies brought to the attention of Tesserarch Pty Ltd prior to construction. When a dimension is not clear is the builder's responsibility to clarify the dimension with the architect. It is the builder's responsibility to cross reference working drawings with authority endorsed documents. These drawings are not to be scaled. This design is dependent on approval by relevant authorities and companison with client budget requirements. At time of design, confirmation of these approvals has not been reclieved.

© Tesserarch Pty Ltd. This confidential design and any accompanying documentation is and remains the exclusive property of Tesserarch Pty Ltd. and is to be used soely for the purpose of evaluating our design unless permitted otherwise under a licensity arrangement with Tesserarch Pty Ltd. Design is schematic only and subject to council and other requisite approvals.

ISSUE DESCRIPTION FOR DA FOR REVIEW

47 BLACKBUTTS RD. FRENCHES FOREST ADDRESS:

47 BLACKBUTTS RD. FRENCHES FOREST

DRAWING TITLE: SHADOW DIAGRAMS 1:400 @ A3

CLIENT: CARL VAN SELM

DRAWN BY: DM CHECKED BY: 25014 REV DATE: 24/06/2025

STATUS: PRELIMINARY
FOR COORDINATION DRAWING NO: A810

REV

C







All dimensions are to be checked by the builder on site and any discrepancies brought to the attention of Tesserarch Pty Ltd prior to construction. When a dimension is not clear it is the builder's responsibility to called the dimension with the architect. It is the builder's responsibility to cross reference working drawings with authority endorsed documents. These drawings are not to be scaled. This design is dependent on approval by relevant authorities and comparison with client budget requirements. At time of design, confirmation of these approvals has not been redeved.

Or Tesseranch Pty Ltd. This confidential design and any accompanying documentation is and remains the exclusion of exclusive property of Tesseranch Pty Ltd and is to be used solely for the purpose of exulaxing our period resign unless permitted otherwise under a licensing arrangement with Tesseranch Pty Ltd. Design is schematic only and subject to council and other requisite approvals.

ISSUE	DATE	DESCRIPT
Α	30/05/25	FOR DA
В	16/06/25	FOR DA
С	18/06/25	FOR REVIEW

47 BLACKBUTTS RD. FRENCHES FOREST ADDRESS: 47 BLACKBUTTS RD. FRENCHES FOREST

DRAWING TITLE: 3D BUILDING HEIGHT PLANE @ A3

CLIENT: CARL VAN SELM DRAWN BY: DM CHECKED BY: SS 25014 REV DATE: 24/06/2025

PRELIMINARY
FOR COORDINATION REV DRAWING NO: A820 C





DESCRIPTION FOR DA FOR DA FOR REVIEW

47 BLACKBUTTS RD. FRENCHES FOREST

47 BLACKBUTTS RD. FRENCHES FOREST

ADDRESS:

DRAWING TITLE: 3D RENDER

CLIENT: CARL VAN SELM

DRAWN BY: DM CHECKED BY: SS PROJECT NO: 25014 REV DATE: 24/06/2025

STATUS:
PRELIMINARY
FOR COORDINATION

A900

DRAWING NO:

TESS

REV

C

ARCH — 31 Woodstock Road Carlingford NSW 2151 info@lesserarch.com.au T 0488 22 1234