

Narrabeen Education Precinct -Flood Risk and Impact Assessment for DA





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Author	Richard Wang, Jacquie Hannan	
Reviewed By	Jacquie Hannan	
Project Manager	Jacquie Hannan	

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1 Introduction

1.1 Development Proposal

The proposed Narrabeen Education Precinct (NEP) development includes redevelopment of Narrabeen North Public School (NNPS) and Narrabeen Sports High School (NSHS). The Public School and High School have been identified by the NSW Department of Education (DoE) as requiring upgrade works.

The works at NNPS upgrade the school, including demolition of existing buildings (Blocks H and J), construction of three (3) new buildings and refurbishment of three (3) existing buildings (Blocks B, K and V).

The works at NSHS upgrade the school, including addition of new two (2) storey extension to Building A, construction of new single storey amenities building and refurbishment of four (4) existing buildings (Buildings A, B, C and K).

This Development Application (DA) will seek consent for the following works at NNPS and NSHS:

- The works that are the subject of the Development Application (DA) at NNPS comprise:
 - Construction of a new two (2) storey building containing administration facilities, multi-purpose hall and out-of-school-hours care (OSHC) facility on the ground floor with staff facilities and amenities on the first floor.
 - New Covered Outdoor Learning Area (COLA).
- The works that are the subject of the DA at NSHS comprise:
 - Alterations and additions to Building A (Gymnasium) to create new stage for gymnasium and new two (2) storey addition comprising canteen, boys and girls changing rooms and staff room on the ground floor; and movement studio and two (2) new General Learning Spaces (GLS) on the first floor.

Other development works are occurring on the site under separate planning pathways including:

- Development without consent (REF).
- Exempt development.

The proposed development does not seek to increase staff or student numbers.

1.2 Site Description

The subject sites are located at 6 and 10 Namona Street, North Narrabeen (referred to as the Narrabeen Education Precinct) and within the local government area (LGA) of Northern Beaches Council ("Council"). The NEP has a total area of 9.84 hectares.

NNPS is located on the northern side of Namona Street, North Narrabeen and is legally described as Lot 3 Deposited Plan (DP) 1018621. NNPS is surrounded by residential dwellings to the east, grassed sporting fields (Warriewood Valley Sportsground) to the north and Northern Beaches Indoor Sports Centre to the west. NNPS contains two (2) Binishell domes (Block A and Block B) which are identified as a local heritage items under the 'Pittwater Local Environmental Plan 2014'. The two (2) Binishell Domes are listed as State significant on DoE's Section 170 Heritage and Conservation Register. The Double Binishell Dome (Block B) is listed on the State Heritage Register (SHR).



NSHS is located on the southern side of Namona Street and is legally described as Lot 12 DP 1119562. NSHS is surrounded by Pittwater Road to the east, Pittwater Sports Centre to the south and Mullet Creek to the west.

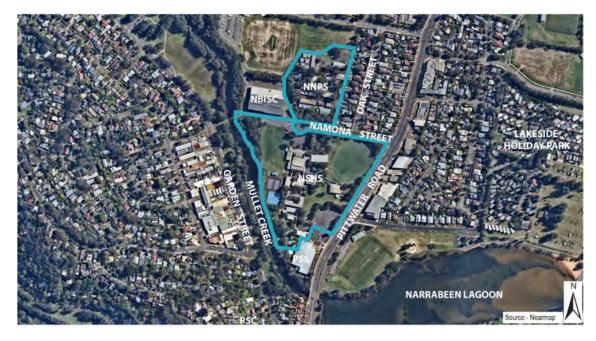


Figure 1.1 Site Aerial Map (Source: Nearmap)

1.3 Purpose of this Report

As shown in Figure 1.1, the NEP is located north of Narrabeen Lagoon on Mullet Creek, immediately upstream of confluence with the South Creek ocean entrance channel. Mainstream flood behaviour within the Narrabeen Lagoon catchment is defined by the 'Narrabeen Lagoon Flood Study' (BMT WBM, 2013) and 'Narrabeen Lagoon Floodplain Risk Management Study' (FRMS) (Cardno, 2019). In 2021, BMT also completed a flood impact assessment (FIA) for the placement of demountable buildings within the NSHS site, as documented in the 'Narrabeen Sports High School – Flood Impact Assessment' (BMT, 2021).

The results of the available flood studies indicate that the site is affected by mainstream flooding from Mullet Creek, as well as backwater flow from South Creek. However, due to its position north of the lagoon and on the lower reaches of Mullet Creek, flood behaviour at the NEP site is dominated by lagoon flood conditions.

As the NEP is located within an area that has been identified as flood prone, proposed works should be compatible with the predicted on-site flood risk and any changes to floodplain conditions as a result of the development have the potential to alter the distribution of floodwaters in the vicinity of the NEP. Accordingly, SINSW engaged BMT to undertake a Flood Risk and Impact Assessment for works proposed in this DA. This report details the methodology and findings of this assessment, including:

- Collection and review of available data and reports.
- Definition of existing (baseline) flood conditions.
- Definition of proposed flood conditions.
- Assessment of the potential impacts of the proposed development on existing flood behaviour.



- Flood emergency assessment.
- Responses to relevant flood-related requirements outlined in Council's 'Pittwater 21 Development Control Plan' (DCP).



2 Existing Flood Behaviour

2.1 Site Characteristics

The NEP is shown in Figure 2.1 and covers an area of approximately 9.87 ha that includes both the NSHS and NNPS sites. The Precinct is generally bounded by Mullet Creek to the west and Pittwater Road to the east, and is intersected by Namona Street. Mullet Creek flows in a south-easterly direction immediately along the western boundary of the NSHS site and discharges into South Creek (or Narrabeen Lagoon) downstream of Pittwater Road. Existing site plans for NNPS and NSHS, showing the current layout and land use within these sites, are provided in Annex A and Annex B respectively.

Existing topography across the NEP is shown in Figure 2.1. NSHS is within a lower lying floodplain area than NNPS and grades from the north-east to south-west towards Mullet Creek with ground levels ranging from 0.0 to 5.2 mAHD. The terrain within NNPS ranges from 1.9 to 5.2 mAHD.

2.2 Previous Flood Studies

2.2.1 Narrabeen Lagoon Flood Study (2013)

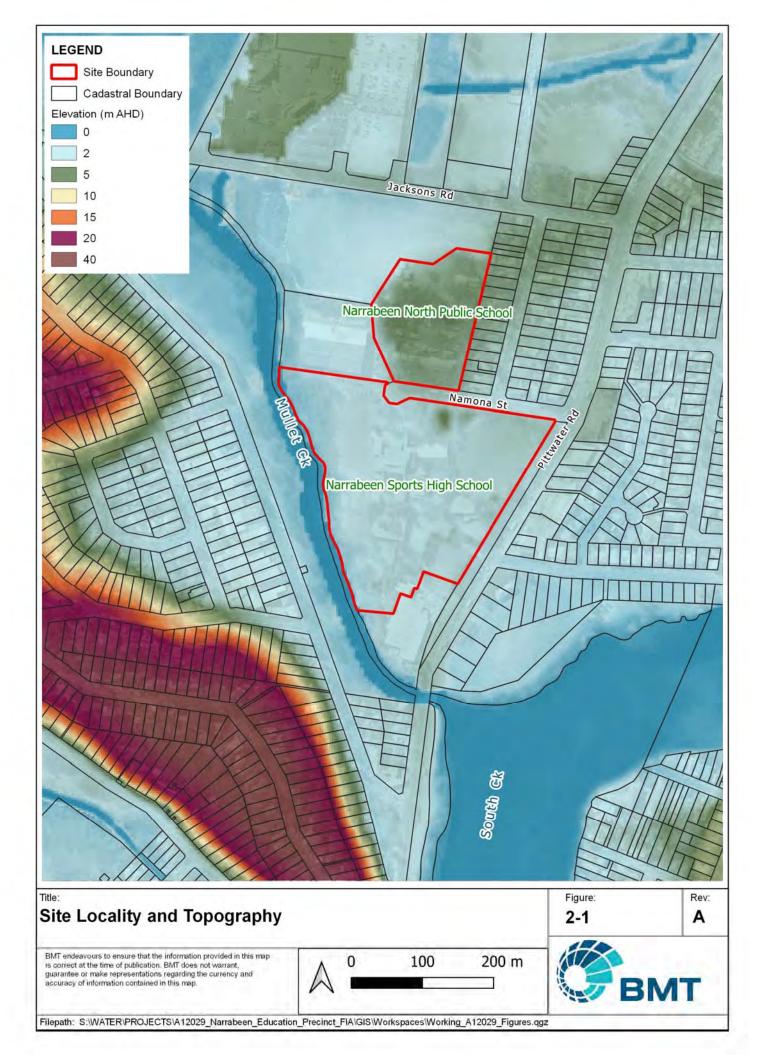
The 'Narrabeen Lagoon Flood Study' (BMT WBM, 2013) covers the catchment areas of Nareen Creek, Mullet Creek, Narrabeen Creek (incorporating Fern Creek), Deep Creek, Middle Creek (incorporating Snake Creek, Oxford Creek and Trefoil Creek) and South Creek (incorporating Wheeler Creek). It defines the flood behaviour within the study area using broad-scale modelling based on an XP-RAFTS hydrologic model of the catchment and a TUFLOW hydraulic model of the watercourses. Inflow hydrographs (produced by the results of the XP-RAFTS modelling) are distributed to every cell in the TUFLOW modelling. The model also simulates the dynamic processes of entrance berm scouring and breakout in order to represent the complex relationship between entrance dynamics and flood conditions in the lower catchment.

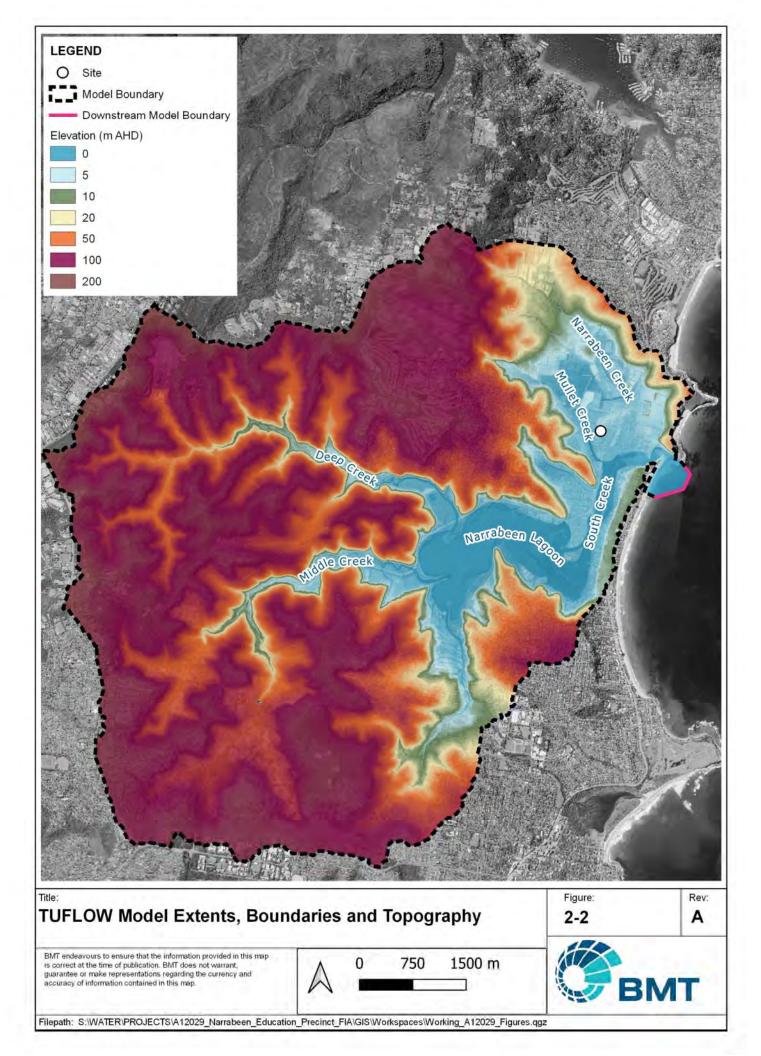
The 'Narrabeen Lagoon Flood Study' was used to establish design flood conditions for the study area for a range of design storm events including the 50%, 20%, 10%, 5%, 2%, 1%, 0.5%, 0.2% and 0.1% annual exceedance probability (AEP) floods, as well as the Probable Maximum Flood (PMF). Sensitivity of the flood behaviour to increased rainfall intensity and sea level rise associated with climate change was also assessed. Figure 2.2 shows the extent, boundary locations and model topography of the TUFLOW model from the flood study.

2.2.2 Narrabeen Lagoon Floodplain Risk Management Study and Plan (2019)

The 'Narrabeen Lagoon Floodplain Risk Management Study' (FRMS) (Cardno, 2019) built upon the previous work from the 'Narrabeen Lagoon Flood Study' to identify and assess flood risk management options for the catchment. The 'Narrabeen Lagoon Flood Study' was reviewed as part of the FRMS and it was determined that: *"all hydraulic parameters utilised within the Flood Study are appropriate...The model is therefore suitable for use within this FRMS."* (Cardno, 2019). Therefore, design flood results from the 'Narrabeen Lagoon Flood Study' were not updated as part of the FRMS.

Accordingly, the TUFLOW Model from the 'Narrabeen Lagoon Flood Study' (hereafter referred to as the Flood Study TUFLOW Model) forms the latest flood model for the catchment adopted for use by Council.







2.2.3 Narrabeen Sports High School Flood Impact Assessment (2021)

This flood impact assessment was completed for proposed demountable buildings within NSHS. The assessment was based on an updated version of the Flood Study TUFLOW model that included the following modifications:

- Inclusion of detailed site survey dated 11 November 2019 to define existing ground surface elevations within NSHS.
- Updates to model terrain within the site and any immediately adjoining areas not covered by the 2019 site survey based on available LiDAR data collected in 2016 (downloaded from Elvis Geographic Website¹).
- Updates to the hydraulic roughness (i.e. material polygons) within NSHS and its immediate vicinity based on aerial photography of the study area and site survey dated 11 November 2019. This included changes to the locations and extents of building footprints within NSHS. Consistent with the approach used for the Flood Study TUFLOW Model, building footprint areas were modelled using a very high Manning's 'n' roughness value. Manning's 'n' values consistent with those used in the 'Narrabeen Lagoon Flood Study' (BMT WBM, 2013) were applied within the model.

The updated version of the Flood Study TUFLOW model, hereafter referred to as the "NSHS TUFLOW model", was used to simulate the critical 50% AEP, 20% AEP, 1% AEP and PMF events. The results of the modelling defined on-site flood behaviour for existing and proposed flood conditions, as well as predicted impacts resulting from the proposed demountable buildings.

The results of the assessment indicated that NSHS is affected by mainstream flooding from Mullet Creek from frequent events such as the 50% AEP flood, and backwater flow from South Creek scaling in severity with flood magnitude up to the PMF.

2.3 TUFLOW Model Updates for Existing Conditions

The NSHS TUFLOW model was used as the basis for modelling completed as part of this Flood Risk and Impact Assessment for NEP. In order to assess the flood impacts of the proposed development at a more localised and detailed scale, it was necessary to update the NSHS TUFLOW model in the vicinity of the NEP as follows:

- **Existing Scenario TUFLOW model:** Establishes a baseline for flood conditions within the NEP that is representative of existing building footprints, local landforms and land use (discussed below).
- **Proposed Scenario TUFLOW model**: Uses the Existing Scenario TUFLOW Model with the proposed site modifications (discussed in Section 3) to define flood conditions with the proposed development in place.

No changes were made to model inflow or boundary conditions.

2.3.1 Model Topography

Detailed site survey undertaken by C.M.S Surveyors Pty Ltd and dated 16 March 2022 was provided to BMT by Enstruct as an electronic 3D Digital Terrain Model (DTM) (file reference: "18830Adetail 4.dwg"). It provides the most contemporary definition of ground surface elevations within the extent of the NEP. The 3D DTM was processed to develop a Digital Elevation Model (DEM) and used to define existing ground surface elevations on-site.

¹ https://elevation.fsdf.org.au/



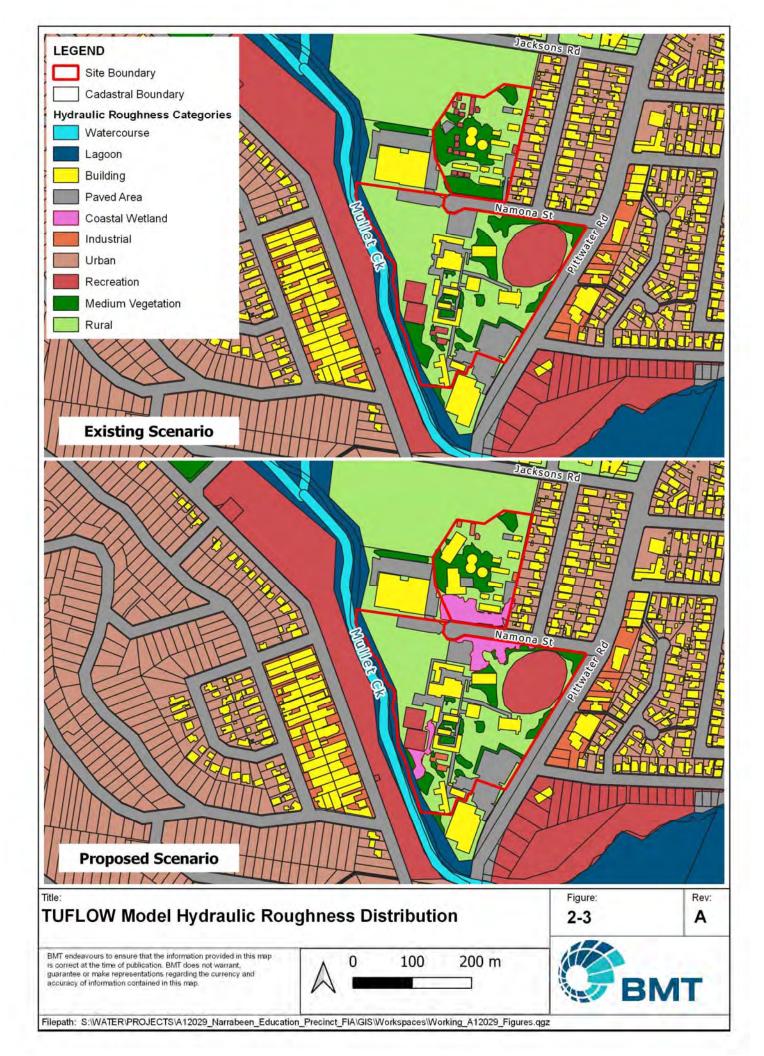
2.3.2 Hydraulic Roughness

The TUFLOW software employs material polygons (or zones) to define the variation in hydraulic roughness (or Manning's 'n' values) across the model. For the Existing Scenario TUFLOW model, the material polygons within the NEP were updated, as necessary, based on the detailed site survey dated 16 March 2022 (file reference: "18830Adetail 4.dwg") and existing site plans enclosed in Annex A and Annex B for NNPS and NSHS respectively. The spatial distribution of the hydraulic roughness zones is shown in Figure 2.3. Manning's 'n' values consistent with those adopted in the 'Narrabeen Lagoon Flood Study' (BMT, 2013) were applied for this assessment.

2.3.3 Representation of Buildings

For the Existing Scenario TUFLOW model, building footprints within the NEP were updated, as necessary, based on the detailed site survey dated 16 March 2022 (file reference: "18830Adetail 4.dwg") and existing site plans enclosed in Annex A and Annex B. The spatial distribution of building footprints is shown in Figure 2.3. A high Manning's 'n' roughness value was applied within building footprints, consistent with the approach and values adopted in the 'Narrabeen Lagoon Flood Study' (BMT, 2013).

Building floor levels (where available) were adopted across building footprints that provide a solid obstruction to flow. However, due to the elevated nature of existing demountables within the school sites (i.e. placement on piers rather than slab on ground construction), demountable buildings were not modelled as "buildings" within the hydraulic roughness categories but were instead modelled as layered flow constriction shapes with a "recreational" hydraulic roughness category applied to the ground surface beneath these structures. This approach allowed floodwaters to flow with some impedance underneath the structures but restricted higher flows at levels sufficient to meet the solid portion of the demountable structure.





2.4 Existing Flood Conditions

2.4.1 Flood Behaviour

The Existing Scenario TUFLOW model was used to simulate the critical 1% AEP flood and PMF to establish existing (baseline) flood conditions within the NEP. Peak flood depths, velocities, and hazard and hydraulic categories for existing conditions have been mapped and are presented in Annex C.

Existing flood behaviour with the NEP can be summarised as follows:

- Mullet Creek is predicted to flow in a south-easterly direction into South Creek under normal conditions. Outflows from South Creek are restricted by the berm downstream of Ocean Street.
- During rare and extreme flood such as the 1% AEP flood and PMF, the NEP is inundated by high floodwater depths, with initial inundation occurring as a result of flow breakout from Mullet Creek and excess backwater flow from South Creek then contributing to flooding within the site.
- Predicted peak 1% AEP flood and PMF levels within the NEP are 2.96 mAHD and 4.87 mAHD, respectively.
- Within NNPS:
 - Inundation during the 1% AEP flood is restricted to areas immediately adjoining the western boundary of the site, whilst the remainder of the NNPS site is above the 1% AEP flood level. Maximum peak floodwater depths of 1.0 m are predicted, however floodwater depths are typically less than 0.5 m.
 - More significant extent of inundation is predicted during the PMF. Maximum peak floodwater depths exceed 2 m along the western site boundary, however floodwater depths across the majority of NNPS are generally less than 0.8 m.
- Within NSHS:
 - The majority of the site is inundated during both the 1% AEP flood and PMF.
 - Peak 1% AEP floodwater depths are typically less than 0.8 m, reaching a maximum of 4.6 m within Mullet Creek along the western boundary of the site.
 - More significant depths of inundation are predicted during the PMF, ranging up to a maximum depth of approximately 6 m within Mullet Creek along the western site boundary. However, depths are typically less than 2.2 m across the majority of the site.

2.4.2 Flood Hazard

The 'Australian Disaster Resilience Handbook 7 Managing the Floodplain: A Guide to Best Practice in Flood Risk Management in Australia' (AIDR, 2017) considers a holistic approach to consider flood hazards to people, vehicles and structures. It recommends a composite six-tiered hazard classification, reproduced in Figure 2.4 and summarised in Table 2.1. Existing flood hazard mapping for the 1% AEP flood and PMF is provided in Annex C.



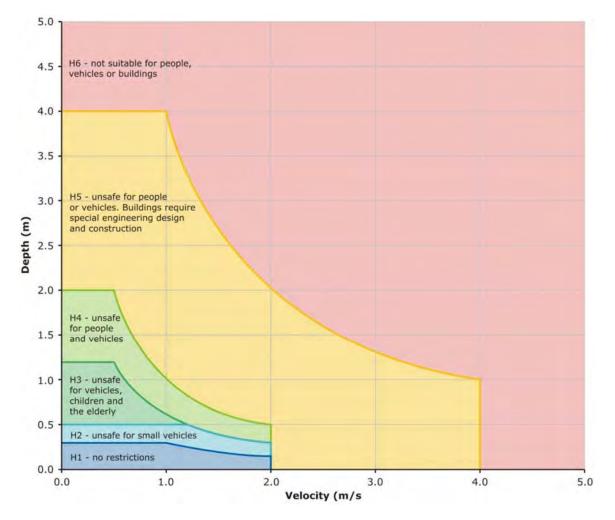


Figure 2.4 Combined Flood Hazard Curves

Table 2.1 Best Practice Provisional Flood Hazards (AIDR, 2017)

Hazard Classification		Description
H1	Depth less than 0.3 m and Velocity less than 2.0 m/s and Velocity*Depth less than 0.3 m²/s	Generally safe for vehicles, people and buildings.
H2	Depth less than 0.5 m and Velocity less than 2.0 m/s and Velocity*Depth less than 0.6 m²/s	Unsafe for small vehicles
H3	Depth less than 1.2 m and Velocity less than 2.0 m/s and Velocity*Depth less than 0.6 m²/s	Unsafe for vehicles, children and the elderly.
H4	Depth less than 2.0 m and Velocity less than 2.0 m/s and Velocity*Depth less than 1.0 m²/s	Unsafe for vehicles and people.



Hazard Classification		Description
H5	Depth less than 4.0m and Velocity less than 4.0 m/s and Velocity*Depth less than 4.0 m²/s	Unsafe for vehicles and people. All building types vulnerable to structural damage. Some less robust building types vulnerable to failure.
H6	Depth greater than 4.0 m OR Velocity greater than 4.0 m/s OR Velocity*Depth greater than 4.0 m²/s	Unsafe for vehicles and people. All building types considered vulnerable to failure.

The 1% AEP flood extent is confined to areas immediately along the western site boundary and is dominated by a H1 hazard classification within NNPS. During the PMF, hazard classification within NNPS is primarily H1 to H3, with higher hazard classifications of H4 and H5 restricted to areas immediately adjoining the western and northern site boundaries.

The 1% AEP flood hazard classification within NSHS is predominately H3 under existing conditions, where H3 hazard categorisation indicates that floodwaters are unsafe for children, vehicles and the elderly. Higher 1% AEP hazard classifications of H4 are predicted along the western boundary adjacent to Mullet Creek and lower hazard categories of H1 and H2 are predicted in the north-east and east of the site. The PMF hazard classification within the site is predominantly H5, indicating that floodwaters are unsafe for all people and vehicles and that buildings will require special engineering design and construction to withstand floodwaters.

The main access roads to the NEP – Pittwater Road and Namona Street – are predicted to be subject to up to H5 hazard conditions at the peak of the PMF. Under existing peak 1% AEP conditions, hazard conditions along these roads are classified as H1 to H3.



3 Proposed Flood Behaviour

3.1 Proposed Development

Proposed design plans for NEP were provided to BMT by JohnStaff for NSHS and NNPS on 16 September 2022 (refer Annex A and Annex B). These plans show the proposed development layout and land use within these sites (discussed further below) and informed this Flood Risk and Impact Assessment.

3.1.1 NNPS

The works at NNPS upgrade the school and include demolition of existing buildings (Blocks H and J), construction of three (3) new buildings, and refurbishment of three (3) existing buildings (Blocks B, K and V). Eleven (11) demountables will also be removed from the site.

The works that are the subject of the DA at NNPS comprise:

- Construction of a new two (2) storey building (Block D) containing administration facilities, multipurpose hall and out-of-school-hours care (OSHC) facility on the ground floor with staff facilities and amenities on the first floor.
- New Covered Outdoor Learning Area (COLA).

Proposed finished floor levels for the two (2) new buildings within NNPS, referred to as Block D (part of this DA) and Block E (separate planning pathway) are set at:

- Ground Floor: 4.95 mAHD (i.e. above the PMF level of 4.87 mAHD).
- Level 1: 8.55 mAHD.

3.1.2 NSHS

The works at NSHS upgrade the school, including addition of new two (2) storey extension to Building A, construction of new single storey amenities building and refurbishment of four (4) existing buildings (Buildings A, B, C and K).

The works that are the subject of the DA at NSHS comprise:

 Alterations and additions to Building A (Gymnasium) to create new stage for gymnasium and new two (2) storey addition comprising canteen, boys and girls changing rooms and staff room on the ground floor; and movement studio and two (2) new General Learning Spaces (GLS) on the first floor.

The ground finished floor level (FFL) for the extension will be 2.55 mAHD, however all habitable new build space will be situated on Level 1 which has a proposed FFL of 5.90 mAHD.

3.2 TUFLOW Model Modifications for Proposed Conditions

The Existing Scenario TUFLOW model was updated (as specified in the sections below) to incorporate the proposed development based on the design plans provided by JohnStaff and enclosed in Annex A and Annex B. This updated model constituted the Proposed Scenario TUFLOW Model and was used to simulate proposed flood behaviour.

Please note that the works proposed as part of this DA, as well as other proposed works subject to separate planning pathways (e.g. removal of buildings proposed for demolition from the model to



enable placement of new buildings, etc) were included in the Proposed Scenario TUFLOW model to represent the ultimate development conditions within the NSHS and NNPS sites.

3.2.1 Model Topography

Ground surface elevations within the Existing Scenario TUFLOW model were also used for the Proposed Scenario TUFLOW model.

3.2.2 Hydraulic Roughness

Roughness zones were modified to represent the land use surfaces with the proposed development in place. The spatial distribution of the hydraulic roughness zones under proposed conditions is shown in Figure 2.3.

3.2.3 Representation of Buildings

Building footprints within the NEP were updated to either remove buildings and demountables proposed for demolition/removal, or include new building footprints and apply proposed finished ground floor levels. The spatial distribution of building footprints within the Proposed Scenario TUFLOW model is shown in Figure 2.3.

3.3 Proposed Flood Conditions

3.3.1 Flood Behaviour

The Proposed Scenario TUFLOW model was used to simulate the critical 1% AEP flood and PMF to establish proposed (post-development) flood conditions. Under proposed conditions, on-site inundation is predicted across NSHS and along the western boundary of NNPS (as per existing conditions). Peak flood depths, velocities, and hazard and hydraulic categories have been mapped and are presented in Annex D.

The general description of proposed peak flood behaviour across the NEP is predominantly as per existing conditions (discussed previously in Section 2.4.1). However, the following comments apply specifically to flood conditions relevant to the works that form part of the DA:

- Within NNPS:
 - The new two (2) storey building (Block D) is outside the 1% AEP flood extent.
 - PMF depths in the vicinity of Block D are typically less than 0.2 metres.
 - The predicted peak 1% AEP flood level of 2.96 mAHD and PMF level of 4.87 mAHD are both below the ground FFL of 4.95 mAHD for Block D.
- Within NSHS:
 - The predicted peak 1% AEP flood level of 2.96 mAHD and PMF level of 4.87 mAHD are both above the minimum FFL of the ground floor of the new build extension to Building A (i.e. 2.55 mAHD). However, the Level 1 FFL will be 5.90 mAHD and therefore above the predicted PMF level.

3.3.2 Flood Hazard

The hazard mapping for the 1% AEP and PMF event under proposed conditions is provided in Annex D. Post-development hazard conditions within NEP are as per existing conditions (discussed previously in Section 2.4.2).



3.3.3 Flood Function (Hydraulic Categorisation)

There are no prescriptive methods for determining which parts of the floodplain constitute floodway, flood storage and flood fringe. Descriptions of these terms within the 'Floodplain Development Manual' (NSW Government, 2005) are essentially qualitative in nature. Of difficulty is the fact that a definition of flood behaviour and associated impacts is likely to vary from one floodplain to another depending on the circumstances and nature of flooding within the catchment.

The flood function categories (also referred to as hydraulic categories) as defined in the 'Floodplain Development Manual' (NSW Government, 2005) are:

- **Floodway** Areas that convey a significant portion of the flow. These are areas that, even if partially blocked, would cause a significant increase in flood levels or a significant redistribution of flood flows, which may adversely affect other areas.
- Flood Storage Areas that are important in the temporary storage of the floodwater during the passage of the flood. If the area is substantially removed by levees or fill it will result in elevated water levels and/or elevated discharges. Flood Storage areas, if completely blocked would cause peak flood levels to increase by 0.1m and/or would cause the peak discharge to increase by more than 10%.
- **Flood Fringe** Remaining area of flood prone land, after Floodway and Flood Storage areas have been defined. Blockage or filling of this area will not have any significant effect on the flood pattern or flood levels.

The 'Narrabeen Lagoon Flood Study' includes the following definitions of flood function:

- Floodway is defined as areas where the velocity depth product is greater than 0.50 m²/s.
- **Flood storage** areas were identified as those areas that do not operate as floodways but where the depth of inundation exceeds 0.5 m.
- **Flood fringe** is the remaining area of land affected by flooding, after floodway and flood storage areas have been defined.

The 1% AEP and PMF hydraulic categorisation mapping for proposed conditions is presented in Annex D. It can be seen that:

- During the 1% AEP flood, Mullet Creek is a floodway but the majority of NSHS acts as a flood storage area, with small areas of flood fringe dispersed across the site and within the north-eastern corner adjacent to Pittwater Road. Within NNPS, only the western site boundary is impacted by flooding and is classified as a flood fringe area.
- During the PMF, the floodway extent increases (compared to the 1% AEP floodway extent) to cover
 portions of NSHS including areas along the western site boundary and major flow paths through the
 site. However, the remainder of the NSHS site is classified as flood storage. Within NNPS, a small
 area of the site adjoining the western boundary is classified as a floodway, however the majority of
 inundated areas within the site are classified as flood storage or flood fringe.

3.4 Climate Change Sensitivity Assessment

The 'Narrabeen Lagoon Flood Study' (BMT WBM, 2013) assessed the potential influence of climate change on the Narrabeen Lagoon system and the implications for medium and long term floodplain management. The following changes were assessed:

- increases to flood levels at the ocean boundary
- increases to the berm height



- increases in the initial Lagoon level
- increases in rainfall intensity.

A sensitivity analysis based on a worst-case climate change scenario (assuming a 30% increase in rainfall and a 0.9m increase in sea level) was completed for the 1% AEP flood as part of the 'Narrabeen Sports High School Flood Impact Assessment' (BMT, 2021). It was determined that the impacts of climate change resulted in peak 1% AEP plus climate change flood levels of 3.79 mAHD within both the NNPS and NSHS sites, i.e. 0.85 m higher than the present day 1% AEP flood level of 2.96 mAHD. These results are considered to also be applicable to inform this assessment.

3.5 Flood Impact Assessment

The proposed development has been considered in terms of potential adverse impacts on existing flood behaviour. Flood level and velocity difference mapping was prepared by subtracting peak existing water levels/velocities from peak proposed water levels/velocities and indicate the magnitude and location of changes associated with the proposed works. The flood level and velocity difference maps for modelled design events are provided in Annex E.

The change in peak flood level and velocity mapping provided in Annex E shows that the proposed development will result in minor modifications to design flood conditions, as follows:

- 1% AEP impact results indicate that the proposed development is only predicted to result in a reduction of flood extent as a result of the proposed works within NNPS and NSHS.
- No adverse impacts on peak 1% AEP flood levels within or outside the NEP are predicted. Furthermore, negligible changes to 1% AEP flood velocities are predicted as a result of the development.
- PMF impact results indicate that the proposed development will result in negligible flood level impacts.
- Increases in PMF velocities are predicted within surrounding areas outside of the NEP notably
 around Namona Road and Pittwater Road. These impacts are relatively minor and very localised,
 and are predicted to result from the minor re-distribution of flow associated with the placement of
 structures in a flood storage area. Due to the minor nature of these PMF velocity impacts and
 because they are not accompanied by an associated increase in peak PMF level (or depth), it is not
 considered that there will be a material impact on the predicted flood risk across properties outside
 of the NEP.
- Impact results indicate that the proposed development will cause very minor and localised increases (and decreases) to PMF levels and velocities within South Creek and at the outlet into the Pacific Ocean. Increases in these locations are relatively minor and limited in extent, and will occur in large flood storage areas with high flood depths. These increases are considered to be more associated with the impact of the very minor flow distribution on the dynamic modelling of entrance berm conditions than any material increases themselves.

Overall, negligible 1% AEP impacts and minimal PMF impacts on existing flood risk are predicted by this assessment.



4 Pittwater 21 DCP Requirements

4.1 Development Control Requirements

Flood planning and development control requirements for this area within the Northern Beaches LGA are set out in *Section B3.11 Flood Prone Land* of Council's Pittwater 21 DCP. These include the following requirements applicable to flood prone land such as the NEP:

- 1. Development must comply with the prescriptive controls set out in the Development Control Matrix provided in the DCP. Where a property is affected by more than one Flood Risk Precinct, or has varying Flood Life Hazard Category across it, the assessment must consider the controls relevant at each location on the property.
- Development on flood prone land requires the preparation of a Flood Management Report by a suitably qualified professional. Please note that this Flood Risk and Impact Assessment report forms the Flood Management Report for this DA.

The Development Control Matrix defines prescriptive controls based on the relevant land use type of the proposed development and the Flood Risk Precinct applicable to the site. Council divides flood prone land into three precincts: Low, Medium and High Flood Risk Precincts. Council's mapping classifies both the NSHS and NNPS sites as containing all three precincts, as shown in Figure 4.1 and Figure 4.2, respectively. Educational establishments, such as NSHS and NNPS, are classified by Council as "Vulnerable & Critical Use".

Accordingly, the NEP development should comply with the prescriptive controls in the Development Control Matrix that apply for vulnerable and critical development within each of these Flood Risk Precincts (where relevant to particular locations within these sites).

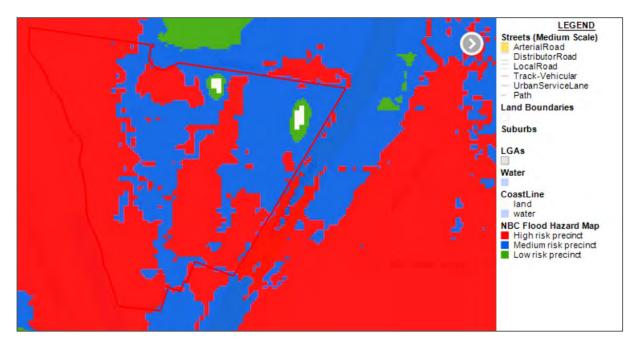


Figure 4.1 Flood Risk Precinct Mapping for NSHS (Source: <u>Northern Beaches Mapping (nb-icongis.azurewebsites.net</u>))





Figure 4.2 Flood Risk Precinct Mapping for NNPS (Source: <u>Northern Beaches Mapping (nb-icongis.azurewebsites.net)</u>)

4.2 Flood Planning Level and Finished Floor Level Requirements

The following flood planning level (FPL) and finished floor level (FFL) requirements apply to proposed buildings within the NEP to comply with the requirements of Pittwater 21 DCP:

- The FPL is defined by Council as the 1% AEP flood level plus 0.5 m freeboard. Accordingly, the FPL for the NEP is 3.46 mAHD (i.e. 1% AEP flood level of 2.96 mAHD plus 0.5 m).
- As an educational establishment, the NEP is classified as "Vulnerable & Critical Land Use". Minimum habitable FFLs must be set at the higher of the FPL and PMF level. Therefore the minimum FFL requirement for development within NEP is the PMF level of 4.87 mAHD.

Based on these requirements, minimum habitable FFL for the new builds within NSHS and NNPS that form part of this DA are listed in Table 4.2, along with proposed design levels and associated comments.

Building	FFL Requirement (mAHD)	Proposed Ground FFL (mAHD)	Proposed Level 1 FFL (mAHD)	BMT Comment
NNPS – Block D	4.87	4.95	8.55	Complies with FFL requirement.
NSHS – Building A extension	4.87	2.55 (minimum)	5.90	Whilst the ground floor level does not comply with FFL requirement due to functional requirements to connect to existing Building A facilities, Level 1 is located higher than the PMF level (refer further discussion below).

Table 4.1 FFL Requirements for Proposed Development



As outlined in Table 4.2, the ground floor level of the proposed Building A extension in NSHS does not comply with Council's FFL requirement due to functional requirements to connect to existing Building A facilities which are at a current minimum FFL of 2.42 mAHD. However, flood risk has been considered as part of the design process for NSHS, as discussed below:

- Refurbished and New Build accommodation that is below the PMF meets one of the following criteria:
 - Refurbished to align with current usage.
 - Refurbished accommodation requiring direct connection to Ground Floor Level.
 - New Build habitable accommodation requiring direct connection to Gymnasium.
 - New Build non-habitable accommodation.
- Habitable accommodation being refurbished at Ground Floor Level includes:
 - General Learning Spaces existing function.
 - Metal/Woodwork Workshops existing function.
 - Learning Support Unit connection to Ground Floor preferred due to accessibility.
 - Storage connections to Gymnasium and Sports Pitches required.
 - Gymnasium existing function.
 - Control Room for Gymnasium direct connection to Gymnasium required.
 - ALU Café Connection to COLA required.
- The following New Build accommodation is located at 2.55 mAHD:
 - Student Change Rooms require a direct connection to the Ground Level.
 - Student Toilets direct connection at Ground Level.
 - First Aid Store direct connection to Gymnasium required.
 - Stage direct connection to Gymnasium required (at 3.32 mAHD).

4.3 Response to Prescriptive Development Controls

Flood-related development control requirements have been extracted from the Development Control Matrix in Pittwater 21 DCP and are listed in Table 4.2 together with BMT's responses addressing these requirements relevant to works that form part of this DA.

It is noted that consistent controls apply to Items A to E for vulnerable and critical land use within Low, Medium and High Flood Risk Precincts, and to Items F to G within Medium and High Flood Risk Precincts. Therefore, it was not considered necessary to distinguish which flood risk precinct individual components of the proposed DA works are located within and responses have been provided for the maximum Flood Risk Precinct requirement. It is also noted that Items D, F and H are not relevant to the proposed works for this DA and therefore have not been included in Table 4.2.



Table 4.2 Pittwater 21 Flood-related Development Controls and Responses for NEP

Requirement	Response
A. Flood Effects Caused by Development	
A1. Development shall not be approved unless it can be demonstrated in a Flood Management Report that it has been designed and can be constructed so that in all events up to the 1% AEP event:	
(a) There are no adverse impacts on flood levels or velocities caused by alterations to the flood conveyance; and	This assessment has considered the flood impacts of the proposed NEP development (refer Section 3.5). No adverse impacts are predicted in the 1% AEP flood. Minimal impacts are predicted in the PMF and are considered to result in negligible impact on existing flood risk.
(b) There are no adverse impacts on surrounding properties; and	No adverse impacts on surrounding properties are predicted during the 1% AEP flood (refer Section 3.5).
(c) It is sited to minimise exposure to flood hazard.	The proposed works within NNPS are sited either within a low flood hazard area (H1) in the 1% AEP flood or outside the 1% AEP flood extent. Building A extension within NSHS is sited in an area classified as H3 flood hazard during the 1% AEP flood, however the majority of the site is classified as H3 flood hazard during an event of this magnitude.
A2. Development shall not be approved unless it can be demonstrated in a Flood Management Report that in all events up to the 1% AEP event there is no net loss of flood storage.Consideration may be given for exempting the volume of standard piers from flood storage calculations.If Compensatory Works are proposed to balance the loss of flood storage from the development, the Flood Management Report shall include detailed calculations to demonstrate how this is achieved.	The proposed development within NNPS is located above the 1% AEP flood level. Therefore, this requirement is not applicable to works within the NNPS site. Compensatory flood storage works are not proposed within the NSHS site as part of this DA. The loss of available flood storage up to the 1% AEP flood level resulting from the Building A extension within NSHS is considered to be negligible, particularly when considered relative to the significant volume of available flood storage across the large floodplain in the Narrabeen Lagoon catchment. This is also evidenced by the results of the flood impact assessment (refer Section 3.5) which demonstrates negligible impacts on flood behaviour in the 1% AEP flood as a result of the development (including any loss of flood storage associated with the proposed Building A extension).



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Requirement	Response
B. Building Components and Structural Soundness	
B1. All buildings shall be designed and constructed with flood compatible materials in accordance with "Reducing Vulnerability of Buildings to Flood Damage: Guidance on Building in Flood Prone Areas", Hawkesbury-Nepean Floodplain Management Steering Committee (2006).	To be considered as part of the detailed design process.
B2. All new development must be designed and constructed to ensure structural integrity up to the Flood Planning Level, taking into account the forces of floodwater, wave action, flowing water with debris, buoyancy and immersion. Where shelter-in-place refuge is required, the structural integrity for the refuge is to be up to the Probable Maximum Flood level. Structural certification shall be provided confirming the above.	As discussed in Section 5, shelter-in-place refuge is proposed within new build Block D in NNPS and Level 1 of the Building A extension within NSHS. Therefore, structural certification by a suitably qualified structural engineer is required for these proposed buildings up to the PMF level as part of the detailed design process.
B3. All new electrical equipment, power points, wiring, fuel lines, sewerage systems or any other service pipes and connections must be waterproofed and/or located above the Flood Planning Level. All existing electrical equipment and power points located below the Flood Planning Level within the subject structure must have residual current devices installed that turn off all electricity supply to the property when flood waters are detected.	To be considered as part of the detailed design process based on the FPL of 3.46 mAHD.
C. Floor Levels	
C2. All floor levels within the development shall be at or above the Probable Maximum Flood level or Flood Planning Level (FPL), whichever is higher.	The FFL of 4.95 mAHD for Block D in NNPS is higher than the PMF level of 4.87 mAHD. The Level 1 FFL of 5.90 mAHD of the proposed Building A extension in NSHS is higher than the PMF level. However, the ground floor level is proposed at 2.55 mAHD and does not comply with Council's FFL requirement set at the PMF
	level of 4.87 mAHD due to functional requirements to connect to existing Building A facilities with a current minimum FFL of 2.42 mAHD (refer discussion in Section 4.2).



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Requirement	Response
C3. All new development must be designed and constructed so as not to impede the floodway or flood conveyance on the site, as well as ensuring no net loss of flood storage in all events up to the 1% AEP event.	The proposed development within NNPS is located above the 1% AEP flood level. Therefore, this requirement is not applicable to works within the NNPS site. Within NSHS, no development is proposed within the 1% AEP floodway (shown in the mapping in Annex D) and will therefore not impede the floodway or flood conveyance within the site.
	The loss of available flood storage within NSHS up to the 1% AEP flood level resulting from the Building A extension is considered to be negligible relative to the significant volume of available flood storage across the large floodplain in the Narrabeen Lagoon catchment. This is also evidenced by the results of the flood impact assessment (refer Section 3.5) which demonstrates negligible impacts on flood behaviour in the 1% AEP flood as a result of any loss of flood storage due to the proposed development.
E. Emergency Response	
E1. If the property is affected by a Flood Life Hazard Category of H3 or higher, then Control E1 applies and a Flood Emergency Assessment must be included in the Flood Management Report.	A Flood Emergency Assessment has been completed and is documented in Section 5.
E2. If a shelter-in-place refuge is required, it must contain as a minimum: sufficient clean water for all occupants; portable radio with spare batteries; torch with spare batteries; a first aid kit; emergency power; and a practical means of medical evacuation.	To be considered as part of the detailed design process.
G. Storage of Goods	
G1. Hazardous or potentially polluting materials shall not be stored below the Flood Planning Level unless adequately protected from floodwaters in accordance with industry standards.	To be considered as part of the detailed design process based on the FPL of 3.46 mAHD.



5 Flood Emergency Assessment

5.1 Overview

Both the NSHS and NNPS sites (or part thereof) are subject to medium to high mainstream flood hazard in rare and extreme events (e.g. PMF). Ground floor levels within the extension to Building A in NSHS is proposed below both the 1% AEP flood and PMF levels due to functional reasons outlined previously in Section 4.2. Proposed new buildings within NNPS will have FFLs that are elevated above the peak level of the PMF. However, the NNPS site is surrounded by higher hazard floodplain areas. Therefore, consideration of the flood risk that future users of the proposed development within both NSHS and NNPS may be exposed to during a major flood event is required.

The current hours of operation of these schools is between 9am and 3pm, with the school sites accessible from 7:30am to 6:30pm weekdays and restricted access outside of these hours (Ason Group, 2022a and 2022b). Therefore, typical occupation of the school sites is only expected during hours of accessibility on weekdays and limited occupants should be on-site outside of these times during weekdays or at any time on the weekend.

5.2 Risk Assessment Categories

The Flood Life Hazard Categories defined within the Pittwater 21 DCP are consistent with the peak flood hazard mapping provided in Annex D and range up to H4 and H5 within the NNPS and NSHS sites, respectively. As these sites are predicted to contain H3 or higher flood hazard classifications, an emergency management assessment is required to address Council's flood-related DA requirements.

Emergency response management considerations specific to the works within NEP covered by this DA are outlined in the sections below. This includes a broad assessment of the flood risk to occupants of the proposed development for events up to and including the PMF, potential for site evacuation, refuge requirements and guidance on what to do in a flood event.

5.3 Evacuation Feasibility

Proposed pedestrian and vehicular ingress and egress points for the NEP are shown in the design plans enclosed in Annex A and Annex B and are as follows:

- NSHS:
 - Pedestrian ingress/egress from the site is possible along a number of locations, including along Namona Street, as well as via pedestrian bridge crossings of Mullet Creek at the north-western and south-western corners of the site.
 - Vehicular access to the site can occur at two locations along Pittwater Road (at the intersection with Lake Park Road and further south), as well as two locations at the western end of Namona Street.
- NNPS:
 - Pedestrian ingress/egress from the site is possible from Pittwater Road and Namona Street, as well as from the west from the Northern Beaches Indoor Sports Centre (NBISC) site.
 - Vehicular access to the site is from Namona Street in the south-eastern corner of the NNPS.

Flood inundation is predicted along these roadways during the 1% AEP flood and PMF and, more significantly, flooded areas are classified as being up to a H5 hazard classification during the PMF. This



indicates that site ingress and egress during this extreme flood would be hydraulically unsafe for people and vehicles.

Current best practice is to avoid entering floodwaters wherever possible, and under no circumstances should floodwater be considered "safe". As the site is located in the downstream area of the Narrabeen Lagoon catchment, a warning time of up to 1.5 hours would be afforded from the initial onset of rain until the roadway is cut in the PMF. However, it would require considerable coordination and effort to evacuate the large numbers of students and staff that are expected on-site during hours of operation (and potentially during hours of accessibility); and considering the short evacuation warning time available, neither pedestrian nor vehicular egress is recommended for students, staff and visitors after the onset of a rainfall event.

Shelter-in-place is the proposed flood emergency response following the onset of a severe rainfall event. This is in line with the Flood Life Hazard Category of the site and requirements outlined in Pittwater 21 DCP (refer requirement for E1 in Table 4.2).

The following sections outline the appropriate emergency responses for action before and after the onset of rainfall, and/or upon the receipt of a flood warning.

5.4 Emergency Response Before the Onset of Rainfall

The NNPS and NSHS should avoid the need for evacuation, if at all possible, by cancellation of operation (before the schools are open) or early release of students (during hours of operation) if extreme rainfall (e.g. severe weather warning for torrential rain and/or flash flooding) is predicted, or flood watches or warnings are in place.

If cancellation of operation is not possible (e.g. school is operational when warnings are issued) or unable to be completed, the schools should act as quickly as possible to arrange for evacuation of students, staff and visitors if a Flood Warning or Flood Bulletin for the area is issued by the BoM or SES.

5.5 Emergency Response After the Onset of Rainfall

Evacuation of NSHS and NNPS is not recommended after the onset of a rainfall event due to the limited available warning time, rapid rate of rise of floodwaters and high hazard conditions on-site and/or along potential evacuation routes during extreme floods. Staff, visitors and students should instead shelter-in-place within habitable sections of the schools that are elevated above the peak PMF level and provide safe refuge. Specific to the works that form part of this DA, Level 1 of the Building A extension within NSHS and Block D within NNPS all comply with this requirement and therefore, satisfy Council's requirement to provide a potential evacuation location to shelter-in-place above the peak PMF level.

5.6 Shelter-in-Place Requirements

Floodwaters on-site are likely to remain in place for durations in excess of 9 hours during a PMF, and the schools will be isolated during this time. As such, shelter-in-place should only be undertaken in the event that prior early evacuation of the site or cancellation of operation has not occurred.

Pittwater 21 DCP outlines emergency response requirements for new developments, including the following requirements for shelter-in-place refuge areas:

- Floor level is at or above the PMF level.
- Floor space provides at least 2m² per person where the expected duration of flooding exceeds 6 hours in the PMF.

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- Accessible to all people on the site, plainly evident, and self-directing, with sufficient capacity of
 access routes for all occupants without reliance on an elevator.
- Must contain as a minimum: sufficient clean water for all occupants; portable radio with spare batteries; torch with spare batteries; a first aid kit; emergency power; and a practical means of medical evacuation.

Therefore, in order to provide conditions suitable for long-term refuge (i.e. greater than 6 hours), it should be ensured that, if required, sufficient supplies (as listed above) are available for occupants seeking flood refuge within Block D in NNPS and on Level 1 of the Building A extension in NSHS to be able to cope with a period of isolation during a particularly large flood and that there are nominated flood wardens to coordinate the response.

Within the extension to Building A, the internal area associated with the PE GLS rooms and Movement Studio combined is approximately 300 m². This area encompasses all habitable new build space on Level 1 which has a proposed FFL of 5.90 mAHD (i.e. above the predicted PMF level of 4.87 mAHD). Based on the available floor space of approximately 300 m² and Council's 2 m² per person requirement for the predicted duration of PMF inundation in this area, up to 150 people could be accommodated above the PMF level within Level 1 of Building A of NSHS. It is also noted that Level 1 of the Building A extension is proposed to accessible from the ground floor via both stairs and a lift.

Based on available floor space within the ground floor and Level 1 of the new two (2) storey Block D of NNPS, it is expected that this area is sufficient to accommodate the maximum number of likely occupants within this building as a flood refuge and comply with Council's floor space requirements, i.e. at least 2 m² floor space will be available for all staff, visitors and students in Block D.

Detailed flood emergency response plans should be prepared for NSHS and NNPS (or any existing flood emergency response plans for these schools be updated to reflect the proposed redevelopment of the sites) outlining the proposed strategy for flood emergency management for these schools. This may include provisions for accessibility of shelter-in-place refuge, consideration of flood warning systems and serviceability requirements.

Furthermore, Council requires that all shelter-in-place refuge buildings demonstrate structural stability up to the PMF level through verification by a suitably qualified structural engineer and compliance with the Building Code of Australia. This requirement is therefore applicable to this development.



6 Conclusion

This report documents the methodology and outcomes of the Flood Risk and Impact Assessment completed for the proposed Narrabeen Education Precinct (NEP) development including redevelopment of Narrabeen North Public School (NNPS) and Narrabeen Sports High School (NSHS). It satisfies the requirements of the flood management report required by Council for the proposed works that are the subject of this DA.

TUFLOW modelling of existing and proposed conditions was undertaken to define flood risk within the NEP, and assess the potential impacts of the proposed development on flood behaviour. No adverse impacts on existing 1% AEP flood risk are predicted within the site or on surrounding properties and/or infrastructure as a result of the proposed works that form part of this DA. Any impacts of the development during the PMF are predicted to be minimal, with negligible impact on existing flood risk.

Assessment of the development design against flood-related requirements of Council's Pittwater 21 DCP was also completed and indicates that the development can comply with these requirements, with the exception of the ground FFL for the Building A extension within NSHS. The ground FFL of this building extension is proposed to be located at a minimum finished floor level of 2.55 mAHD that is lower than the PMF level of 4.87 mAHD. However, this ground floor level is governed by functional requirements to connect to existing Building A facilities, and it is noted that the Level 1 FFL of the Building A extension is proposed at 5.90 mAHD and would provide a suitable flood refuge above the PMF level.

A Flood Emergency Assessment was also completed for the proposed development and is documented in this report. It provides information on flood risk to occupants of the proposed development for events up to and including the PMF, potential for site evacuation, shelter-in-place requirements and preliminary guidance on how to respond in the event of a flood. It is recommended that detailed flood emergency response plans be prepared for NSHS and NNPS (or any existing plans for the schools be updated to reflect the proposed redevelopment of the sites) prior to school operation within these proposed new builds.



7 References

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Northern Beaches Council (formerly Pittwater Council) (2014). Pittwater LEP 2014.



Annex A Site and Design Plans for NNPS



SOURCE: NEARMAP

NARRABEEN NORTH PUBLIC SCHOOL

6 NAMONA STREET, NORTH NARRABEEN NSW 2101 LOT 3, D.P.10/8621

	SHEET LIST- NARRABEEN NORTH PUBLIC SCHOOL - DA							
SHEET NUMBER	SHEET NAME	REVISION	REVISION DATE	REVISION DESCRIPTION				
0000 - GENERA	L & SITE INFORMATION							
DA-P-0101	COVER SHEET, LOCATION PLAN & DRAWING LIST	В	23/08/2022	DA SUBMISSION				
DA-P-0200	SITE ANALYSIS	A	18/08/2022	DA SUBMISSION				
DA-P-0210	PHOTOMONTAGE - NEW ADMIN & HALL	A	18/08/2022	DA SUBMISSION				
DA-P-0220	MATERIALS BOARD - NEW ADMIN & HALL	A	18/08/2022	DA SUBMISSION				
DA-P-0302	3D SITE TOPOGRAPHY HEIGHT PLANE	A	18/08/2022	DA SUBMISSION				
DA-P-0303	3D SITE TOPOGRAPHY HEIGHT PLANE - NEW ADMIN & HALL	A	18/08/2022	DA SUBMISSION				
DA-P-0521	NEW SITE PLAN - SCHOOL - GROUND FLOOR	В	23/08/2022	DA SUBMISSION				
DA-P-0522	NEW SITE PLAN - SCHOOL - LEVEL 01	В	23/08/2022	DA SUBMISSION				
DA-P-0523	NEW SITE PLAN - SCHOOL - ROOF	В	23/08/2022	DA SUBMISSION				
DA-P-0600	SHADOW DIAGRAMS	A	18/08/2022	DA SUBMISSION				
1000 - GA PLAN	IS		L					
DA-P-1040	NEW HALL & ADMIN - GROUND FLOOR	A	18/08/2022	DA SUBMISSION				
DA-P-1041	NEW HALL & ADMIN - LEVEL 1	В	23/08/2022	DA SUBMISSION				
DA-P-1042	NEW HALL & ADMIN - ROOF PLAN	В	23/08/2022	DA SUBMISSION				
3000 - ELEVATI	ONS & SECTIONS							
DA-P-3001	NEW ADMIN HALL - SITE ELEVATIONS	A	18/08/2022	DA SUBMISSION				
DA-P-3002	NEW GLS HUB - SITE ELEVATIONS	A	18/08/2022	DA SUBMISSION				
DA-P-3040	NEW ADMIN & HALL - GA ELEVATIONS	A	18/08/2022	DA SUBMISSION				
DA-P-3041	NEW HALL & ADMIN - GA ELEVATIONS	В	23/08/2022	DA SUBMISSION				
DA-P-3042	NEW HALL & ADMIN - GA SECTIONS	A	18/08/2022	DA SUBMISSION				

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ARCHITECT

DesignInc

Designinc Sydney Pty Ltd Level 14, 85 Castlereagh Street Sydney NSW 2000 Australia +61 2 8905 7100 sydney@designinc.com.au

Nominated Architects

Ian Armstrong 7260 | Cathryn Drew-Bredin 7269 | Richard Does 8126 | Mary Anne McGirr 10946 CLIENT





NARRABEEN EDUCATION PRECINCT NAMONA ST, NORTH NARRABEEN NSW 2101

DETAILS DRAWN CHECKED APPROVED

PROJECT

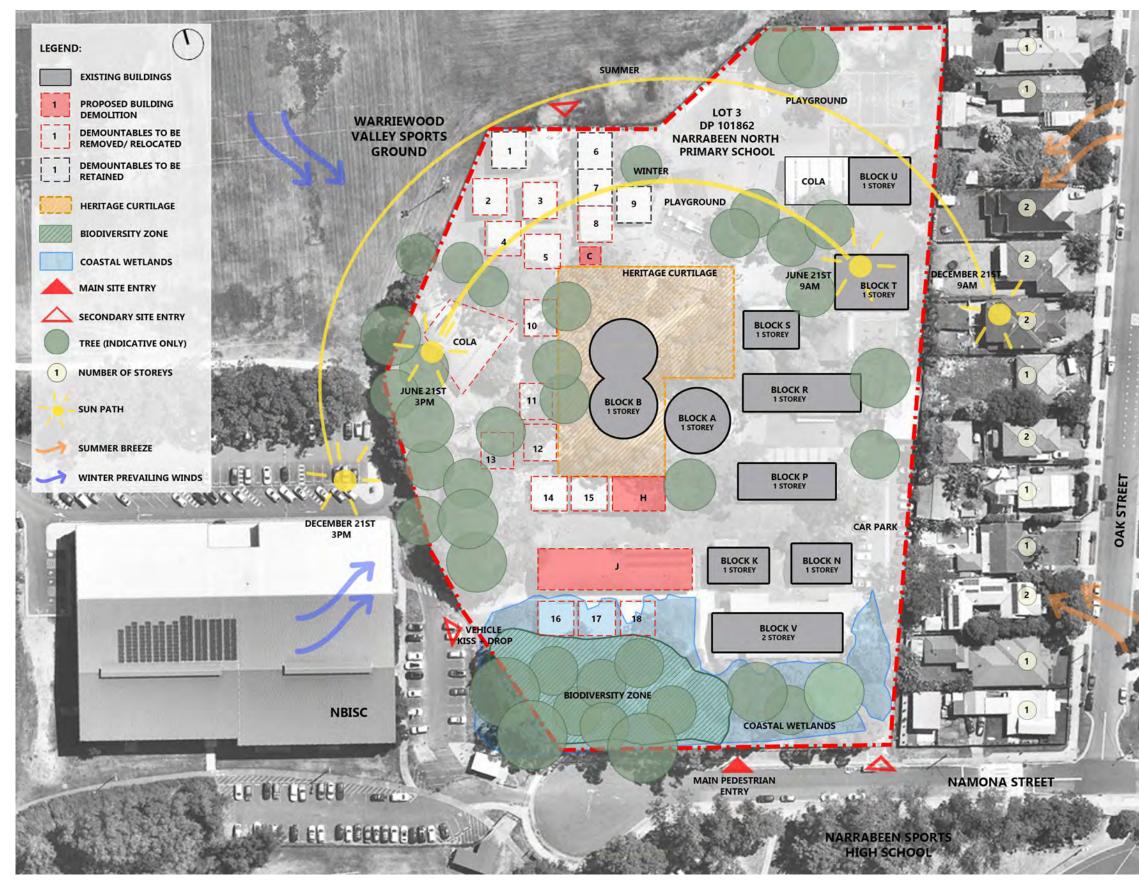
JO RF <APPROVER>

SCALE @ A1



TITLE COVER SHEET, LOCATION PLAN & DRAWING LIST

DRAWING NUMBER DA-P-0101



SITE ANALYSIS - NARRABEEN NORTH PUBLIC SCHOOL

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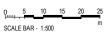
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TITLE SITE ANALYSIS



DRAWING NUMBER DA-P-0200 REVISION

А



VIEW FROM ENTRY PATH TO NEW ADMIN, HALL & COLA



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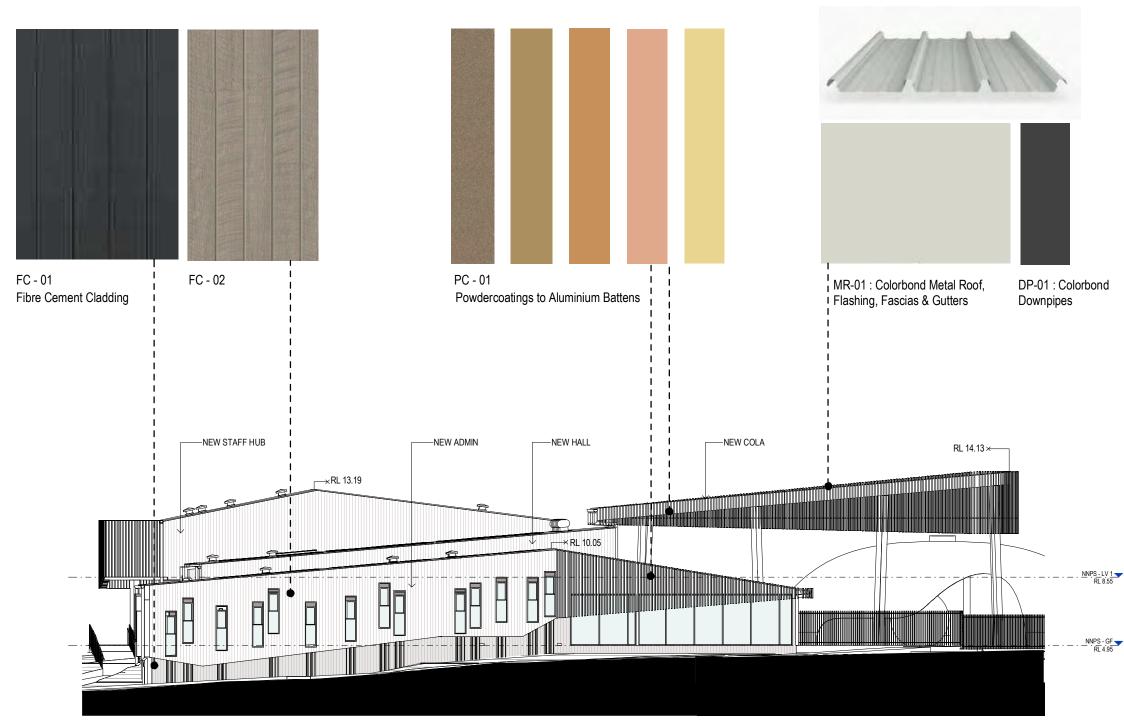
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TITLE PHOTOMONTAGE - NEW ADMIN & HALL





1 NNPS - SOUTH ELEVATION - NEW HALL + ADMIN - MATERIALS - DA



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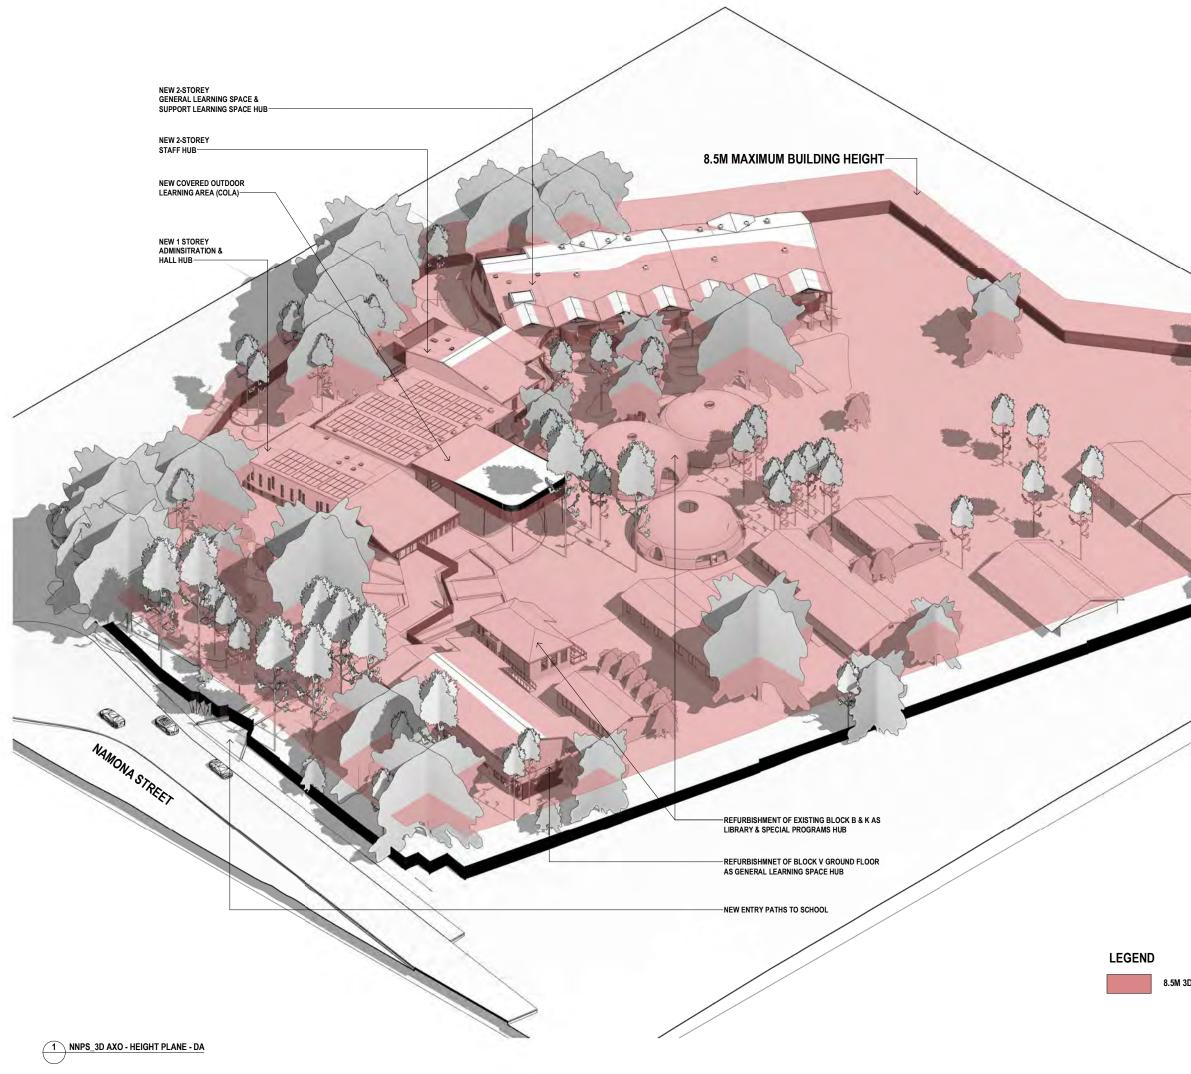
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MATERIALS BOARD - NEW ADMIN & HALL



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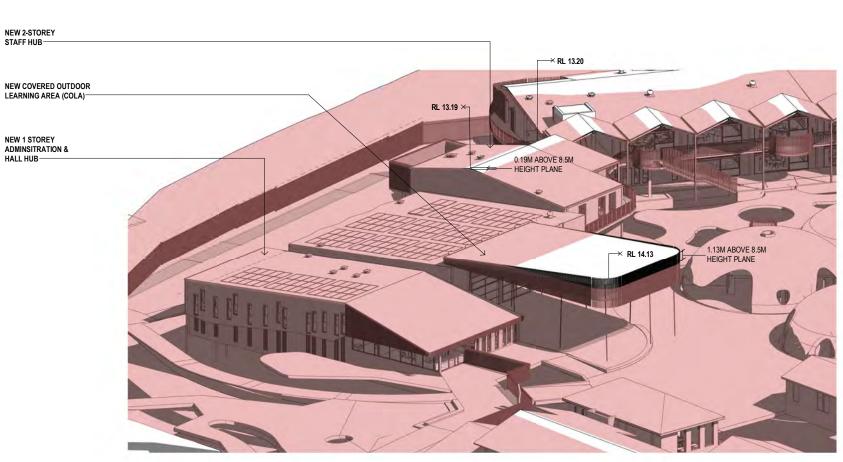
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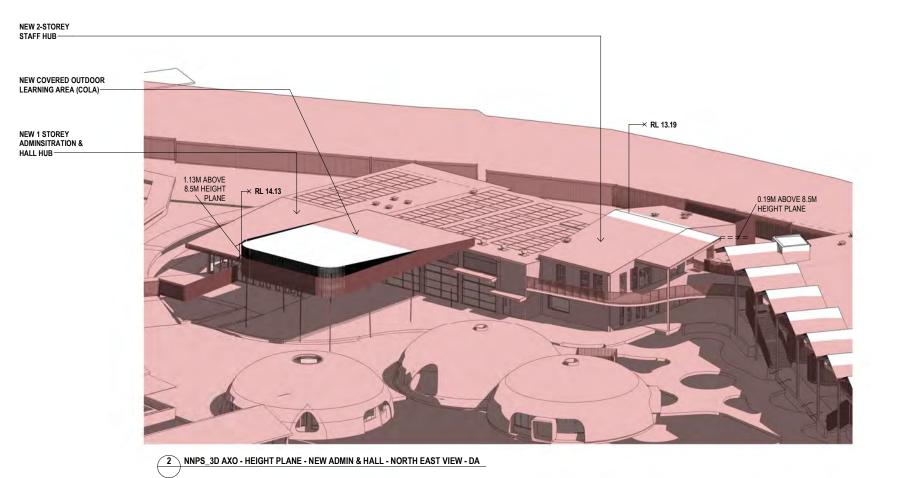
8.5M 3D HEIGHT PLANE

TITLE **3D SITE TOPOGRAPHY HEIGHT PLANE**

DRAWING NUMBER DA-P-0302 REVISION А



1 NNPS 3D AXO - HEIGHT PLANE - NEW ADMIN & HALL - SOUTH EAST VIEW - DA



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8.5M 3D HEIGHT PLANE

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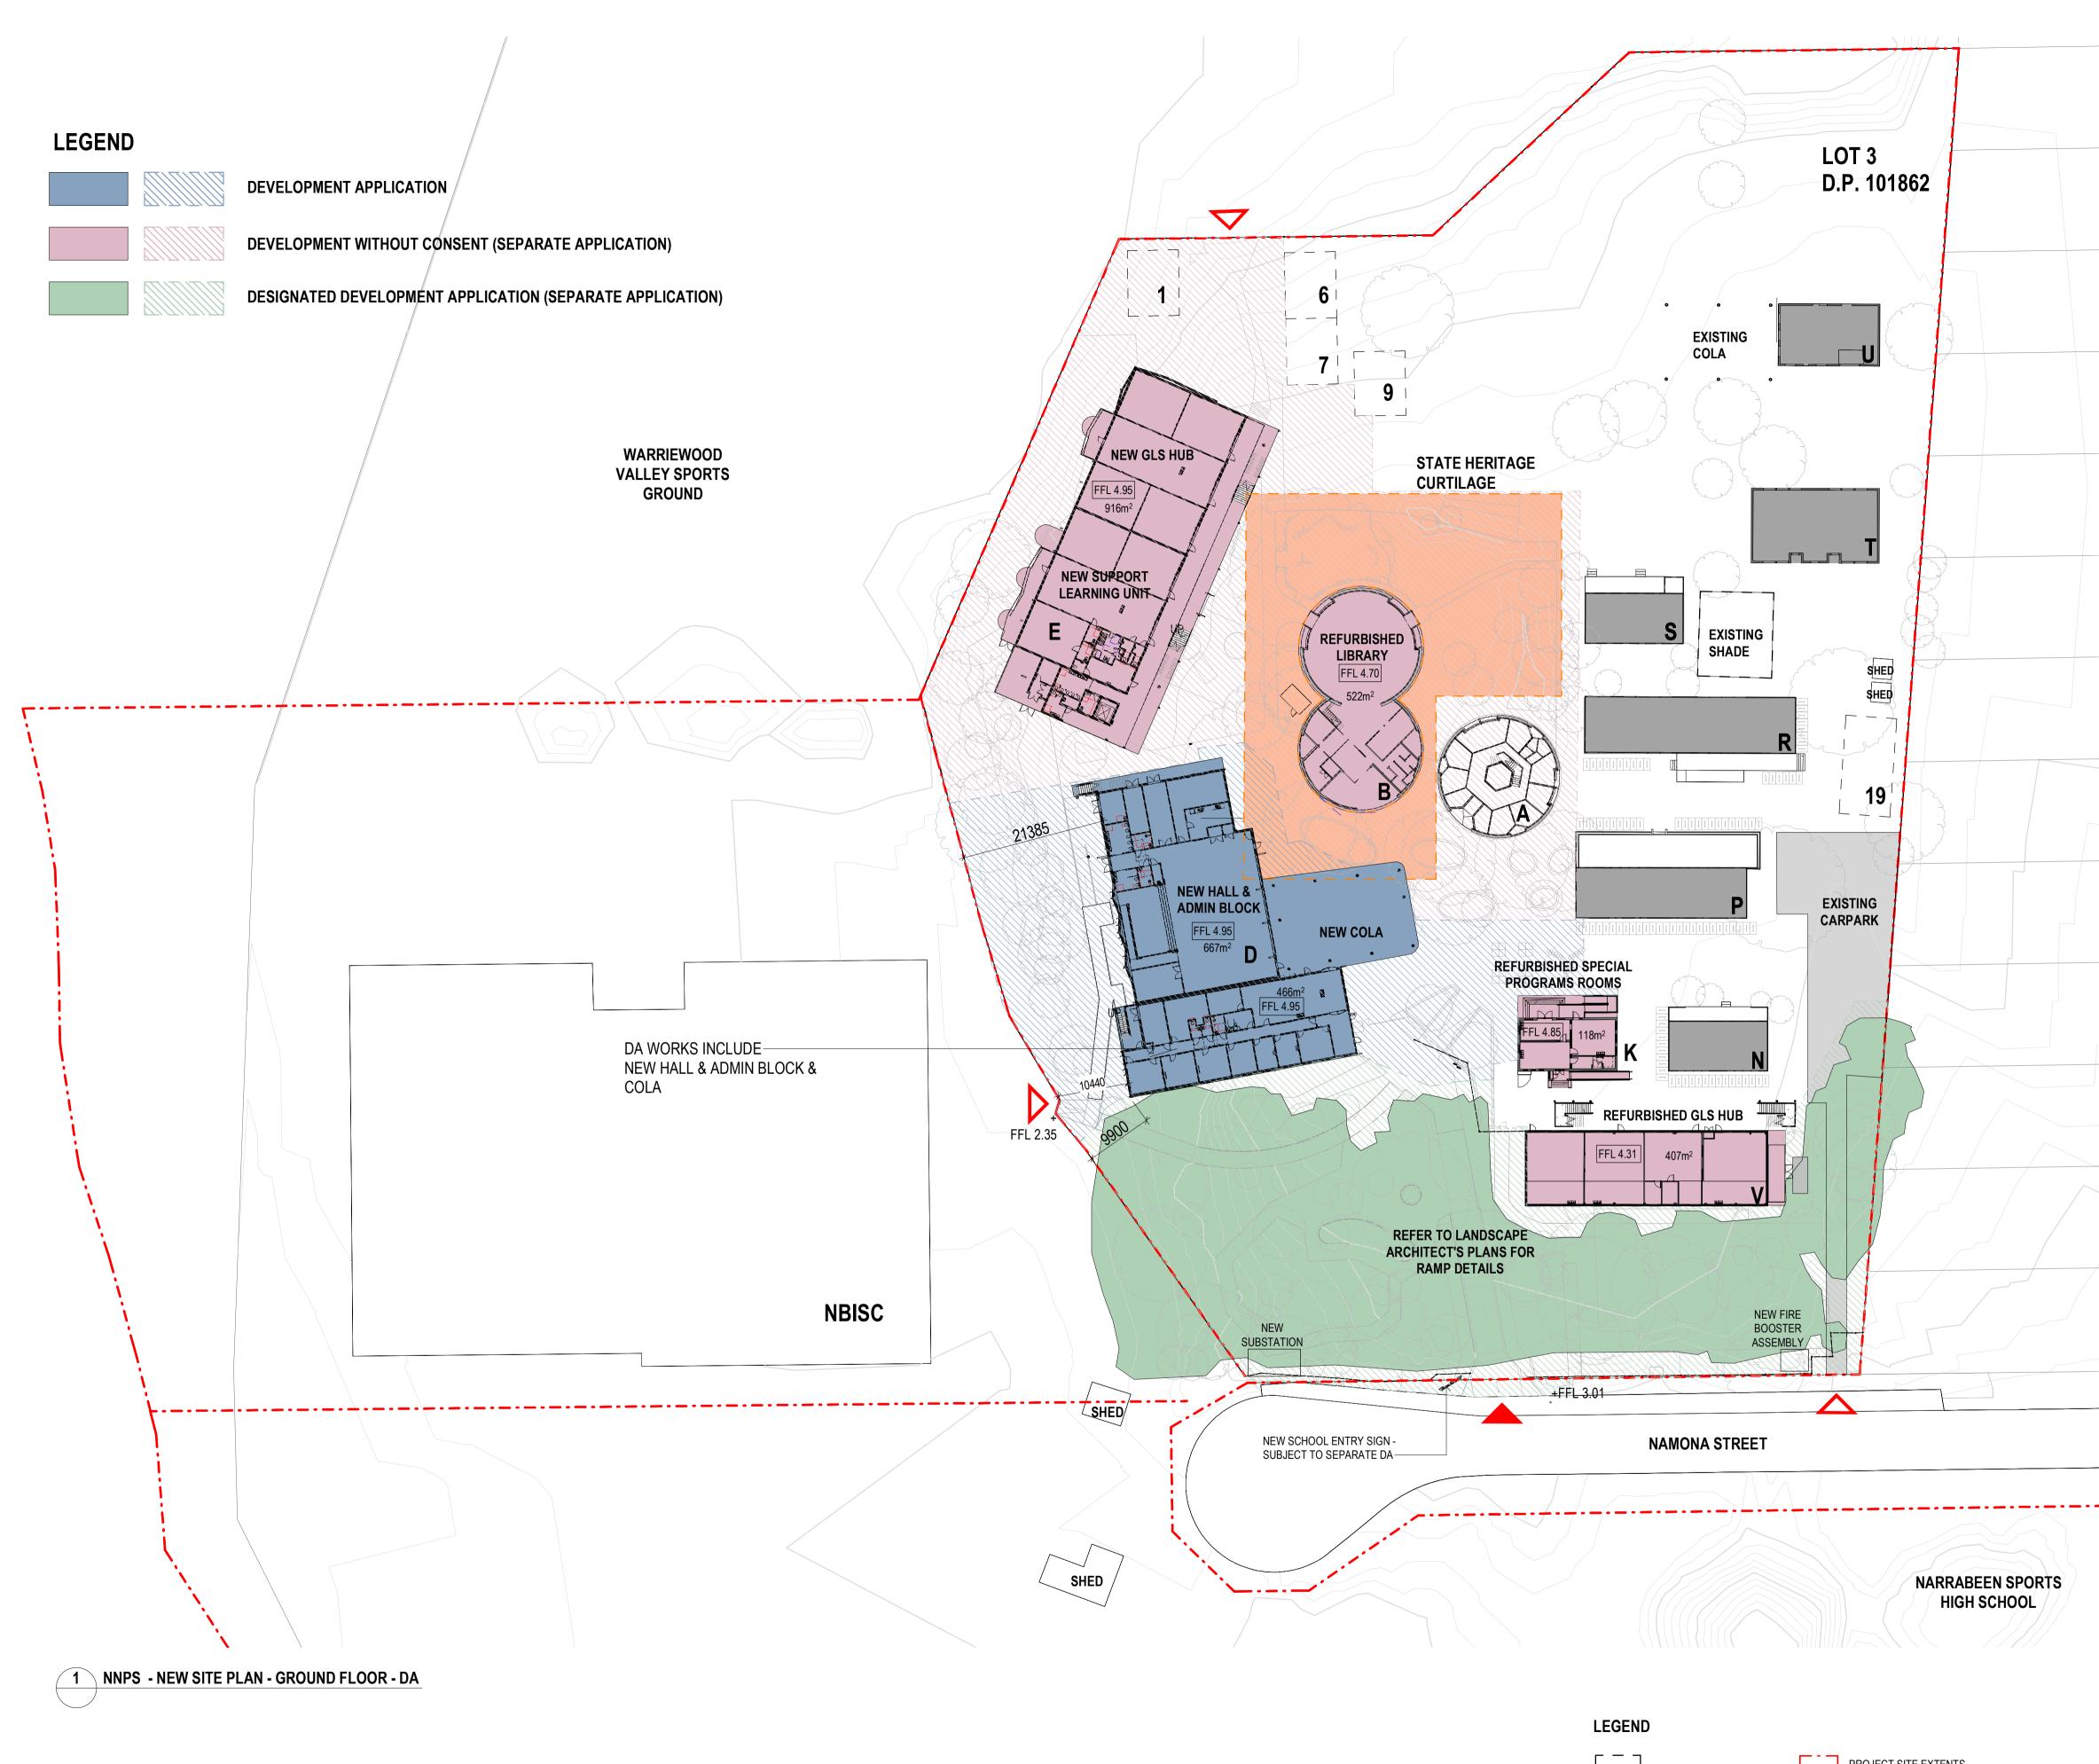
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TITLE 3D SITE TOPOGRAPHY HEIGHT PLANE -**NEW ADMIN & HALL**

DRAWING NUMBER DA-P-0303 REVISION А



DEMOUNTABLES EXISTING PERMANENT **BUILDING / STRUCTURE** COASTAL WETLANDS/ BIODIVERSITY ZONE

PROJECT SITE EXTENTS STATE HERITAGE CURTILAGE MAIN ENTRY SECONDARY ENTRY

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Ian Armstrong 7260 | Cathryn Drew-Bredin 7269 | Richard Does 8126 | Mary Anne McGirr 10946





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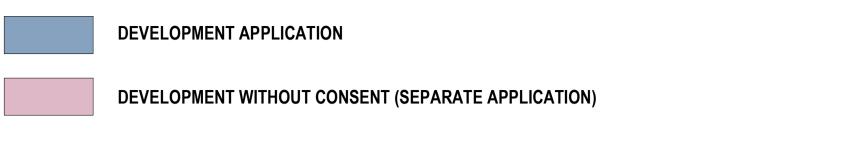


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TITLE NEW SITE PLAN - SCHOOL - GROUND FLOOR

DRAWING NUMBER DA-P-0521







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Nominated Architects

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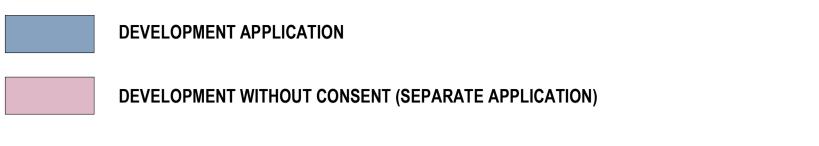


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NEW SITE PLAN - SCHOOL - LEVEL 01

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COASTAL WETLANDS/ BIODIVERSITY ZONE

SECONDARY ENTRY

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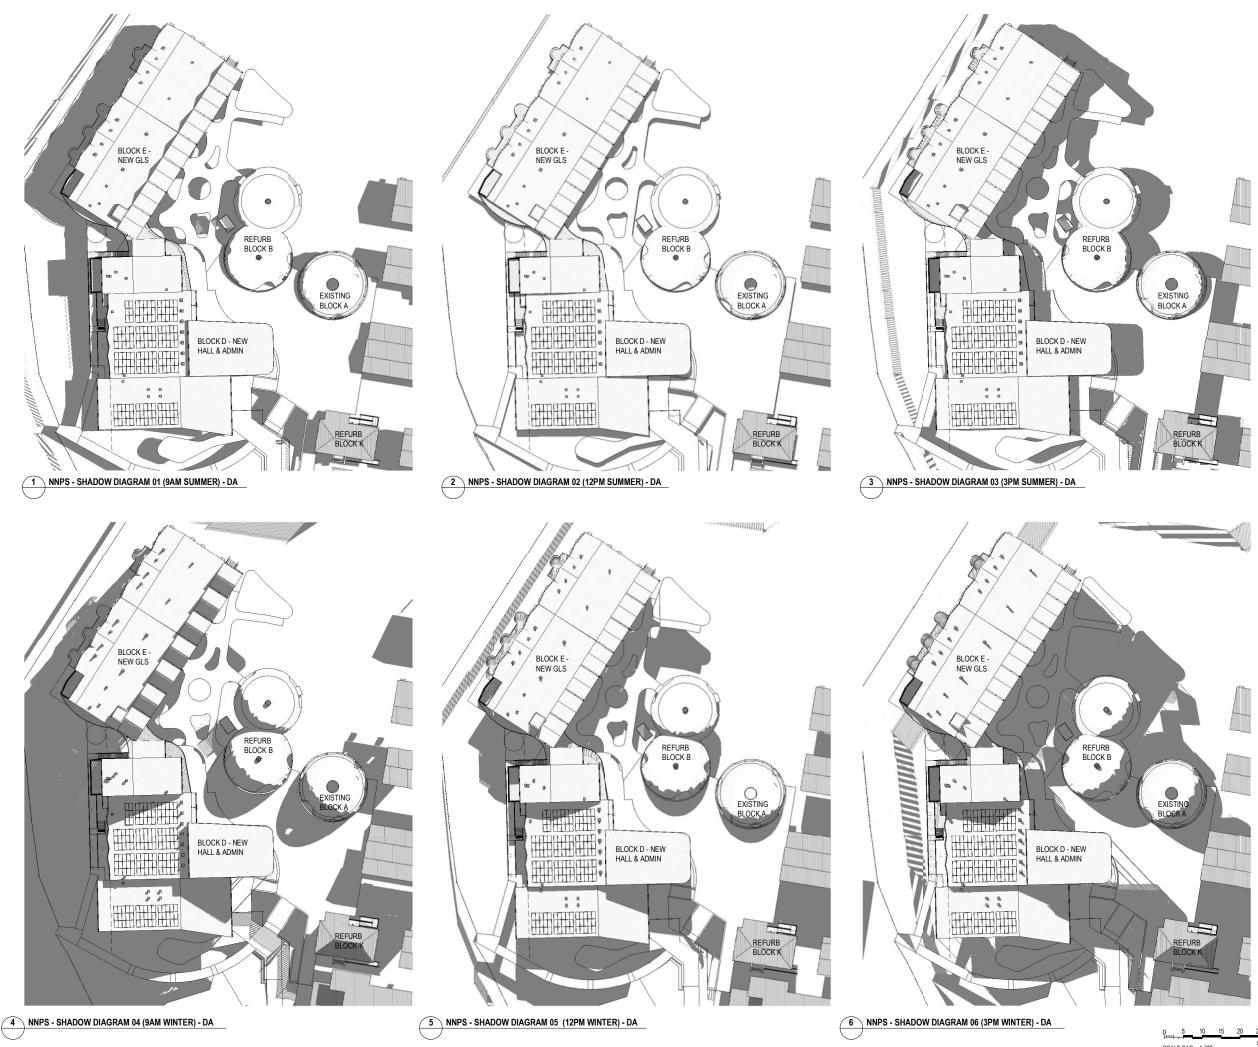


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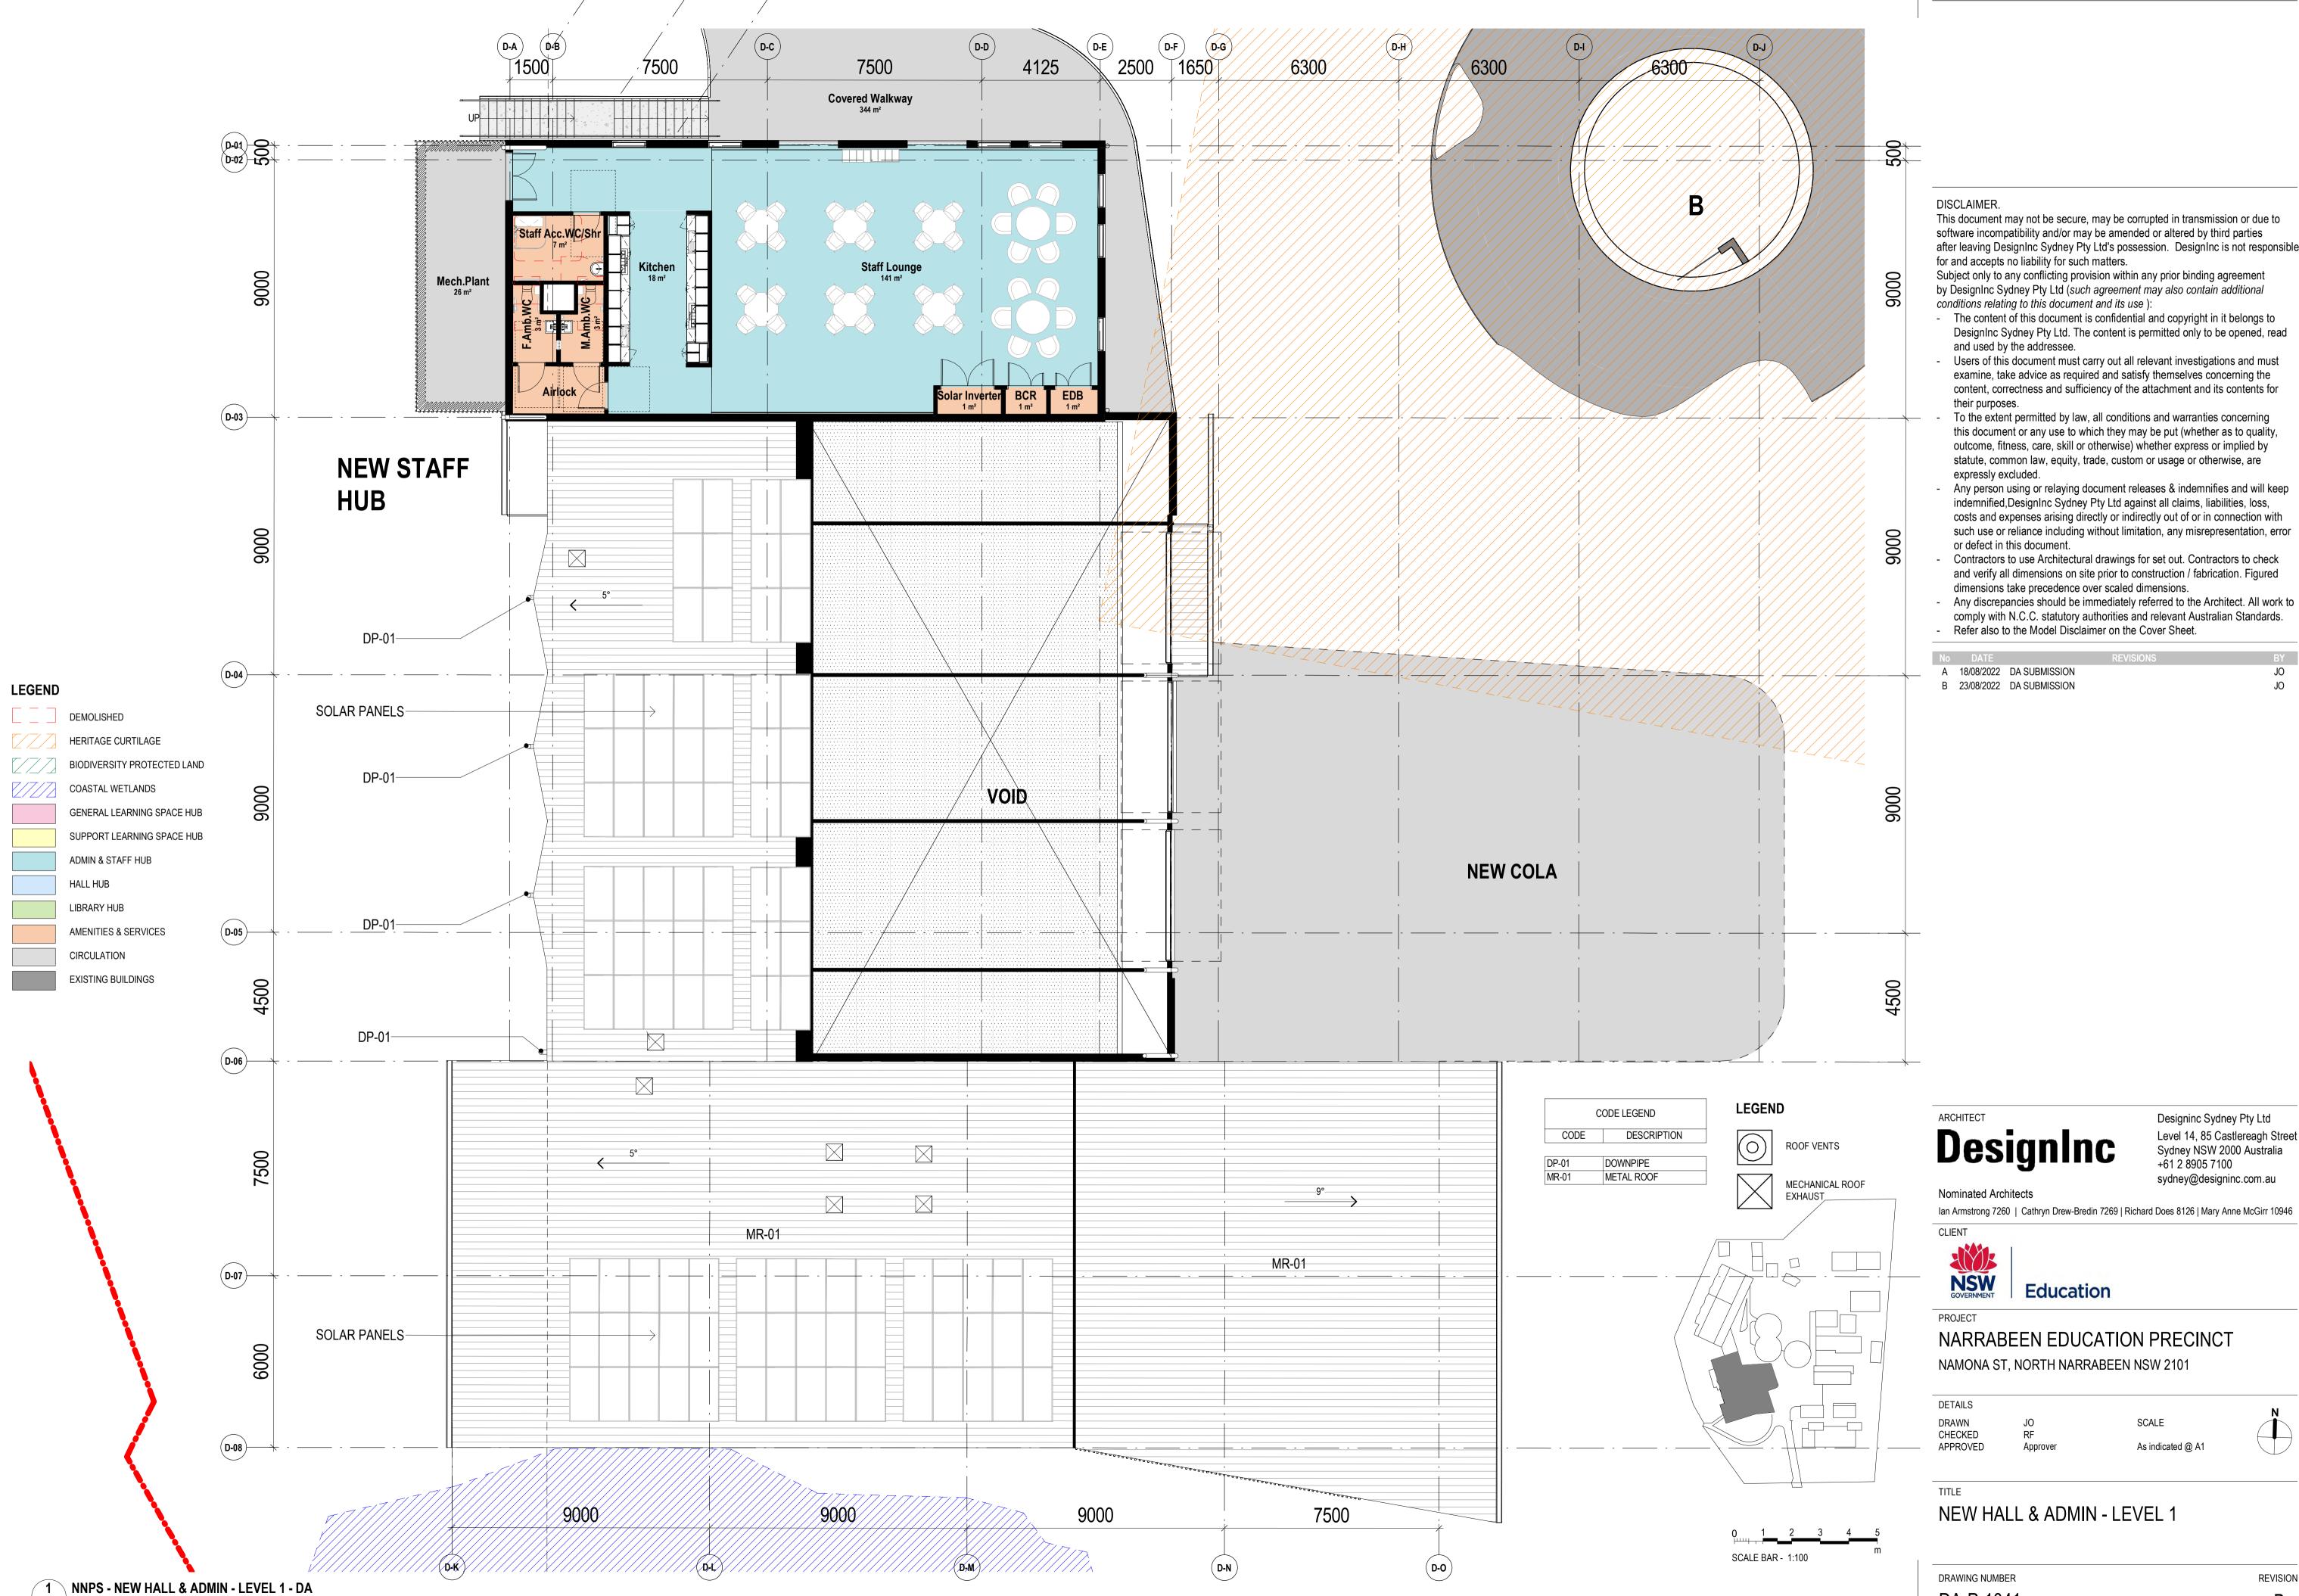
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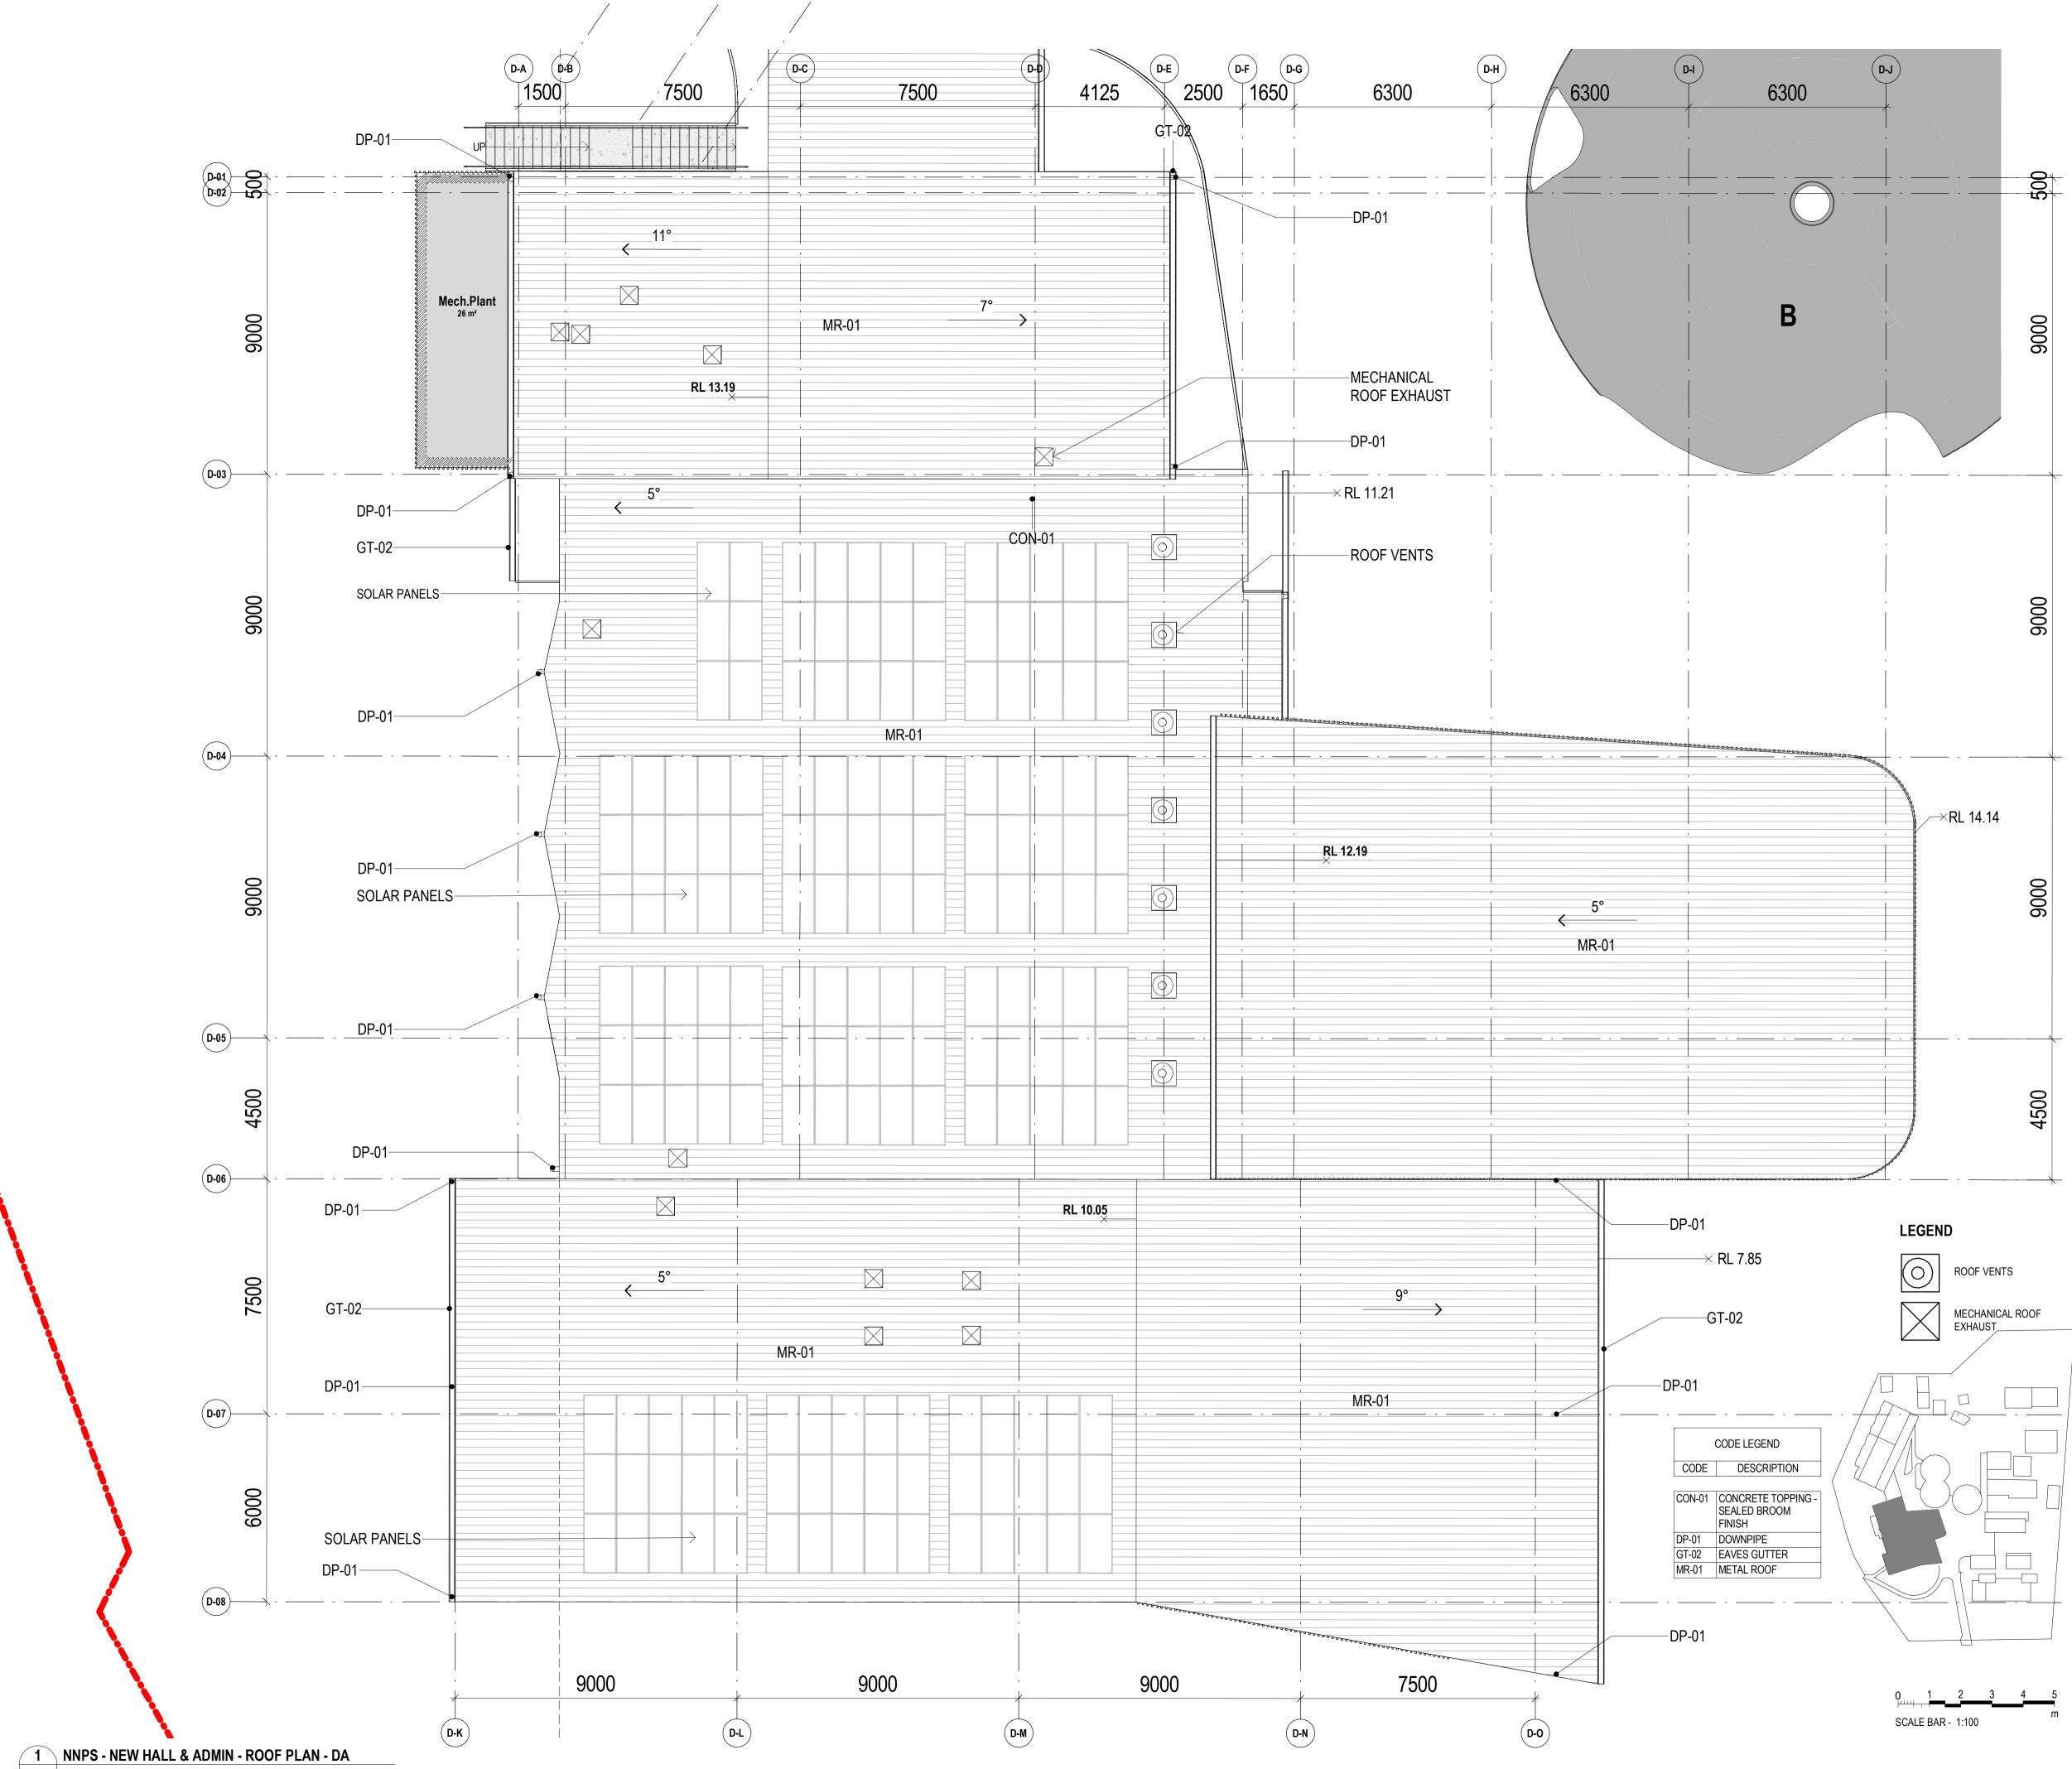
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Nominated Architects

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TITLE

NEW HALL & ADMIN - ROOF PLAN

DRAWING NUMBER REVISION DA-P-1042 В



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lan Armstrong 7260 | Cathryn Drew-Bredin 7269 | Richard Does 8126 | Mary Anne McGirr 10946 CLIENT



PROJECT



NARRABEEN EDUCATION PRECINCT NAMONA ST, NORTH NARRABEEN NSW 2101

JO RF Approver


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DRAWN CHECKED APPROVED	

TITLE

SCALE 1:200@A1

NEW ADMIN & HALL - SITE ELEVATIONS

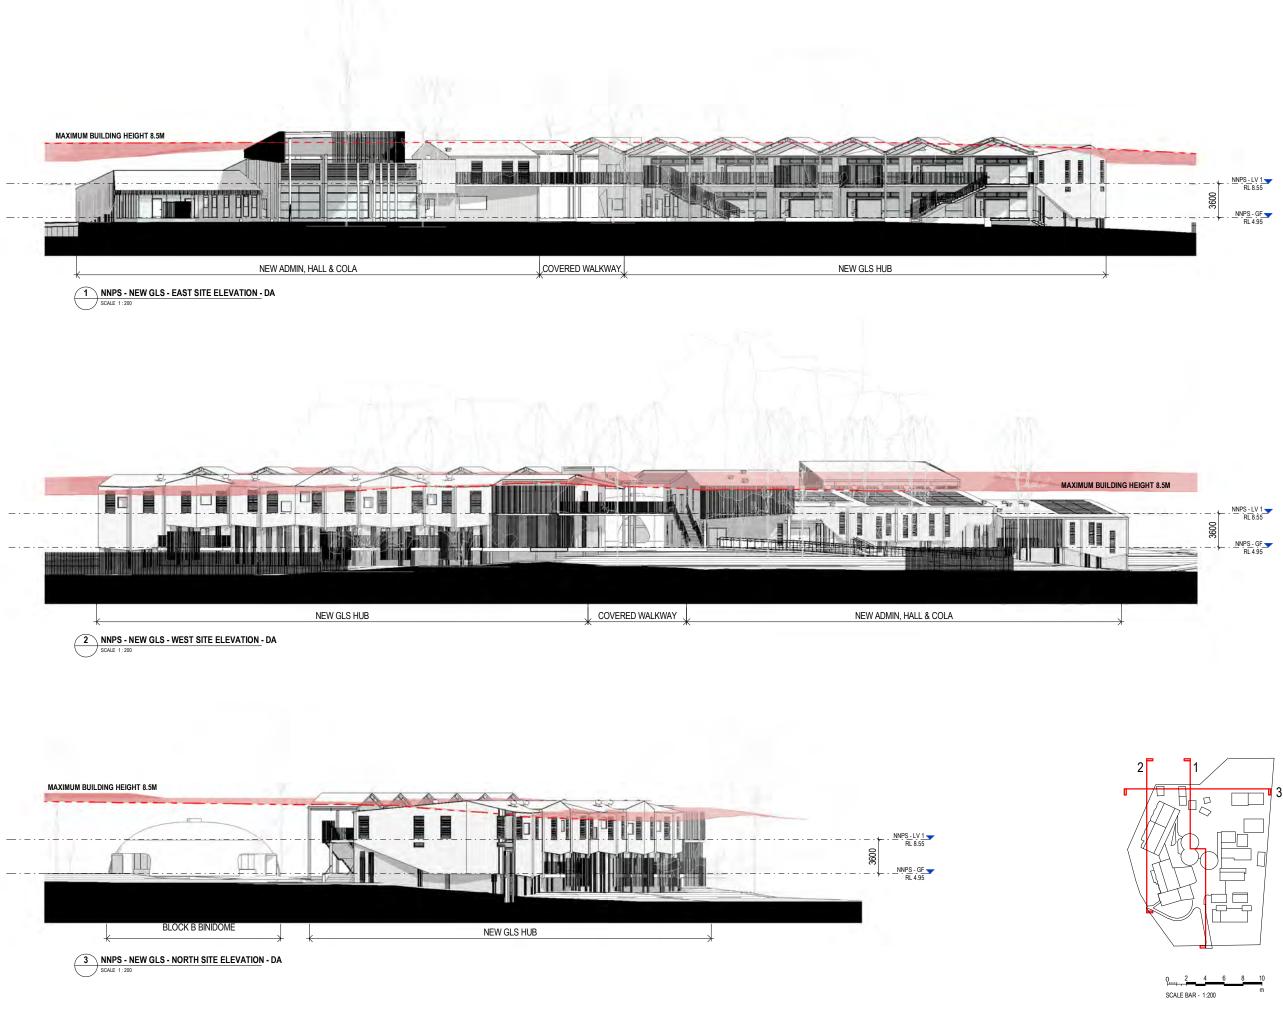DRAWING NUMBER REVISION DA-P-3001 А



3000 - ELEVATIONS & SECTIONS

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ARCHITECT

Designinc Sydney Pty Ltd Level 14, 85 Castlereagh Street Sydney NSW 2000 Australia +61 2 8905 7100 sydney@designinc.com.au

Nominated Architects



lan Armstrong 7260 | Cathryn Drew-Bredin 7269 | Richard Does 8126 | Mary Anne McGirr 10946



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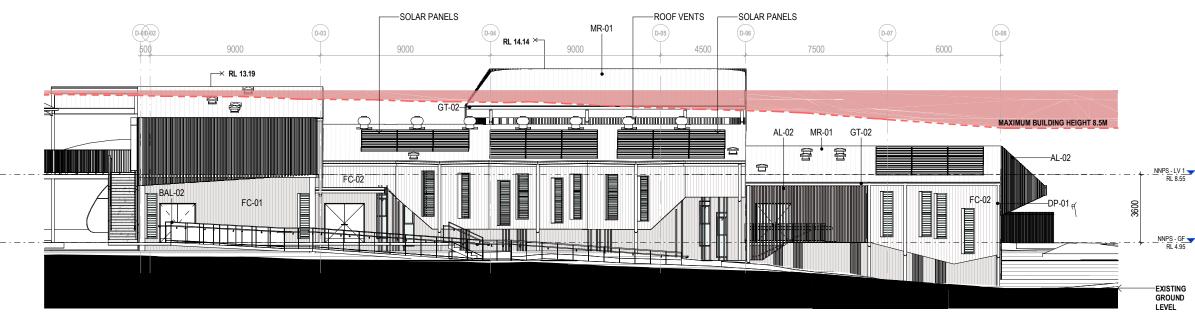
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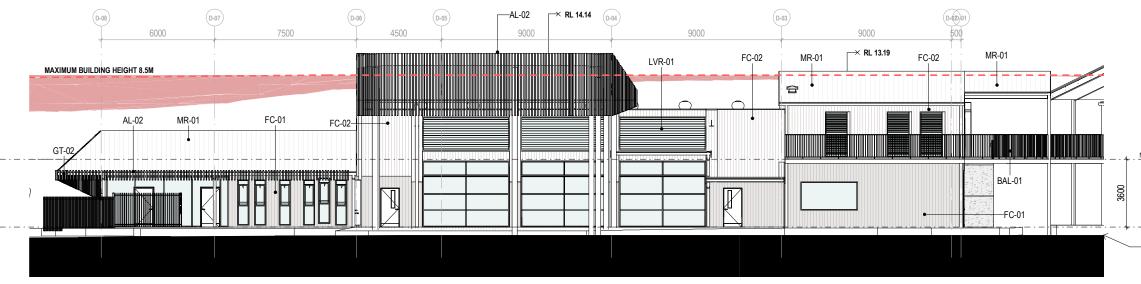
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NEW GLS HUB - SITE ELEVATIONS






1 NNPS - NEW ADMIN & HALL - WEST ELEVATION - DA SCALE 1:10



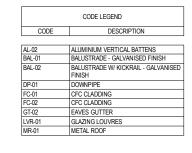2 NNPS - NEW ADMIN & HALL - EAST ELEVATION - DA





3000 - ELEVATIONS & SECTIONS

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NNPS - LV 1 RL 8.55





0 1 2 3 SCALE BAR - 1:100





Designinc Sydney Pty Ltd Level 14, 85 Castlereagh Street Sydney NSW 2000 Australia +61 2 8905 7100 sydney@designinc.com.au

Nominated Architects Ian Armstrong 7260 | Cathryn Drew-Bredin 7269 | Richard Does 8126 | Mary Anne McGirr 10946



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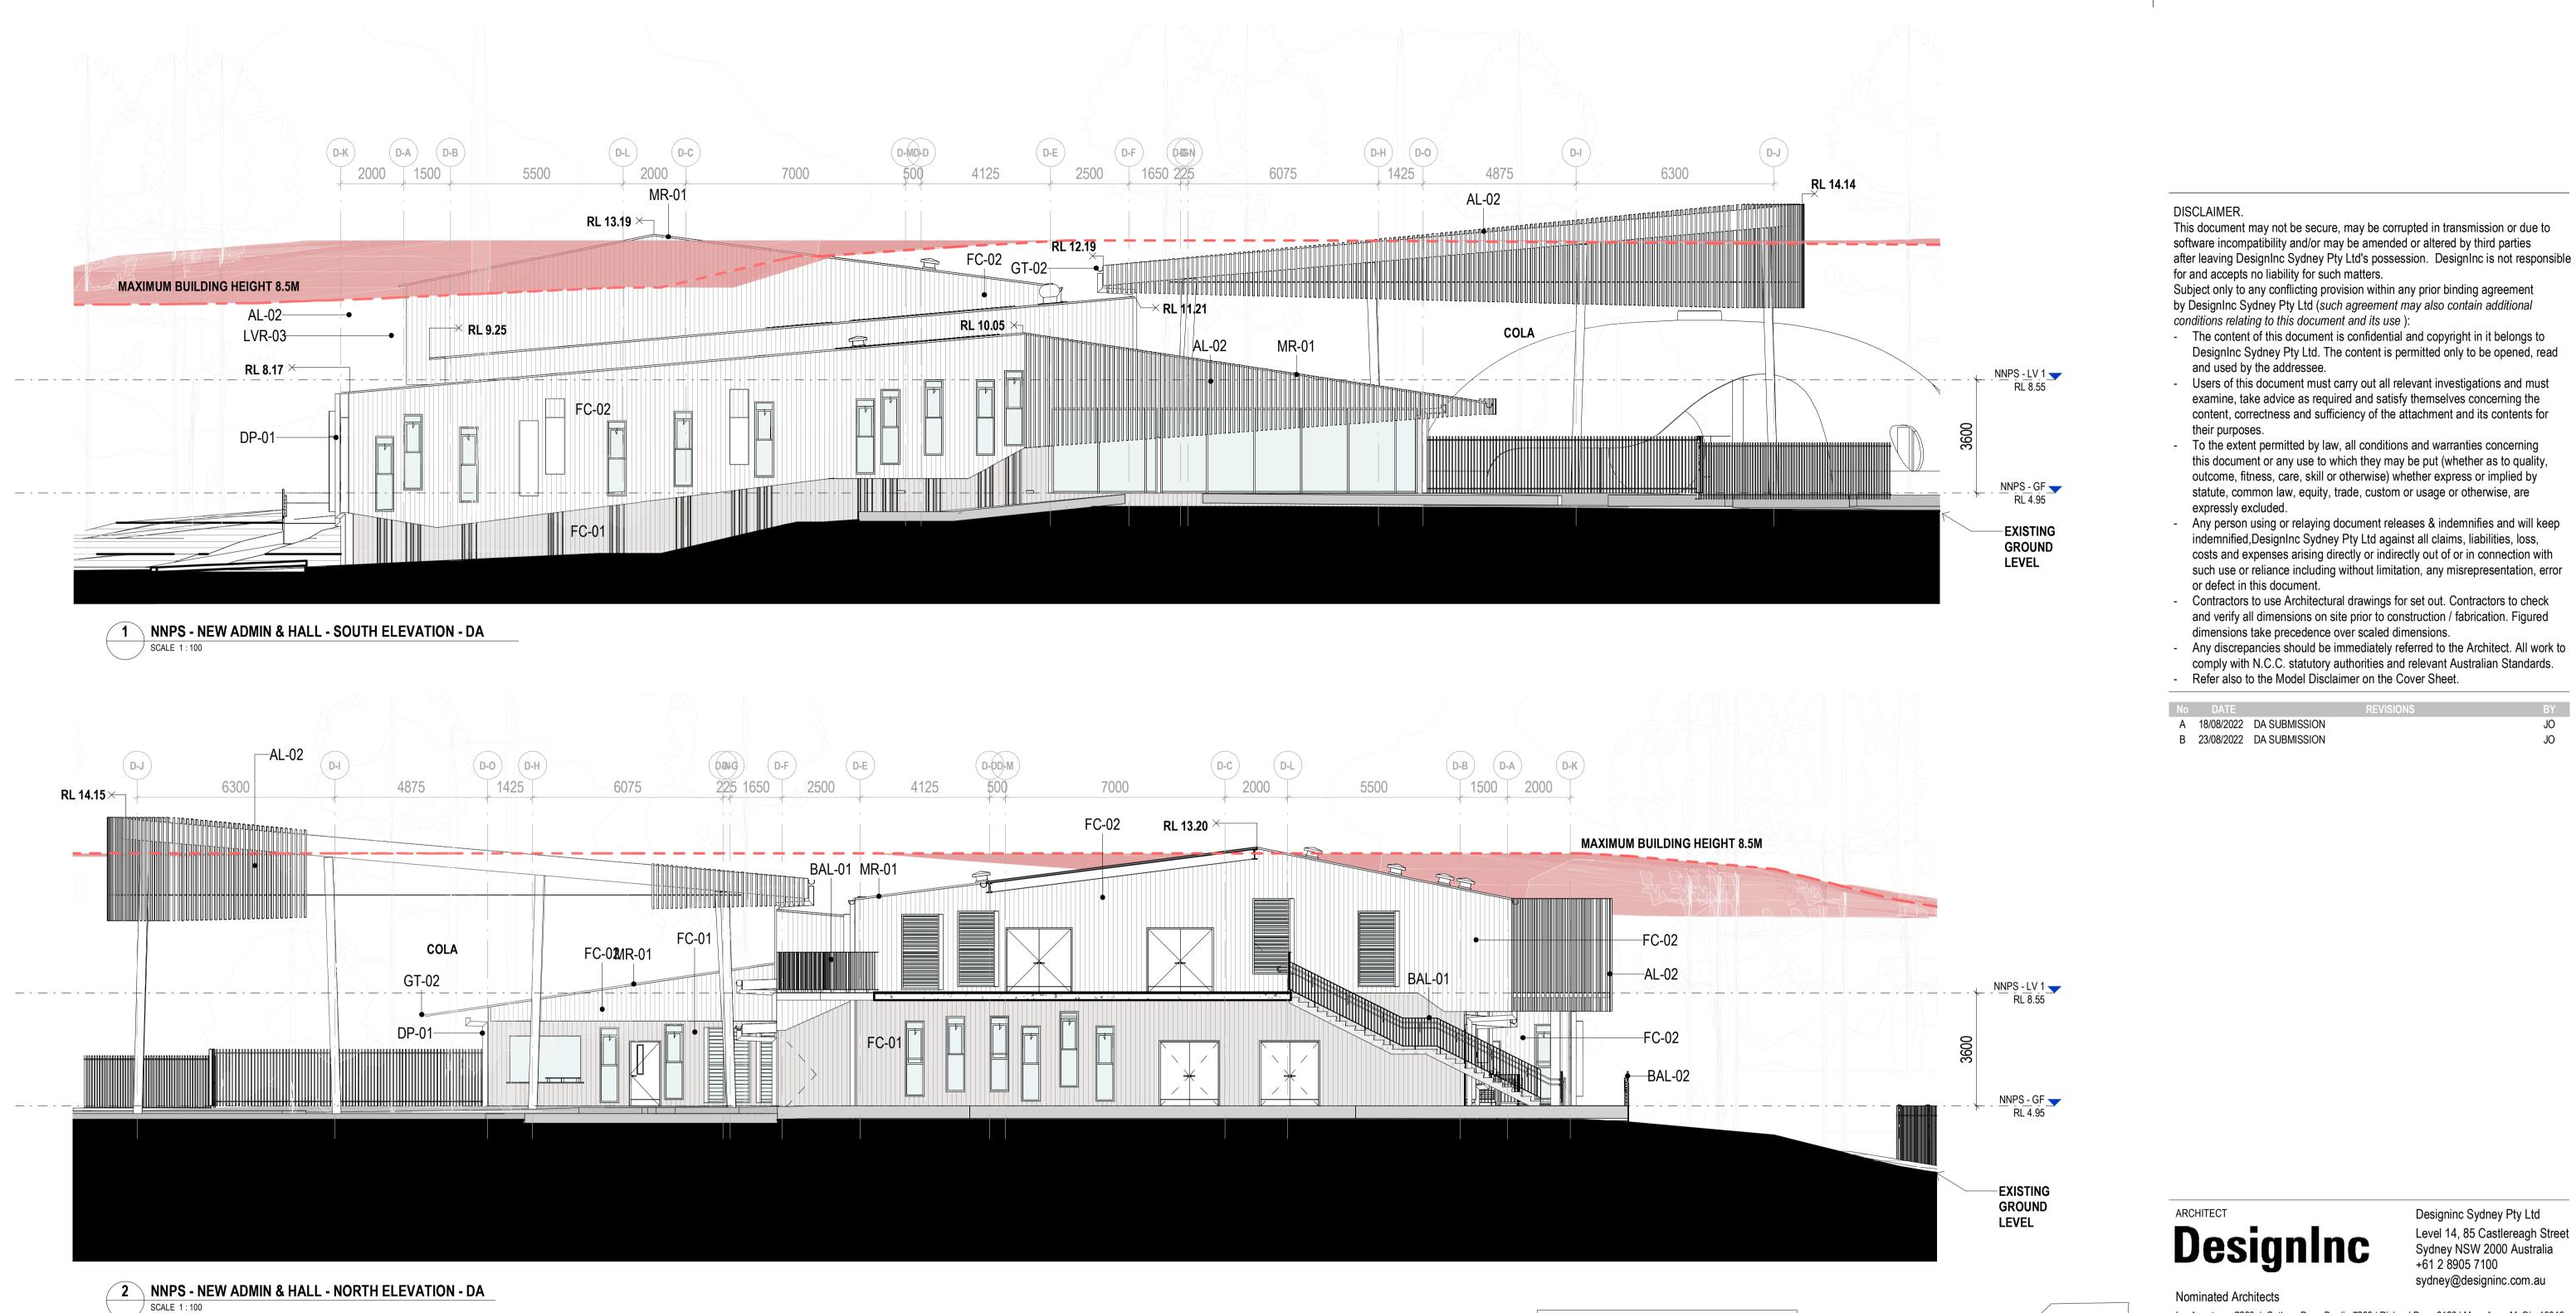
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DETAILS	
DRAWN CHECKED APPROVED	


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TITLE NEW ADMIN & HALL - GA ELEVATIONS





	CODE LEGEND
CODE	DESCRIPTION
AL-02	ALUMINIUM VERTICAL BATTENS
BAL-01	BALUSTRADE - GALVANISED FINISH
BAL-02	BALUSTRADE W/ KICKRAIL - GALVANISED FINISH
DP-01	DOWNPIPE
FC-01	CFC CLADDING
FC-02	CFC CLADDING
GT-02	EAVES GUTTER
LVR-03	FIXED METAL LOUVRES - ACOUSTIC
MR-01	METAL ROOF

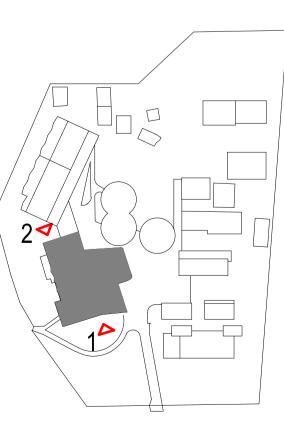

3000 - ELEVATIONS & SECTIONS

No	DATE		REVISIONS	BY
Α	18/08/2022	DA SUBMISSION		JO
В	23/08/2022	DA SUBMISSION		JO

1 2 3 SCALE BAR - 1:100

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DETAILS DRAWN CHECKED APPROVED

PROJECT


JO RF Approver


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TITLE


NEW HALL & ADMIN - GA ELEVATIONS

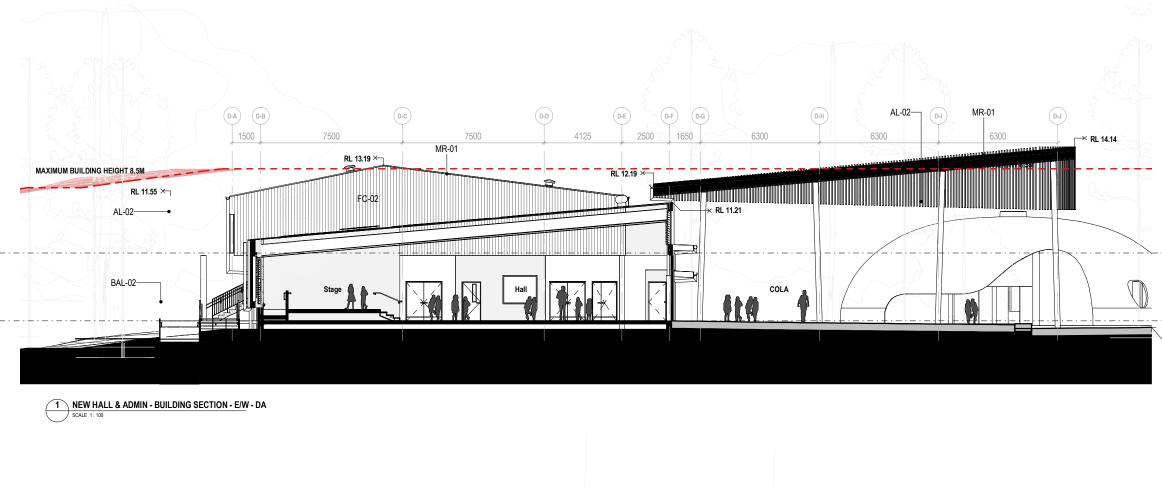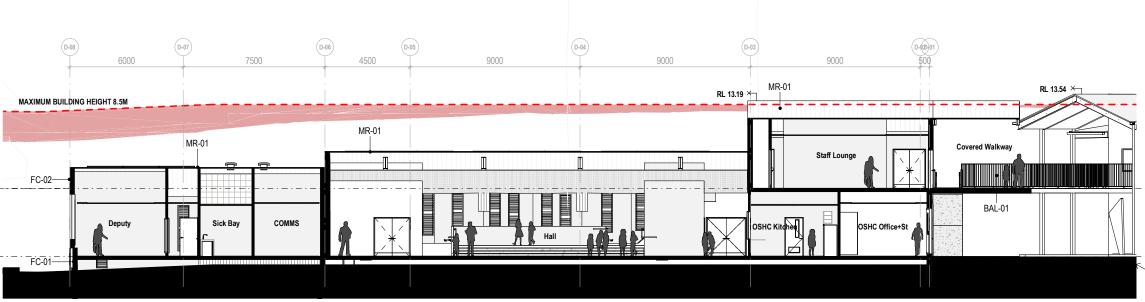DRAWING NUMBER REVISION DA-P-3041 В





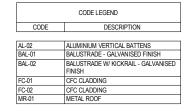2 NEW HALL & ADMIN - BUILDING SECTION - N/S - DA SCALE 1:100





.NNPS - LV 1 RL 8.55

3000 - ELEVATIONS & SECTIONS



NNPS - LV 1 - RL 8.55

NNPS - GF -RL 4.95

-EXISTING Ground Level

800

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0 1 2 3 SCALE BAR - 1:100

ARCHITECT



Designinc Sydney Pty Ltd Level 14, 85 Castlereagh Street Sydney NSW 2000 Australia +61 2 8905 7100 sydney@designinc.com.au

Nominated Architects Ian Armstrong 7260 | Cathryn Drew-Bredin 7269 | Richard Does 8126 | Mary Anne McGirr 10946



PROJECT



NARRABEEN EDUCATION PRECINCT NAMONA ST, NORTH NARRABEEN NSW 2101

DETAILS DRAWN CHECKED APPROVED

Author Checker Approver SCALE 1:100@A1

TITLE

NEW HALL & ADMIN - GA SECTIONS





Annex B Site and Design Plans for NSHS



NARRABEEN SPORTS HIGH SCHOOL

10 NAMONA STREET, NORTH NARRABEEN NSW 2101

Sheet Number	Sheet Name	Current Revision	Current Revision Date	Current Revision Description
0000 - GENERAL	& SITE INFORMATION			
AR-H-0100	COVER SHEET, LOCATION PLAN & DRAWING LIST - DA	A	15/09/2022	ISSUE FOR DA
AR-H-0200	SITE ANALYSIS	A	15/09/2022	ISSUE FOR DA
AR-H-0302	NSHS GYMNASIUM AXONOMETRIC VIEW	A	15/09/2022	ISSUE FOR DA
AR-H-0303	NSHS PROPOSED EXTENSION PERSPECTIVE VIEWS	A	15/09/2022	ISSUE FOR DA
AR-H-0350	SHADOW DIAGRAMS	A	15/09/2022	ISSUE FOR DA
AR-H-0351	SHADOW DIAGRAMS	A	15/09/2022	ISSUE FOR DA
AR-H-0352	SHADOW DIAGRAMS	A	15/09/2022	ISSUE FOR DA
AR-H-0510	EXISTING SITE PLAN	A	15/09/2022	ISSUE FOR DA
AR-H-0512	DEMOLITION SITE PLAN - GROUND FLOOR	A	15/09/2022	ISSUE FOR DA
AR-H-0513	DEMOLITION SITE PLAN - LEVEL 1	A	15/09/2022	ISSUE FOR DA
AR-H-0521	PROPOSED SITE PLAN - GROUND FLOOR	A	15/09/2022	ISSUE FOR DA
AR-H-0522	PROPOSED SITE PLAN-LEVEL 1 PLAN	A	15/09/2022	ISSUE FOR DA
AR-H-0523	PROPOSED SITE PLAN ROOF PLAN	A	15/09/2022	ISSUE FOR DA
	AND DEMOLITION PLANS			
AR-H-0533	EXISTING PLAN- BLOCK A SOUTH GROUND FLOOR	A	15/09/2022	ISSUE FOR DA
AR-H-0534	EXISTING PLAN- BLOCK A SOUTH LEVEL 1	A	15/09/2022	ISSUE FOR DA
AR-H-0535	EXISTING PLAN_BLOCK A SOUTH ROOF PLAN	A	15/09/2022	ISSUE FOR DA
AR-H-0553	DEMOLITION PLAN - GROUND FLOOR_BLOCK A SOUTH	A	15/09/2022	ISSUE FOR DA
AR-H-0554	DEMOLITION SITE PLAN_BLOCK A SOUTH_LEVEL 1	A	15/09/2022	ISSUE FOR DA
AR-H-0555	DEMOLITION PLAN_BLOCK A SOUTH_ROOF PLAN	A	15/09/2022	ISSUE FOR DA
1000 - GA PLANS				
AR-H-1010	PROPOSED PLAN_ BLOCK A SOUTH_GROUND FLOOR	A	15/09/2022	ISSUE FOR DA
AR-H-1011	PROPOSED PLAN_BLOCK A SOUTH_LEVEL 1	A	15/09/2022	ISSUE FOR DA
AR-H-1012	PROPOSED PLAN_BLOCK A SOUTH_ROOF PLAN	A	15/09/2022	ISSUE FOR DA
AR-H-1013	PROPOSED PLAN_ BLOCK A LIFT	A	15/09/2022	ISSUE FOR DA
3000 - ELEVATIOI		~	10/00/2022	
AR-H-3005	EXISTING ELEVATION - BLOCK A3	A	15/09/2022	ISSUE FOR DA
AR-H-3006	EXISTING ELEVATION - BLOCK A3	A	15/09/2022	ISSUE FOR DA
AR-H-3007	DEMOLITION ELEVATION - BLOCK A3	A	15/09/2022	ISSUE FOR DA
AR-H-3008	DEMOLITION ELEVATION - BLOCK A3	A	15/09/2022	ISSUE FOR DA
AR-H-3010	PROPOSED ELEVATIONS- BLOCK A- SOUTH AND EAST	A	15/09/2022	ISSUE FOR DA
AR-H-3011	PROPOSED ELEVATIONS- BLOCK A- EAST, NORTH AND WEST	A	15/09/2022	ISSUE FOR DA
AR-H-3012	PROPOSED ELEVATIONS- BLOCK A_GYM_NORTH ELEVATION	A	15/09/2022	ISSUE FOR DA
AR-H-3041	SECTIONS- BLOCK A	A	15/09/2022	ISSUE FOR DA
AR-H-3042	SECTIONS- BLOCK A	A	15/09/2022	ISSUE FOR DA

SOURCE: NEARMAP

DA SET

0000 - GENERAL & SITE INFORMATION

ARCHITECTURE:

AIVOIT	
0000	GENERAL & SITE INFORMATION
1000	GENERAL ARRANGEMENT PLANS
2000	GA RCPs
3000	GA SECTIONS & ELEVATIONS
4000	REFERENCE PLANS
5000	STRUCTURAL SET-OUT
6000	VERTICAL CIRCULATION
7000	INTERIOR DESIGN DETAILS
8000	EXTERIOR & FACADE DETAILS
9000	DRAWN SCHEDULES
9000	SCHEDULES & SPECIFICATIONS

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No	DATE	REVISIONS	BY
1	26/05/2022	SCHEMATIC DESIGN - DRAFT	JO
2	08/06/2022	PRE-DA - DRAFT	JO
3	29/06/2022	FOR INFORMATION	
4	07/07/2022	FOR INFORMATION	
5	12/07/2022	FOR INFORMATION	RF
6	09/09/2022	FOR INFORMATION	RF
А	15/09/2022	ISSUE FOR DA	

ARCHITECT

DesignInc

Designinc Sydney Pty Ltd Level 14, 85 Castlereagh Street Sydney NSW 2000 Australia +61 2 8905 7100 sydney@designinc.com.au

Nominated Architects

Ian Armstrong 7260 | Cathryn Drew-Bredin 7269 | Richard Does 8126 | Mary Anne McGirr 10946 CLIENT





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NARRABEEN SPORTS HIGH SCHOOL

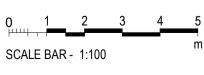
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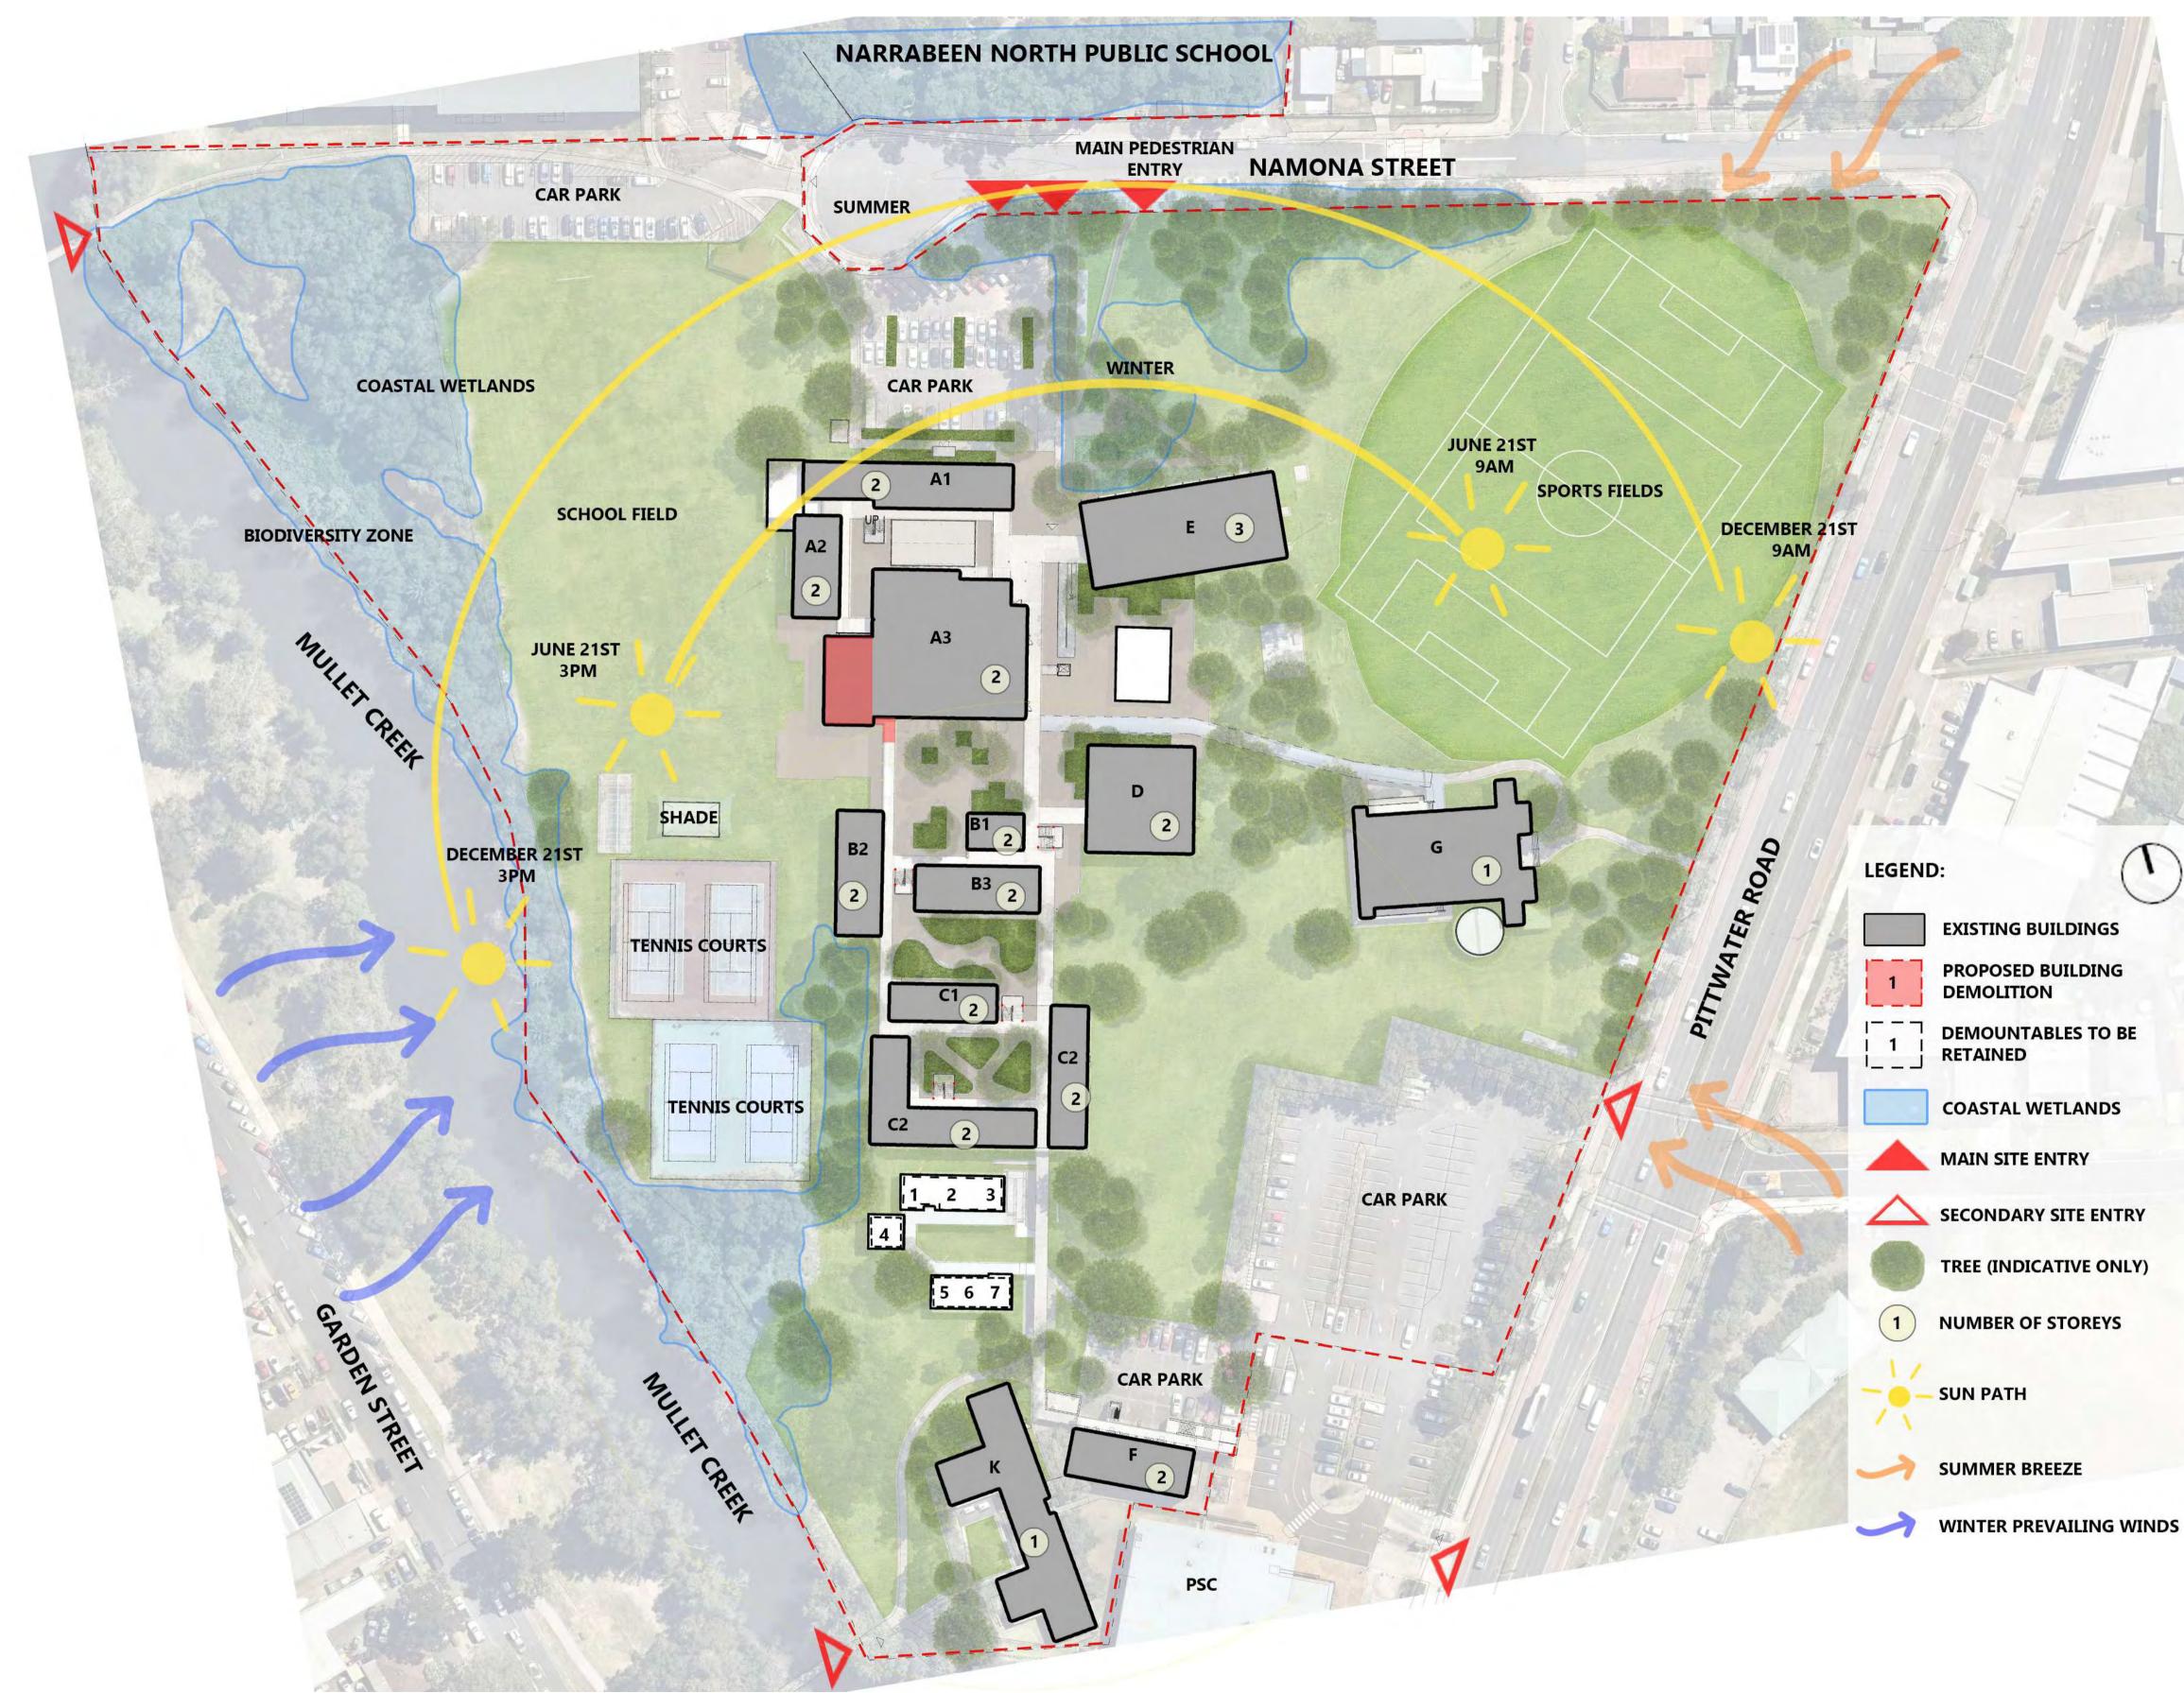


TITLE



COVER SHEET, LOCATION PLAN & DRAWING LIST - DA

DRAWING NUMBER AR-H-0100



SITE ANALYSIS - NARRABEEN SPORTS HIGHSCHOOL

0000 - GENERAL & SITE INFORMATION

ARCHITECTURE:

0000 GENERAL & SITE INFORMATION 1000 GENERAL ARRANGEMENT PLANS 2000 GA RCPs

- 3000 GA SECTIONS & ELEVATIONS
- 4000 REFERENCE PLANS 5000 STRUCTURAL SET-OUT
- 6000 VERTICAL CIRCULATION
- 7000 INTERIOR DESIGN DETAILS
- 8000 EXTERIOR & FACADE DETAILS 9000 DRAWN SCHEDULES
- 9000 SCHEDULES & SPECIFICATIONS

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2	12/07/2022	FOR INFORMATION		RF
3	09/09/2022	FOR INFORMATION		RF
А	15/09/2022	ISSUE FOR DA		





Designinc Sydney Pty Ltd Level 14, 85 Castlereagh Street Sydney NSW 2000 Australia +61 2 8905 7100 sydney@designinc.com.au

Nominated Architects

Ian Armstrong 7260 | Cathryn Drew-Bredin 7269 | Richard Does 8126 | Mary Anne McGirr 10946 CLIENT





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NARRABEEN SPORTS HIGH SCHOOL

DETAILS DRAWN CHECKED APPROVED

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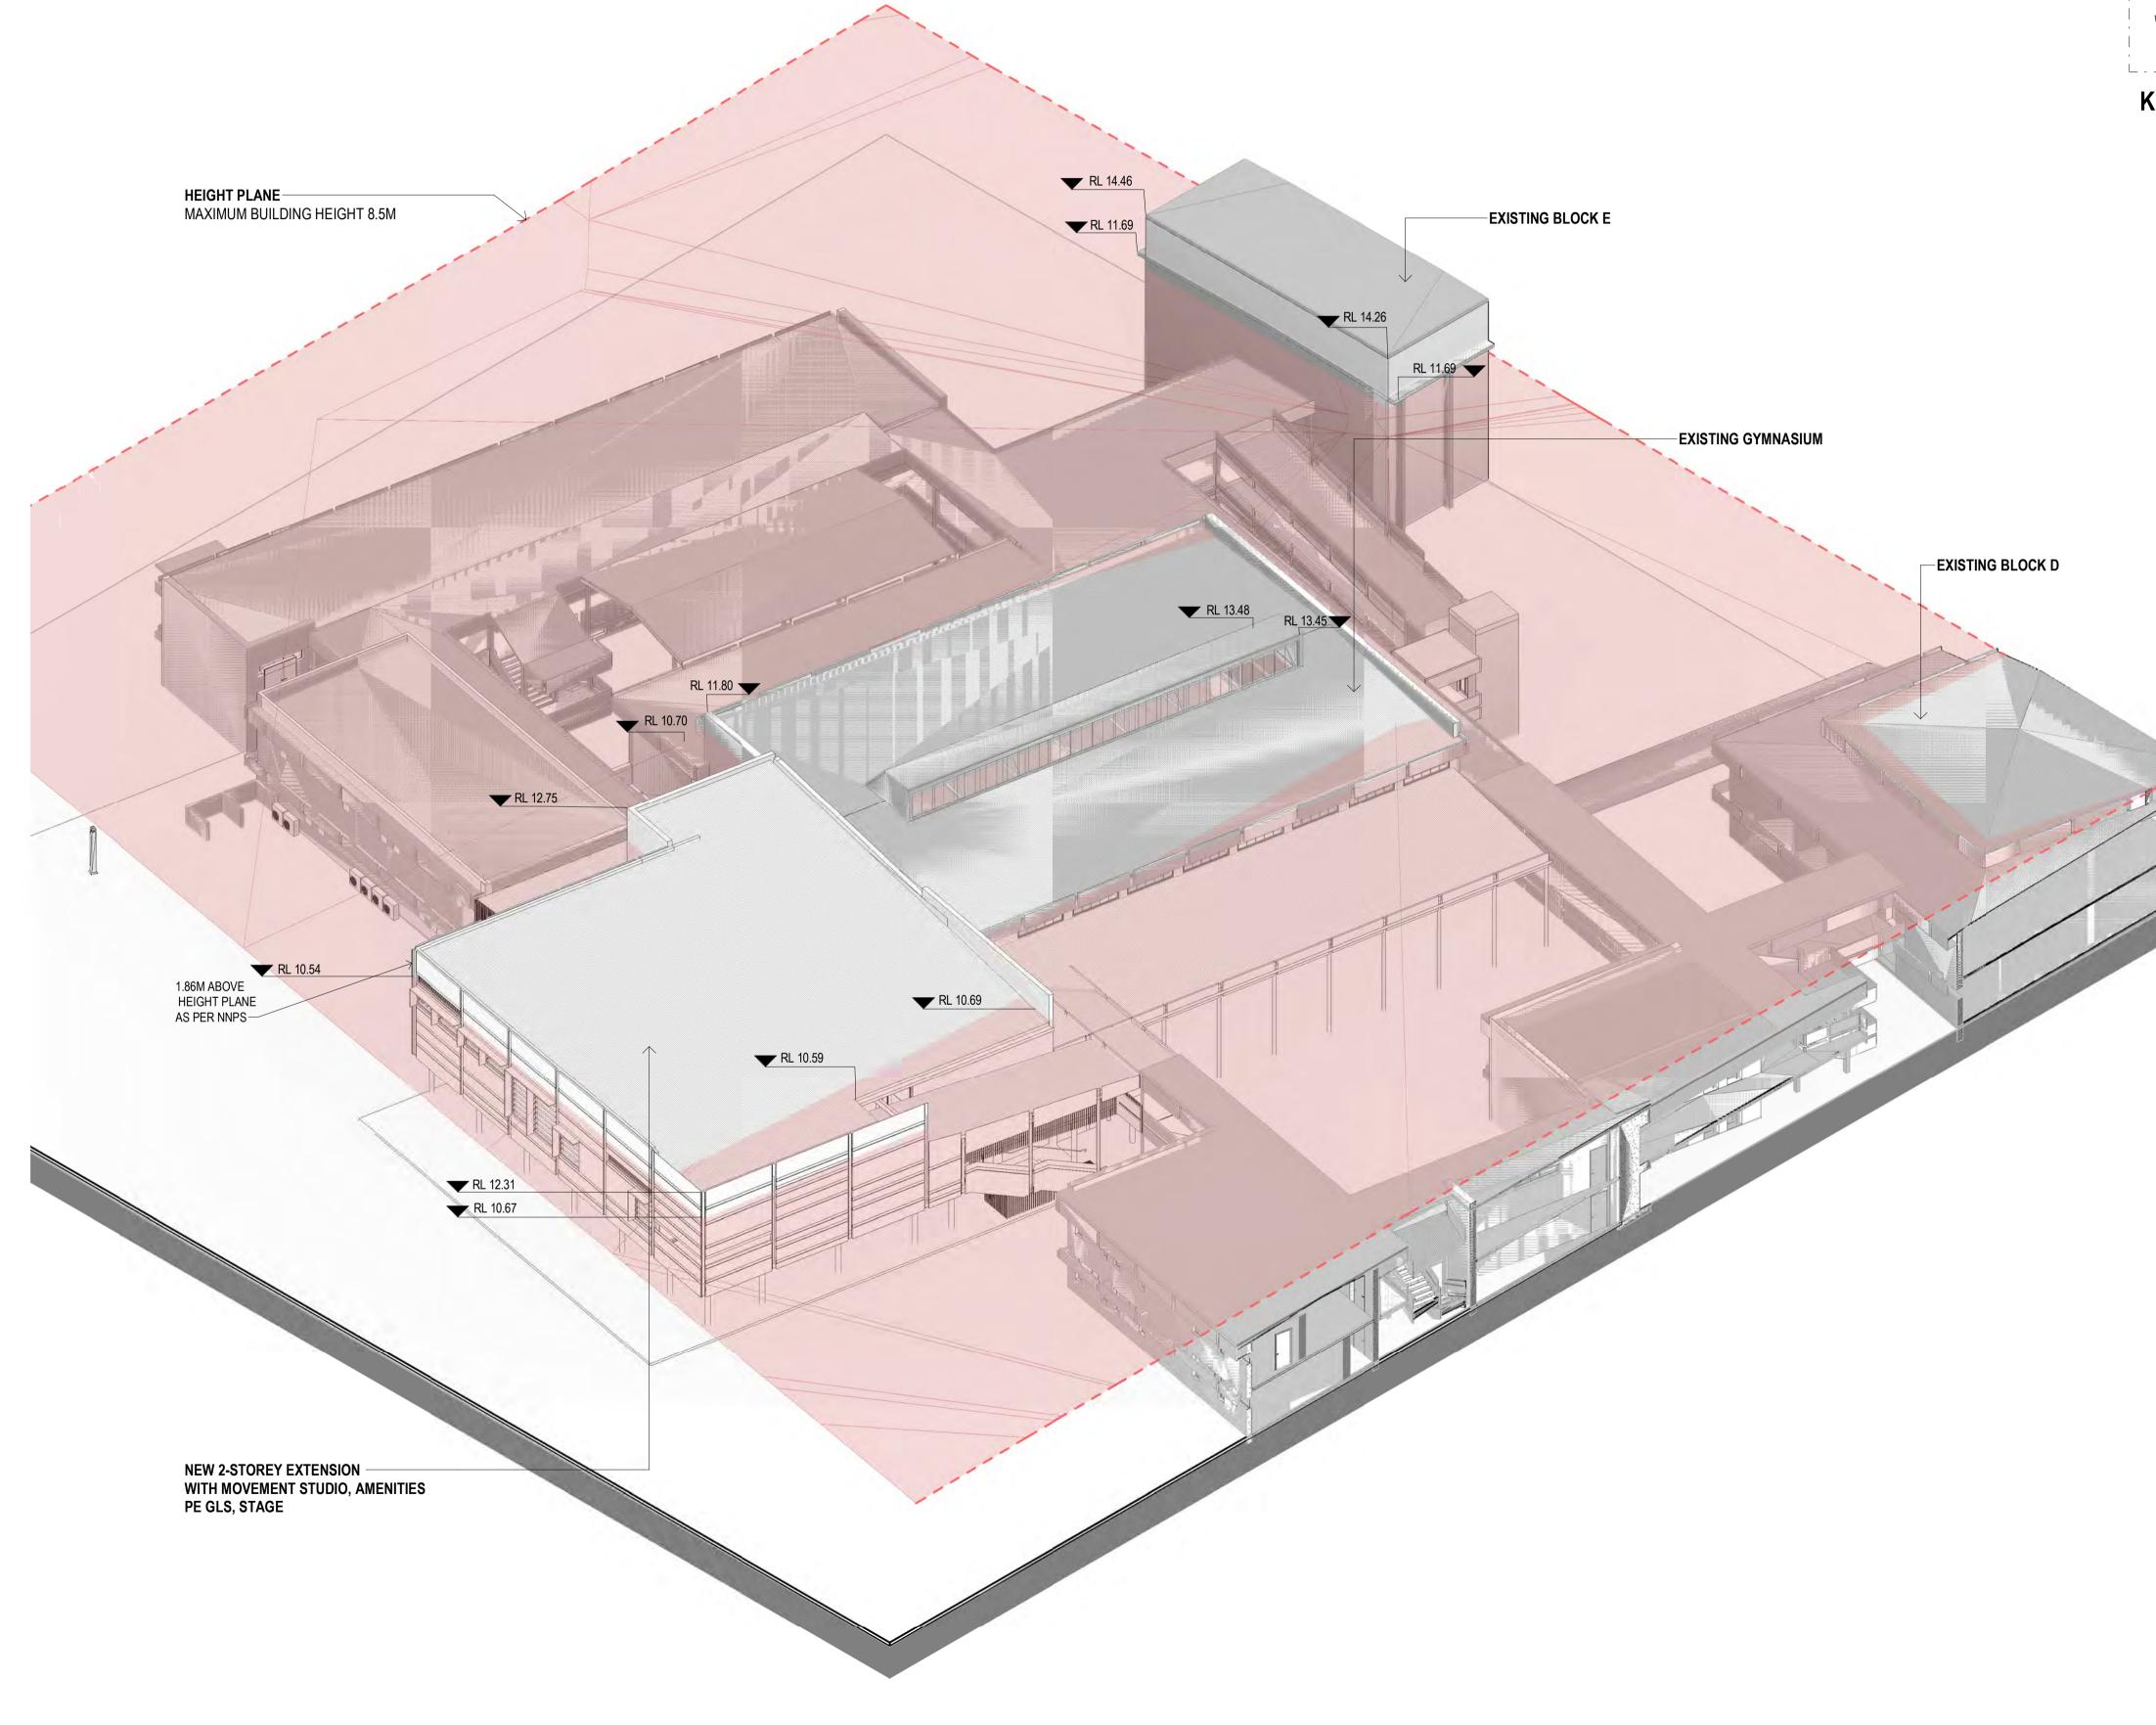
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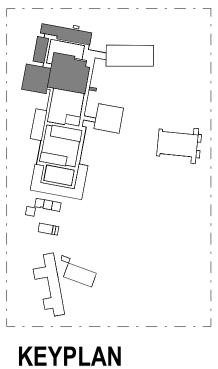
TITLE SITE ANALYSIS

DRAWING NUMBER

AR-H-0200



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0000 - GENERAL & SITE INFORMATION

ARCHITECTURE:

АКСП	HECTURE.
0000	GENERAL & SITE INFORMATION
1000	GENERAL ARRANGEMENT PLANS
2000	GA RCPs
3000	GA SECTIONS & ELEVATIONS
4000	REFERENCE PLANS
5000	STRUCTURAL SET-OUT
6000	VERTICAL CIRCULATION
7000	INTERIOR DESIGN DETAILS
8000	EXTERIOR & FACADE DETAILS
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No	DATE	REVISIONS	BY
1	02/08/2022	FOR CONSULTANT	RF
2	03/08/2022	FOR INFORMATION	RF
3	09/09/2022	FOR INFORMATION	RF
А	15/09/2022	ISSUE FOR DA	





DesignInc

Designinc Sydney Pty Ltd Level 14, 85 Castlereagh Street Sydney NSW 2000 Australia +61 2 8905 7100 sydney@designinc.com.au

Nominated Architects

Ian Armstrong 7260 | Cathryn Drew-Bredin 7269 | Richard Does 8126 | Mary Anne McGirr 10946





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NARRABEEN SPORTS HIGH SCHOOL

DETAILS DRAWN CHECKED APPROVED

Author Checker Approver

SCALE N/A @ A1

NSHS GYMNASIUM AXONOMETRIC VIEW

DRAWING NUMBER AR-H-0302





0000 - GENERAL & SITE INFORMATION

ARCHITECTURE:

0000 GENERAL & SITE INFORMATION 1000 GENERAL ARRANGEMENT PLANS

2000 GA RCPs 3000 GA SECTIONS & ELEVATIONS

- 4000 REFERENCE PLANS
- 5000 STRUCTURAL SET-OUT 6000 VERTICAL CIRCULATION

7000 INTERIOR DESIGN DETAILS

8000 EXTERIOR & FACADE DETAILS

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- No DATE 1 09/09/2022 FOR INFORMATION A 15/09/2022 ISSUE FOR DA

ARCHITECT

DesignInc

Designinc Sydney Pty Ltd Level 14, 85 Castlereagh Street

RF

Nominated Architects

lan Armstrong 7260 | Cathryn Drew-Bredin 7269 | Richard Does 8126 | Mary Anne McGirr 10946 CLIENT





PROJECT NARRABEEN EDUCATION PRECINCT NAMONA ST, NORTH NARRABEEN NSW 2101

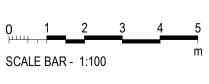
NARRABEEN SPORTS HIGH SCHOOL

DETAILS DRAWN CHECKED APPROVED

Author Checker Approver

SCALE @ A1

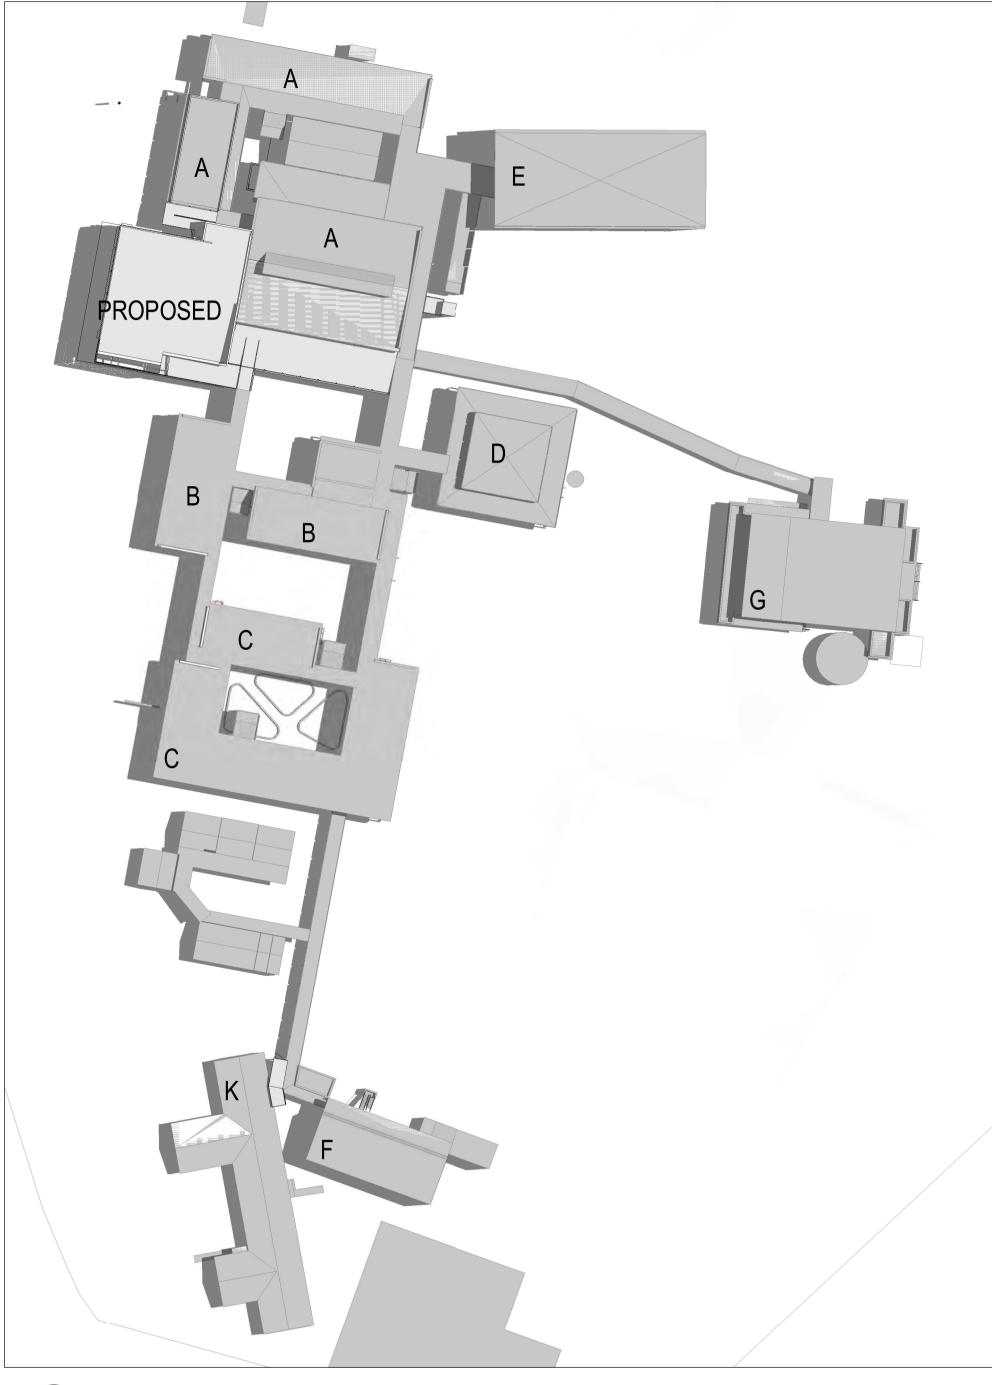
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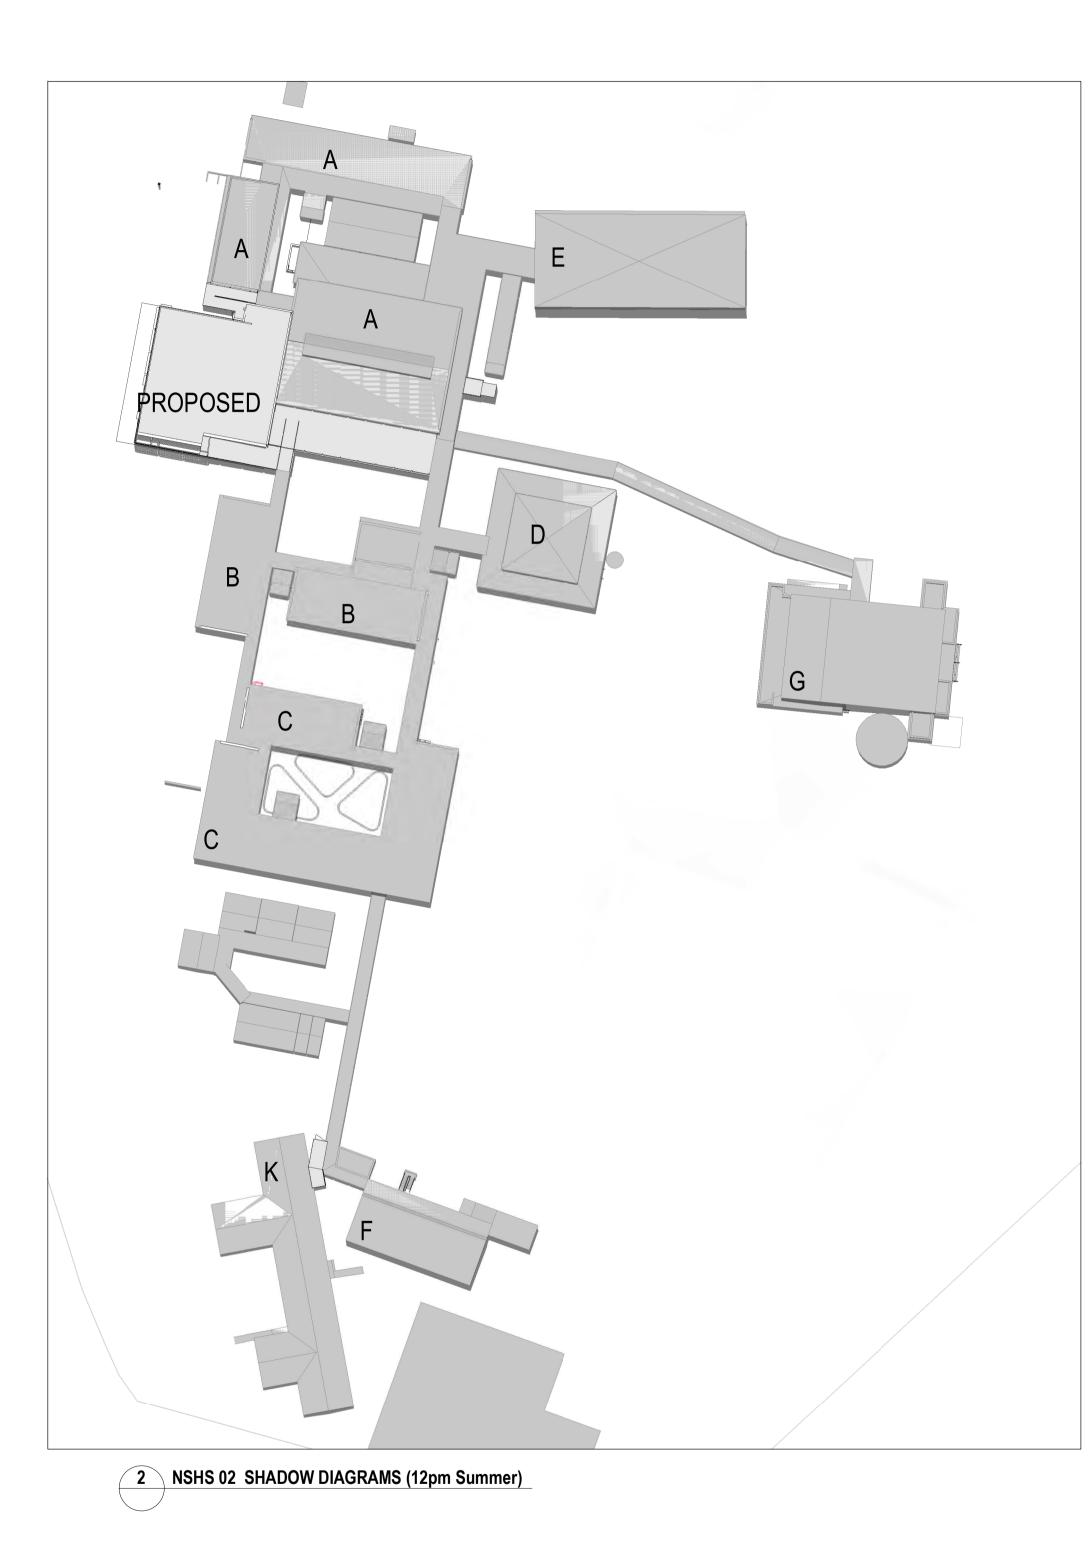
NSHS PROPOSED EXTENSION PERSPECTIVE VIEWS


DRAWING NUMBER AR-H-0303 REVISION Α

Sydney NSW 2000 Australia +61 2 8905 7100 sydney@designinc.com.au



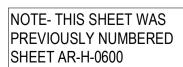1 NSHS 01 SHADOW DIAGRAMS (9am Summer)





0000 - GENERAL & SITE INFORMATION

ARCHITECTURE:

0000 GENERAL & SITE INFORMATION 1000 GENERAL ARRANGEMENT PLANS

2000 GA RCPs	
--------------	--

- 3000 GA SECTIONS & ELEVATIONS 4000 REFERENCE PLANS
- 5000 STRUCTURAL SET-OUT

6000 VERTICAL CIRCULATION

- 7000 INTERIOR DESIGN DETAILS 8000 EXTERIOR & FACADE DETAILS
- 9000 DRAWN SCHEDULES
- 9000 SCHEDULES & SPECIFICATIONS

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No	DATE		REVISIONS	BY
1	29/06/2022	FOR INFORMATION		
2	07/07/2022	FOR INFORMATION		
3	12/07/2022	FOR INFORMATION		RF
4	02/08/2022	FOR CONSULTANT		RF
5	03/08/2022	FOR INFORMATION		RF
6	09/09/2022	FOR INFORMATION		RF
А	15/09/2022	ISSUE FOR DA		

ARCHITECT

DesignInc

Designinc Sydney Pty Ltd Level 14, 85 Castlereagh Street Sydney NSW 2000 Australia +61 2 8905 7100 sydney@designinc.com.au

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PROJECT NARRABEEN EDUCATION PRECINCT NAMONA ST, NORTH NARRABEEN NSW 2101

NARRABEEN SPORTS HIGH SCHOOL

DETAILS DRAWN CHECKED APPROVED

JO RF СМ

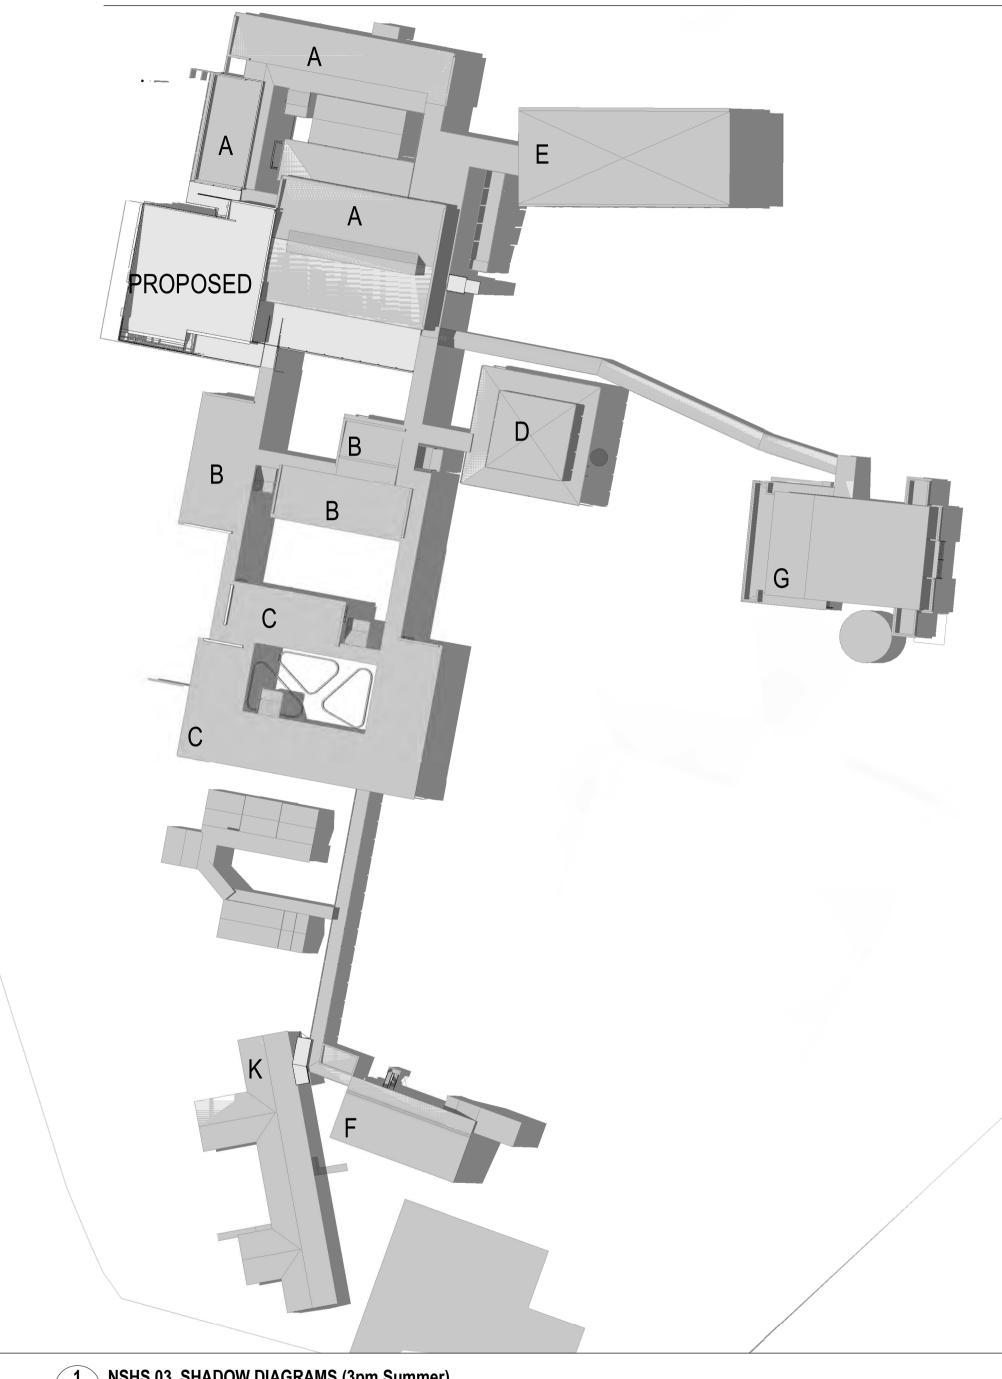
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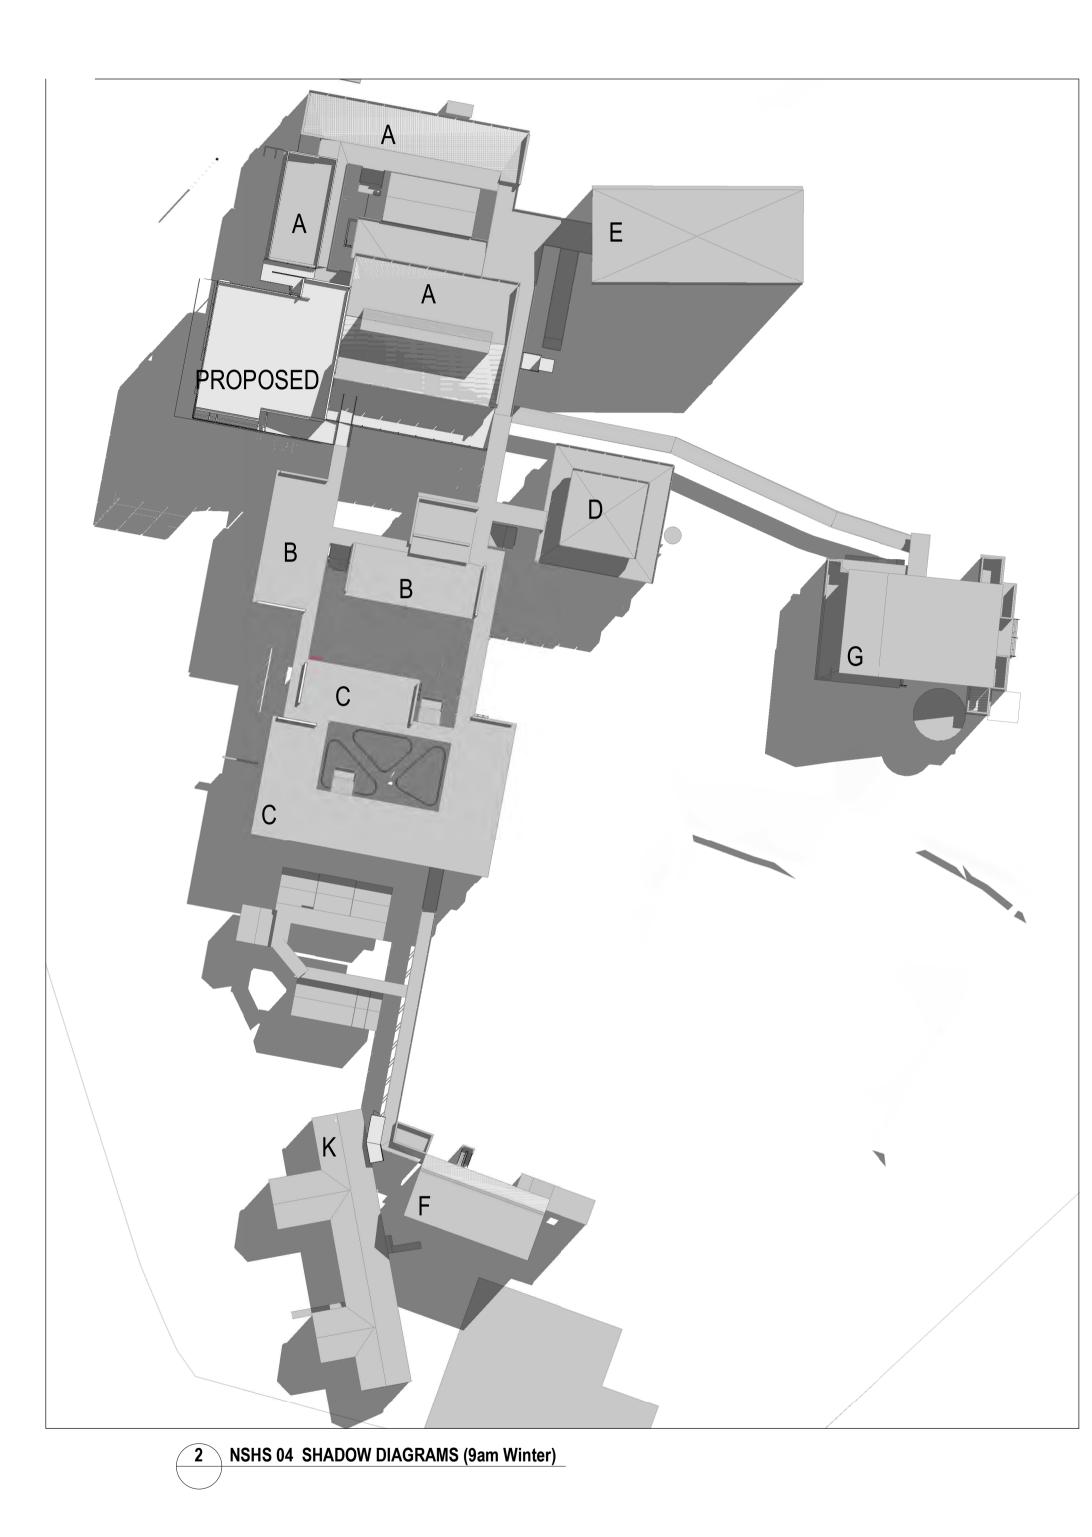
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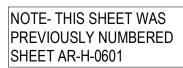
TITLE SHADOW DIAGRAMS

DRAWING NUMBER REVISION AR-H-0350 Α



1 NSHS 03 SHADOW DIAGRAMS (3pm Summer)





0000 - GENERAL & SITE INFORMATION

ARCHITECTURE:

0000 GENERAL & SITE INFORMATION 1000 GENERAL ARRANGEMENT PLANS

2000 GA RCPs	
--------------	--

- 3000 GA SECTIONS & ELEVATIONS
- 4000 REFERENCE PLANS 5000 STRUCTURAL SET-OUT
- 6000 VERTICAL CIRCULATION
- 7000 INTERIOR DESIGN DETAILS
- 8000 EXTERIOR & FACADE DETAILS
- 9000 DRAWN SCHEDULES
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1	12/07/2022	FOR INFORMATION		RF
2	02/08/2022	FOR CONSULTANT		RF
3	03/08/2022	FOR INFORMATION		RF
4	09/09/2022	FOR INFORMATION		RF
А	15/09/2022	ISSUE FOR DA		

ARCHITECT

DesignInc

Designinc Sydney Pty Ltd Level 14, 85 Castlereagh Street Sydney NSW 2000 Australia +61 2 8905 7100 sydney@designinc.com.au

Nominated Architects

Ian Armstrong 7260 | Cathryn Drew-Bredin 7269 | Richard Does 8126 | Mary Anne McGirr 10946 CLIENT





PROJECT NARRABEEN EDUCATION PRECINCT NAMONA ST, NORTH NARRABEEN NSW 2101

NARRABEEN SPORTS HIGH SCHOOL

DETAILS		
DRAWN	JJ	SCALE
CHECKED	RF	
APPROVED	СМ	@ A1

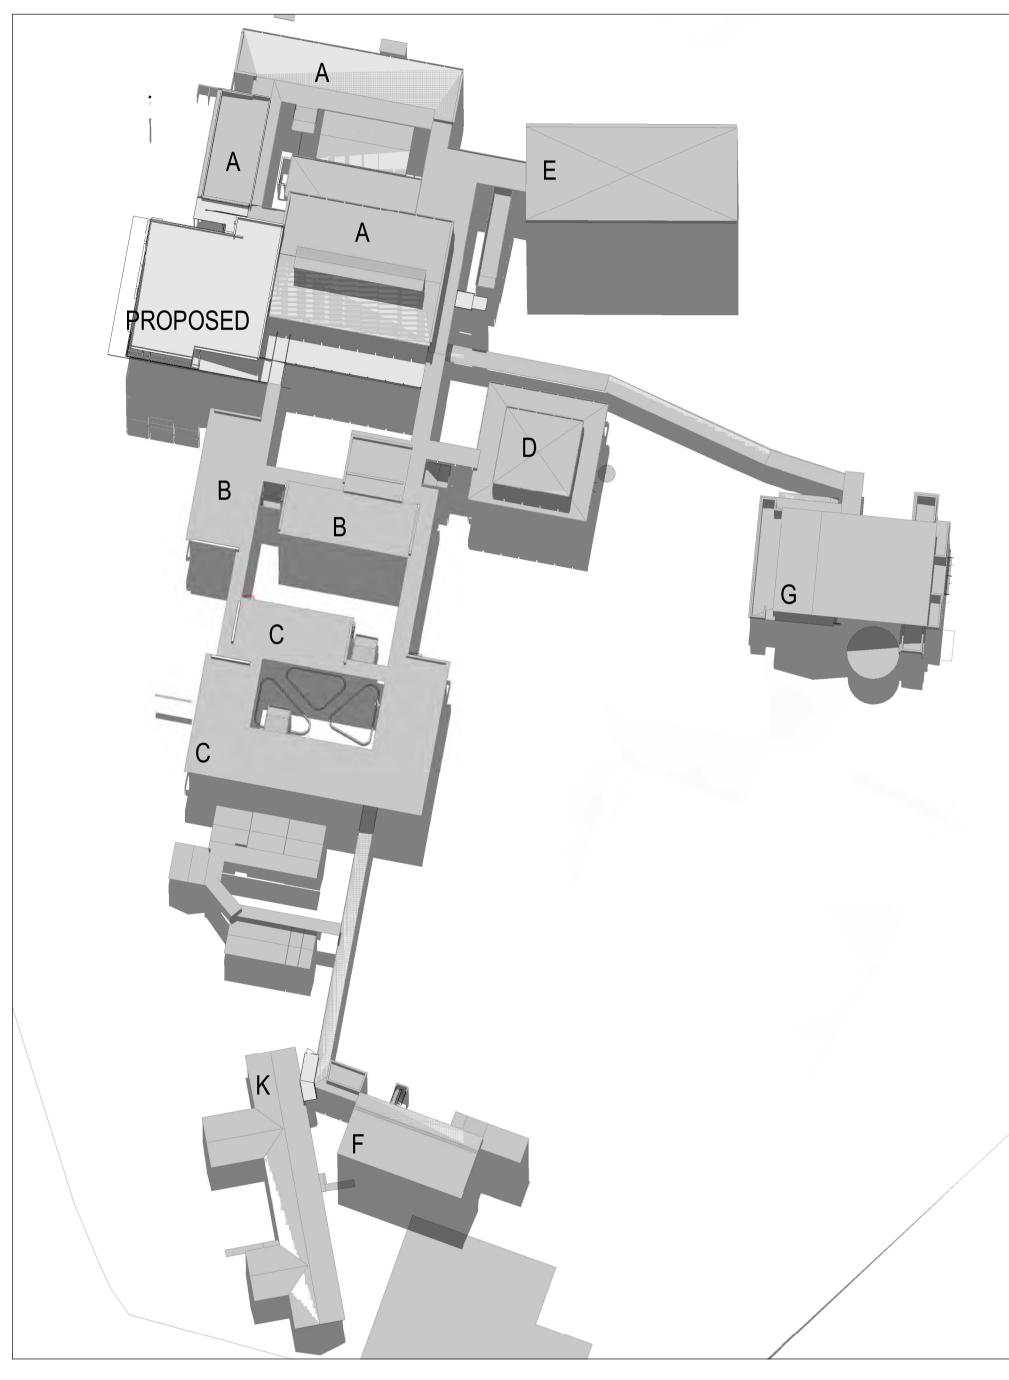


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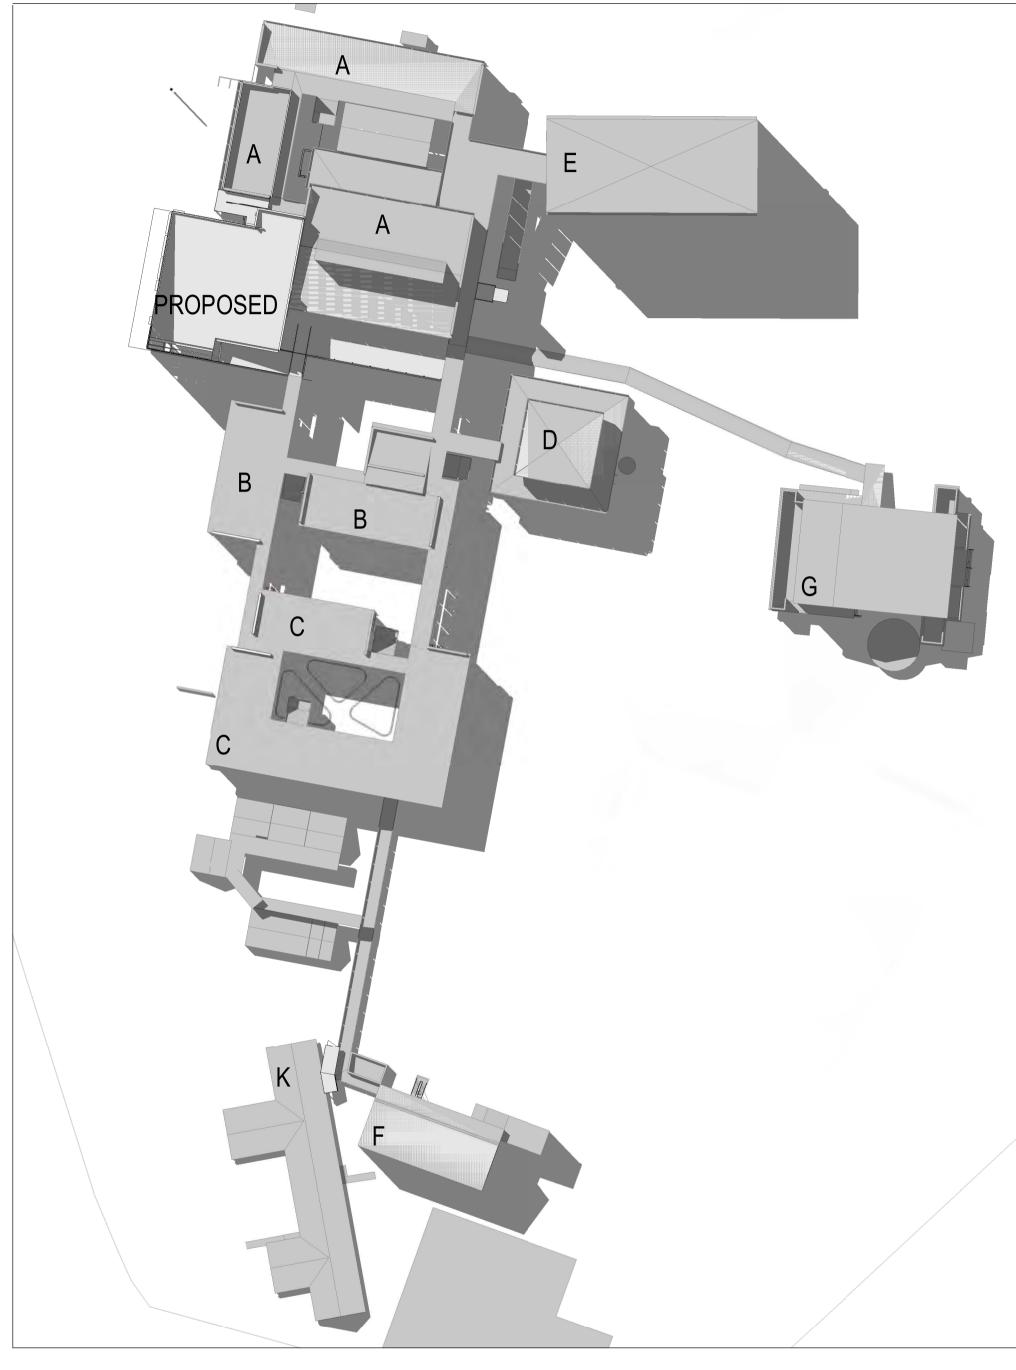
SHADOW DIAGRAMS

DRAWING NUMBER REVISION AR-H-0351 Α

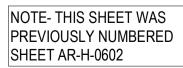
NOTE- THIS SHEET WAS



1 NSHS 05 SHADOW DIAGRAMS (12pm Winter)



2 NSHS 06 SHADOW DIAGRAMS (3pm Winter)



0000 - GENERAL & SITE INFORMATION

ARCHITECTURE:

0000 GENERAL & SITE INFORMATION 1000 GENERAL ARRANGEMENT PLANS

2000 GA RCPs 3000 GA SECTIONS & ELEVATIONS

- 4000 REFERENCE PLANS
- 5000 STRUCTURAL SET-OUT

6000 VERTICAL CIRCULATION 7000 INTERIOR DESIGN DETAILS

8000 EXTERIOR & FACADE DETAILS

9000 DRAWN SCHEDULES

9000 SCHEDULES & SPECIFICATIONS

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No	DATE		REVISIONS	BY
1	12/07/2022	FOR INFORMATION		RF
2	02/08/2022	FOR CONSULTANT		RF
3	03/08/2022	FOR INFORMATION		RF
4	09/09/2022	FOR INFORMATION		RF
А	15/09/2022	ISSUE FOR DA		

ARCHITECT

DesignInc

Designinc Sydney Pty Ltd Level 14, 85 Castlereagh Street Sydney NSW 2000 Australia +61 2 8905 7100 sydney@designinc.com.au

Nominated Architects

Ian Armstrong 7260 | Cathryn Drew-Bredin 7269 | Richard Does 8126 | Mary Anne McGirr 10946 CLIENT





PROJECT NARRABEEN EDUCATION PRECINCT NAMONA ST, NORTH NARRABEEN NSW 2101

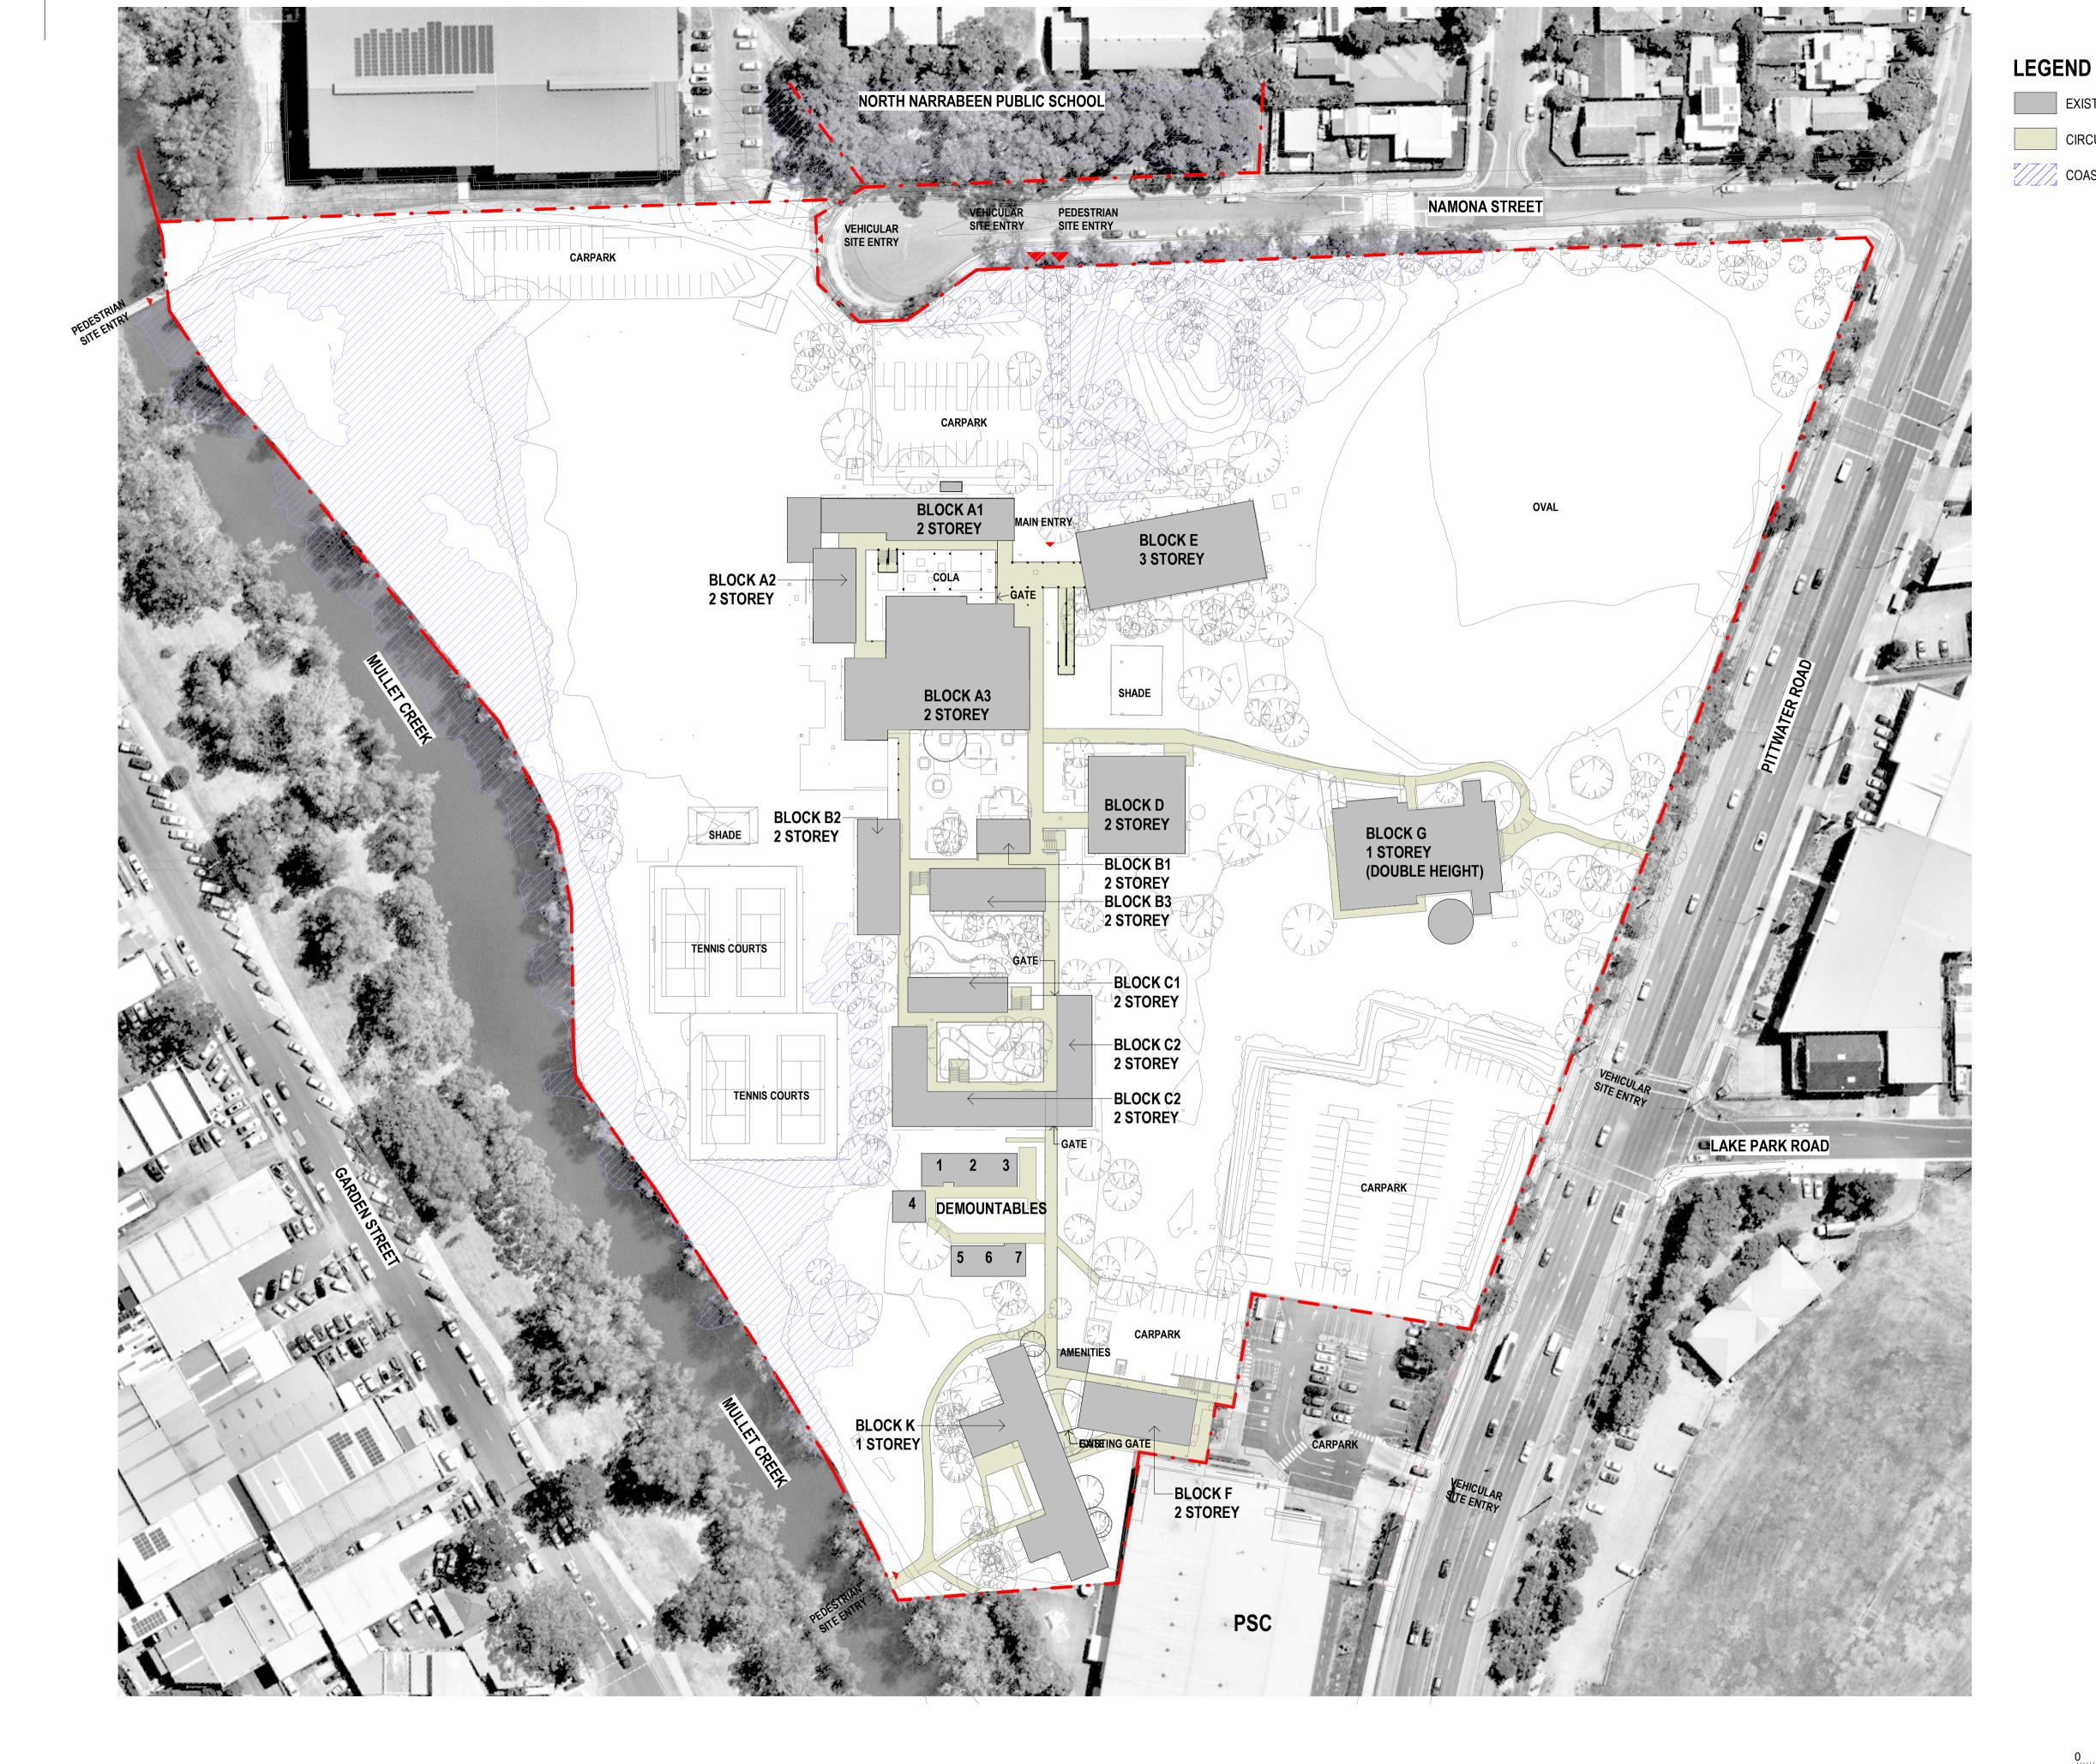
NARRABEEN SPORTS HIGH SCHOOL

DETAILS DRAWN SCALE JJ CHECKED RF @ A1 APPROVED СМ



TITLE SHADOW DIAGRAMS

DRAWING NUMBER REVISION AR-H-0352 Α



- EXISTING BUILDING
- CIRCULATION
- COASTAL WETLANDS ZONE

0000 - GENERAL & SITE INFORMATION

- ARCHITECTURE: 0000 GENERAL & SITE INFORMATION 1000 GENERAL ARRANGEMENT PLANS 2000 GA RCPs 3000 GA SECTIONS & ELEVATIONS 4000 REFERENCE PLANS 5000 STRUCTURAL SET-OUT 6000 VERTICAL CIRCULATION 7000 INTERIOR DESIGN DETAILS 8000 EXTERIOR & FACADE DETAILS
- 9000 DRAWN SCHEDULES 9000 SCHEDULES & SPECIFICATIONS

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No	DATE	REVISIONS	BY
1	26/05/2022	SCHEMATIC DESIGN - DRAFT	JO
2	08/06/2022	PRE-DA - DRAFT	JO
3	29/06/2022	FOR INFORMATION	
4	07/07/2022	FOR INFORMATION	
5	12/07/2022	FOR INFORMATION	RF
6	02/08/2022	FOR CONSULTANT	RF
7	03/08/2022	FOR INFORMATION	RF
8	09/09/2022	FOR INFORMATION	RF
А	15/09/2022	ISSUE FOR DA	

ARCHITECT				
Des	i(jn	n	C

Designinc Sydney Pty Ltd Level 14, 85 Castlereagh Street Sydney NSW 2000 Australia +61 2 8905 7100 sydney@designinc.com.au

Nominated Architects

lan Armstrong 7260 | Cathryn Drew-Bredin 7269 | Richard Does 8126 | Mary Anne McGirr 10946 CLIENT



NARRABEEN EDUCATION PRECINCT NAMONA ST, NORTH NARRABEEN NSW 2101

NARRABEEN SPORTS HIGH SCHOOL

DETAILS DRAWN CHECKED APPROVED

PROJECT

VB, JJ RF СМ

SCALE 1:750 @ A1



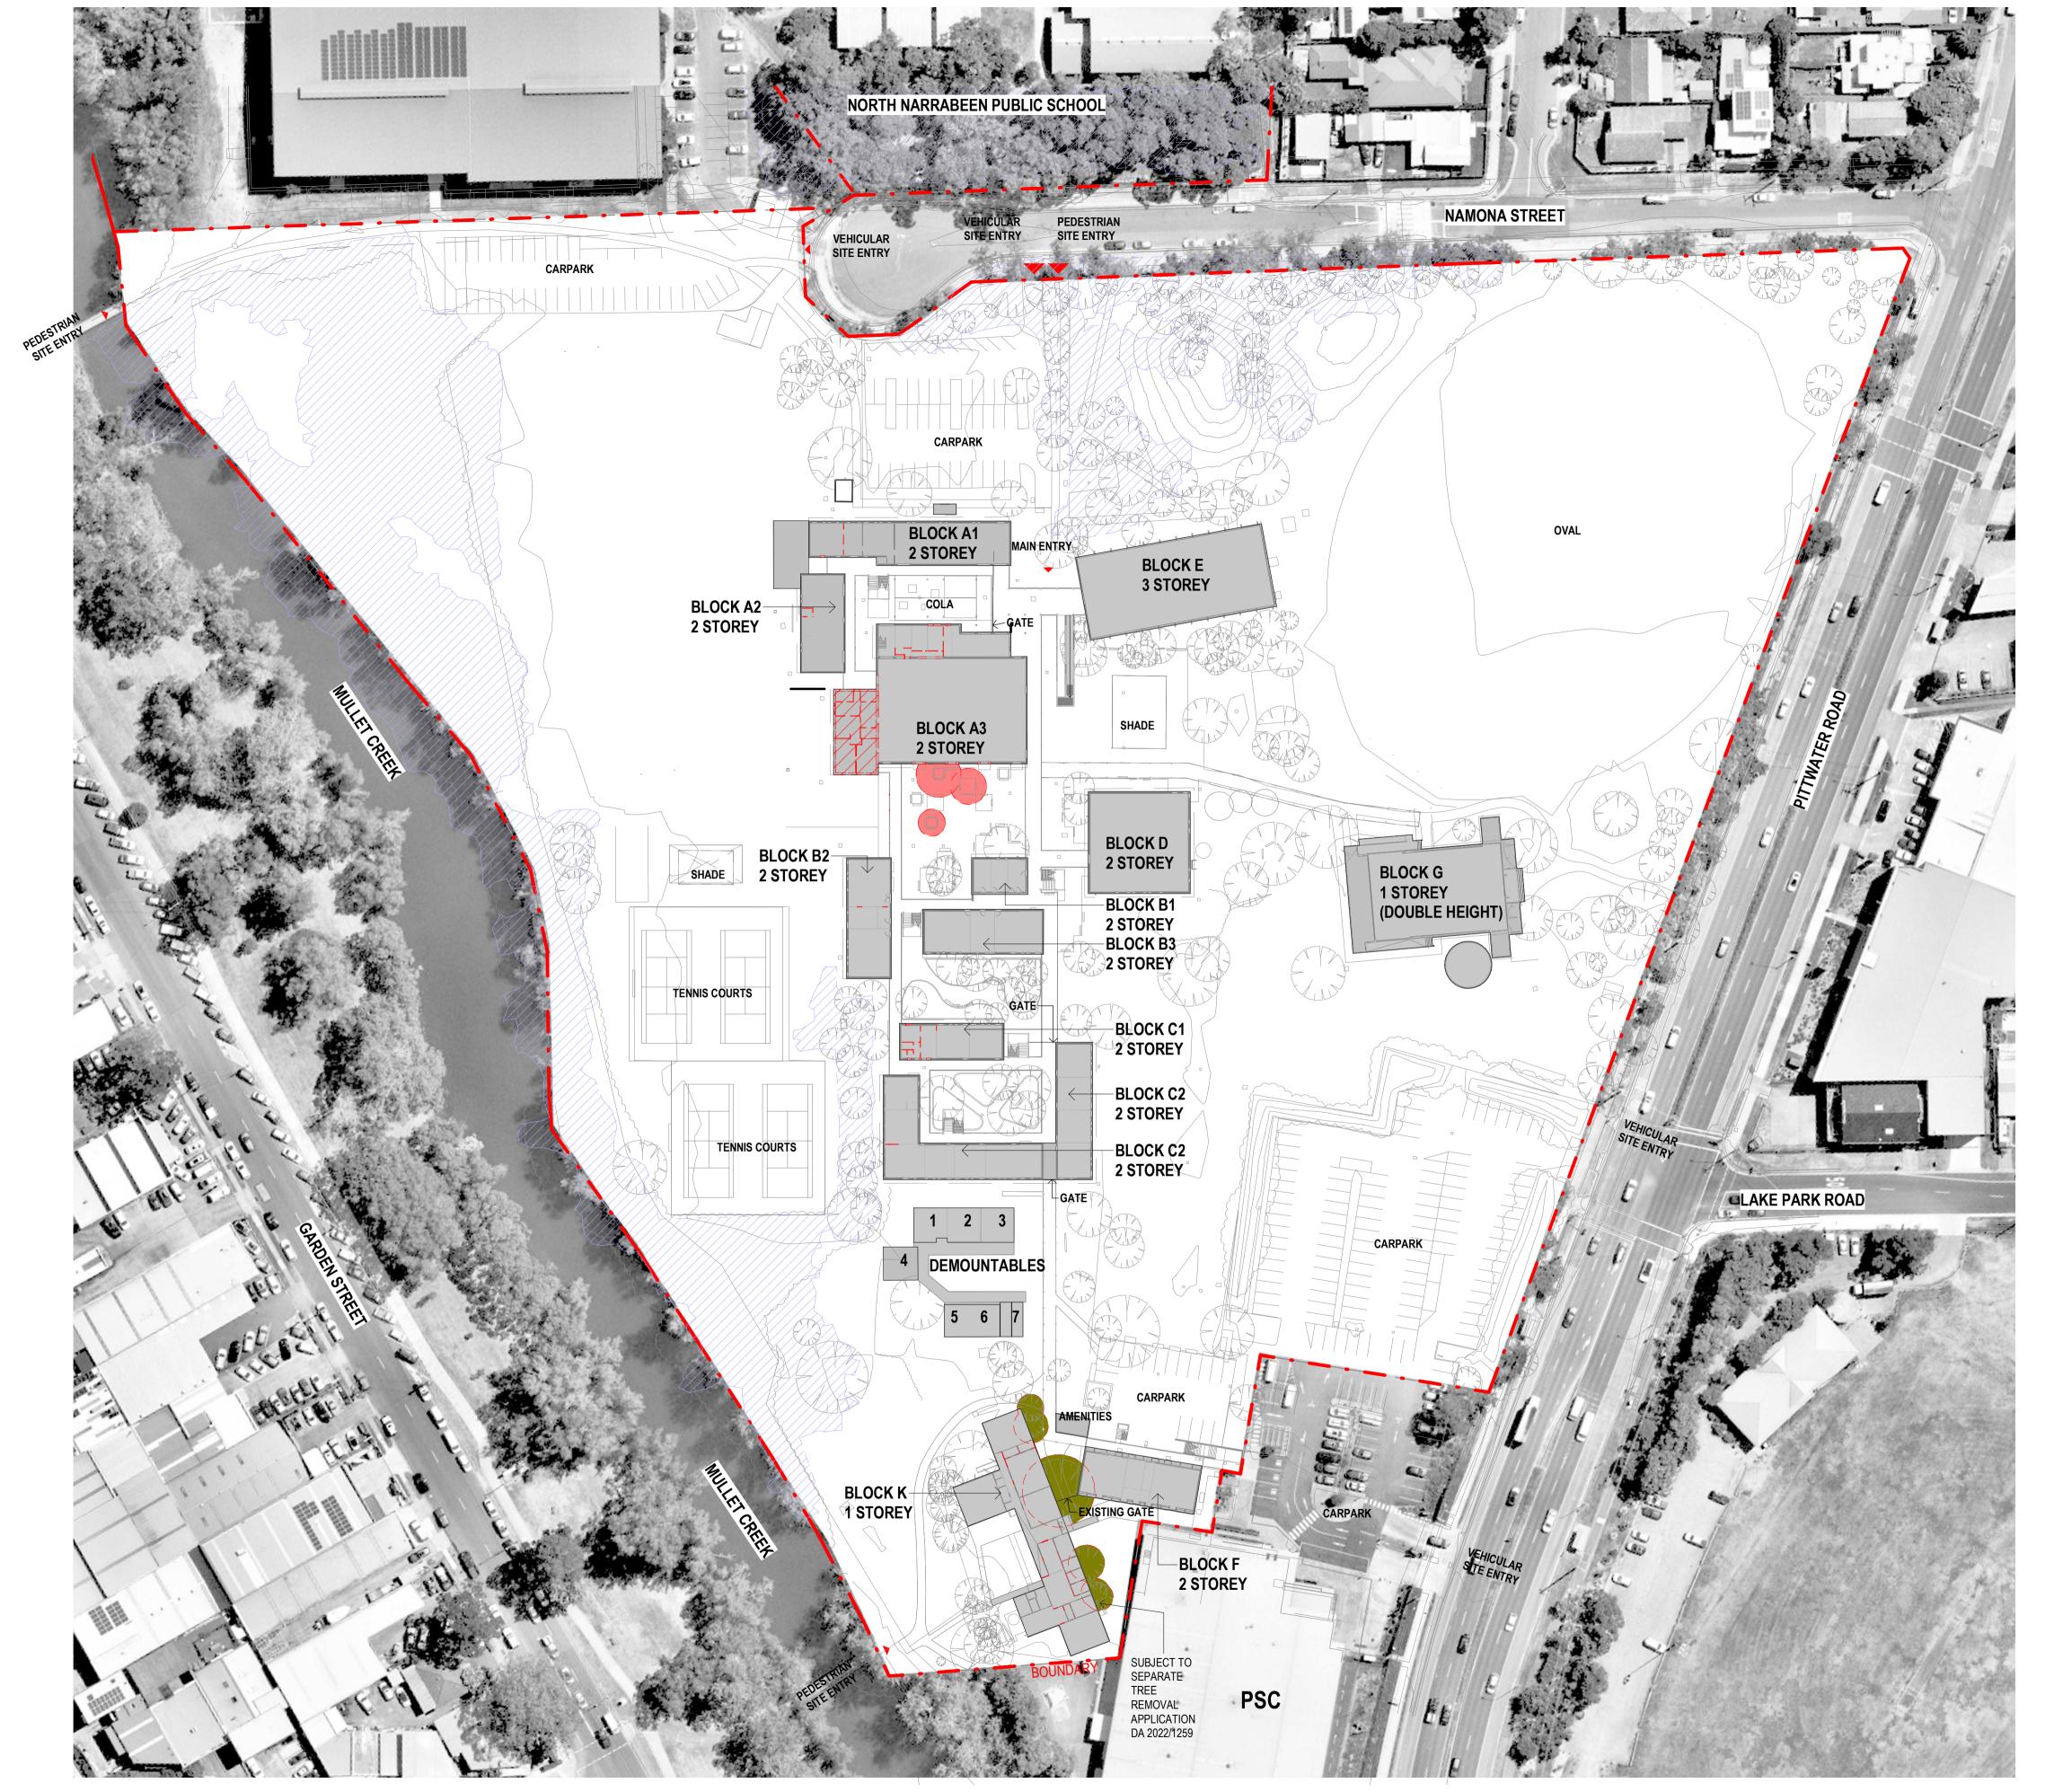
TITLE

EXISTING SITE PLAN

7.5 15 22.5 30 37.5 SCALE BAR - 1:750

> DRAWING NUMBER AR-H-0510





DEMOLISHED/ REMOVED WALL

DEMOLISHED/ REMOVED BUILDING

- COASTAL WETLANDS ZONE
- EXISTING BUILDING

0000 - GENERAL & SITE INFORMATION

ARCHITECTURE:

- 0000 GENERAL & SITE INFORMATION 1000 GENERAL ARRANGEMENT PLANS
- 2000 GA RCPs
- 3000 GA SECTIONS & ELEVATIONS
- 4000 REFERENCE PLANS
- 5000 STRUCTURAL SET-OUT
- 6000 VERTICAL CIRCULATION
- 7000 INTERIOR DESIGN DETAILS
- 8000 EXTERIOR & FACADE DETAILS 9000 DRAWN SCHEDULES
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No	DATE		REVISIONS	BY
1	07/07/2022	FOR INFORMATION		
2	12/07/2022	FOR INFORMATION		RF
3	18/07/2022	FOR INFORMATION		RF
4	02/08/2022	FOR CONSULTANT		RF
5	03/08/2022	FOR INFORMATION		RF
6	09/09/2022	FOR INFORMATION		RF
А	15/09/2022	ISSUE FOR DA		



Designinc Sydney Pty Ltd Level 14, 85 Castlereagh Street Sydney NSW 2000 Australia +61 2 8905 7100 sydney@designinc.com.au

Nominated Architects

lan Armstrong 7260 | Cathryn Drew-Bredin 7269 | Richard Does 8126 | Mary Anne McGirr 10946 CLIENT



NARRABEEN EDUCATION PRECINCT NAMONA ST, NORTH NARRABEEN NSW 2101

NARRABEEN SPORTS HIGH SCHOOL

DETAILS DRAWN CHECKED APPROVED

PROJECT

VB, JJ RF СМ

SCALE 1:750 @ A1



TITLE

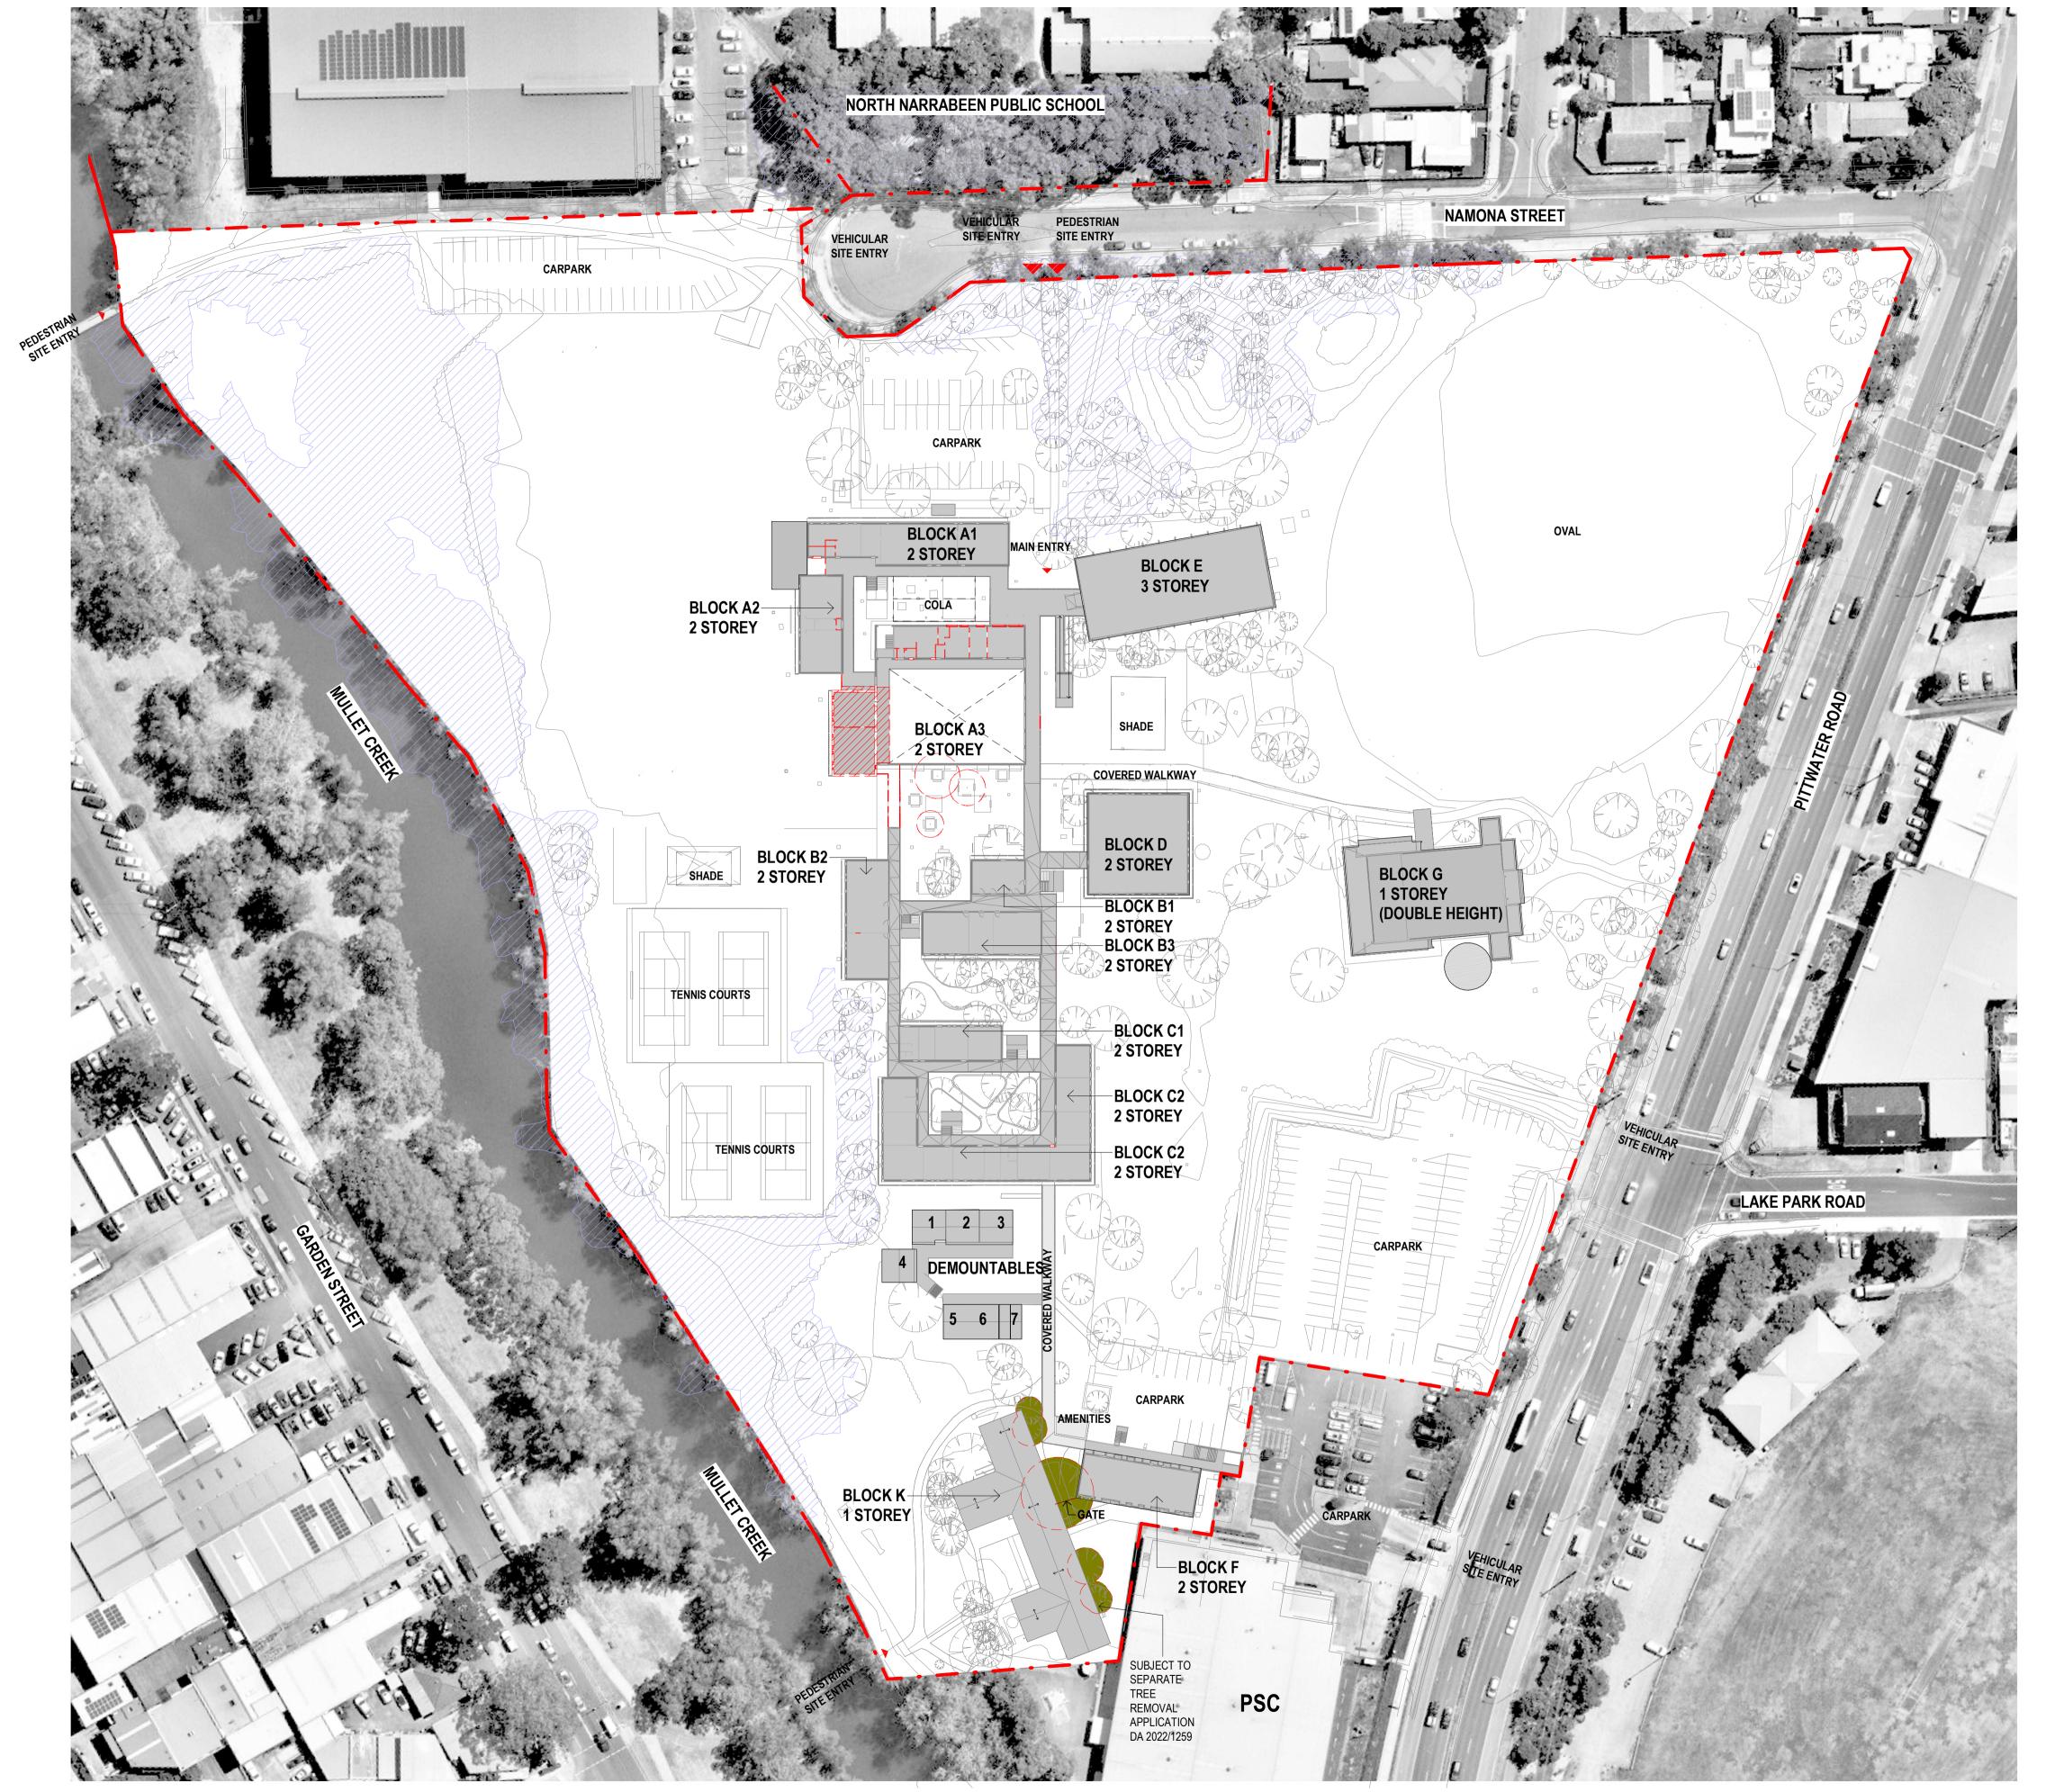
DEMOLITION SITE PLAN - GROUND FLOOR

7.5 15 22.5 30 37.5 SCALE BAR - 1:750

DRAWING NUMBER

AR-H-0512

REVISION



DEMOLISHED/ REMOVED WALL

DEMOLISHED/ REMOVED BUILDING

- COASTAL WETLANDS ZONE
- EXISTING BUILDING

0000 - GENERAL & SITE INFORMATION

ARCHITECTURE:

- 0000 GENERAL & SITE INFORMATION 1000 GENERAL ARRANGEMENT PLANS
- 2000 GA RCPs
- 3000 GA SECTIONS & ELEVATIONS
- 4000 REFERENCE PLANS
- 5000 STRUCTURAL SET-OUT
- 6000 VERTICAL CIRCULATION
- 7000 INTERIOR DESIGN DETAILS
- 8000 EXTERIOR & FACADE DETAILS 9000 DRAWN SCHEDULES
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2	12/07/2022	FOR INFORMATION		RF
3	18/07/2022	FOR INFORMATION		RF
4	02/08/2022	FOR CONSULTANT		RF
5	03/08/2022	FOR INFORMATION		RF
6	09/09/2022	FOR INFORMATION		RF
А	15/09/2022	ISSUE FOR DA		



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PROJECT NARRABEEN EDUCATION PRECINCT NAMONA ST, NORTH NARRABEEN NSW 2101

NARRABEEN SPORTS HIGH SCHOOL

DETAILS DRAWN CHECKED APPROVED

VB, JJ RF СМ

SCALE 1:750 @ A1



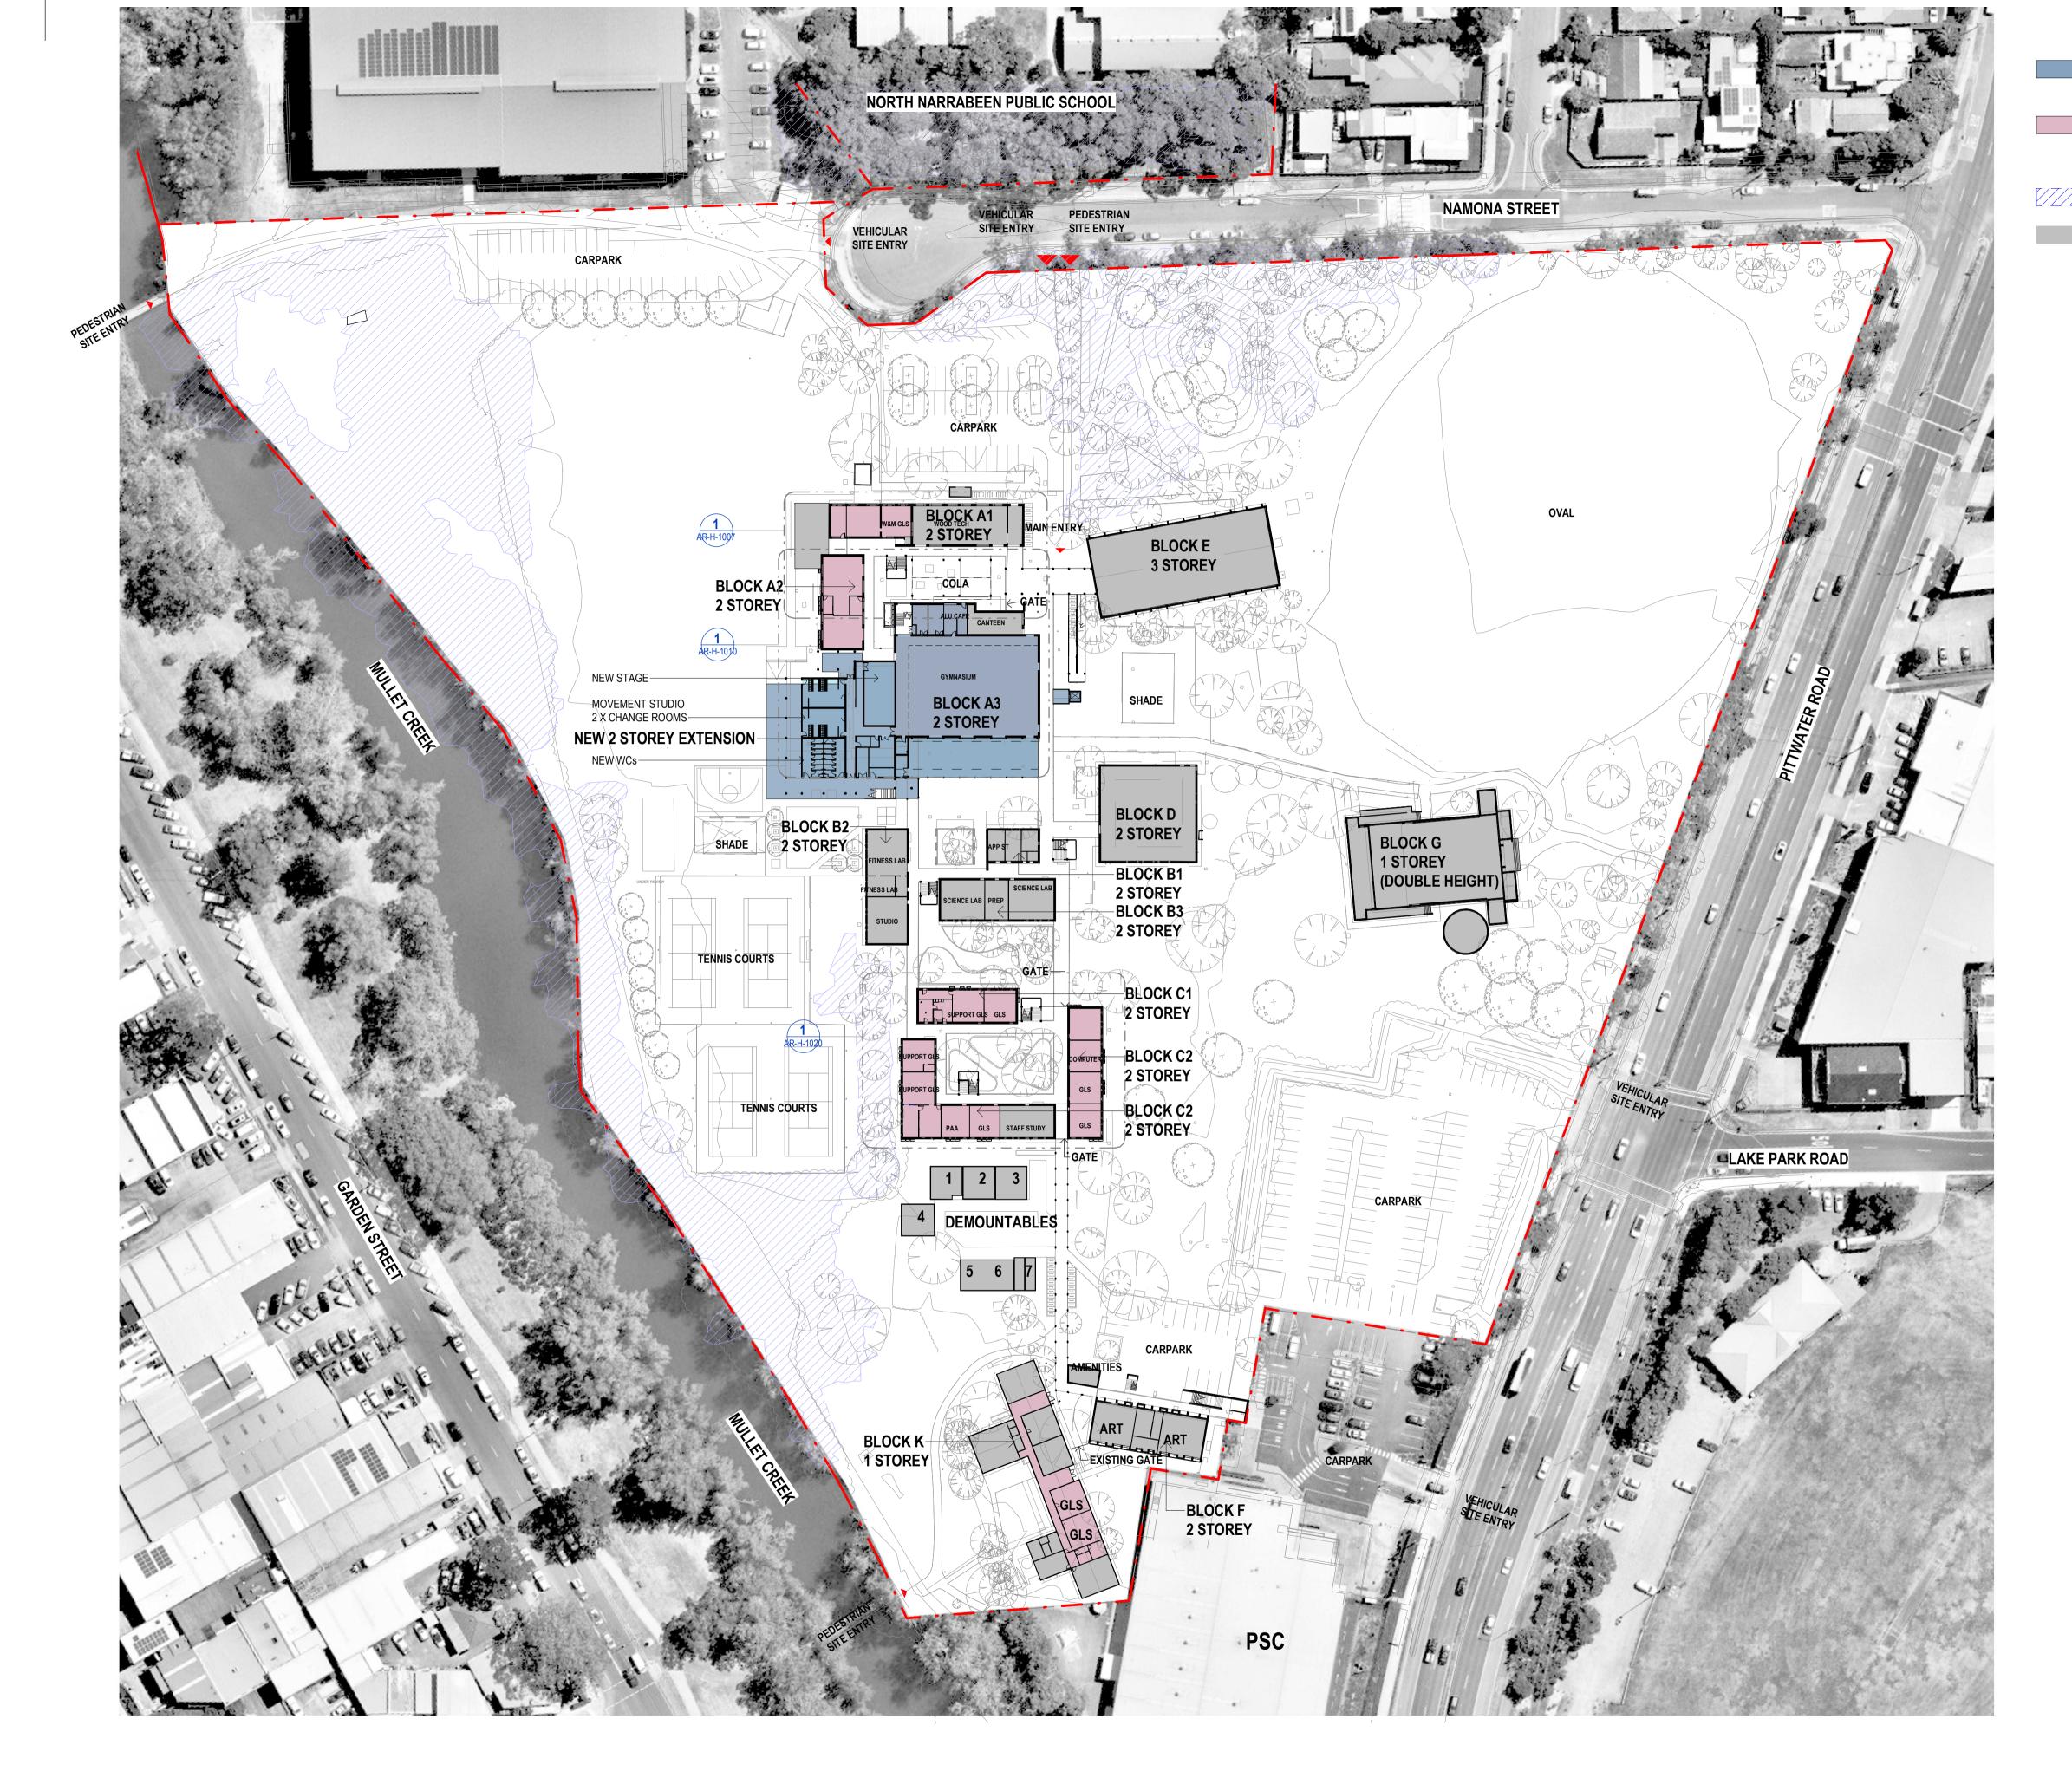
TITLE

DEMOLITION SITE PLAN - LEVEL 1

7.5 15 22.5 30 37.5 SCALE BAR - 1:750

> DRAWING NUMBER AR-H-0513





DEVELOPMENT APPLICATION

- DEVELOPMENT WITHOUT CONSENT
- (SEPARATE APPLICATION)
- COASTAL WETLANDS ZONE
- OUT OF SCOPE

0000 - GENERAL & SITE INFORMATION

ARCHITECTURE:

- 0000 GENERAL & SITE INFORMATION 1000 GENERAL ARRANGEMENT PLANS 2000 GA RCPs 3000 GA SECTIONS & ELEVATIONS 4000 REFERENCE PLANS 5000 STRUCTURAL SET-OUT 6000 VERTICAL CIRCULATION 7000 INTERIOR DESIGN DETAILS 8000 EXTERIOR & FACADE DETAILS
- 9000 DRAWN SCHEDULES
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- No DATE 02/09/2022 FOR REVIEW 2 09/09/2022 FOR INFORMATION
- A 15/09/2022 ISSUE FOR DA

ARCHITECT DesignInc

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Nominated Architects

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NARRABEEN EDUCATION PRECINCT NAMONA ST, NORTH NARRABEEN NSW 2101

NARRABEEN SPORTS HIGH SCHOOL

DETAILS DRAWN CHECKED APPROVED

PROJECT

СМ

SCALE 1:750 @ A1



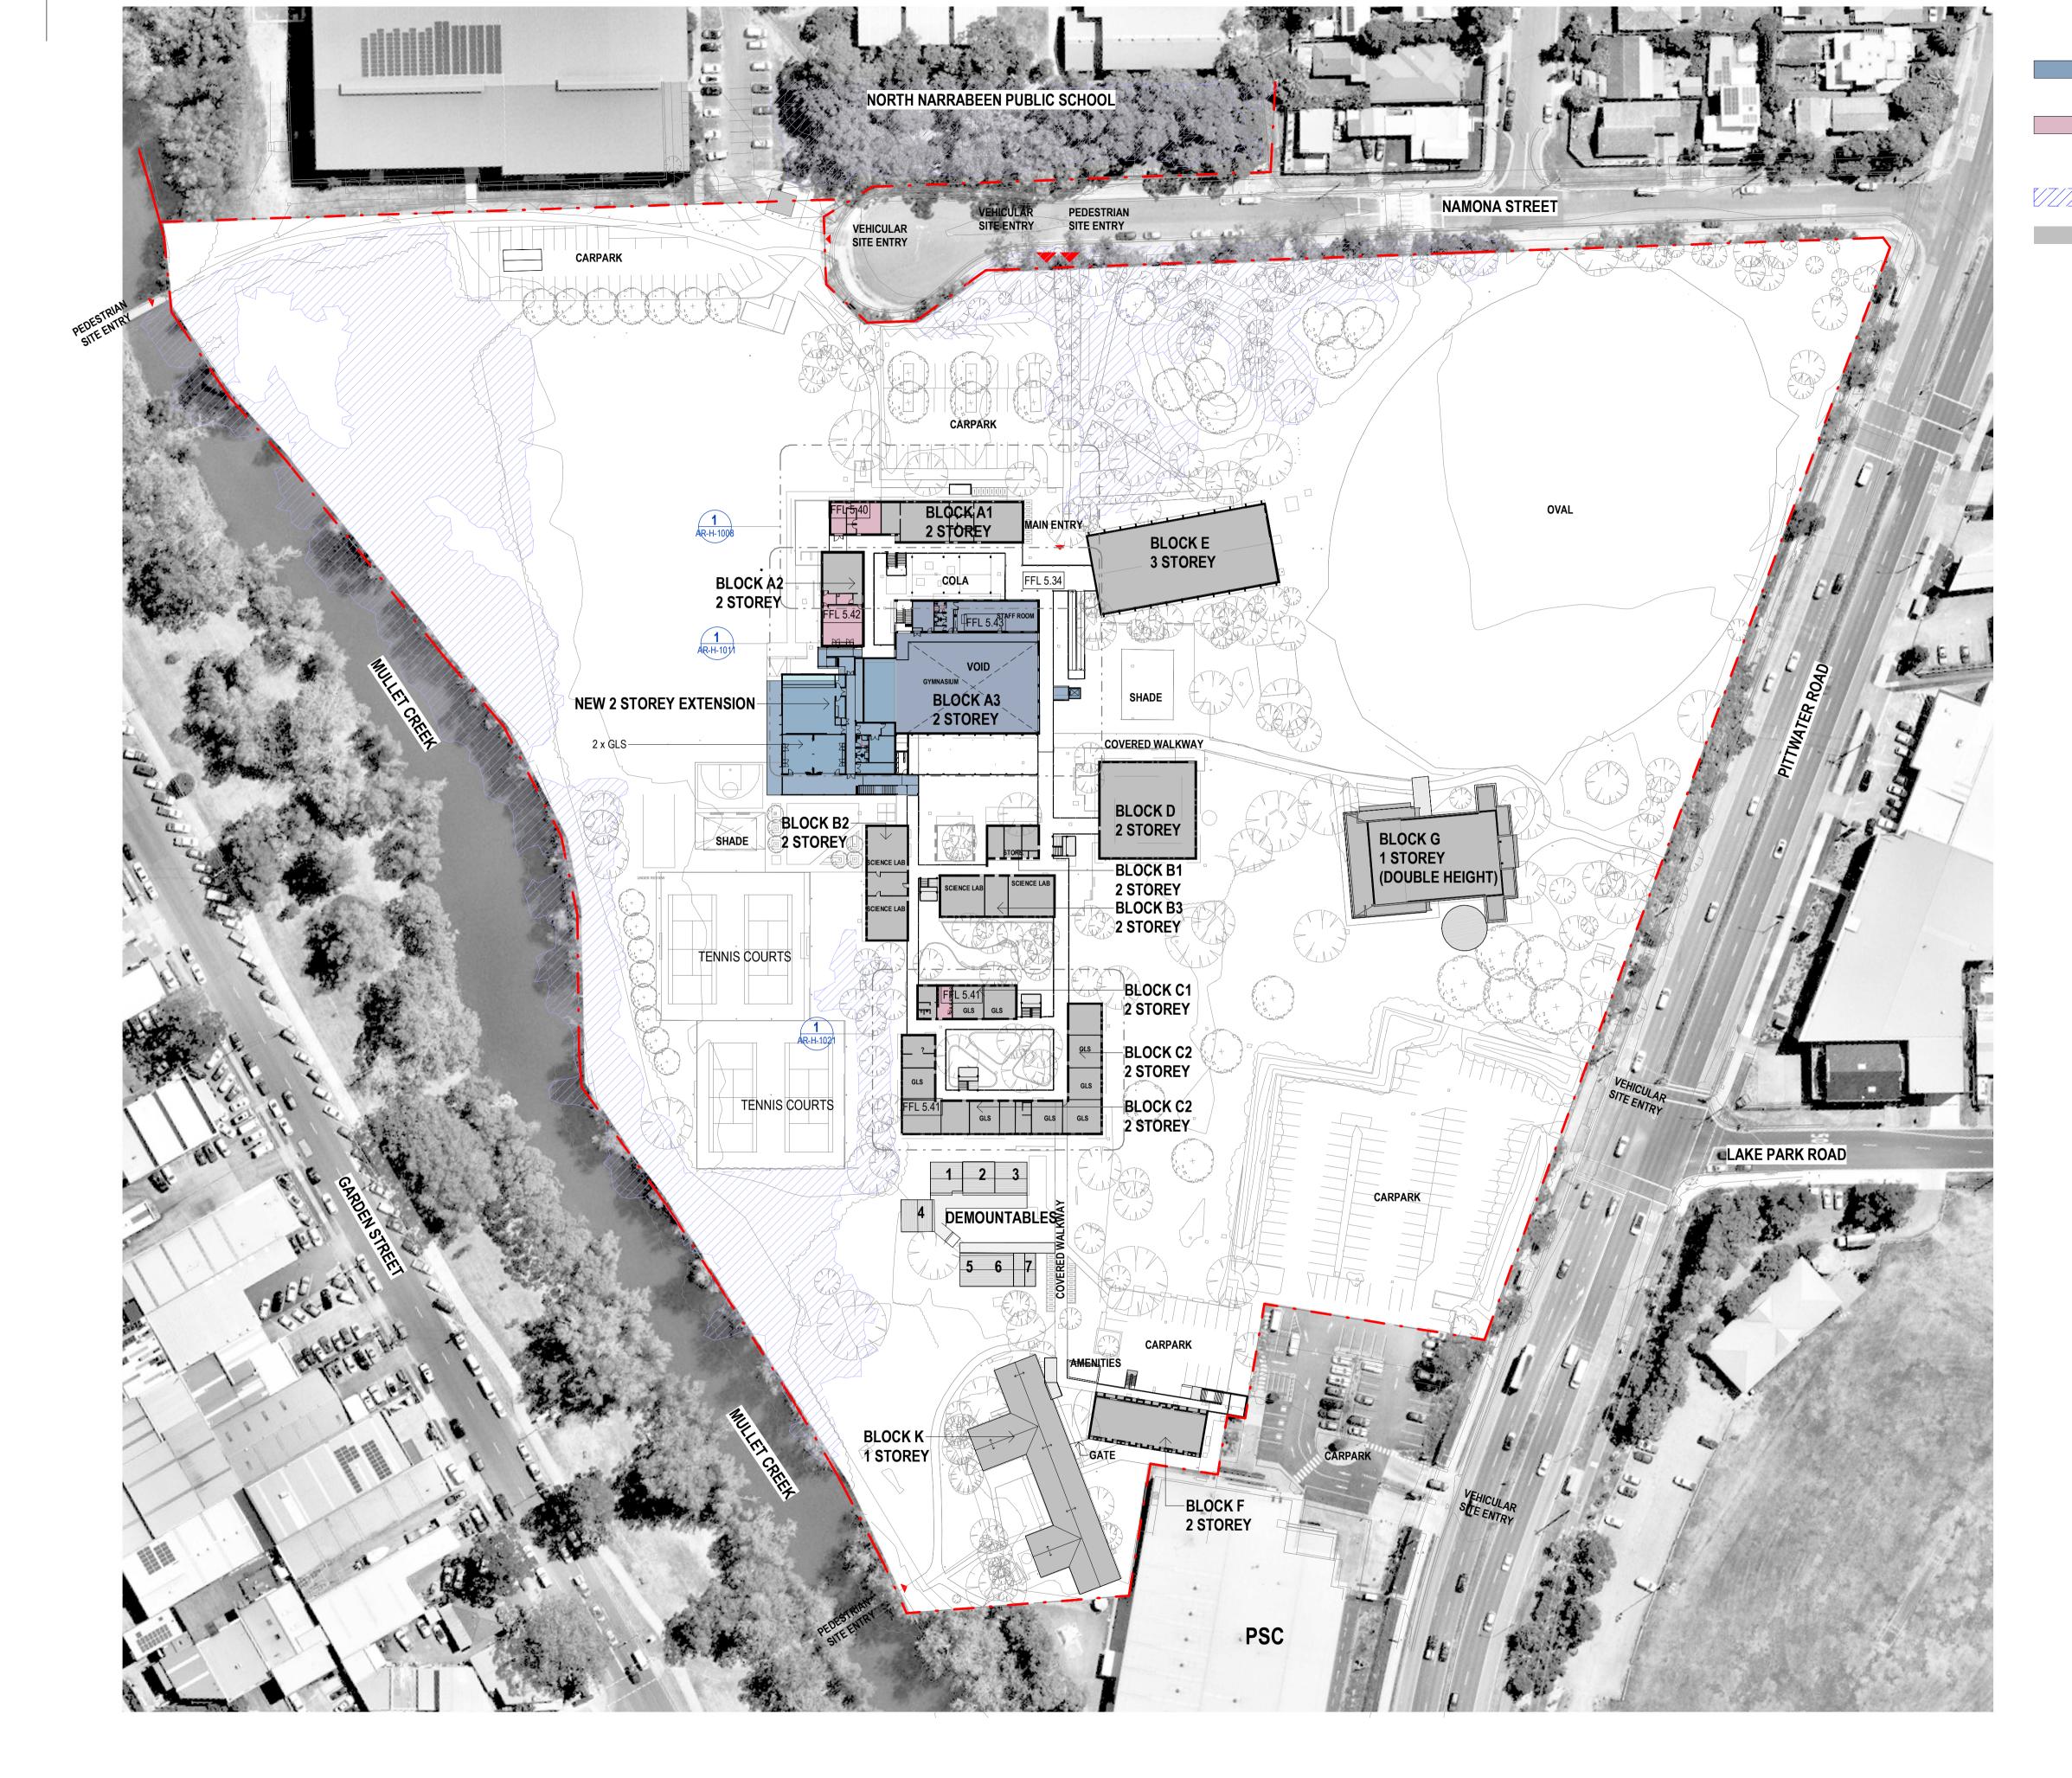
TITLE

PROPOSED SITE PLAN - GROUND FLOOR

7.5 15 22.5 30 37.5 SCALE BAR - 1:750

DRAWING NUMBER AR-H-0521

REVISION



DEVELOPMENT APPLICATION

DEVELOPMENT WITHOUT CONSENT (SEPARATE APPLICATION)

COASTAL WETLANDS ZONE

OUT OF SCOPE

0000 - GENERAL & SITE INFORMATION

ARCHITECTURE:

- 0000 GENERAL & SITE INFORMATION
- 1000 GENERAL ARRANGEMENT PLANS
- 2000 GA RCPs3000 GA SECTIONS & ELEVATIONS
- 4000 REFERENCE PLANS
- 5000 STRUCTURAL SET-OUT
- 6000 VERTICAL CIRCULATION
- 7000 INTERIOR DESIGN DETAILS8000 EXTERIOR & FACADE DETAILS
- 9000 DRAWN SCHEDULES
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 No
 DATE
 REVISIONS

 1
 02/09/2022
 FOR REVIEW

 2
 09/09/2022
 FOR INFORMATION

2 09/09/2022 FOR INFORMATION A 15/09/2022 ISSUE FOR DA RF RF



Designinc Sydney Pty Ltd Level 14, 85 Castlereagh Street Sydney NSW 2000 Australia +61 2 8905 7100 sydney@designinc.com.au

Nominated Architects Ian Armstrong 7260 | Cathryn Drew-Bredin 7269 | Richard Does 8126 | Mary Anne McGirr 10946



PROJECT



NARRABEEN EDUCATION PRECINCT NAMONA ST, NORTH NARRABEEN NSW 2101

NARRABEEN SPORTS HIGH SCHOOL

DETAILS	
DRAWN	VE
CHECKED	RF
APPROVED	CN

SCALE 1:750 @ A1



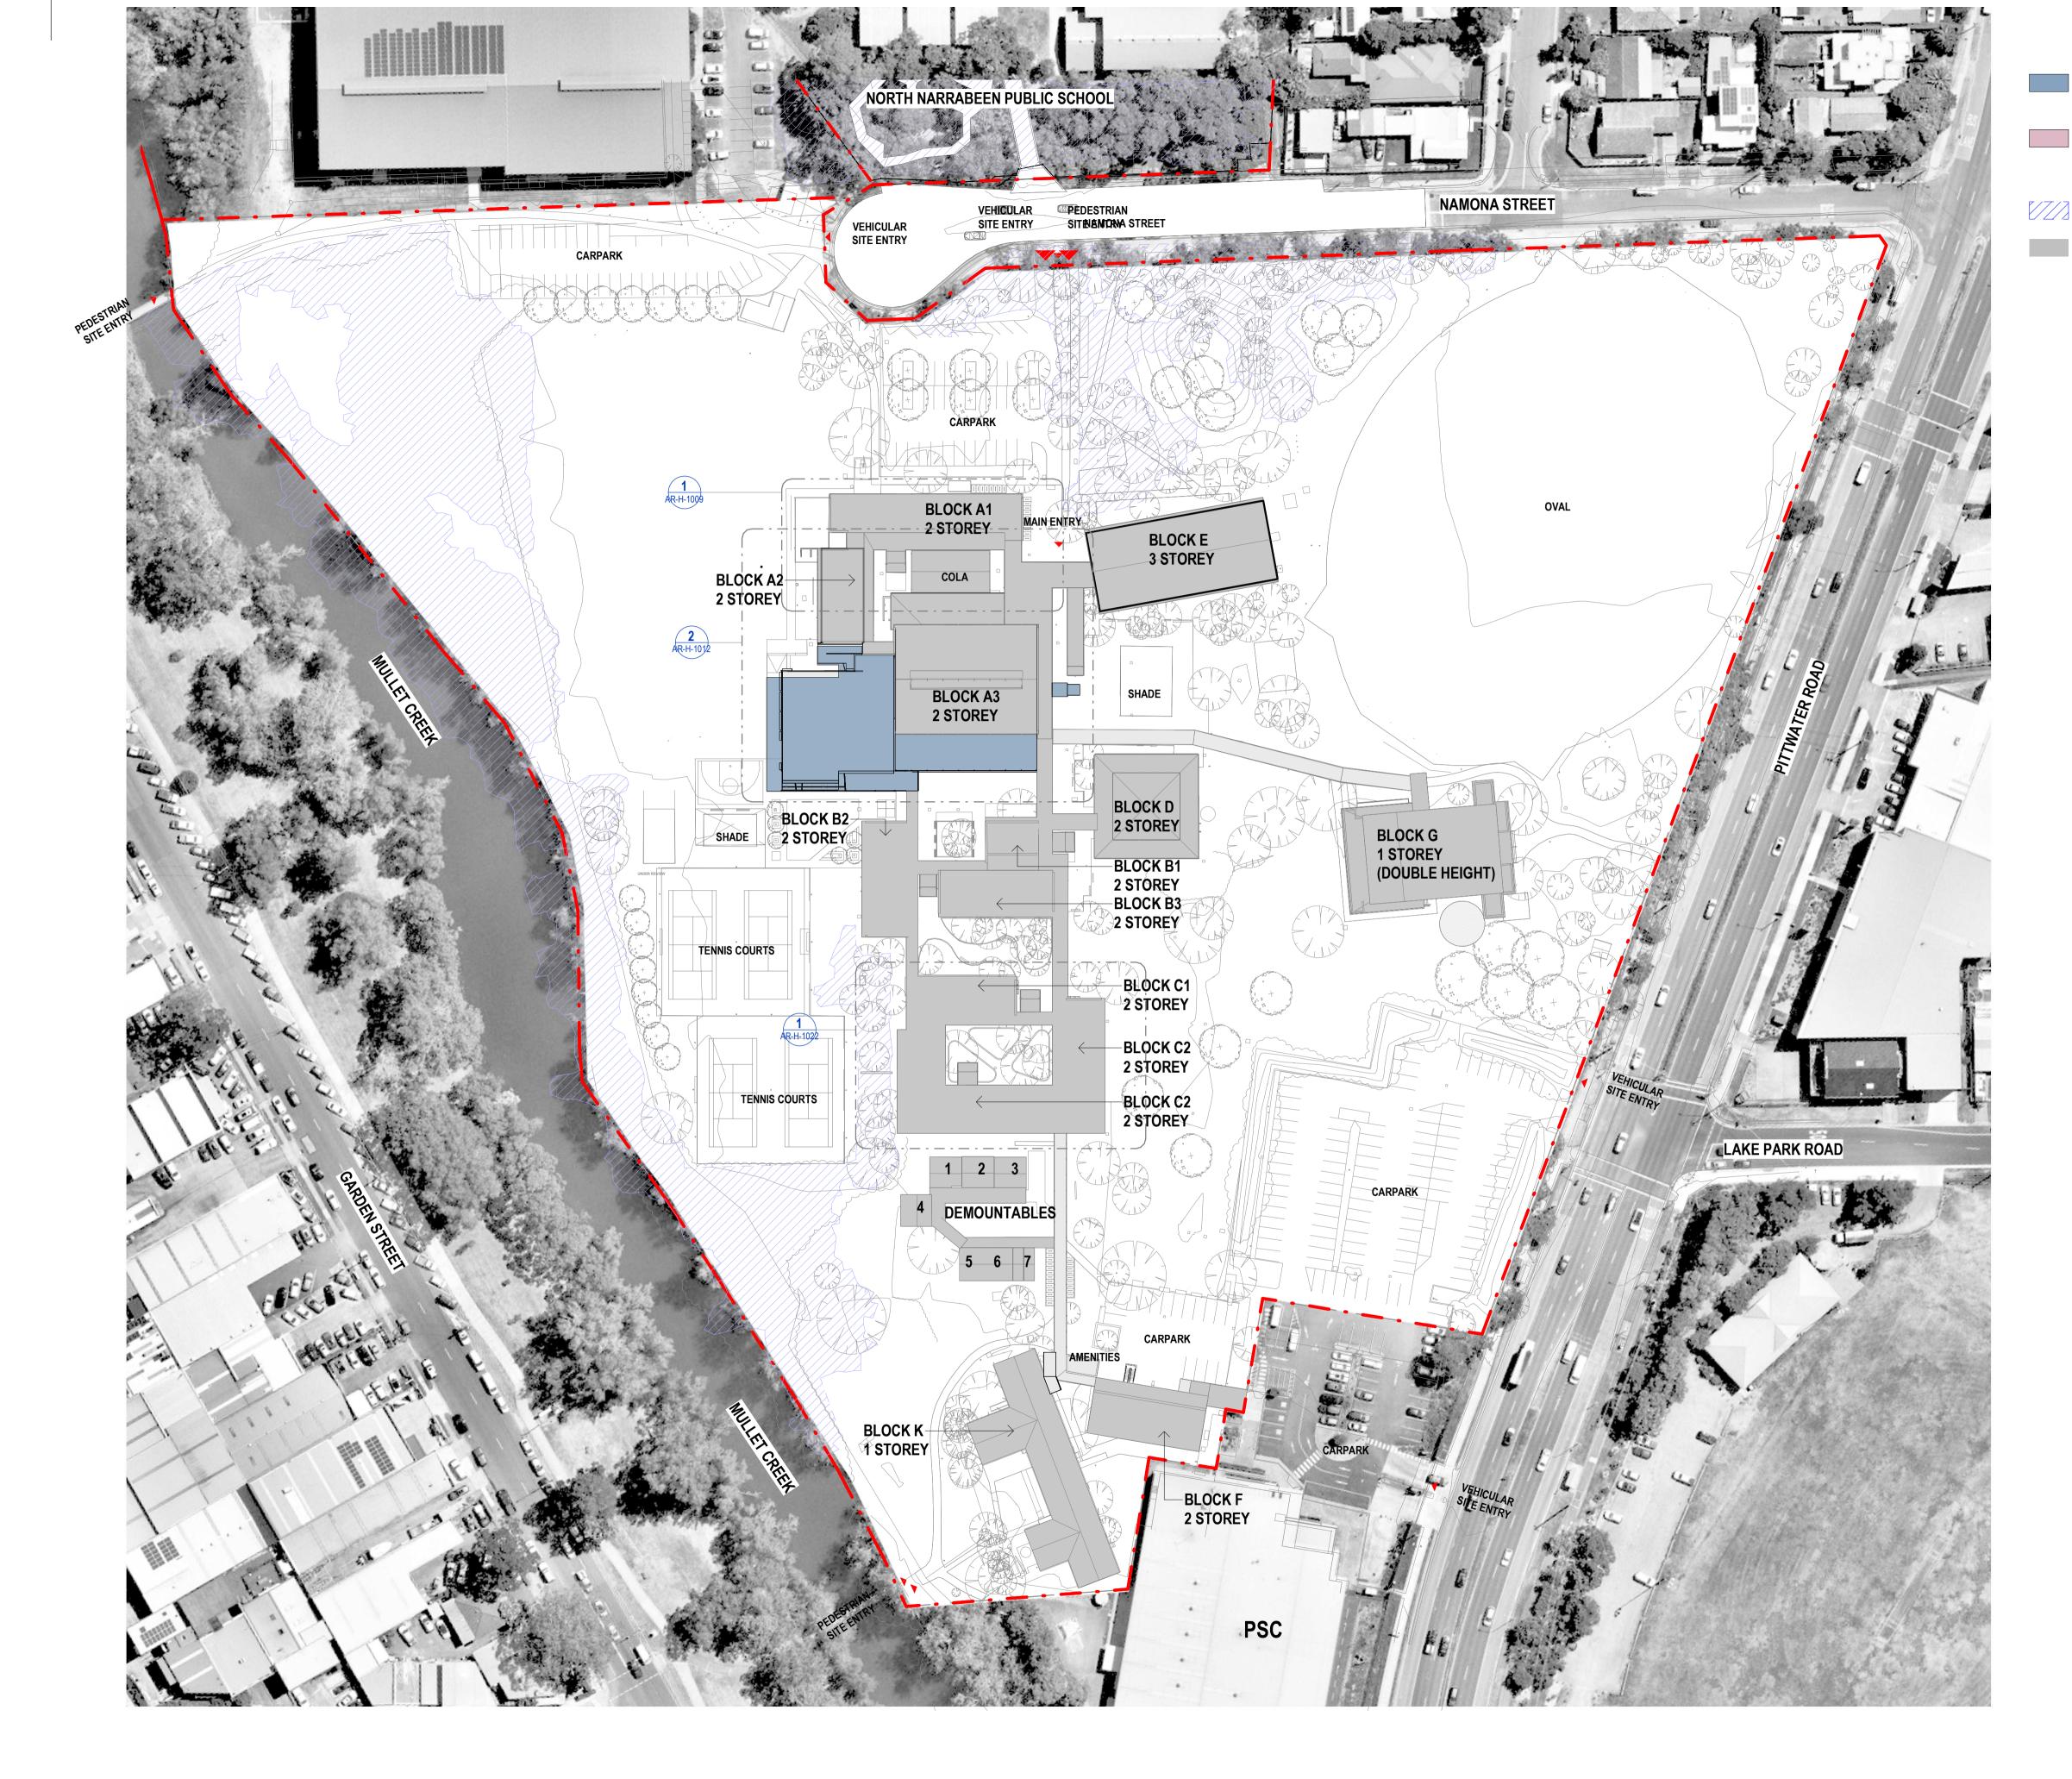
TITLE

PROPOSED SITE PLAN-LEVEL 1 PLAN

0 7.5 15 22.5 30 37.5 SCALE BAR - 1:750

DRAWING NUMBER





DEVELOPMENT APPLICATION

DEVELOPMENT
DEVELOPMENT WITHOUT CONSENT
(SEPARATE APPLICATION)

COASTAL WETLANDS ZONE

OUT OF SCOPE

0000 - GENERAL & SITE INFORMATION

ARCH	ITECTURE:
0000	GENERAL & SITE INFORMATION
1000	GENERAL ARRANGEMENT PLANS
2000	GA RCPs
3000	GA SECTIONS & ELEVATIONS
4000	REFERENCE PLANS
5000	STRUCTURAL SET-OUT
6000	VERTICAL CIRCULATION
7000	INTERIOR DESIGN DETAILS
8000	EXTERIOR & FACADE DETAILS
9000	DRAWN SCHEDULES
0000	

9000 SCHEDULES & SPECIFICATIONS

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Nominated Architects

ARCHITECT

Ian Armstrong 7260 | Cathryn Drew-Bredin 7269 | Richard Does 8126 | Mary Anne McGirr 10946 CLIENT



Education

PROJECT NARRABEEN EDUCATION PRECINCT NAMONA ST, NORTH NARRABEEN NSW 2101

NARRABEEN SPORTS HIGH SCHOOL

DETAILS DRAWN CHECKED APPROVED

СМ

SCALE 1:750 @ A1



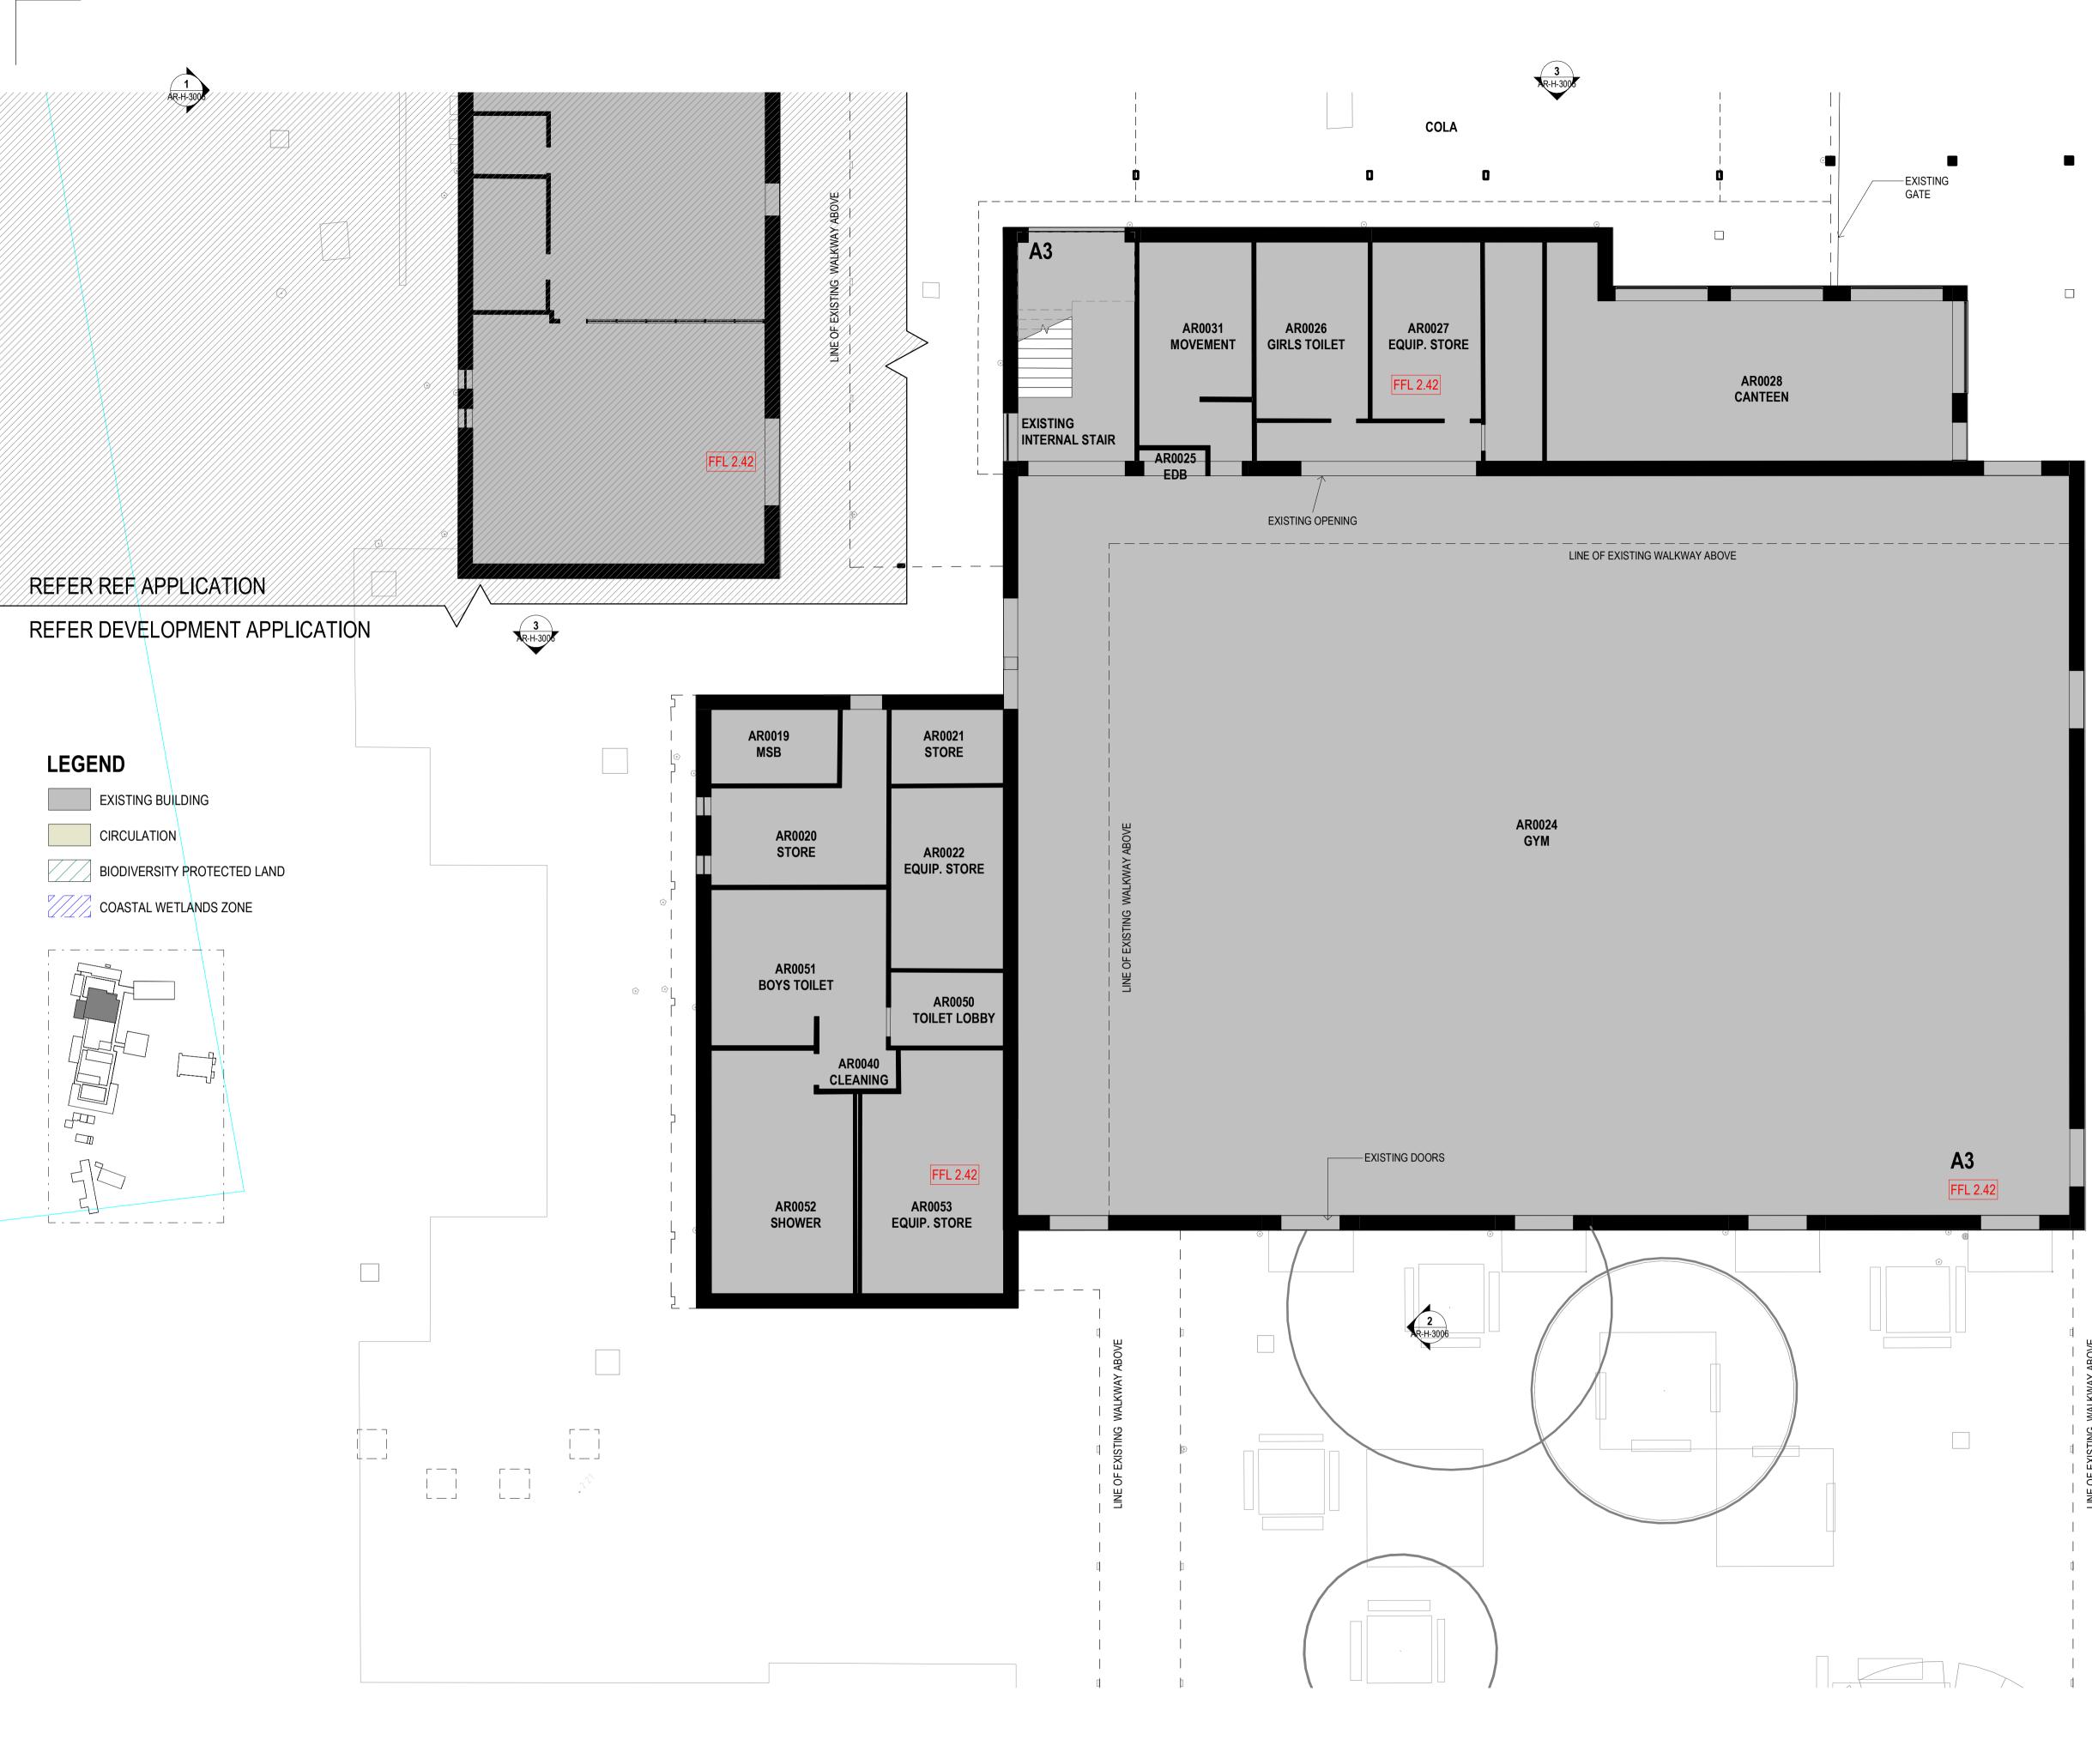
TITLE

PROPOSED SITE PLAN ROOF PLAN

0 7.5 15 22.5 30 37.5 SCALE BAR - 1:750

> DRAWING NUMBER AR-H-0523





0500 - EXISTING AND DEMOLITION PLANS

ARCHITECTURE:

0000 GENERAL & SITE INFORMATION 1000 GENERAL ARRANGEMENT PLANS

2000	GA RCPs
3000	GA SECTIONS & ELEVATIONS

- 4000 REFERENCE PLANS
- 5000 STRUCTURAL SET-OUT
- 6000 VERTICAL CIRCULATION 7000 INTERIOR DESIGN DETAILS
- 8000 EXTERIOR & FACADE DETAILS
- 9000 DRAWN SCHEDULES
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1	24/08/2022	FOR INFORMATION		
2	31/08/2022	FOR REVIEW		TJF
3	09/09/2022	FOR INFORMATION		RF
А	15/09/2022	ISSUE FOR DA		

ARCHITECT

DesignInc

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PROJECT NARRABEEN EDUCATION PRECINCT NAMONA ST, NORTH NARRABEEN NSW 2101


NARRABEEN SPORTS HIGH SCHOOL

DETAILS DRAWN CHECKED APPROVED

SCALE 1:100 @ A1


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TITLE

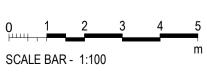

EXISTING PLAN- BLOCK A SOUTH GROUND FLOOR

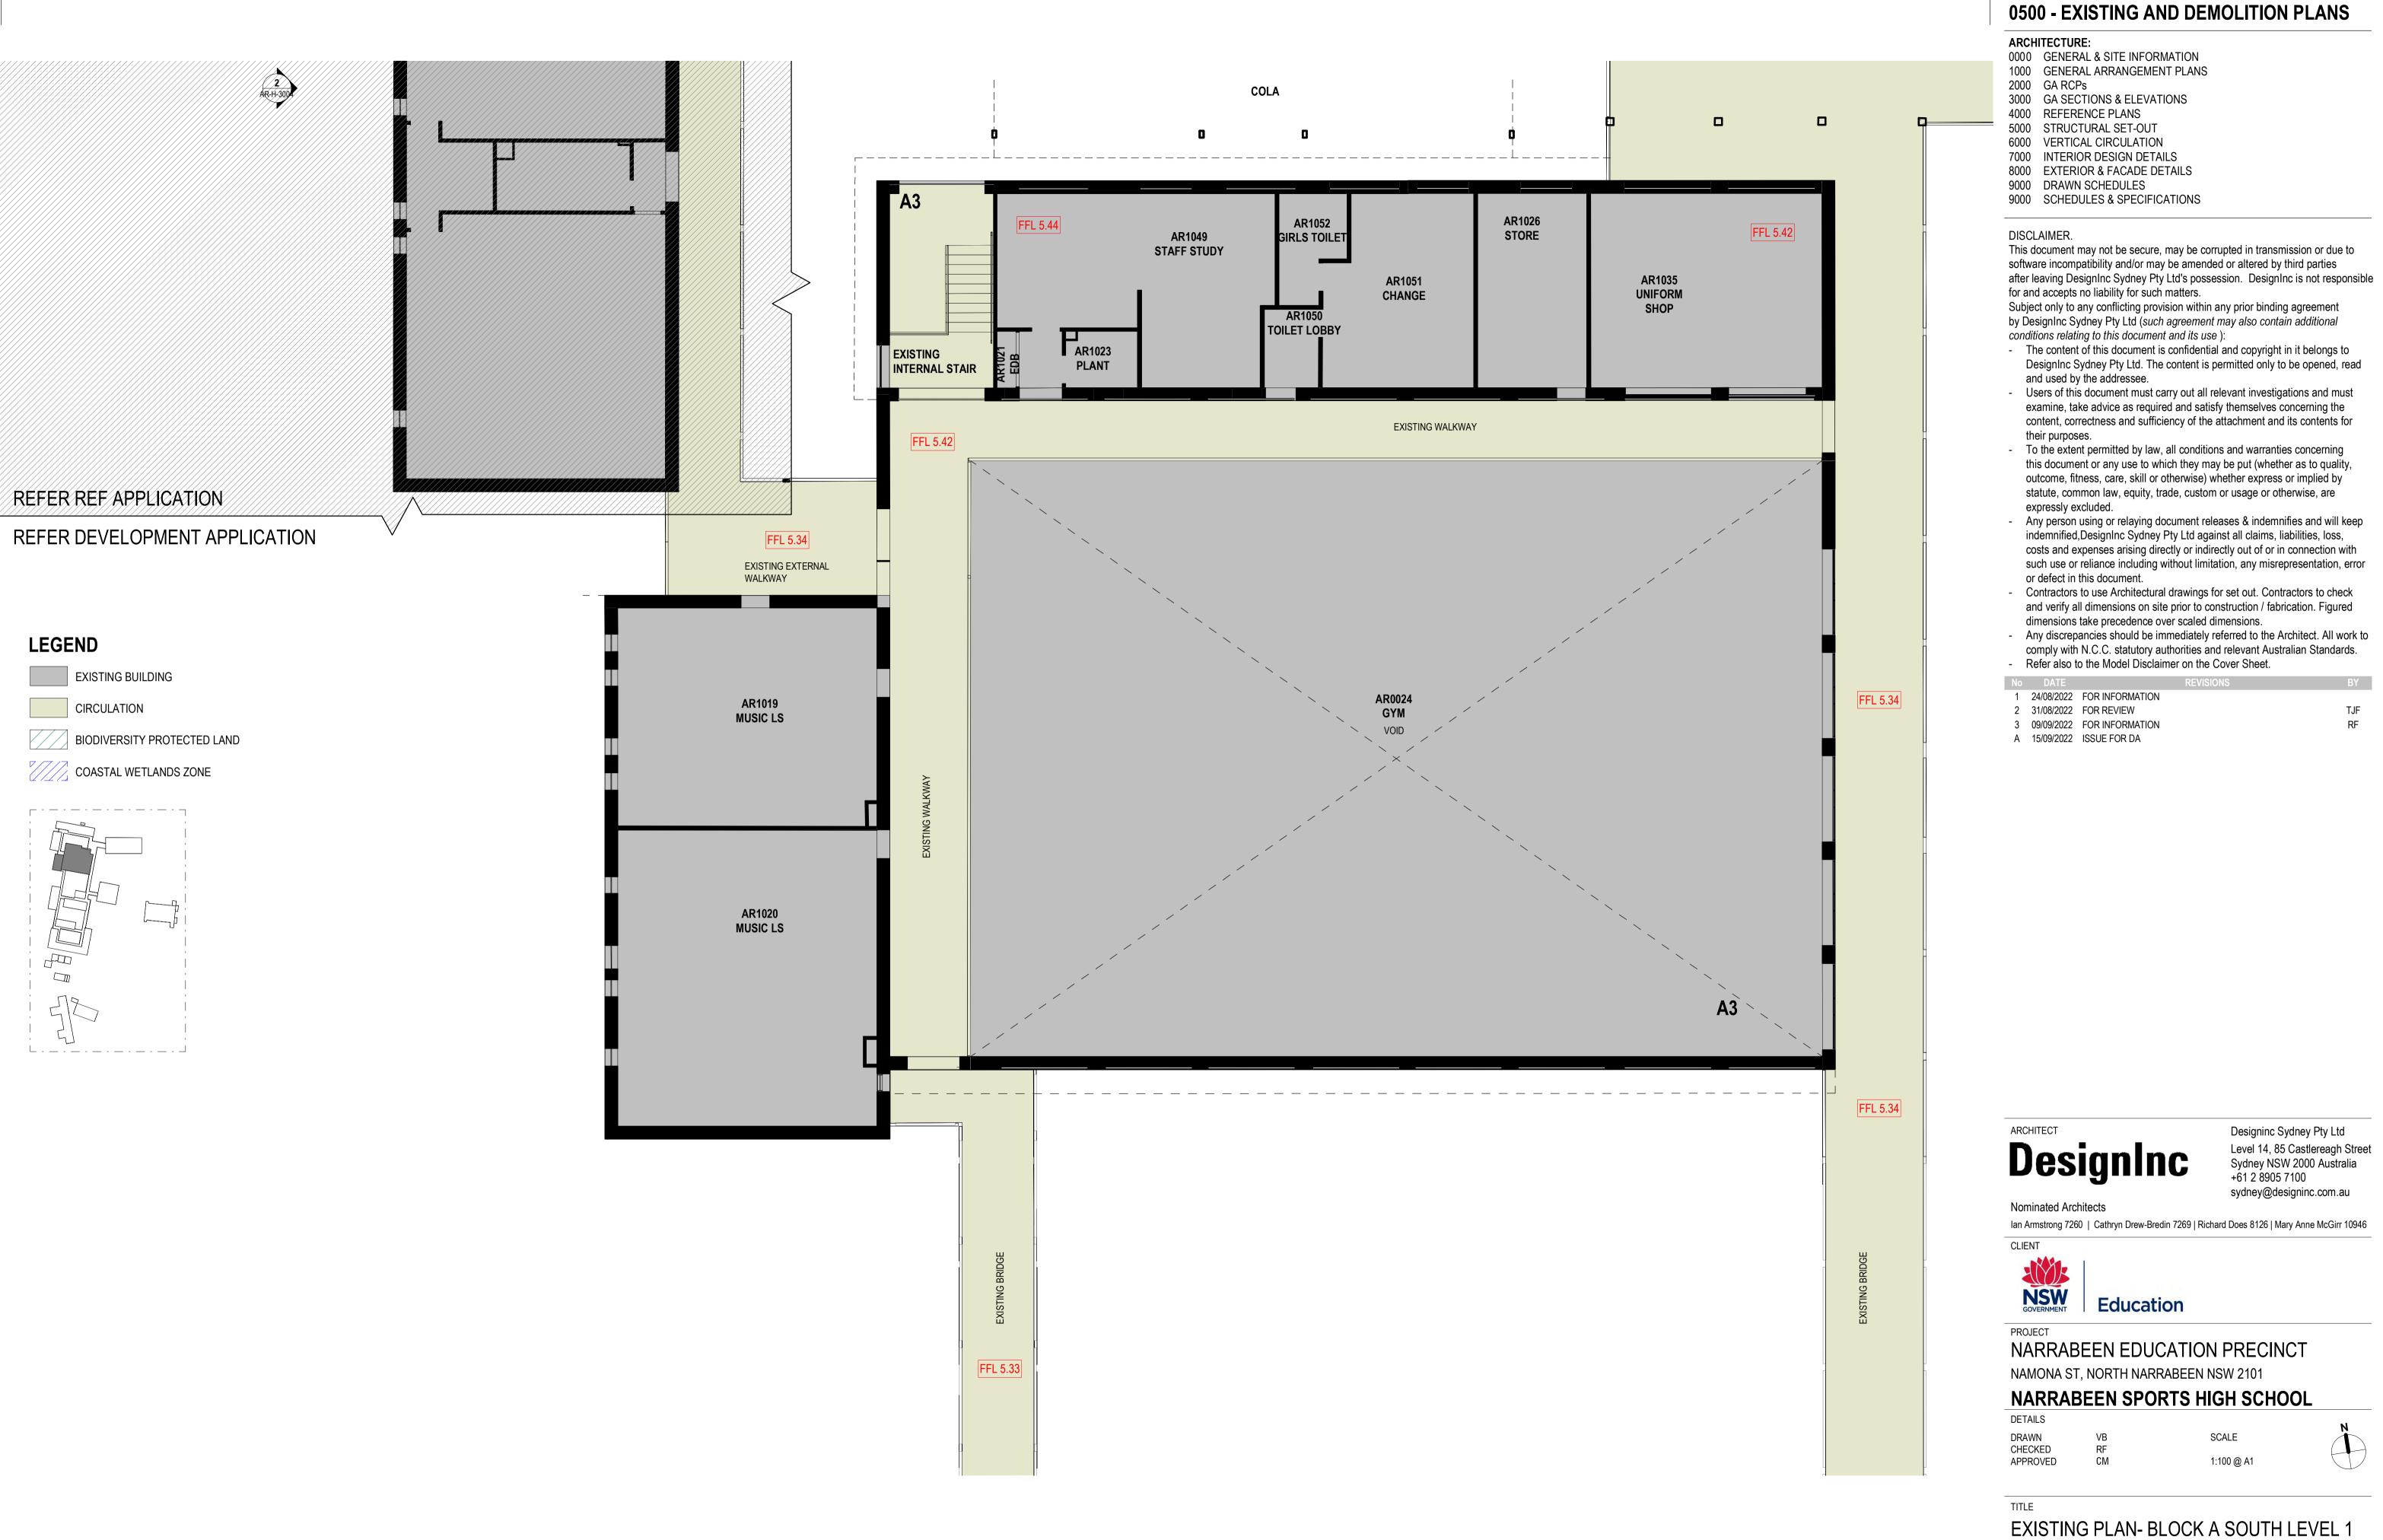DRAWING NUMBER AR-H-0533




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REVISION


AR-H-0534

DRAWING NUMBER

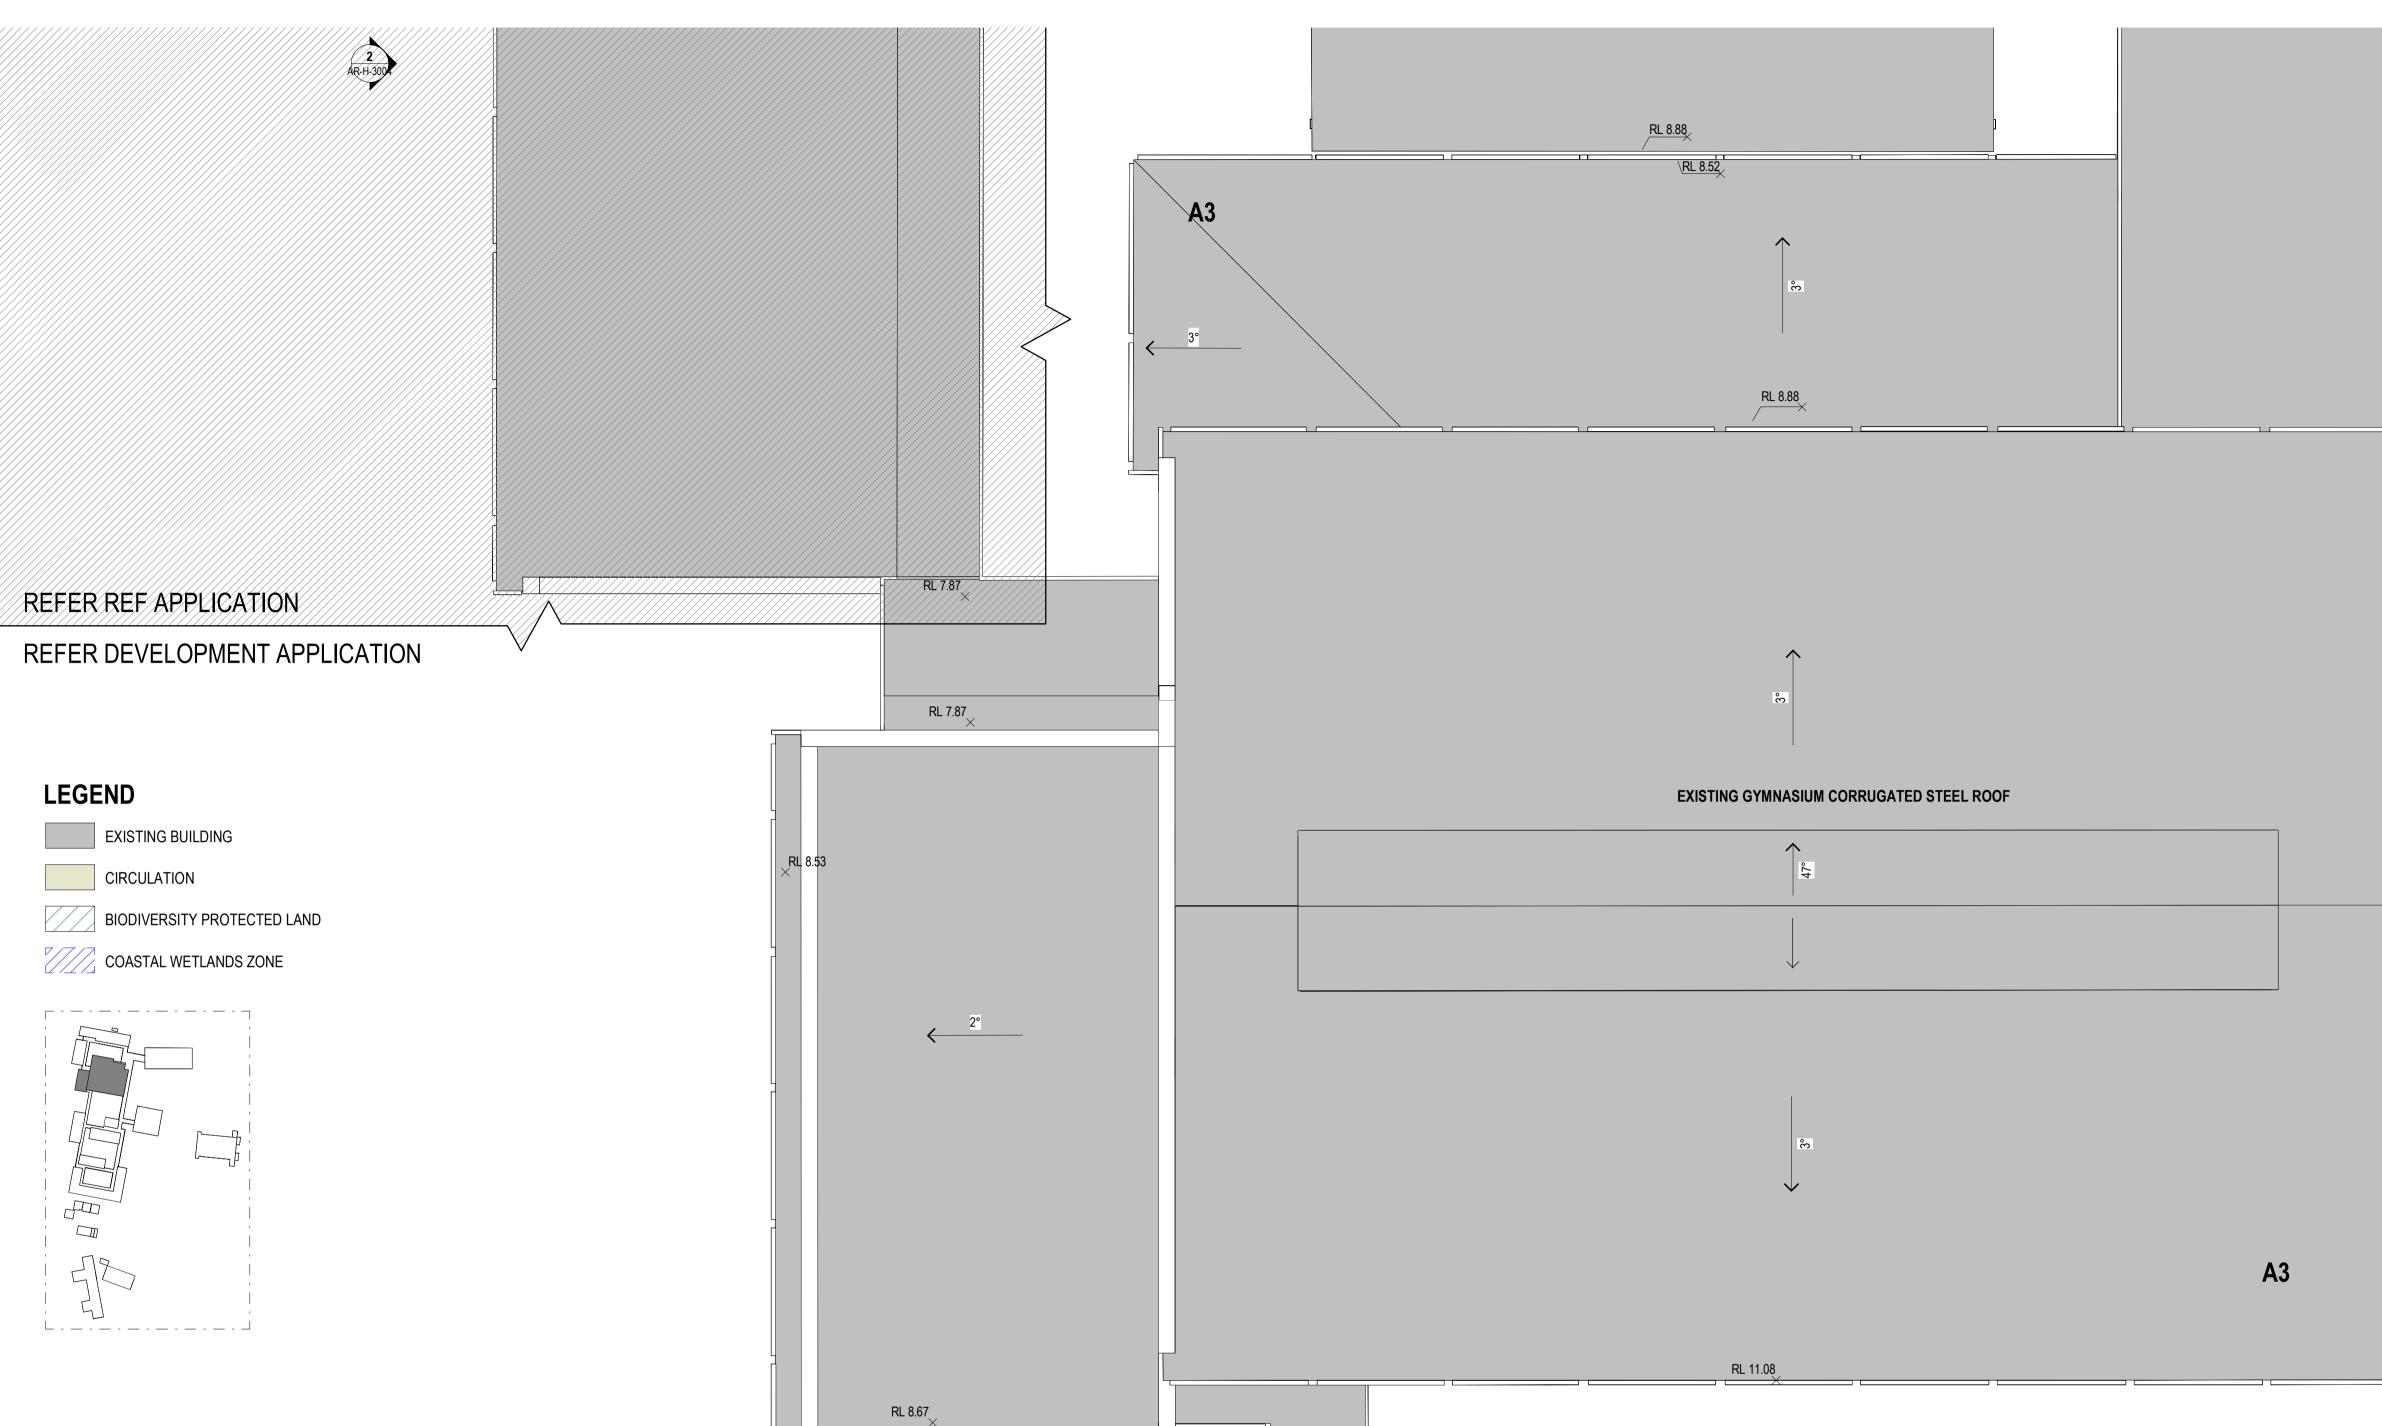Α



0500 - EXISTING AND DEMOLITION PLANS

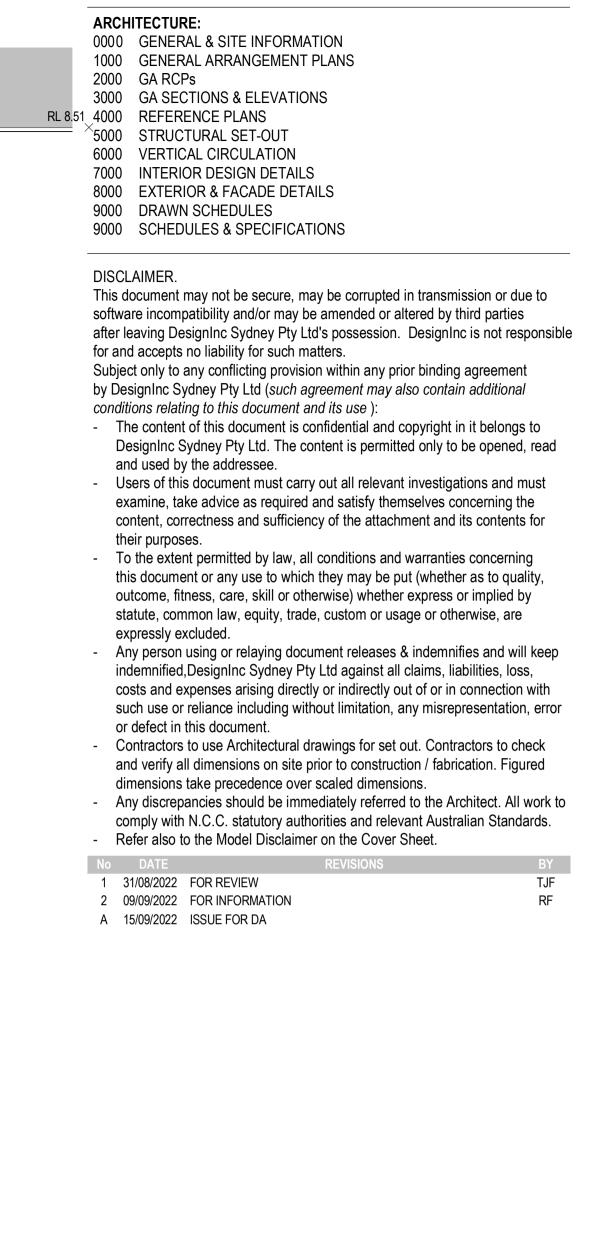

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NARRABEEN SPORTS HIGH SCHOOL

DETAILS DRAWN CHECKED APPROVED


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TITLE

EXISTING PLAN_ BLOCK A SOUTH ROOF PLAN

DRAWING NUMBER AR-H-0535



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0500 - EXISTING AND DEMOLITION PLANS

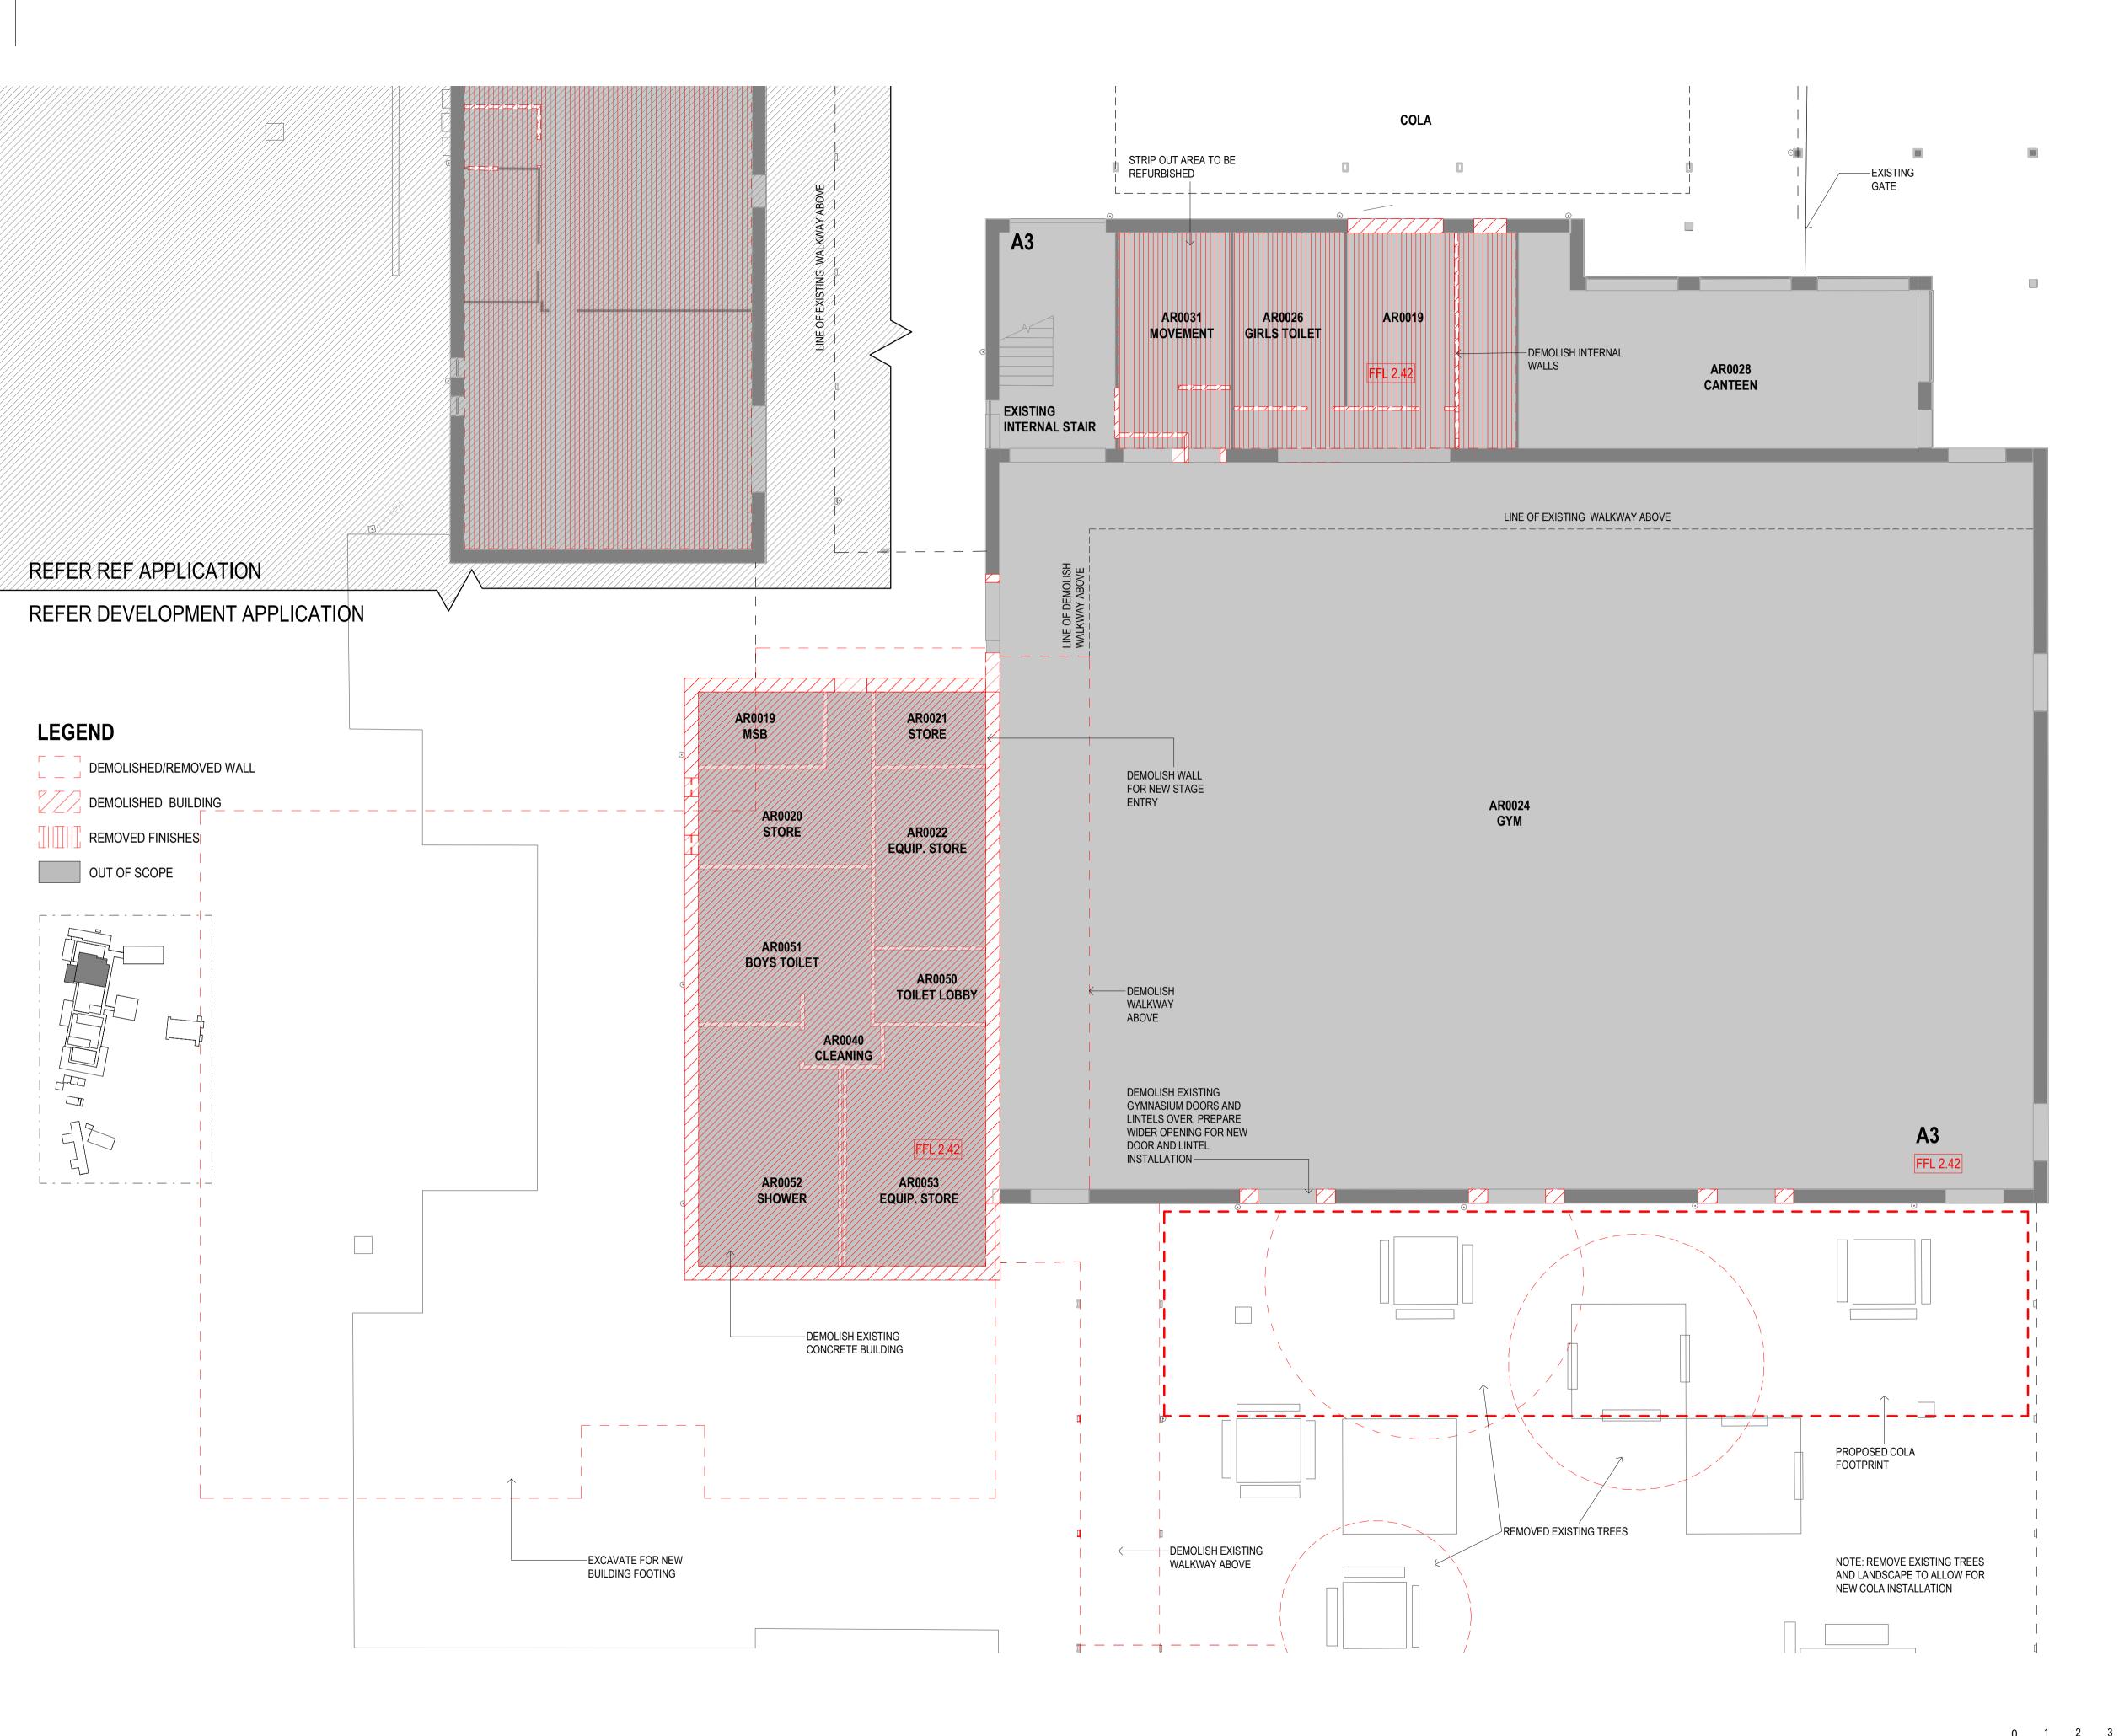ARCHITECTURE:

ANGH	ILCIURE.
0000	GENERAL & SITE INFORMATION
1000	GENERAL ARRANGEMENT PLANS
2000	GA RCPs
3000	GA SECTIONS & ELEVATIONS
4000	REFERENCE PLANS
5000	STRUCTURAL SET-OUT
6000	VERTICAL CIRCULATION
7000	INTERIOR DESIGN DETAILS
8000	EXTERIOR & FACADE DETAILS
9000	DRAWN SCHEDULES
9000	SCHEDULES & SPECIFICATIONS

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3	09/09/2022	FOR INFORMATION		RF
А	15/09/2022	ISSUE FOR DA		

ARCHITECT



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NARRABEEN SPORTS HIGH SCHOOL

DETAILS DRAWN CHECKED APPROVED

SCALE 1:100 @ A1

N

TITLE

DEMOLITION PLAN - GROUND FLOOR_BLOCK A SOUTH


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RF

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DRAWING NUMBER





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SCALE BAR - 1:100

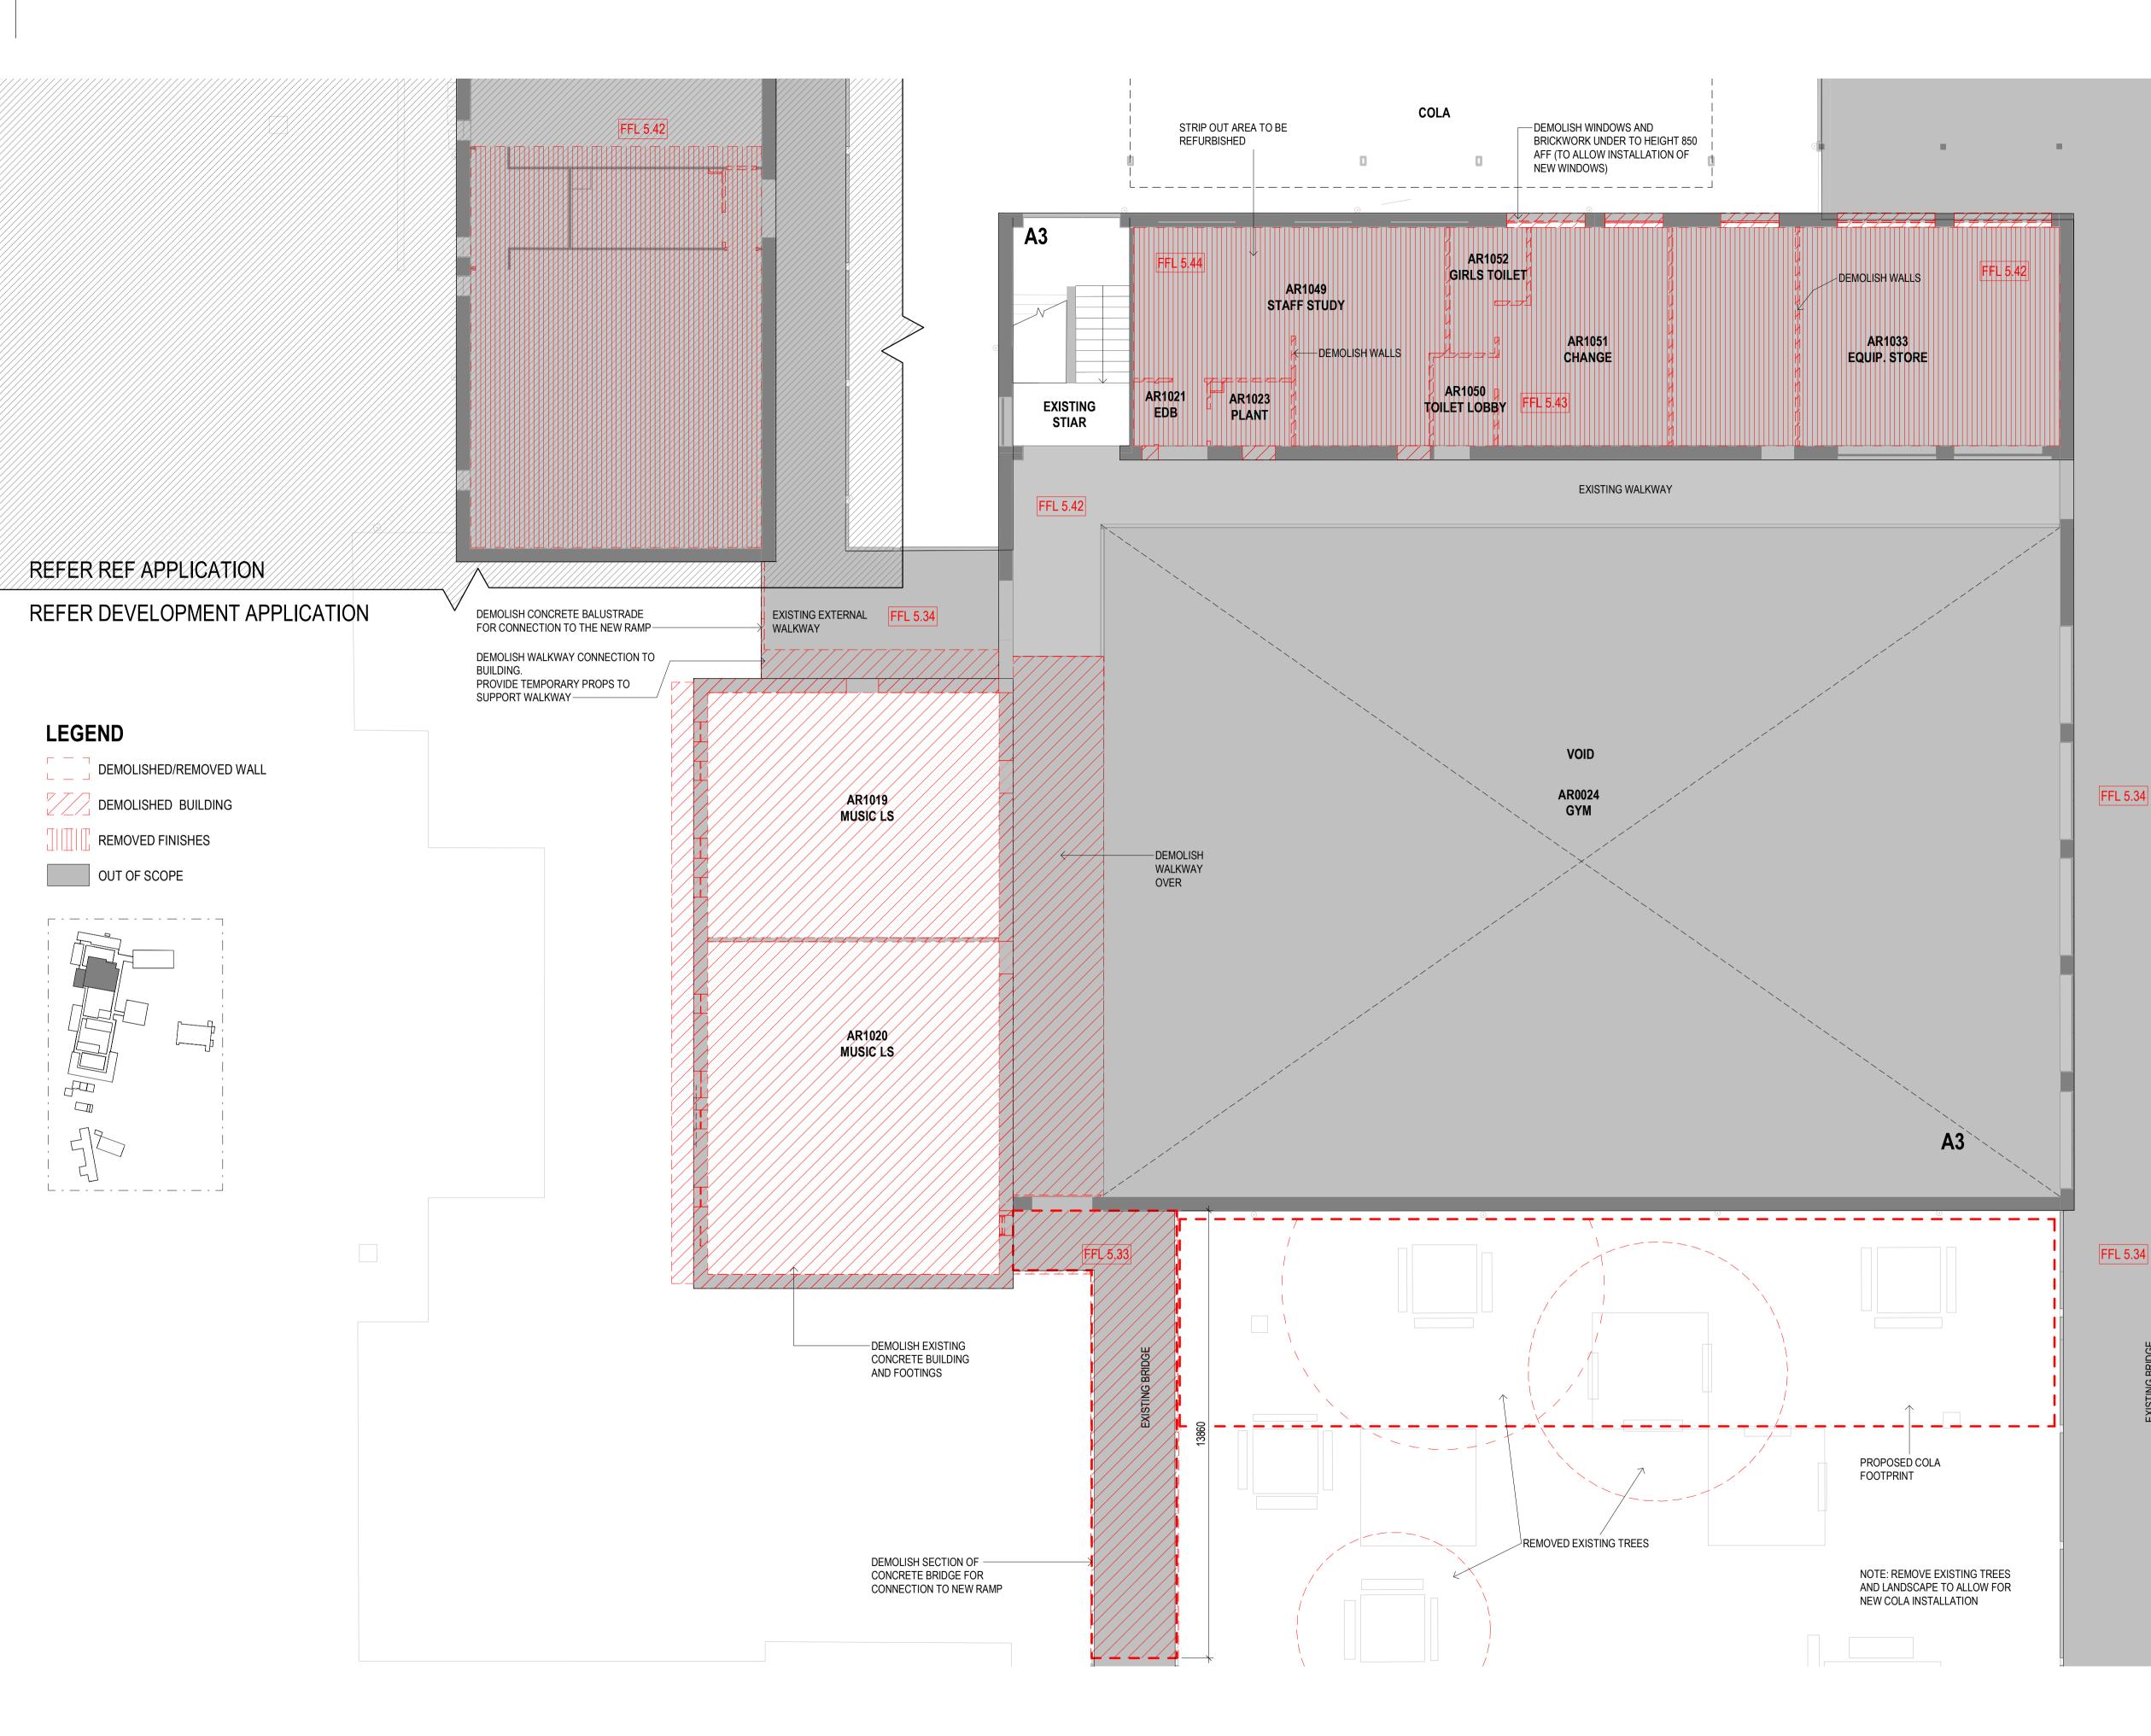0500 - EXISTING AND DEMOLITION PLANS

ARCHITECTURE:

0000 GENERAL & SITE INFORMATION 1000 GENERAL ARRANGEMENT PLANS 2000 GA RCPs

3000 GA SECTIONS & ELEVATIONS 4000 REFERENCE PLANS

5000 STRUCTURAL SET-OUT

6000 VERTICAL CIRCULATION

7000 INTERIOR DESIGN DETAILS 8000 EXTERIOR & FACADE DETAILS

9000 DRAWN SCHEDULES

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Education

PROJECT NARRABEEN EDUCATION PRECINCT NAMONA ST, NORTH NARRABEEN NSW 2101

NARRABEEN SPORTS HIGH SCHOOL

DETAILS DRAWN CHECKED APPROVED


VB, JJ RF СМ

SCALE 1:100 @ A1




TITLE DEMOLITION SITE PLAN_BLOCK A SOUTH_LEVEL 1

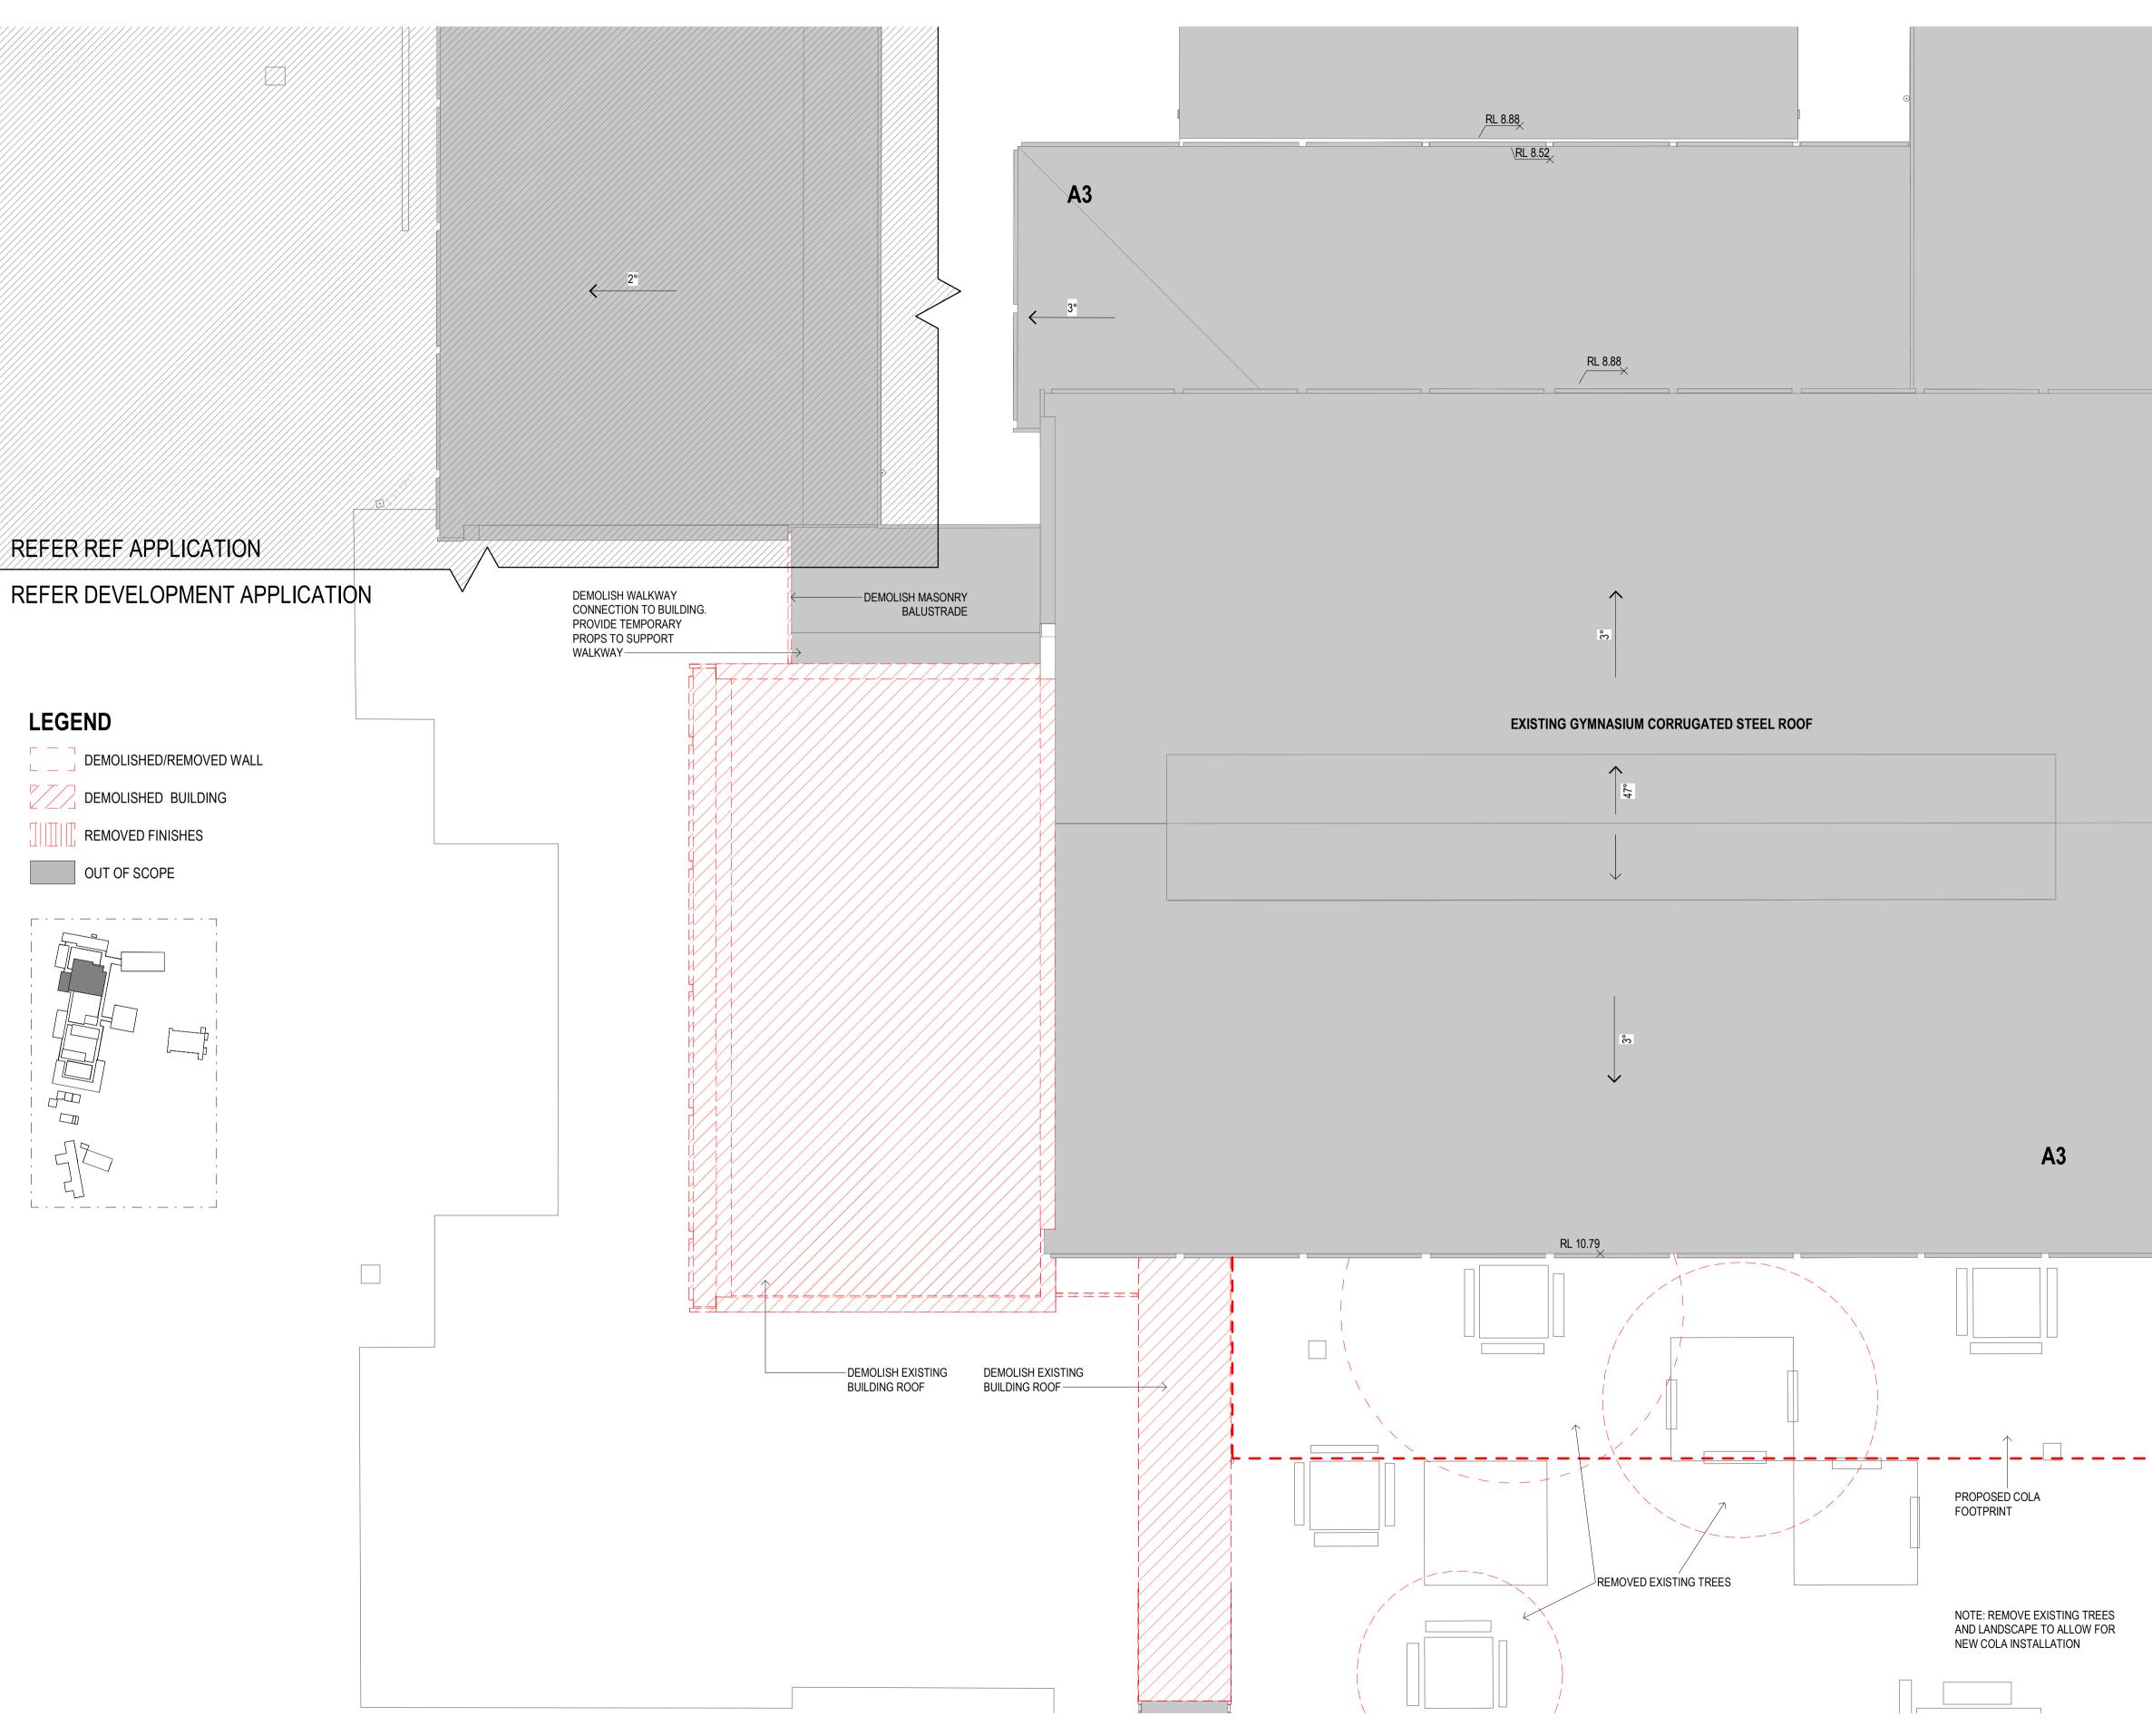DRAWING NUMBER AR-H-0554




0500 - EXISTING AND DEMOLITION PLANS

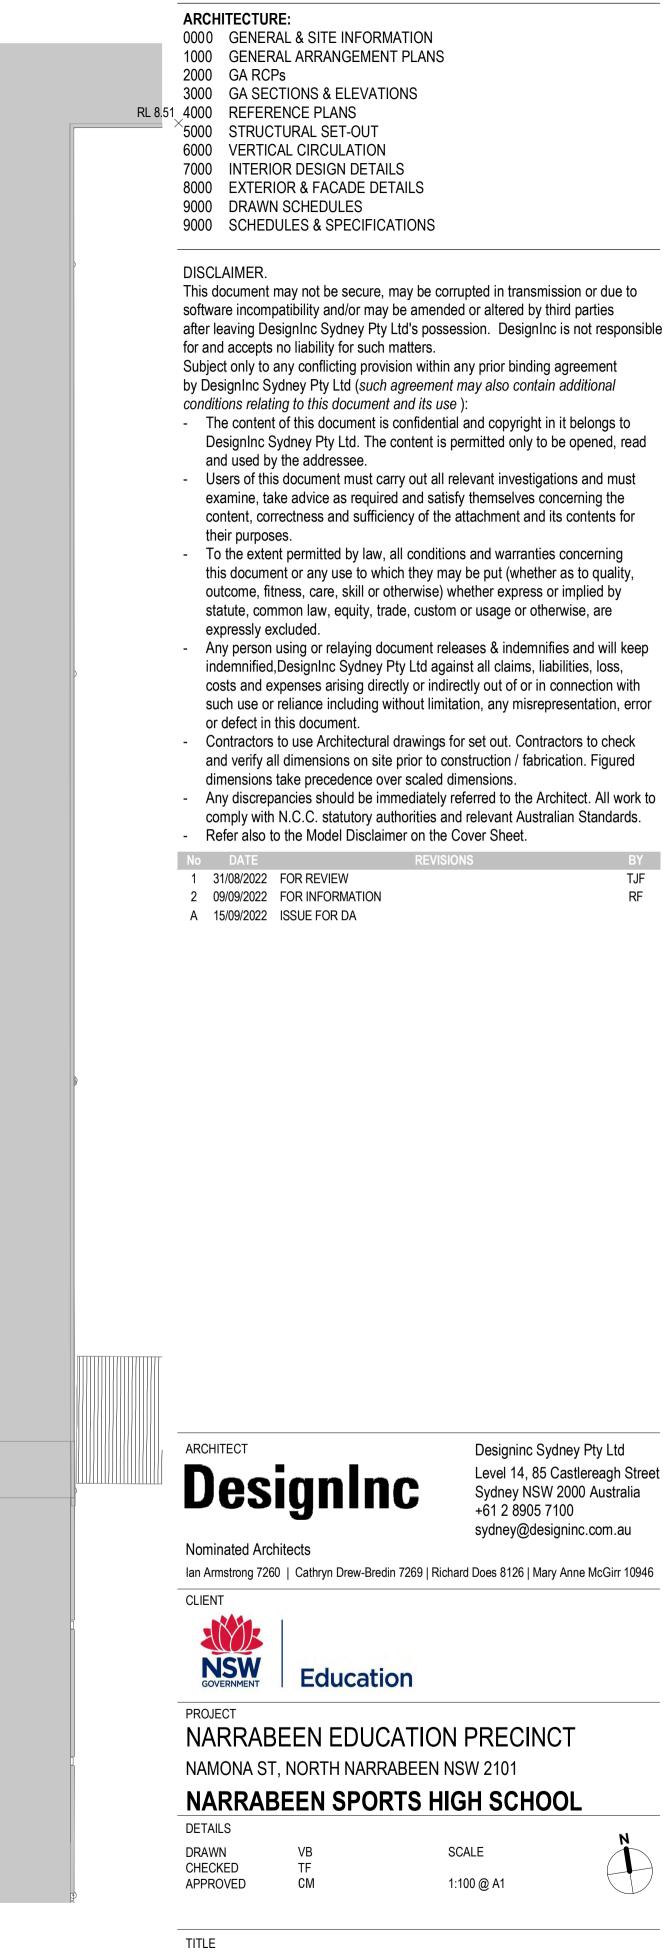


SCALE BAR - 1:100


DEMOLITION PLAN_BLOCK A SOUTH_ROOF PLAN

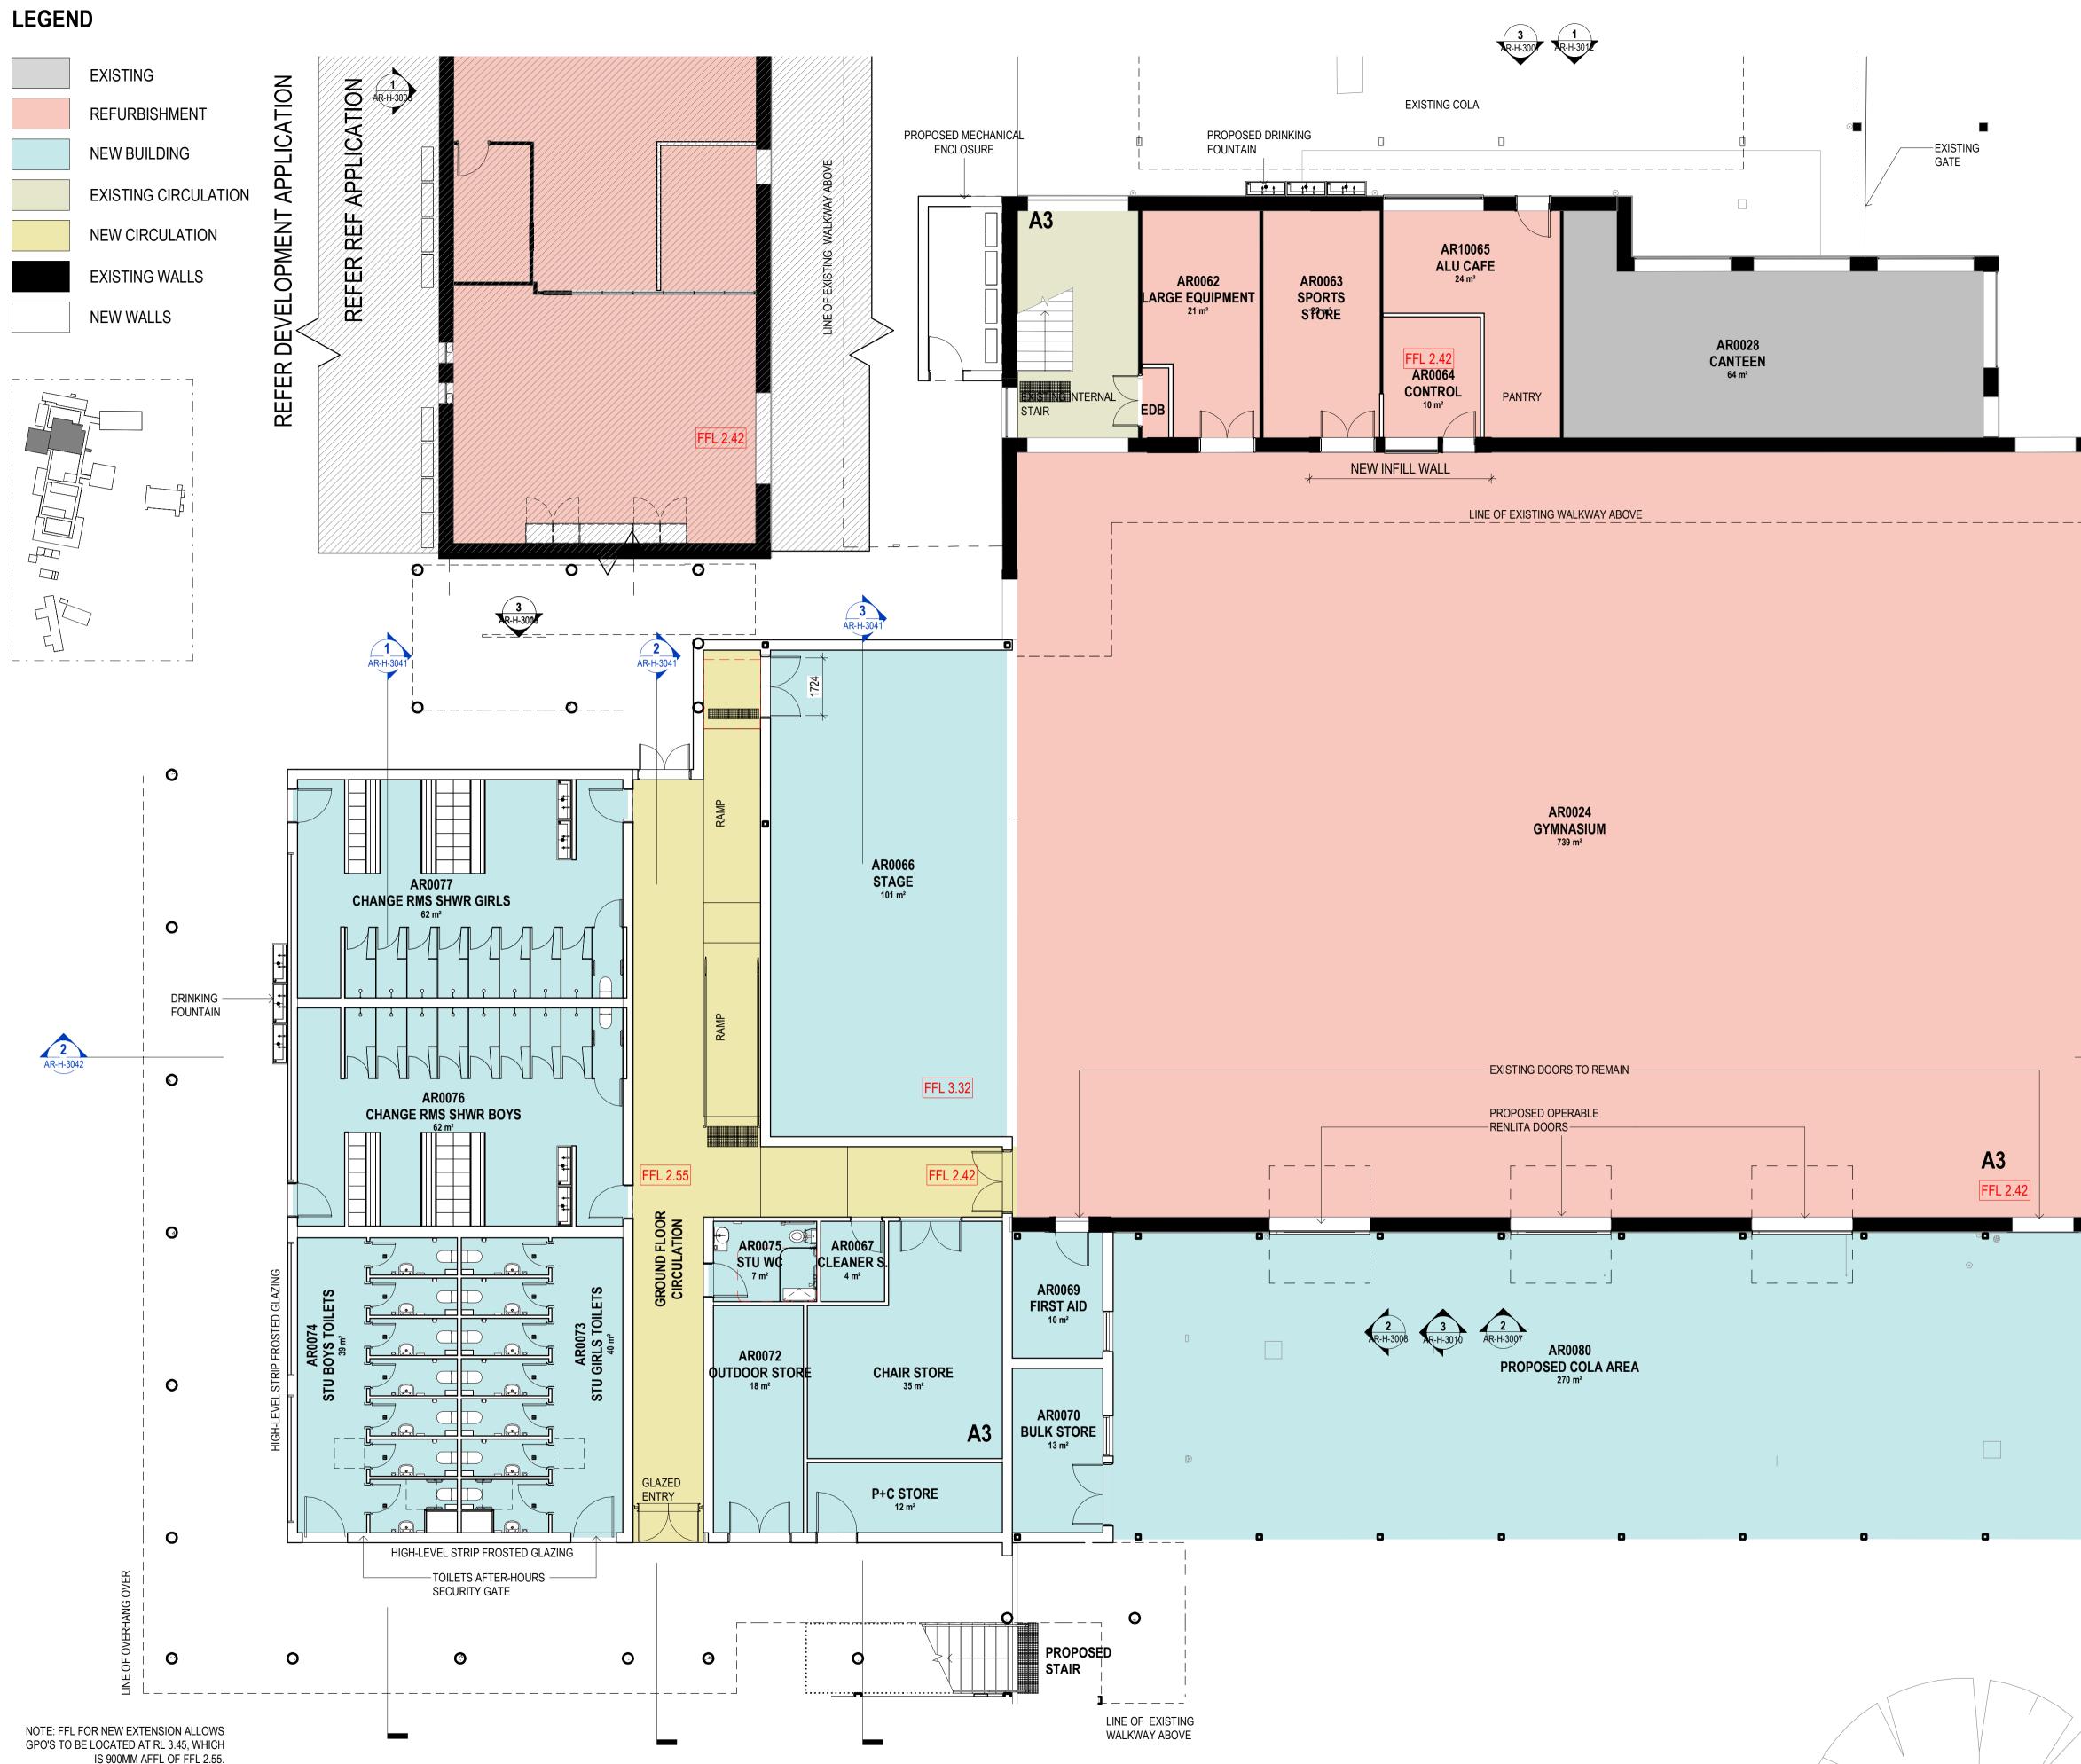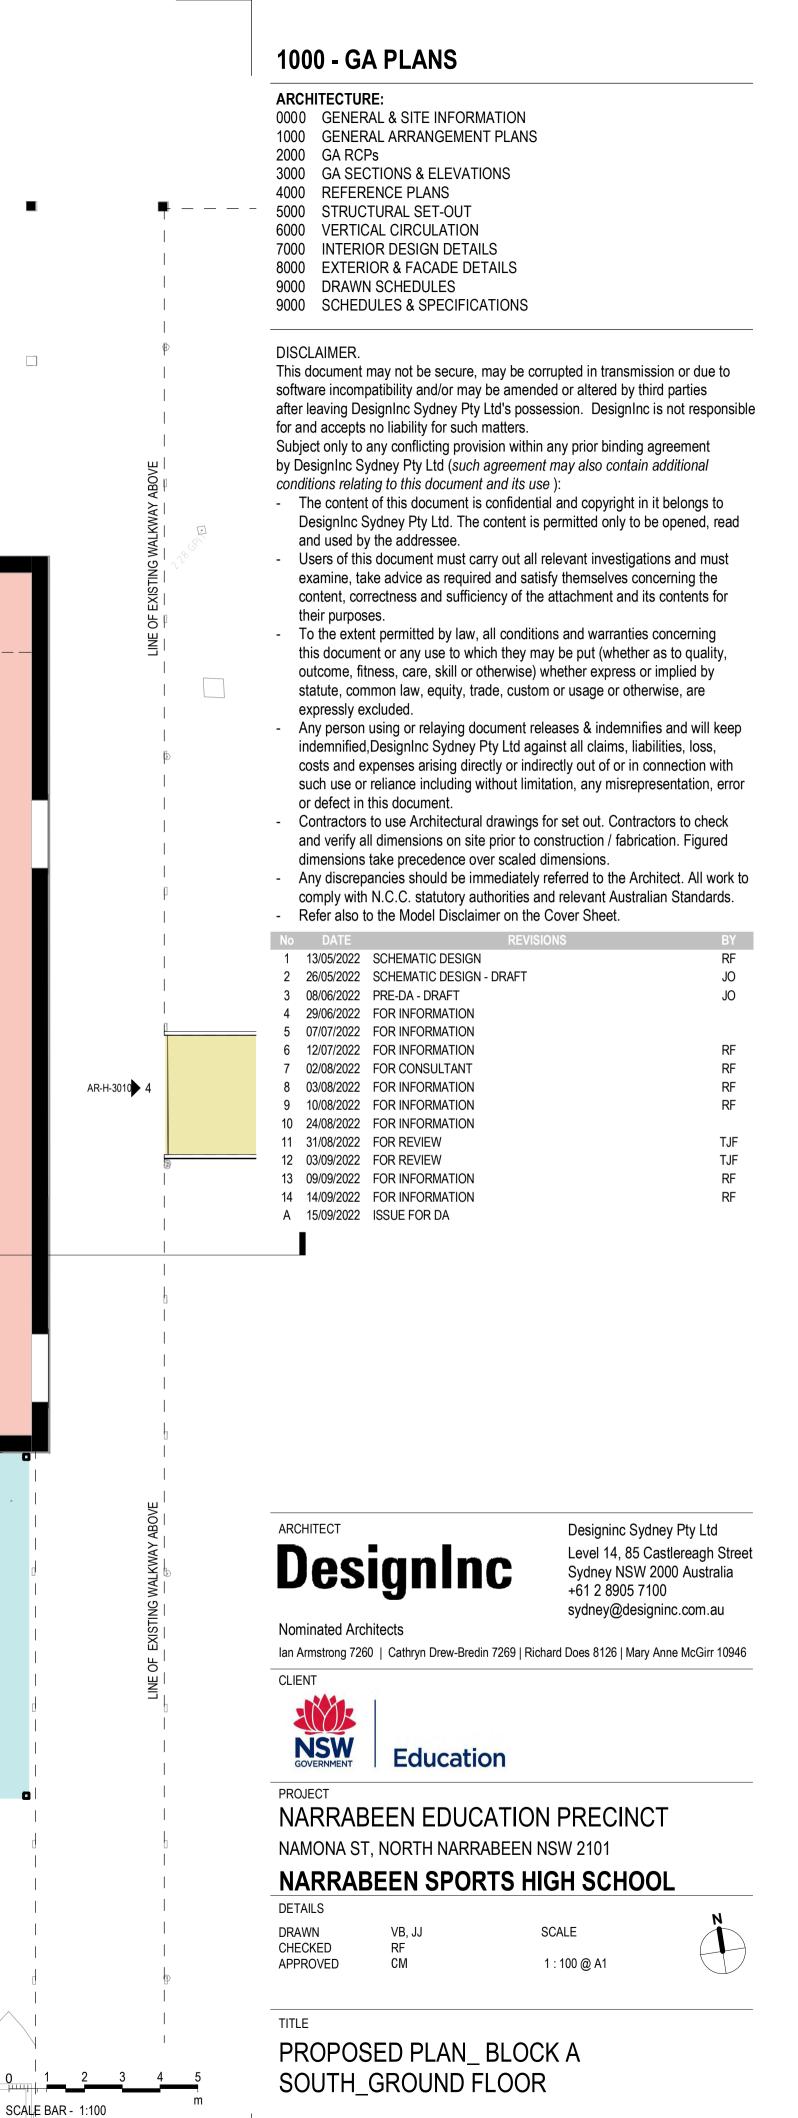DRAWING NUMBER AR-H-0555





DRAWING NUMBER AR-H-1010

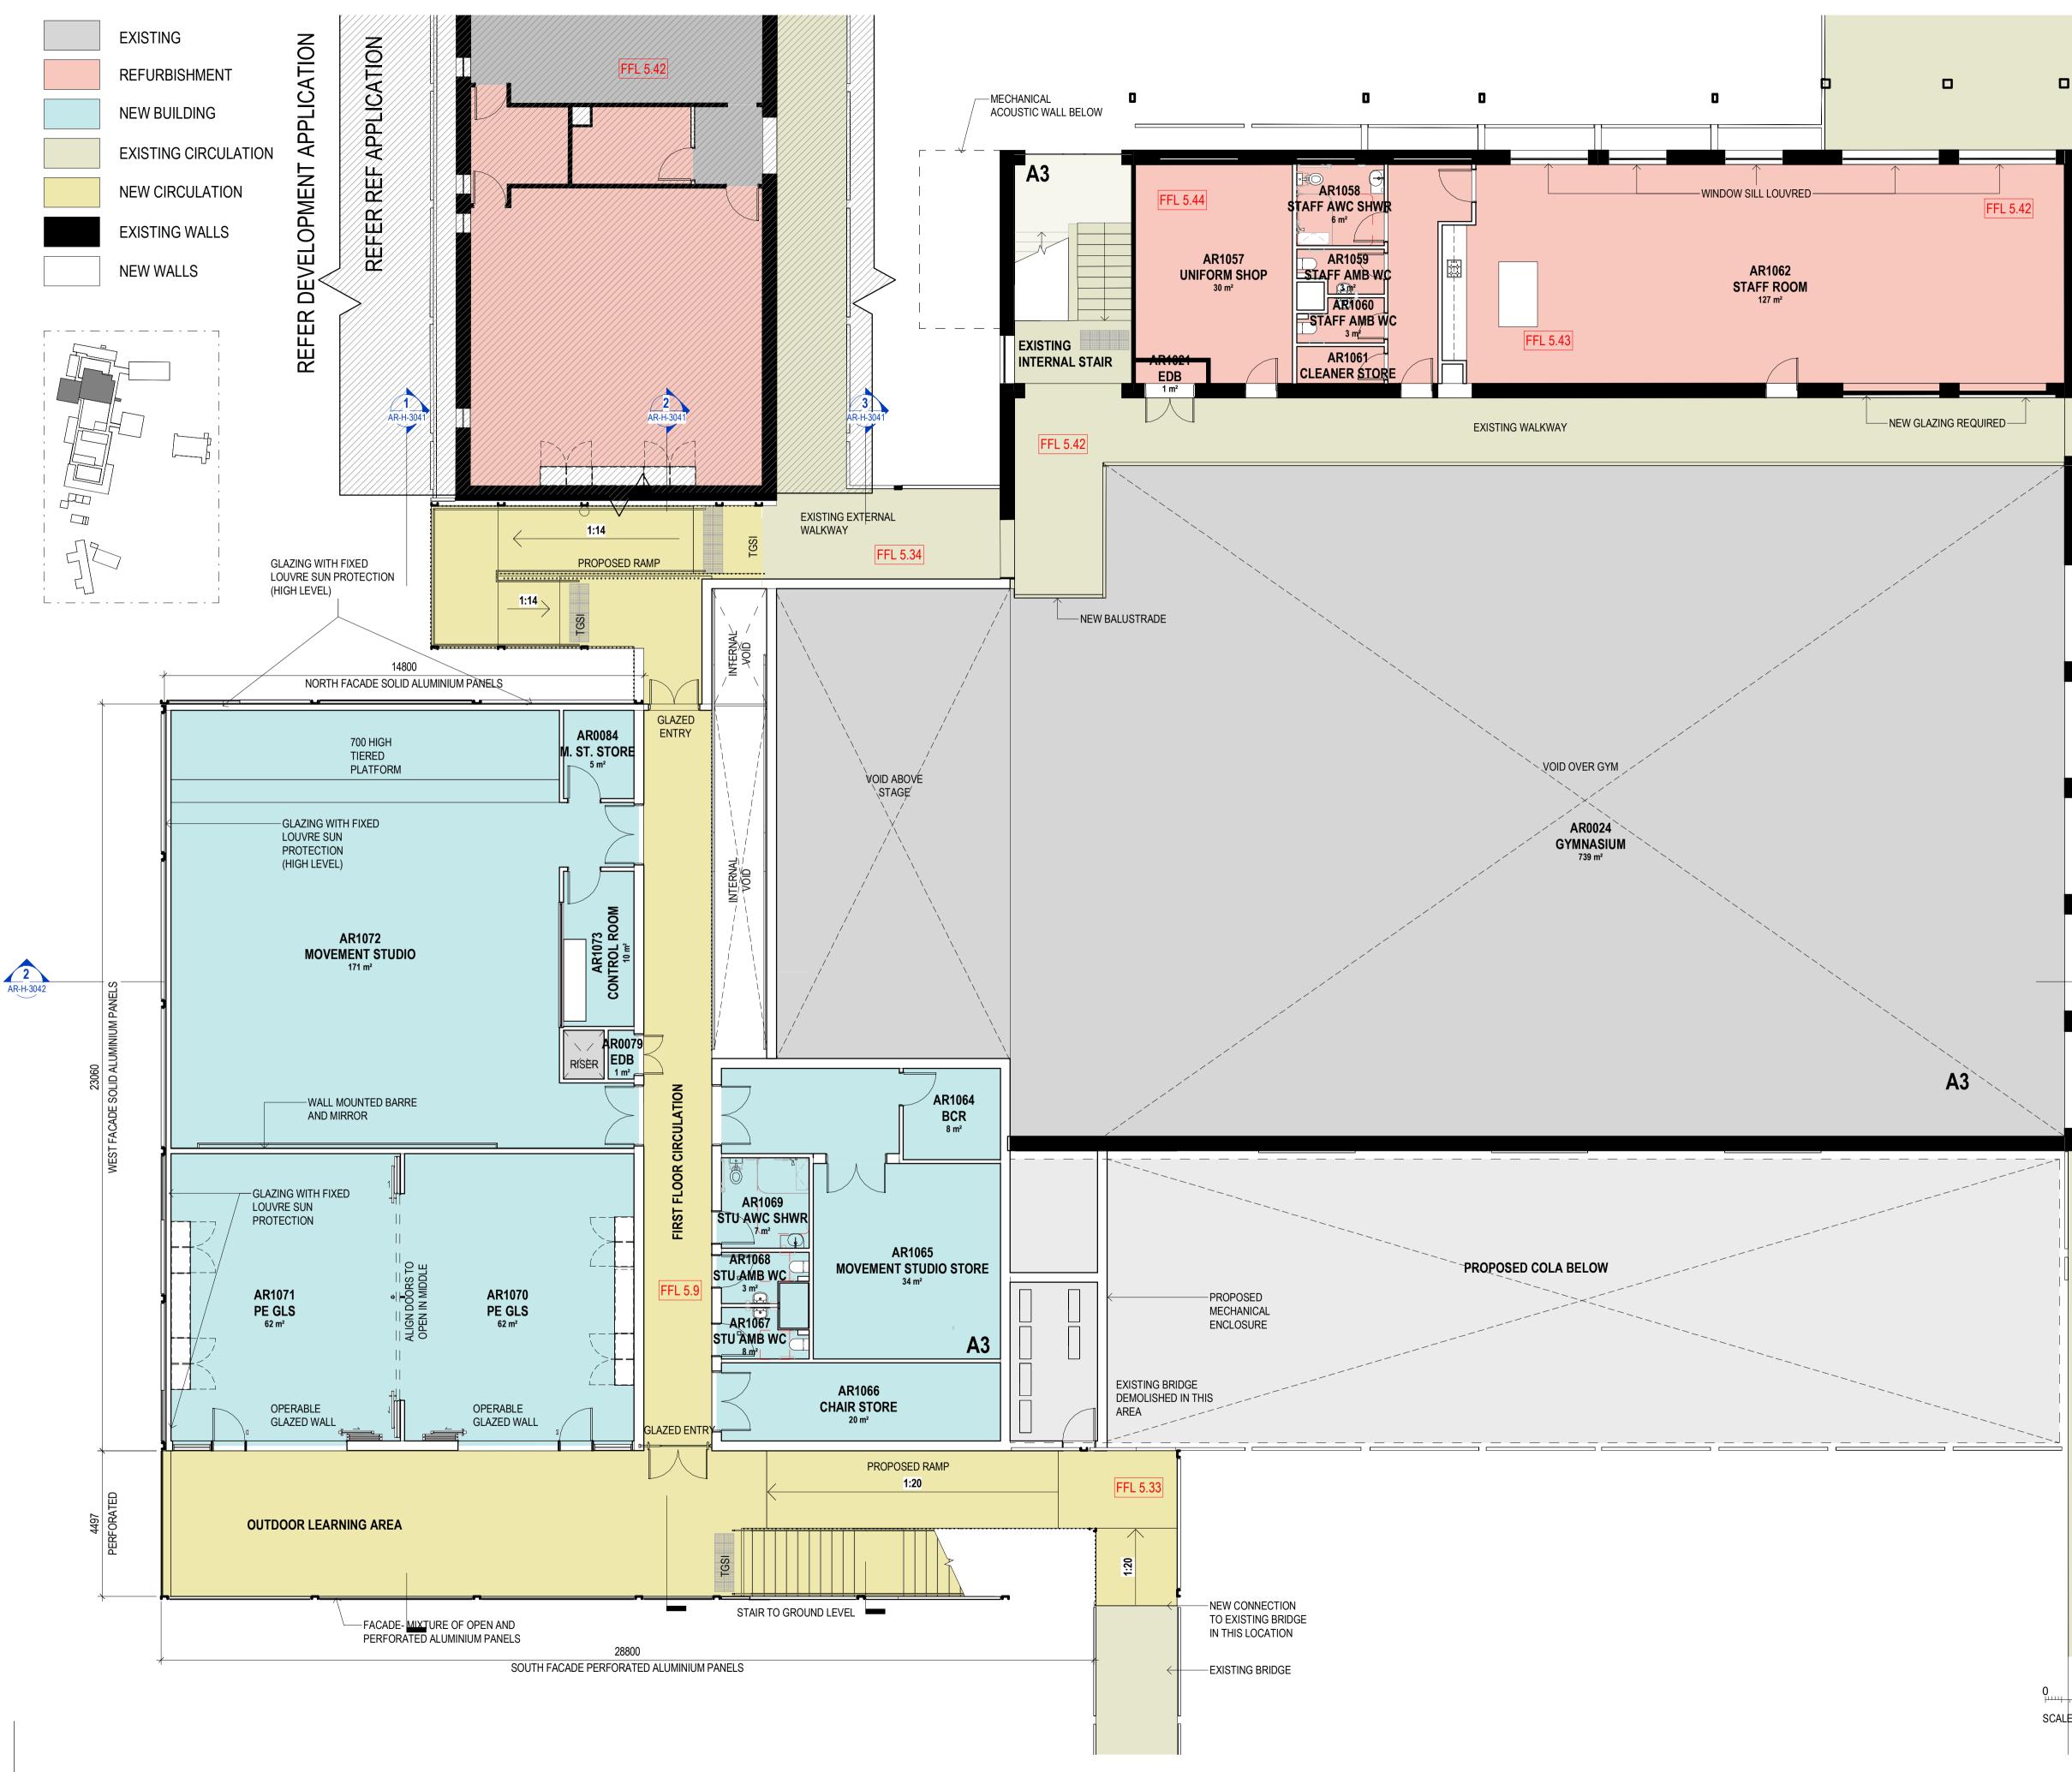

1000 - GA PLANS


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FFL 5.34 1 3002222 SOLEWATIC DESIGN - RAFT .0 2 9902222 POR INFORMATION .0 3 000222 POR INFORMATION .0 6 000222 POR INFORMATION .0 7 020222 POR INFORMATION .0 9 000222 POR INFORMATION .0 10 000222 POR INFORMATION .0 11 000222 POR INFORMATION .0 12 0000222 POR INFORMATION .0 13 100222 POR INFORMATION .0 14 000222 POR INFORMATION .0 15 000222 POR INFORMATION .0 14 000222 POR INFORMATION .0 15 000222 POR INFORMATION <td< th=""><th></th><th> for and accepts no liability for such matters. Subject only to any conflicting provision within any prior bin by DesignInc Sydney Pty Ltd (<i>such agreement may also co</i> <i>conditions relating to this document and its use</i>): The content of this document is confidential and copyrig DesignInc Sydney Pty Ltd. The content is permitted onl and used by the addressee. Users of this document must carry out all relevant invest examine, take advice as required and satisfy themselve content, correctness and sufficiency of the attachment a their purposes. To the extent permitted by law, all conditions and warra this document or any use to which they may be put (wh outcome, fitness, care, skill or otherwise) whether expres statute, common law, equity, trade, custom or usage or expressly excluded. Any person using or relaying document releases & indefindemnified, DesignInc Sydney Pty Ltd against all claim costs and expenses arising directly or indirectly out of c such use or reliance including without limitation, any mi or defect in this document. Contractors to use Architectural drawings for set out. C and verify all dimensions on site prior to construction / f dimensions take precedence over scaled dimensions. Any discrepancies should be immediately referred to th comply with N.C.C. statutory authorities and relevant A Refer also to the Model Disclaimer on the Cover Sheet. </th><th>ading agreement ontain additional ght in it belongs to ly to be opened, read stigations and must es concerning the and its contents for anties concerning nether as to quality, ess or implied by r otherwise, are emnifies and will keep s, liabilities, loss, or in connection with isrepresentation, error ontractors to check fabrication. Figured he Architect. All work to ustralian Standards.</th></td<>		 for and accepts no liability for such matters. Subject only to any conflicting provision within any prior bin by DesignInc Sydney Pty Ltd (<i>such agreement may also co</i> <i>conditions relating to this document and its use</i>): The content of this document is confidential and copyrig DesignInc Sydney Pty Ltd. The content is permitted onl and used by the addressee. Users of this document must carry out all relevant invest examine, take advice as required and satisfy themselve content, correctness and sufficiency of the attachment a their purposes. To the extent permitted by law, all conditions and warra this document or any use to which they may be put (wh outcome, fitness, care, skill or otherwise) whether expres statute, common law, equity, trade, custom or usage or expressly excluded. Any person using or relaying document releases & indefindemnified, DesignInc Sydney Pty Ltd against all claim costs and expenses arising directly or indirectly out of c such use or reliance including without limitation, any mi or defect in this document. Contractors to use Architectural drawings for set out. C and verify all dimensions on site prior to construction / f dimensions take precedence over scaled dimensions. Any discrepancies should be immediately referred to th comply with N.C.C. statutory authorities and relevant A Refer also to the Model Disclaimer on the Cover Sheet. 	ading agreement ontain additional ght in it belongs to ly to be opened, read stigations and must es concerning the and its contents for anties concerning nether as to quality, ess or implied by r otherwise, are emnifies and will keep s, liabilities, loss, or in connection with isrepresentation, error ontractors to check fabrication. Figured he Architect. All work to ustralian Standards.
ARCHITECT Designinc Sydney Phy Ltd Level 14, 85 Castlereagh Strei- Sydney NSW 2000 Australia +61 2 8905 7100 sydney@designinc.com.au Nominated Architects Ian Armstrong 7260 Cathryn Drew-Bredin 7269 Richard Does 8126 Mary Anne McGirr 10944 CLIENT CLIENT PROJECT PROJECT NARRABEEN EDUCATION PRECINCT NAMONA ST, NORTH NARRABEEN NSW 2101 MARRABEEN SPORTS HIGH SCHOOL DETAILS DRAWN VB, JJ SCALE DRAWN DRAWN VB, JJ SCALE DRAWN DRAWN ST, NORTH NARRABEEN SOUTH LEVEL DRAWN DRAWN JETTILE DRAWN DRAWN JETTILE DRAWN JETIL		1 13/05/2022 SCHEMATIC DESIGN 2 26/05/2022 SCHEMATIC DESIGN - DRAFT 3 08/06/2022 PRE-DA - DRAFT 4 29/06/2022 FOR INFORMATION 5 07/07/2022 FOR INFORMATION 6 12/07/2022 FOR INFORMATION 7 02/08/2022 FOR CONSULTANT 8 03/08/2022 FOR INFORMATION 9 10/08/2022 FOR INFORMATION 10 24/08/2022 FOR INFORMATION 11 31/08/2022 FOR REVIEW 12 03/09/2022 FOR REVIEW 13 09/09/2022 FOR INFORMATION 14 14/09/2022 FOR INFORMATION A 15/09/2022 FOR INFORMATION	RF JO JO RF RF RF RF TJF TJF TJF
PROJECT NARRABEEN EDUCATION PRECINCT NAMONA ST, NORTH NARRABEEN NSW 2101 NARRABEEN SPORTS HIGH SCHOOL DETAILS DRAWN VB, JJ SCALE CHECKED RF APPROVED CM 1:100@A1 TITLE PROPOSED PLAN_BLOCK A SOUTH_LEVEL 1		Designing Level 14 Sydney 14 +61 2 89 Sydney@ Nominated Architects Ian Armstrong 7260 Cathryn Drew-Bredin 7269 Richard Does 8126	, 85 Castlereagh Stree NSW 2000 Australia 005 7100)designinc.com.au
PROPOSED PLAN_BLOCK A SOUTH_LEVEL	EXISTING BRIDG	PROJECT NARRABEEN EDUCATION PREC NAMONA ST, NORTH NARRABEEN NSW 2101 NARRABEEN SPORTS HIGH SCH DETAILS DRAWN VB, JJ SCALE CHECKED RF	HOOL
			JTH_LEVEL

DRAWING NUMBER





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1000 - GA PLANS

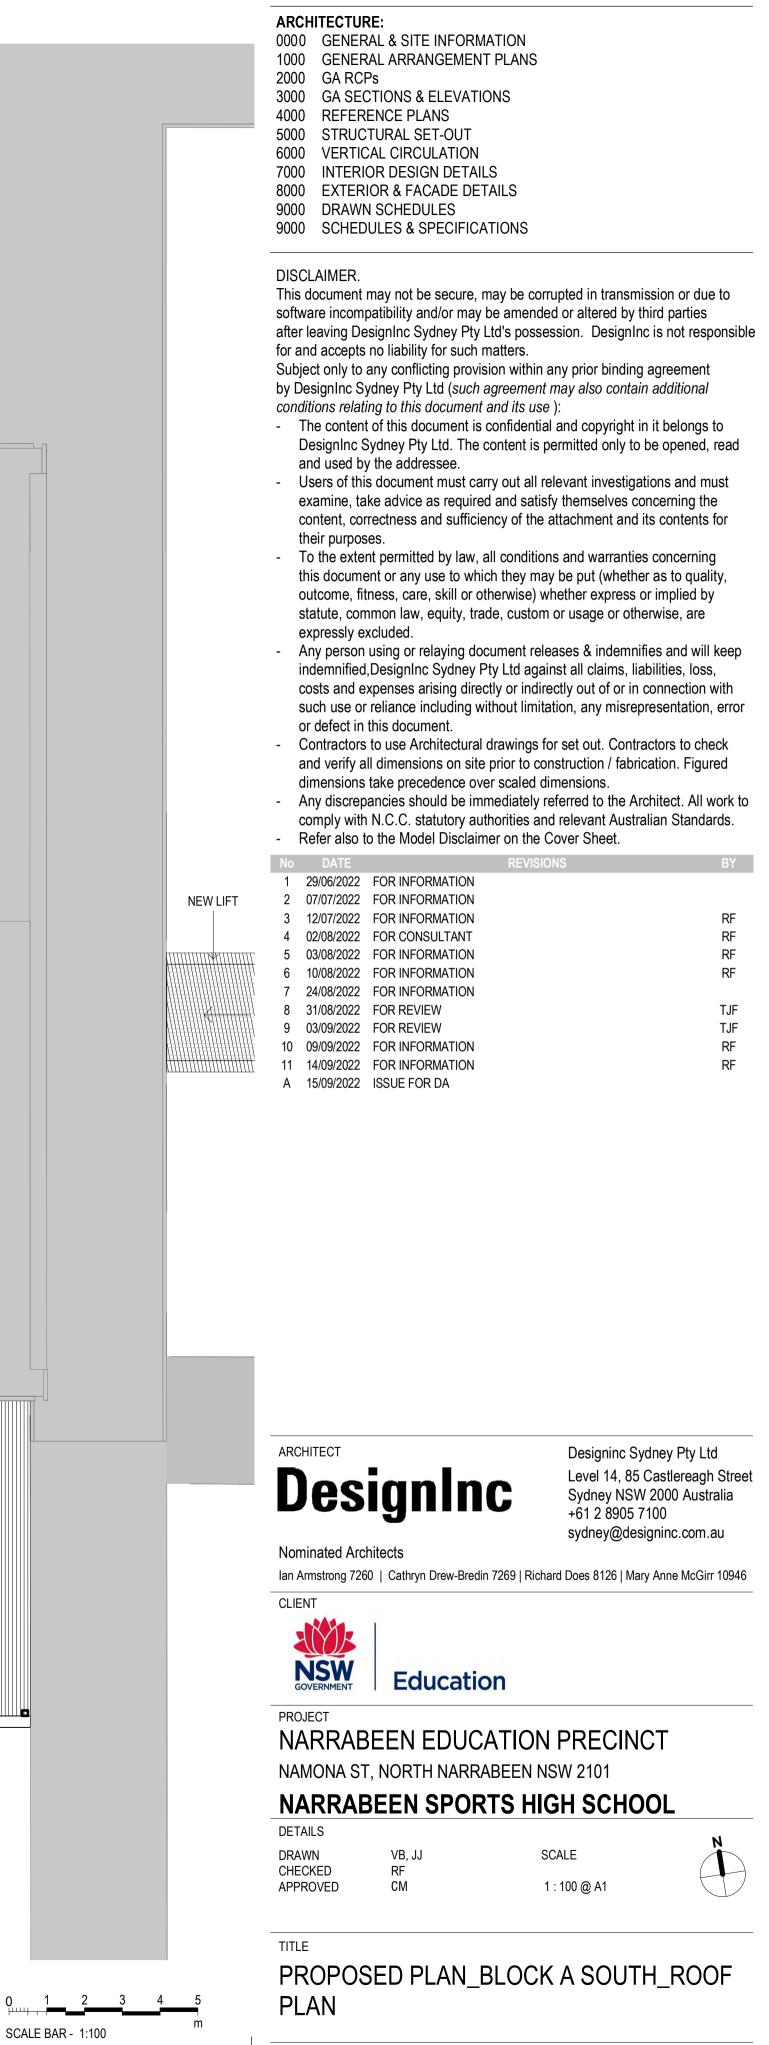

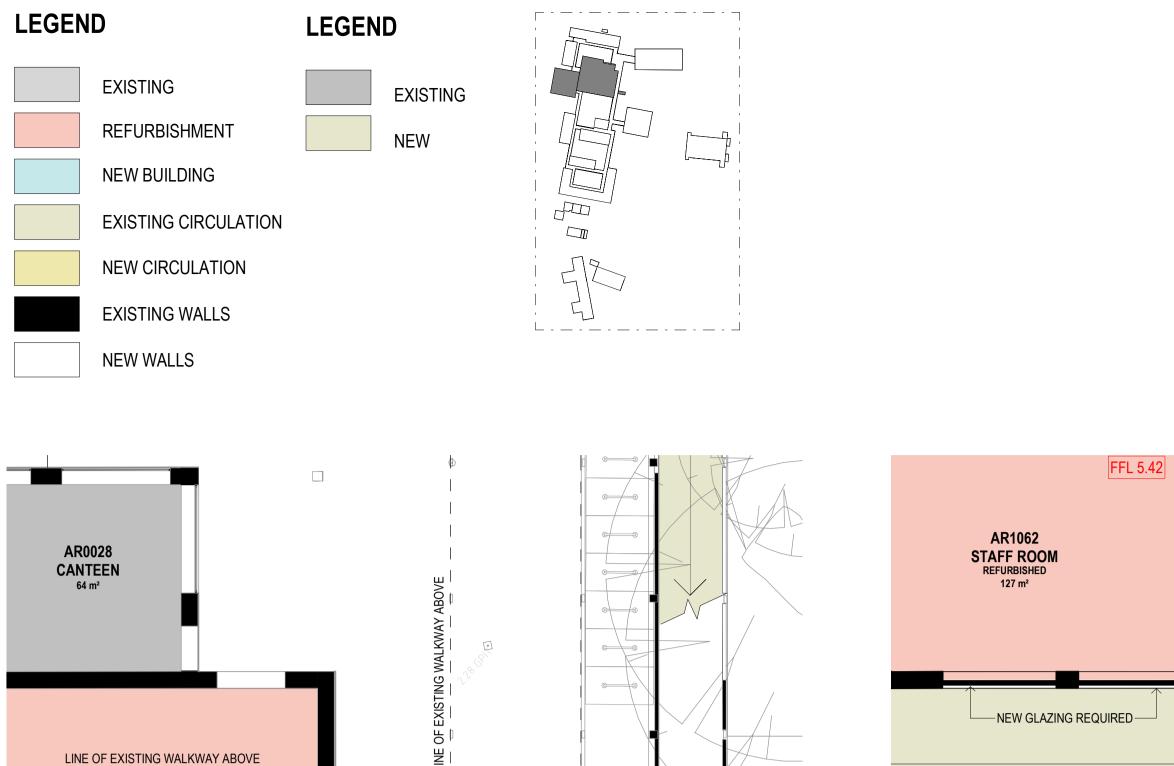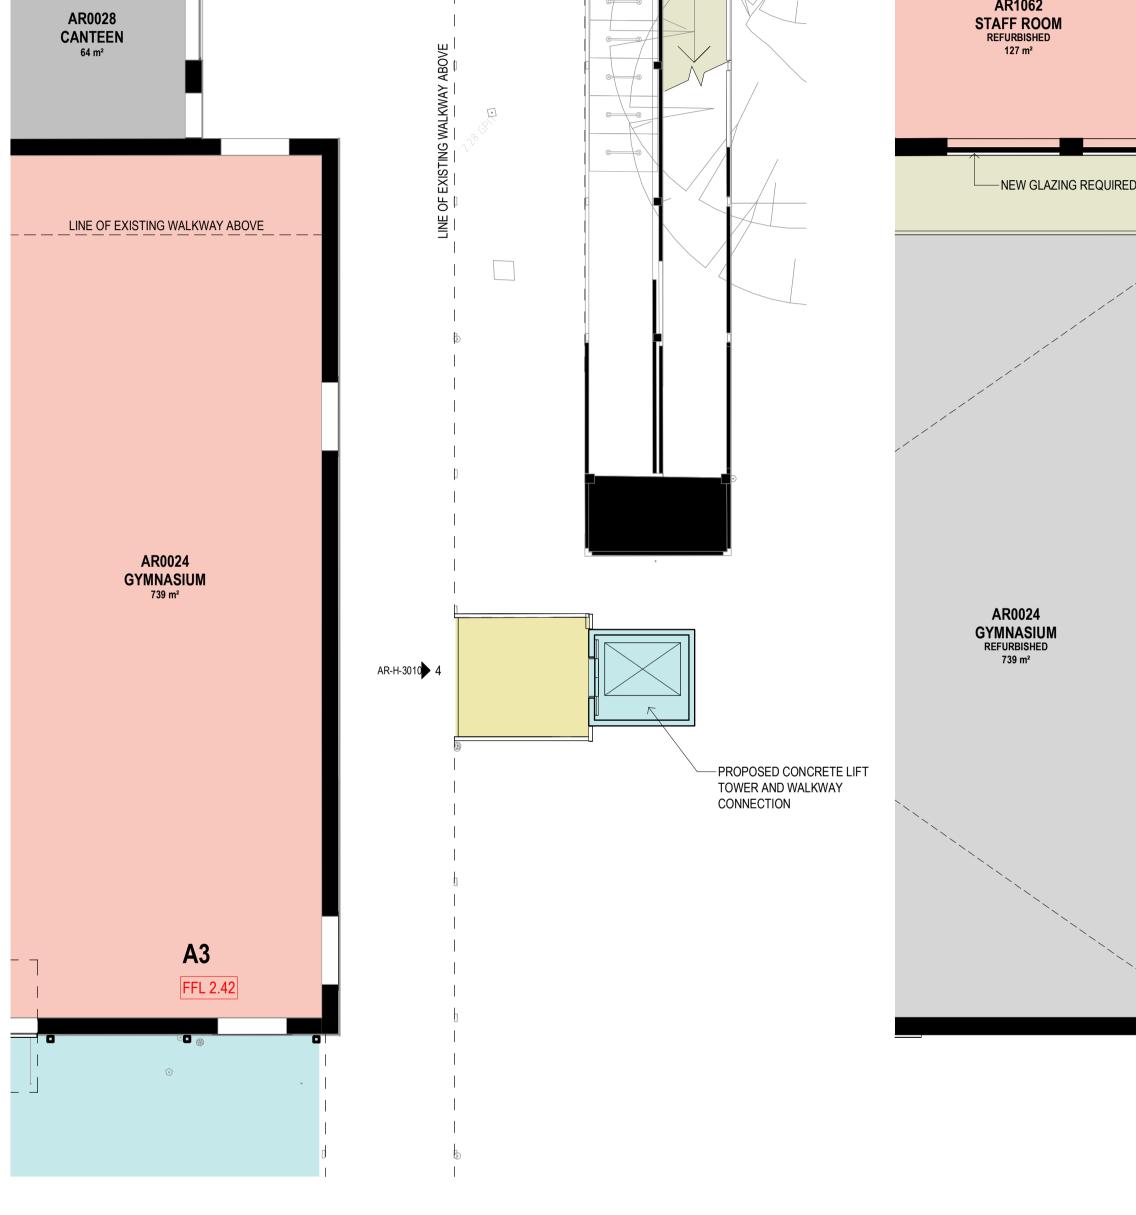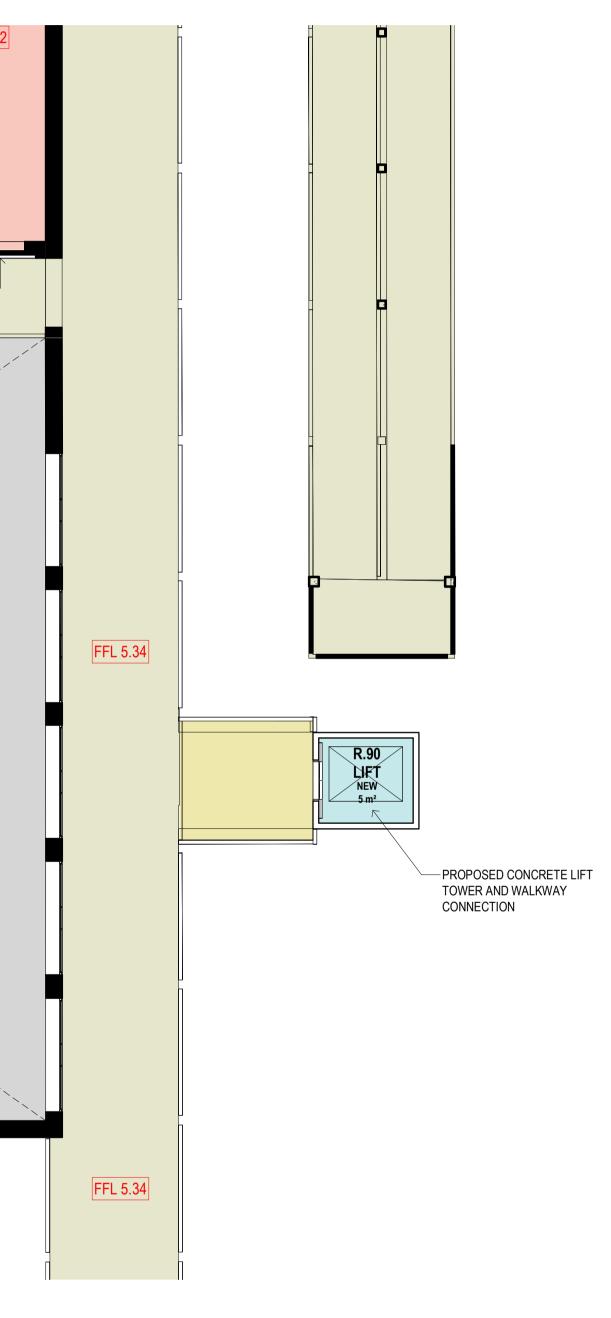
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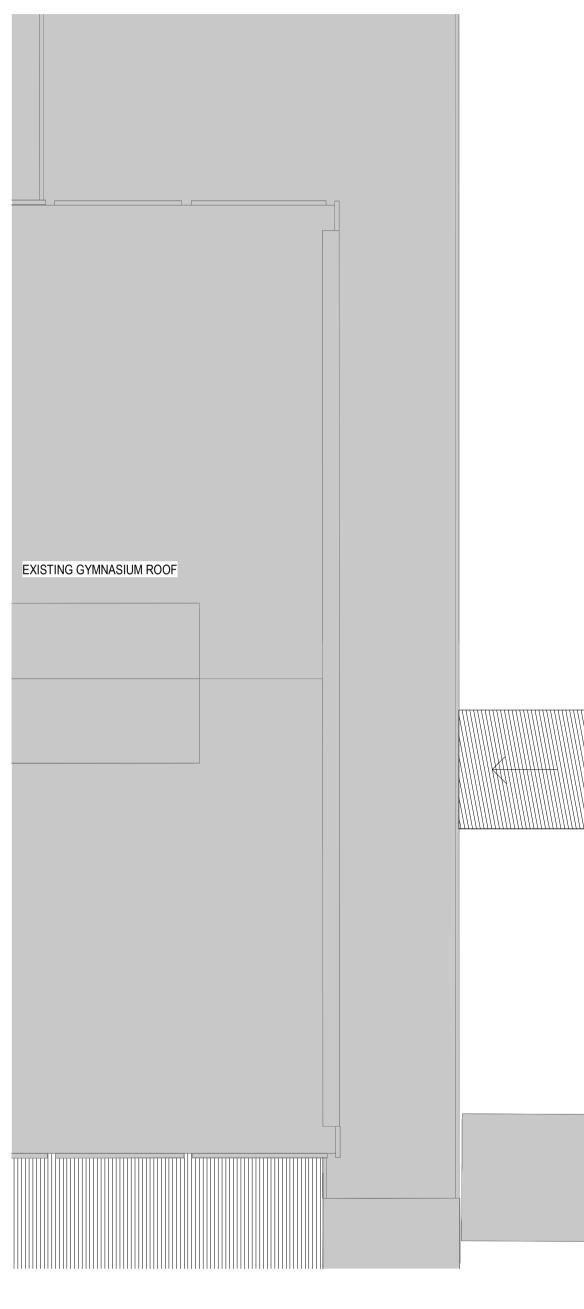




1 PROPOSED GROUND FLOOR PLAN - BLOCK A LIFT

2 PROPOSED LEVEL 1 PLAN - BLOCK A LIFT





3 PROPOSED ROOF PLAN - BLOCK A LIFT

1000 - GA PLANS

ARCH	ITECTURE:
0000	GENERAL & SITE INFORMATION
1000	GENERAL ARRANGEMENT PLANS
2000	GA RCPs
3000	GA SECTIONS & ELEVATIONS
4000	REFERENCE PLANS
5000	STRUCTURAL SET-OUT
6000	VERTICAL CIRCULATION
7000	INTERIOR DESIGN DETAILS
8000	EXTERIOR & FACADE DETAILS

9000 DRAWN SCHEDULES 9000 SCHEDULES & SPECIFICATIONS

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A 15/09/2022 ISSUE FOR DA

ARCHITECT

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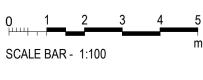
NARRABEEN SPORTS HIGH SCHOOL

DETAILS DRAWN CHECKED APPROVED

SCALE 1 : 100 @ A1

TITLE

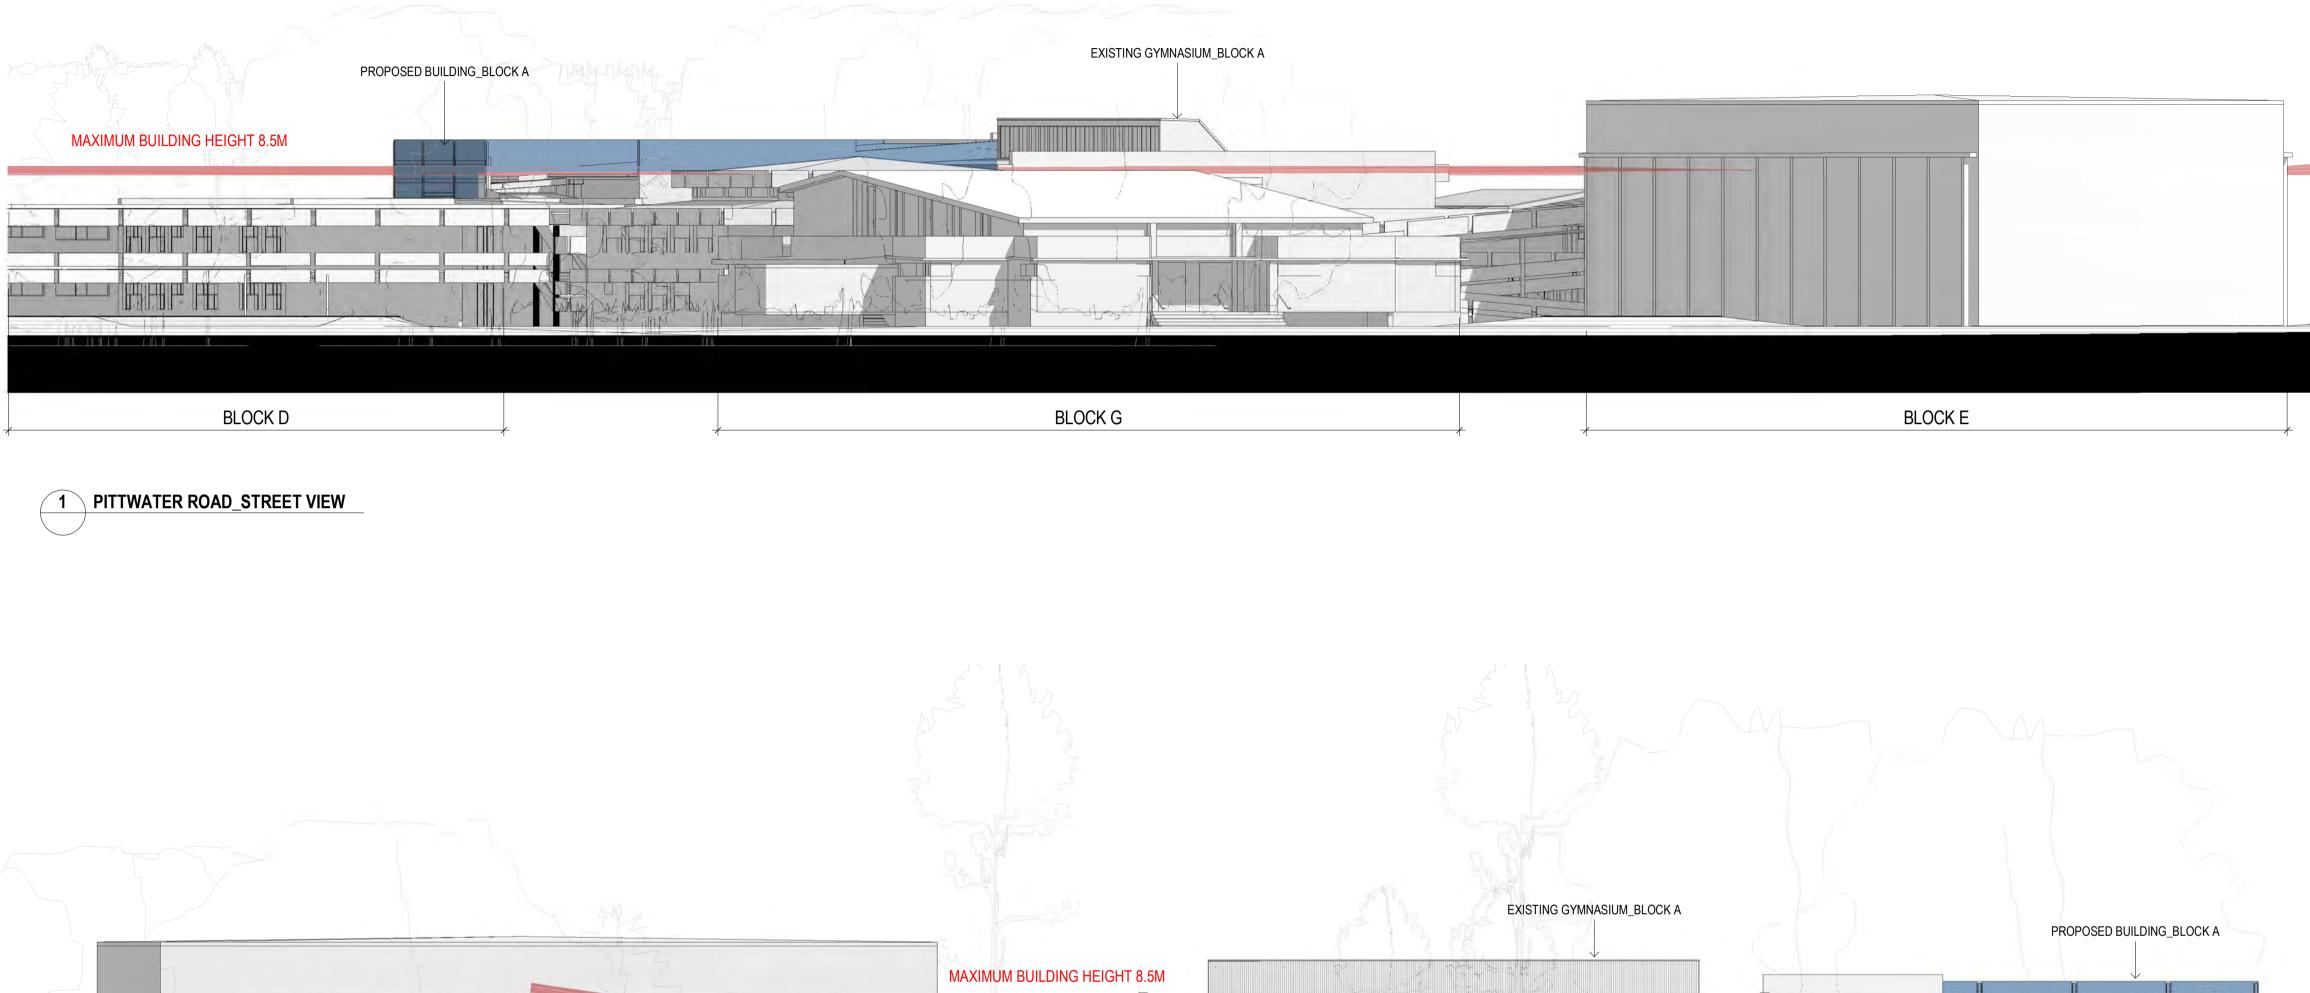
PROPOSED PLAN_ BLOCK A LIFT



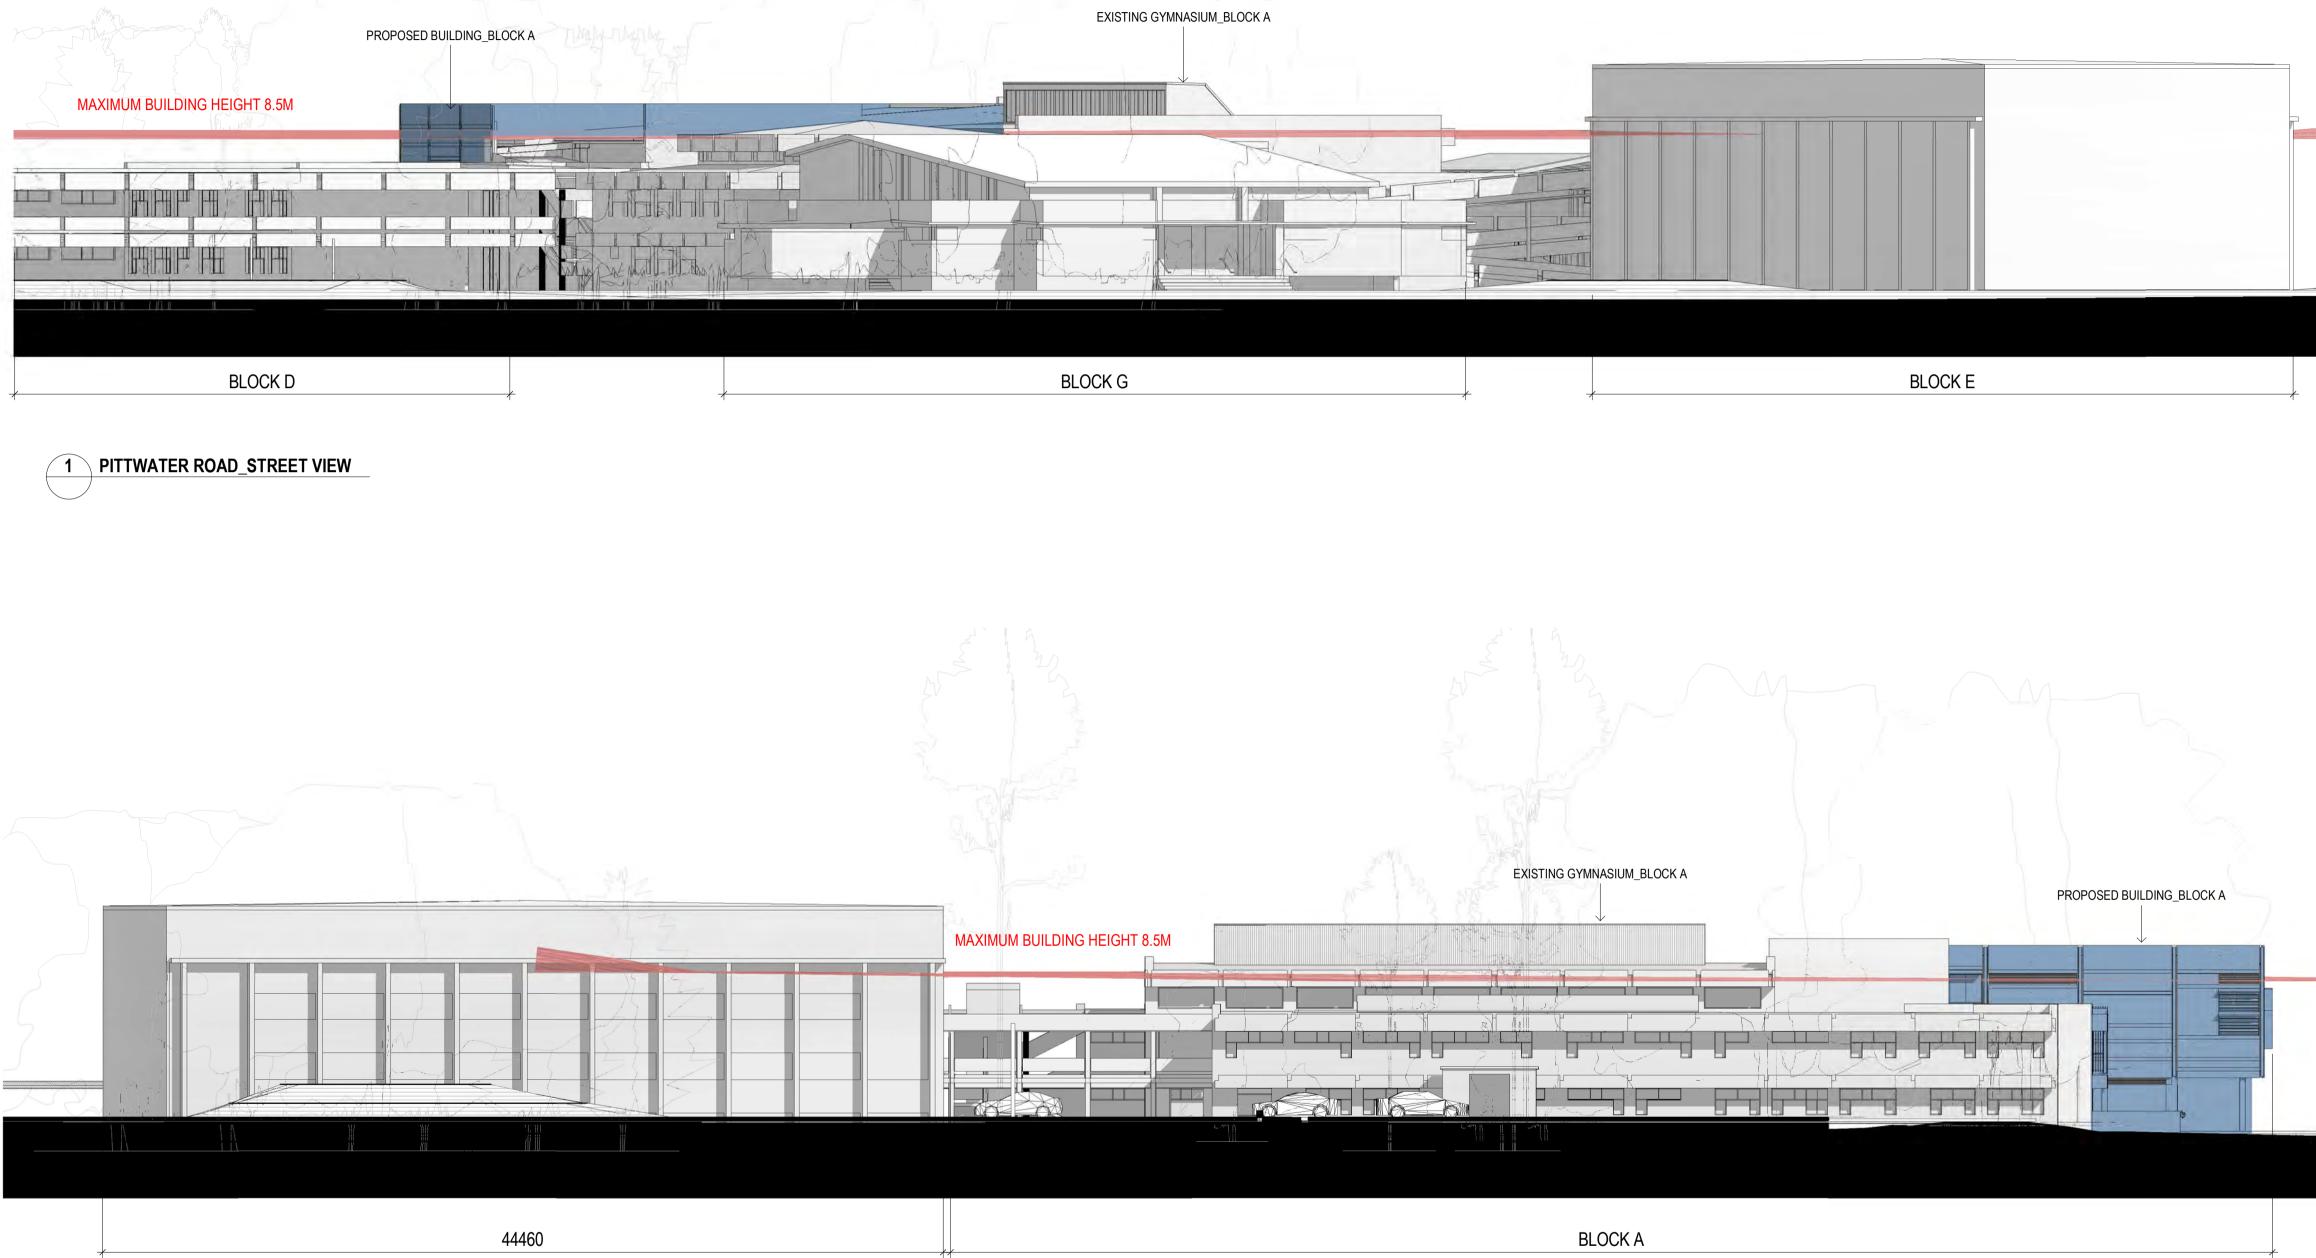
DRAWING NUMBER AR-H-1013













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3000 - ELEVATIONS & SECTIONS

ARCHITECTURE:

0000 GENERAL & SITE INFORMATION 1000 GENERAL ARRANGEMENT PLANS

2000 GA RCPs

- 3000 GA SECTIONS & ELEVATIONS
- 4000 REFERENCE PLANS
- 5000 STRUCTURAL SET-OUT
- 6000 VERTICAL CIRCULATION 7000 INTERIOR DESIGN DETAILS
- 8000 EXTERIOR & FACADE DETAILS
- 9000 DRAWN SCHEDULES
- 9000 SCHEDULES & SPECIFICATIONS

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2	09/09/2022	FOR INFORMATION	RF



ARCHITECT



VB

RF

СМ

Designinc Sydney Pty Ltd Level 14, 85 Castlereagh Street

Nominated Architects

Ian Armstrong 7260 | Cathryn Drew-Bredin 7269 | Richard Does 8126 | Mary Anne McGirr 10946 CLIENT





PROJECT NARRABEEN EDUCATION PRECINCT NAMONA ST, NORTH NARRABEEN NSW 2101

NARRABEEN SPORTS HIGH SCHOOL

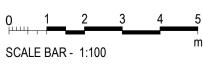
DETAILS DRAWN CHECKED APPROVED

SCALE As indicated @ A1



TITLE


ELEVATIONS- STREET ELEVATIONS



DRAWING NUMBER AR-H-3000 REVISION 2

Sydney NSW 2000 Australia +61 2 8905 7100

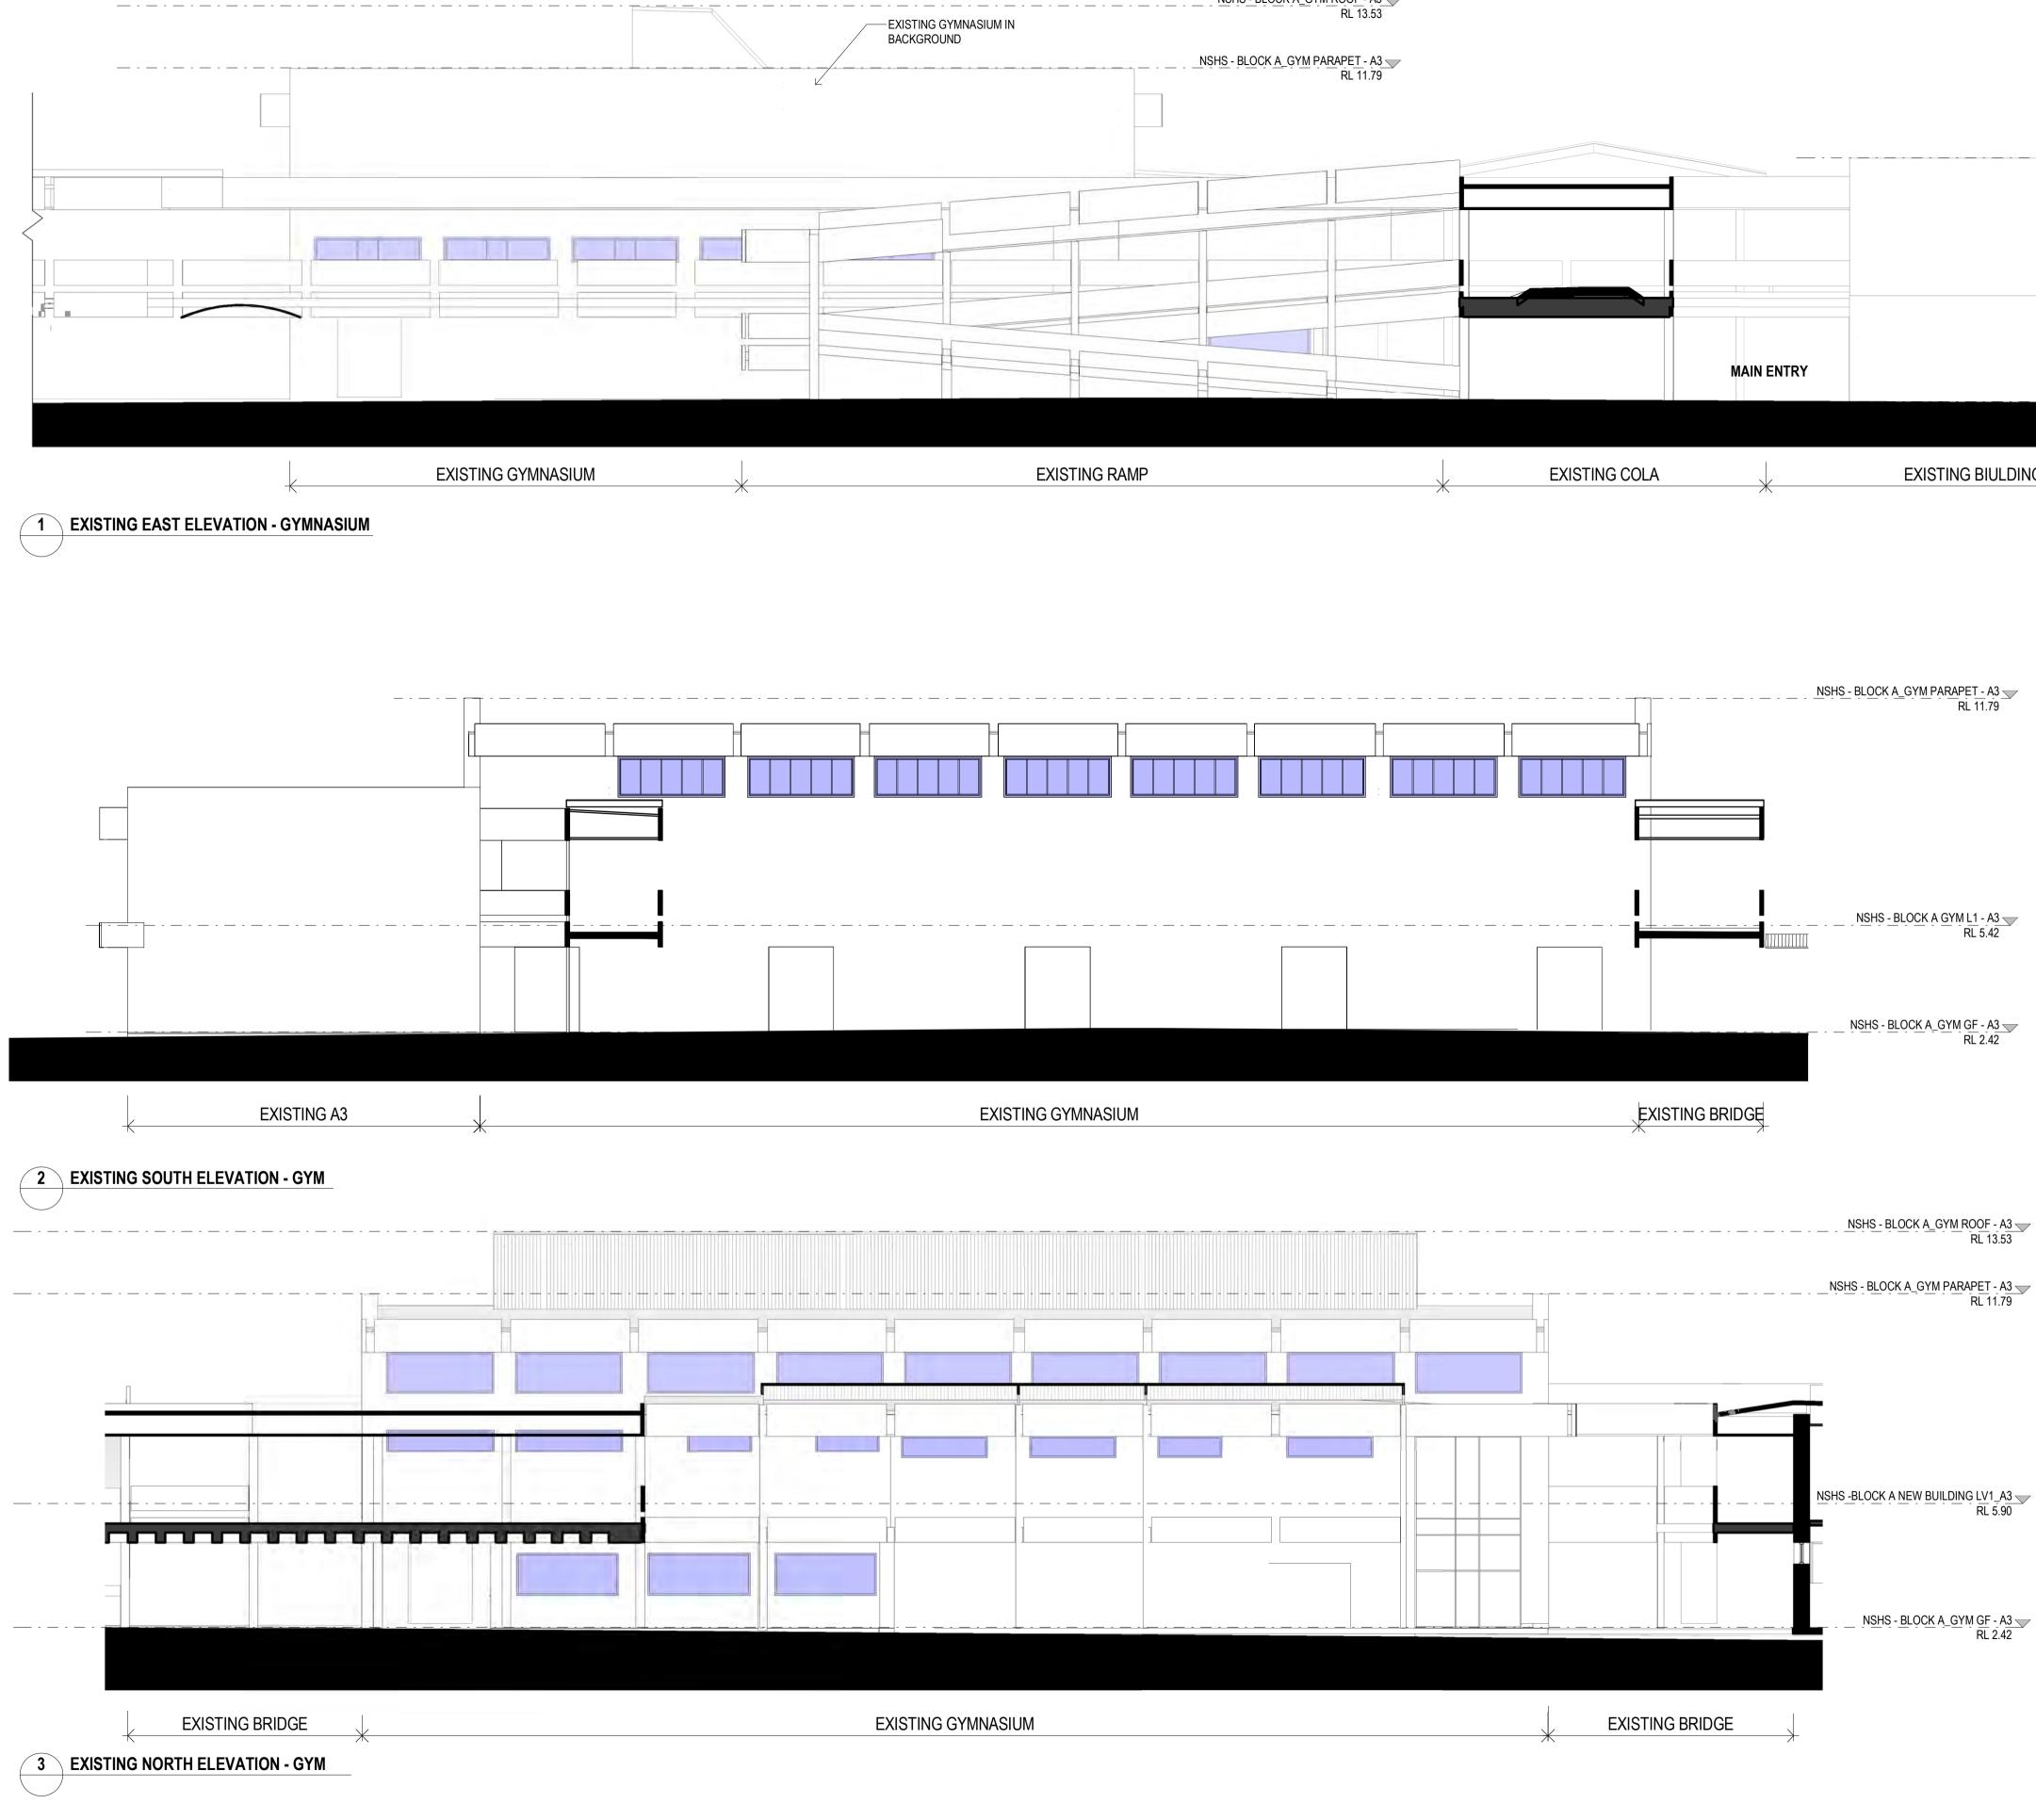sydney@designinc.com.au



	RL 11.79				
					,
					-
			MAIN ENTRY		
STING RAMP	×	EXISTING COLA	×	EXISTING BIULDING A1	\rightarrow

NSHS - BLOCK A_GYM ROOF - A3

3000 - ELEVATIONS & SECTIONS

ADOUNTEOTUDE

ARCH	ITECTURE:
0000	GENERAL & SITE INFORMATION
1000	GENERAL ARRANGEMENT PLANS
2000	GA RCPs
3000	GA SECTIONS & ELEVATIONS
4000	REFERENCE PLANS
5000	STRUCTURAL SET-OUT
6000	VERTICAL CIRCULATION
7000	INTERIOR DESIGN DETAILS
8000	EXTERIOR & FACADE DETAILS
9000	DRAWN SCHEDULES

9000 SCHEDULES & SPECIFICATIONS

NSHS -BLOCK A PARAPET_A1

NSHS -BLOCK A GF 1_A1 RL 2.42

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A 15/09/2022 ISSUE FOR DA

ARCHITECT

DesignInc

Designinc Sydney Pty Ltd Level 14, 85 Castlereagh Street Sydney NSW 2000 Australia +61 2 8905 7100 sydney@designinc.com.au

REVISION

Α

Nominated Architects

Ian Armstrong 7260 | Cathryn Drew-Bredin 7269 | Richard Does 8126 | Mary Anne McGirr 10946 CLIENT





PROJECT NARRABEEN EDUCATION PRECINCT NAMONA ST, NORTH NARRABEEN NSW 2101

NARRABEEN SPORTS HIGH SCHOOL

DETAILS DRAWN CHECKED APPROVED

SCALE 1 : 100 @ A1

TITLE

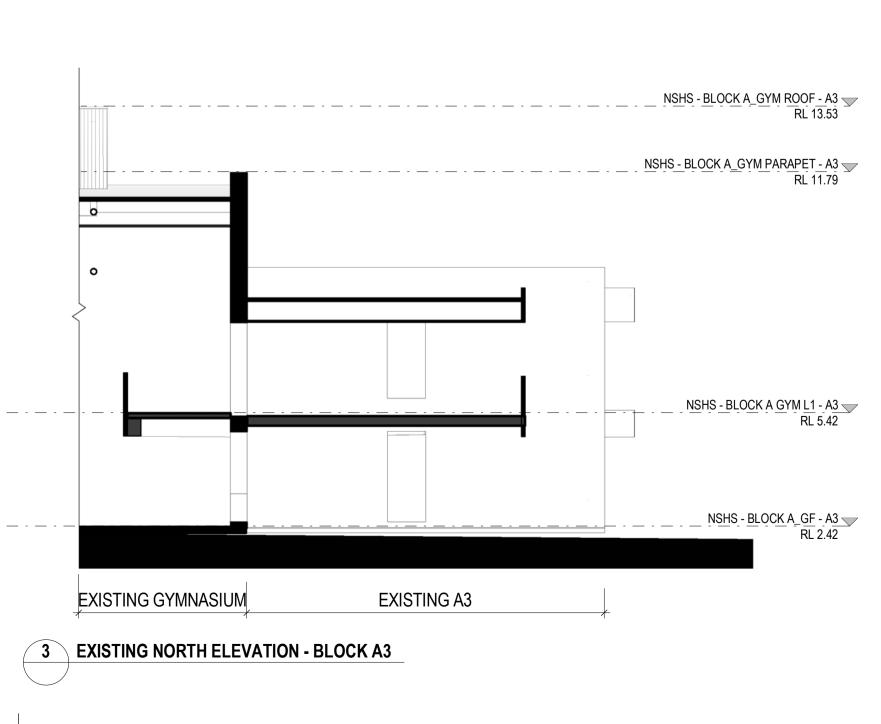
EXISTING ELEVATION - BLOCK A3

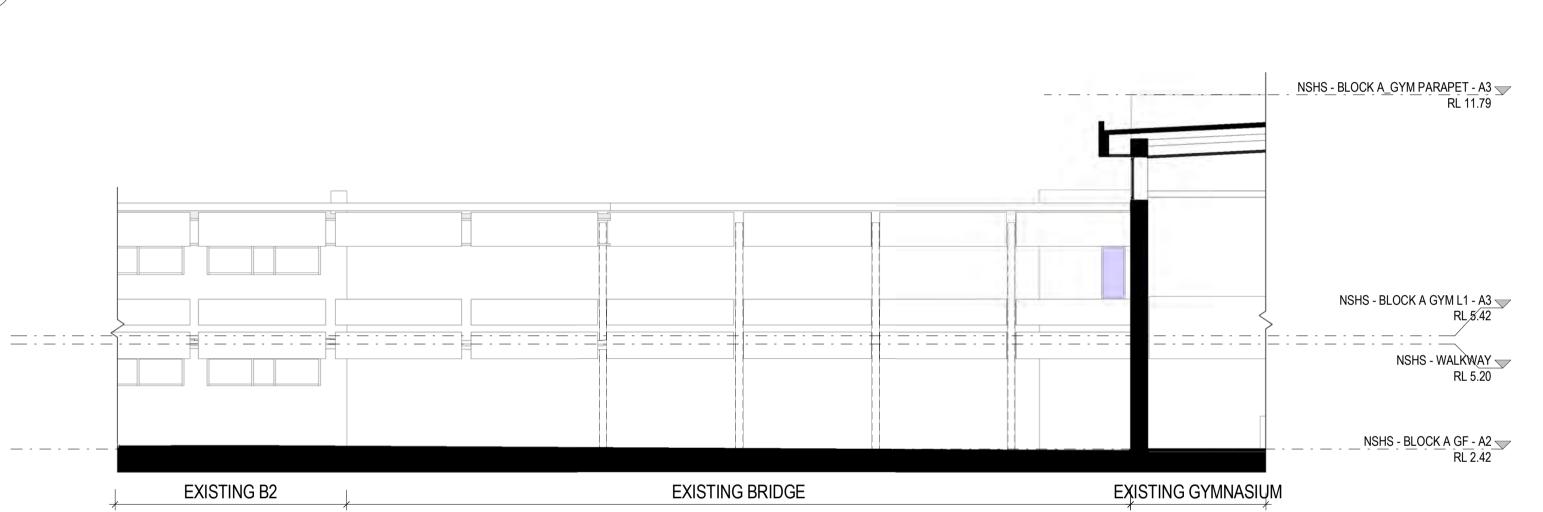
DRAWING NUMBER AR-H-3005

JJ

RF СМ

SCALE BAR - 1:100





1 EXISTING WEST ELEVATION- BLOCK A2 AND A3

2 EXISTING EAST ELEVATION - BLOCK A3



3000 - ELEVATIONS & SECTIONS

ARCHITECTURE:

0000 GENERAL & SITE INFORMATION 1000 GENERAL ARRANGEMENT PLANS

2000 GA RCPs

- 3000 GA SECTIONS & ELEVATIONS
- 4000 REFERENCE PLANS 5000 STRUCTURAL SET-OUT
- 6000 VERTICAL CIRCULATION
- 7000 INTERIOR DESIGN DETAILS
- 8000 EXTERIOR & FACADE DETAILS
- 9000 DRAWN SCHEDULES
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ARCHITECT

DesignInc

Designinc Sydney Pty Ltd Level 14, 85 Castlereagh Street Sydney NSW 2000 Australia +61 2 8905 7100 sydney@designinc.com.au

REVISION

Α

Nominated Architects

Ian Armstrong 7260 | Cathryn Drew-Bredin 7269 | Richard Does 8126 | Mary Anne McGirr 10946 CLIENT





PROJECT NARRABEEN EDUCATION PRECINCT NAMONA ST, NORTH NARRABEEN NSW 2101

NARRABEEN SPORTS HIGH SCHOOL

DETAILS DRAWN CHECKED APPROVED

SCALE 1 : 100 @ A1

TITLE



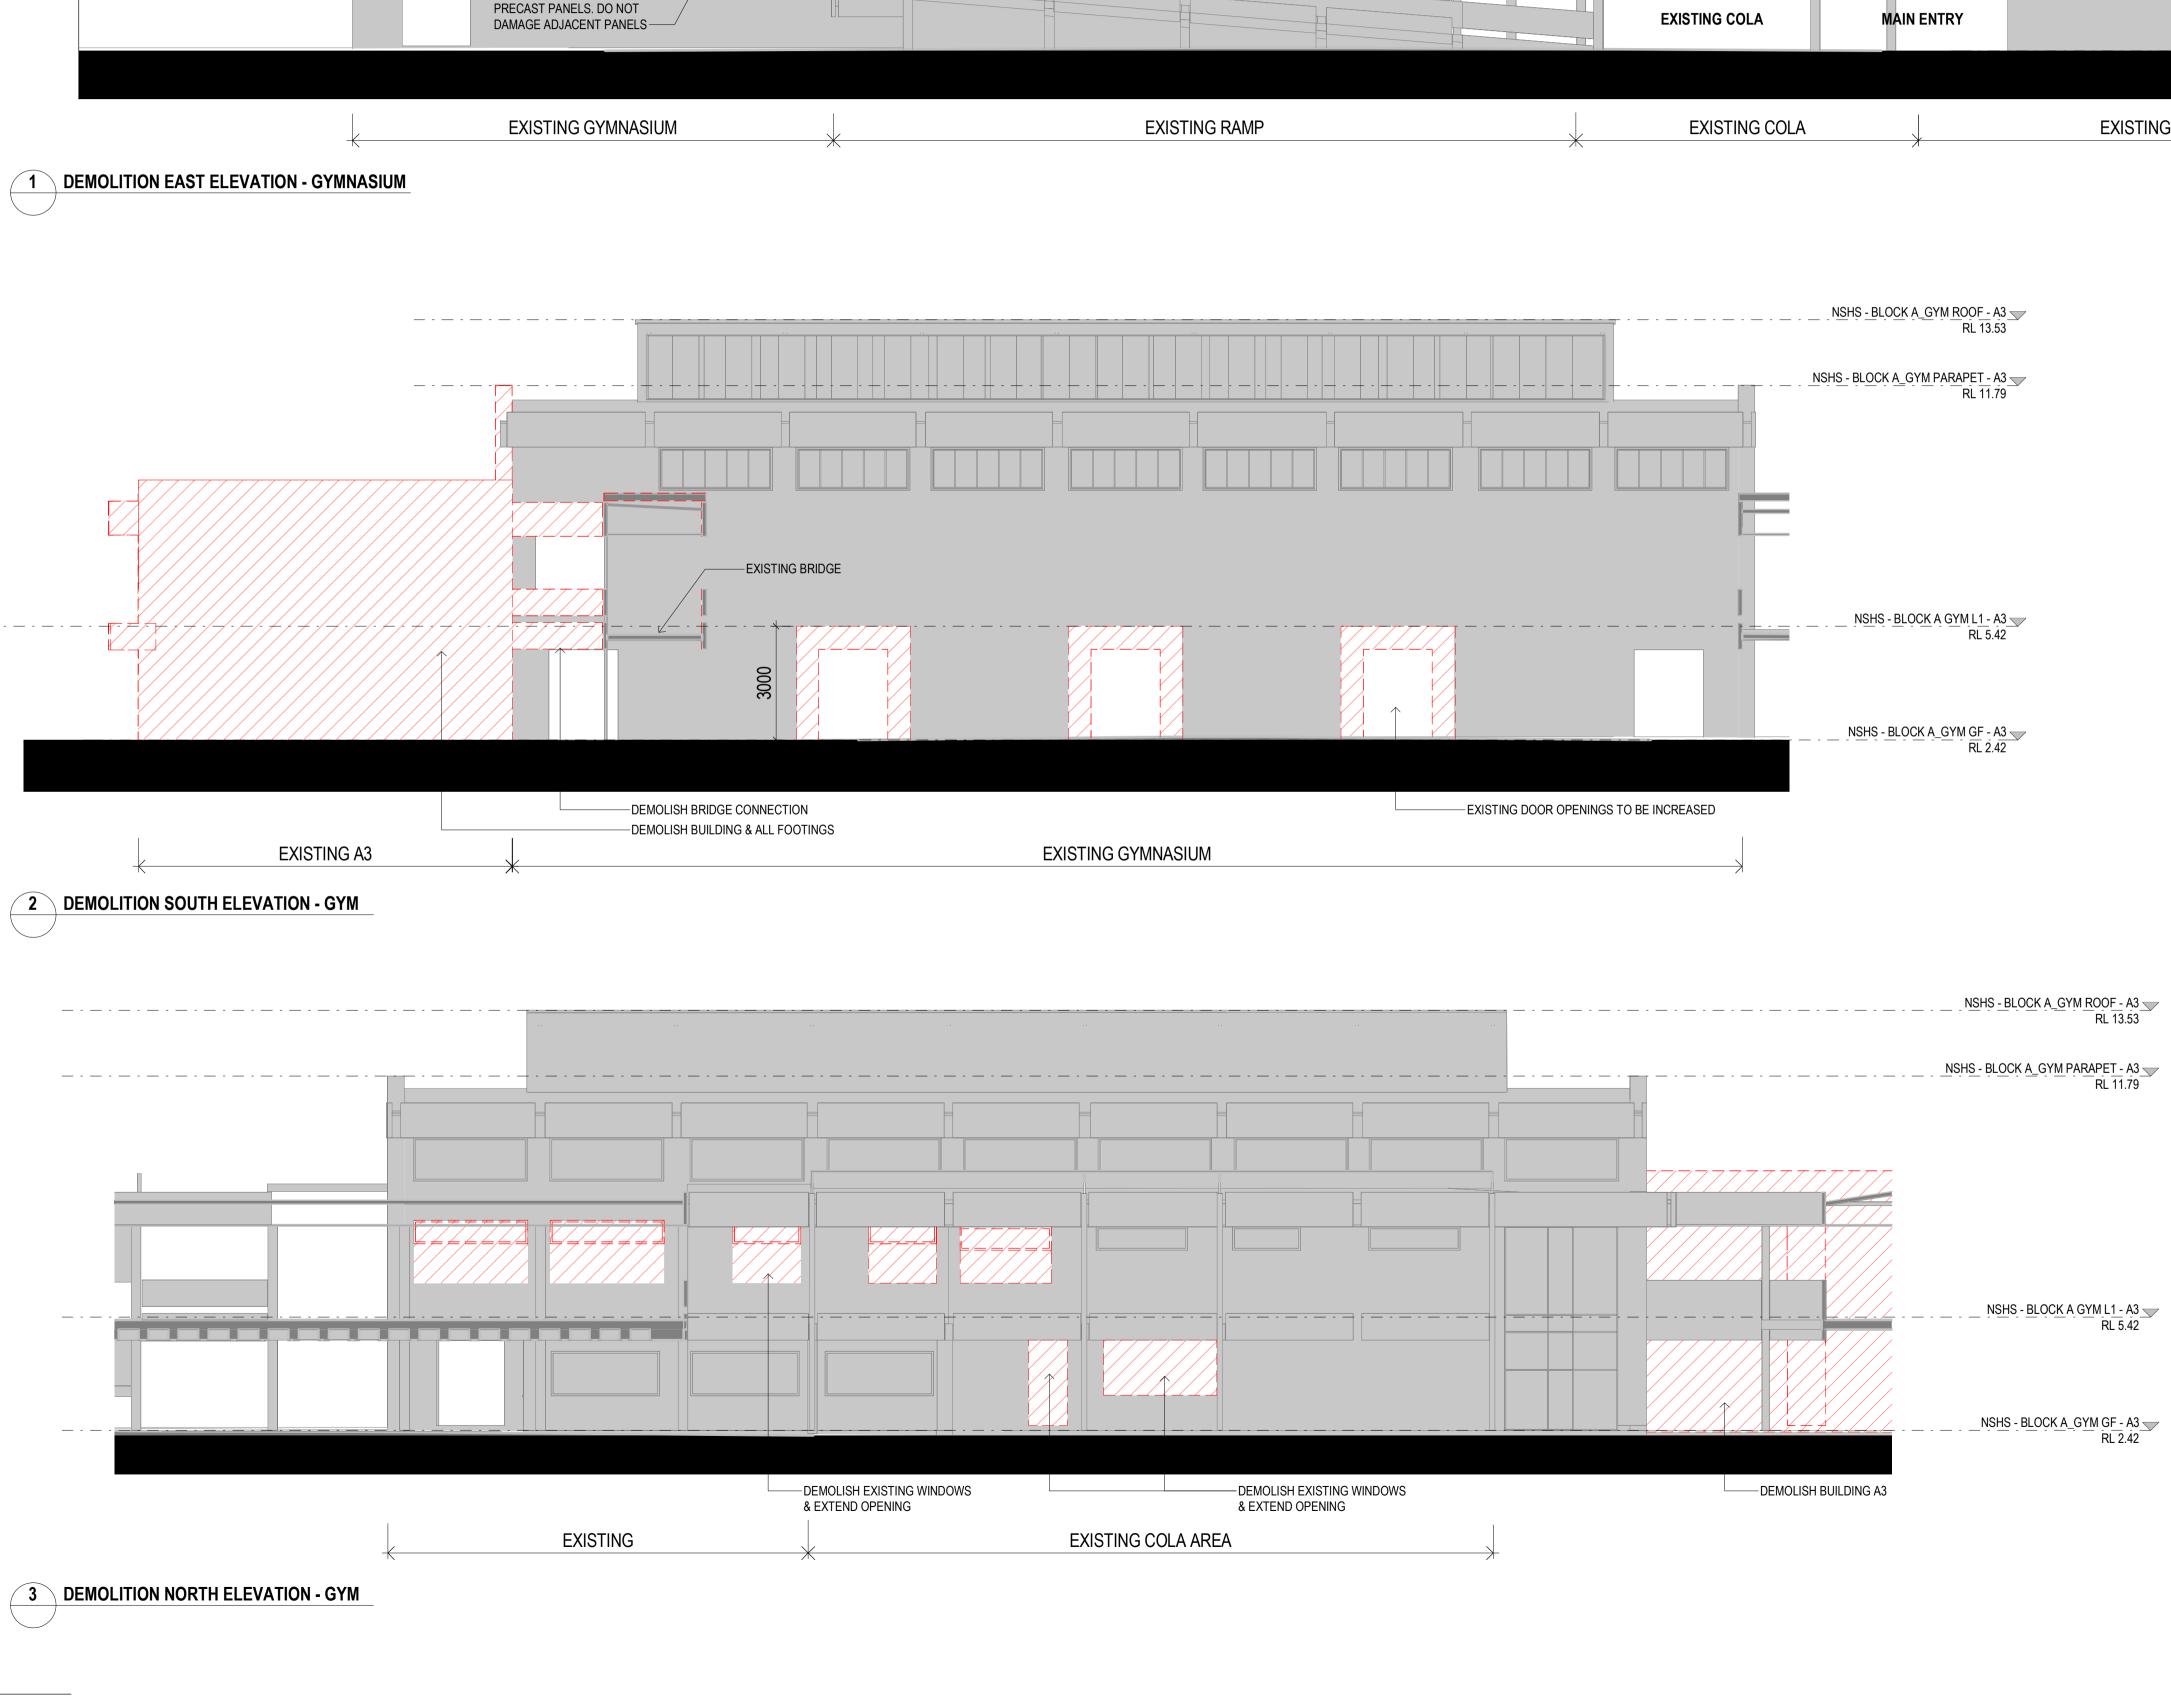
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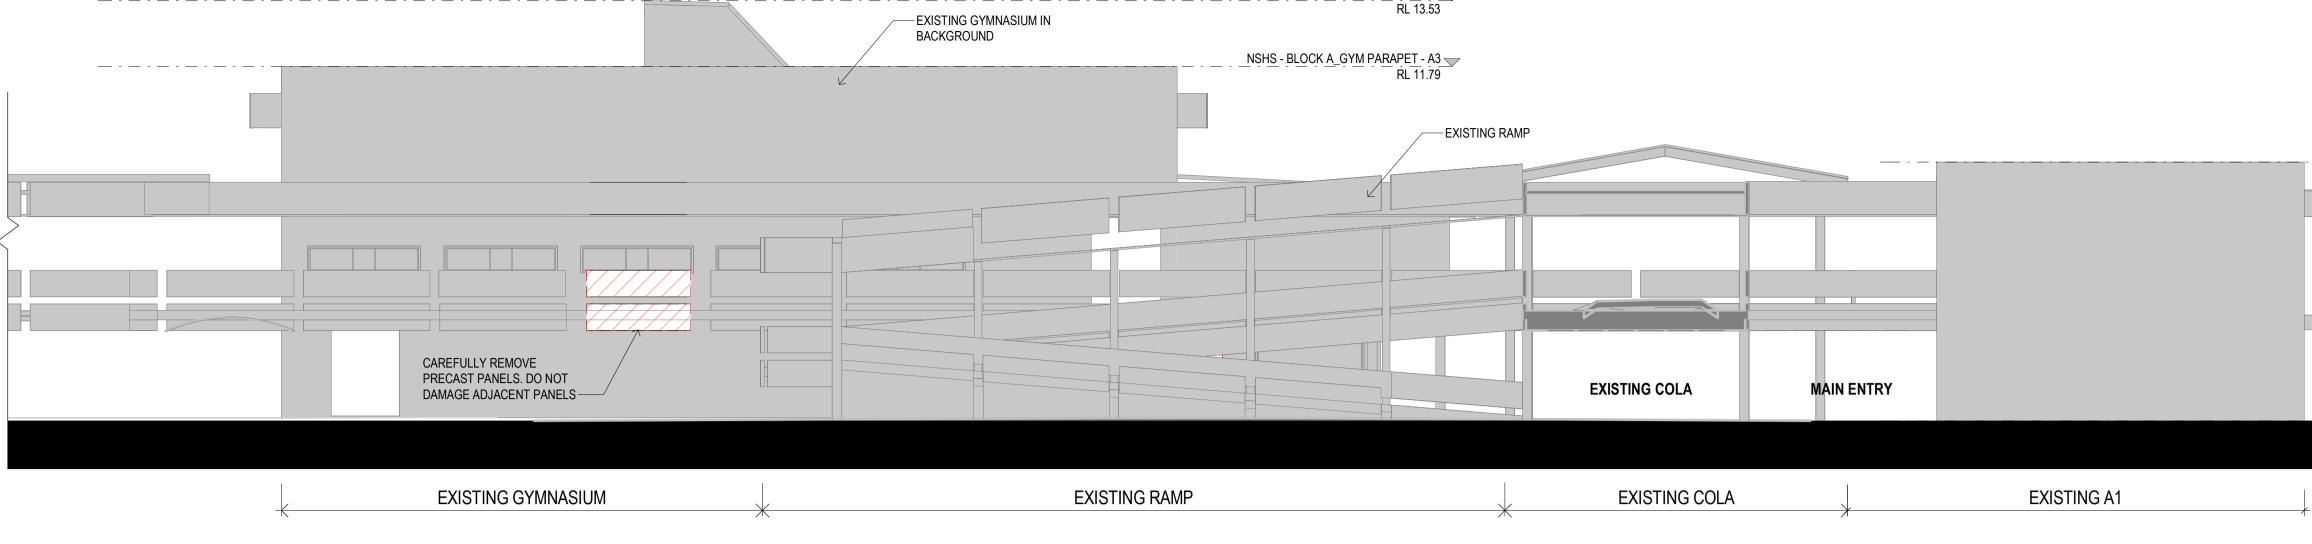
JJ

RF

СМ

μ 2 3 SCALE BAR - 1:100





NSHS - BLOCK A_GYM ROOF - A3

3000 - ELEVATIONS & SECTIONS

ARCHITECTURE:

ANGH	ILCIURE.
0000	GENERAL & SITE INFORMATION
1000	GENERAL ARRANGEMENT PLANS
2000	GA RCPs
3000	GA SECTIONS & ELEVATIONS
4000	REFERENCE PLANS
5000	STRUCTURAL SET-OUT
6000	VERTICAL CIRCULATION
7000	INTERIOR DESIGN DETAILS
8000	EXTERIOR & FACADE DETAILS
9000	DRAWN SCHEDULES
9000	SCHEDULES & SPECIFICATIONS

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NSHS -BLOCK A PARAPET_A1

NSHS -BLOCK A GF 1_A1

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ARCHITECT

DesignInc

Designinc Sydney Pty Ltd Level 14, 85 Castlereagh Street Sydney NSW 2000 Australia +61 2 8905 7100 sydney@designinc.com.au

RF

Nominated Architects

Ian Armstrong 7260 | Cathryn Drew-Bredin 7269 | Richard Does 8126 | Mary Anne McGirr 10946 CLIENT





PROJECT NARRABEEN EDUCATION PRECINCT NAMONA ST, NORTH NARRABEEN NSW 2101

NARRABEEN SPORTS HIGH SCHOOL

DETAILS DRAWN CHECKED APPROVED

SCALE

TITLE



JJ

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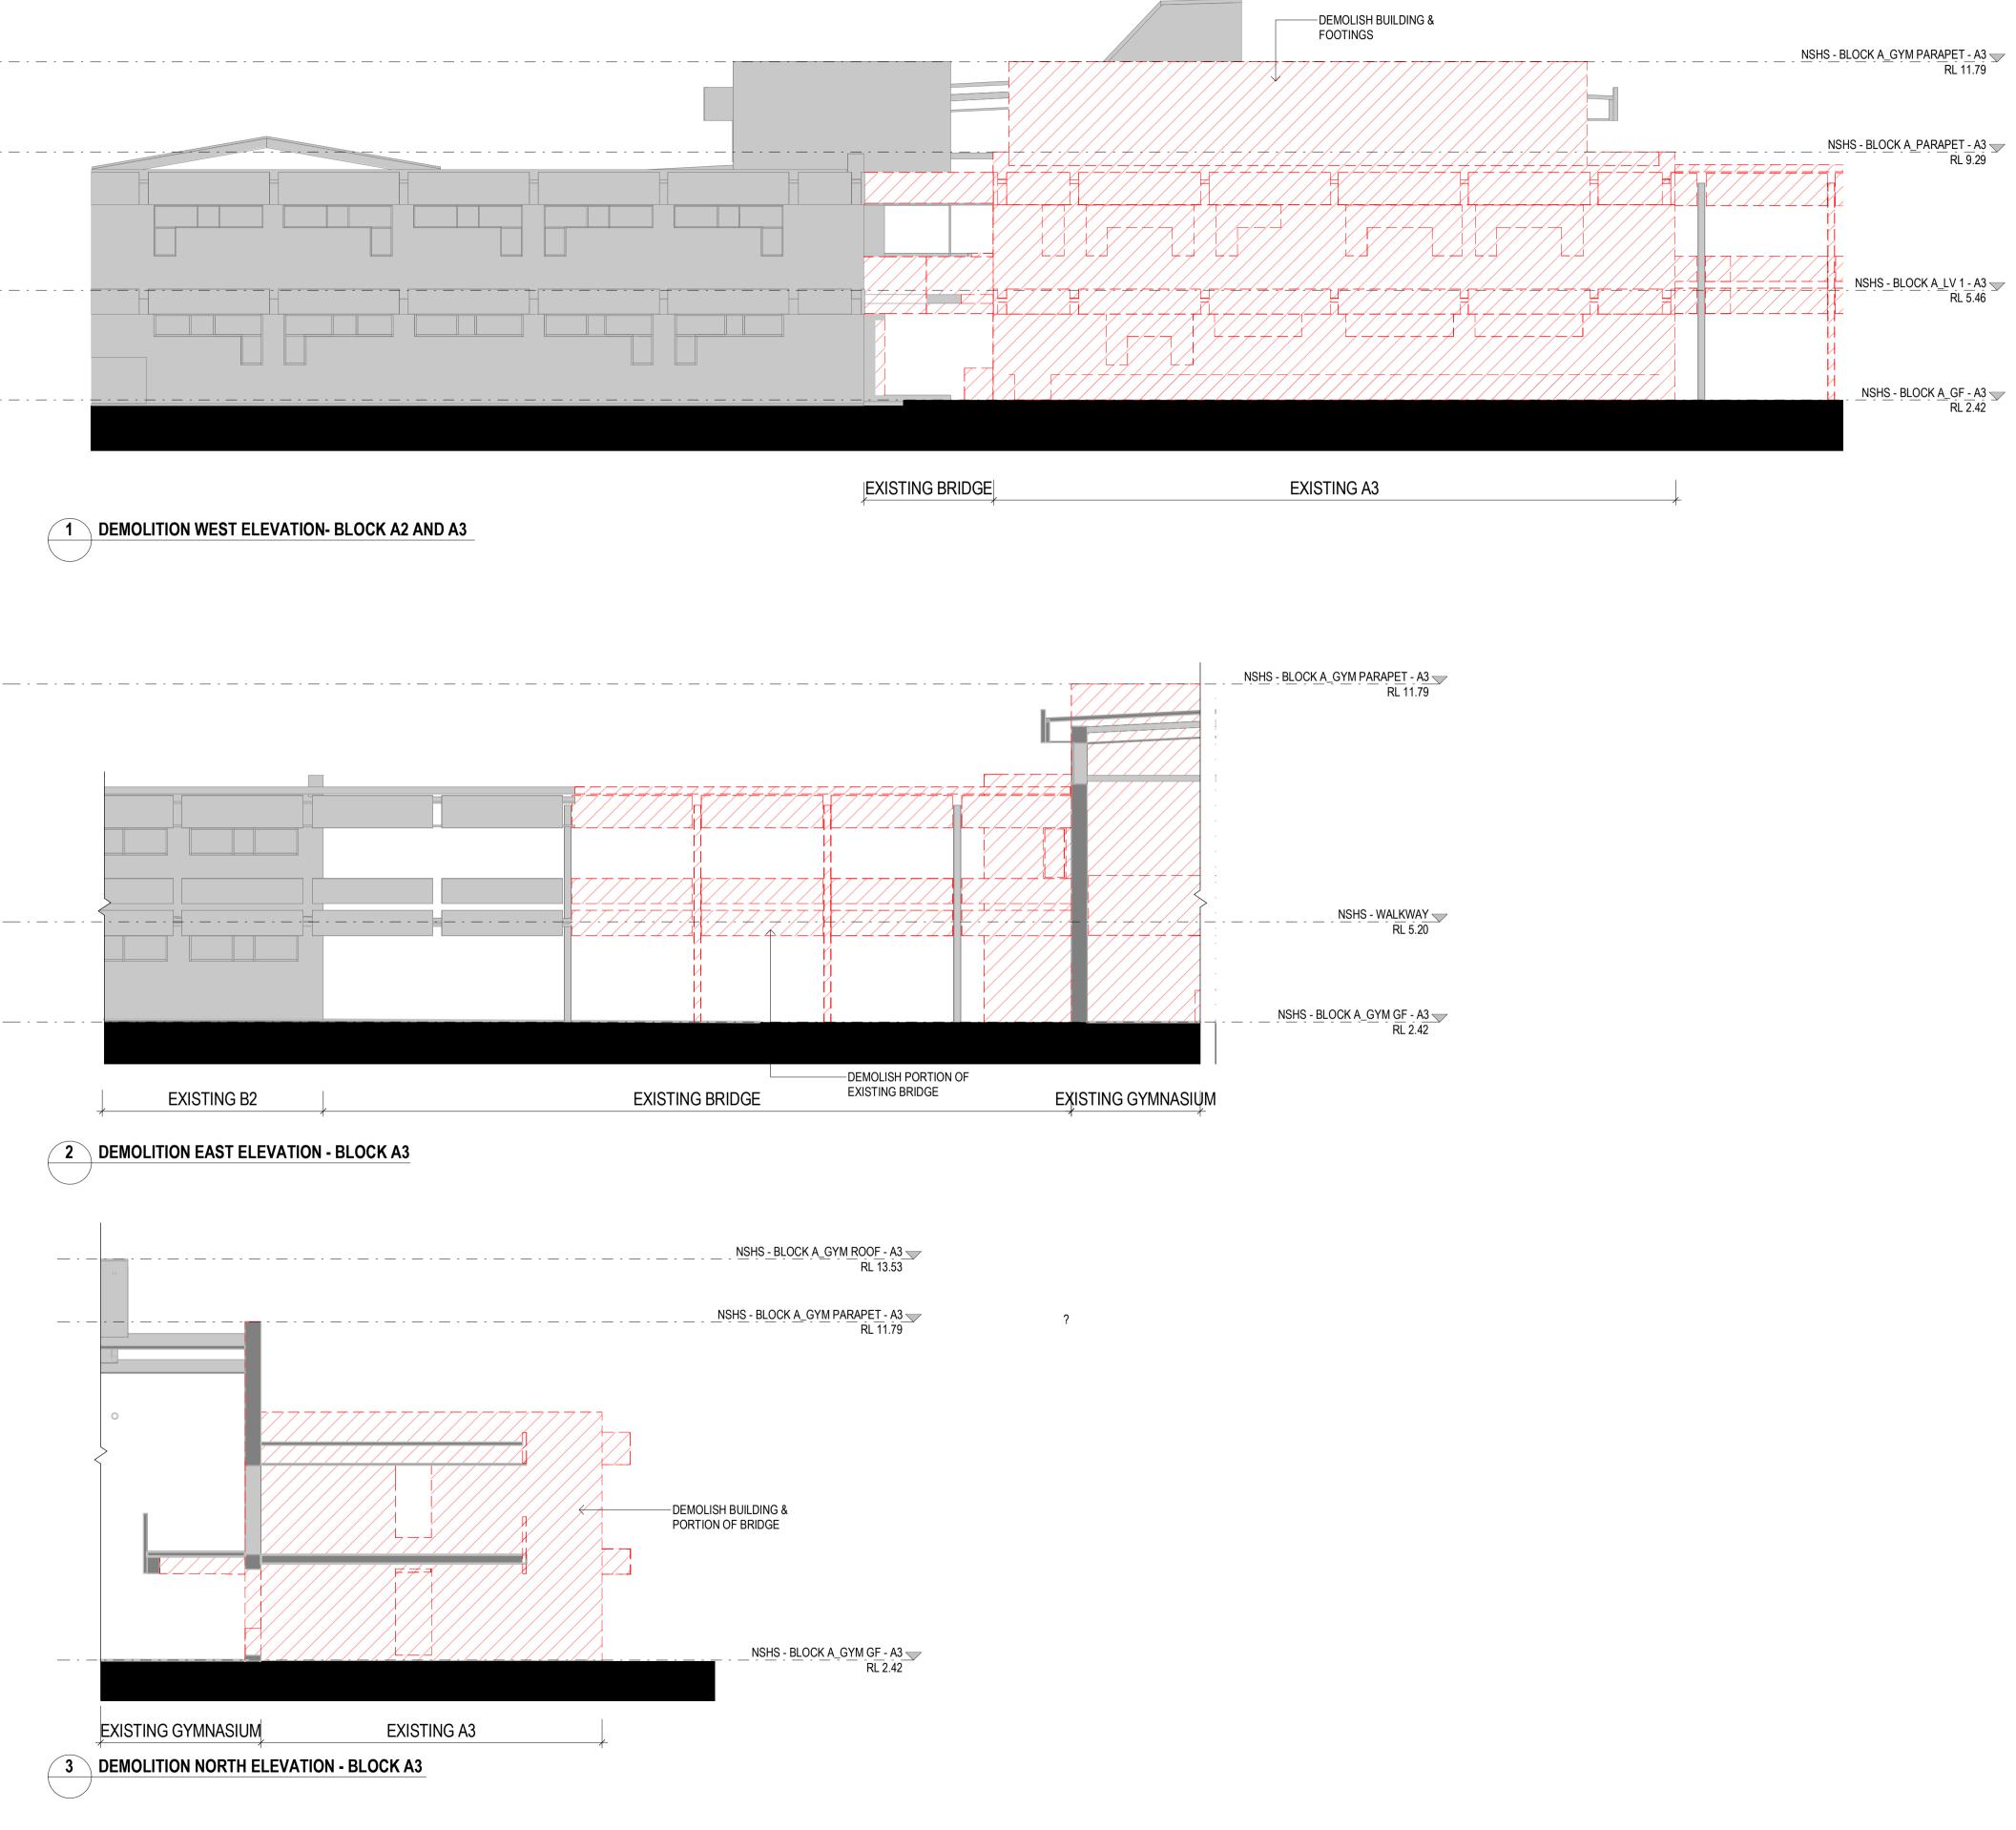
1 : 100 @ A1





_ . _ . _ . _ . _ 2 3 SCALE BAR - 1:100





3000 - ELEVATIONS & SECTIONS

ARCHITECTURE:

0000 GENERAL & SITE INFORMATION 1000 GENERAL ARRANGEMENT PLANS

2000 GA RCPs

- 3000 GA SECTIONS & ELEVATIONS
- 4000 REFERENCE PLANS 5000 STRUCTURAL SET-OUT
- 6000 VERTICAL CIRCULATION
- 7000 INTERIOR DESIGN DETAILS
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PROJECT NARRABEEN EDUCATION PRECINCT NAMONA ST, NORTH NARRABEEN NSW 2101

NARRABEEN SPORTS HIGH SCHOOL

DETAILS DRAWN CHECKED APPROVED

SCALE

RF

JJ

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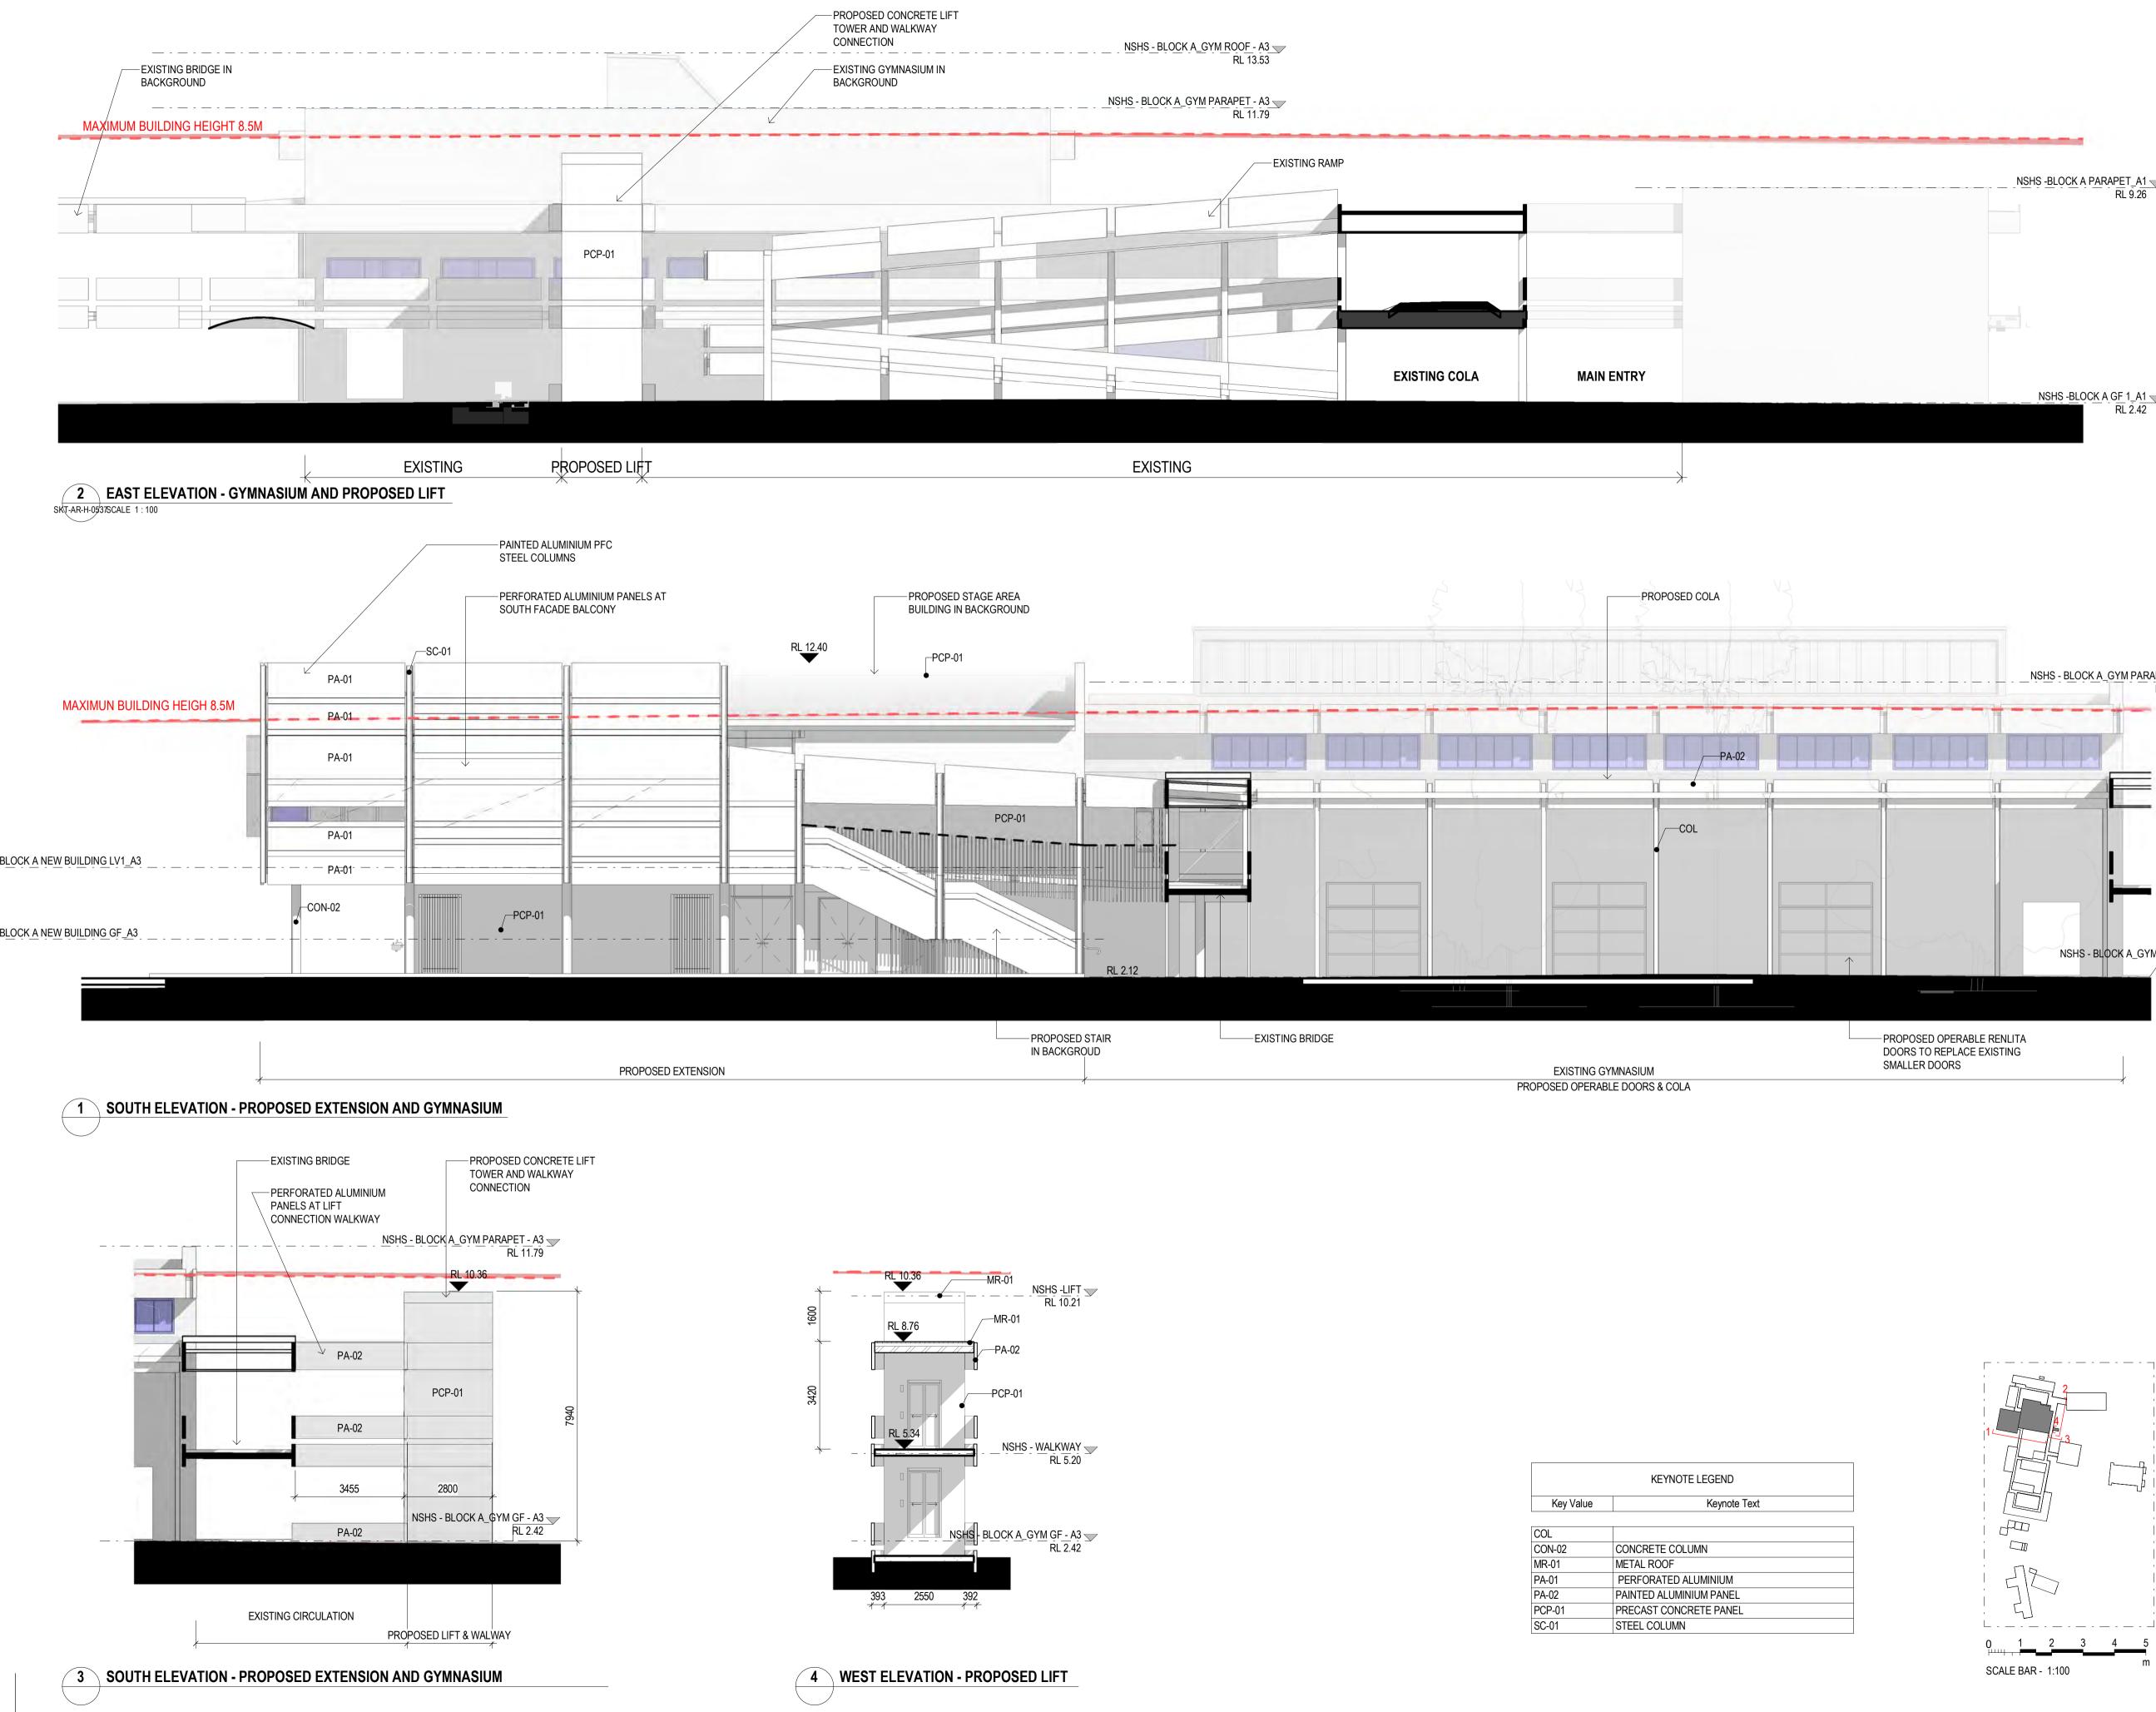
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TITLE



DRAWING NUMBER AR-H-3008

μŪ 2 3 SCALE BAR - 1:100



KEYNOTE LEGEND			
Key Value Keynote Text			
COL			
CON-02	CONCRETE COLUMN		
MR-01	METAL ROOF		
PA-01	PERFORATED ALUMINIUM		
PA-02	PAINTED ALUMINIUM PANEL		
PCP-01	PRECAST CONCRETE PANEL		
SC-01	STEEL COLUMN		

	3000 - ELEVATIONS & SECTIONS	
NSHS -BLOCK A PARAPET_A1	ARCHITECTURE:0000GENERAL & SITE INFORMATION1000GENERAL ARRANGEMENT PLANS2000GA RCPs3000GA SECTIONS & ELEVATIONS4000REFERENCE PLANS5000STRUCTURAL SET-OUT6000VERTICAL CIRCULATION7000INTERIOR DESIGN DETAILS8000EXTERIOR & FACADE DETAILS9000DRAWN SCHEDULES9000SCHEDULES & SPECIFICATIONS	
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NSHS - BLOCK A_GYM PARAPET - A3	comply with N.C.C. statutory authorities and relevant Australian	
	NoDATEREVISIONS126/05/2022SCHEMATIC DESIGN - DRAFT208/06/2022PRE-DA - DRAFT329/06/2022FOR INFORMATION412/07/2022FOR INFORMATION502/08/2022FOR CONSULTANT603/08/2022FOR INFORMATION703/09/2022FOR REVIEW809/09/2022FOR INFORMATIONA15/09/2022ISSUE FOR DA	BY JO JO RF RF TJF RF
NSHS - BLOCK A_GYM GF - A3 RL 2.42		

ARCHITECT

DesignInc

Designinc Sydney Pty Ltd Level 14, 85 Castlereagh Street Sydney NSW 2000 Australia +61 2 8905 7100 sydney@designinc.com.au

Nominated Architects

Ian Armstrong 7260 | Cathryn Drew-Bredin 7269 | Richard Does 8126 | Mary Anne McGirr 10946





PROJECT NARRABEEN EDUCATION PRECINCT NAMONA ST, NORTH NARRABEEN NSW 2101

NARRABEEN SPORTS HIGH SCHOOL

DETAILS DRAWN CHECKED APPROVED


VB, JJ RF Approver

SCALE 1 : 100 @ A1


TITLE **PROPOSED ELEVATIONS- BLOCK A- SOUTH** AND EAST

DRAWING NUMBER AR-H-3010

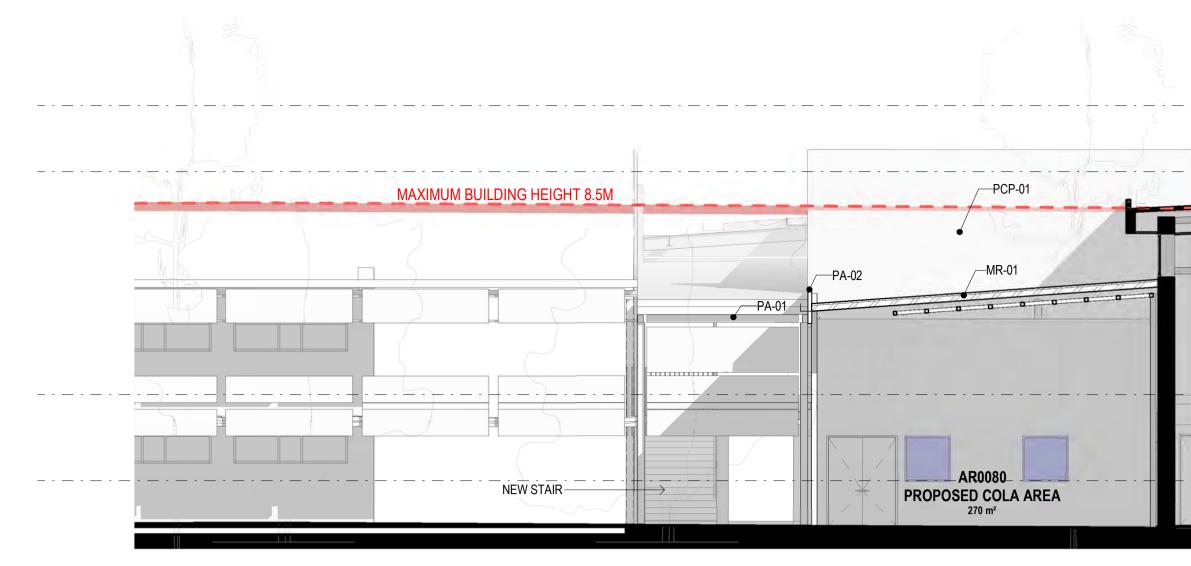
REVISION А



1 EAST ELEVATION - BLOCK A

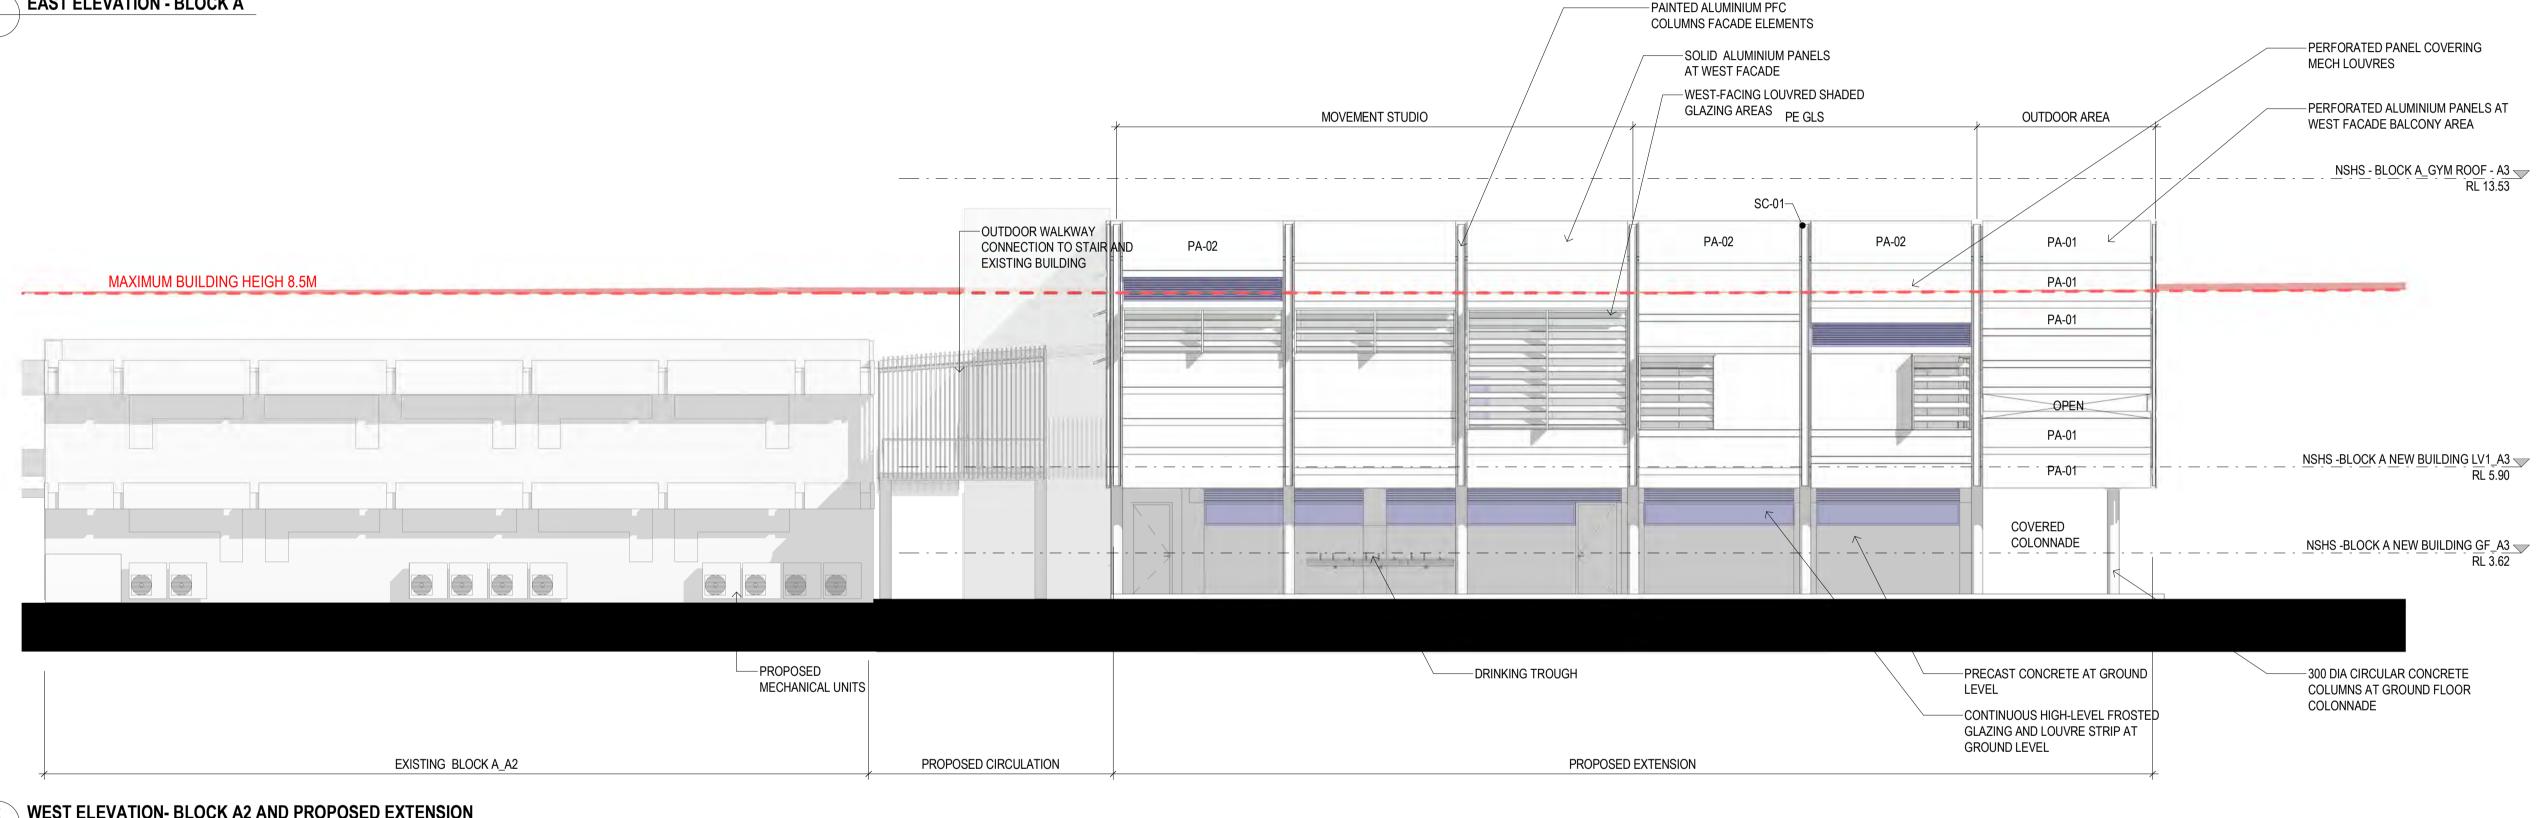

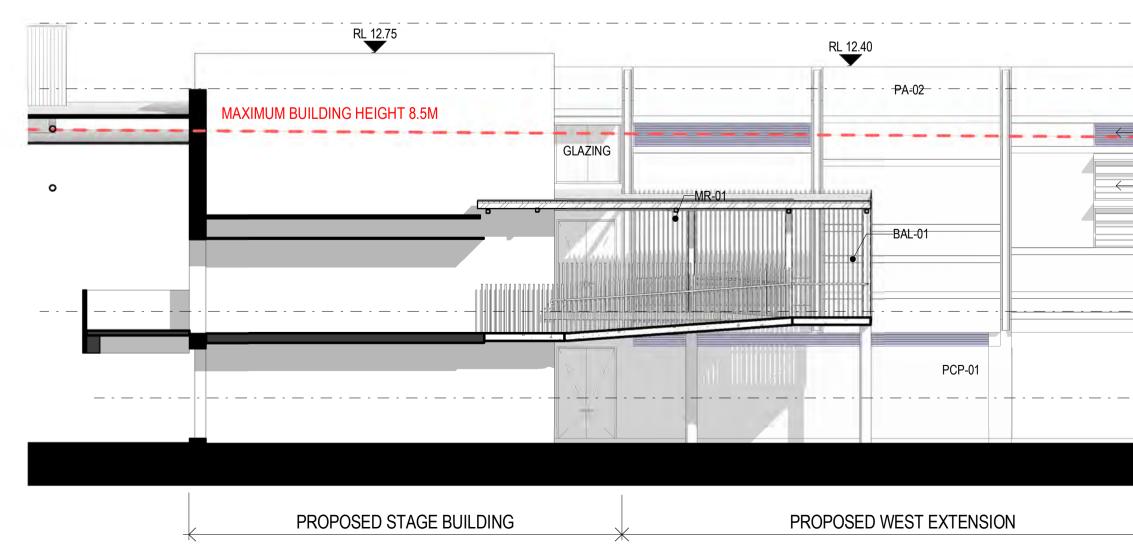2 WEST ELEVATION- BLOCK A2 AND PROPOSED EXTENSION



NORTH ELEVATION - PROPOSED EXTENSION 3

NSHS - BLOCK A_GYM ROOF - A3 RL 13.53	

RL 11.79

NSHS - BLOCK A_GYM PARAPET - A3

NSHS -BLOCK A NEW BUILDING LV1_A3 RL 5.90

NSHS -BLOCK A NEW BUILDING GF_A3 RL 3.62

TROUGH		PRECAST CONCRETE AT GROUND		
		CONTINUOUS HIGH-LEVEL FROSTED GLAZING AND LOUVRE STRIP AT GROUND LEVEL		
PROPOSED EXTENSION				
		1		
3	G TROUGH PROPOSED EXTENSION		LEVEL CONTINUOUS HIGH-LEVEL FROSTED GLAZING AND LOUVRE STRIP AT GROUND LEVEL	LEVEL CONTINUOUS HIGH-LEVEL FROSTED GLAZING AND LOUVRE STRIP AT GROUND LEVEL

	NSHS - BLOCK A_GYM ROOF - A3 RL 13.53	
·	NSHS_BLOCK A_GYM PARAPET - A3	
	- MECHLOUVRES	
	-SHADED NORTH-FACING GLAZING	
	NSHS -BLOCK A NEW BUILDING LV1_A3	
CON-02	NSHS -BLOCK A NEW BUILDING GF_A3 RL 3.62	

[
KEYNOTE LEGEND			
Key Value Keynote Text			
BAL-01	BALUSTRADE - GALVANISED FINISH		
CON-02	CONCRETE COLUMN		
MR-01	METAL ROOF		
PA-01	PERFORATED ALUMINIUM		
PA-02	PAINTED ALUMINIUM PANEL		
PCP-01	PRECAST CONCRETE PANEL		
SC-01	STEEL COLUMN		

3000 - ELEVATIONS & SECTIONS

ARCHITECTURE:	

0000	GENERAL & SITE INFORMATION
1000	GENERAL ARRANGEMENT PLANS
2000	GA RCPs
3000	GA SECTIONS & ELEVATIONS
4000	REFERENCE PLANS
5000	STRUCTURAL SET-OUT
6000	VERTICAL CIRCULATION
7000	INTERIOR DESIGN DETAILS

8000 EXTERIOR & FACADE DETAILS

9000 DRAWN SCHEDULES

9000 SCHEDULES & SPECIFICATIONS

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No	DATE		REVISIONS	BY
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А	15/09/2022	ISSUE FOR DA		

NSHS -BLOCK A NEW BUILDING LV1_A3 RL 5.90

NSHS -BLOCK A NEW BUILDING GF_A3 RL 3.62

ARCHITECT	

DesignInc

Designinc Sydney Pty Ltd Level 14, 85 Castlereagh Street Sydney NSW 2000 Australia +61 2 8905 7100 sydney@designinc.com.au

Nominated Architects

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PROJECT NARRABEEN EDUCATION PRECINCT NAMONA ST, NORTH NARRABEEN NSW 2101

NARRABEEN SPORTS HIGH SCHOOL


DETAILS DRAWN CHECKED APPROVED

VB, JJ RF СМ

SCALE 1 : 100 @ A1

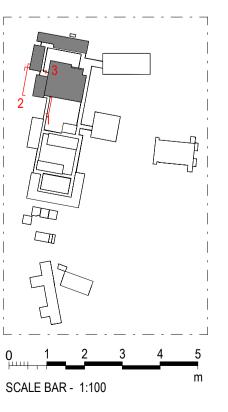TITLE





DRAWING NUMBER AR-H-3011



NORTH ELEVATION - GYM (1)

KEYNOTE LEGEND			
Key Value	Keynote Text		

3000 - ELEVATIONS & SECTIONS

ARCHITECTURE:

0000 GENERAL & SITE INFORMATION 1000 GENERAL ARRANGEMENT PLANS

2000 GA RCPs

- 3000 GA SECTIONS & ELEVATIONS
- 4000 REFERENCE PLANS 5000 STRUCTURAL SET-OUT
- 6000 VERTICAL CIRCULATION
- 7000 INTERIOR DESIGN DETAILS
- 8000 EXTERIOR & FACADE DETAILS
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2	09/09/2022	FOR INFORMATION		RF
А	15/09/2022	ISSUE FOR DA		

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СМ

Designinc Sydney Pty Ltd Level 14, 85 Castlereagh Street Sydney NSW 2000 Australia +61 2 8905 7100 sydney@designinc.com.au

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NARRABEEN SPORTS HIGH SCHOOL

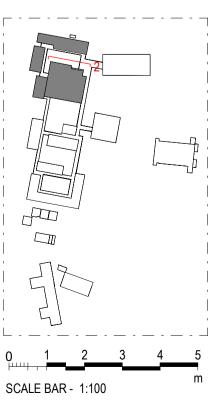
DETAILS DRAWN CHECKED APPROVED

SCALE


TITLE

1 : 100 @ A1

PROPOSED ELEVATIONS- BLOCK A_GYM_NORTH ELEVATION




DRAWING NUMBER AR-H-3012

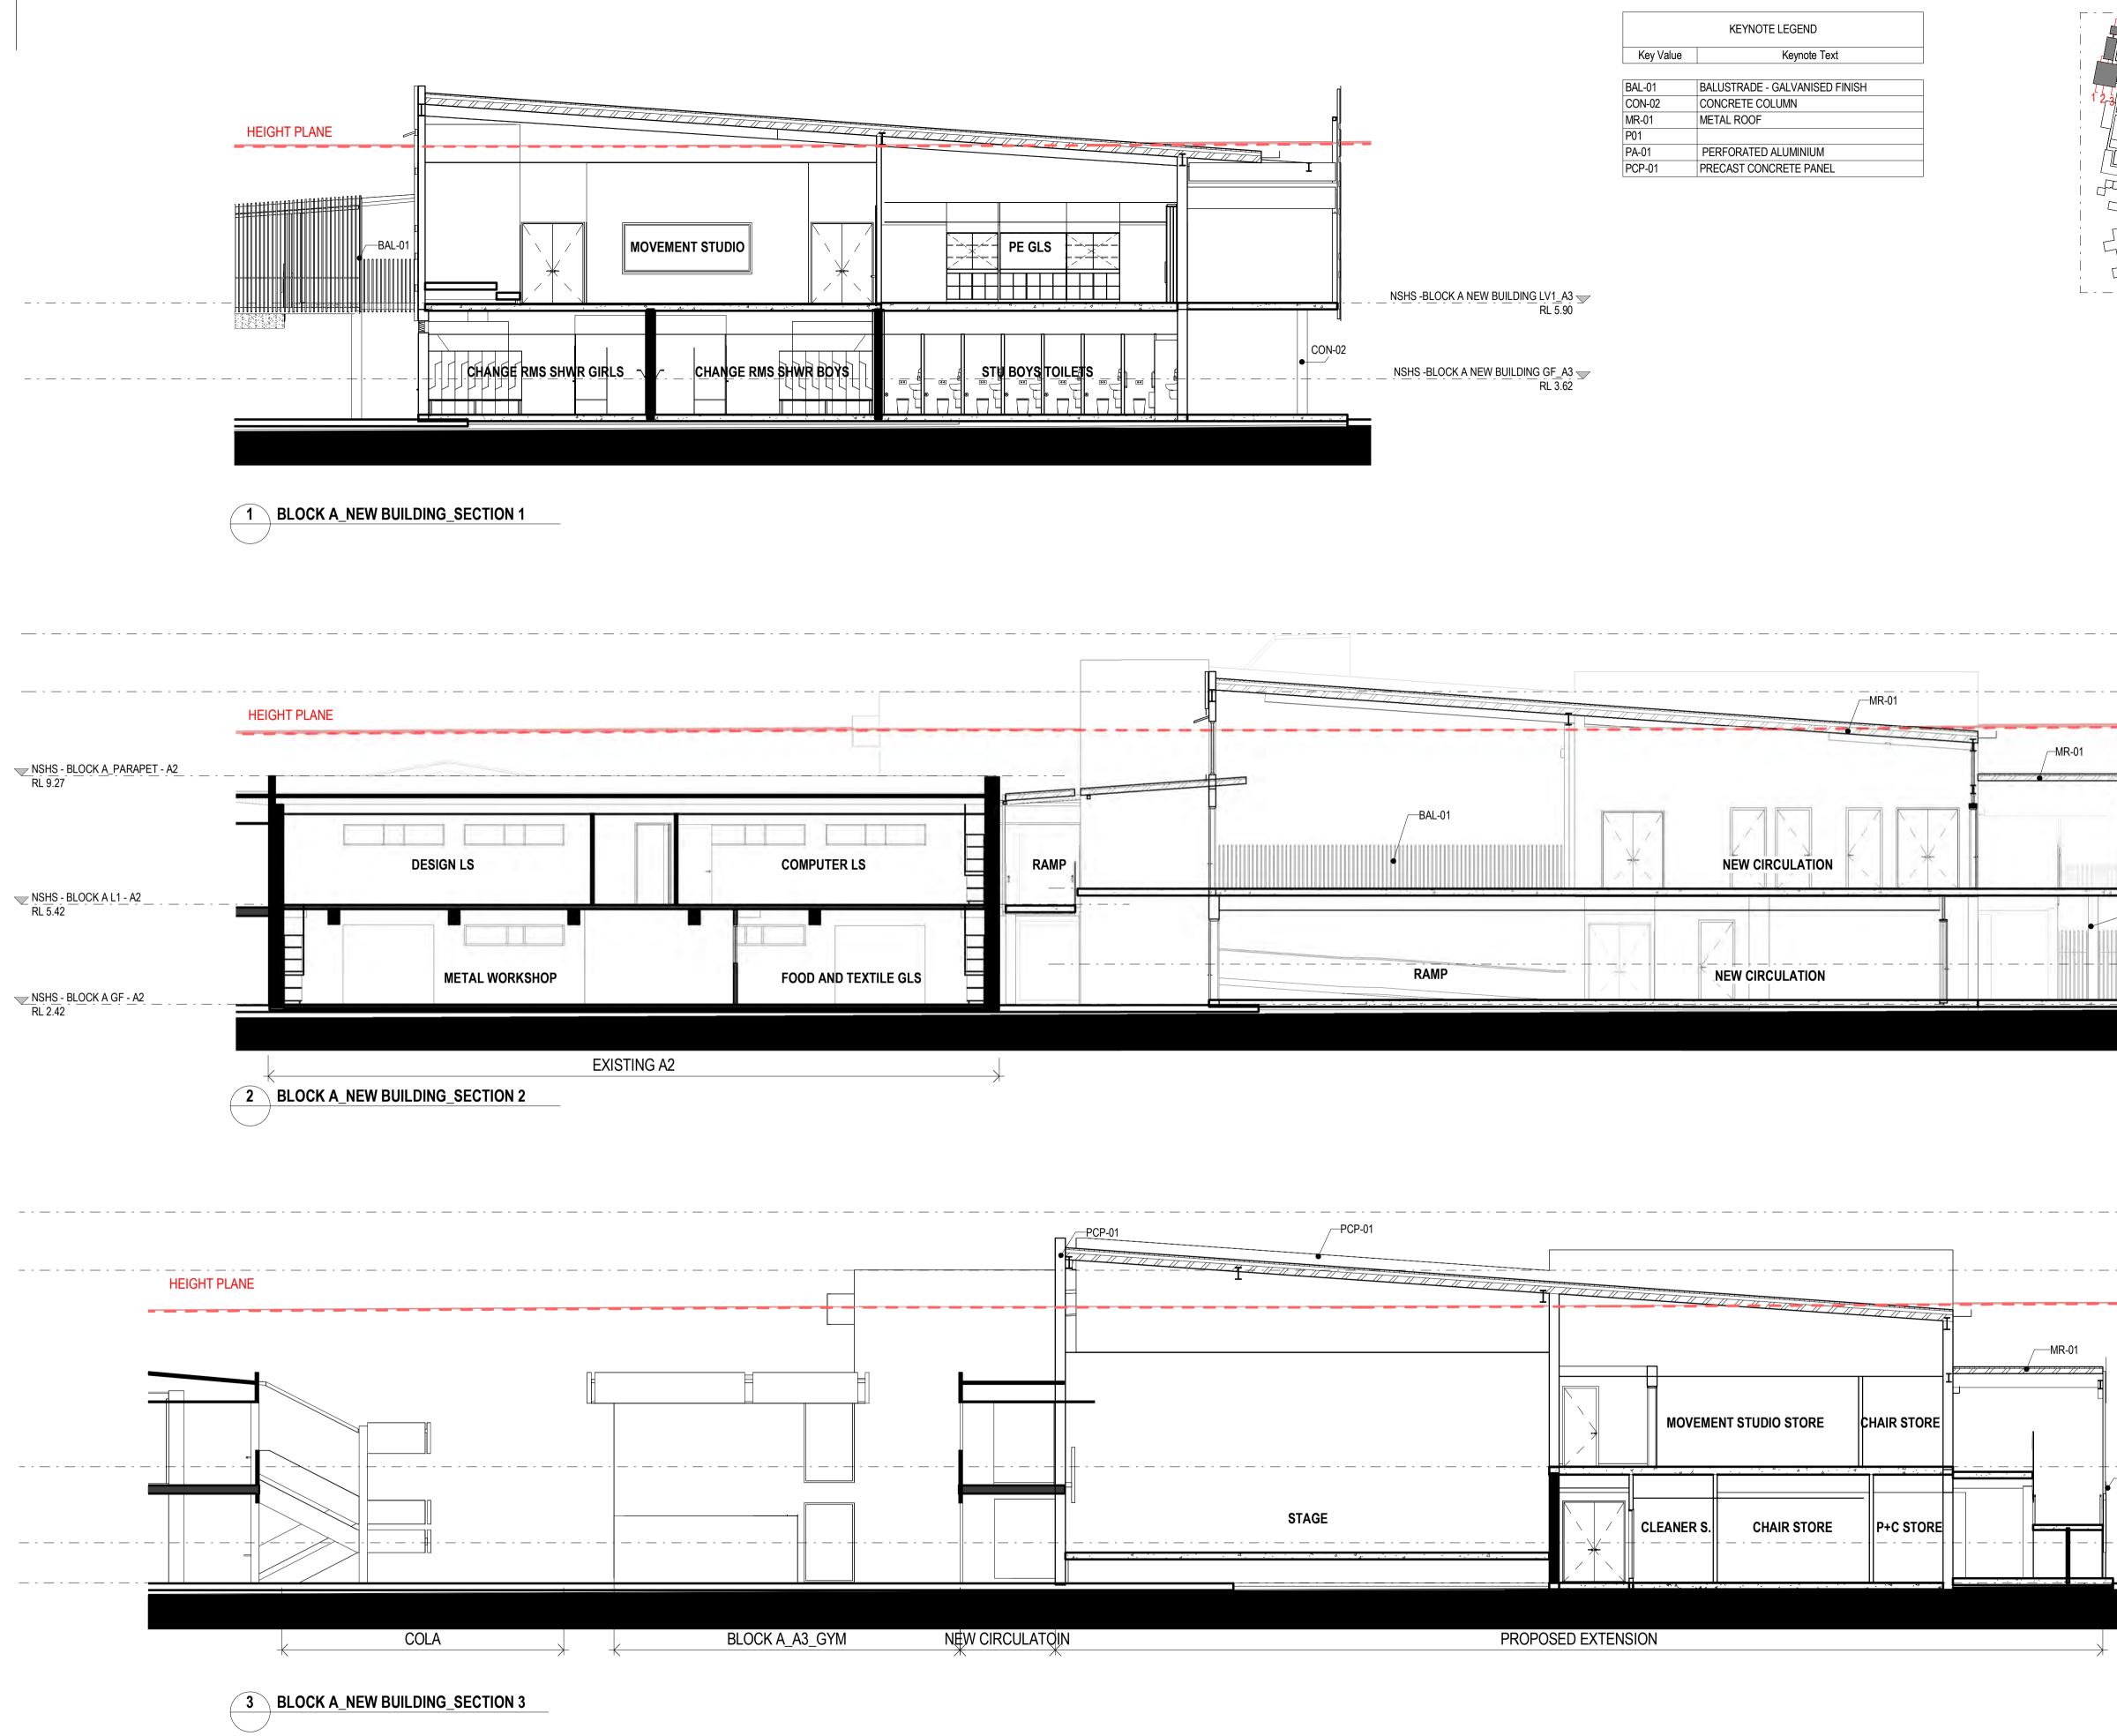

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REVISION А

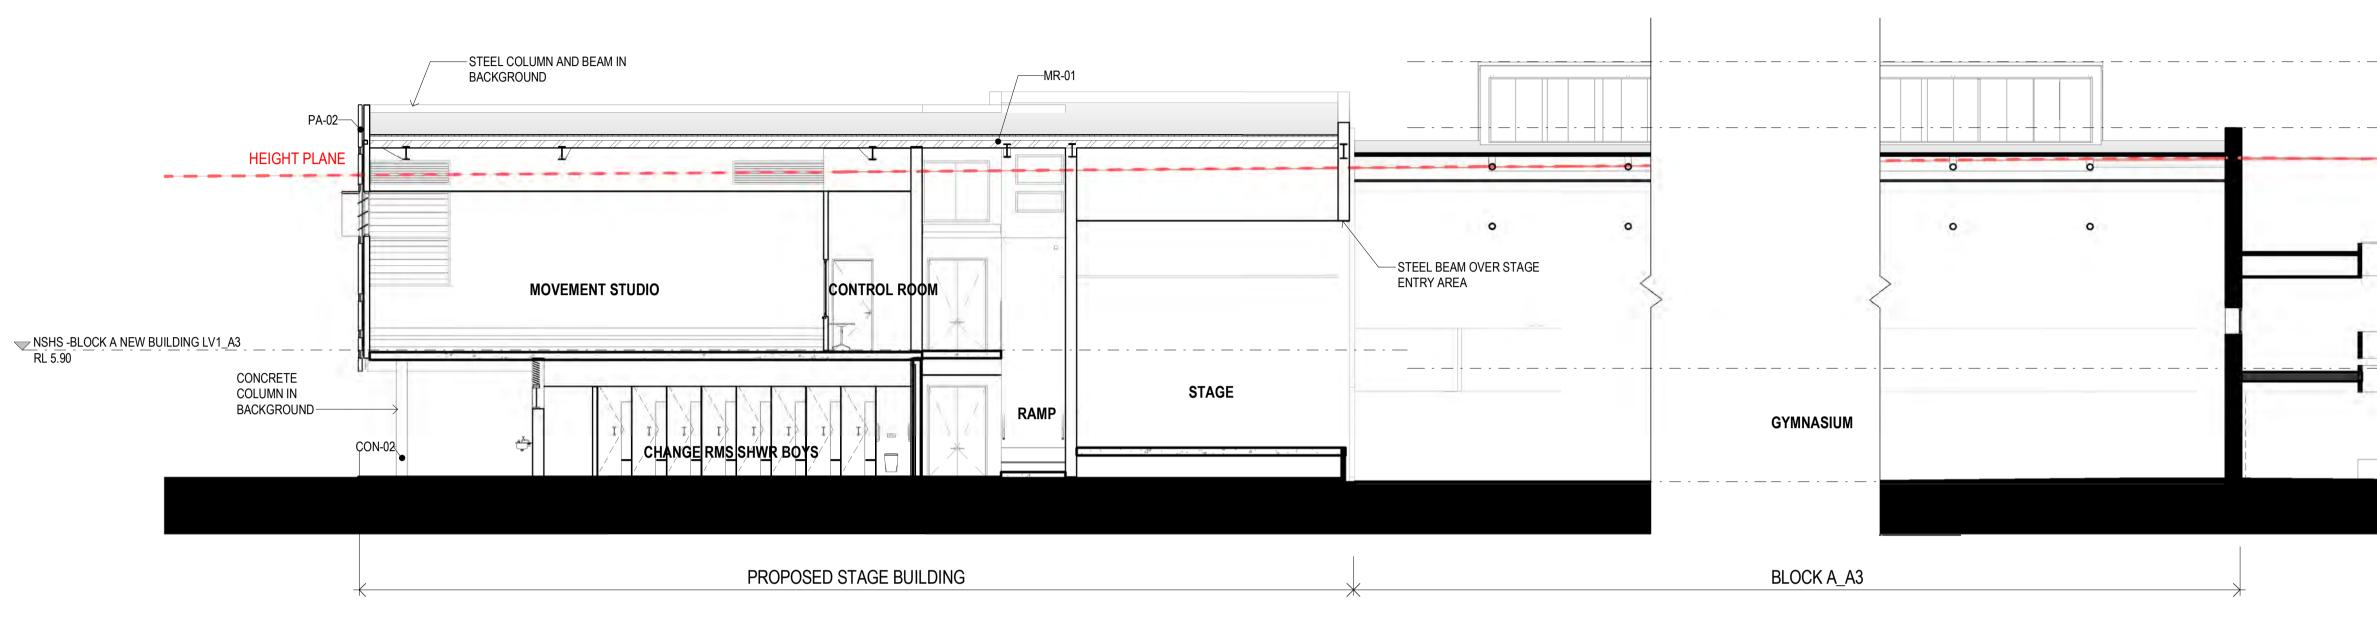

2 BLOCK A_NEW BUILDING + GYM_PROPOSED SECTION 4

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	No DATE REVISIONS BY 1 09/09/2022 FOR INFORMATION RF

A 15/09/2022 ISSUE FOR DA

ARCHITECT

DesignInc

Designinc Sydney Pty Ltd Level 14, 85 Castlereagh Street Sydney NSW 2000 Australia +61 2 8905 7100 sydney@designinc.com.au

Nominated Architects

Ian Armstrong 7260 | Cathryn Drew-Bredin 7269 | Richard Does 8126 | Mary Anne McGirr 10946 CLIENT



Education

PROJECT NARRABEEN EDUCATION PRECINCT NAMONA ST, NORTH NARRABEEN NSW 2101

NARRABEEN SPORTS HIGH SCHOOL

DETAILS DRAWN CHECKED APPROVED

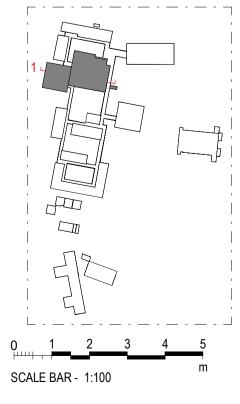
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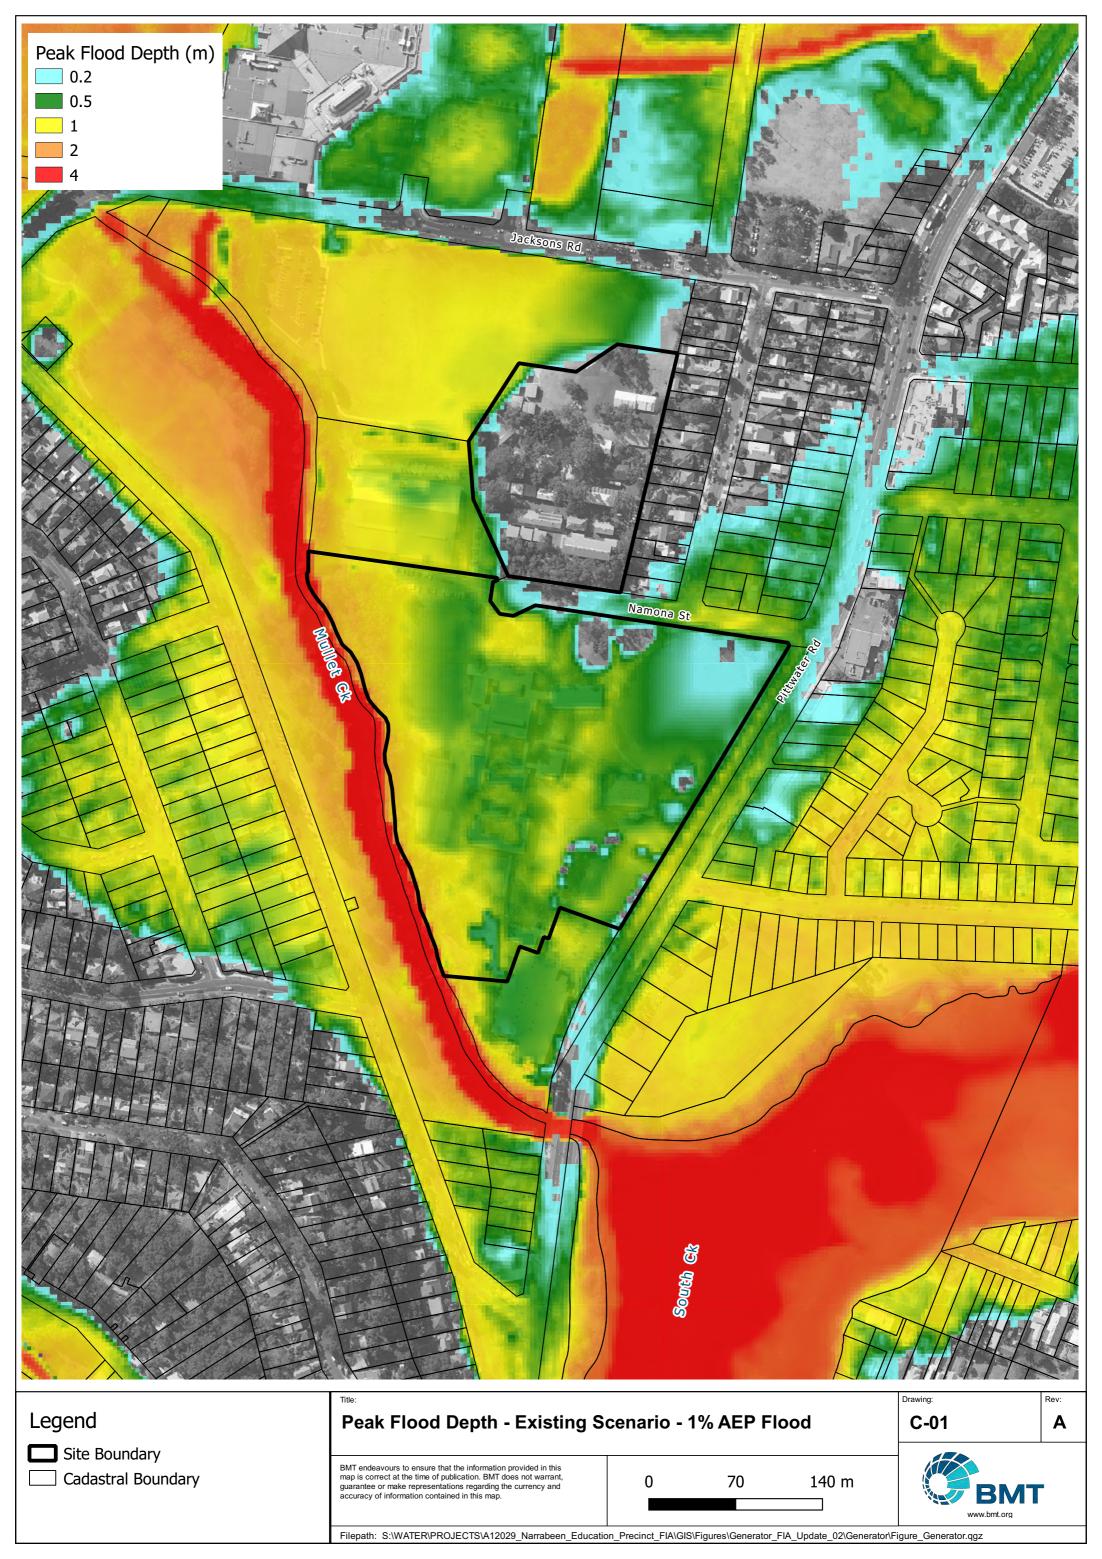
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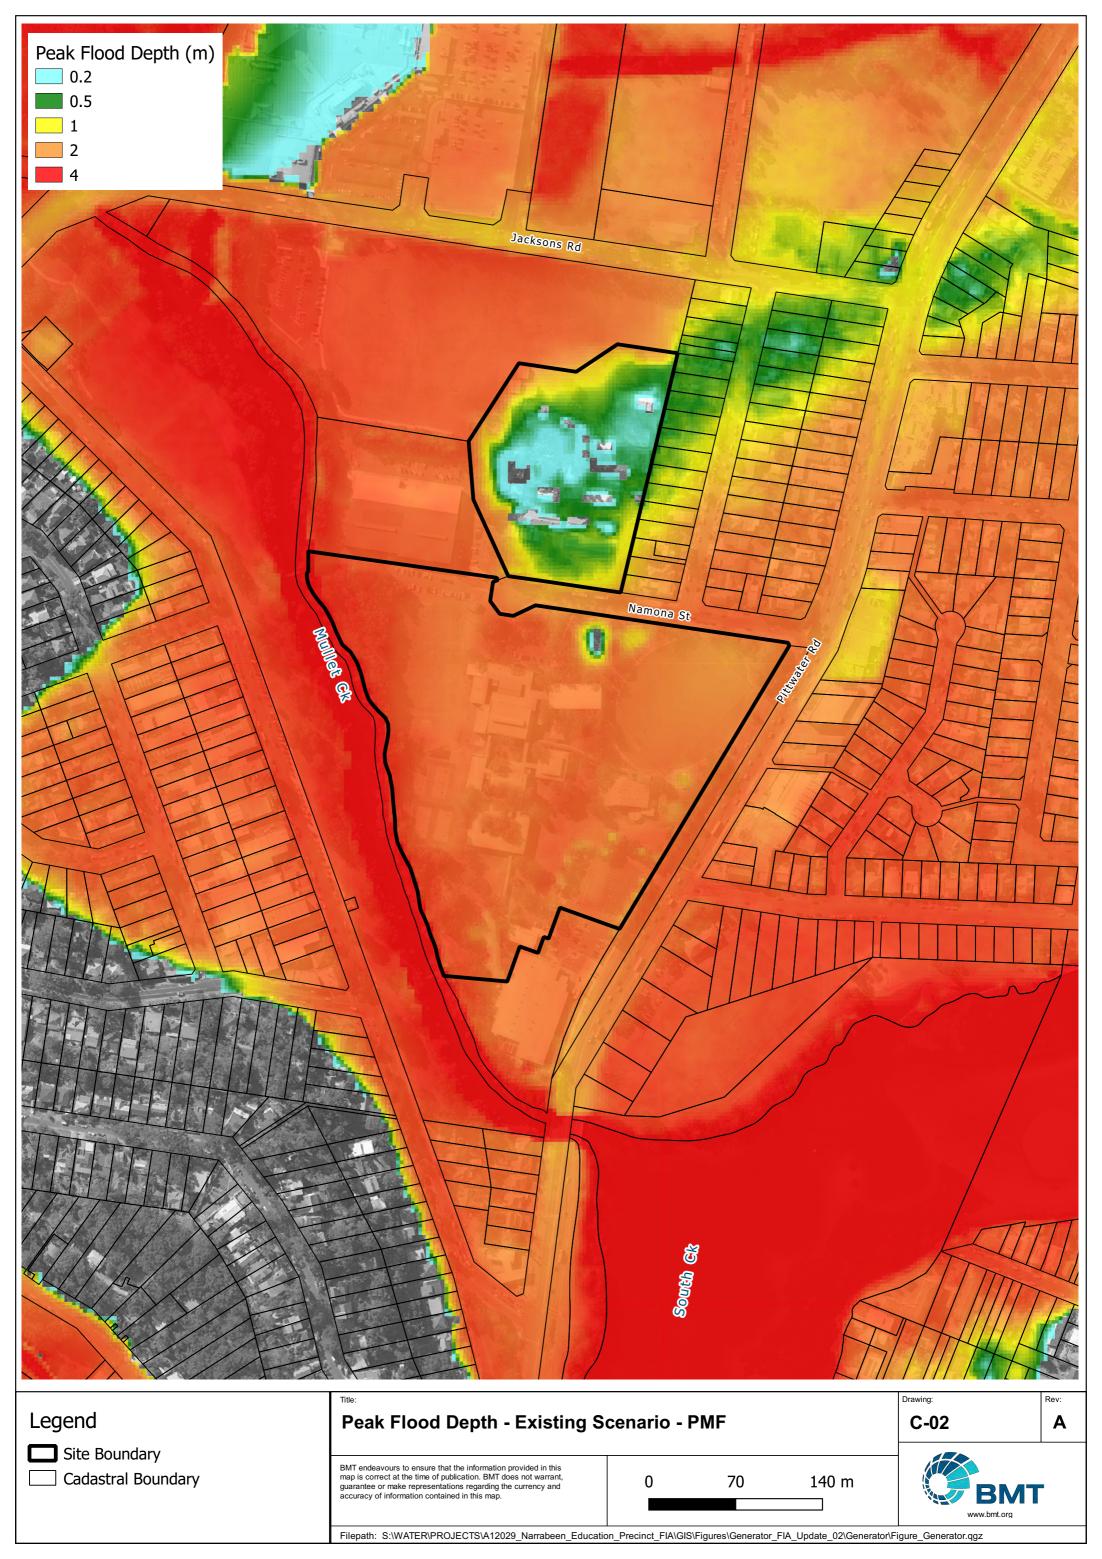
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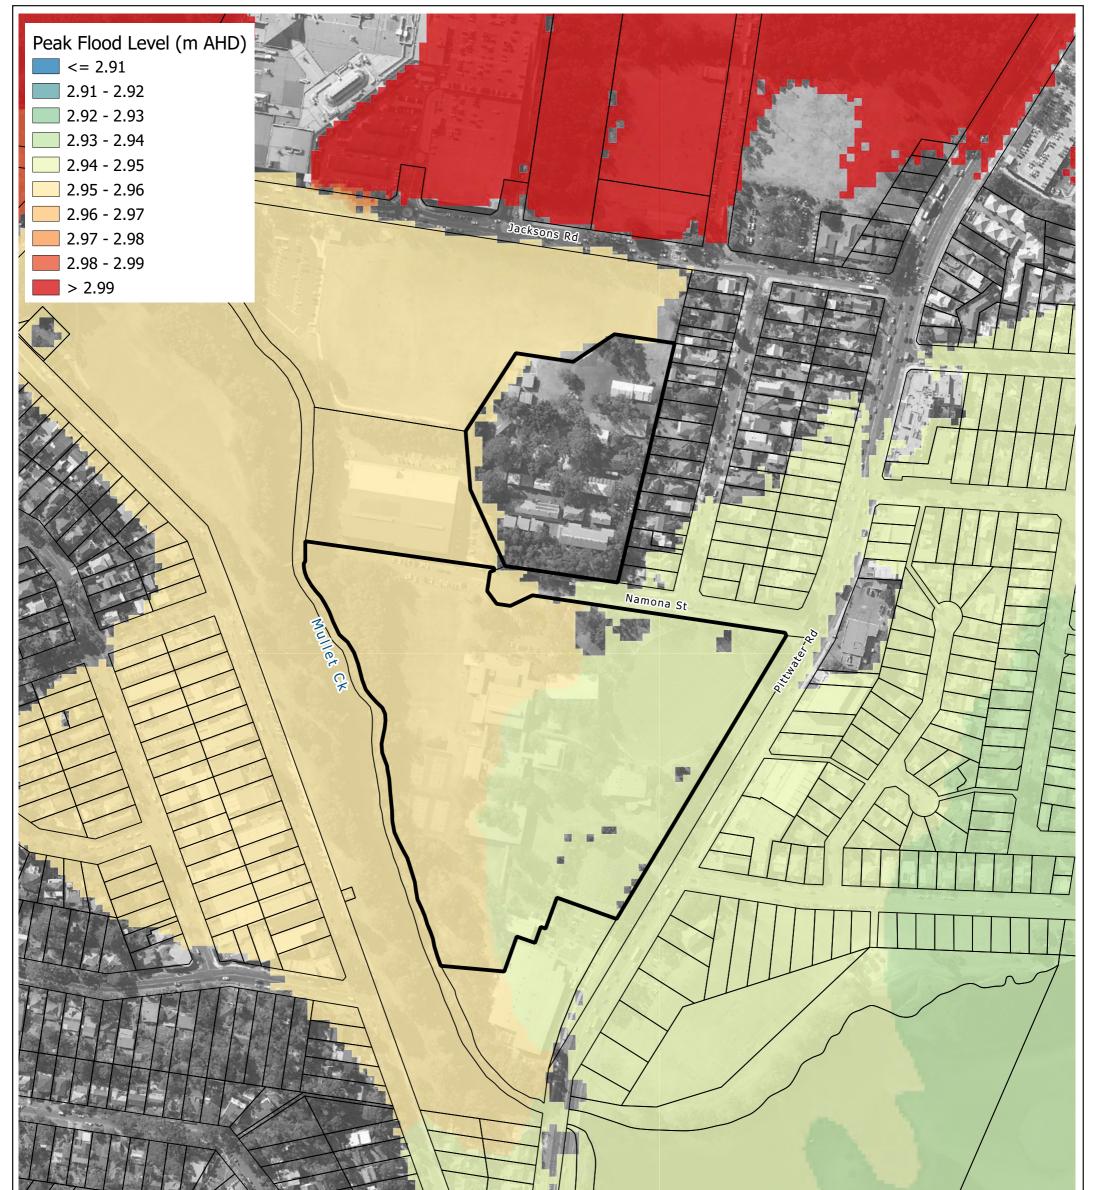




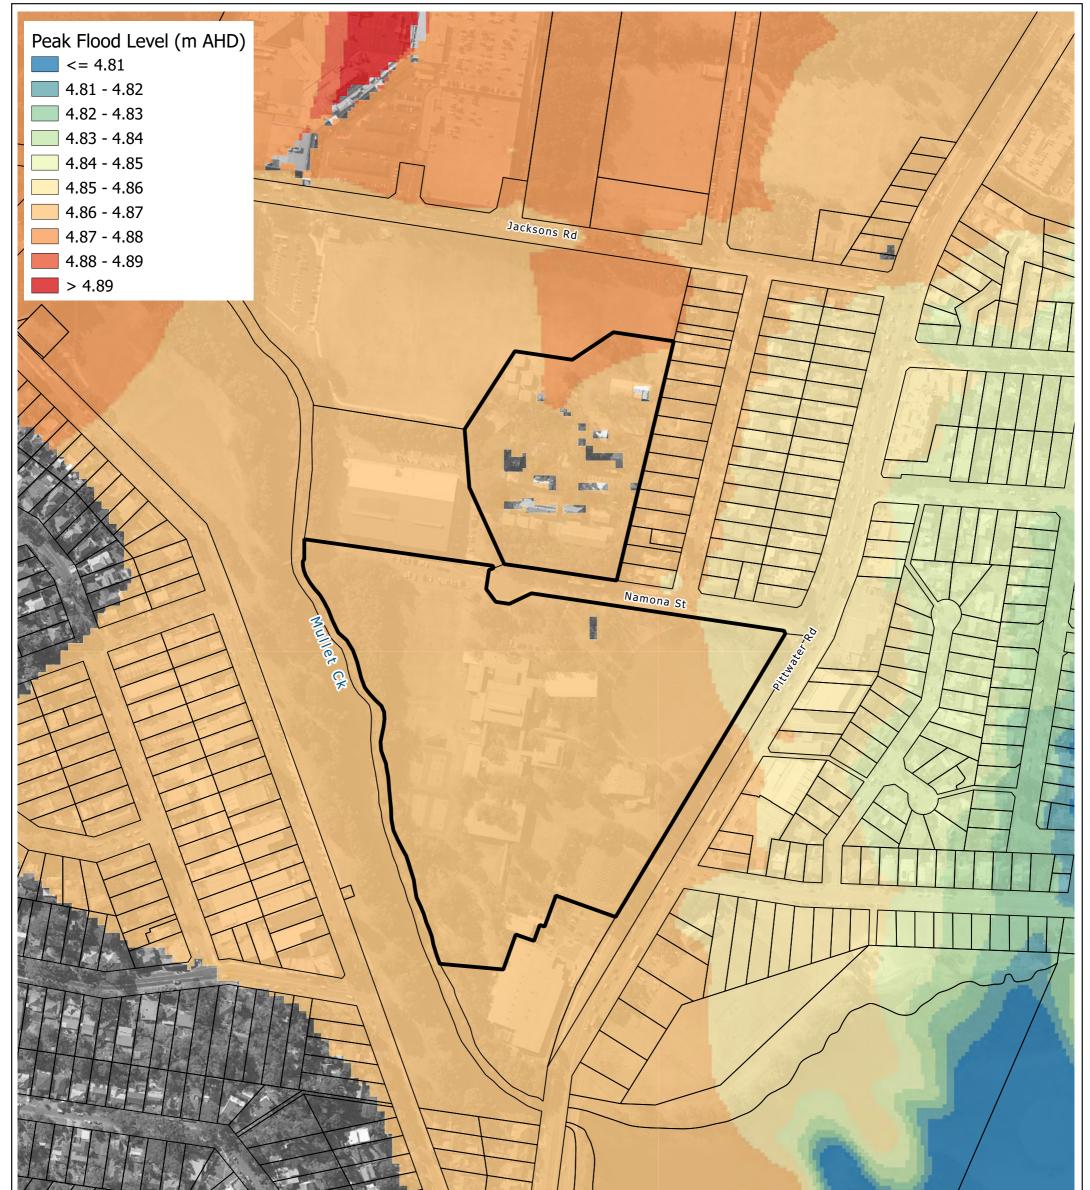
Annex C Flood Mapping for Existing Conditions





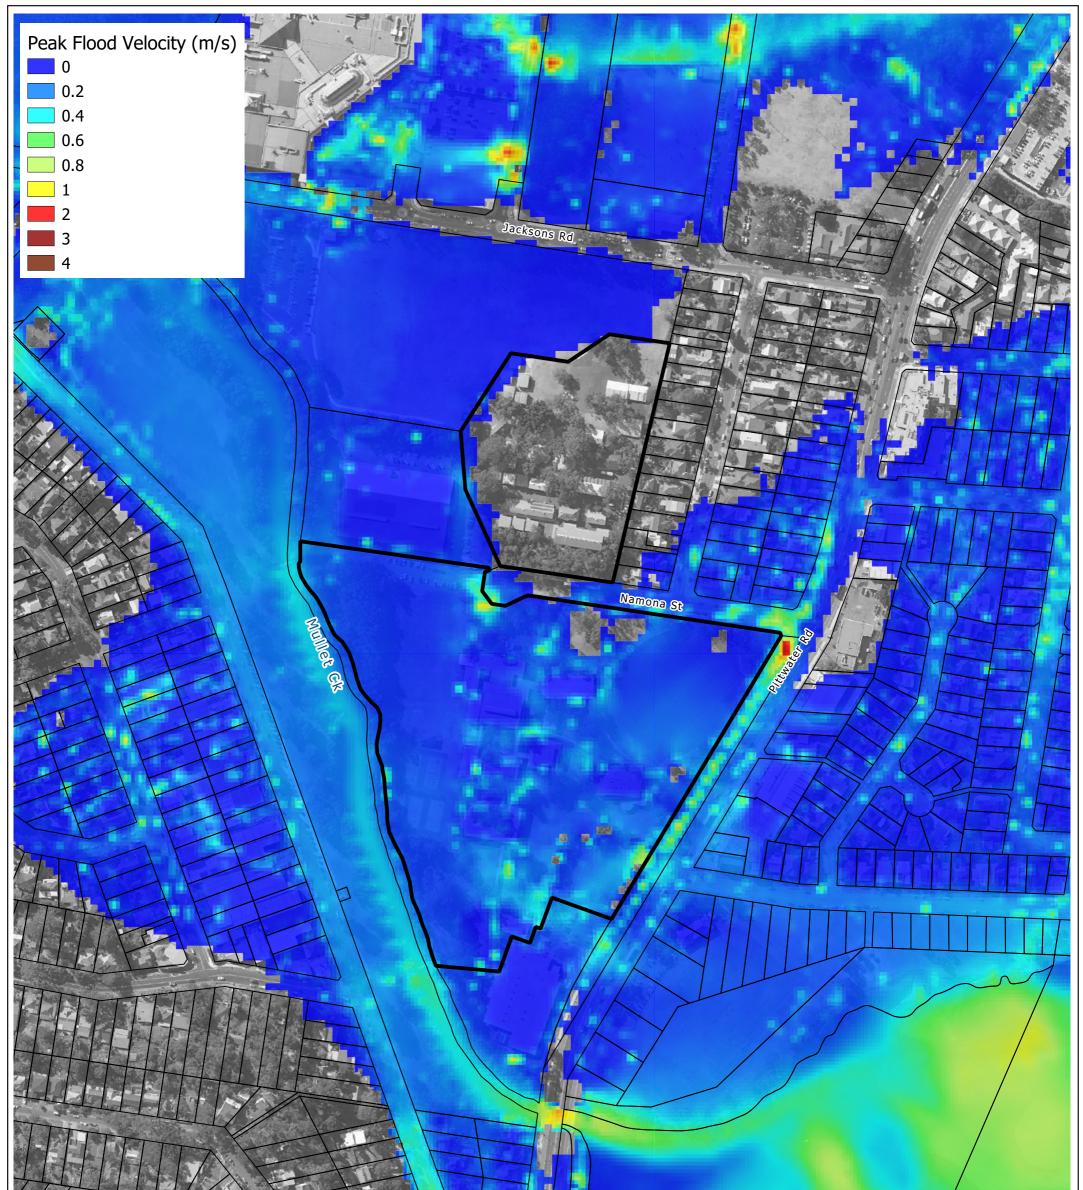


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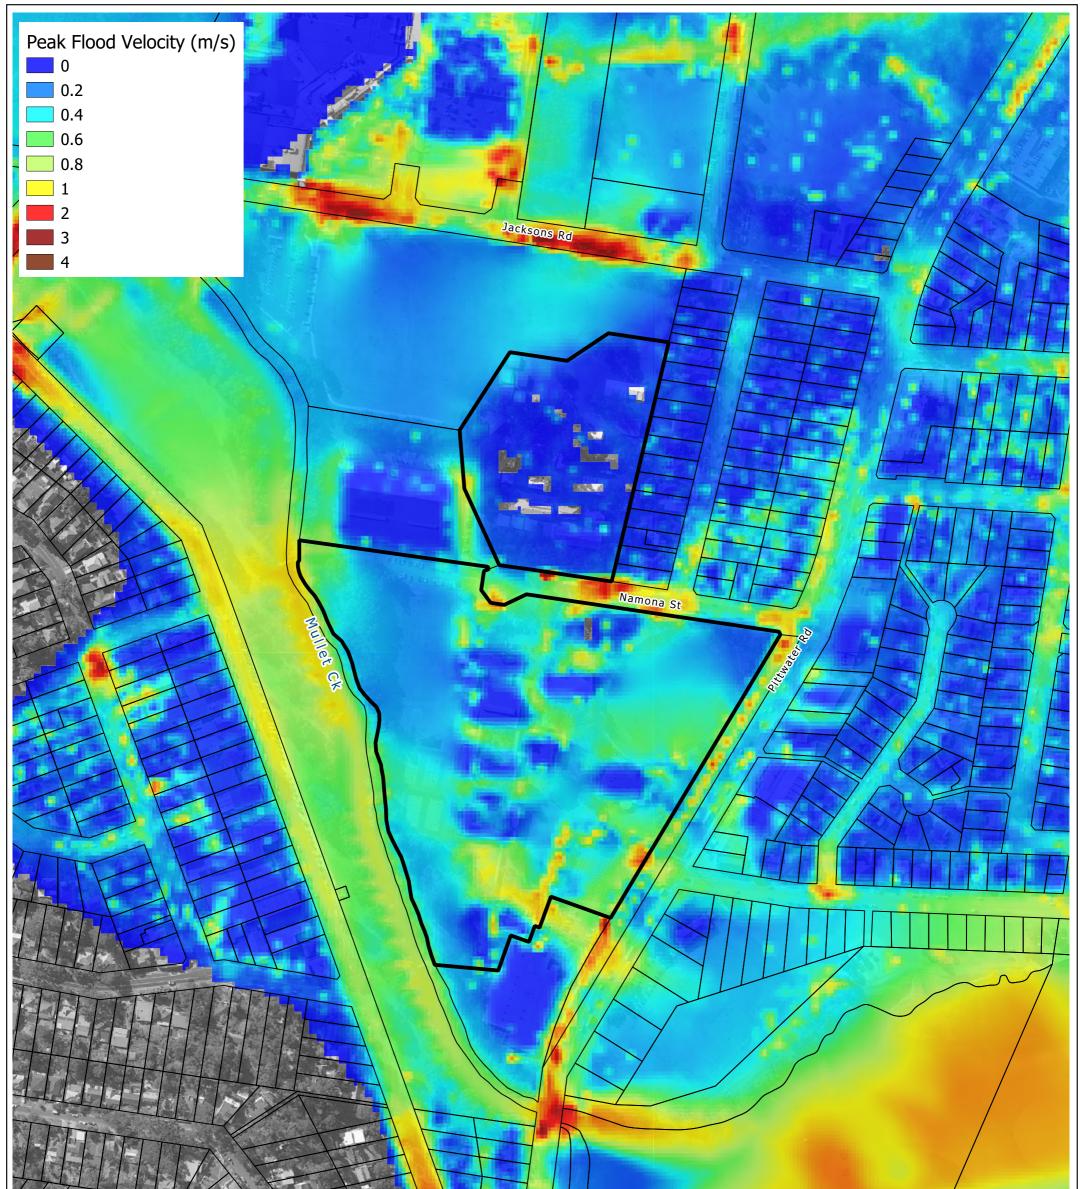


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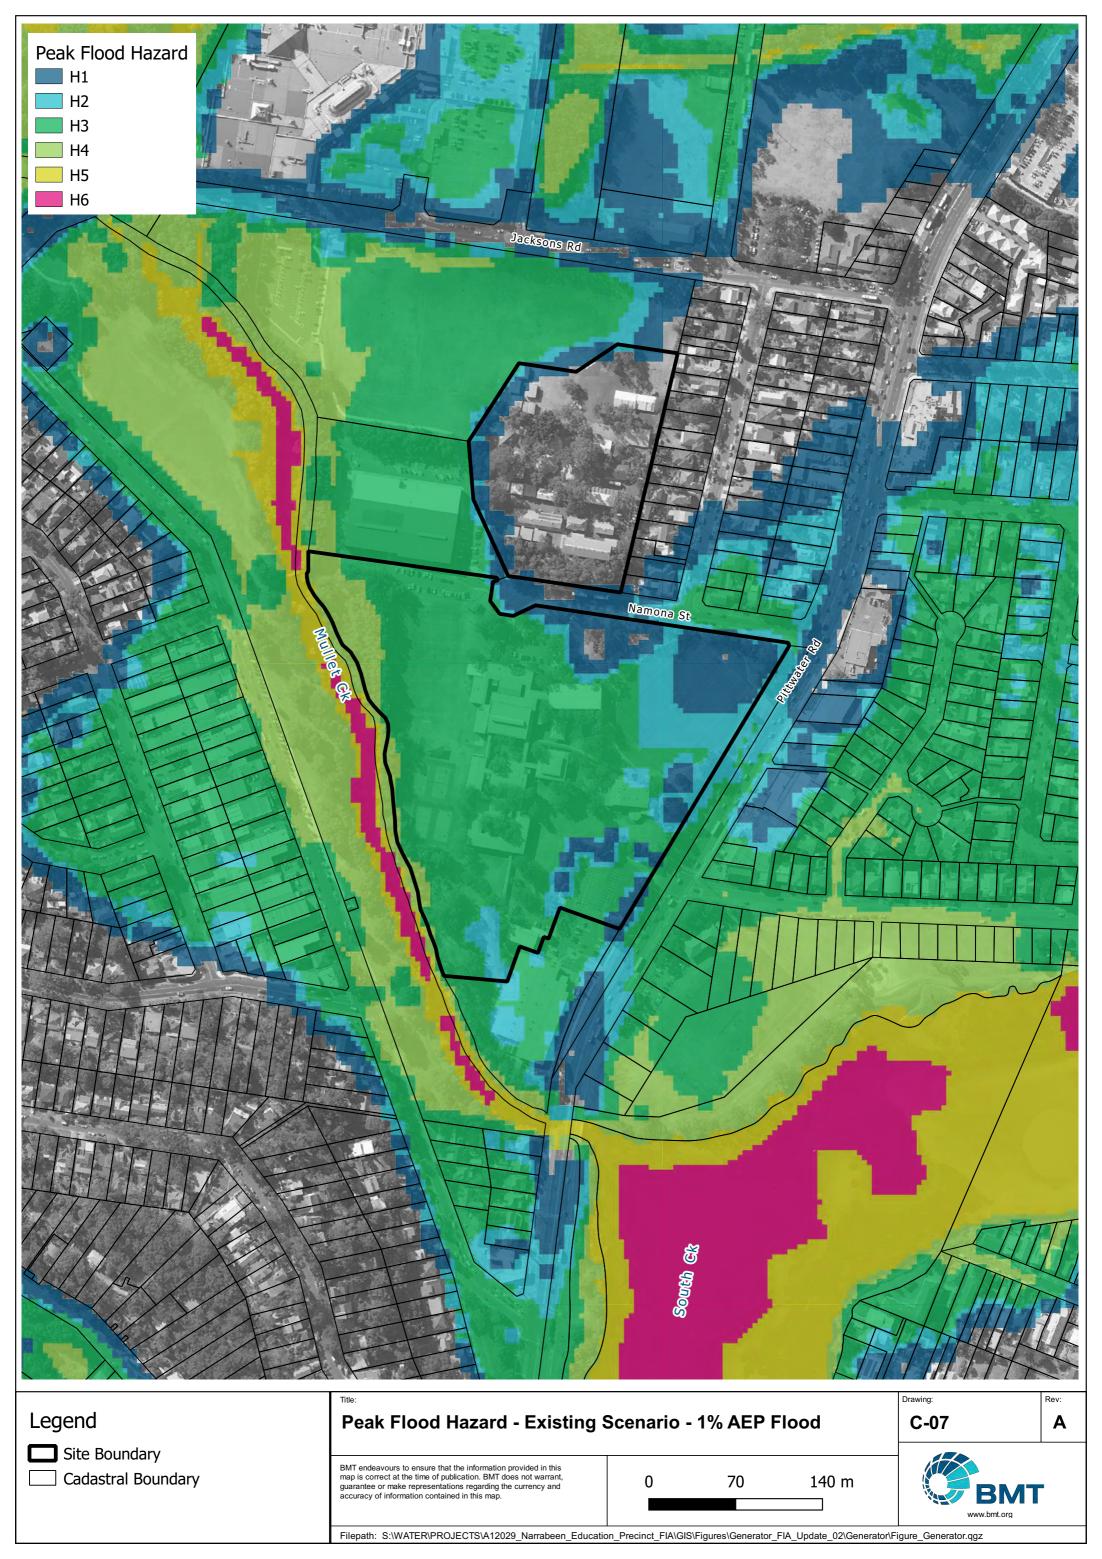
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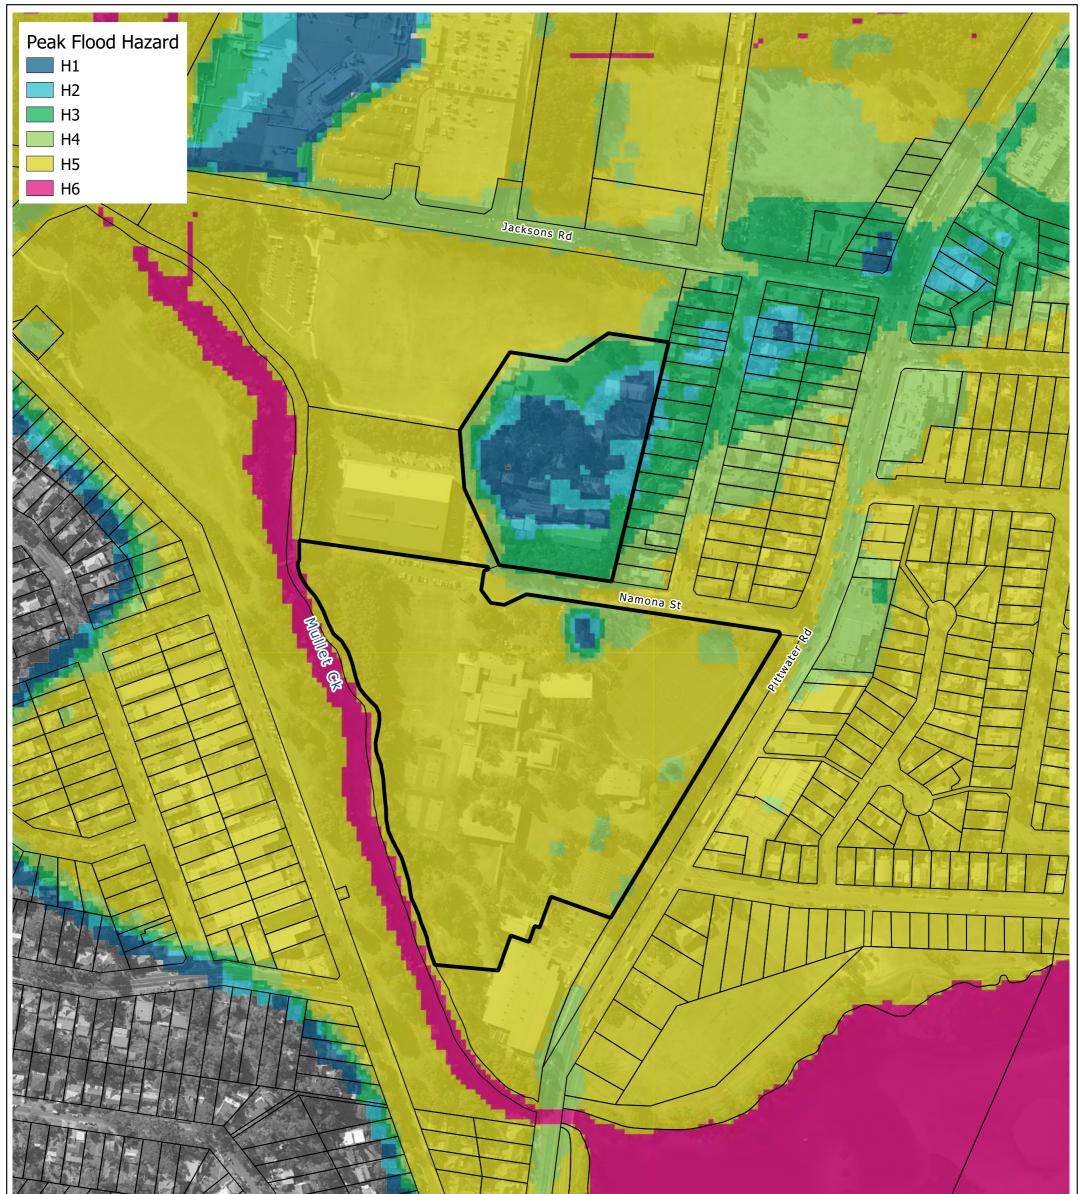


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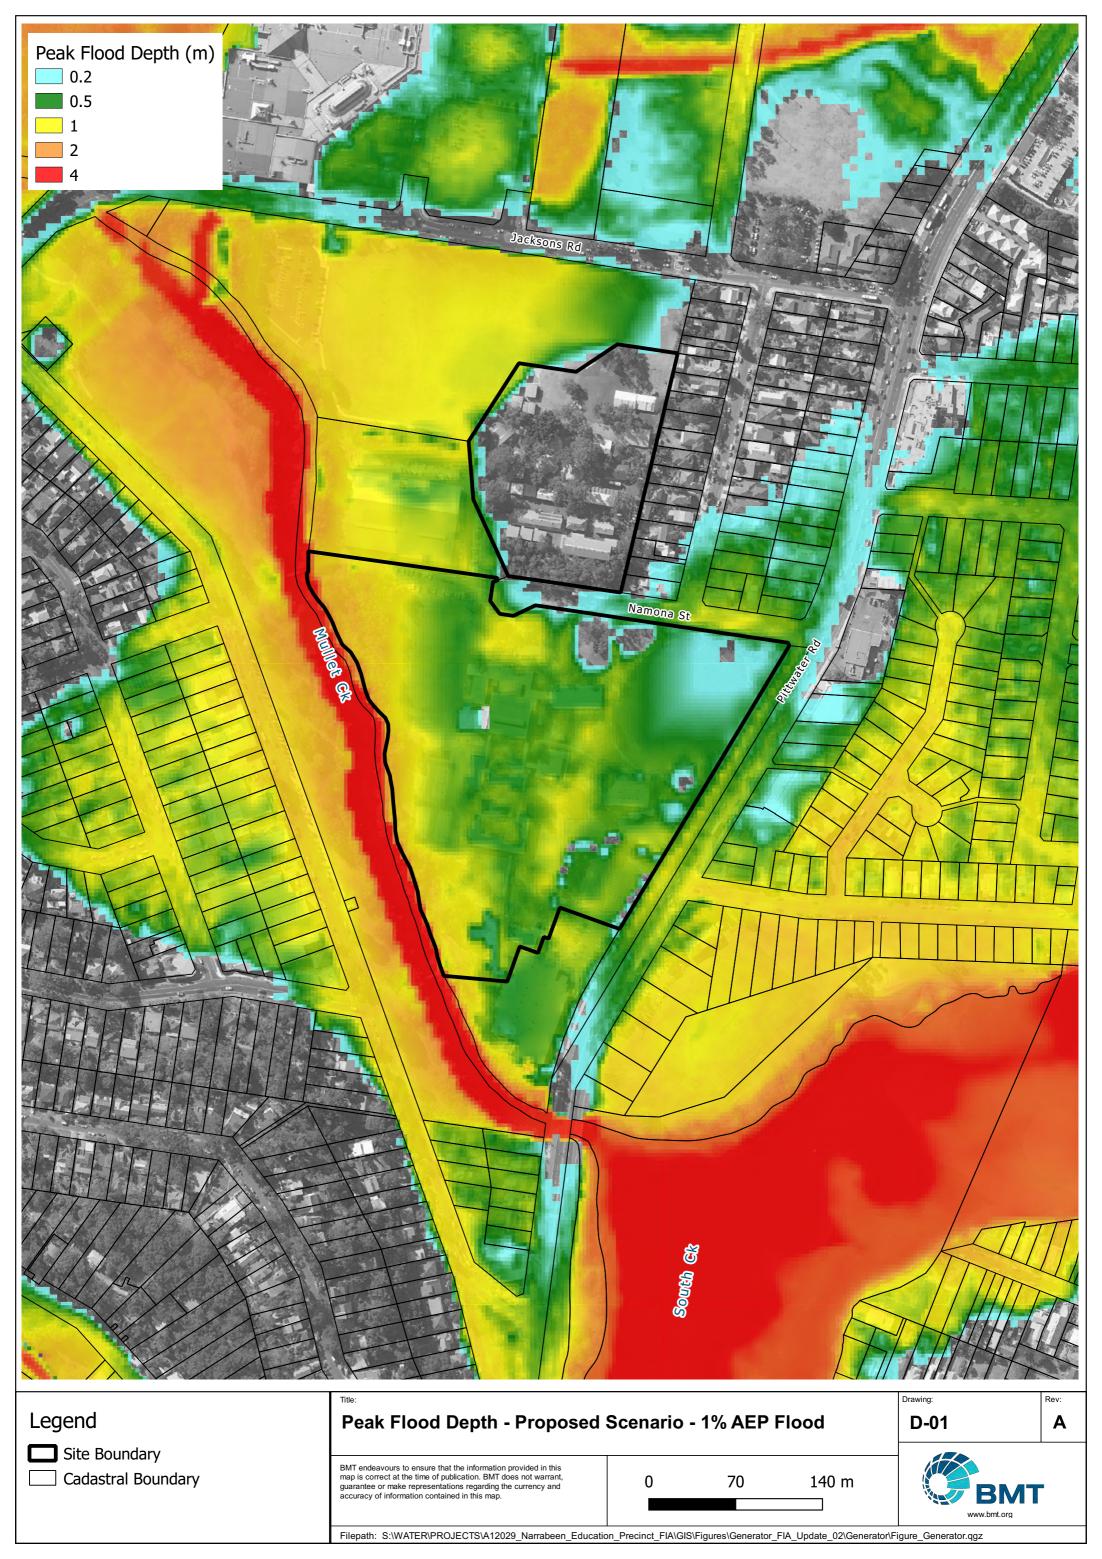


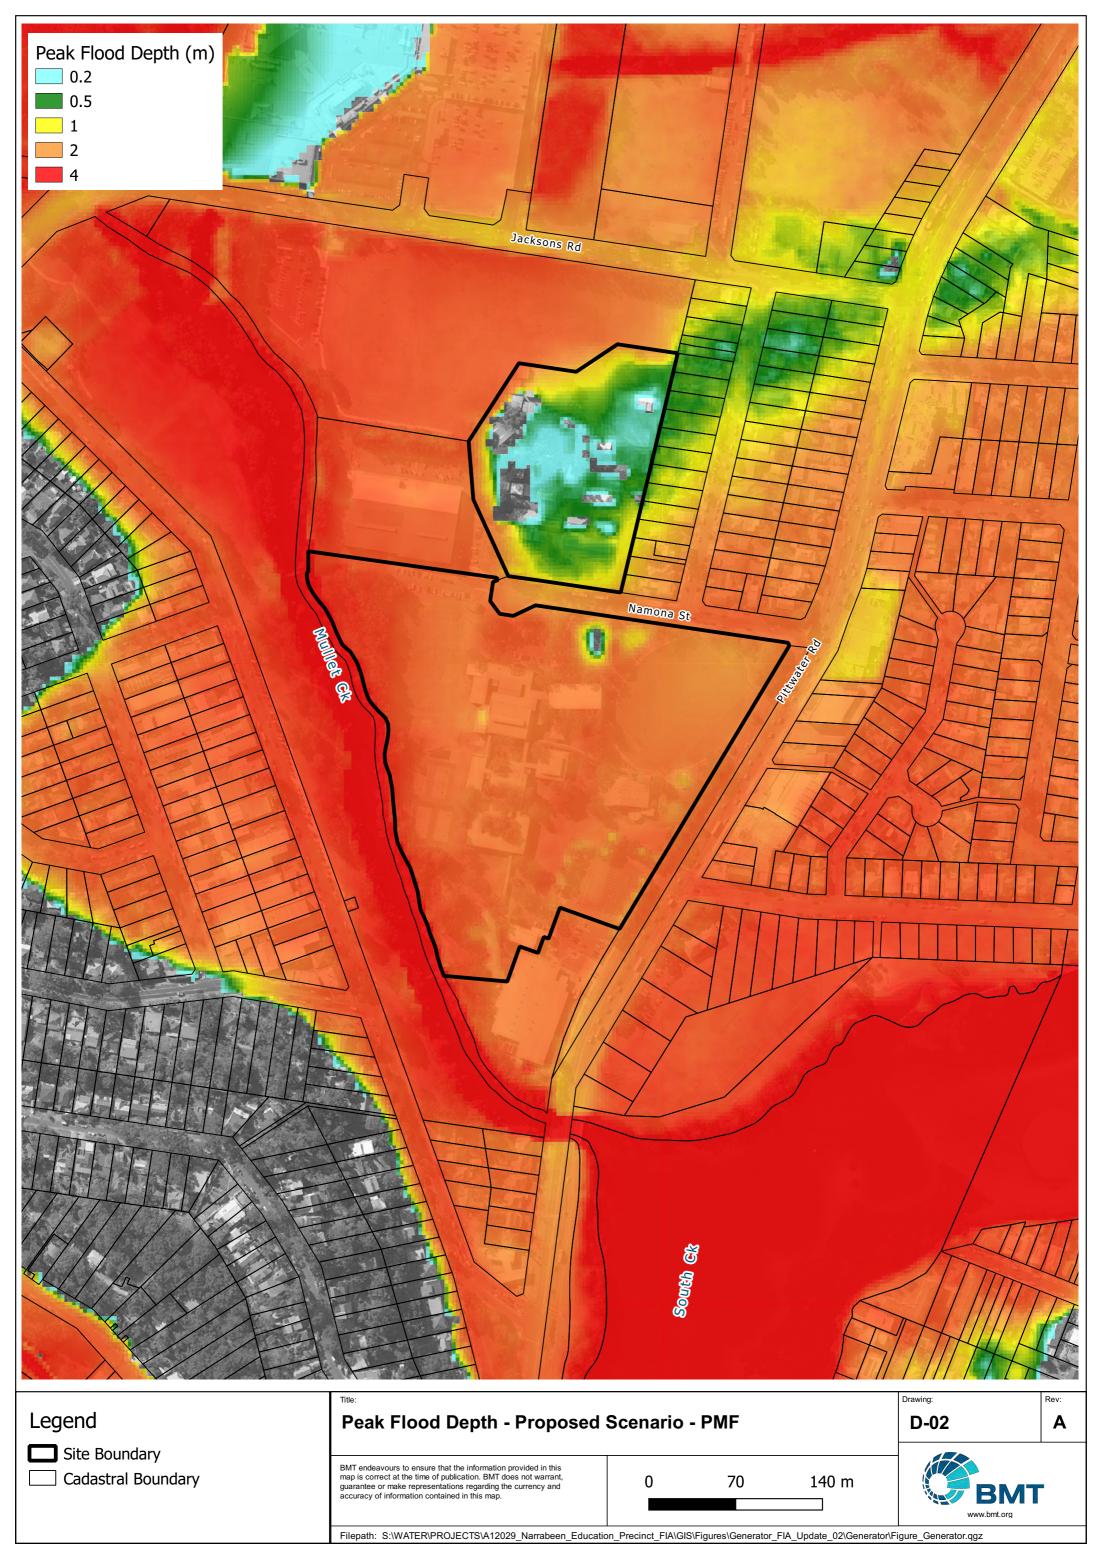


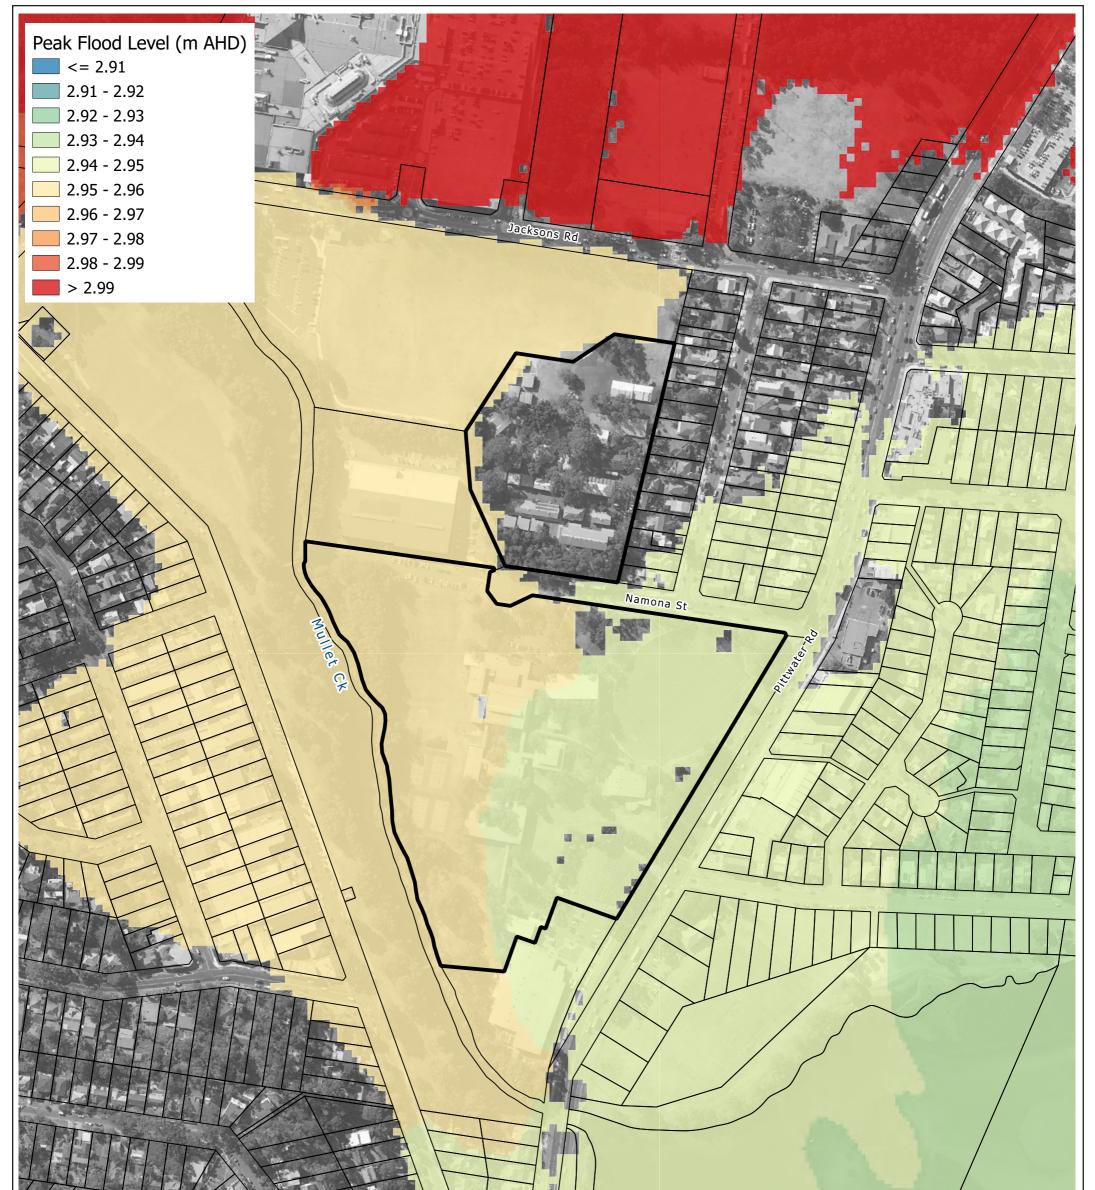
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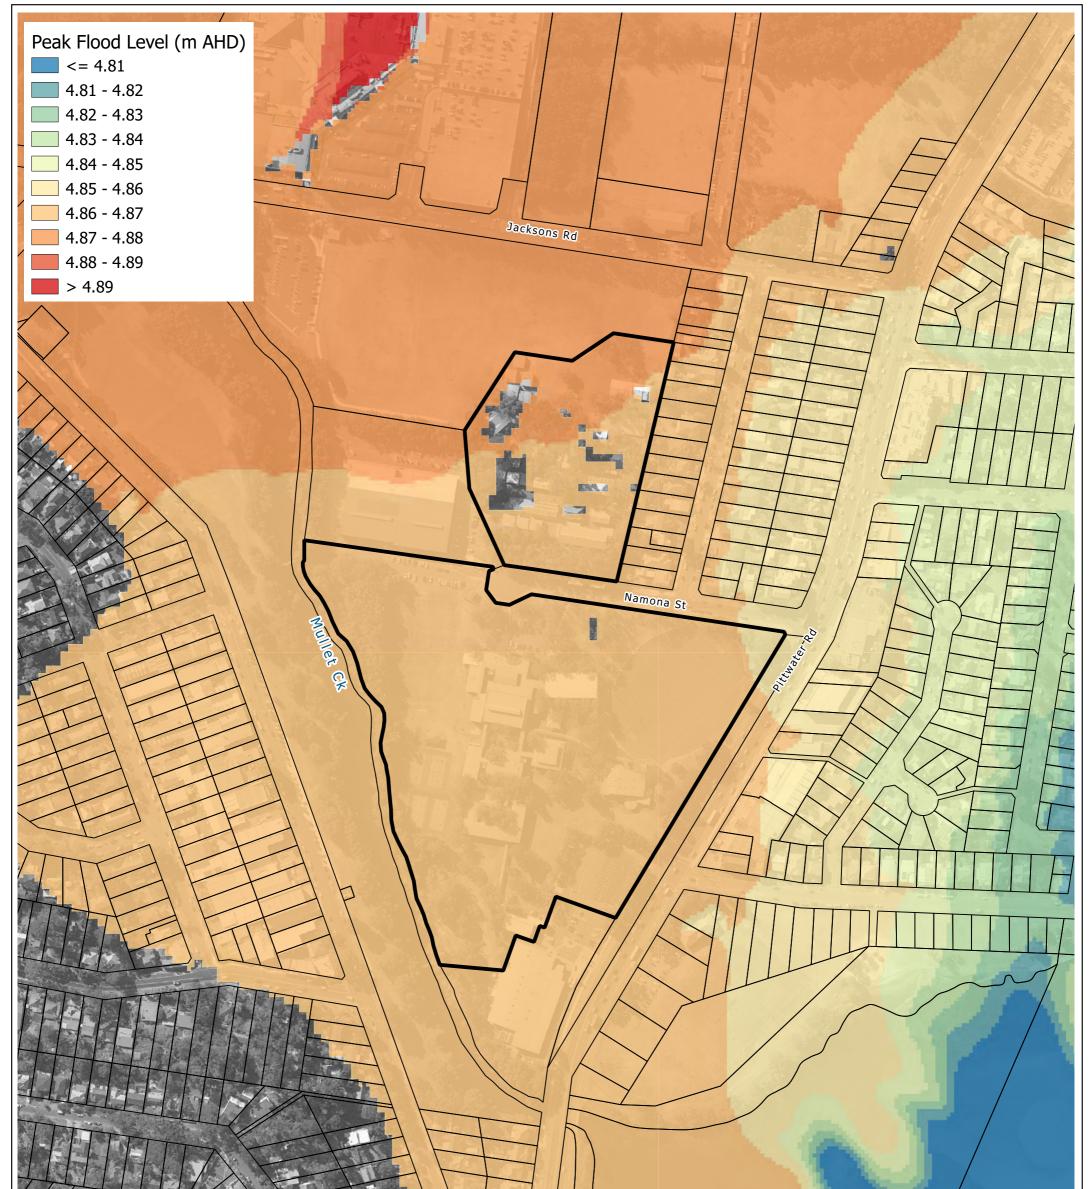
Annex D Flood Mapping for Proposed Conditions





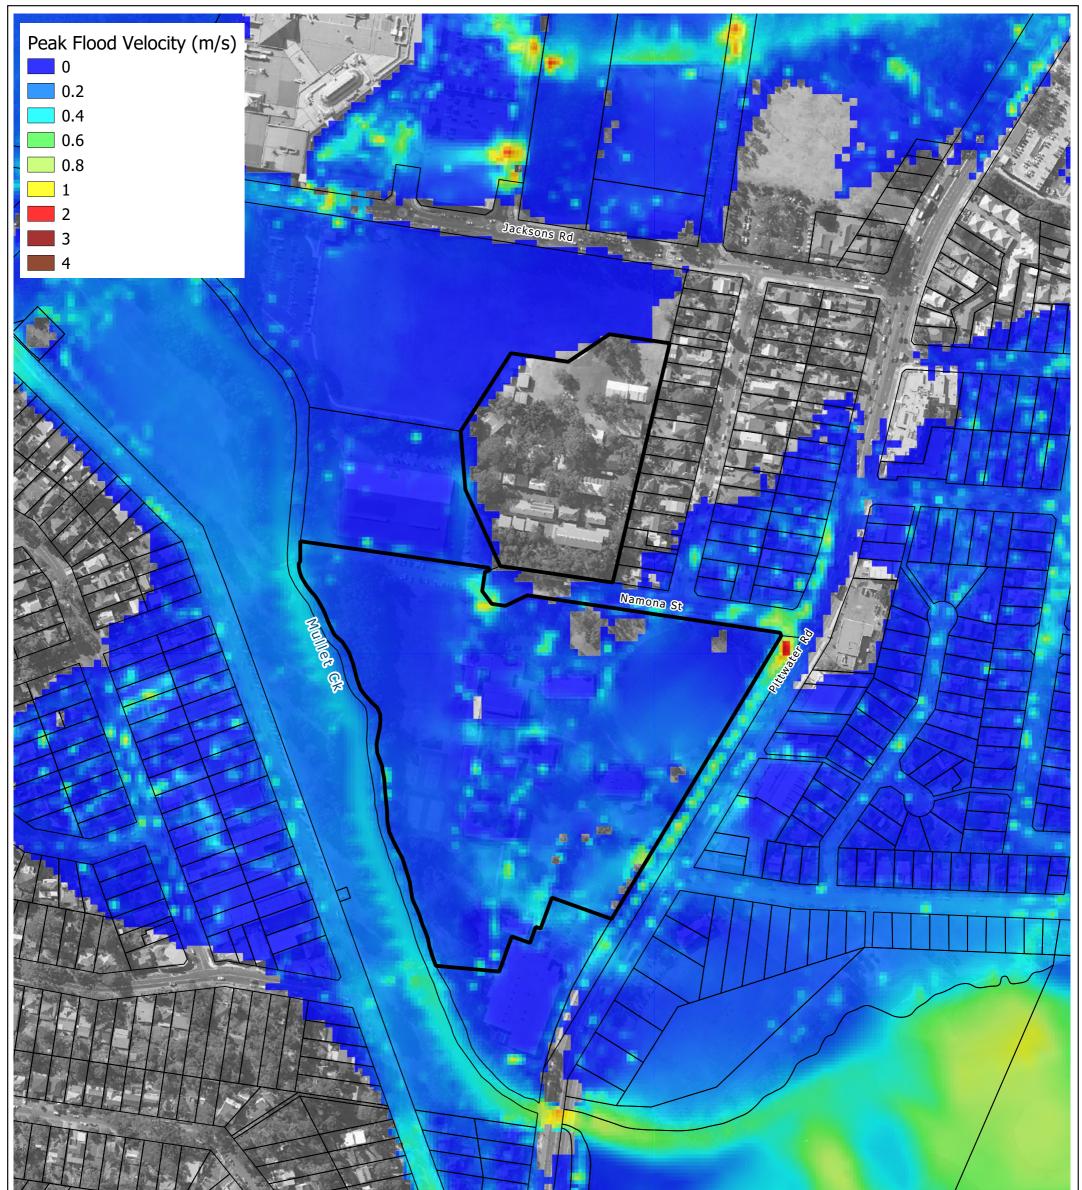


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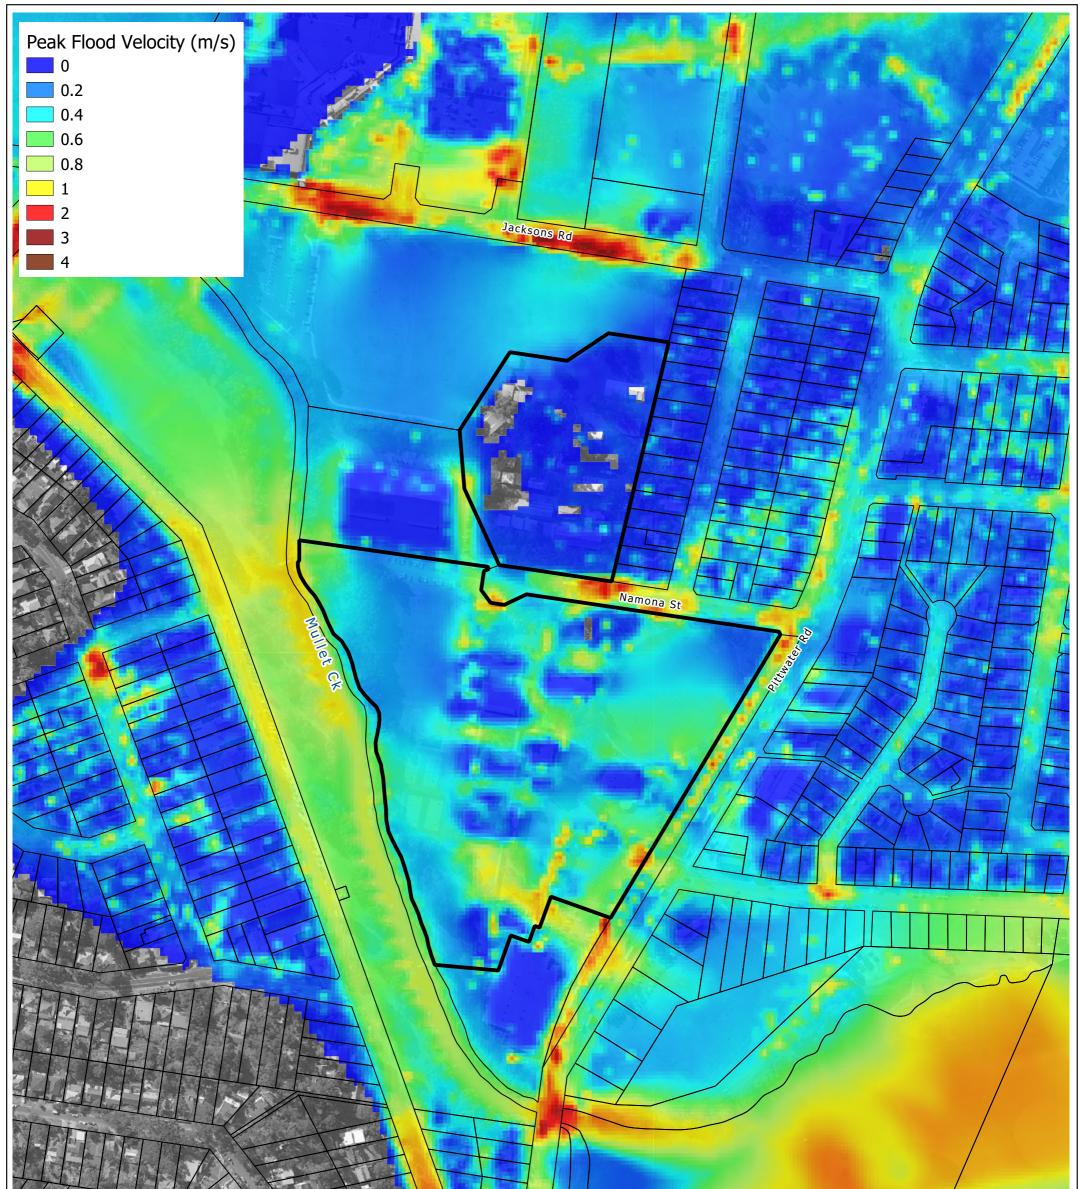


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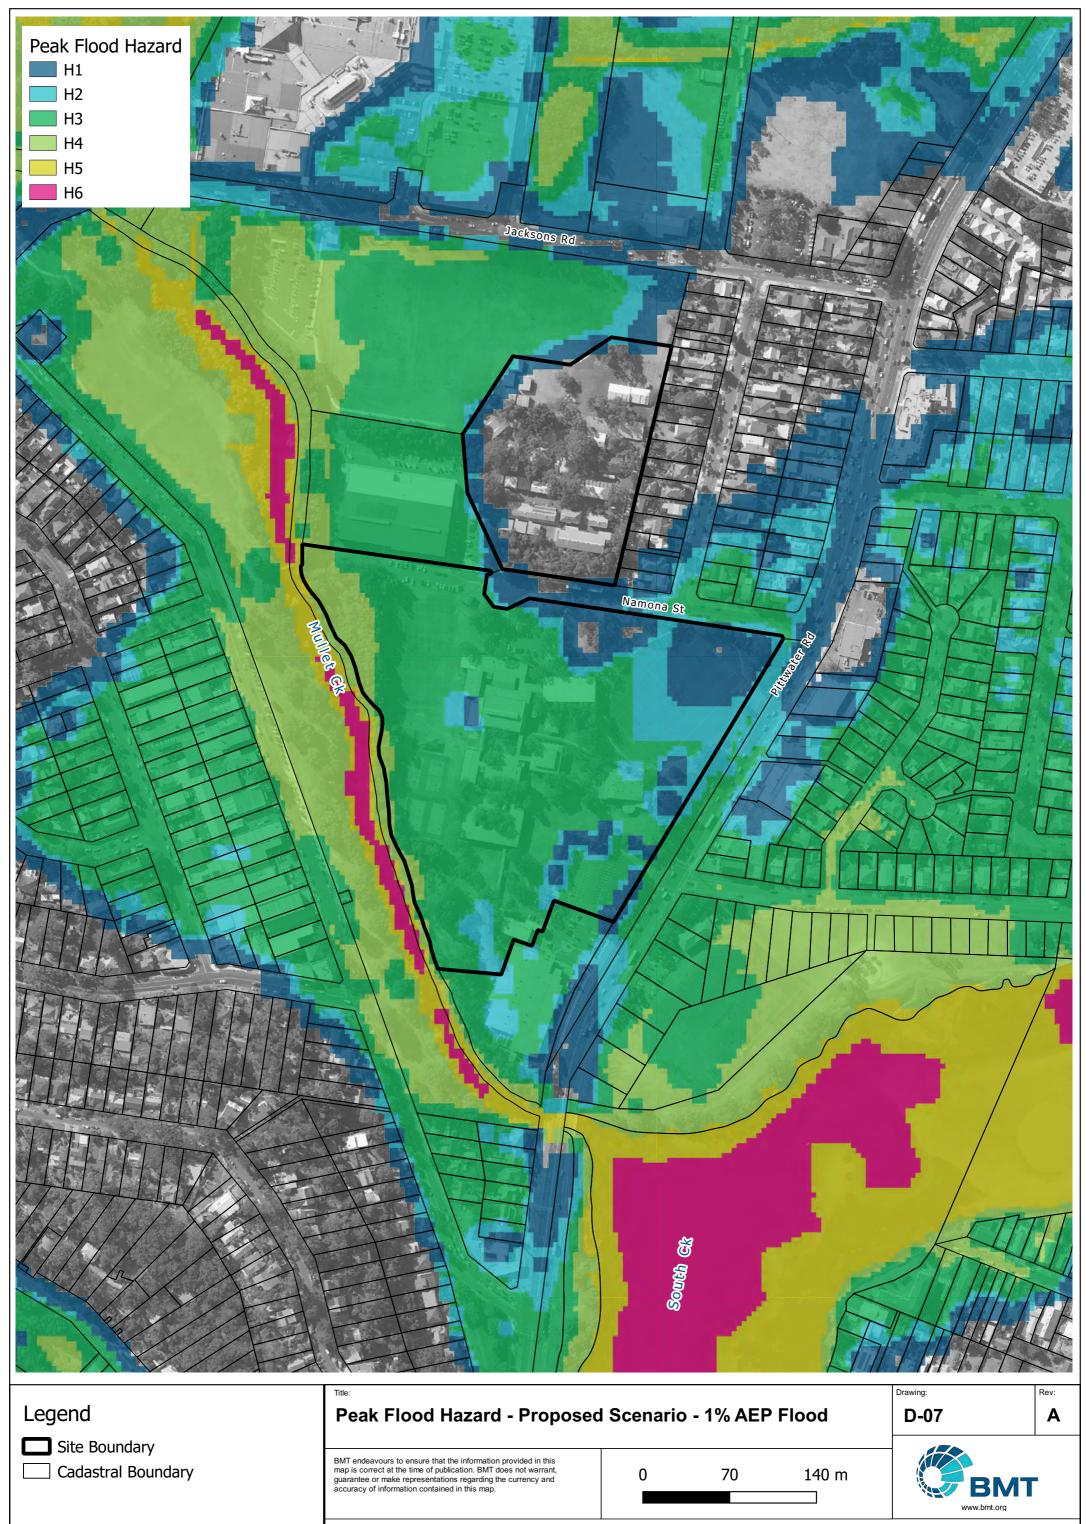
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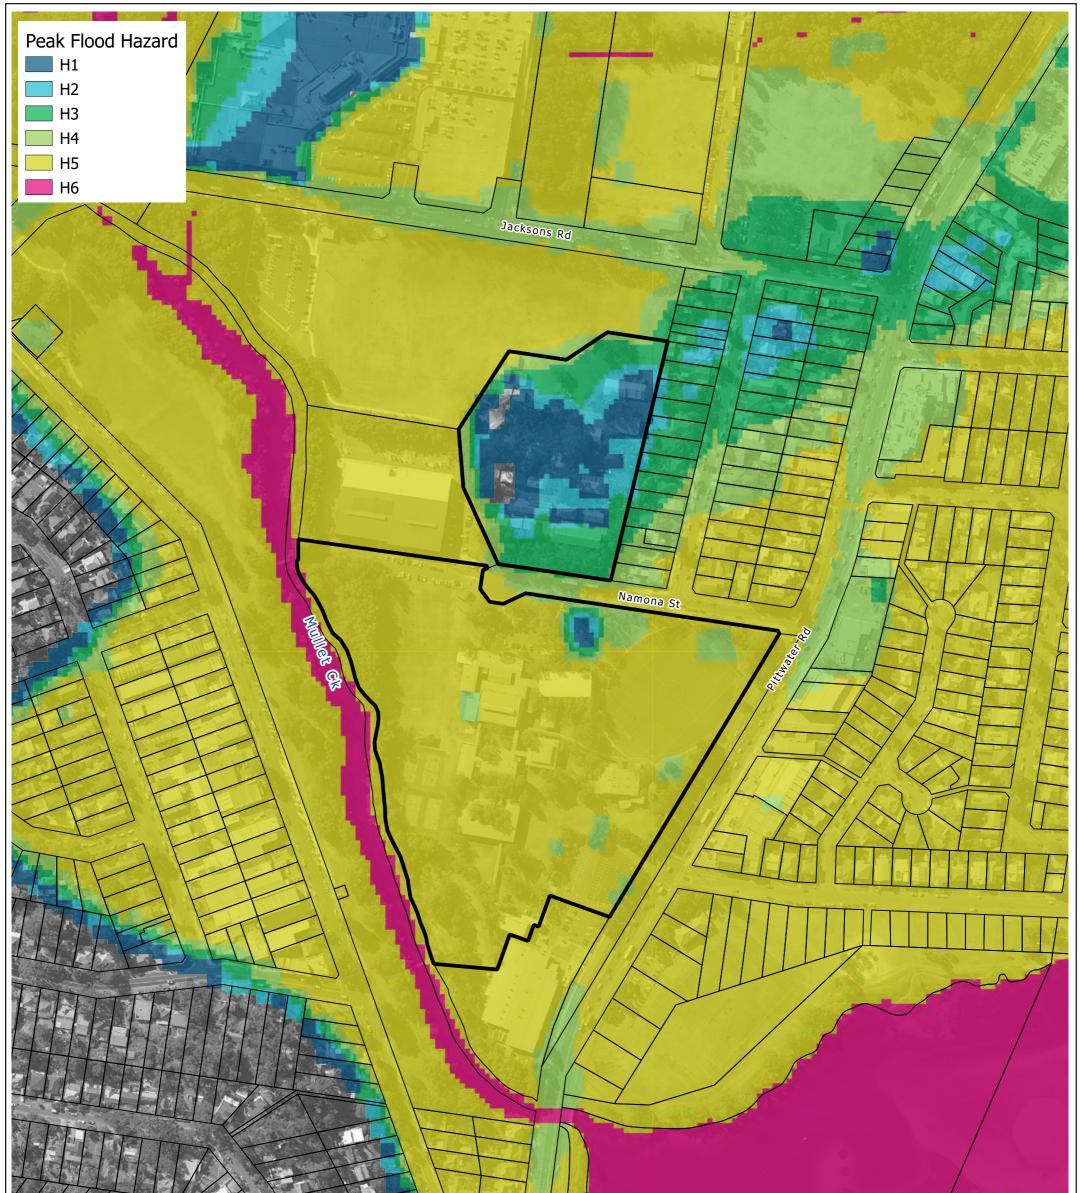
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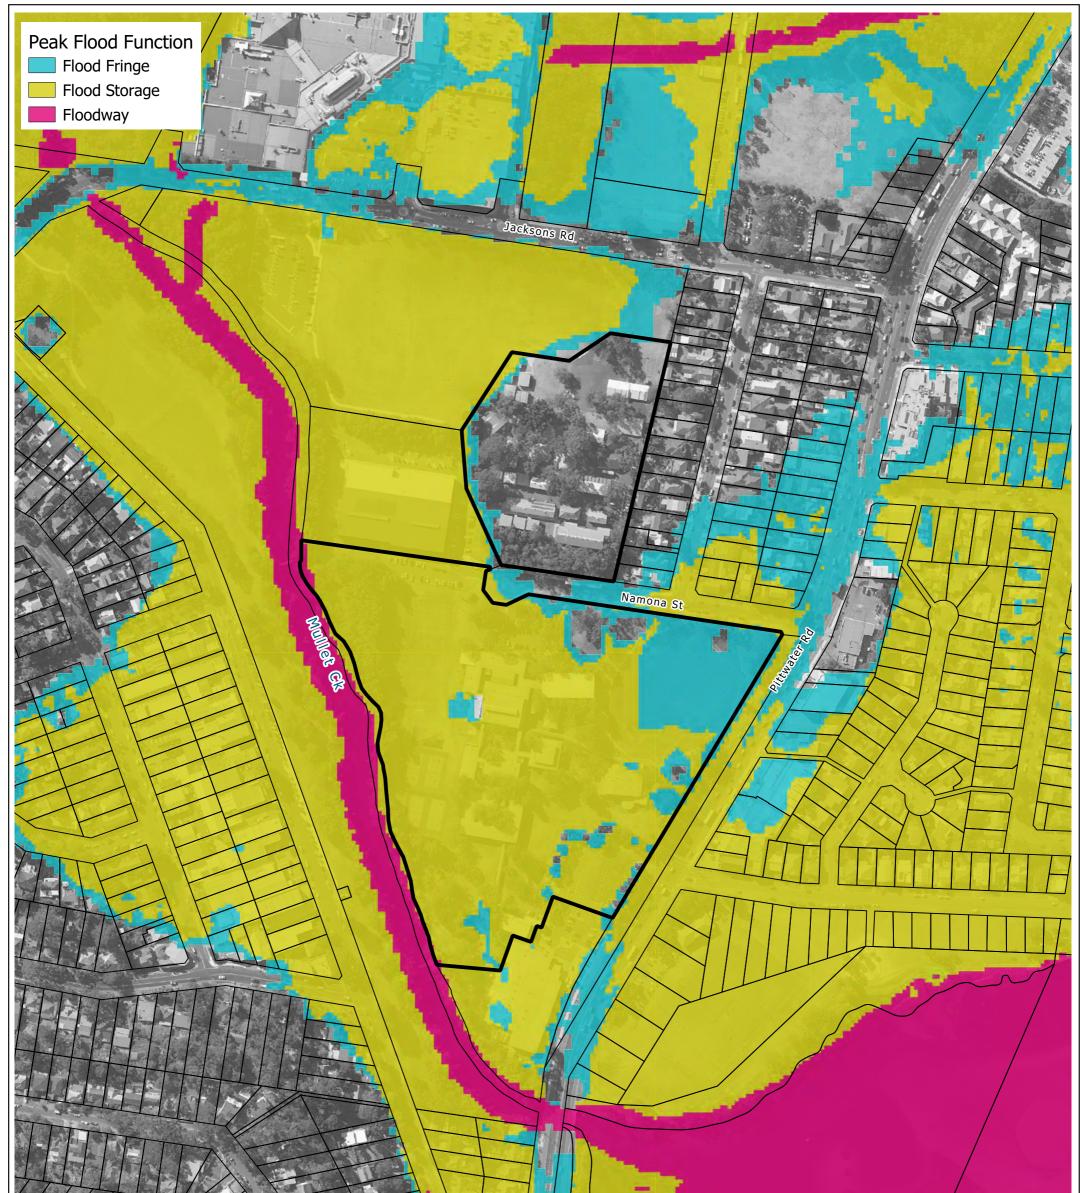
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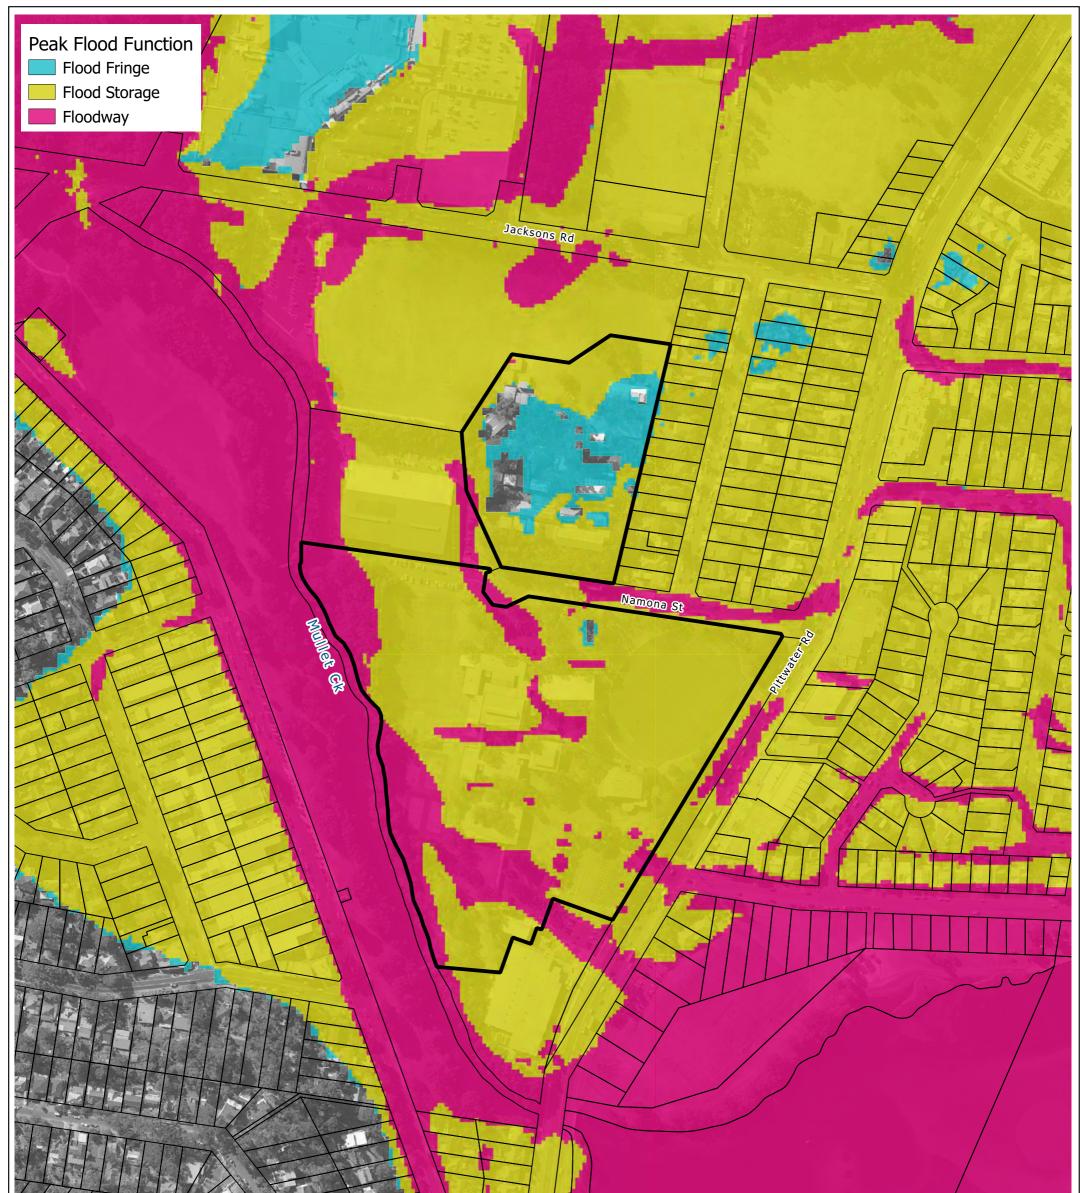
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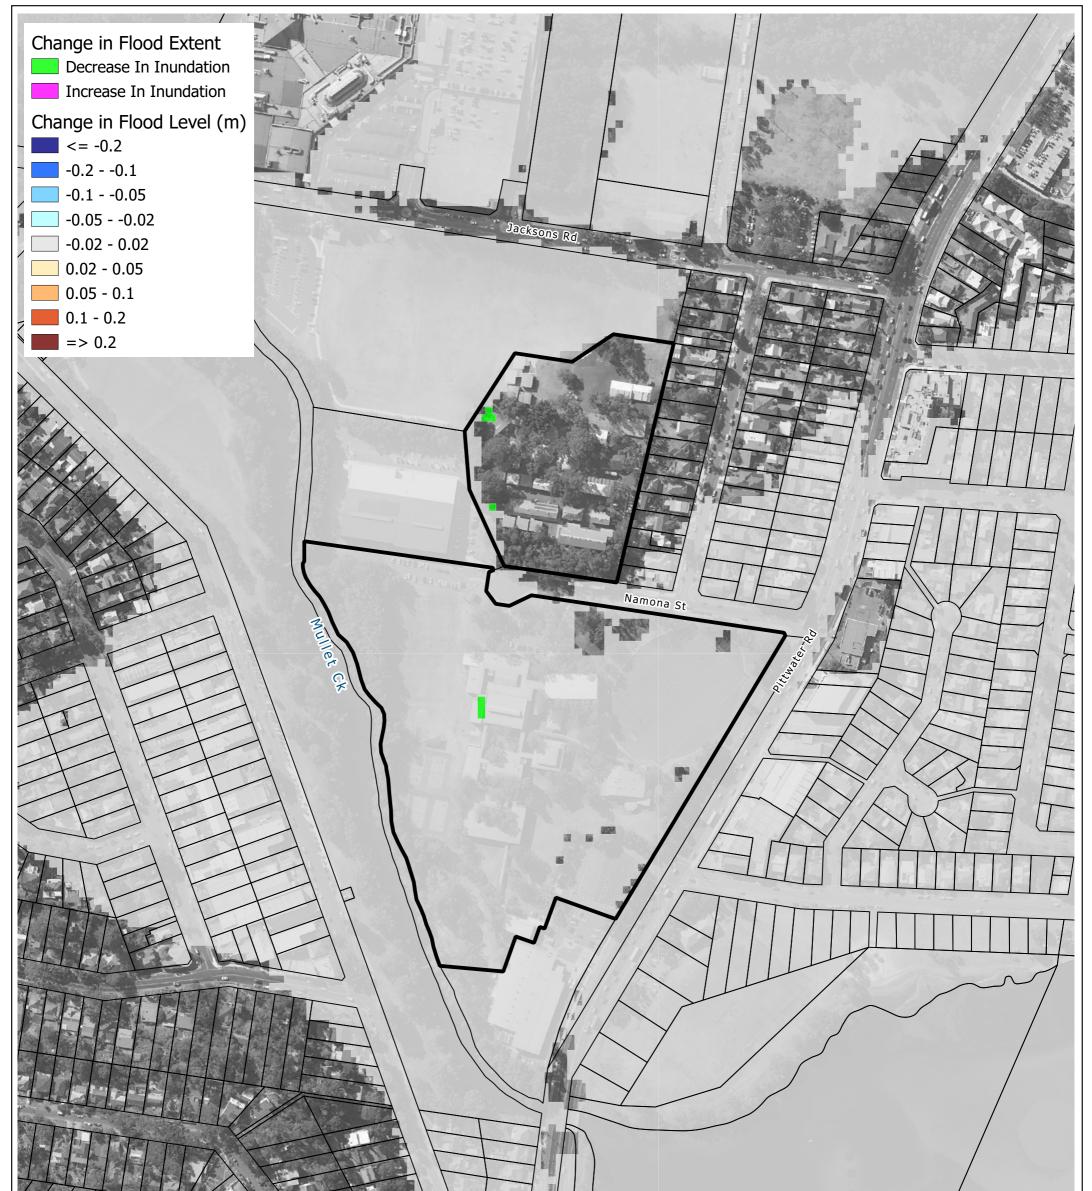
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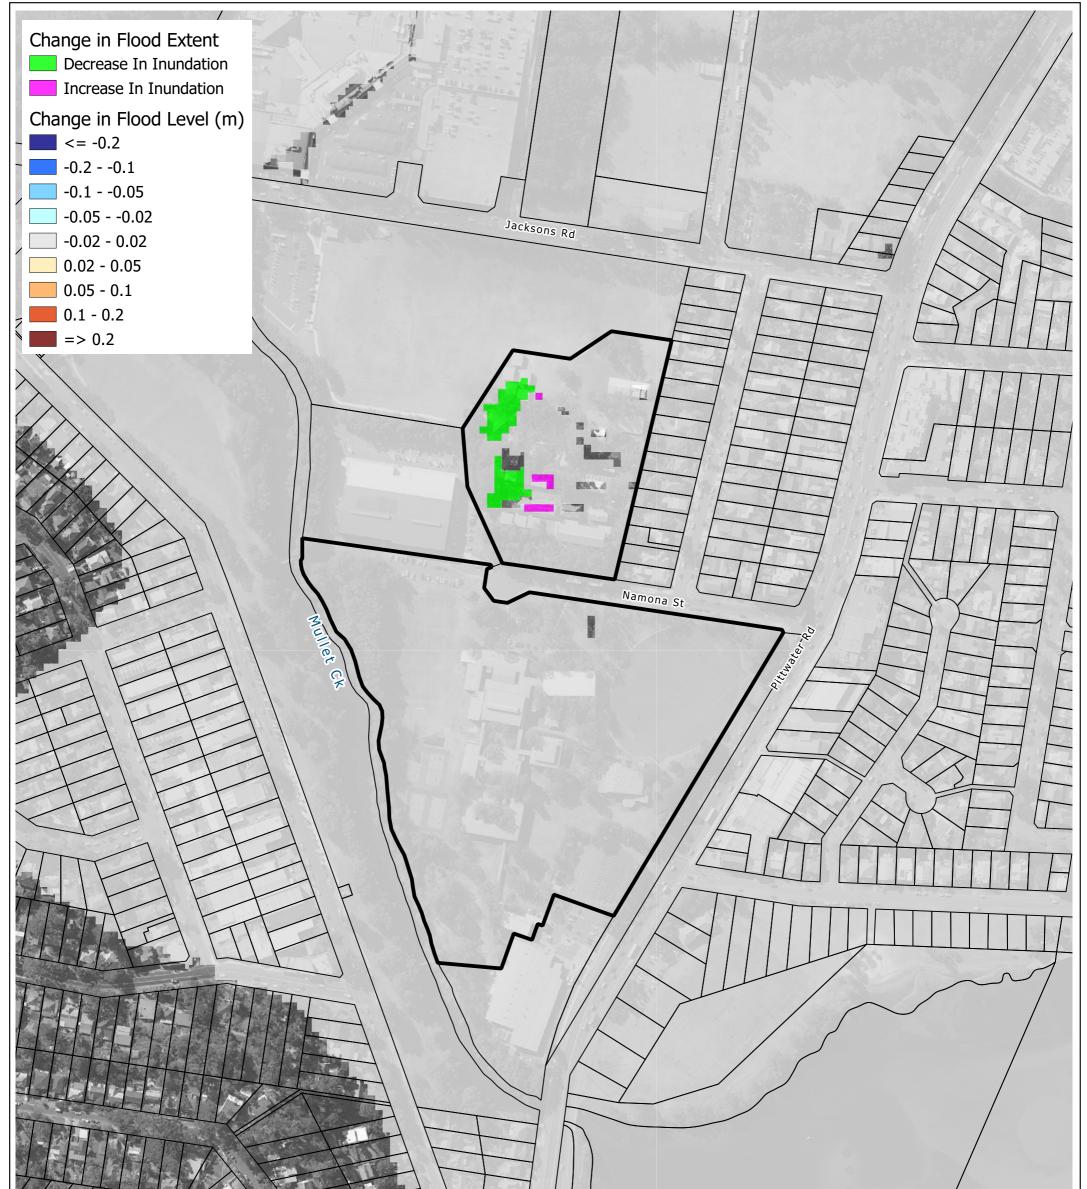
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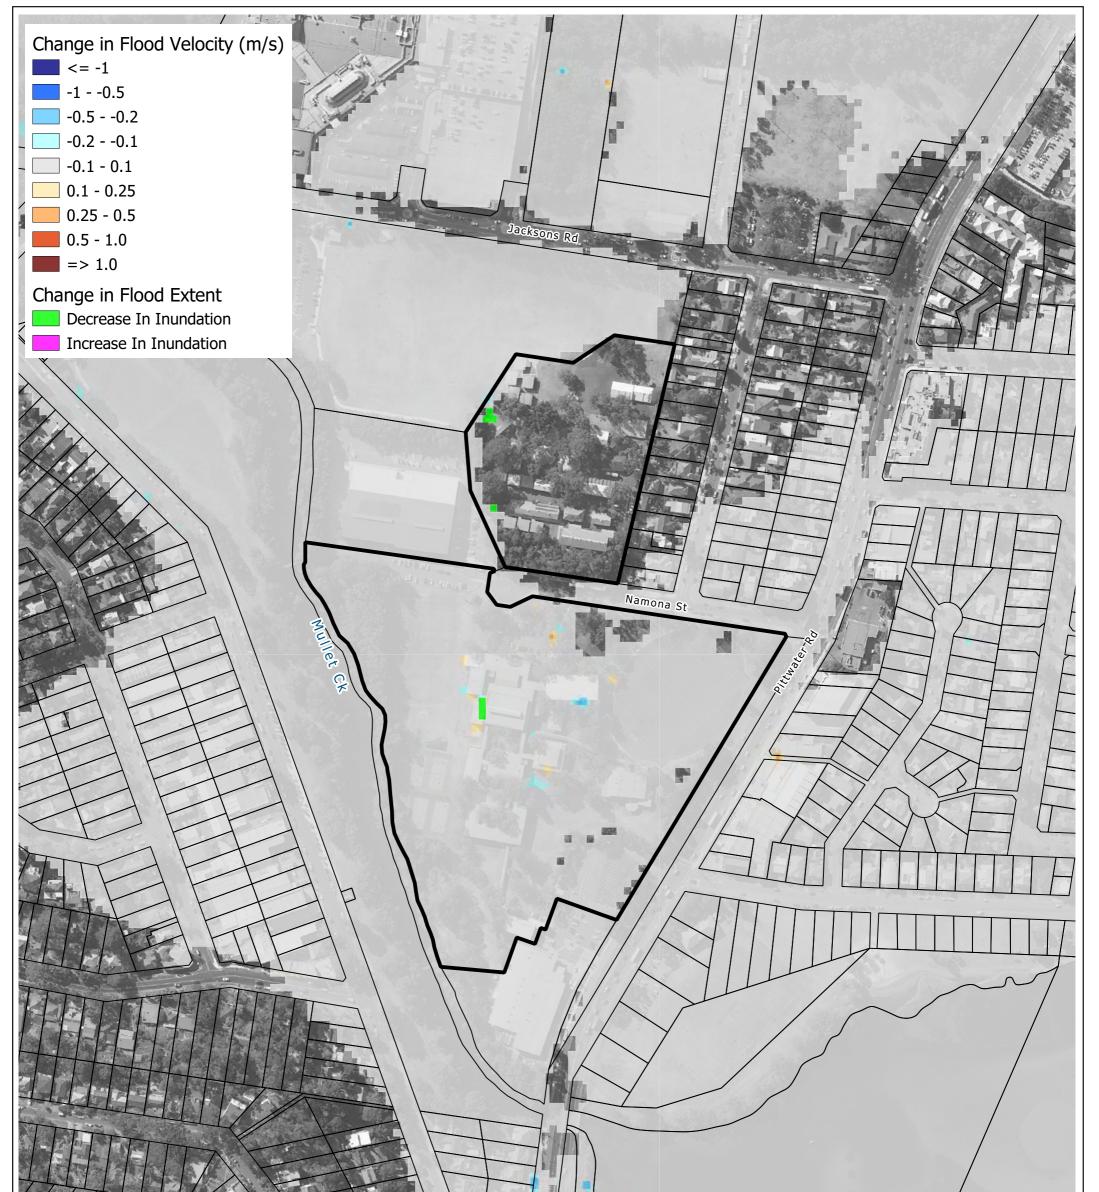
Annex E Flood Impact Mapping

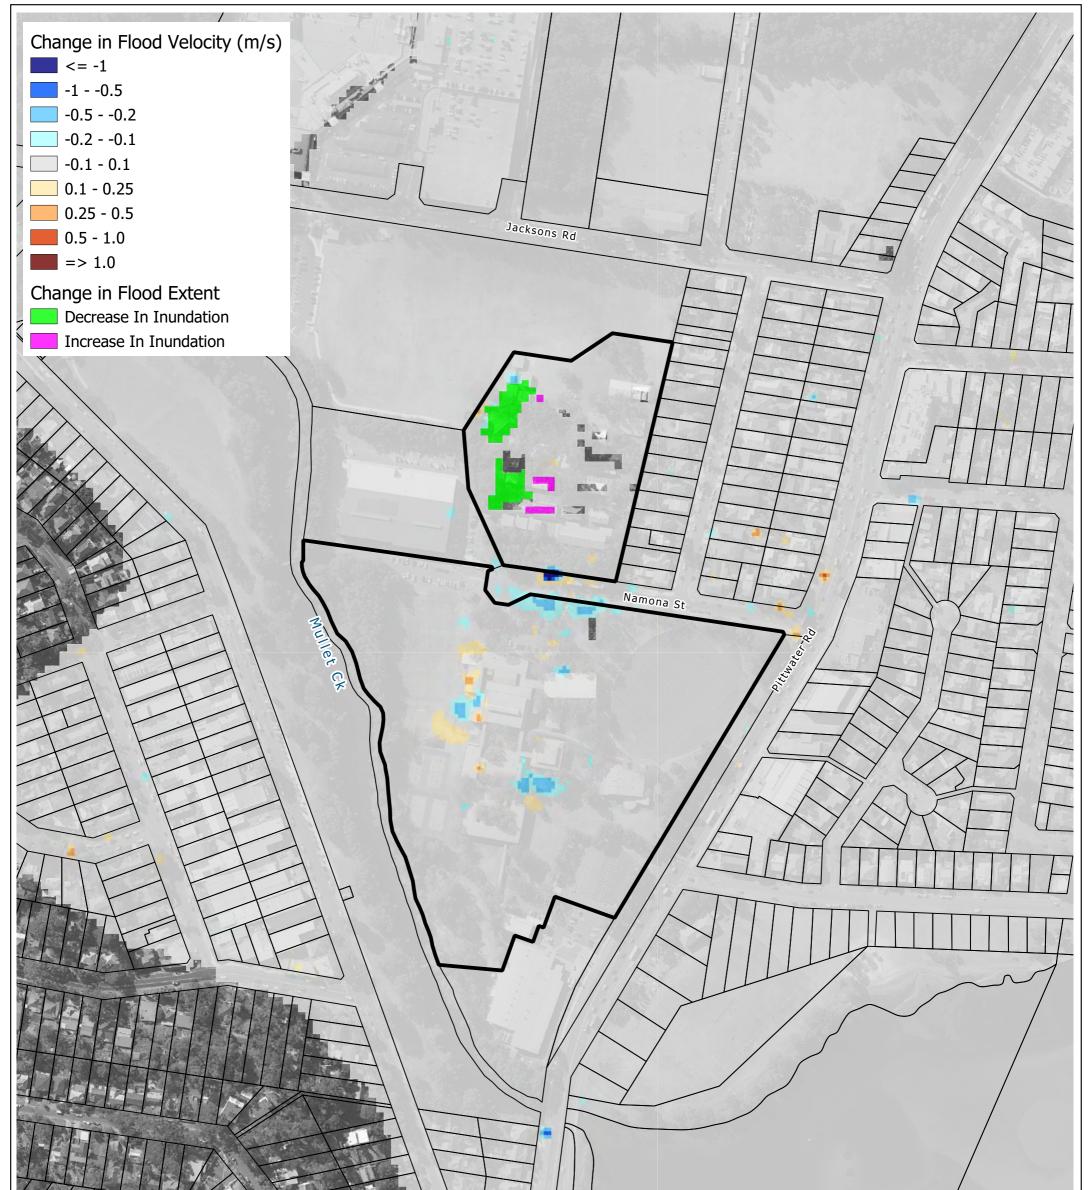


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