PROJECT MAUI - ONCOLOGY


WARRINGAH ROAD & WAKEHURST PARKWAY, FRENCHS FOREST




SHEET LIST- SECTION 4.55					
Sheet Number	Sheet Name	Current Revision	Current Revision Date		
DA					
000-Specific	ation + Site				
DA-0000	COVER SHEET	В	30.06.2022		
DA-0050	ROOF PLAN	В	30.06.2022		
100-Genera	Arrangement Plans				
DA-0103	FLOOR PLAN - GROUND	В	30.06.2022		
200-Elevatio	bns				
DA-0200	ELEVATIONS - SHEET 1	В	30.06.2022		
DA-0201	ELEVATIONS - SHEET 2	В	30.06.202		
DA-0202	ELEVATIONS - SHEET 3	В	30.06.202		


Α	EVELOPMENT APPLIC Revision Description	Date
В	Section 4.55 Update For Section 4.55 application	23.06.202 30.06.202
This drawin Copyright A reproduced, the copyrigh Constructio Team 2 Arcl injury wheth	Team 2 Architects g is protected by copyright. All right are reserved. Unlet ct 1968. No part of this drawing may in any form or by a published, broadcast or transmitted without the prior v ht owner. Please Note: If the status of this drawing is no n it may be subject to change, alteration or amendment hitects. If so, Team 2 Architects is not liable for any los her special, consequential, direct or indirect, suffered b result of your use of this drawing for construction purp	ny means be written permission of t signed off For at the discretion of s, damage, harm or y you or any other
	DRAWING LEGEND: ural drawings shall be read in conjunction with other con	
proceeding 2. All dimen	s. Any discrepancies shall be referred to Team 2 Archil with work. sions and levels are in millimeters unless noted otherwis by scaling the drawing.	
 All dimensional Architects b All work t 	sions to be checked on site with any discrepancies refer efore proceeding with work. o be carried out in accordance with the requirements of	
	rrrent NCC & Australian standards.	
	EASEMENTS INDICATIVE, TBC AS CUI REVIEW	RRENTLY
NOT	<u>'E:</u>	
EAS	' <u>E:</u> EMENTS SUBJECT TO FINA VEY	λL
EAS	— EMENTS SUBJECT TO FINA	λL
EAS	— EMENTS SUBJECT TO FINA	λL
EAS SUR	— EMENTS SUBJECT TO FINA	۹L
EAS SUR Client Gene 11/41-4:	EMENTS SUBJECT TO FINA	λL
EAS SUR Client Gene 11/41-4:	EMENTS SUBJECT TO FINA VEY SISCare 3 Bourke Rd	۹L
EAS SUR Client Gene 11/41-4:	EMENTS SUBJECT TO FINA VEY SISCare 3 Bourke Rd	AL
Client Client Client Client Client	EMENTS SUBJECT TO FINA VEY SISCare 3 Bourke Rd	
Client Gene 11/41-4: Alexand Client Fores Constru	EMENTS SUBJECT TO FINA VEY SisCare 3 Bourke Rd Iria, NSW 2015	
Client Gene 11/41-4: Alexand Client Fores Constru	EMENTS SUBJECT TO FINA VEY sisCare 3 Bourke Rd Iria, NSW 2015 st Central Business Park ction 9 PtyLtd ACN: 613 108 795	
Client Gene 11/41-4: Alexand	EMENTS SUBJECT TO FINA VEY sisCare 3 Bourke Rd Iria, NSW 2015 st Central Business Park ction 9 PtyLtd ACN: 613 108 795	
Client Gene 11/41-4: Alexand	EMENTS SUBJECT TO FINA VEY sisCare 3 Bourke Rd Iria, NSW 2015 st Central Business Park ction 9 PtyLtd ACN: 613 108 795	
Client Gene 11/41-4: Alexand Client Fores Constru	EMENTS SUBJECT TO FINA VEY sisCare 3 Bourke Rd Iria, NSW 2015 st Central Business Park ction 9 PtyLtd ACN: 613 108 795	
Client Gene 11/41-4: Alexand Client Fores Constru	EMENTS SUBJECT TO FINA VEY sisCare 3 Bourke Rd Iria, NSW 2015 st Central Business Park ction 9 PtyLtd ACN: 613 108 795	
Client Gene 11/41-4: Alexand Client Fores Constru	EMENTS SUBJECT TO FINA VEY sisCare 3 Bourke Rd Iria, NSW 2015 st Central Business Park ction 9 PtyLtd ACN: 613 108 795	
Client Gene 11/41-4: Alexand Client Fores Constru L1 55 G	EMENTS SUBJECT TO FINA VEY esisCare 3 Bourke Rd Iria, NSW 2015 est Central Business Park ction 9 PtyLtd ACN: 613 108 795 randview St, Pymble, NSW 2073	
Client Gene 11/41-4: Alexand Client Fores Constru L1 55 G	EMENTS SUBJECT TO FINA- VEY esisCare 3 Bourke Rd bria, NSW 2015 St Central Business Park ction 9 PtyLtd ACN: 613 108 795 randview St, Pymble, NSW 2073 ECON CONSTRUCTION CONSTRUCTION CONSTRUCTION Suite 204/9-11 South	
Client Gene 11/41-4: Alexand Client Fores Constru L1 55 G	esisCare 3 Bourke Rd Iria, NSW 2015 St Central Business Park ction 9 PtyLtd ACN: 613 108 795 randview St, Pymble, NSW 2073 CEACHIEC Chandos Street, 9437 3166 Suite 204/9-11 South 9437 3166 Suite 204/9-11 South	C T S MELBOUR Claremont Stre Yarra VIC 31
Client Gene 11/41-4: Alexand Client Fores Constru L1 55 G	EMENTS SUBJECT TO FINA- VEY esisCare 3 Bourke Rd biria, NSW 2015 St Central Business Park ction 9 PtyLtd ACN: 613 108 795 randview St, Pymble, NSW 2073 EXAMPLE ACN: 613 108 795 RECENTER ACN: 613 108 795 RECENTER ACN: 613 108 795 RECENTER ACN: 613 108 795 EXAMPLE ACN: 613 108 795 RECENTER ACN: 613 108 795 EXAMPLE AC	CTS MELBOUR Claremont Stre Yarra VIC 31 72 104 833 5 Reg Vic: 193
Client Gene 11/41-4: Alexand Client Fores Constru L1 55 G	esisCare 3 Bourke Rd Iria, NSW 2015 est Central Business Park ction 9 PtyLtd ACN: 613 108 795 randview St, Pymble, NSW 2073 EST CENTRAL Business Park ction 9 PtyLtd ACN: 613 108 795 randview St, Pymble, NSW 2073 EST CENTRAL Suite 204/9-11 South 9437 3166 Suite 204/9-11 South 9437 3166 Suite 204/9-11 South 9437 3166 Suite 204/9-11 South 9437 3166 CENTRAL Suite 204/9-11 South 1000 10	CTS MELBOUR Claremont Stre Yarra VIC 31 72 104 833 5 Reg Vic: 193
Client Gene 11/41-4: Alexand Client Fores Constru L1 55 G	esisCare 3 Bourke Rd Iria, NSW 2015 est Central Business Park ction 9 PtyLtd ACN: 613 108 795 randview St, Pymble, NSW 2073 EST CENTRAL Business Park ction 9 PtyLtd ACN: 613 108 795 randview St, Pymble, NSW 2073 EST CENTRAL Suite 204/9-11 South 9437 3166 Suite 204/9-11 South 9437 3166 Suite 204/9-11 South 9437 3166 Suite 204/9-11 South 9437 3166 CENTRAL Suite 204/9-11 South 1000 10	CTS MELBOUR Claremont Stre Yarra VIC 31 72 104 833 5 Reg Vic: 193
Client Gene 11/41-4: Alexand Client Fores Constru L1 55 G	esisCare 3 Bourke Rd Iria, NSW 2015 est Central Business Park ction 9 PtyLtd ACN: 613 108 795 randview St, Pymble, NSW 2073 Extended Street, 10 Suite 204/9-11 South 9437 3166 team2.com.au 7: 9940 Scale Dow:	CTS MELBOUR Claremont Stre Yarra VIC 31 72 104 833 5 Reg Vic: 193
EAS SUR	esisCare 3 Bourke Rd Iria, NSW 2015 est Central Business Park ction 9 PtyLtd ACN: 613 108 795 randview St, Pymble, NSW 2073 Extended Street, 10 Suite 204/9-11 South 9437 3166 team2.com.au 7: 9940 Scale Dow:	C T Start VIC 31 Freq Vic: 193 Start Street



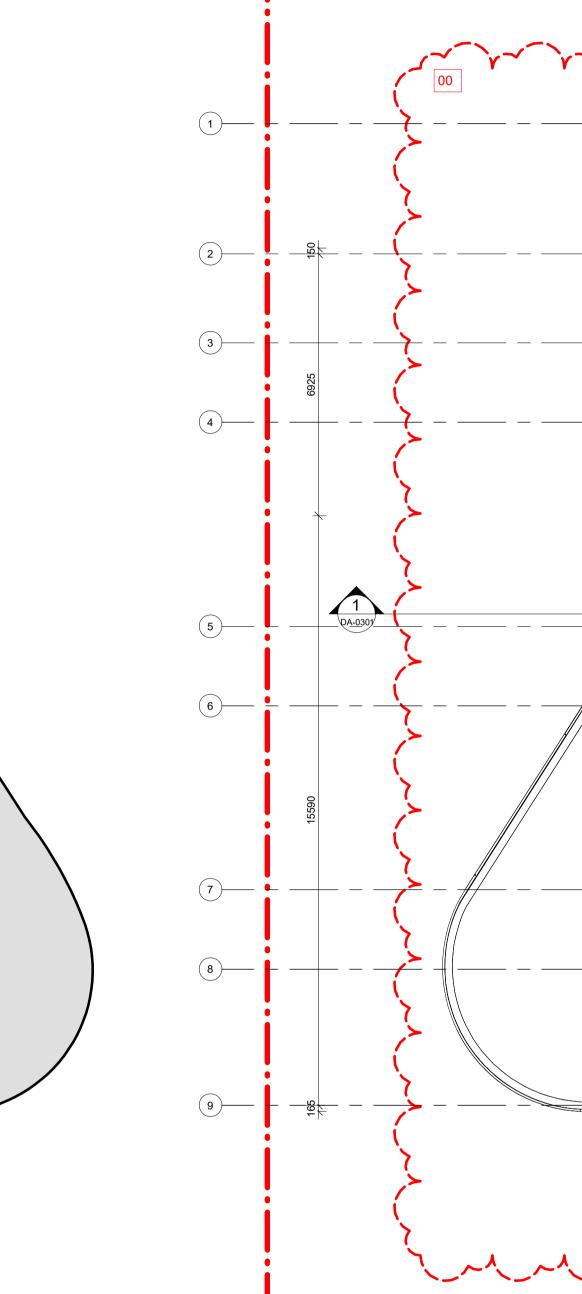


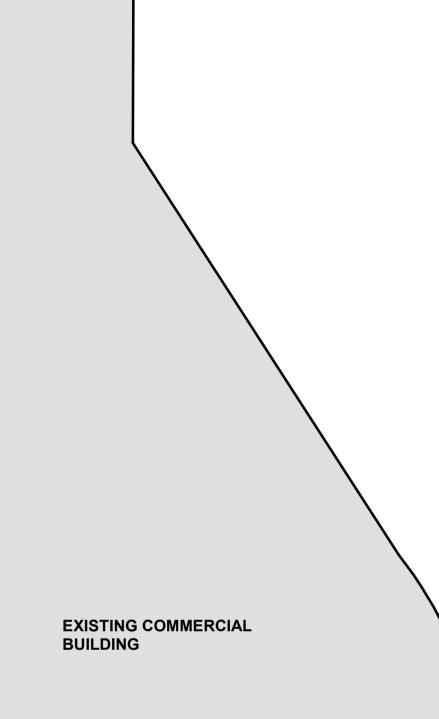



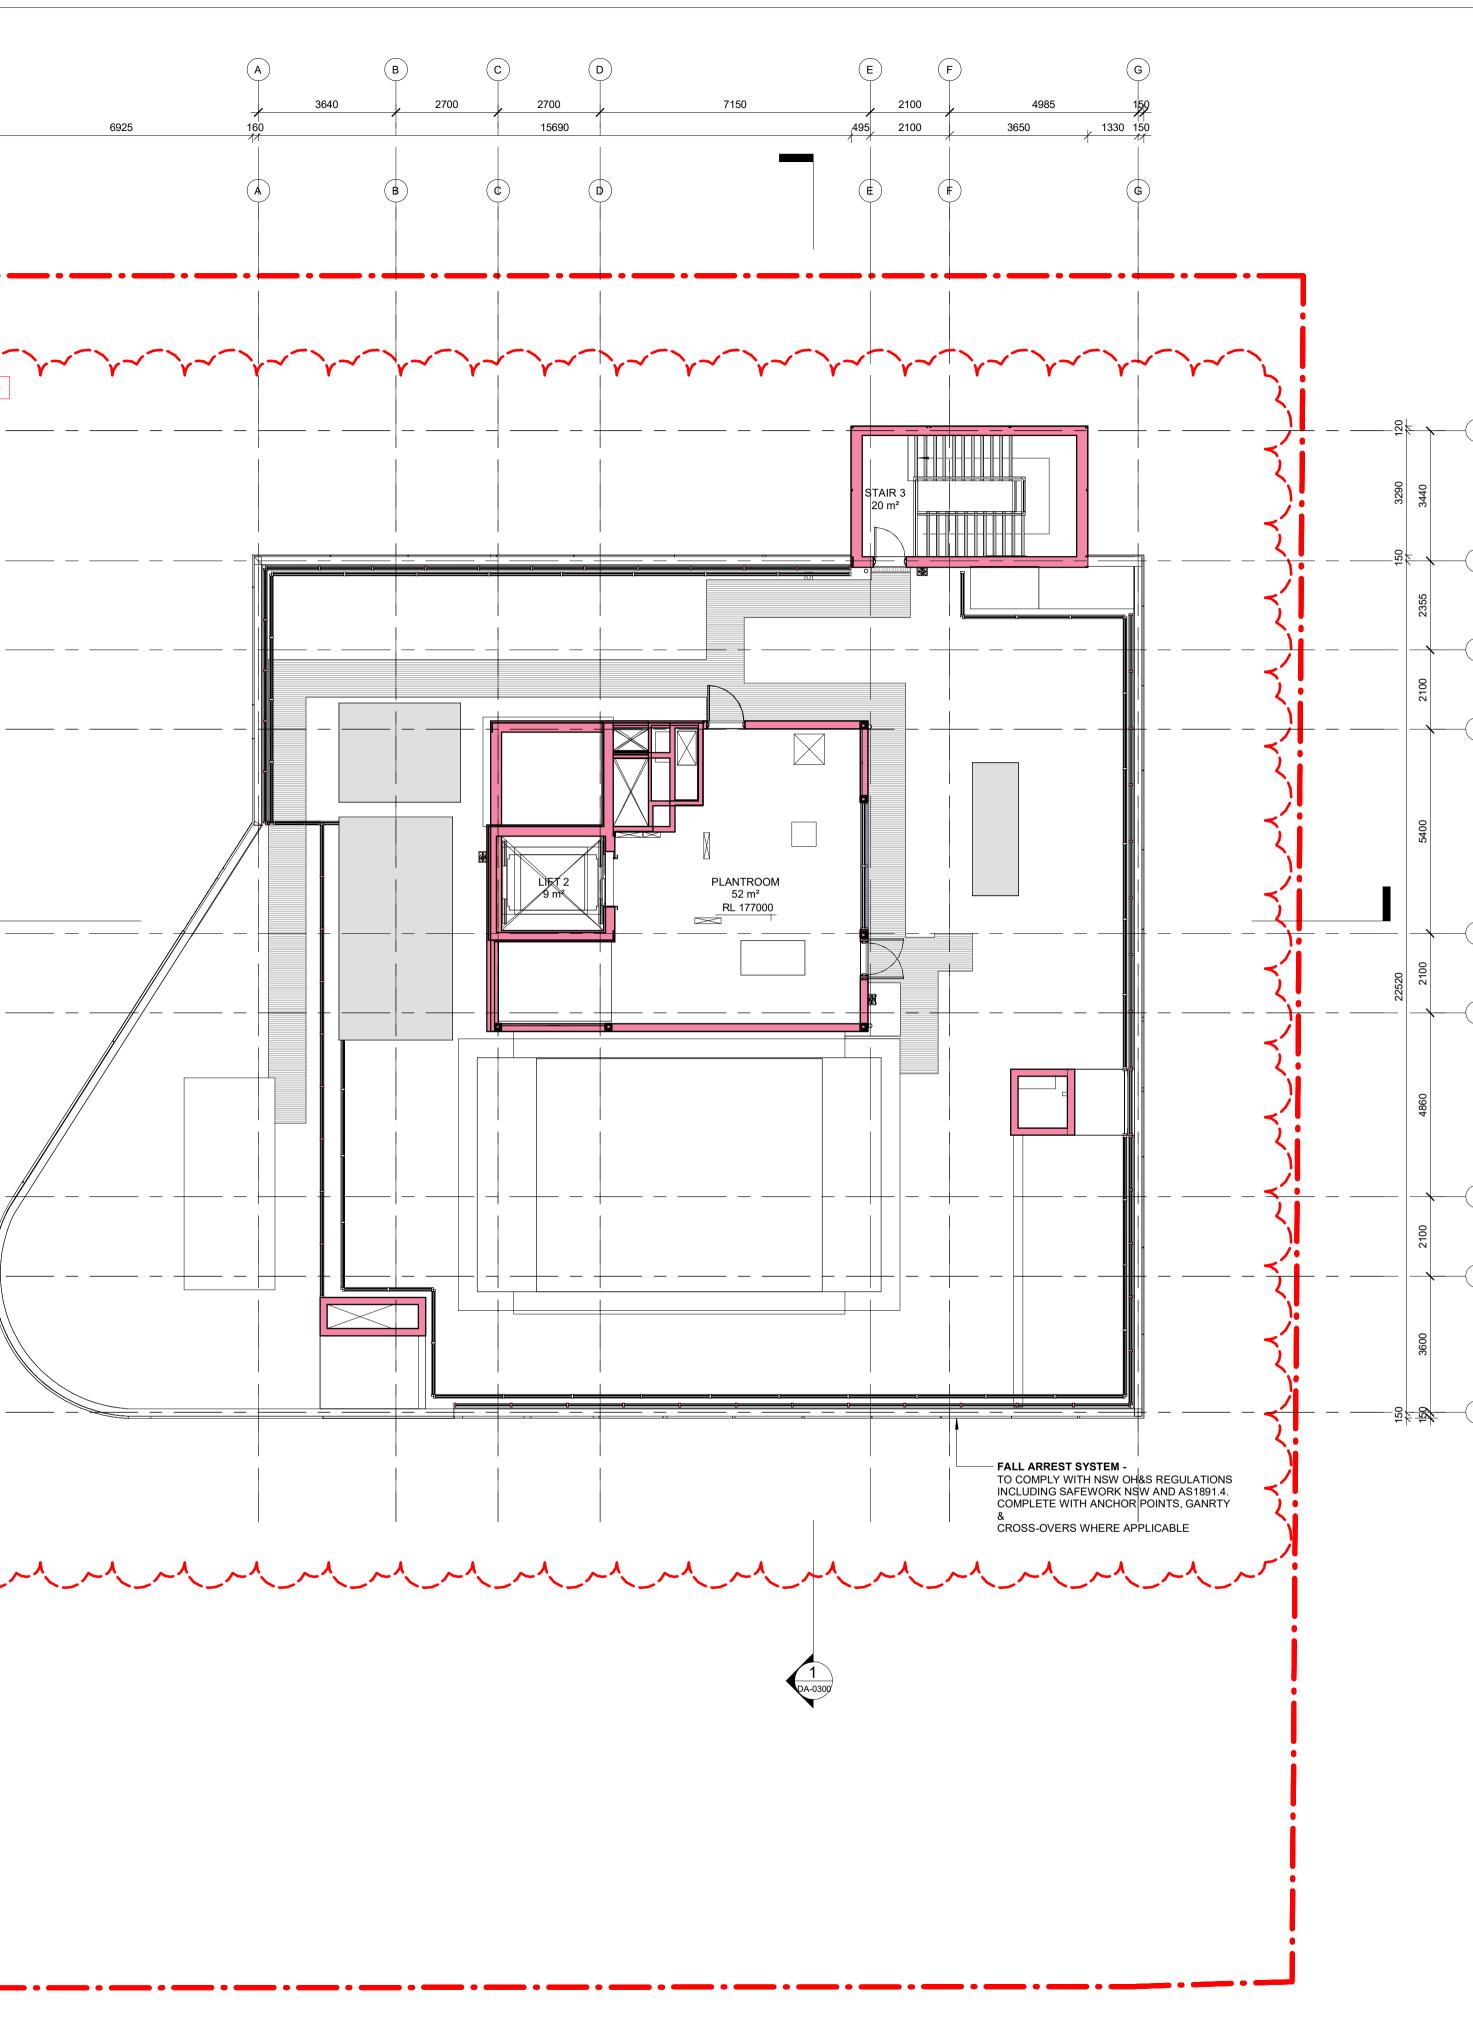


SCHEDULE OF CHANGES	DEVELOPMENT APPLICATION Rev Revision Description Date
00. Change in layout and heights of	A Section 4.55 Update 23.06.202 B For Section 4.55 application 30.06.202
plant and mechanical overruns. External louvre screening updated to suit.	
1. Hydrant booster reocated	
2. Stair and glazing shifted inwards3. Landscaping updated	
4. Row of panels added	
5. Louvre size updated6. Window shifted to accomodate	
columns 7. Levels updated	©Copyright Team 2 Architects This drawing is protected by copyright. All right are reserved. Unless permitted under t Copyright Act 1968. No part of this drawing may in any form or by any means be reproduced, published, broadcast or transmitted without the prior written permission o
8.Service penetrations added	the copyright owner. Please Note: If the status of this drawing is not signed off For Construction it may be subject to change, alteration or amendment at the discretion of Team 2 Architects. If so, Team 2 Architects is not liable for any loss, damage, harm or injury whether special, consequential, direct or indirect, suffered by you or any other
9. Sprinkler control valve, booster assembly and hydrant booster assembly	person as a result of your use of this drawing for construction purposes. DRAWING
moved. 10. Height lowered by 360mm	LEGEND: 1. Architectural drawings shall be read in conjunction with other consultant drawings and specifications. Any discrepancies shall be referred to Team 2 Architects before proceeding with work.
11. Changed from curved glazing to polygonal	 All dimensions and levels are in millimeters unless noted otherwise. No dimension sh be obtained by scaling the drawing. All dimensions to be checked on site with any discrepancies referred to Team 2
12. Louvre removed	 Architects before proceeding with work. All work to be carried out in accordance with the requirements of the principal certifyin authority, current NCC & Australian standards.
13. Balustrade deleted 14. Width reduced	NOTECEASENES INDICATIVE, TBC AS CURRENTLY
15. Increased by 25mm 16. Change to layout and height of	PROPOSED WALLS & FLOORS
overuns.	NEIGHBOURING EXISTING BUILDINGS
17. Louvres extended18. Window size reduced	
19. Glazing and Louvre layout and sizes updated	
20 Louvres deleted, glazing reduced	
21. Reduced from 150 before22. Bollards removed	DEMOLITION/EXCAVATION AREA
23. Planter bed height, balustrade length increased	
24. Window height reduced by 200mm 25. Height reduced	
26. Height increased by 200 27. Finishes updated	
	NOTE: EASEMENTS SUBJECT TO FINAL SURVEY
	TO FINAL SURVEY
	ТО
	TO FINAL SURVEY
	TO FINAL SURVEY Client GenesisCare 11/41-43 Bourke Rd
	TO FINAL SURVEY Client GenesisCare 11/41-43 Bourke Rd Alexandria, NSW 2015
	TO FINAL SURVEY Client GenesisCare 11/41-43 Bourke Rd Alexandria, NSW 2015
	TO FINAL SURVEY Client GenesisCare 11/41-43 Bourke Rd Alexandria, NSW 2015
	TO FINAL SURVEY Client GenesisCare 11/41-43 Bourke Rd Alexandria, NSW 2015
	TO FINAL SURVEY Client GenesisCare 11/41-43 Bourke Rd Alexandria, NSW 2015
	TO FINAL SURVEY
	TO FINAL SURVEY Client GenesisCare 11/41-43 Bourke Rd Alexandria, NSW 2015 Client Forest Central Business Park Construction 9 PtyLtd ACN: 613 108 795 L1 55 Grandview St, Pymble, NSW 2073
	TO FINAL SURVEY
	TO FINAL SURVEY
	TO FINAL SURVEY
	TO FINAL SURVEY Cient GenesisCare 11/41-43 Bourke Rd Alexandria, NSW 2015 Cient Forest Central Business Park Construction 9 PtyLtd ACN: 613 108 795 L1 55 Grandview St, Pymble, NSW 2073 Construction 9 PtyLtd ACN: 613 108 795 L1 55 Grandview St, Pymble, NSW 2073 Construction 9 PtyLtd ACN: 613 108 795 L1 55 Grandview St, Pymble, NSW 2073 Construction 9 PtyLtd ACN: 613 108 795 L1 55 Grandview St, Pymble, NSW 2073 Construction 9 PtyLtd ACN: 613 108 795 L1 55 Grandview St, Pymble, NSW 2073 Construction 9 PtyLtd ACN: 613 108 795 L1 55 Grandview St, Pymble, NSW 2073 Construction 9 PtyLtd ACN: 613 108 795 L1 55 Grandview St, Pymble, NSW 2073 Construction 9 PtyLtd ACN: 613 108 795 L1 55 Grandview St, Pymble, NSW 2073 Construction 9 PtyLtd ACN: 613 108 795 L1 55 Grandview St, Pymble, NSW 2073 Construction 9 PtyLtd ACN: 613 108 795 L1 55 Grandview St, Pymble, NSW 2073 Construction 9 PtyLtd ACN: 613 108 795 L1 55 Grandview St, Pymble, NSW 2073 Construction 9 PtyLtd ACN: 613 108 795 L1 55 Grandview St, Pymble, NSW 2073 Construction 9 PtyLtd ACN: 613 108 795 L1 55 Grandview St, Pymble, NSW 2005 T: + 612 9437 3166 E: info@team2.com.au
	TO FINAL SURVEY Circit GenesisCare 11/41-43 Bourke Rd Alexandria, NSW 2015 Circit Forest Central Business Park Construction 9 PtyLtd ACN: 613 108 795 L 1 55 Grandview St, Pymble, NSW 2073 O O O O O O O O O O O O O O O O O O O
	TO FINAL SURVEY FINAL SURVEY Clim GenesisCare 11/41-43 Bourke Rd Alexandria, NSW 2015 Clim Forest Central Business Park Construction 9 PtyLtd ACN: 613 108 795 L1 55 Grandview St, Pymble, NSW 2073 O O O O Clim Forest Central Business Park Construction 9 PtyLtd ACN: 613 108 795 L1 55 Grandview St, Pymble, NSW 2073 O O O O Construction 9 PtyLtd ACN: 613 108 795 L1 55 Grandview St, Pymble, NSW 2073 O O O Construction 9 PtyLtd ACN: 613 108 795 L1 55 Grandview St, Pymble, NSW 2073 O Construction 9 PtyLtd ACN: 613 108 795 L1 55 Grandview St, Pymble, NSW 2073 O Construction 9 PtyLtd ACN: 613 108 795 L1 55 Grandview St, Pymble, NSW 2073 O Construction 9 PtyLtd ACN: 613 108 795 L1 55 Grandview St, Pymble, NSW 2073 O Construction 9 PtyLtd ACN: 613 108 795 L1 55 Grandview St, Pymble, NSW 2073 Construction 9 PtyLtd ACN: 613 108 795 L1 55 Grandview St, Pymble, NSW 2073 Construction 9 PtyLtd ACN: 613 108 795 L1 55 Grandview St, Pymble, NSW 2073 Construction 9 PtyLtd ACN: 613 108 795 L1 55 Grandview St, Pymble, NSW 2073 Construction 9 PtyLtd ACN: 613 108 795 L1 55 Grandview St, Pymble, NSW 2073 Construction 9 PtyLtd ACN: 613 108 795 L1 55 Grandview St, Pymble, NSW 2073 Construction 9 PtyLtd ACN: 613 108 795 L1 55 Grandview St, Pymble, NSW 2073 Construction 9 PtyLtd ACN: 613 108 795 L1 55 Grandview St, Pymble, NSW 2073 Construction 9 PtyLtd ACN: 613 108 795 L1 55 Grandview St, Pymble, NSW 2075 Construction 9 PtyLtd ACN: 613 108 795 L1 55 Grandview St, Pymble, NSW 2075 Construction 9 PtyLtd ACN: 613 108 795 L1 55 Grandview St, Pymble, NSW 2005 Construction 9 PtyLtd ACN: 613 108 Construction 9 PtyLtd ACN: 613 108 795 L1 55 Grandview St, Pymble, NSW 2005 Construction 9 PtyLtd ACN: 613 108 Construction 9 PtyLtd ACN:
	TO FINAL SURVEY
	TO FINAL SURVEY

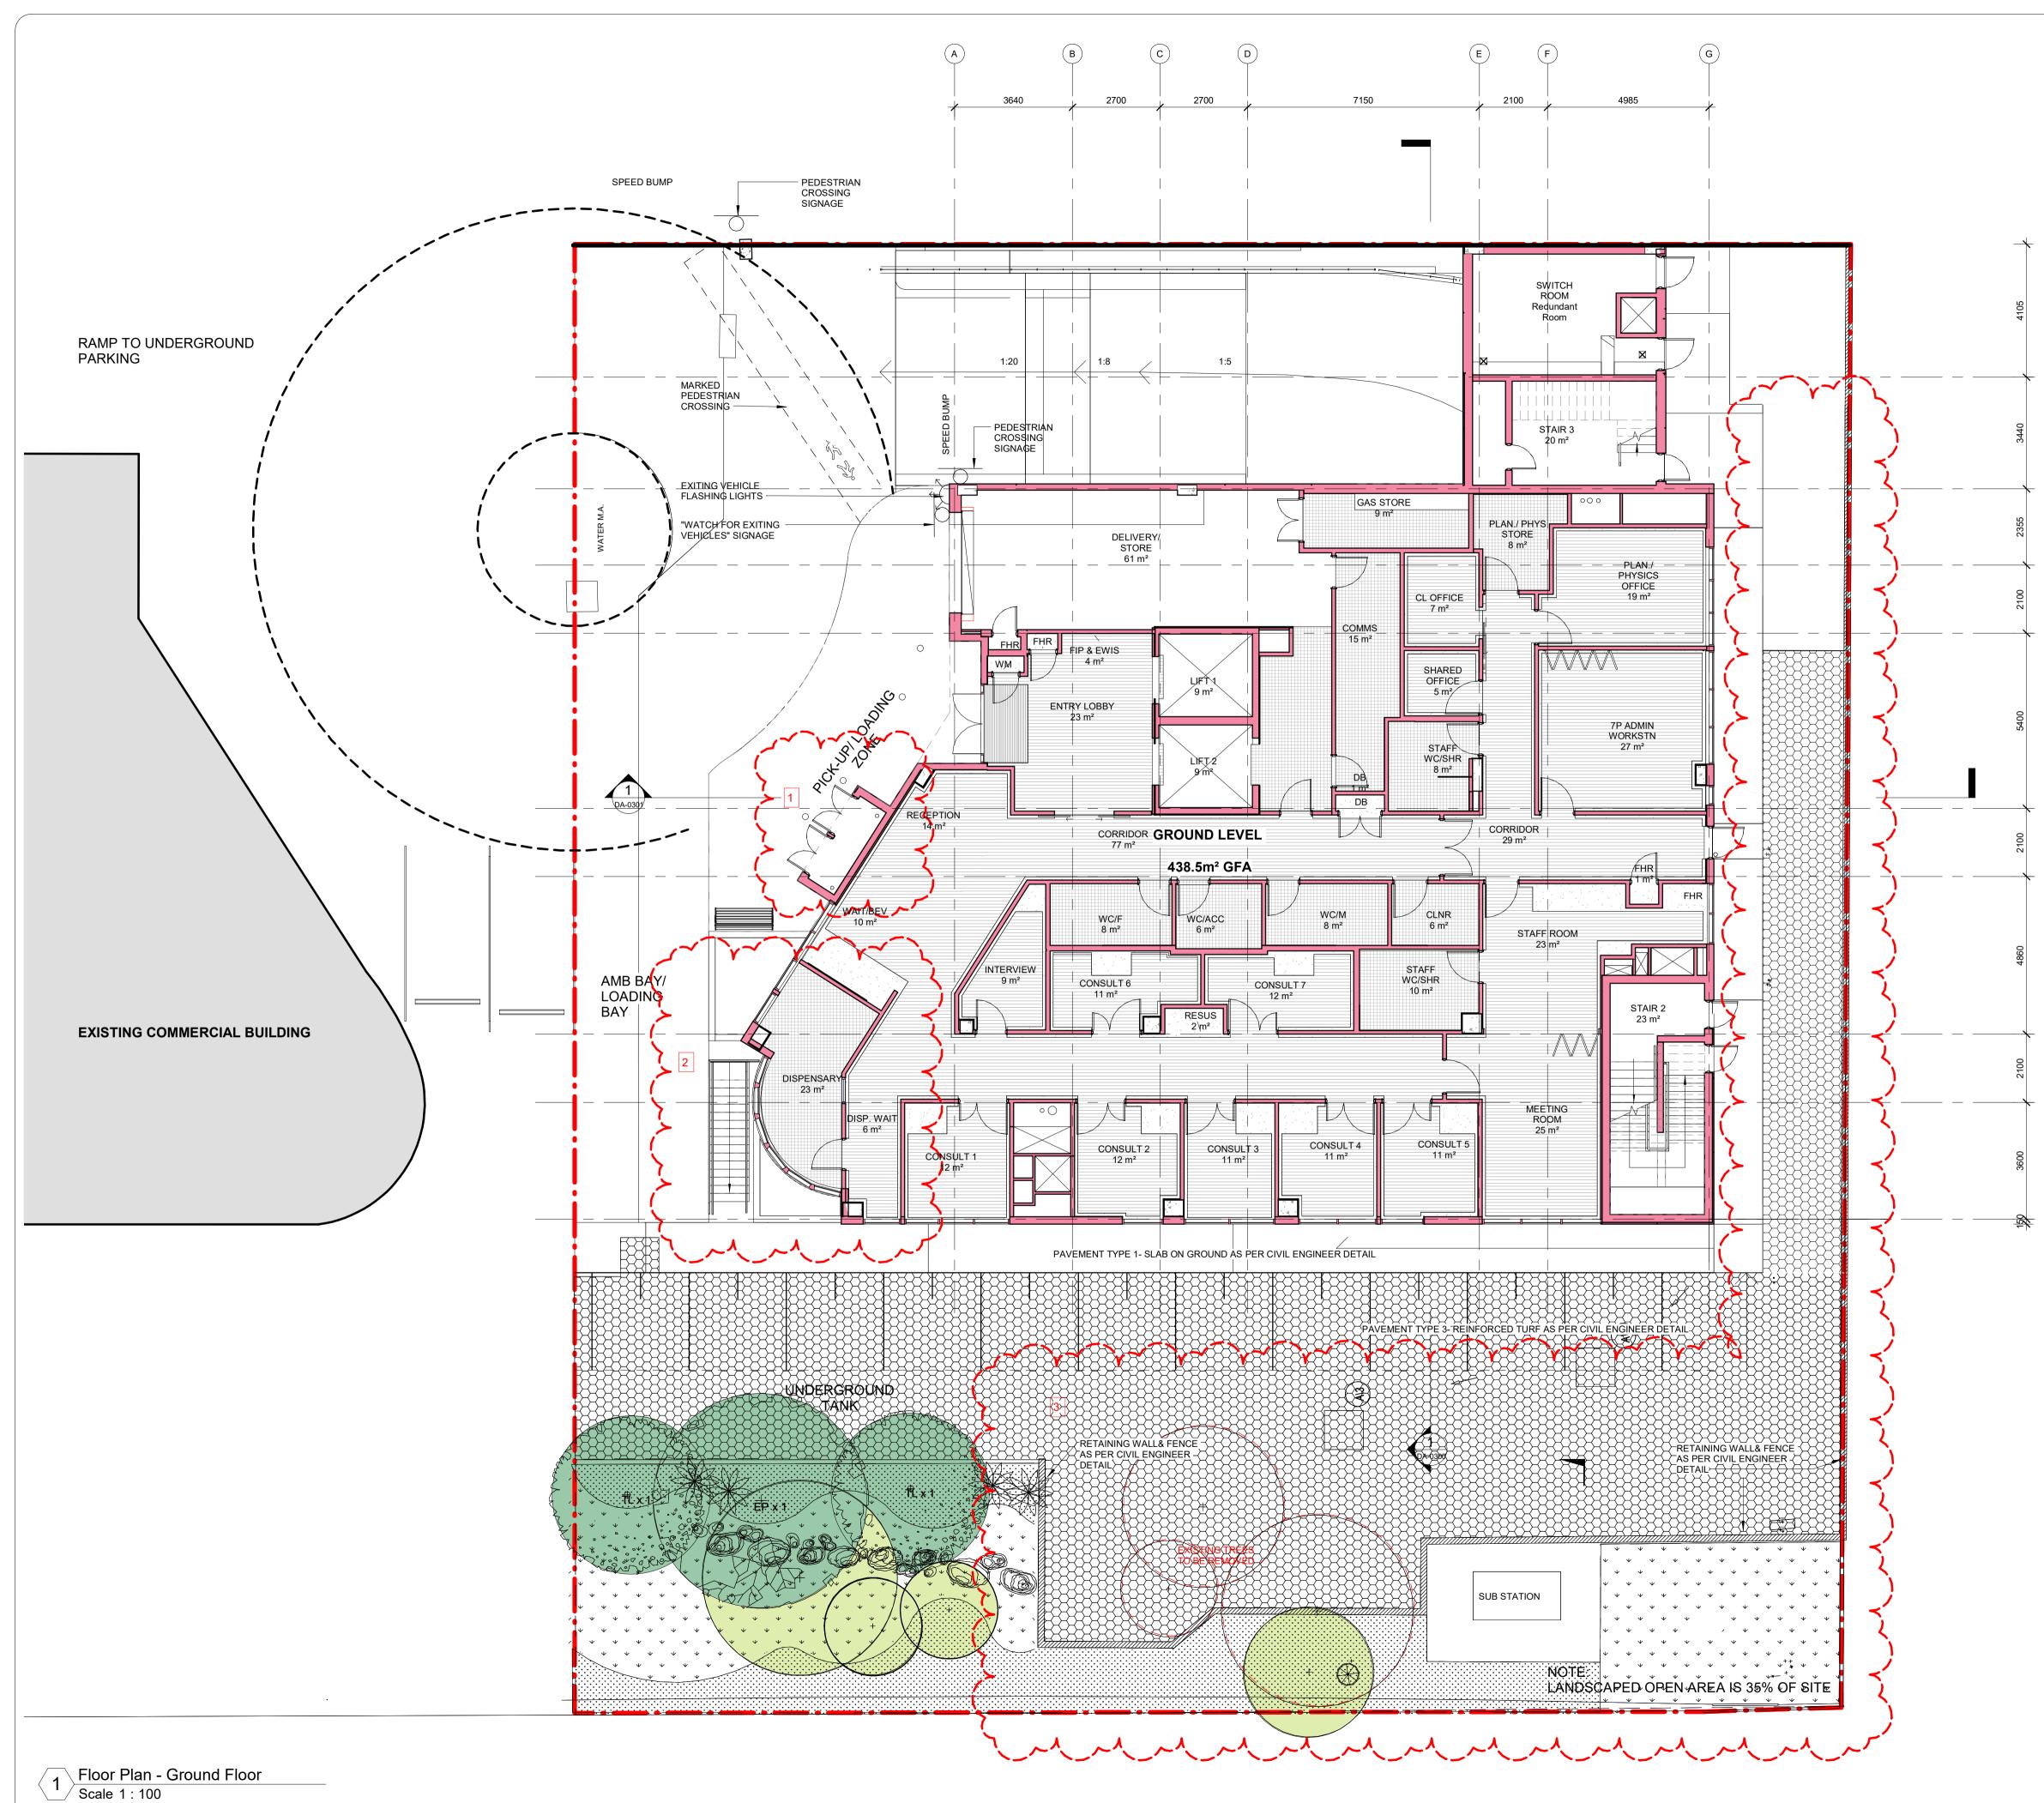


:

			DRAWING STATUS:	
		Rev	Revision Description Section 4.55 Update	Date 23.06.2022
		B	For Section 4.55 application	30.06.2022
		©Copyright	Team 2 Architects	
		This drawin Copyright A reproduced,	g is protected by copyright. All right are reserved. Unl ct 1968. No part of this drawing may in any form or by published, broadcast or transmitted without the prior	any means be written permission of
		Construction Team 2 Arch	t owner. Please Note: If the status of this drawing is n it may be subject to change, alteration or amendmer litects. If so, Team 2 Architects is not liable for any lo er special, consequential, direct or indirect, suffered	nt at the discretion of oss, damage, harm or
		person as a	result of your use of this drawing for construction pu DRAWING	rposes.
			LEGEND: Irral drawings shall be read in conjunction with other cc s. Any discrepancies shall be referred to Team 2 Arcl with work	
1		2. All dimensible obtained 3. All dimension	sions and levels are in millimeters unless noted otherw by scaling the drawing. sions to be checked on site with any discrepancies reference of the state of th	
		4. All work to	efore proceeding with work. b be carried out in accordance with the requirements o rrent NCC & Australian standards.	f the principal certifying
		NOTE:	EASEMENTS INDICATIVE, TBC AS CL	JRRENTLY
			<u>SENES:</u>	
2			PROPOSED WALLS & FLO	ORS
			BUILDINGS	•
		E.	EXISTING PLANTING	
3		E.	PROPOSED PLANTING	
				N AREA
5				
U				
7				
(8)				
0				
	SCHEDULE OF CHANGES			
9	00. Change in layout and heights of plant and mechanical overruns. External		OTE: EASEMENTS SUBJE	CT TO
	louvre screening updated to suit. 1. Hydrant booster reocated			
	2. Stair and glazing shifted inwards	_{Client} Gene	sisCare	
	 Landscaping updated Row of panels added 		3 Bourke Rd ria, NSW 2015	
	5. Louvre size updated6. Window shifted to accomodate			
	columns			
	7. Levels updated 8.Service penetrations added	<u>Client</u> Fores	t Central Business Par	k
	9. Sprinkler control valve, booster assembly and hydrant booster assembly	Construe	ction 9 PtyLtd ACN: 613 108 795 randview St, Pymble, NSW 2073	
	moved.			
	10. Height lowered by 360mm 11. Changed from curved glazing to		(-+)	
	polygonal 12. Louvre removed		0 1 2 3 4	5
	13. Balustrade deleted		SCALE	
	14. Width reduced 15. Increased by 25mm			
	16. Change to layout and height of			
	overuns. 17. Louvres extended	AF	RCHITE	CTS
	18. Window size reduced 19. Glazing and Louvre layout and sizes	SYDNEY Lvl 1/45 C	handos Street, Suite 204/9-11	MELBOURNE 1 Claremont Street, th Yarra VIC 3141
	updated	T: + 61 2	9437 3166 eam2.com.au ABN	N: 72 104 833 507 Reg Vic: 19340
	20 Louvres deleted, glazing reduced 21. Reduced from 150 before	Project:	ct Maui, Frenches Fore	
	22. Bollards removed	Warri	ngah Road & Wakehur	
	23. Planter bed height, balustrade length increased	Parkv	•	
	24. Window height reduced by 200mm 25. Height reduced		R PLAN - GROUND	
	26. Height increased by 200	Project #: 856		SG VM
	27. Finishes updated	<u>Drawing #:</u>	DA-0103	B

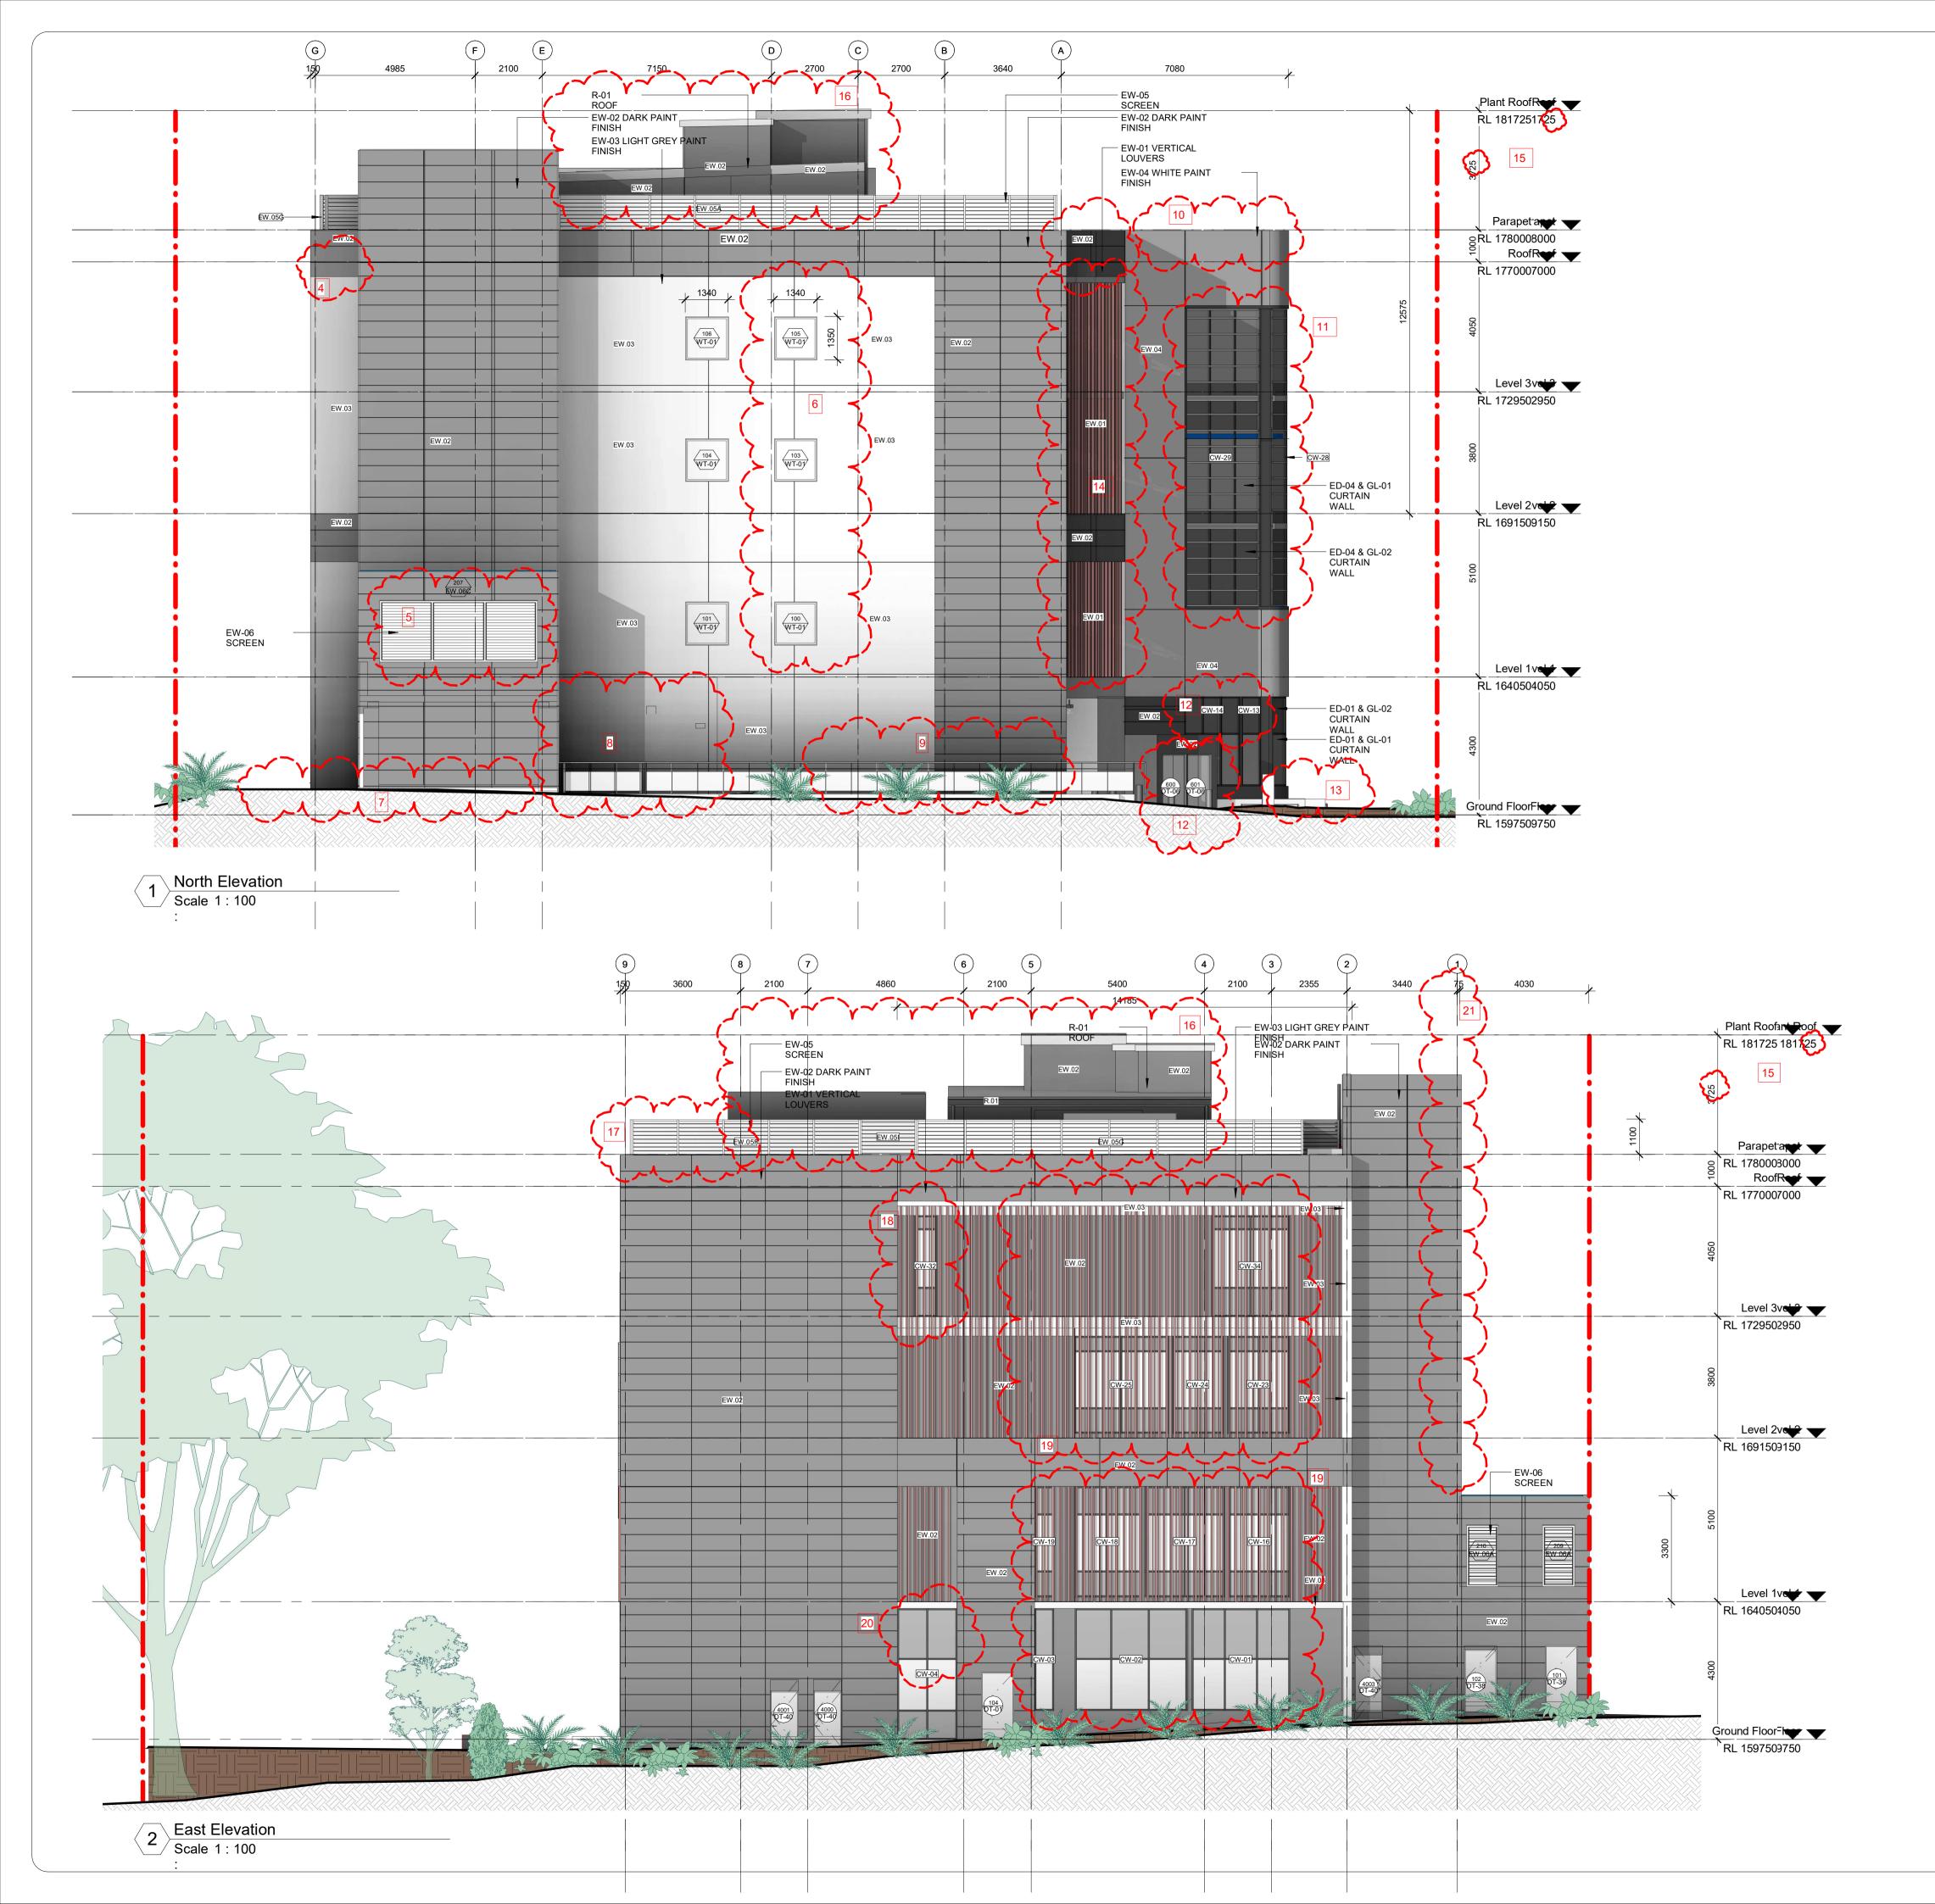


		DRAWING STATUS:	
	Rev	Revision Description	Date
CHEDULE OF CHANGES	A B	Section 4.55 Update For Section 4.55 application	23.06.2022 30.06.2022
 Change in layout and heights of ant and mechanical overruns. External 			
uvre screening updated to suit.			
Hydrant booster reocated			
Stair and glazing shifted inwards			
Row of panels added			
Louvre size updated	This drawin	Team 2 Architects g is protected by copyright. All right are reserved. Un	
Window shifted to accomodate	reproduced the copyrig	Let 1968. No part of this drawing may in any form or by , published, broadcast or transmitted without the prio ht owner. Please Note: If the status of this drawing is i	r written permission of not signed off For
Levels updated	Team 2 Arc injury whet	n it may be subject to change, alteration or amendme hitects. If so, Team 2 Architects is not liable for any l her special, consequential, direct or indirect, suffered	oss, damage, harm or by you or any other
Service penetrations added	person as a	DRAWING	rposes.
Sprinkler control valve, booster ssembly and hydrant booster assembly		LEGEND: ural drawings shall be read in conjunction with other or ns. Any discrepancies shall be referred to Team 2 Arc	
oved.	proceeding 2. All dimen	with work. sions and levels are in millimeters unless noted otherw	
). Height lowered by 360mm	3. All dimen Architects b	by scaling the drawing. sions to be checked on site with any discrepancies ref before proceeding with work.	
1. Changed from curved glazing to		to be carried out in accordance with the requirements of urrent NCC & Australian standards.	of the principal certifying
olygonal 2. Louvre removed		EASEMENTS INDICATIVE, TBC AS CI	JRRENTLY
3. Balustrade deleted		R REVIEW	
4. Width reduced			
5. Increased by 25mm 6. Change to layout and height of			
veruns.			
7. Louvres extended			
 B. Window size reduced B. Glazing and Louvre layout and sizes 			
dated			
) Louvres deleted, glazing reduced			
. Reduced from 150 before . Bollards removed			
. Planter bed height, balustrade length			
creased			
. Window height reduced by 200mm			
6. Height increased by 200			
7. Finishes updated			
	Client		
		sisCare	
		3 Bourke Rd Iria, NSW 2015	
	Client		
	Fores	st Central Business Par	k
		ction 9 PtyLtd ACN: 613 108 795 irandview St, Pymble, NSW 2073	
	1		

SCA				
1:10				
A R SYDNEY Lvl 1/45 Chando St Leonards NS T: + 61 2 9437 E: info@team2, Reg NSW: 9940	os Street, SW 2065 3166 .com.au		ME /9-11 Claren South Yarra ABN: 72 10	LBOURNE nont Street, VIC 3141
Project: Project M Warringa Parkway				
Title: ELEVATIO	DNS - SH	IEET 1	Drw:	Ckd:
856	A-02	icated ¹	SG ^{Rev} E	<u></u> З

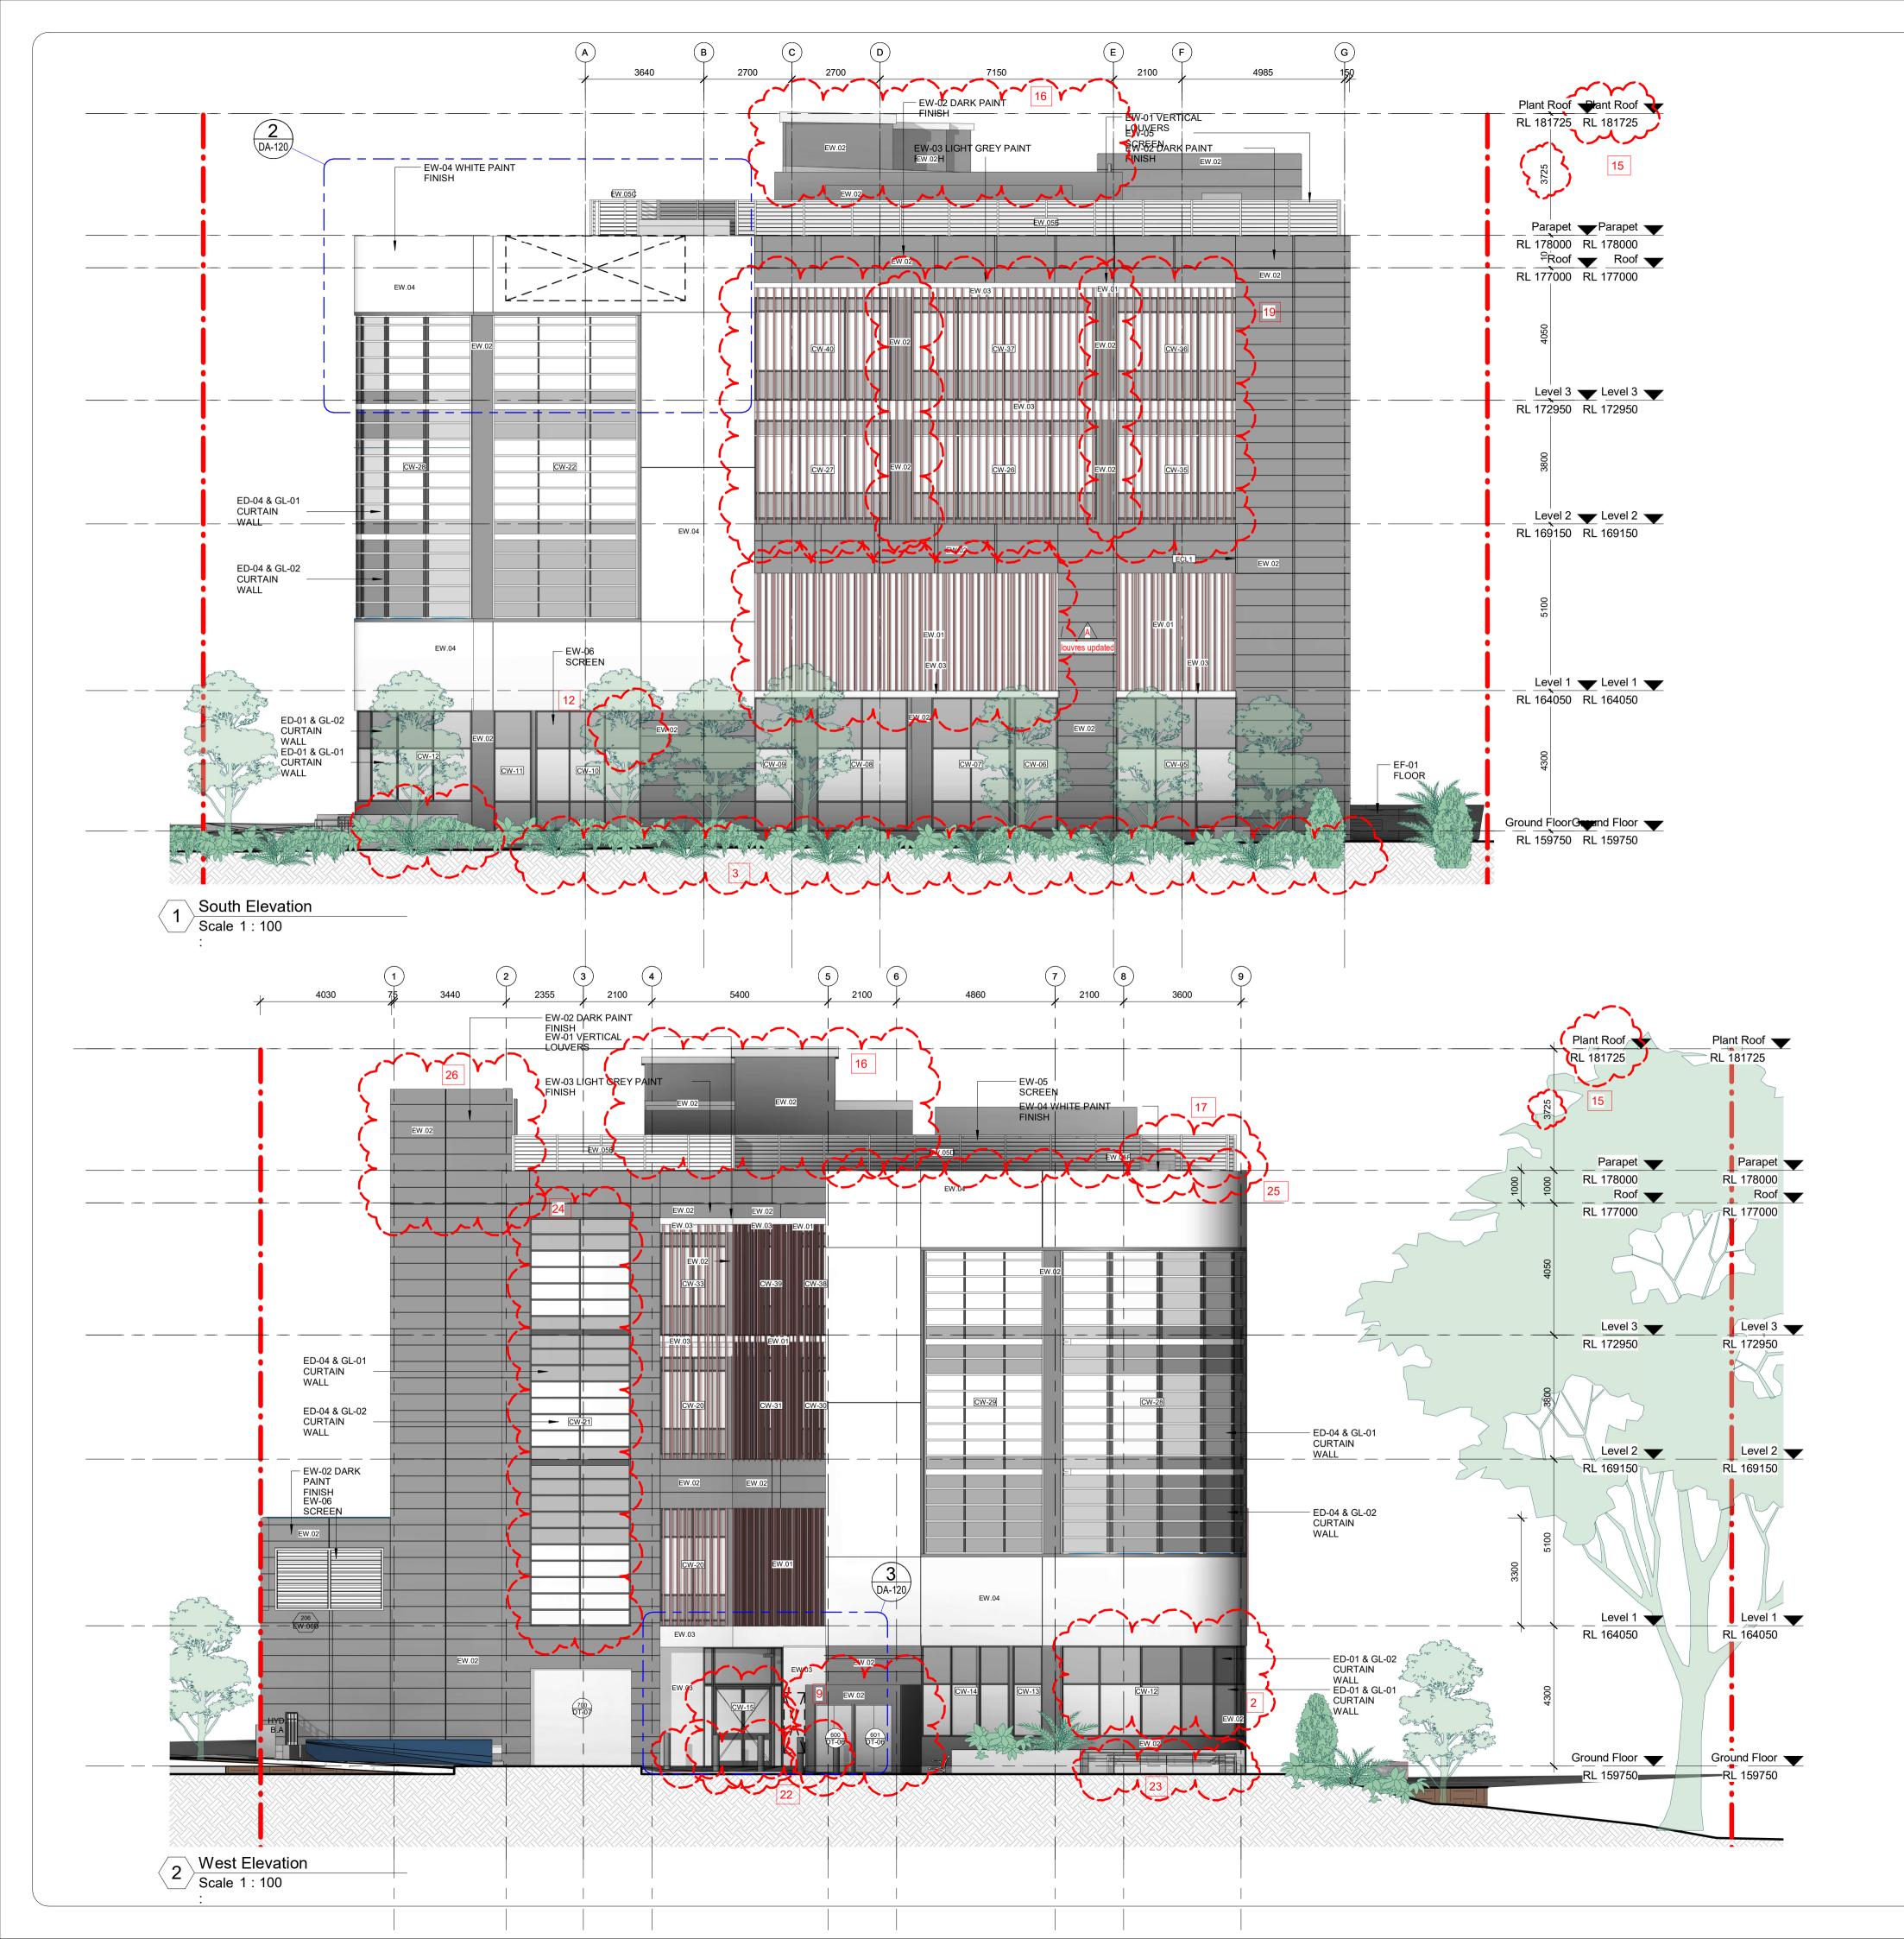


	DF	DRAWING STATUS:	
SCHEDULE OF CHANGES	Rev A	Revision Description Section 4.55 Update	Date 23.06.2022
00. Change in layout and heights of	В	For Section 4.55 application	30.06.2022
plant and mechanical overruns. External louvre screening updated to suit.			
 Hydrant booster reocated Stair and glazing shifted inwards 			
3. Landscaping updated			
4. Row of panels added5. Louvre size updated			
6. Window shifted to accomodate	©Copyright 1	Team 2 Architects	
columns 7. Levels updated	This drawing Copyright Ac reproduced,	g is protected by copyright. All right are reserved. Unles ct 1968. No part of this drawing may in any form or by a published, broadcast or transmitted without the prior w	ny means be vritten permission of
8.Service penetrations added 9. Sprinkler control valve, booster	Construction Team 2 Arch injury wheth	It owner. Please Note: If the status of this drawing is not in it may be subject to change, alteration or amendment litets. If so, Team 2 Architects is not liable for any los er special, consequential, direct or indirect, suffered by	at the discretion of s, damage, harm or / you or any other
assembly and hydrant booster assembly	person as a	result of your use of this drawing for construction purp DRAWING	US 85.
moved. 10. Height lowered by 360mm	specification proceeding v		ects before
11. Changed from curved glazing to polygonal	2. All dimensible obtained I 3. All dimension	sions and levels are in millimeters unless noted otherwise by scaling the drawing. sions to be checked on site with any discrepancies refer efore proceeding with work.	
12. Louvre removed	4. All work to	o be carried out in accordance with the requirements of t rrent NCC & Australian standards.	he principal certifying
13. Balustrade deleted14. Width reduced		EASEMENTS INDICATIVE, TBC AS CUP	RRENTLY
15. Increased by 25mm 16. Change to layout and height of			
overuns. 17. Louvres extended			
18. Window size reduced			
19. Glazing and Louvre layout and sizes updated			
20 Louvres deleted, glazing reduced 21. Reduced from 150 before			
22. Bollards removed			
23. Planter bed height, balustrade length increased			
24. Window height reduced by 200mm 25. Height reduced			
26. Height increased by 200			
27. Finishes updated			
		sisCare	
		3 Bourke Rd ria, NSW 2015	
	Client		
		t Central Business Park	
		ction 9 PtyLtd ACN: 613 108 795 randview St, Pymble, NSW 2073	
		0 1 2 3 4	5
		SCALE	
		FΛN	6
		RCHITEO	
	Lvl 1/45 C St Leonard	ds NSW 2065 South 9437 3166	Claremont Street, Yarra VIC 3141
		eam2.com.au ABN:	72 104 833 507 Reg Vic: 19340
	Proje	ct Maui, Frenches Fores	
	Parkw	ngah Road & Wakehurs vay	51
		ATIONS - SHEET 2	
	Project #: 856	6 ^{Scale} As @A S	G VM
	850 <u>Drawing #:</u>	ה או אין	
			D

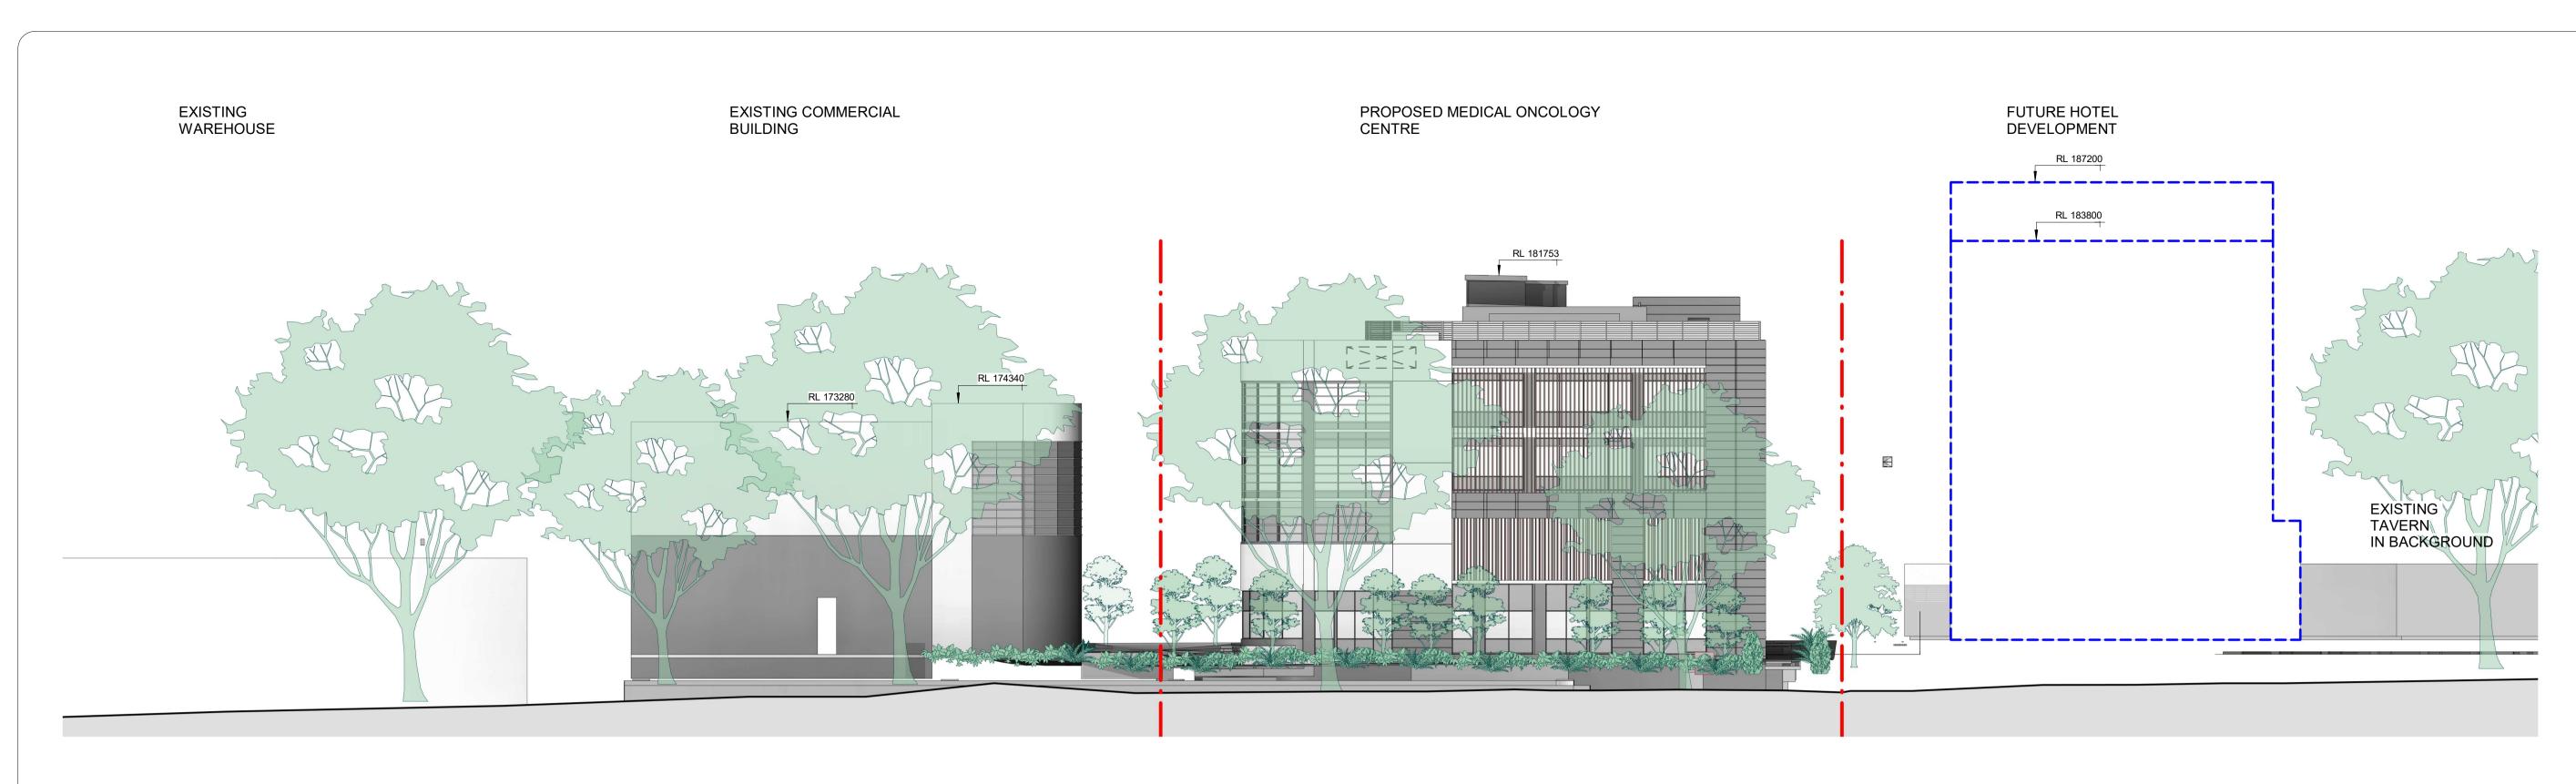



South Elevation - Warringah Road Streetscape Scale 1 : 200 1



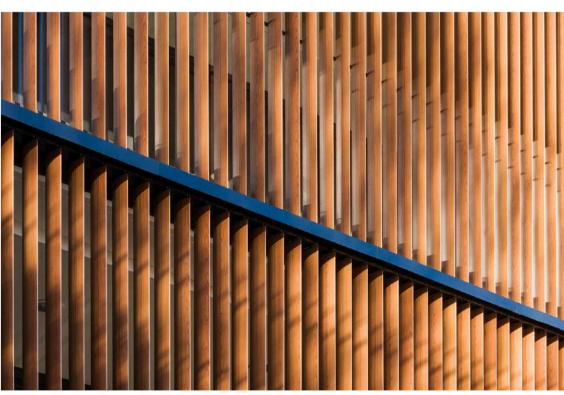


EW-01 VERTICAL LOUVERED GLADDING - TIMBER LOOK

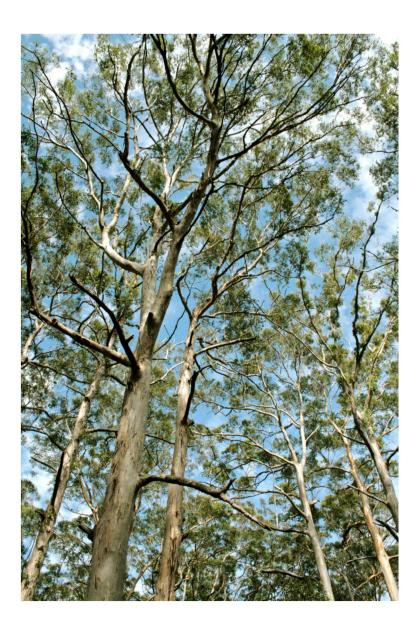


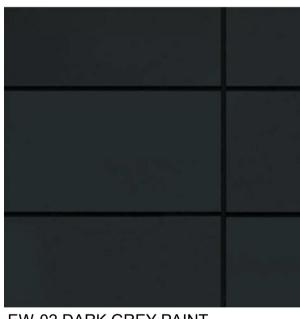

EW-02 DARK GREY PAINT FINISH

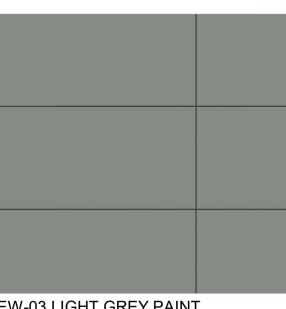

EW-03 LIGHT GREY PAINT FINISH

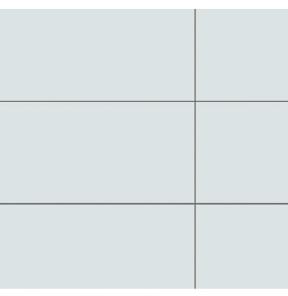

EW-04 WHITE PAINT FINISH







ED-01 CURTAIN WALL WITH A MIXTURE OF DARK TINTED GLASS PANELS (GL-01) AND OPAQUE PANELS (GL-02)



ED-02 CURTAIN WALL MATCH NEIGHBOURING BUILDING WITH A MIXTURE OF DARK TINTED GLASS PANELS (GL-01) AND OPAQUE PANELS (GL-02)

DRAWING STATUS:					
DEVELOPMENT APPLICATION					
Rev	Revision Description	Date			
Α	Section 4.55 Update	23.06.2022			
В	For Section 4.55 application	30.06.2022			
©Copyright 1	Feam 2 Architects				


©Copyright Team 2 Architects This drawing is protected by copyright. All right are reserved. Unless permitted under the Copyright Act 1968. No part of this drawing may in any form or by any means be reproduced, published, broadcast or transmitted without the prior written permission of the copyright owner. Please Note: If the status of this drawing is not signed off For Construction it may be subject to change, alteration or amendment at the discretion of Team 2 Architects. If so, Team 2 Architects is not liable for any loss, damage, harm or injury whether special, consequential, direct or indirect, suffered by you or any other person as a result of your use of this drawing for construction purposes.

DRAWING
 LEGEND:
 1. Architectural drawings shall be read in conjunction with other consultant drawings and
specifications. Any discrepancies shall be referred to Team 2 Architects before
proceeding with work.
 2. All dimensions and levels are in millimeters unless noted otherwise. No dimension shall
be obtained by scaling the drawing.
 3. All dimensions to be checked on site with any discrepancies referred to Team 2
 Architects before proceeding with work.
 4. All work to be carried out in accordance with the requirements of the principal certifying
 authority, current NCC & Australian standards.

NOTE: EASEMENTS INDICATIVE, TBC AS CURRENTLY UNDER REVIEW

	. Change in layout and heights of
	nt and mechanical overruns. External vre screening updated to suit.
	Hydrant booster reocated
	Stair and glazing shifted inwards
	Landscaping updated
	Row of panels added
	Louvre size updated
	Window shifted to accomodate umns
	Levels updated
	Service penetrations added
	Sprinkler control valve, booster
as	sembly and hydrant booster assembly
	oved.
	. Height lowered by 360mm
	. Changed from curved glazing to
	lygonal . Louvre removed
	Balustrade deleted
	. Width reduced
15	. Increased by 25mm
	. Change to layout and height of
	eruns.
	. Louvres extended . Window size reduced
-	. Glazing and Louvre layout and sizes
	dated
	Louvres deleted, glazing reduced
	. Reduced from 150 before
	. Bollards removed
	. Planter bed height, balustrade length
	reased Window beight reduced by 200mm
	. Window height reduced by 200mm . Height reduced
	. Height increased by 200
	. Finishes updated
	•


SCHEDULE OF CHANGES

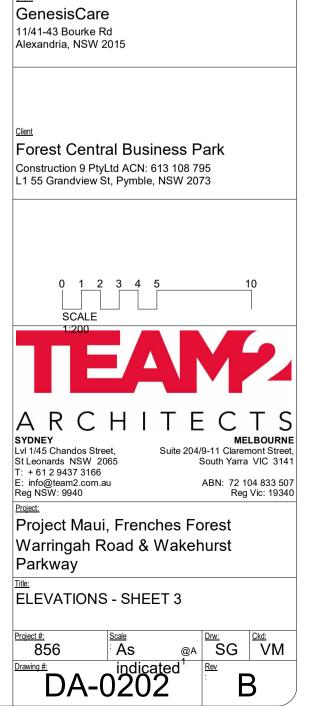

2-630	5 GENESIS MAUI PLANT SCH				
9-03.	J OLINESIS MAUI FLANT SCH				
CODE	BOTANIC NAME	COMMON NAME	MATURE SIZE	PROPOSED POT SIZE	QUANTITY
			(h x w) (m)		
	TREES & PALMS				
Ер	Eucalyptus piperita	Sydney Peppermint	15 x 5	100L	1
TI	Tristaniopsis laurina	Water Gum	15 x 6	100L	2
	SHRUBS & ACCENTS				
Ac	Alpinia caerulea	Native Ginger	2 x 2	200mm	7
	STREET MATRIX 01				
Ag	Anigozanthos Spp.	Kangaroo Paws	1.5 x 1.5	150mm	75
Cm	Carpobrotus menziesii	Native Pigface	0.15 x spreading	150mm	75
LT	Lomandra 'Tanika'	Mat Rush	0.6 x 0.6	150mm	75
	NATIVE SHADE MATRIX 02				
LI	Lomandra longifolia	Spiny Headed Mat Rush	0.7 x 0.5	200mm	6
Vh	Viola hederacea	Native violet	0.25 x spreading	150mm	6
Dr	Dichondra repens	Kidney Weed	0.2 x spreading	150mm	6
	NATIVE GRASS MATRIX 03				
LI	Lomandra longifolia	Spiny Headed Mat Rush	1 x 1	150mm	131
PE	Poa labillardieri 'Eskdale'	Tussock Grass	0.5 x 0.5	150mm	131
Та	Themeda australis	Kangaroo Grass	1 x 1	150mm	131
Dc	Dianella caerulea	Blue flax- lily	0.5 -1 x 0.5	150mm	131

Copyright remains the property of Arcadia Design Group Pty Ltd. Use only figured dimensions. Any other required dimensions are to be referred to and supplied by the landscape architect. All discrepancies to be referred to the project manager and Arcadia Design Group Pty Ltd prior to construction. Ensure compliance with the Building Code of Australia and all relevant Australian Standards and Authority requirements.

_____ Legend

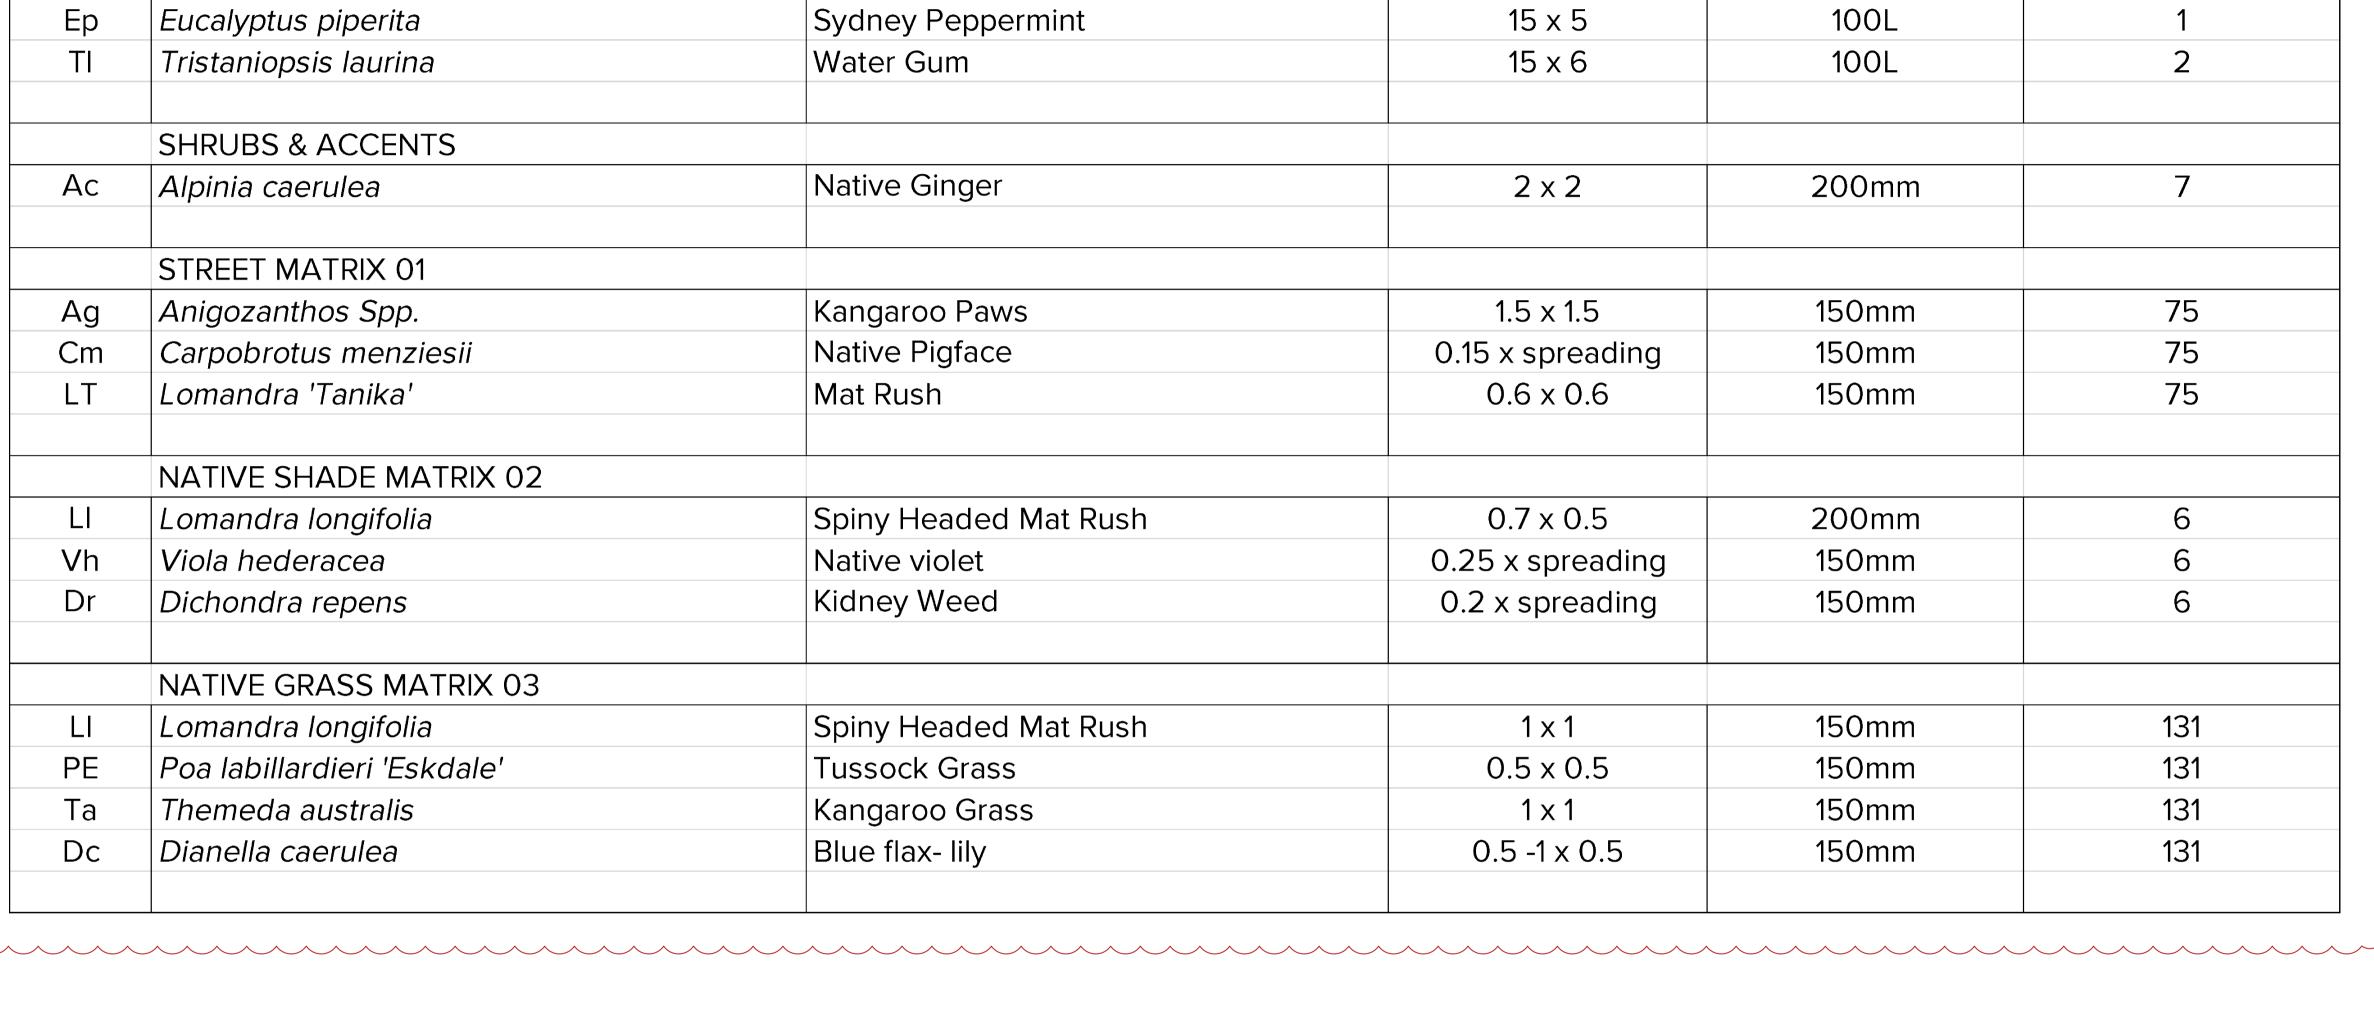

SCHEDULE OF CHANGES: 18. Plant Schedule updated.

A S. 4.55 Modification FL VO 05.04.22 Issue Revision Description Drawn Check Date

Not for Construction

Project

Maui - Healthcare Warringah Road & Wakehurst Parkway, Frenchs Forest, NSW Section 4.55 Modification

Client	Genesis Care 11/ 41-43 Bourke Rd, Alexandria, NSW, 2015 (02) 8236 3300
Architect	Team 2 701/1 Chandos Street, St Leonards, NSW, 2065 (02) 9437 3166
Drawing No.	Drawing Name Plant Schedule

Job No. lssue


Scale

.

19-635

А NA @ A 1



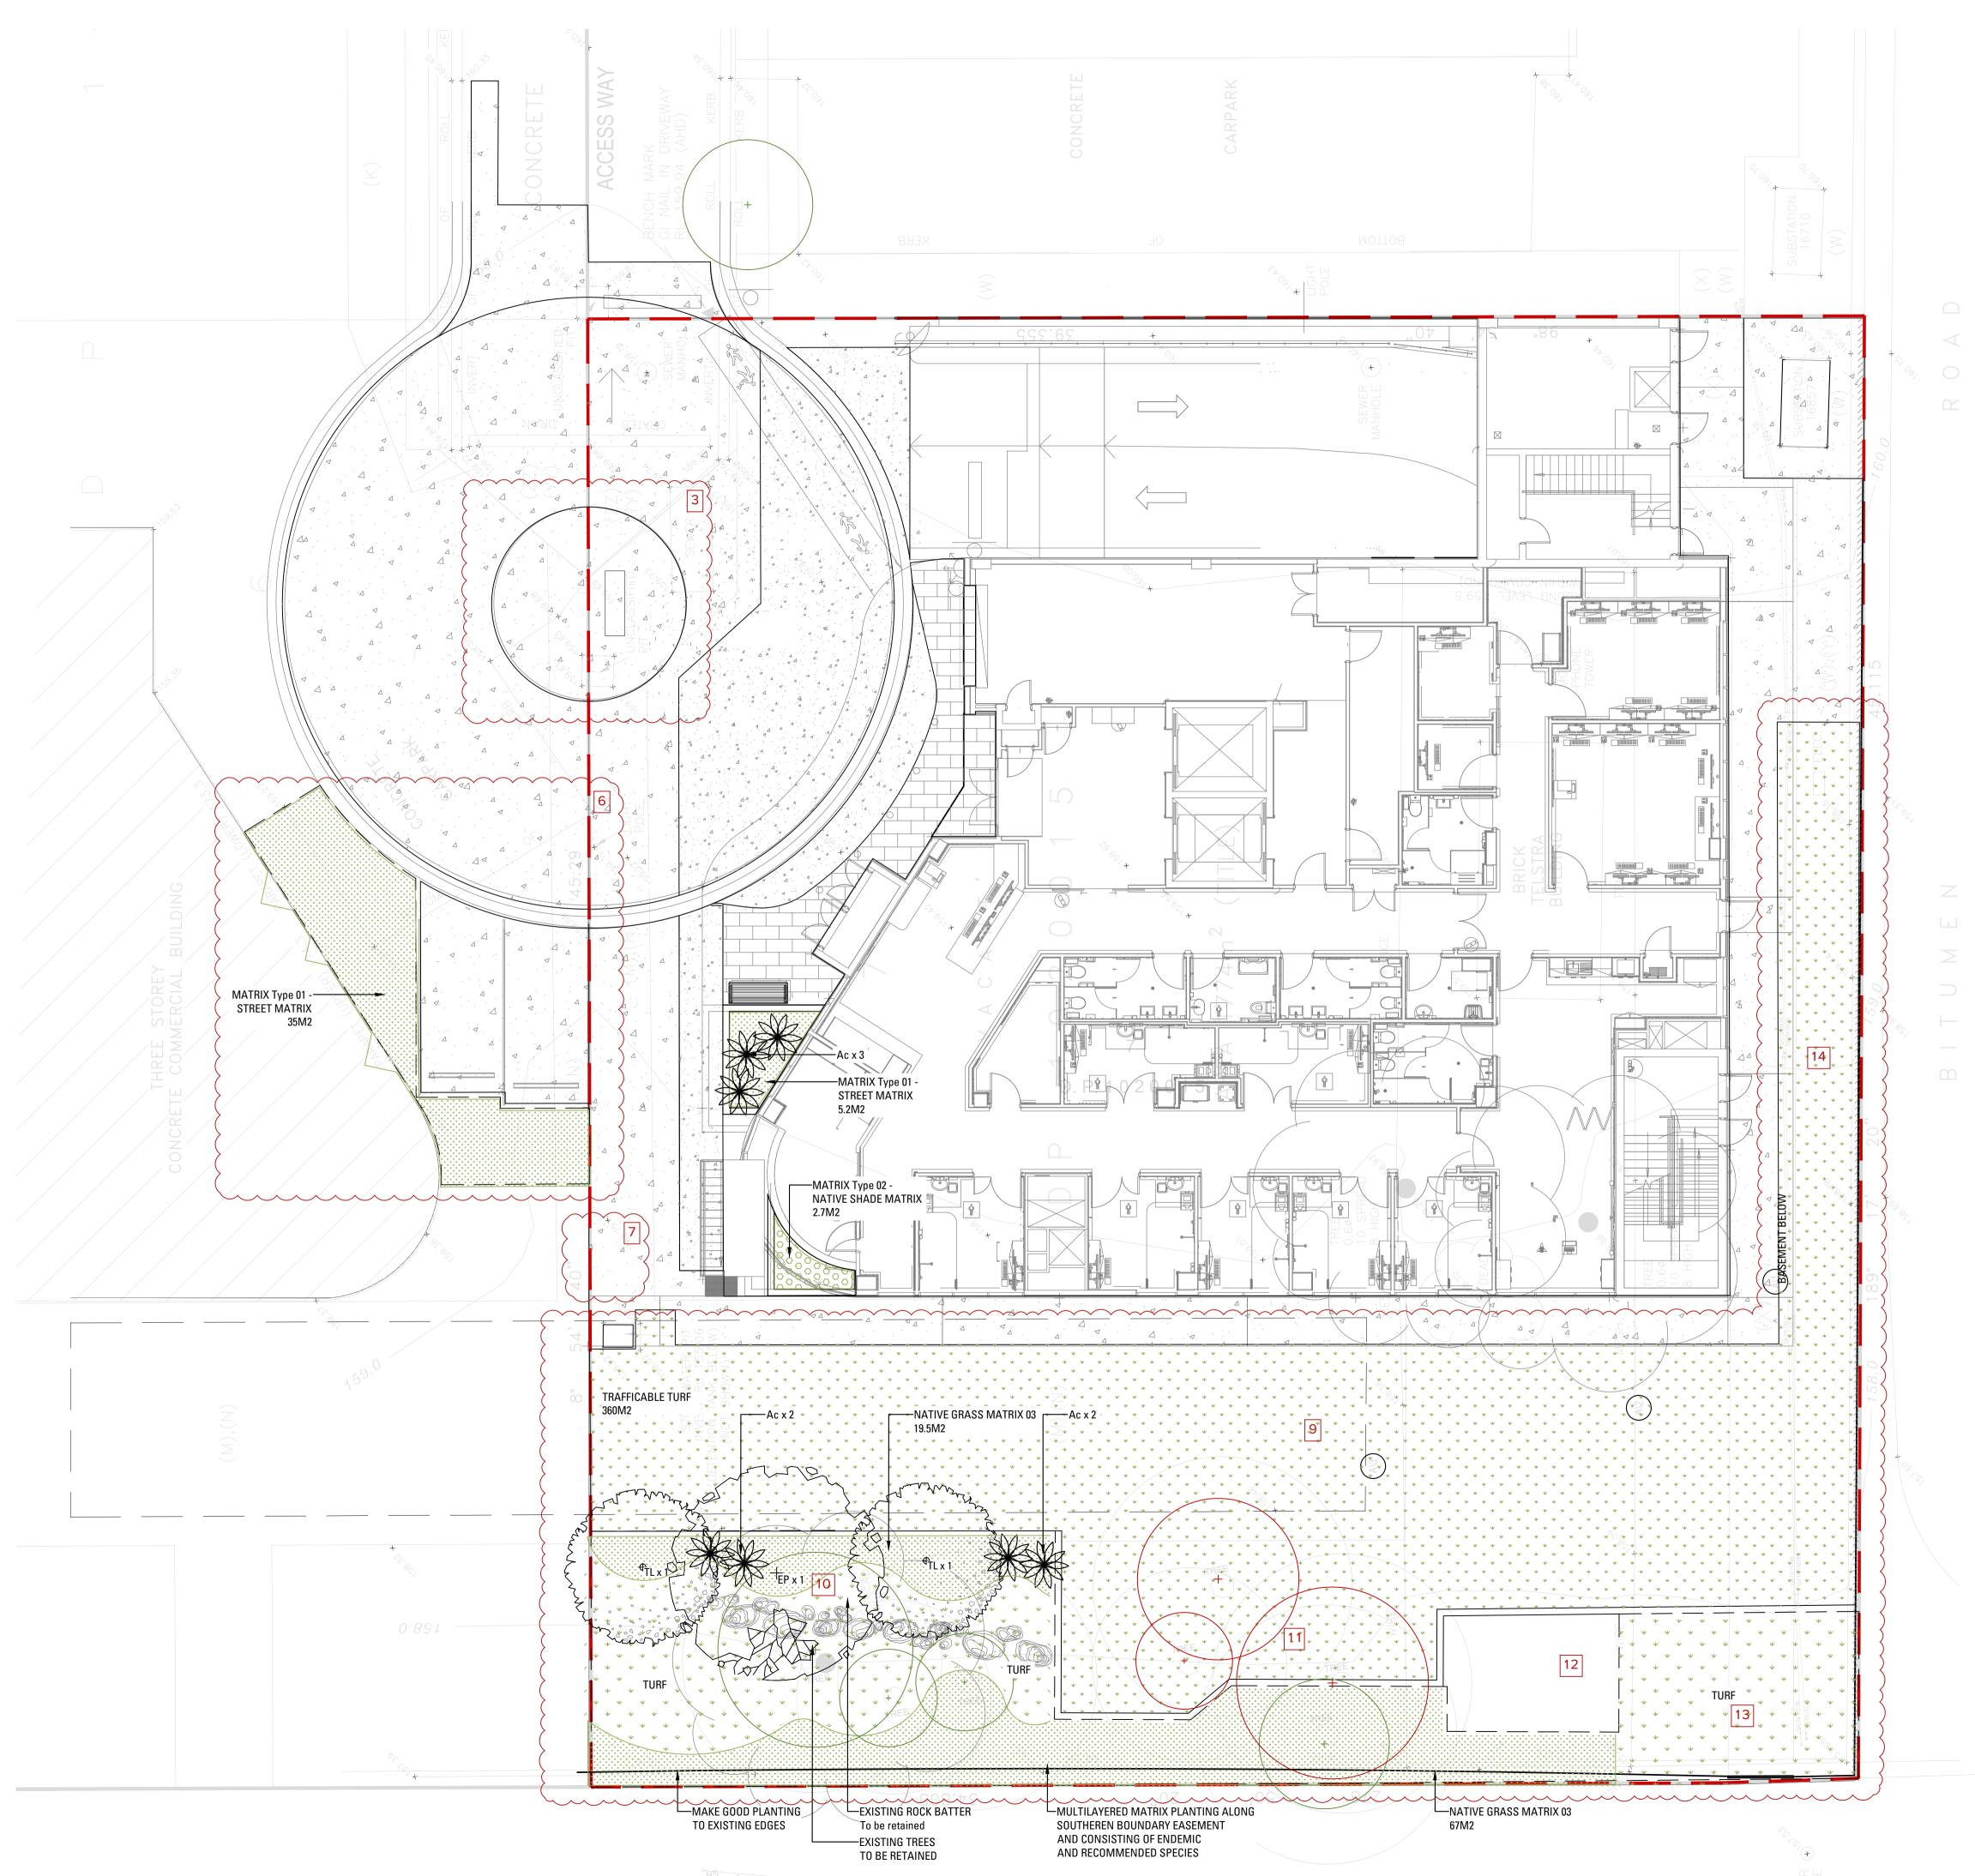

Copyright remains the property of Arcadia Design Group Pty Ltd. Use only figured dimensions. Any other required dimensions are to be referred to and supplied by the landscape architect. All discrepancies to be referred to the project manager and Arcadia Design Group Pty Ltd prior to construction. Ensure compliance with the Building Code of Australia and all relevant Australian Standards and Authority requirements.

Legend SOFTWORKS



• EXISTING TREES TO BE RETAINED Refer Landscape Specification Refer Landscape Specification

> EXISTING TREES TO BE REMOVED / Refer Landscape Specification

FEATURE TREE PLANTING Refer Landscape Specification

SHRUB AND ACCENT PLANTING Refer Landscape Specification

GROUNDCOVER PLANTING Refer Landscape Specification MATRIX PLANTING

Refer Landscape Specification

TURF Refer Landscape Specification

REINFORCED/ TRAFFICABLE TURF Refer Civil Engineer's Documentation

SCHEDULE OF CHANGES: 3: Planting removed to provide required access. 6: Landscape treatment to edges added. 7: Path width revised to provide required access. Planting removed. 9: Planting removed and replaced with trafficable turf. 10. Tree and understory planting revised due to access constraints. 11. Existing trees to be removed due to access constraints. 12: Planting removed and substation added.
13: Emergency access added.
14: Planting removed and replaced with trafficable turf along Eastern boundary.

А	S. 4.55 Modification	FL	VO	05.04.22
Issue	Revision Description	Drawn	Check	Date

Not for Construction

Project Maui - Healthcare

Warringah Road & Wakehurst Parkway, Frenchs Forest, NSW Section 4.55 Modification


Client	Genesis Care 11/ 41-43 Bourke Rd, Alexandria, NSW, 2015 (02) 8236 3300
Architect	Team 2 701/1 Chandos Street, St Leonards, NSW, 2065 (02) 9437 3166
Drawing No.	Drawing Name


L-401


Planting Plan

ob No.			1	9-635	
sue				А	\bigcirc
cale			1:100	D@A1	
1	2	3	4	5m	



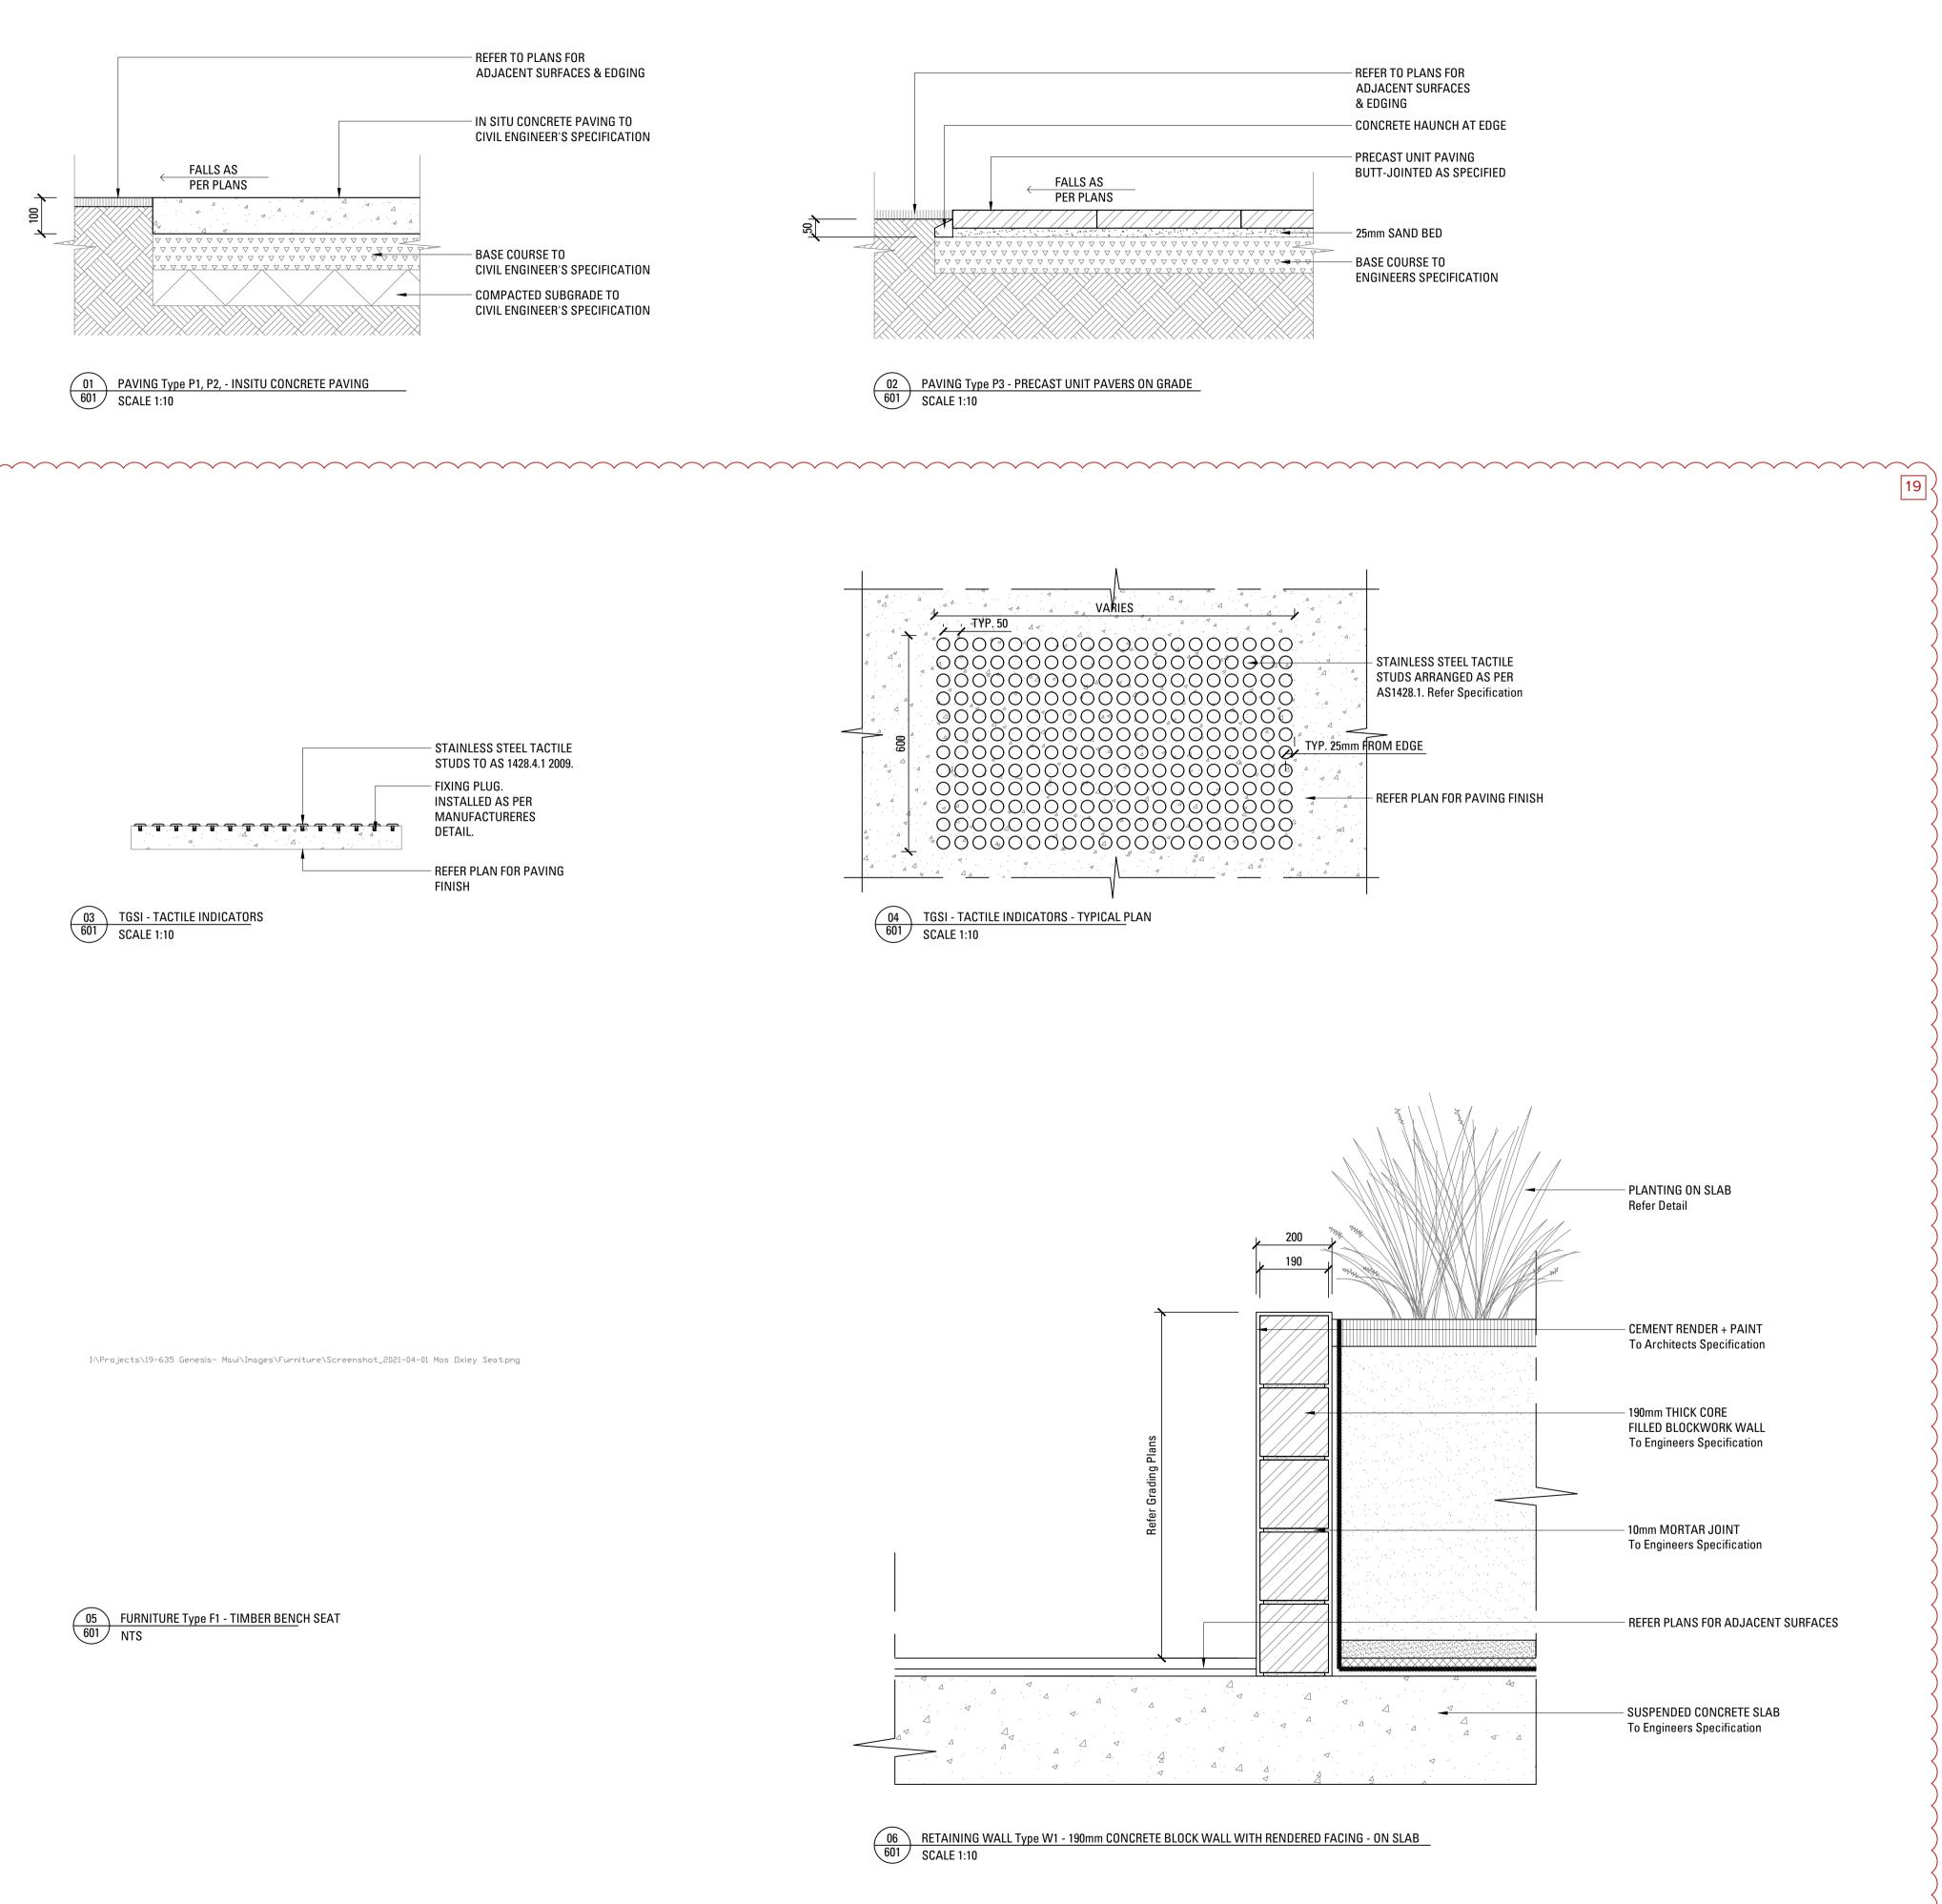

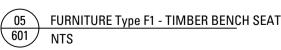

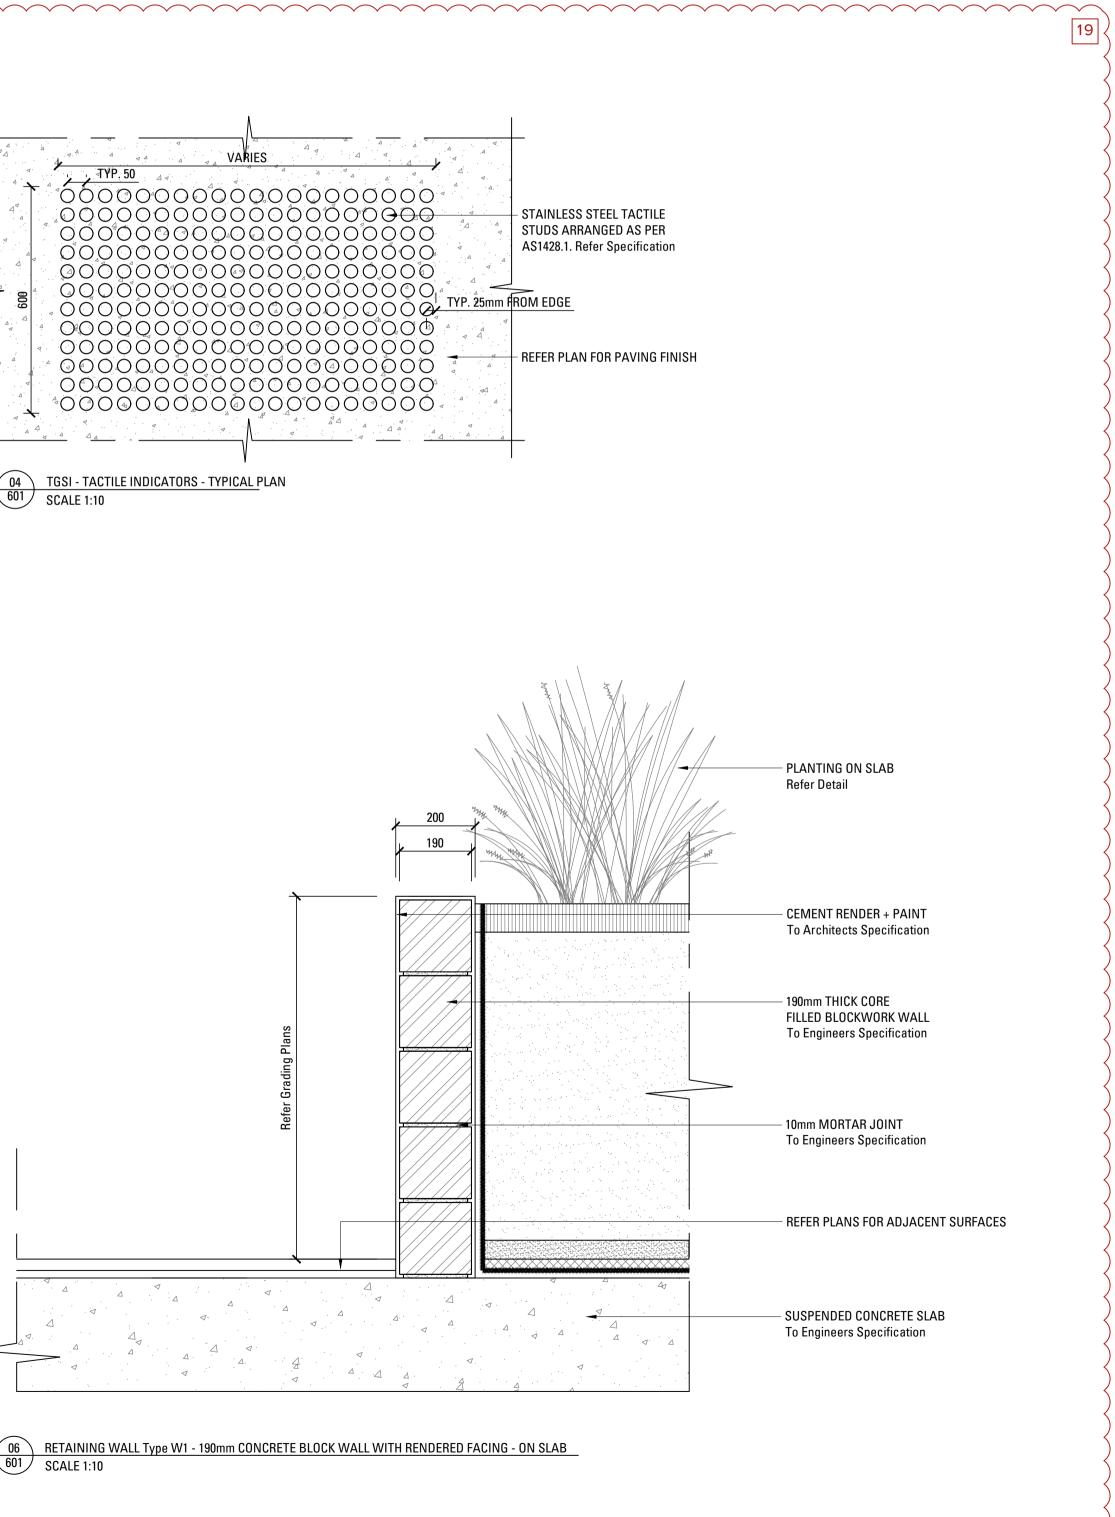

Copyright remains the property of Arcadia Design Group Pty Ltd. Use only figured dimensions. Any other required dimensions are to be referred to and supplied by the landscape architect. All discrepancies to be referred to the project manager and Arcadia Design Group Pty Ltd prior to construction. Ensure compliance with the Building Code of Australia and all relevant Australian Standards and Authority requirements.

SCHEDULE OF CHANGES: 19: Details added.


A S. 4.55 Modification FL VO 05.04.22 Issue Revision Description Drawn Check Date


Not for Construction

Project Maui - Healthcare Warringah Road & Wakehurst Parkway, Frenchs Forest, NSW Section 4.55 Modification Genesis Care 11/ 41-43 Bourke Rd, Alexandria, NSW, 2015 Client (02) 8236 3300 Architect Team 2 701/1 Chandos Street, St Leonards, NSW, 2065 (02) 9437 3166 Drawing No. Drawing Name L-601 Landscape Softworks Details


19-635 Job No. Δ Issue As shown @ A1 Scale 4 5 2 3



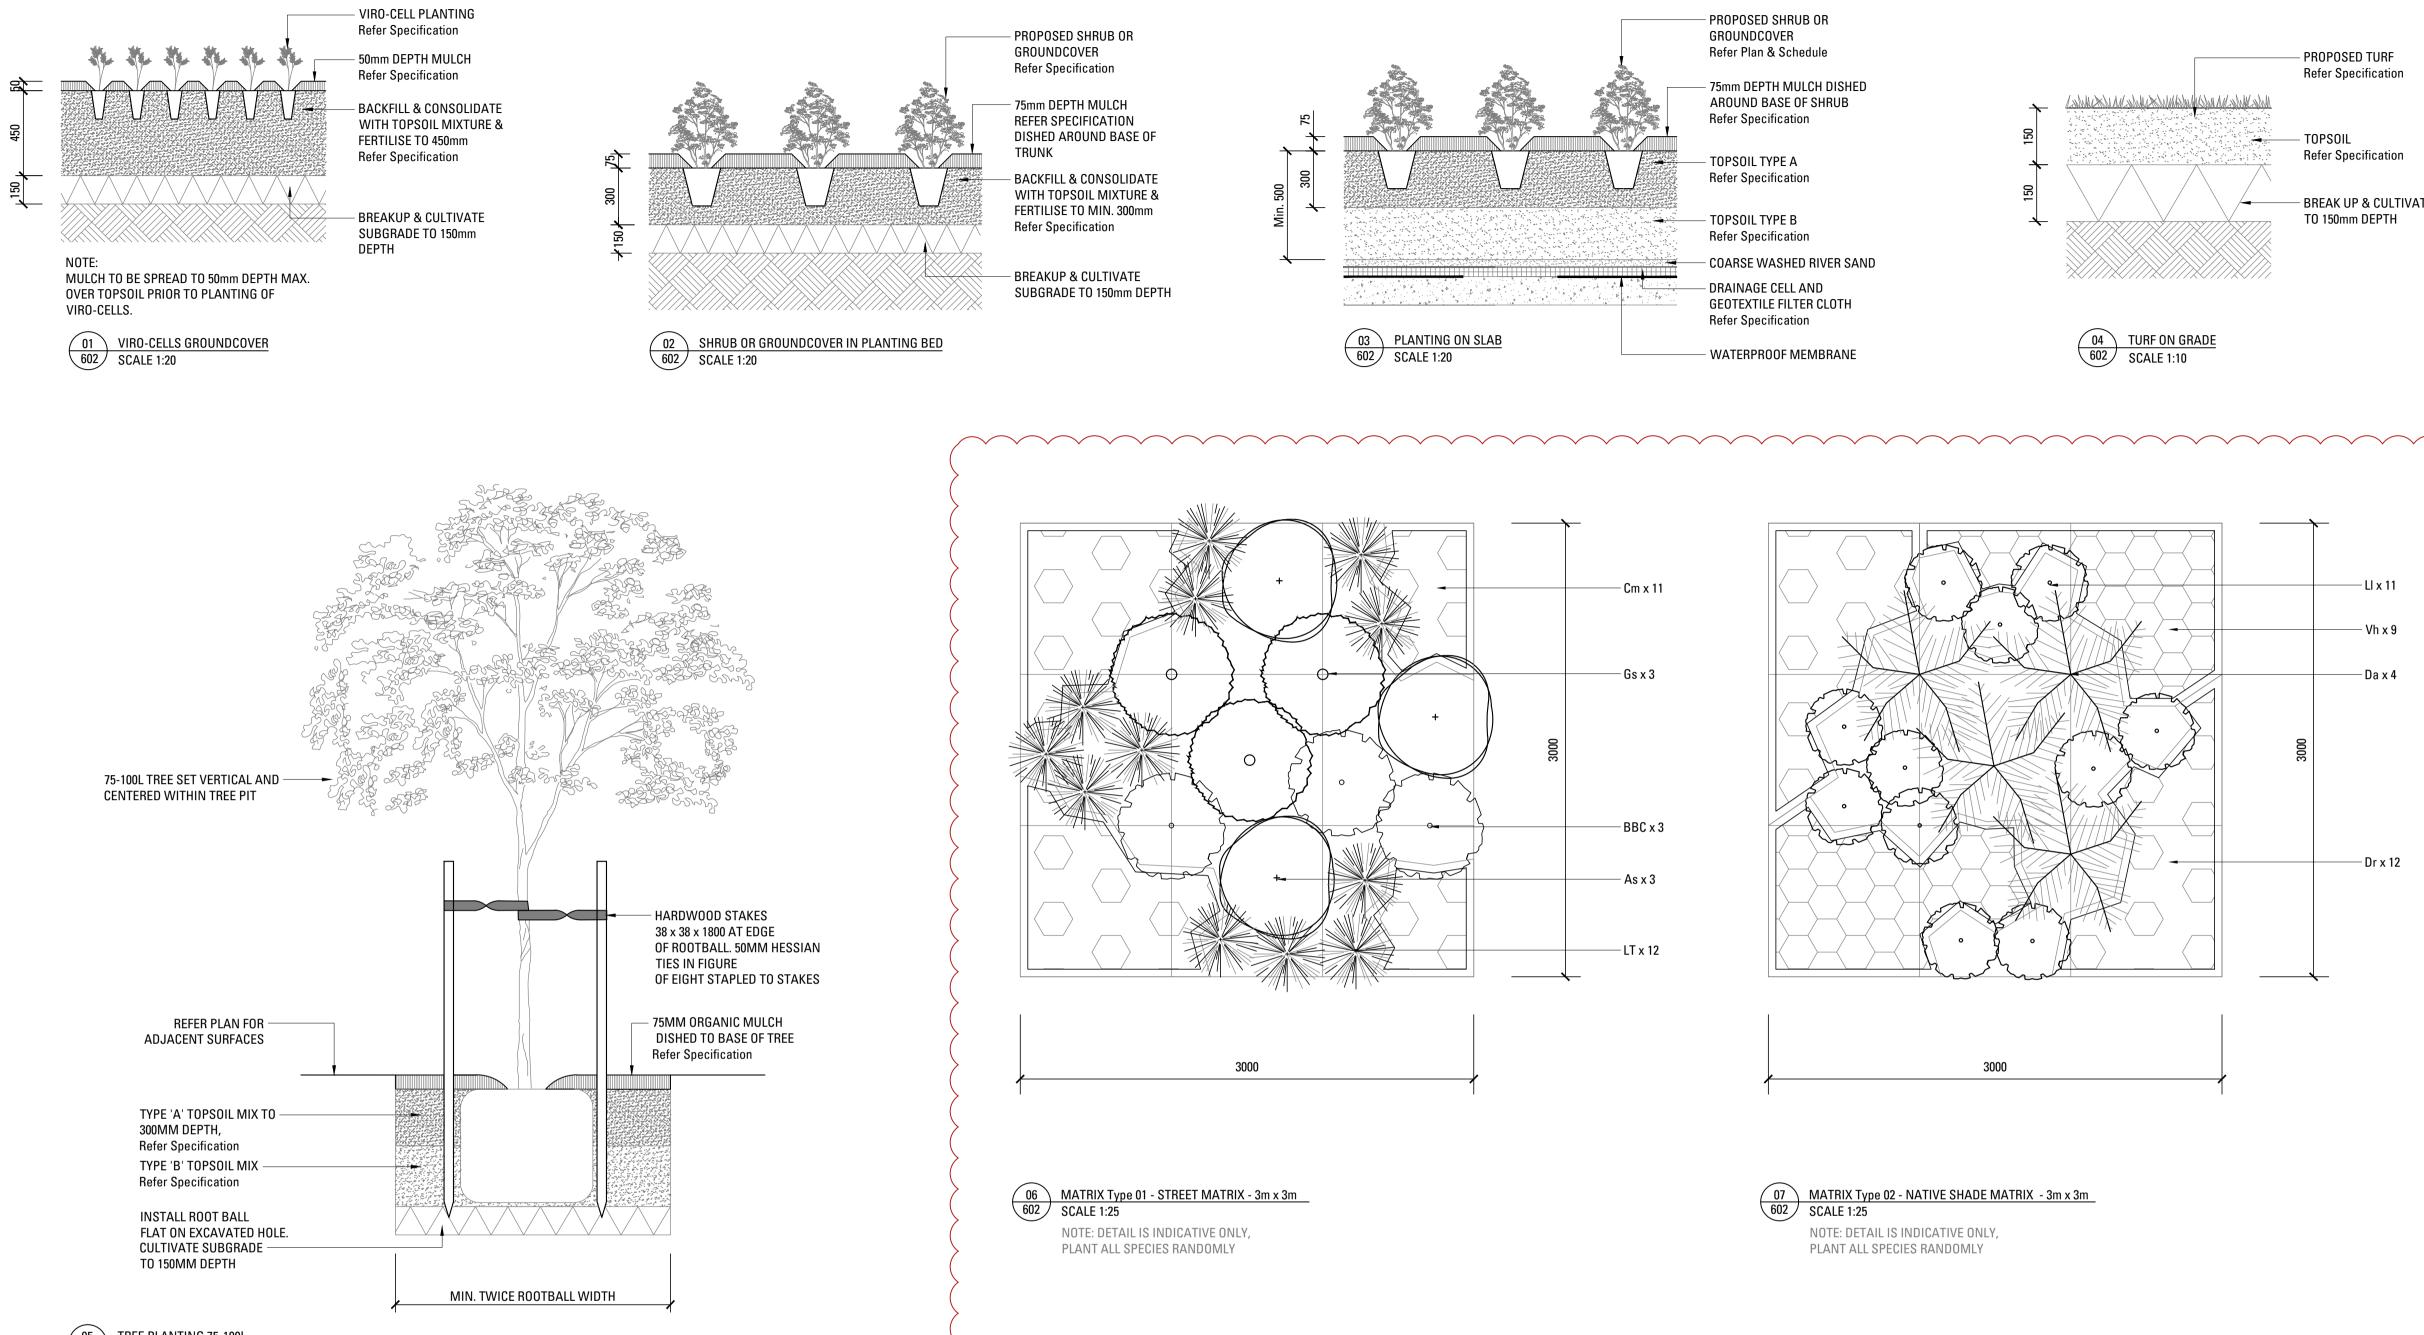

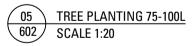



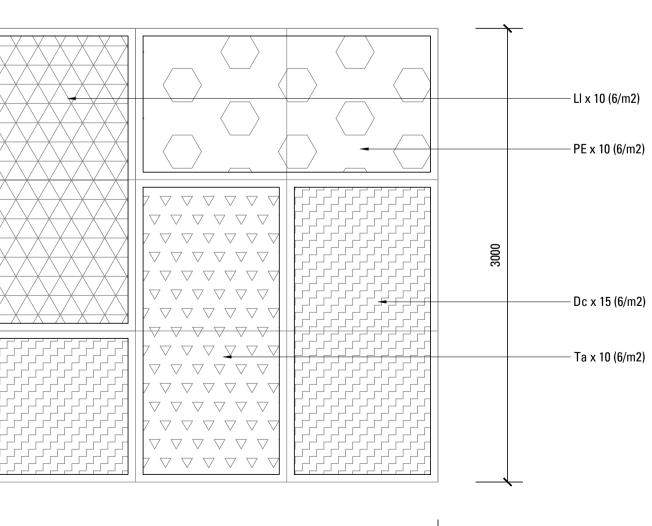

3000


08 MATRIX Type 03 - NATIVE GRASS MATRIX - 3m x 5m - 15m2 602 SCALE 1:25

Copyright remains the property of Arcadia Design Group Pty Ltd. Use only figured dimensions. Any other required dimensions are to be referred to and supplied by the landscape architect. All discrepancies to be referred to the project manager and Arcadia Design Group Pty Ltd prior to construction. Ensure compliance with the Building Code of Australia and all relevant Australian Standards and Authority requirements.

PROPOSED TURF **Refer Specification**

– TOPSOIL **Refer Specification**

BREAK UP & CULTIVATE SUBGRADE TO 150mm DEPTH

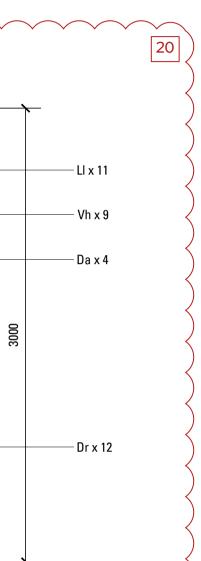

SCHEDULE OF CHANGES: 20: Detail scale changed.

А	S. 4.55 Modification	FL	VO	05.04.22
lssue	Revision Description	Drawn	Check	Date

Not for Construction

Project Maui - Healthcare

Warringah Road & Wakehurst Parkway, Frenchs Forest, NSW Section 4.55 Modification

Client	Genesis Care 11/ 41-43 Bourke Rd, Alexandria, NSW, 2015 (02) 8236 3300
Architect	Team 2 701/1 Chandos Street, St Leonards, NSW, 206 (02) 9437 3166
Drawing No.	Drawing Name
L-602	Landscape Softworks Details
Job No.	19-635

А

Issue Scale

Sydney, Suite 76, Jones Bay Wharf, 26-32 Pirrama Road,

Pyrmont NSW 2009 Ésydney@arcadiala.com.au T 02 8571 2900



LANDSCAPE SPECIFICATION NOTES

SERVICES

BEFORE LANDSCAPE WORK IS COMMENCED THE LANDSCAPE CONTRACTOR IS TO ESTABLISH THE POSITION OF ALL SERVICE LINES AND ENSURE TREE PLANTING IS CARRIED OUT AT LEAST 3 METRES AWAY FROM THESE SERVICES. SERVICE LIDS, VENTS AND HYDRANTS SHALL BE LEFT EXPOSED AND NOT COVERED BY ANY LANDSCAPE FINISHES (TURFING, PAVING, GARDEN BEDS) ETC.) FINISH ADJOINING SURFACES FLUSH WITH PIT LIDS.

ABORIST MANAGEMENT OF TREE PROTECTION

A QUALIFIED AND APPROVED ABORIST IS TO BE CONTRACTED TO UNDERTAKE OR MANAGE THE INSTALLATION OF PROTECTIVE FENCING, AND TO UNDERTAKE SUCH MEASURES AS HE DEEMS APPROPRIATE TO PRESERVE THE SUBJECT TREES TO BE RETAINED. THE ARBORIST IS TO BE RETAINED FOR THE ENTIRE CONTRACT PERIOD TO UNDERTAKE ONGOING MANAGEMENT AND **REVIEW OF THE TREES.**

DRAINAGE CELL AND FILTER FABRIC

FOR ON-SLAB AREAS INSTALL AN APPROVED 'DRAINAGE CELL' PRODUCT TO COMPREHENSIVELY COVER THE BOTTOM OF ALL PLANTERS. OVER DRAINAGE CELL TO ON-SLAB AREAS, A POLYFELT GEOTEXTILE LINING (AS SUPPLIED BY 'POLYFELT TS' OR APPROVED EQUIVALENT) IS TO BE INSTALLED TO COVER THE BOTTOM OF ALL PLANTERS, TURNED UP 300MM AND TAPED TO THE PLANTER SIDES TO ENSURE SOIL MIX DOES NOT ESCAPE INTO DRAINAGE OUTLETS/HOLES. INSTALL MIN. 50MM COARSE RIVER SAND OVER ALL GEOTEXTILE LINING PRIOR TO INSTALLATION OF SOIL MIX.

PLANTING MIXTURE

SHALL BE HOMOGENOUS BLEND OF SOIL AND ADDITIVES IN THE FOLLOWING PROPORTIONS: EXISTING SITE SOIL IF SUITABLE OR IMPORTED TOPSOIL 50% COMPOST 30%

D/W SAND 20%

SOIL TESTING OF EXISTING SITE SOIL IS TO BE UNDERTAKEN TO ASSESS SUITABILITY OF USE AS PLANTING TOPSOIL AND COMPLIANCE WITH AUSTRALIAN STANDARDS.

MULCH APPLICATION

PLACE MULCH TO THE REQUIRED DEPTH, (REFER TO DRAWINGS) CLEAR OF PLANT STEMS, AND RAKE TO AN EVEN SURFACE FINISHING 25MM BELOW ADJOINING LEVELS. ENSURE MULCH IS WATERED IN AND TAMPED DOWN DURING INSTALLATION.

MULCH TYPE

PINE BARK: FROM MATURE TREES, GRADED IN SIZE FROM 15MM TO 30MM, FREE FROM WOOD SLIVERS. DARK BROWN IN COLOUR AND TEXTURE.

COMPOST

SHALL BE WELL ROTTED VEGETATIVE MATERIAL OR ANIMAL MANURE, OR OTHER APPROVED MATERIAL, FREE FROM HARMFUL CHEMICALS, GRASS AND WEED GROWTH AND WITH NEUTRAL PH. PROVIDE A CERTIFICATE OF PROOF OF PH UPON REQUEST.

PLANT MATERIAL

ALL PLANTS SUPPLIED ARE TO CONFORM WITH THOSE SPECIES LISTED IN THE PLANT SCHEDULE ON THE DRAWINGS. GENERALLY PLANTS SHALL BE VIGOROUS, WELL ESTABLISHED, HARDENED OFF, OF GOOD FORM CONSISTENT WITH SPECIES OR VARIETY, NOT SOFT OR FORCED, FREE FROM DISEASE OR INSECT PESTS WITH LARGE HEALTHY ROOT SYSTEMS AND NO EVIDENCE OF HAVING BEEN RESTRICTED OR DAMAGED. TREES SHALL HAVE A LEADING SHOOT. IMMEDIATELY REJECT DRIED OUT DAMAGED OR UNHEALTHY PLANT MATERIAL BEFORE PLANTING. ALL STOCK IS TO BE CONTAINER GROWN FOR A MINIMUM OF SIX (6) MONTHS PRIOR TO DELIVERY TO SITE

FERTILISER MASS PLANTING AREAS:

FERTILISER SHALL BE 'NUTRICOTE' OR APPROVED EQUIVALENT IN GRANULE FORM INTENDED FOR SLOW RELEASE OF PLANT NUTRIENTS OVER A PERIOD OF APPROXIMATELY NINE MONTHS. THOROUGHLY MIX FERTILISER WITH PLANTING MIXTURE AT THE **RECOMMENDED RATE, PRIOR TO INSTALLING PLANTS.**

TURF

SHALL BE SIR WALTER BUFFALO. SHIRLEYS NO. 17 OR APPROVED EQUAL LAWN FOOD SHALL BE THOROUGHLY MIXED INTO THE TOPSOIL PRIOR TO PLACING TURF.

TREES IN GRASS AND SUPER ADVANCED TREES:

PELLETS SHALL BE IN THE FORM INTENDED TO UNIFORMLY RELEASE PLANT FOOD ELEMENTS FOR A PERIOD OF APPROXIMATELY NINE MONTHS EQUAL TO SHIRLEYS KOKEI PELLETS, ANALYSIS 6.3:1.8:2.9. KOKEI PELLETS SHALL BE PLACED AT THE TIME OF PLANTING TO THE BASE OF THE PLANT. 50MM MINIMUM FROM THE ROOT BALL AT A RATE OF TWO PELLETS PER 300MM OF TOP **GROWTH TO A MAXIMUM OF 8 PELLETS PER TREE.**

STAKING AND TYING

STAKES SHALL BE STRAIGHT HARDWOOD, FREE FROM KNOTS AND TWISTS, POINTED AT ONE END AND SIZED ACCORDING TO SIZE

OF PLANTS TO BE STAKED.

A. 5-15 LITRE SIZE PLANT 1X(1200X25X25MM)

B. 35-75 LITRE SIZE PLANT 2X(1500X38X38MM)

C. 100-GREATER THAN 200LITRE 3X(1800X50X50MM)

TIES SHALL BE 50MM WIDE HESSIAN WEBBING OR APPROVED EQUIVALENT NAILED OR STAPLED TO STAKE. DRIVE STAKES A MINIMUM ONE THIRD OF THEIR LENGTH, AVOIDING DAMAGE TO THE ROOT SYSTEM, ON THE WINDWARD SIDE OF THE PLANT.

IRRIGATION SYSTEM

SUPPLY AN AUTOMATIC WATERING SYSTEM USING 'TORO IRRIGATION SYSTEM' OR SIMILAR APPROVED, WITH MICRO-JET SPRINKLER HEADS AND LOW DENSITY, RUBBER MODIFIED POLYPROPYLENE RETICULATION, TO INCLUDE FILTERS, BENDS JUNCTIONS, ENDS AND OTHER ANCILLARY EQUIPMENT. THE LANDSCAPER SHALL NOMINATE HIS SOURCE OF SUPPLY FOR THE WATERING SYSTEM AND OBTAIN APPROVAL FROM THE SUPERINTENDENT BEFORE PLACING ORDERS FOR EQUIPMENT OR SUPPLY.

A SCHEMATIC PLAN OF THE PROPOSED IRRIGATION SYSTEM IS TO BE PREPARED BY THE CONTRACTOR, SHOWING SOLENOIDS, PIPE DIAMETERS, AND ALL NOZZLE AND TRICKLE ATTACHMENT TYPES (INCLUDING SPRAY/HEAD ANGLE), FOR REVIEW BY THE SUPERINTENDENT PRIOR TO INSTALLATION

THE CONTRACTOR IS TO LIASE WITH THE HYDRAULIC ENGINEER AND COUNCIL AS NECESSARY, TO ENSURE THE THE IRRIGATION SYSTEM CONFORMS WITH ALL THE COUNCIL AND WATER BOARD CODES AND REQUIREMENTS.

PROVIDE AN AUTOMATIC CONTROLLER THAT PROVIDES FOR TWO WEEK SCHEDULING AND HOURLY MULTI-CYCLE OPERATION. THE CONTROLLER SHALL MANUAL OVERRIDE. PROGRAMMING SHALL BE UNDERTAKEN BY THE CONTRACTOR WHO SHALL ADVISE ON THE OPERATION OF THE SYSTEM.

PROVISION OF SECURE HOUSING FOR THE AUTOMATIC IRRIGATION CONTROLLER TO BE LOCATED IN ASSOCIATION WITH THE LANDSCAPE CONTRACTOR AND LOCATION CONFIRMED BY THE SUPERINTENDENT. WIRING TO CONNECT REMOTE SOLENOID LOCATIONS IS TO BE PROVIDED. THE CONTROLLER SHALL BE LOCATED IN A DRY PLACE, PROTECTED FROM THE WEATHER, AND ALL CABLE CONNECTIONS SHALL BE MADE WITH WATERPROOF CONNECTORS.

SYSTEM.

TIMBER EDGE: 100 X 25MM CCA TREATED RADIATA PINE TIMBER STAKES: 50 X 50 X 500MM CCA TREATED RADIATA PINE-SHARPENED AT ONE END. INSTALL IN LOCATIONS SHOWN ON THE DRAWINGS FLUSH TO FINISHED SURFACE LEVELS.

TURF TURF ALL LANDSCAPE AREAS AS SHOWN ON THE LANDSCAPE DRAWINGS. TURF IS TO HAVE AN EVEN THICKNESS OF NOT LESS THAN 25MM. OBTAIN TURF FROM AN APPROVED GROWER. FURNISH A WARRANTY FROM THE GROWER THAT THE TURF IS FREE FROM WEEDS AND OTHER FOREIGN MATTER. DELIVER TURF TO THE SITE WITHIN 24 HOURS OF BEING CUT, AND LAY IT WITHIN 24 HOURS OF BEING DELIVERED.

TO PREPARE GRADED AREAS TO RECEIVE TURF, EXCAVATE THE AREA AND CULTIVATE SO AS TO ALLOW FOR IMPORTING OF 100MM OF TURF UNDERLAY SOIL. REMOVE ALL STONES OVER 50MM Ø AND REMOVE ALL WEEDS AND FOREIGN MATTER. SPREAD SOIL MIX A.B.S TO A DEPTH OF 100MM AND GRADE TO APPROPRIATE LEVELS TO ACHIEVE GENERAL EVEN GRADES TO DRAINAGE OUTLETS INSTALLED BY OTHERS.

LAY THE TURF ALONG THE LAND CONTOURS WITH STAGGERED, CLOSE BUTTED JOINTS, SO THAT THE FINISHED TURF SURFACE IS FLUSH WITH ADJACENT FINISHED SURFACES OF PAVING AND THE LIKE. AS SOON AS PRACTICABLE AFTER LAYING, ROLL THE TURE WITH A ROLLER WEIGHING NOT MORE THAN 90KG PER METRE OF WIDTH FOR SANDY OR LIGHT SOILS.

WATER AS NECESSARY TO KEEP THE SOIL MOIST TO A DEPTH OF 100MM. PROTECT NEWLY TURFED AREAS AGAINST TRAFFIC UNTIL GRASS IS ESTABLISHED. FERTILISE TWO WEEKS AFTER LAYING FERTILISE A.B.S

'TOP DRESS' THE TURF WHEN IT IS ESTABLISHED TO A DEPTH OF 10MM WITH COARSE WASHED RIVER SAND. RUB THE DRESSING WELL INTO THE JOINTS AND CORRECT ANY UNEVENNESS IN THE TURF SURFACES.

LANDSCAPE MAINTENANCE PROGRAM

MAINTENANCE SHALL MEAN THE CARE AND MAINTENANCE OF THE LANDSCAPE WORKS BY ACCEPTED HORTICULTURAL PRACTICE AS RECTIFYING ANY DEFECTS THAT BECOME APPARENT IN THE LANDSCAPE WORKS UNDER NORMAL USE. THIS SHALL INCLUDE, BUT SHALL NOT BE LIMITED TO, WATERING, MOWING, FERTILISING, RESEEDING, RETURFING, WEEDING, PEST AND DISEASE CONTROL, STAKING AND TYING, REPLANTING, CULTIVATION, PRUNING, AERATING, RENOVATING, TOP DRESSING, MAINTAINING THE SITE IN A NEAT AND TIDY CONDITION AS FOLLOWS:-

GENERAL

WATERING GRASS, TREES AND GARDEN AREAS SHALL BE WATERED REGULARLY SO AS TO ENSURE CONTINUOUS HEALTHY GROWTH.

RUBBISH REMOVAL DURING THE TERM OF THE MAINTENANCE PERIOD THE LANDSCAPE CONTRACTOR SHALL REMOVE RUBBISH THAT MAY OCCUR AND REOCCUR THROUGHOUT THE MAINTENANCE PERIOD. THIS WORK SHALL BE CARRIED OUT REGULARLY SO THAT AT WEEKLY INTERVALS THE AREA MAY BE OBSERVED IN A COMPLETELY CLEAN AND TIDY CONDITION.

REPLACEMENTS THE LANDSCAPE CONTRACTOR SHALL REPLACE ALL PLANTS THAT ARE MISSING, UNHEALTHY OR DEAD AT THE LANDSCAPE CONTRACTOR'S COST. REPLACEMENTS SHALL BE OF THE SAME SIZE, QUALITY AND SPECIES AS THE PLANT THAT HAS FAILED UNLESS OTHERWISE DIRECTED BY THE LANDSCAPE ARCHITECT. REPLACEMENTS SHALL BE MADE ON A CONTINUING BASIS NOT EXCEEDING TWO (2) WEEKS AFTER THE PLANT HAS DIED OR IS SEEN TO BE MISSING.

STAKES AND TIES THE LANDSCAPE CONTRACTOR SHALL REPLACE OR ADJUST PLANT STAKES, AND TREE GUARDS AS NECESSARY OR AS DIRECTED BY THE LANDSCAPE ARCHITECT. REMOVE STAKES AND TIES AT THE END OF THE MAINTENANCE PERIOD IF SO DIRECTED.

PRUNING

MULCHED SURFACES ALL MULCHED SURFACES SHALL BE MAINTAINED IN A CLEAN AND TIDY CONDITION AND BE REINSTATED IF NECESSARY TO ENSURE THAT A DEPTH OF 75MM IS MAINTAINED. ENSURE MULCH IS KEPT CLEAR OF PLANT STEMS AT ALL TIMES.

PEST AND DISEASED CONTROL THE LANDSCAPE CONTRACTOR SHALL SPRAY AGAINST INSECT AND FUNGUS INFESTATION WITH ALL SPRAYING TO BE CARRIED OUT IN ACCORDANCE WITH THE MANUFACTURER'S DIRECTIONS. REPORT ALL INSTANCES OF PESTS AND DISEASES (IMMEDIATELY THAT THEY ARE DETECTED) TO THE LANDSCAPE ARCHITECT.

GRASS AND TURF AREAS

THE LANDSCAPE CONTRACTOR SHALL MAINTAIN ALL GRASS AND TURF AREAS BY WATERING, WEEDING, DRESSING, ROLLING, MOWING, TRIMMING OR OTHER OPERATIONS AS NECESSARY. SEED AND TURF SPECIES SHALL BE THE SAME AS THE ORIGINAL SPECIFIED MIXTURE. GRASS AND TURF AREAS SHALL BE SPRAYED WITH APPROVED SELECTIVE HERBICIDE AGAINST BROAD LEAFED WEEDS AS REQUIRED BY THE LANDSCAPE ARCHITECT AND IN ACCORDANCE WITH THE MANUFACTURER'S DIRECTIONS. GRASS AND TURF AREAS SHALL BE FERTILISED ONCE A YEAR IN AUTUMN WITH "DYNAMIC LIFTER" FOR LAWNS AT A RATE OF 20KG PER 100M2. FERTILISER SHALL BE WATERED IN IMMEDIATELY AFTER APPLICATION. IRREGULARITIES IN THE GRASS AND TURF SHALL BE WATERED IN IMMEDIATELY AFTER APPLICATION. GRASS AND TURF AREAS SHALL BE KEPT MOWN TO MAINTAIN A HEALTHY AND VIGOROUS SWARD, MOWING HEIGHT: 30-50MM.

WEED ERADICATION ERADICATE WEEDS BY ENVIRONMENTALLY ACCEPTABLE METHODS USING A NON-RESIDUAL GLYPHOSATE HERBICIDE (EG. 'ROUNDUP') IN ANY OF ITS REGISTERED FORMULAE, AT THE RECOMMENDED MAXIMUM RATE. REGULARLY REMOVE BY HAND, WEED GROWTH THAT MAY OCCUR OR RECUR THROUGHOUT GRASSED, PLANTED AND MULCHED AREAS. REMOVE WEED GROWTH FROM AN AREA 750MM DIAMETER AROUND THE BASE OF TREES IN GRASSED AREAS. CONTINUE ERADICATION THROUGHOUT THE COURSE OF THE WORKS AND DURING THE MAINTENANCE PERIOD.

SOIL SUBSIDENCE ANY SOIL SUBSIDENCE OR EROSION WHICH MAY OCCUR AFTER THE SOIL FILLING AND PREPARATION OPERATIONS SHALL BE MADE GOOD BY THE LANDSCAPE CONTRACTOR AT NO COST TO THE CLIENT.

IT SHALL BE THE CONTRACTOR'S RESPONSIBILITY TO ENSURE AND GUARANTEE SATISFACTORY OPERATION OF THE IRRIGATION

AFTER THE SYSTEM HAS BEEN INSTALLED TO THE SATISFACTION OF THE SUPERINTENDENT, THE INSTALLATION SHALL BE TESTED UNDER KNOWN WORKING CONDITIONS. ACCEPTANCE OF THE INSTALLED PLANT AND EQUIPMENT SHALL BE SUBJECT TO THESE BEING SATISFACTORY.

TREATED PINE TIMBER EDGING

THE LANDSCAPE CONTRACTOR SHALL MAINTAIN THE LANDSCAPE WORKS FOR THE TERM OF THE MAINTENANCE (OR PLANT ESTABLISHMENT) PERIOD TO THE SATISFACTION OF THE COUNCIL. THE LANDSCAPE CONTRACTOR SHALL ATTEND TO THE SITE ON A WEEKLY BASIS. THE MAINTENANCE PERIOD SHALL COMMENCE AT PRACTICAL COMPLETION AND CONTINUE FOR A PERIOD OF TWENTY SIX (26) WEEKS.

TREES AND SHRUBS SHALL BE PRUNED AS DIRECTED BY THE LANDSCAPE ARCHITECT. PRUNING WILL BE DIRECTED AT THE MAINTENANCE OF THE DENSE FOLIAGE OR MISCELLANEOUS PRUNING AND BENEFICIAL TO THE CONDITION OF THE PLANTS. ANY DAMAGED GROWTH SHALL BE PRUNED. ALL PRUNED MATERIAL SHALL BE REMOVED FROM THE SITE.

Copyright remains the property of Arcadia Design Group Pty Ltd. Use only figured dimensions. Any other required dimensions are to be referred to and supplied by the landscape architect. All discrepancies to be referred to the project manager and Arcadia Design Group Pty Ltd prior to construction. Ensure compliance with the Building Code of Australia and all relevant Australian Standards and Authority requirements.

SCHEDULE OF CHANGES: No changes.

A S. 4.55 Modification EL VO 05.04.22 Issue Revision Description Drawn Check Date

Not for Construction

Maui - Healthcare Warringah Road & Wakehurst Parkway, Frenchs Forest, NSW Section 4.55 Modification

Client	Genesis Care 11/ 41-43 Bourke Rd, Alexandria, NSW, 2015 (02) 8236 3300
Architect	Team 2 701/1 Chandos Street, St Leonards, NSW, 2065 (02) 9437 3166
Drawing No.	Drawing Name Landscape Specification

Job No. Issue Scale


19-635




GENESIS MAUI WARRINGAH ROAD & WAKEHURST PARKWAY

DRAWING SCHEDULE

\frown	\checkmark \checkmark \checkmark	
	DRAWING NO.	DRAWING TITLE
>	000	COVER SHEET
>	100	LANDSCAPE MASTERPLAN
	201	SETOUT AND GRADING PLAN
	301	HARDWORKS PLAN
>	400 401	PLANT SCHEDULE PLANTING PLAN
>	601 602	LANDSCAPE DETAILS - HARDWORKS LANDSCAPE DETAILS - SOFTWORKS
>	701	LANDSCAPE SPECIFICATION
	~ ~ ~	· · · · · · · ·

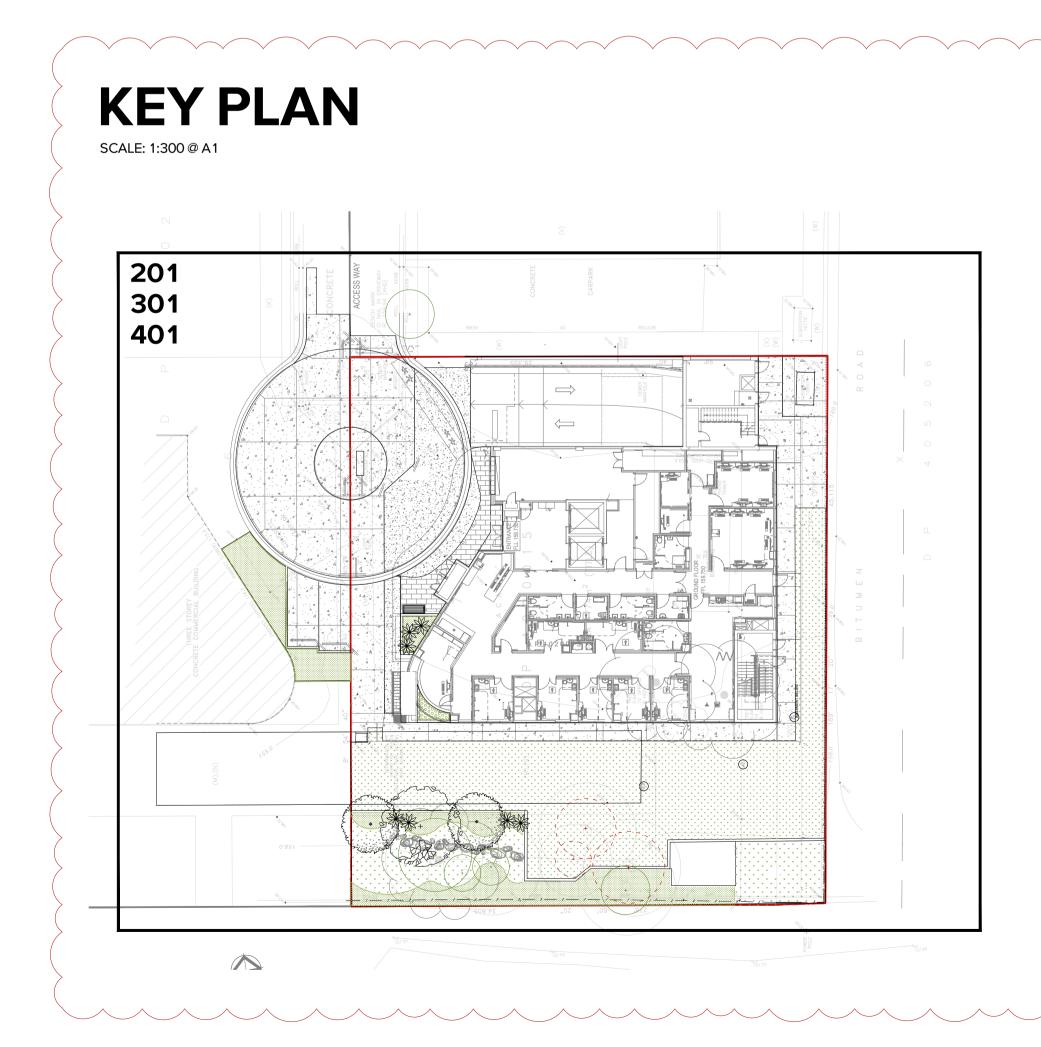

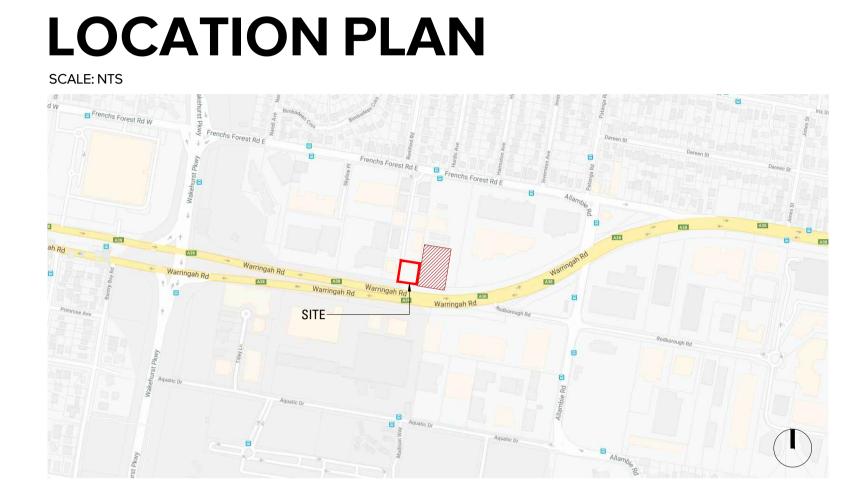

2

Copyright remains the property of Arcadia Design Group Pty Ltd. Use only figured dimensions. Any other required dimensions are to be referred to and supplied by the landscape architect. All discrepancies to be referred to the project manager and Arcadia Design Group Pty Ltd prior to construction. Ensure compliance with the Building Code of Australia and all relevant Australian Standards and Authority requirements.

SCHEDULE OF CHANGES: 1: Drawing schedule updated. 2: Key plan added.

(Refer to sheet L-400 for plant schedule.)

AS. 4.55 ModificationFLVO05.04.22IssueRevision DescriptionDrawnCheckDate

Not for Construction


Project

Maui - Healthcare Warringah Road & Wakehurst Parkway, Frenchs Forest, NSW

Section 4.55 ModificationClientGenesis Care
11/41-43 Bourke Rd, Alexandria, NSW, 2015
(02) 8236 3300ArchitectTeam 2
701/1 Chandos Street, St Leonards, NSW, 2065
(02) 9437 3166Drawing No.Drawing NameL-0000Cover Sheet

Job No. Issue Scale 19-635 A as shown @A1



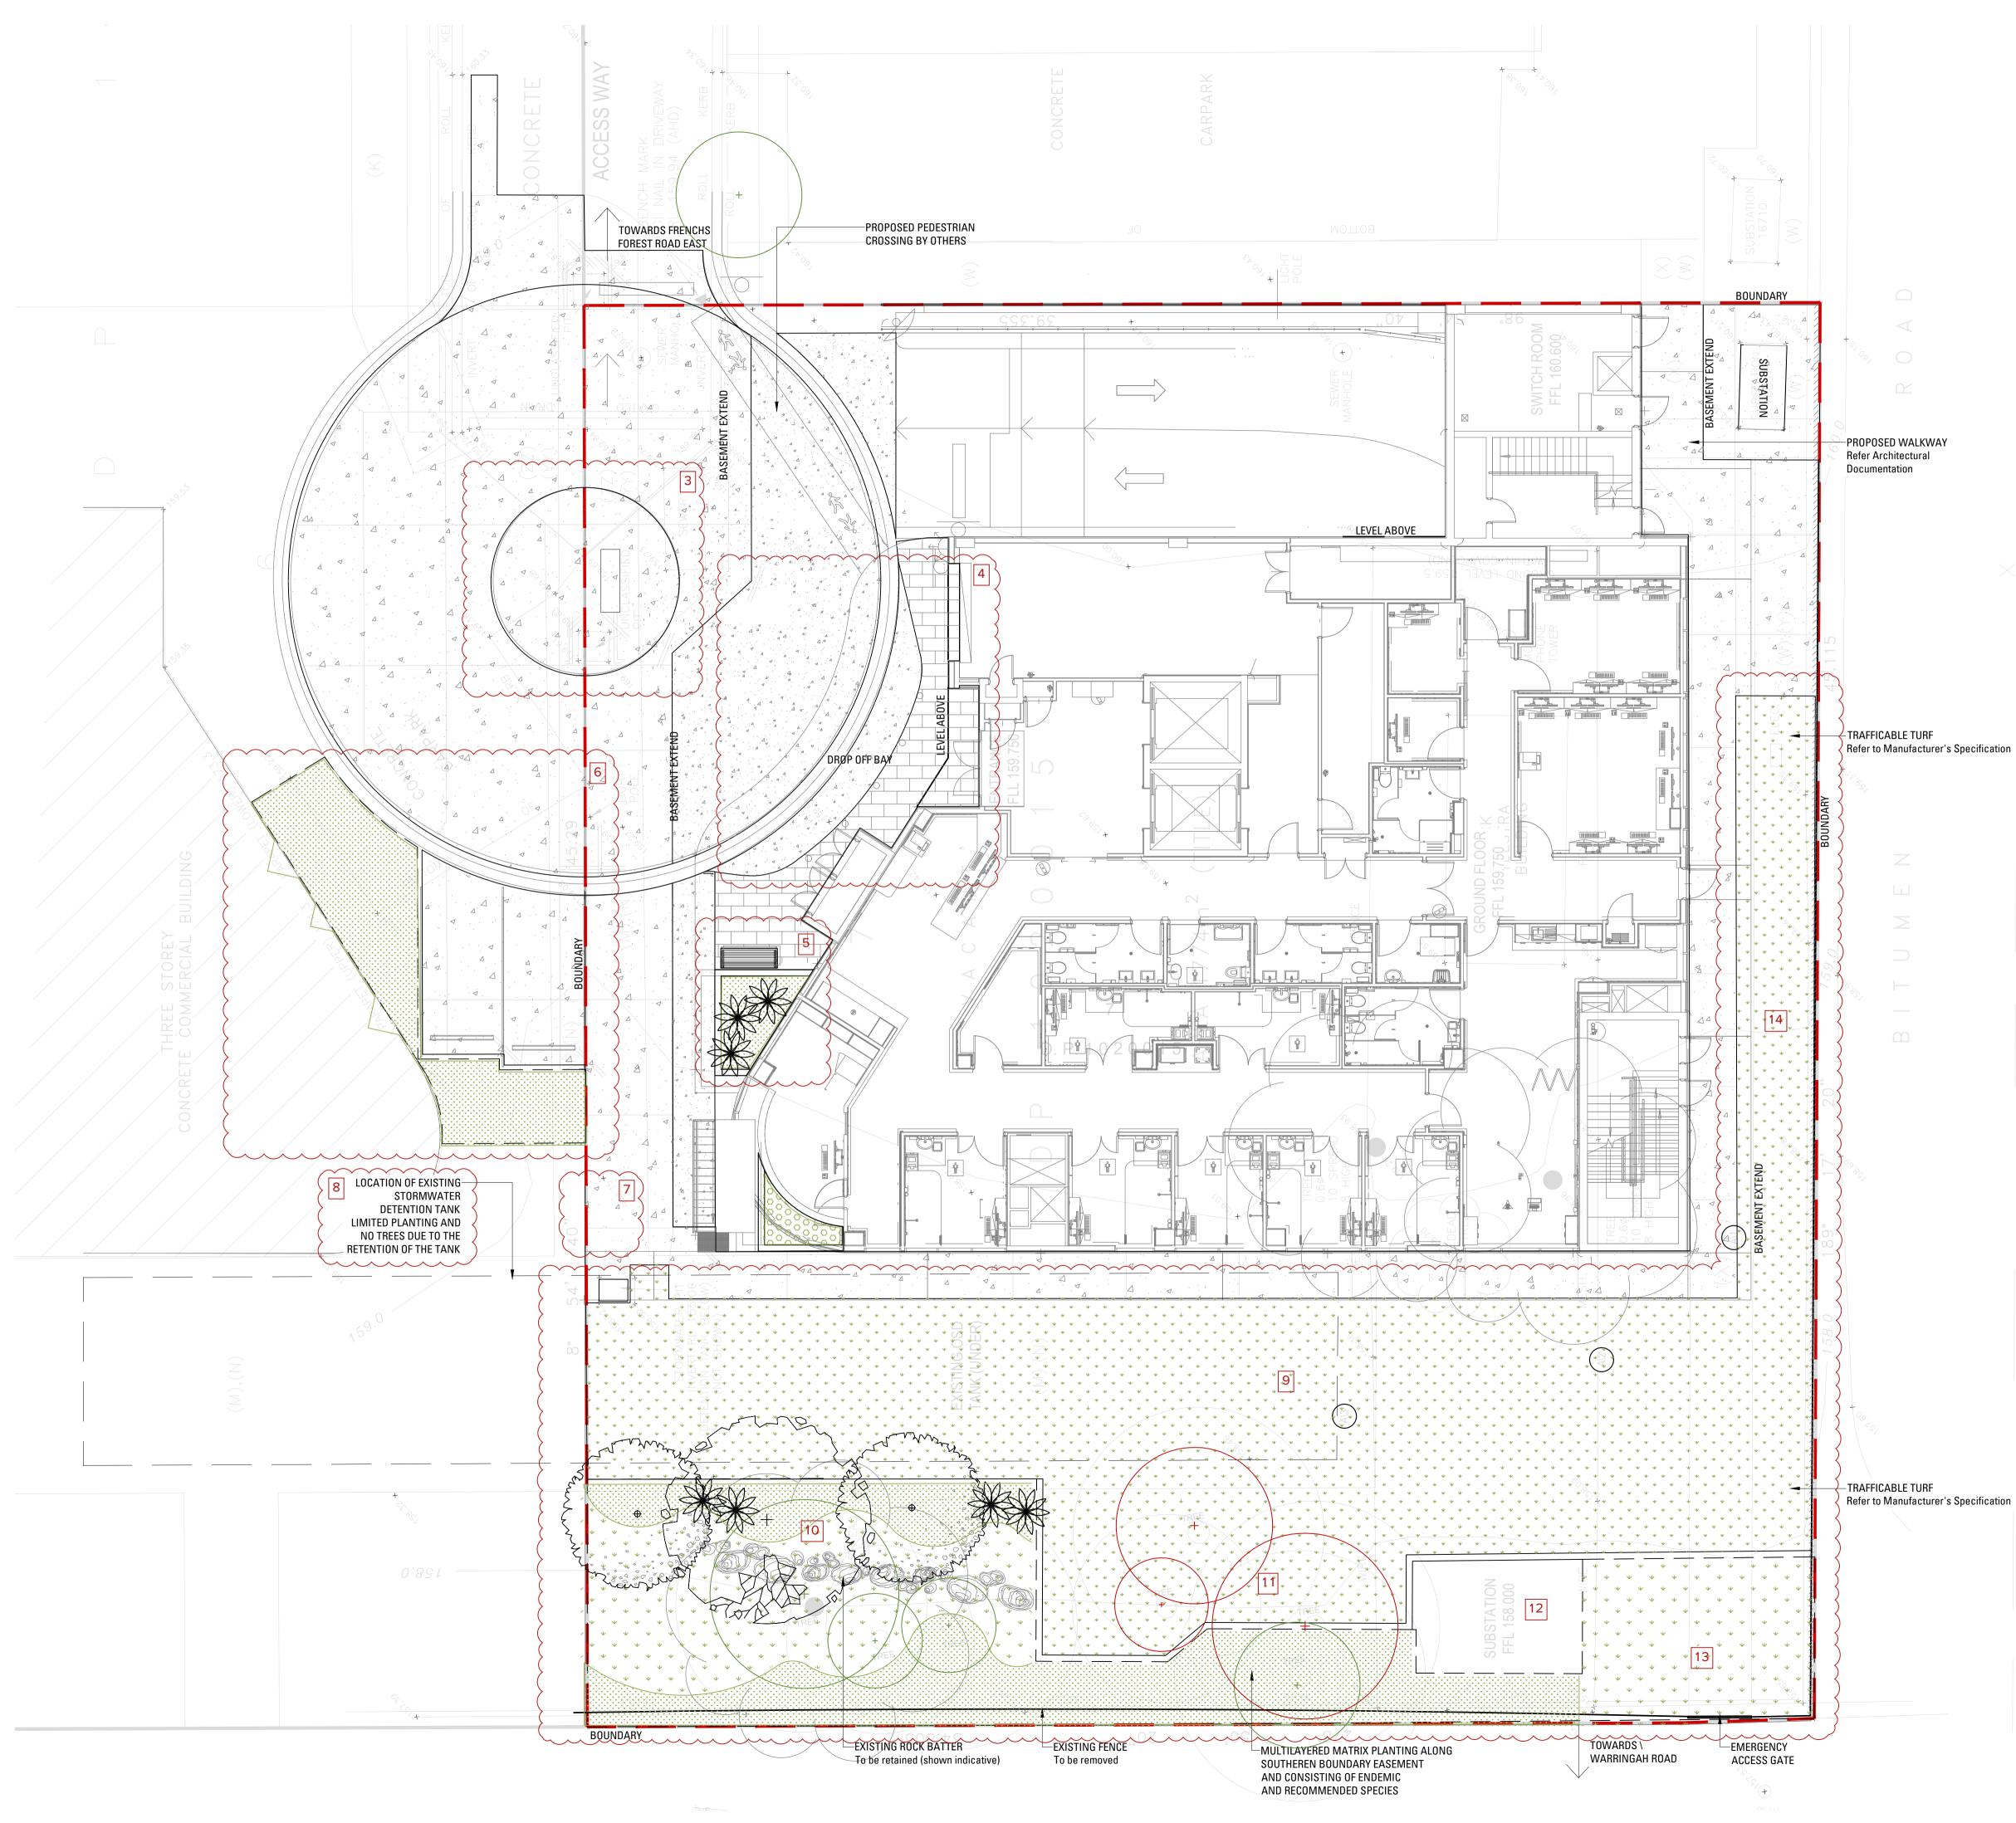

Copyright remains the property of Arcadia Design Group Pty Ltd. Use only figured dimensions. Any other required dimensions are to be referred to and supplied by the landscape architect. All discrepancies to be referred to the project manager and Arcadia Design Group Pty Ltd prior to construction. Ensure compliance with the Building Code of Australia and all relevant Australian Standards and Authority requirements.

Legend	
MASTERPLAN [15])
CONCRETE PAVING Refer Civil Engineer's Documentation	$\left\{ \right.$
UNIT PAVING Refer Landscape Specification	
RETAINING WALL Refer Landscape Specification	
F1 FURNITURE Type F1 Refer Landscape Specification	
FENCE AND ACCESS GATE Refer Landscape Specification	
EXISTING TREES TO BE RETAINED Refer Landscape Specification	$\left\{ \right\}$
EXISTING TREES TO BE REMOVED Refer Landscape Specification	$\left\{ \right.$
TREE PLANTING Refer Landscape Specification	
SHRUB AND ACCENT PLANTING Refer Landscape Specification	
GROUNDCOVER PLANTING Refer Landscape Specification	
MATRIX PLANTING Refer Landscape Specification	$\left\{ \right\}$
TURF Refer Landscape Specification) }
REINFORCED/ TRAFFICABLE TURF Refer Civil Engineer's Documentation	$\left\{ \right\}$

SCHEDULE OF CHANGES: 3: Planting removed to provide required access. 4: Drop-off bay revised. Layout and surface material. 5: Seating area changed to accommodate revised architectural layout. 6: Parking layout revised. Landscape treatment to edges added. 7: Path width revised to provide required access. Planting removed. 8: Correct size of OSD tank below added. 9: Planting removed and replaced with trafficable turf. 10. Tree and understory planting revised due to access constraints. 11. Existing trees to be removed due to access constraints. 12: Planting removed and substation added. 13: Emergency access added.
14: Planting removed and replaced with trafficable turf along Eastern boundary. 15: Legend updated.

А	S. 4.55 Modification	FL	VO	05.04.22
Issue	Revision Description	Drawn	Check	Date


Not for Construction

Project Maui - Healthcare

Warringah Road & Wakehurst Parkway, Frenchs Forest, NSW Section 4.55 Modification Genesis Care 11/ 41-43 Bourke Rd, Alexandria, NSW, 2015 Client (02) 8236 3300 Team 2 701/1 Chandos Street, St Leonards, NSW, 2065 (02) 9437 3166 Architect Drawing Name Drawing No. Landscape Masterplan L-101

Job No.			1	9-635	
Issue				А	\bigcirc
Scale			1:100)@A1	
0 1	2	3	4	5m	



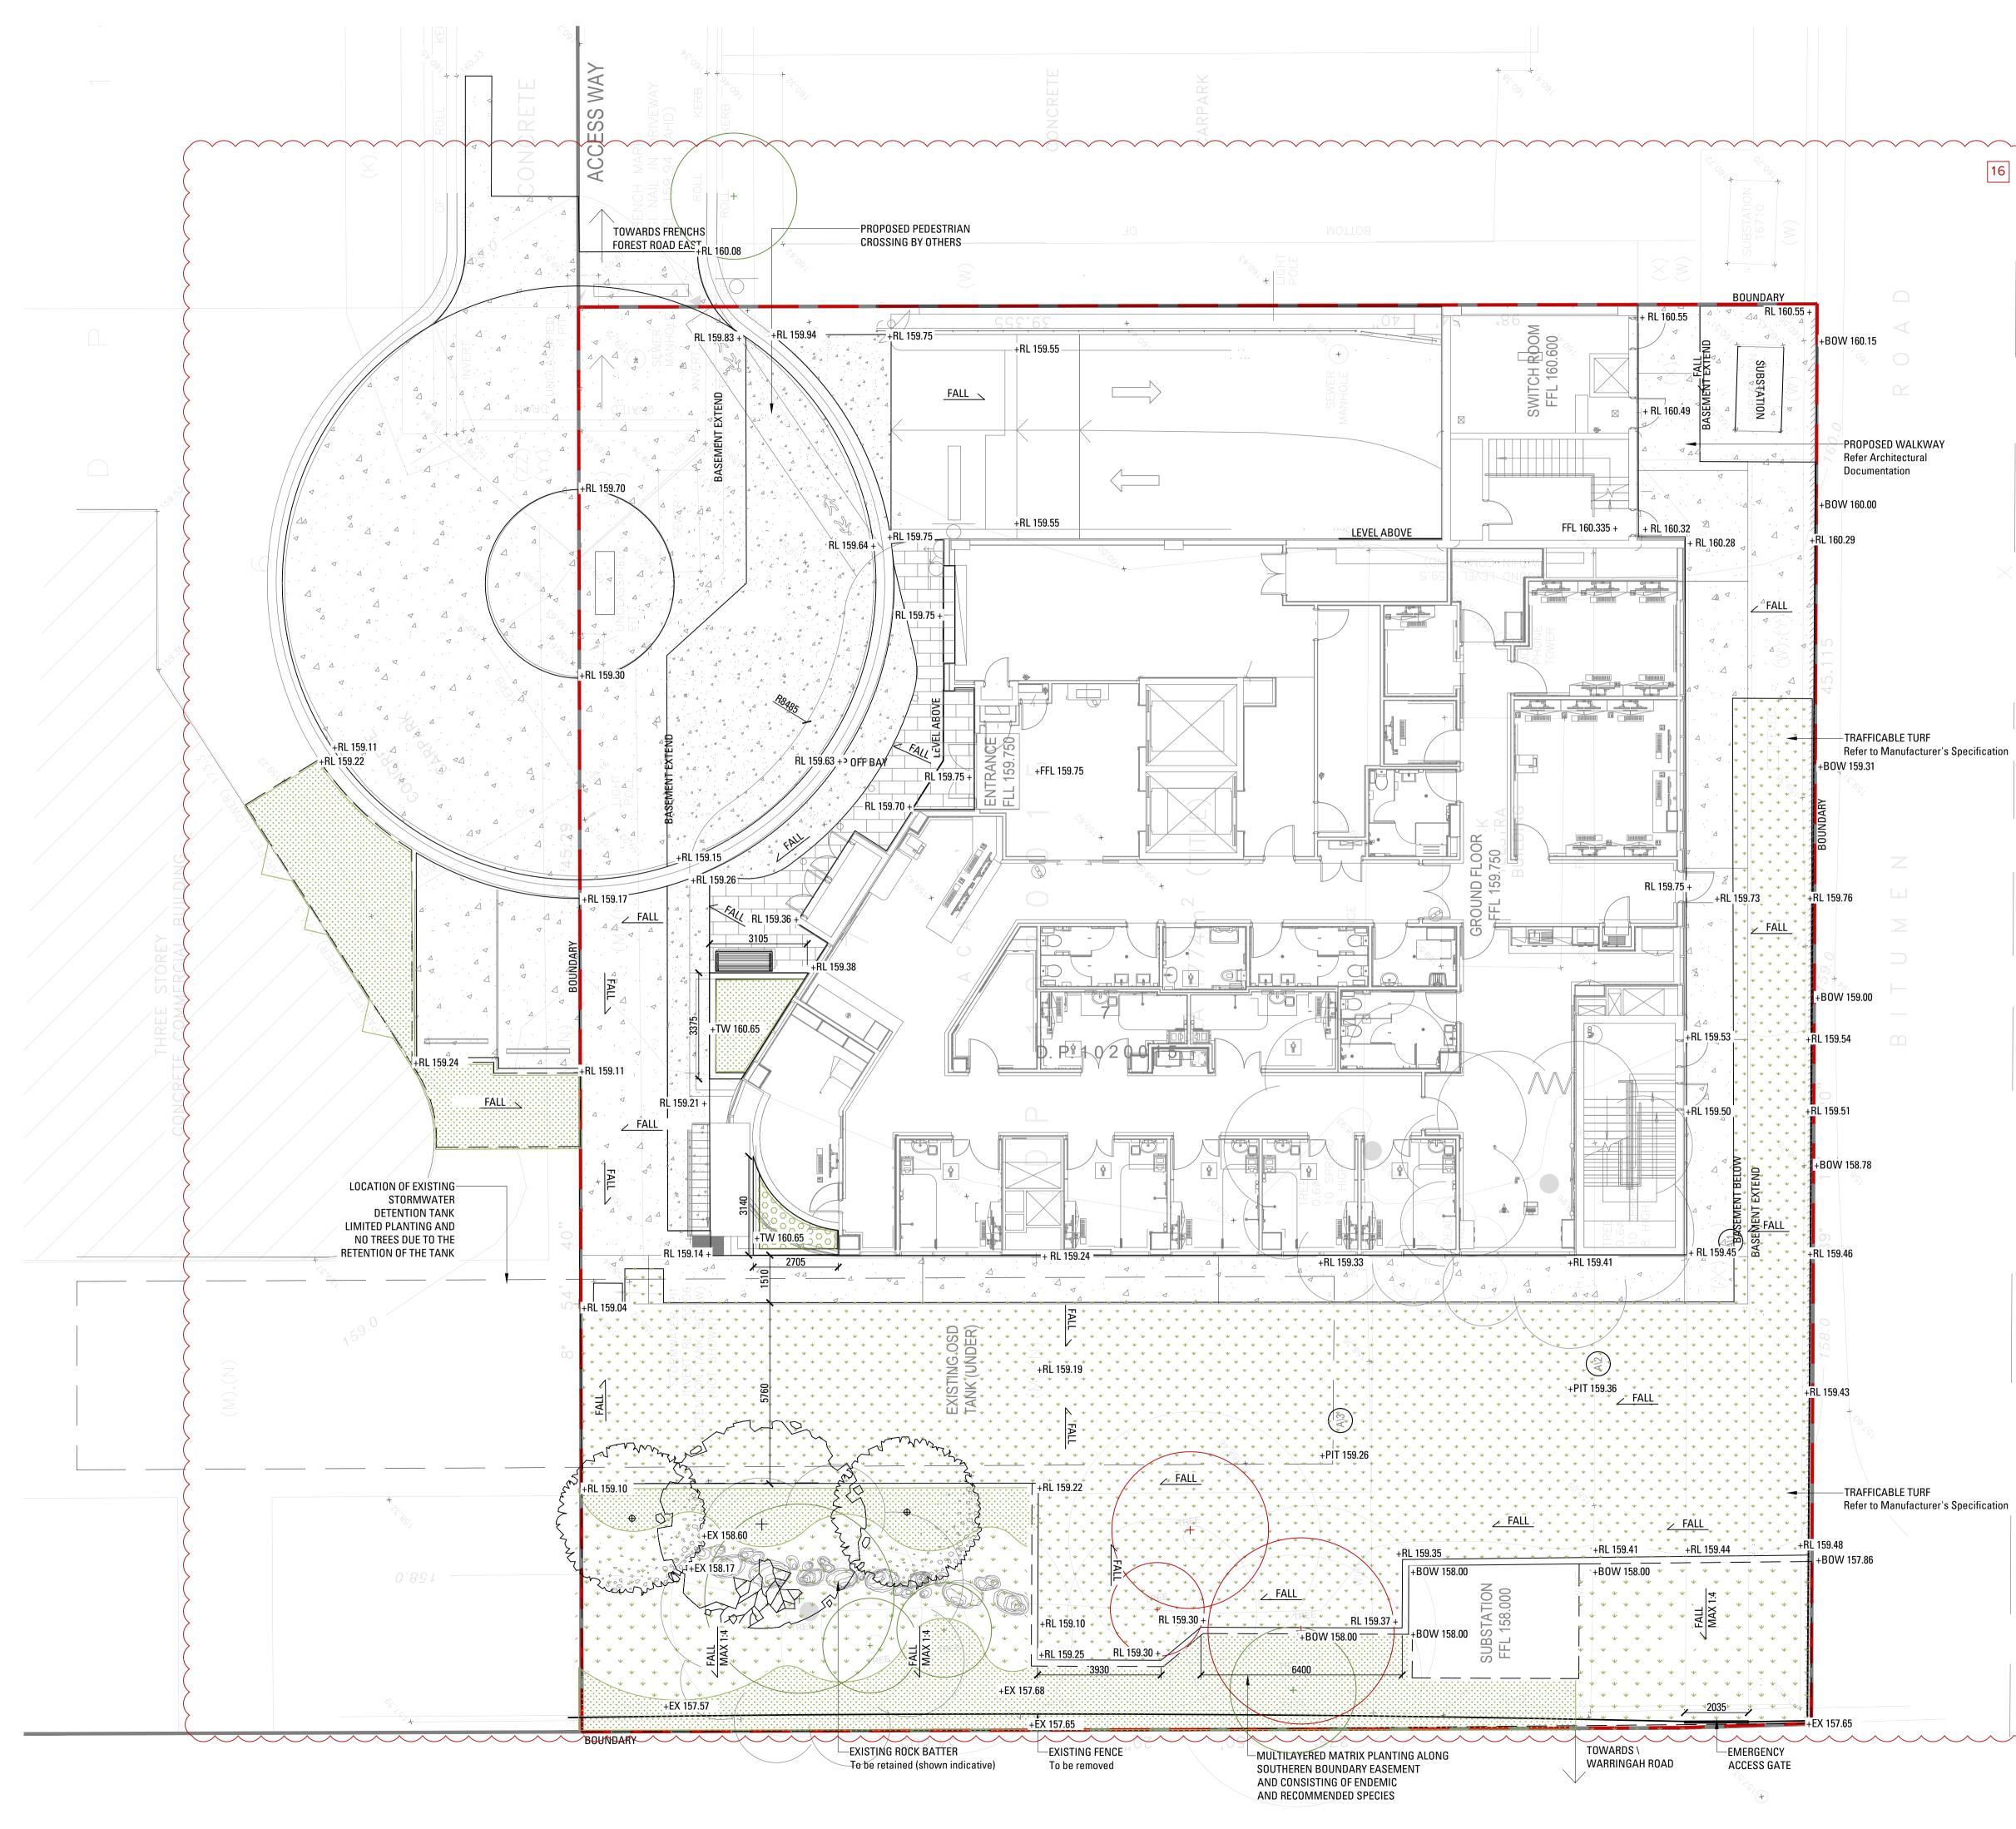

Copyright remains the property of Arcadia Design Group Pty Ltd. Use only figured dimensions. Any other required dimensions are to be referred to and supplied by the landscape architect. All discrepancies to be referred to the project manager and Arcadia Design Group Pty Ltd prior to construction. Ensure compliance with the Building Code of Australia and all relevant Australian Standards and Authority requirements.

Legend SETOUT

SETOUT	
Jest liter	ANGLE MEASUREMENT
ىر ²⁰⁰⁰ بر	DISTANCE MEASUREMENT
<u>R500</u>	RADIUS MEASUREMENT
	SETOUT GUIDES
+	SETOUT MARKER
GRADING	3
RL	REDUCED LEVEL
FFL	FINISHED FLOOR LEVEL
TS/BS	TOP / BOTTOM OF STEP
S	STEP HEIGHT
TW/BW	TOP / BOTTOM OF WALL
ТР	TOP OF STORMWATER PIT
TOS	TOP OF SEAT
	TOP / BOTTOM OF RAMP

SCHEDULE OF CHANGES: 16: Levels updated to match new design and revised Civil documentation.

А	S. 4.55 Modification	FL	VO	05.04.22
Issue	Revision Description	Drawn	Check	Date

Not for Construction

Project

Maui - Healthcare Warringah Road & Wakehurst Parkway, Frenchs Forest, NSW


Section	4.55 Modification
Client	Genesis Care 11/ 41-43 Bourke Rd, Alexandria, NSW, 2015 (02) 8236 3300
Architect	Team 2 701/1 Chandos Street, St Leonards, NSW, 2065 (02) 9437 3166
Drawing No.	Drawing Name Setout and Grading Plan

Job No.			19-635			
lssue			A			\bigcirc
Scale			1:100 @ A1			
0	1	2	3	4	5m	

Sydney, Suite 76, Jones Bay Wharf, 26-32 Pirrama Road, Pyrmont NSW 2009 E sydney@arcadiala.com.au T 02 8571 2900



16

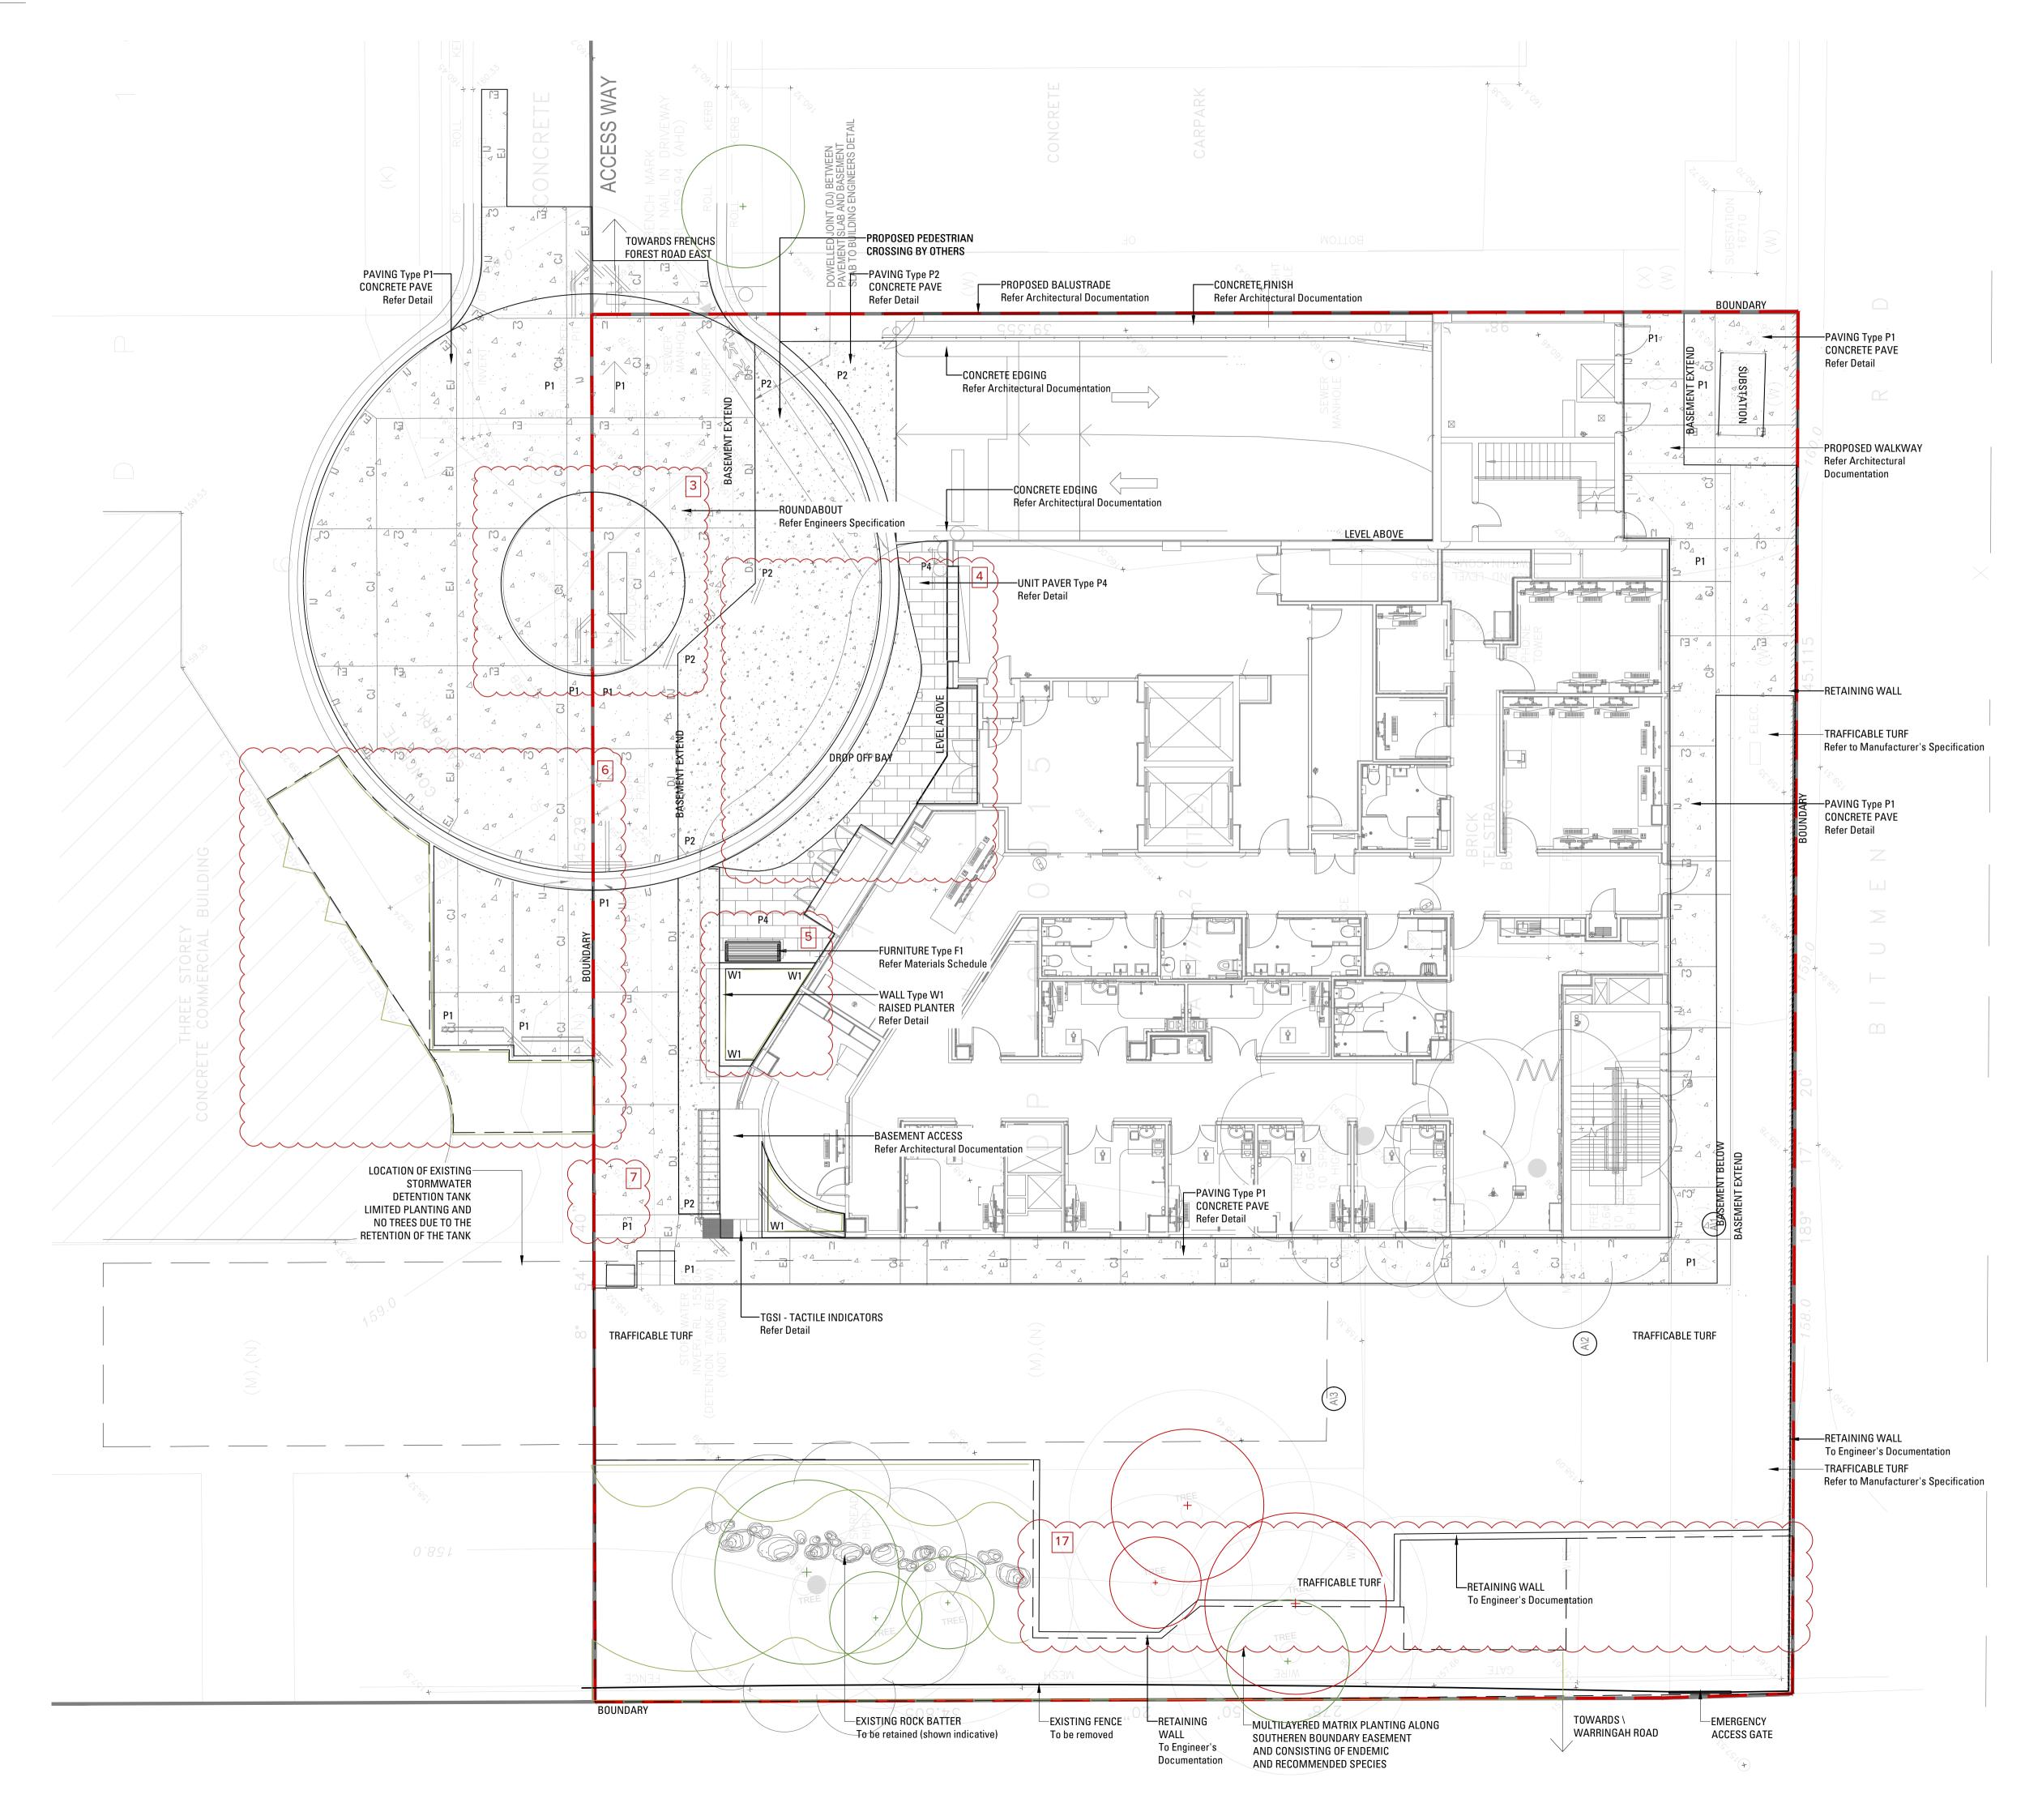

Copyright remains the property of Arcadia Design Group Pty Ltd. Use only figured dimensions. Any other required dimensions are to be referred to and supplied by the landscape architect. All discrepancies to be referred to the project manager and Arcadia Design Group Pty Ltd prior to construction. Ensure compliance with the Building Code of Australia and all relevant Australian Standards and Authority requirements.

Legend HARDWORKS

IIAIIBWOIIRO						
P1	SLAB ON GROUND Refer Civil Engineer's Documentation					
P2	TRAFFICABLE SLAB OVER BASEMENT Refer Civil Engineer's Documentation					
P3.	REINFORCED/ TRAFFICABLE TURF Refer Civil Engineer's Documentation					
P4	UNIT PAVING Refer Landscape Specification					
⊠ W1 <u></u> ∕∕∕	RETAINING WALL Type W1 Refer Landscape Specification					
F1	FURNITURE Type F1 Refer Landscape Specification					
C	FENCE AND ACCESS GATE Refer Landscape Specification					
EJ	EXPANSION JOINT Refer Civil Engineer's Documentation					
CJ	CONTRACTION JOINT Refer Civil Engineer's Documentation					

3: Planting removed to provide required access. 4: Drop-off bay revised. Layout and surface material. 5: Seating area changed to accommodate revised architectural layout. 6: Parking layout revised. Landscape treatment to edges added. 7: Path width revised to provide required access. Planting removed. 17: Retaining wall added.

SCHEDULE OF CHANGES:

AS. 4.55 ModificationFLVO05.04.22IssueRevision DescriptionDrawnCheckDate

Not for Construction

Project Maui - Healthcare Warringah Road & Waket

Warringah Road & Wakehurst Parkway, Frenchs Forest, NSW Section 4.55 Modification

Client	Genesis Care 11/ 41-43 Bourke Rd, Alexandria, NSW, 2015 (02) 8236 3300
Architect	Team 2 701/1 Chandos Street, St Leonards, NSW, 2065 (02) 9437 3166
Drawing No.	Drawing Name Hardworks Plan

Job No. 19-635 Issue A Scale 1:100@A1 0 1 2 3 4 5m

