

ALTERATIONS and ADDITIONS: to EXISTING DETACHED STYLE SINGLE STOREY RENDERED HOUSE at No.2 NEW STREET EAST BALGOWLAH NSW 2093

SYMBOLS + COLOURS:

OUTLINE OF DEMOLITION:
BOUNDARY LINE - AS SURVEYED

METAL TILE NEW ROOF EXISTING TO REMAIN

DIRECTION OF ROOF FALL

DIRECTION OF STORMWATER

DIRECTION OF SURFACE FALL

ACHIEVED SETBACK DIMENSION

900

YELLOW - TIMBER BASED GREEN - CONCRETE BASED
RED - MASONRY BASED BLUE - METAL BASED
ORANGE - DEMOLITION PINK - GENERAL PAVEMENT
EARTHWORK LIGHT GREEN - PERM. LANDS

THE INFORMATION PROVIDED ON THESE PLANS HAVE BEEN PRODUCED BASED ON THE INFORMATION PROVIDED TO US BY THE CLIENT, and THE CLIENT'S CONSULTANTS.


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LEGEND:	ABOVE FINISHED FLOOR LEVEL	H	HIGH HANDRAIL
AFFL	BAL	MDR	METAL DECK ROOF SHEETING
BO	BOX GUTTER - TO ENGINEER'S DETAILS	MTL	METAL SHEET OVERHEAD
BLD	BUILDING	OH	OVERHEAD
BSN	BASIN	PMP	PAVEMENT
BWKF	BRICKWORK - COLOUR/FINISH	PVF	PAINT FINISH
COL	COLUMN	PP	POWER POLE
COMC	CONCRETE	R	READER
COS	CONFIRM ON SITE	RR	ROOF RIDGE
CPT	CARPET	RL	RELATIVE LEVEL
CP	DOWNPIPE	RT	ROOF TILE
DR	DRYER	RWO	RAINWATER OUTLET
EX	EXISTING	SHR	SHOWER
FB	FACE BRICK	TD	TIMBER DECK
FCB	FIBRE CEMENT SHEETING - TYPE	TF	TIMBER FLOOR
FCL	FINISHED CEILING	TFAS	TOP OF FASCIA
FFL	FINISHED FLOOR	TG	TOP OF GUTTER
FLUE	FIRE PLACE FLUE	TG	TILED FLOORING
FP	FIRE PLACE - INTERNAL	TYP	TYPICAL
GL	GLASS-TO-BASIX REQUIREMENTS	TW	TOP OF WALL
		WC	WATER CLOSET
		WIN	WINDOW
		WM	WASHING MACHINE
		VNTY	VANITY

2 NEW STREET EAST, BALGOWLAH 2093

ALTERATIONS and ADDITIONS:


Works Include:
- Ground Floor Addition; New First Floor Addition; Internal and External Modifications; Rectifications and Improvements; and Landscape Concept

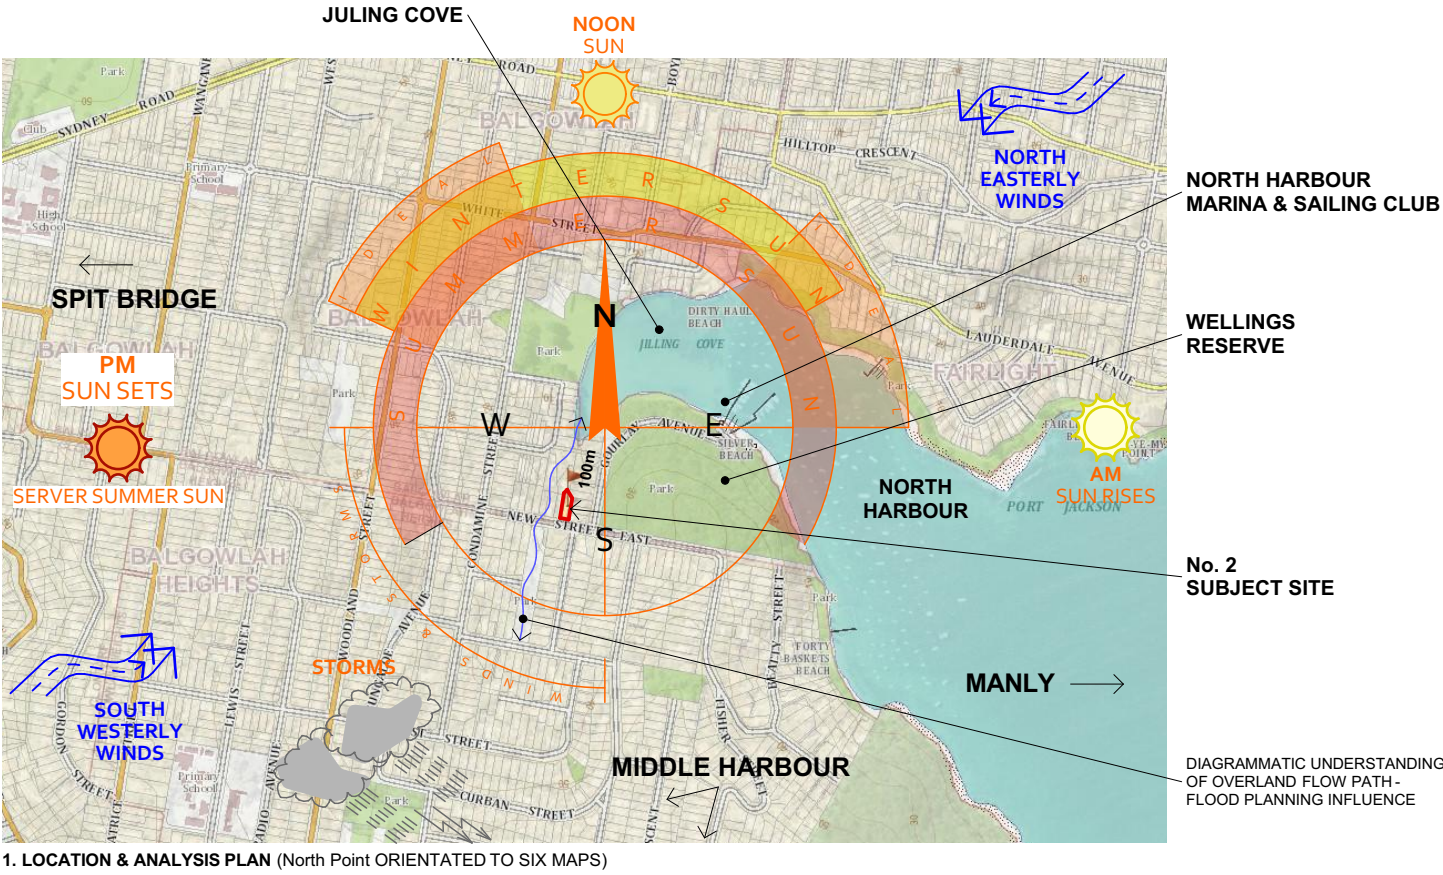


SITE AREA: 550.1m²
SITE WIDTH: 12.19m

PLANNING: MANLY LEP & DCP 2013

-Land Zoning: R2 - Low Density Residential
-FSR: 0.45:1 (247.5m²)
-Site Coverage: Open Space requirement. Max SC. 247.55m²
-Height of Building: 8.5m
-Heritage: Not an Item; Not within a Heritage Conservation Area, and is not a Contributory Item.
-Bushfire Prone Land: Yes is within Bushfire Prone Land
-Flood Risk: Low and Medium Risk
-No. of storeys: Max. 2
-Building Envelope: no less than 1/3 of proposed height
-Landscape ratio: Open Space Area 3 (OS3): 55% = 302.55m², 35% of that to be Landscaped (with 25% max. above ground-balcony or the like). 3m min. dimension, 1m soil depth and at least a 12sqm clear space.
-Front setback: Prevailing Setback - neighbouring carport
-Side setback: 1/3 of wall height
-Rear setback: 8m
-Private Open Space: 18m², rear and level to building.
-Foreshore Building Line / Scenic Protection: Yes
-Acid Sulfate Soils: Class 5
-Geotechnical Hazard: Not in Landslip Risk
-Biodiversity: N/A
-Pool: N/A - Existing Pool - no new work
-Secondary Dwelling: N/A

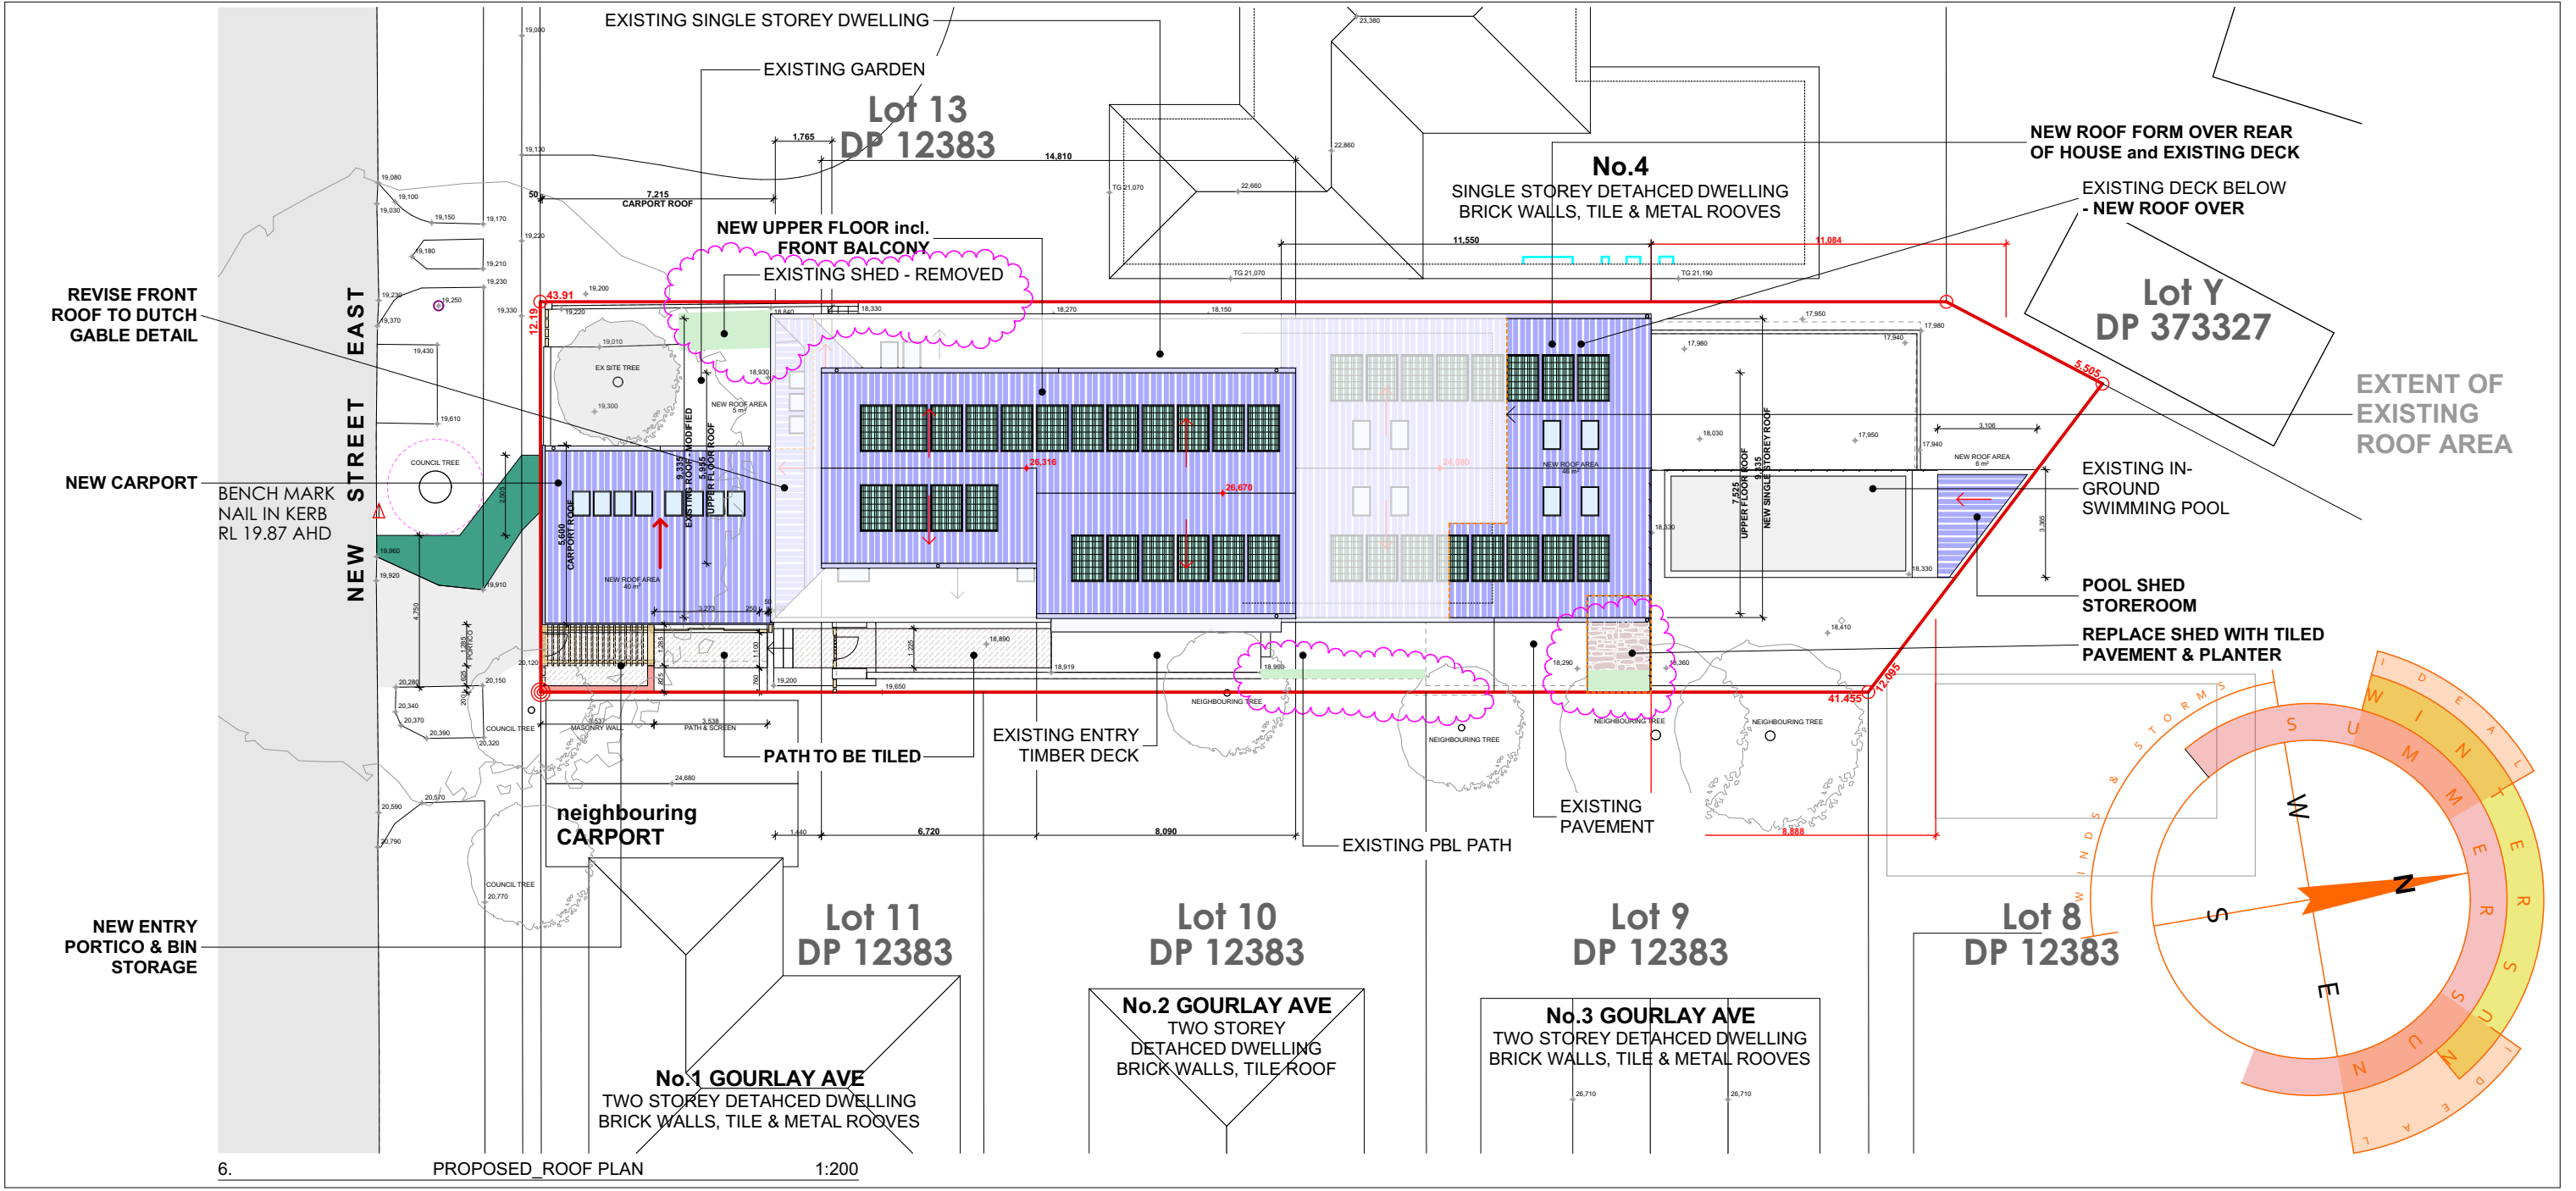

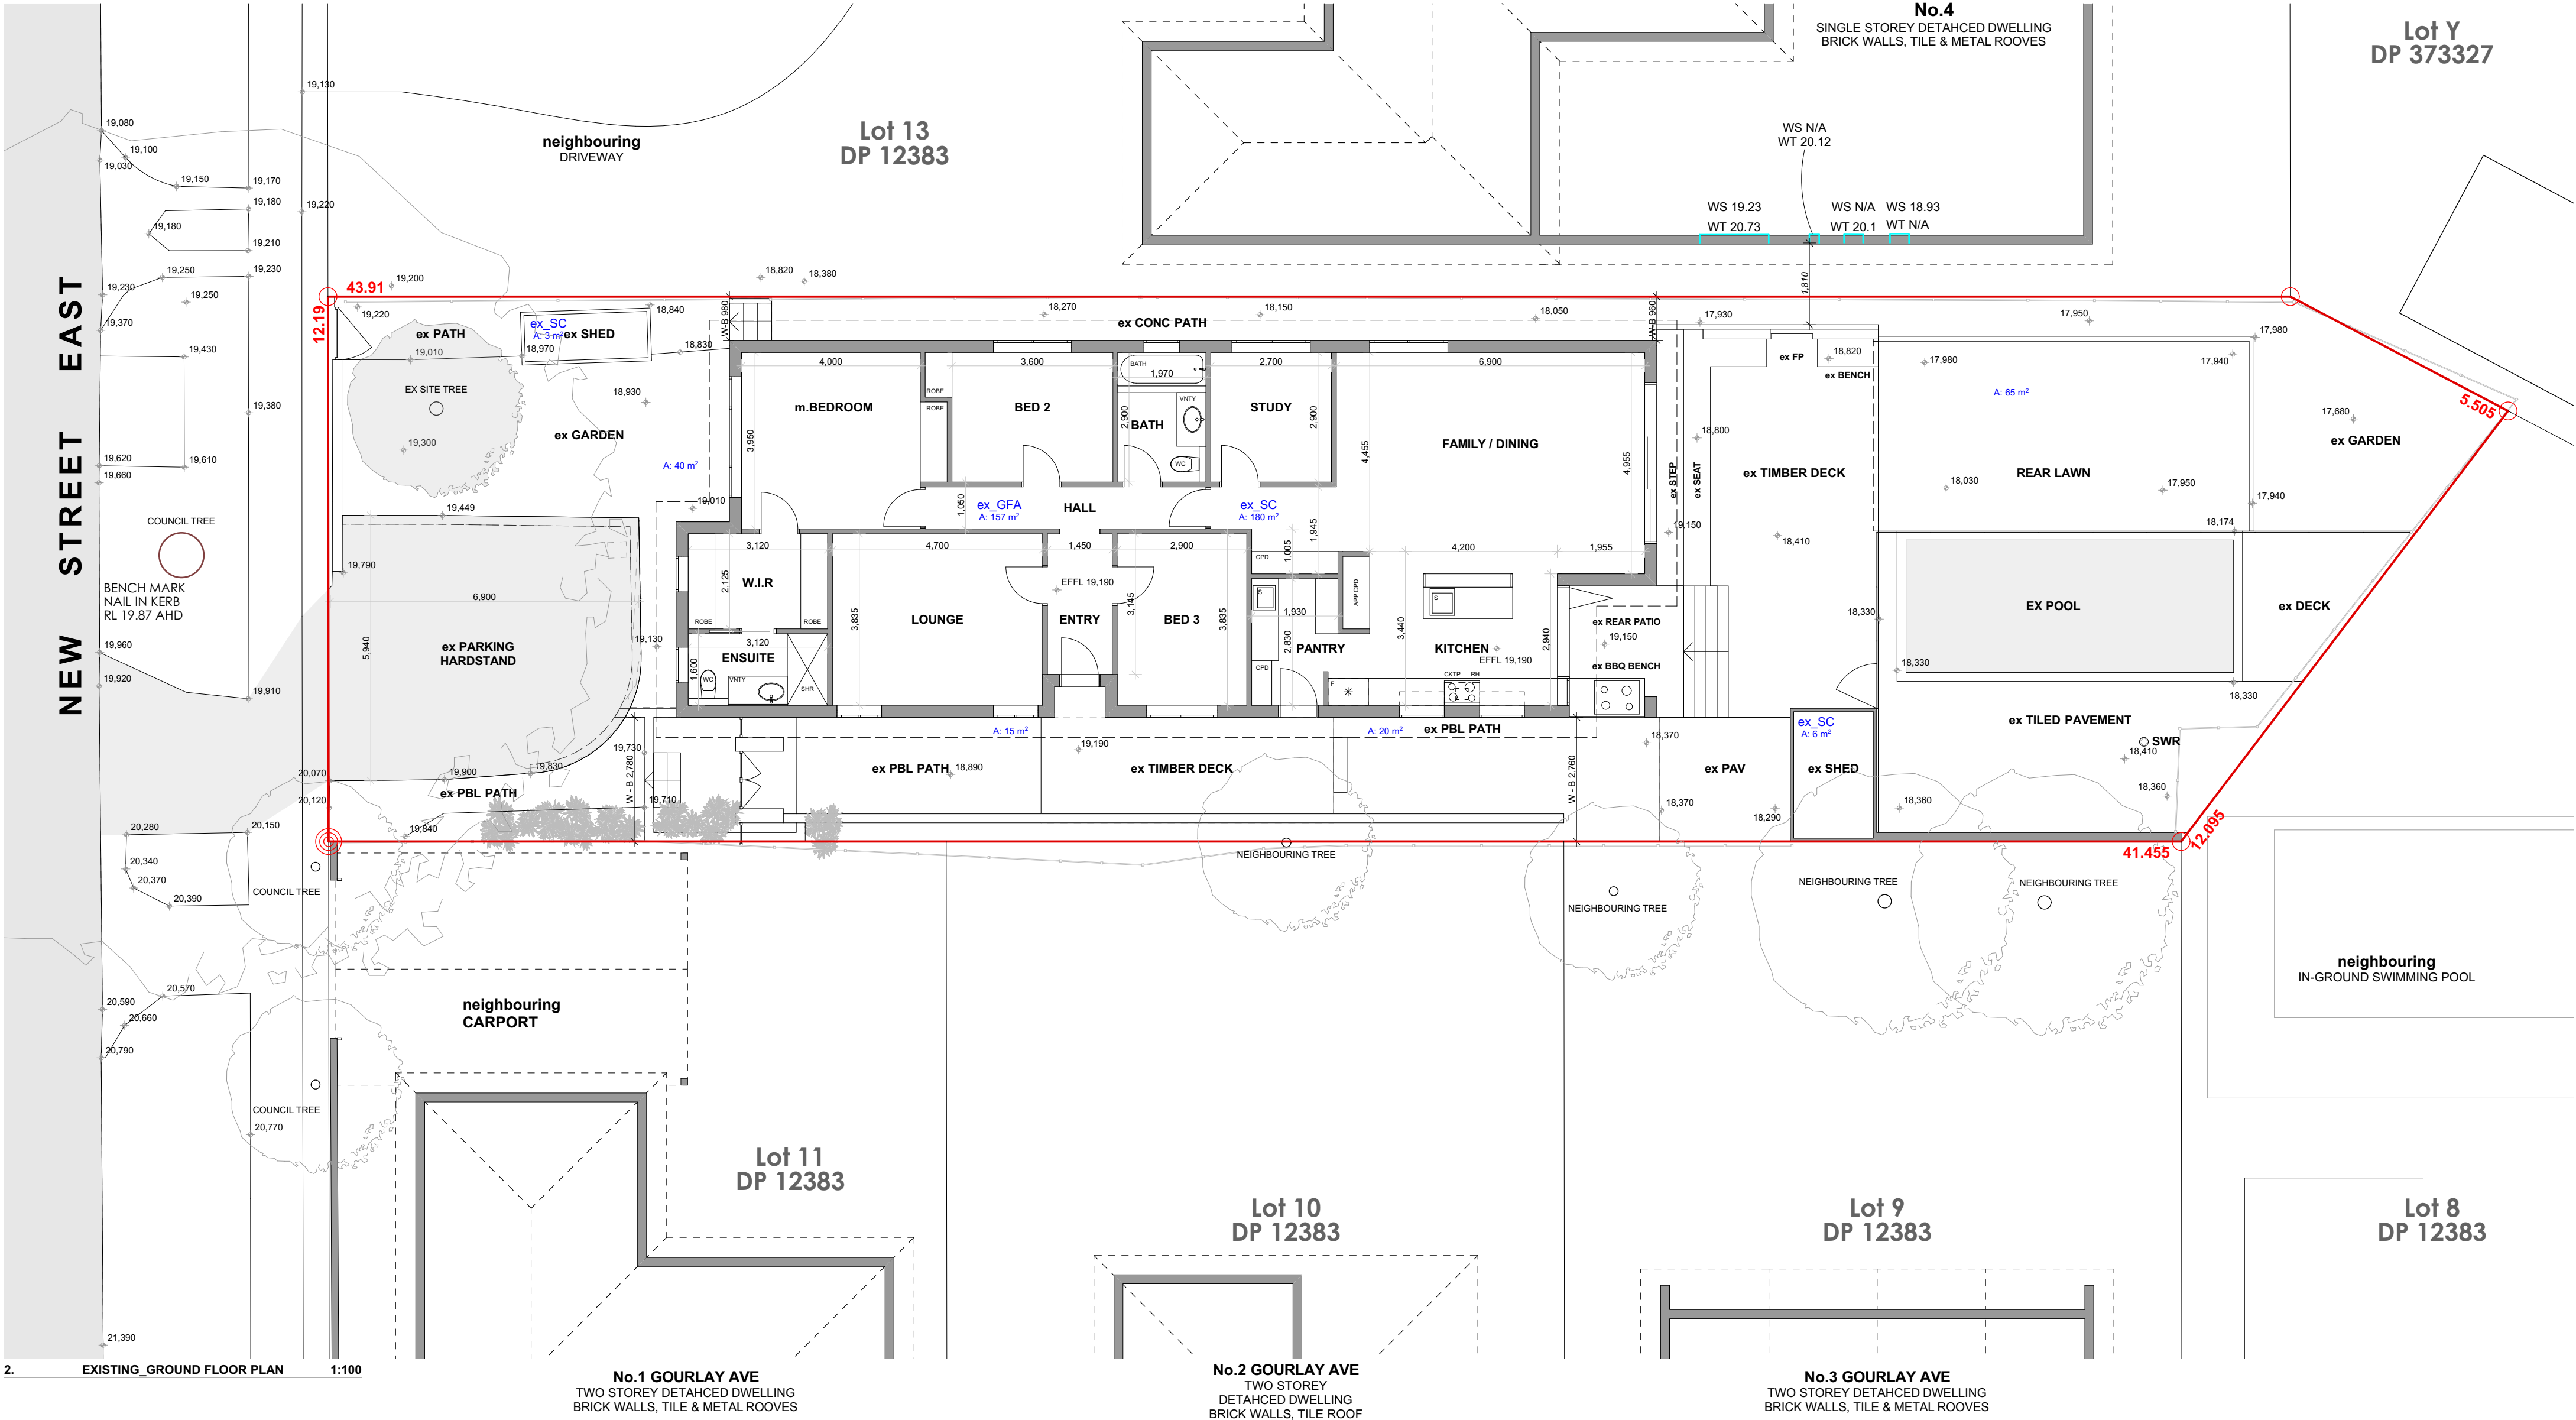

2. EXISTING_GROUND FLOOR PLAN 1:100

No.1 GOURLAY AVE
TWO STOREY DETACHED DWELLING
BRICK WALLS, TILE & METAL ROOVES

No.2 GOURLAY AVE
TWO STOREY
DETACHED DWELLING
BRICK WALLS, TILE ROOF

No.3 GOURLAY AVE
TWO STOREY DETACHED DWELLING
BRICK WALLS, TILE & METAL ROOVES

Lot 8
DP 12383

Lot 9
DP 12383

Lot 10
DP 12383

Lot 11
DP 12383

Lot 13
DP 12383

Lot Y
DP 373327

GENERAL NOTES

1. ALL DIMENSIONS, LEVELS, SEWER AND STORMWATER INVERT LEVELS AND FLOOR AREAS ARE TO BE CHECKED AND VERIFIED. ANY DISCREPANCIES ARE TO BE BROUGHT TO THE ATTENTION OF THE DESIGNER PRIOR TO THE COMMENCEMENT OF ANY BUILDING WORK.
2. DO NOT SCALE OFF DRAWINGS.

DEVELOPMENT APPLICATION

- NOT FOR APPROVALS or CONSTRUCTION

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MEASUREMENTS HAVE NOT BEEN CHECKED.
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2 NEW STREET EAST, BALGOWLAH NSW, 2093

CLIENT

M & N DeGARIS

Designer

HARGROVES DESIGN CONSULTANTS

M: 0410 669 148
E: jacqui@hargroves.com.au

DATE

DEC 2021

TITLE

EXISTING GROUND FLOOR PLAN

SCALE

AS NOTED
BY A2

DRAWN

R.P.


Sheet No

DA-101

Issue

H

G	RP	REVISED UPPER FLOOR PROPOSAL FOR CLIENT APPROVAL	26.11.2024						
F	RP	REVISED UPPER FLOOR PROPOSAL FOR CLIENT APPROVAL	15.11.2024						
E	RP	REVISED UPPER FLOOR PROPOSAL FOR CLIENT APPROVAL	14.11.2024						
D	RP	REVISED UPPER FLOOR PROPOSAL FOR CLIENT APPROVAL	01.11.2024						
C	RP	UPPER FLOOR ISSUED FOR CONSIDERATION	25.02.2022						
B	RP	ISSUED FOR CLIENT APPROVAL	24.02.2022						
A	RP	ISSUED FOR INITIAL REVIEW	10.01.2022	H	RP	DEVELOPMENT APPLICATION SUBMISSION	09.01.2022		
ISSUE	BY	DESCRIPTION	DATE	ISSUE	BY	DESCRIPTION	DATE		

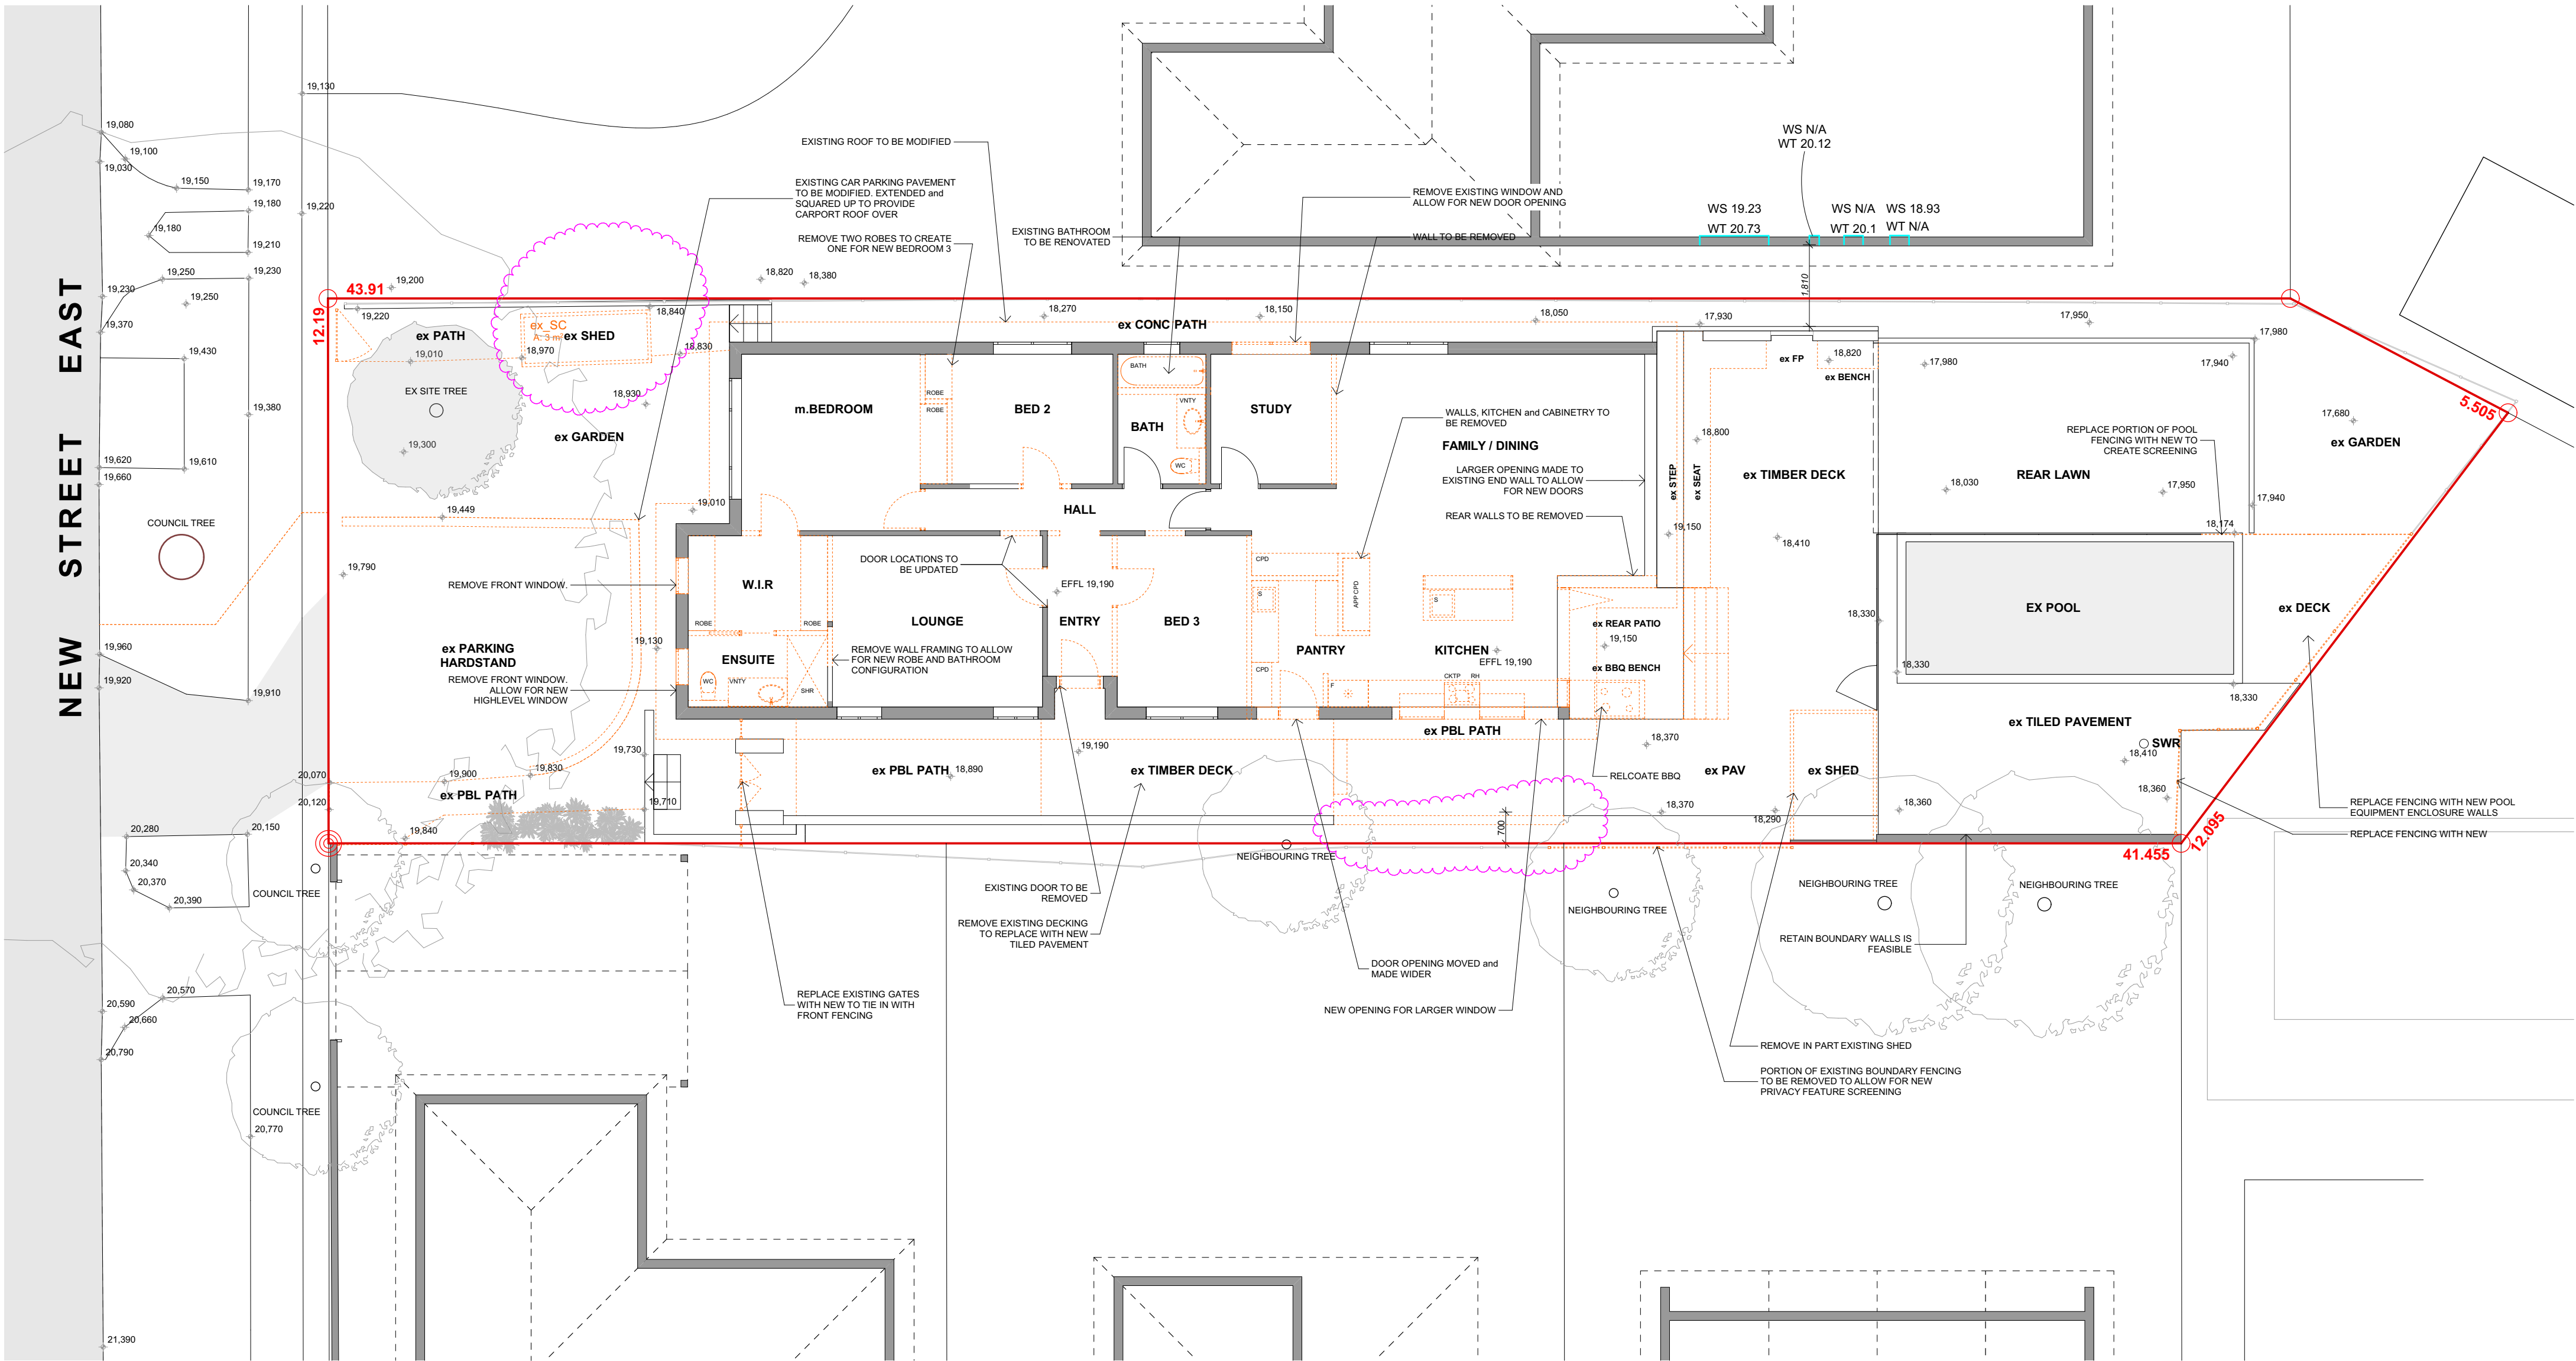

2. DEMOLITION_GROUND FLOOR PLAN 1:100

DEMOLITION NOTE:
ALL DEMOLITION WORKS TO BE DONE IN ACCORDANCE WITH AS2601 and CONSENT AUTHORITY CONDITIONS.

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CLIENT
M & N DeGARIS

Designer
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DATE
DEC 2021
SCALE
AS NOTED
DRAWN
R.P.
TITLE
DEMOLITION GROUND FLOOR PLAN
Sheet No
DA-102
Issue
J

G	RP	REVISED UPPER FLOOR PROPOSAL FOR CLIENT APPROVAL	26.11.2024			
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ISSUE	BY	DESCRIPTION	DATE	ISSUE	BY	DESCRIPTION

BUSHFIRE ASSESSMENT
BAL-12.5

Required construction level

The highest Bushfire Attack Level to the proposed new works was determined to be BAL 12.5 from the eastern aspect. The proposed new works are required to comply with section 3 and 5.2 of AS 3999 - 2018 Construction of buildings in bushfire prone areas or the NASH Standard National Standard Steel Framed Construction in Bushfire Areas 2021 as appropriate for BAL 12.5 construction.

The additional construction requirements detailed within section 7.5.2 of PBP 2019 are also applicable.

Note: Certain provisions of AS 3959 are varied in NSW based on the findings of the Victorian Bush Fires Royal Commission and bush fire industry research. PBP 2019 section 7.5.2 provides a NSW State Variation that BAL 12.5 decks and outdoor areas are covered to section 7.5.2.2. Requirements except that any wall enclosing the outdoor space need only comply with the wall requirements for BAL 12.5.


BASIX Certificate
Building Sustainability Index www.basix.nsw.gov.au

Alterations and Additions

Certificate number: A1779439

This certificate confirms that the proposed development will meet the NSW government's requirements for sustainability, if it is built in accordance with the commitments set out below. Terms used in this certificate, or in the commitments, have the meaning given by the document entitled "BASIX Definitions" dated 10/09/2020 published by the Department. This document is available at www.basix.nsw.gov.au

Secretary
Date of issue: Wednesday, 08 January 2025
To be valid, this certificate must be lodged within 3 months of the date of issue.

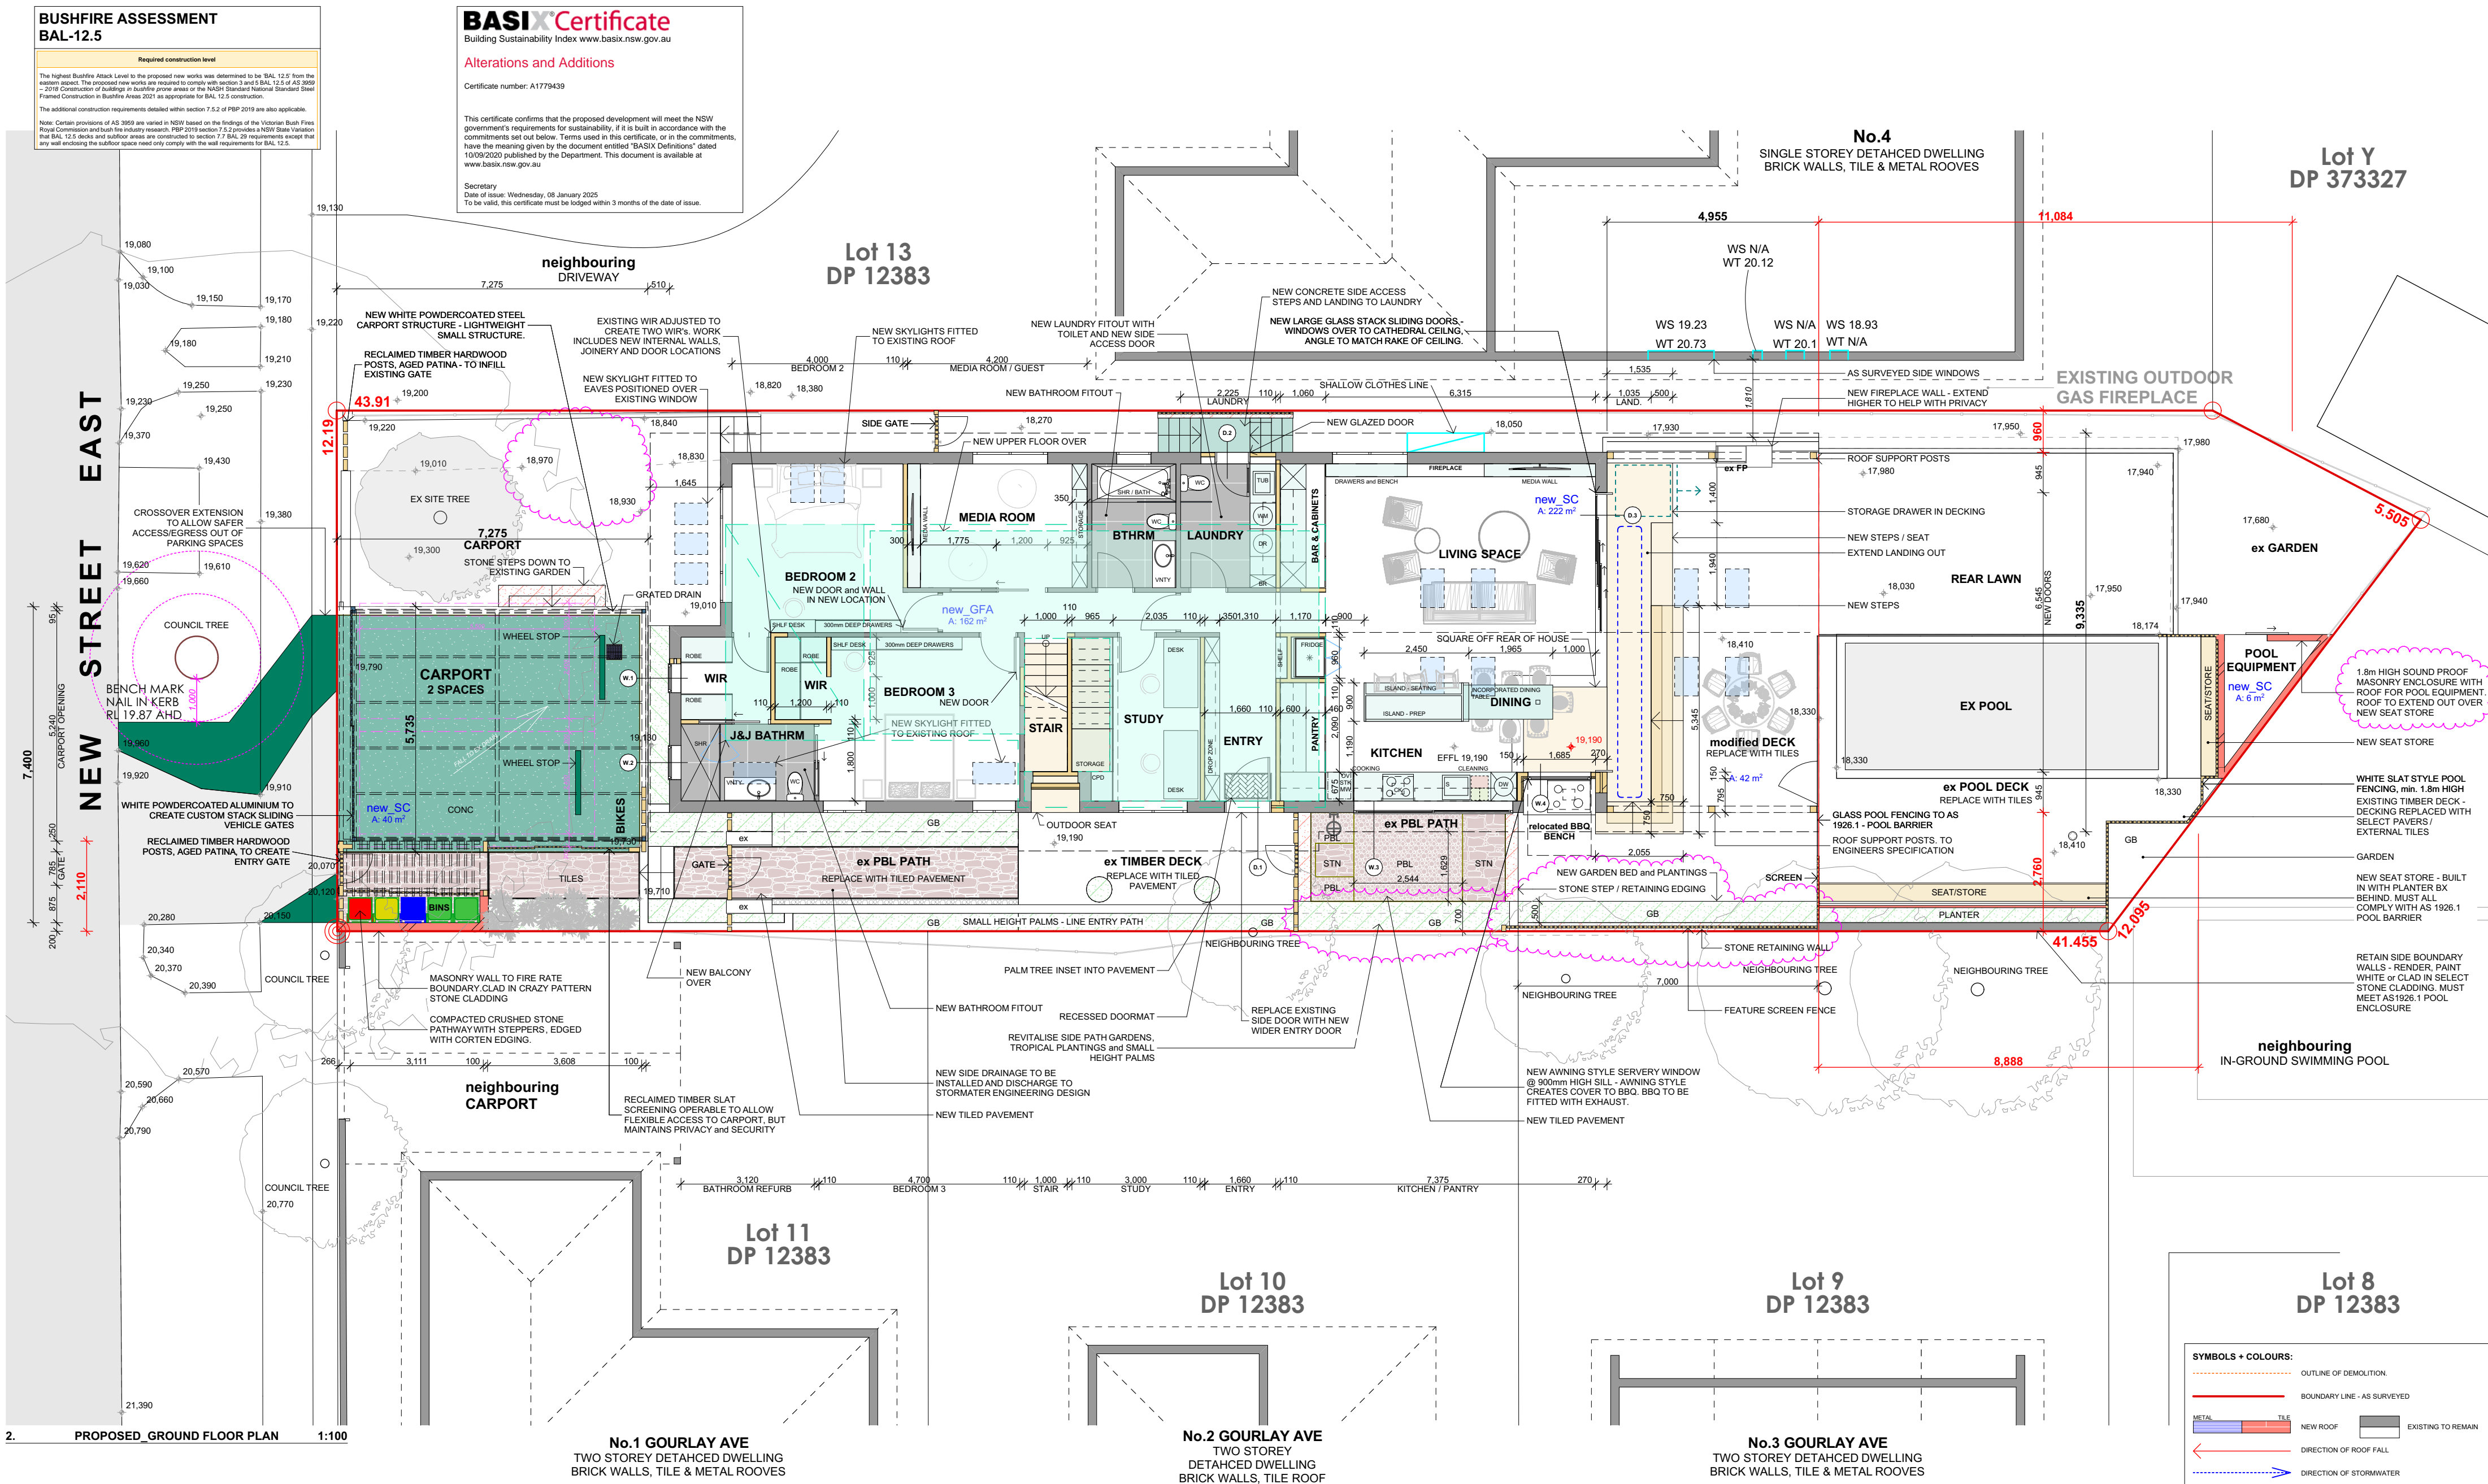

2. PROPOSED_GROUND FLOOR PLAN 1:100

No.1 GOURLAY AVE
TWO STOREY DETACHED DWELLING
BRICK WALLS, TILE & METAL ROOFS

No.2 GOURLAY AVE
TWO STOREY DETACHED DWELLING
BRICK WALLS, TILE ROOF

No.3 GOURLAY AVE
TWO STOREY DETACHED DWELLING
BRICK WALLS, TILE & METAL ROOFS

Lot 8
DP 12383

SYMBOLS + COLOURS:

- OUTLINE OF DEMOLITION.
- BOUNDARY LINE - AS SURVEYED
- METAL TILE
- NEW ROOF
- DIRECTION OF ROOF FALL
- DIRECTION OF STORMWATER
- DIRECTION OF SURFACE FALL
- ACHIEVED SETBACK DIMENSION
- 900
- YELLOW - TIMBER BASED
- RED - MASONRY BASED
- ORANGE - DEMOLITION
- EARTHWORK
- EXISTING TO REMAIN

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Designer
HARGROVES DESIGN CONSULTANTS

M: 0410 669 148
E: jacqui@hargroves.com.au

DATE DEC 2021 TITLE
SCALE AS NOTED @ A2
DRAWN R.P. PROPOSED GROUND FLOOR PLAN DA-103 J

Sheet No
Issue

BUSHFIRE ASSESSMENT
BAL-12.5

Required construction level

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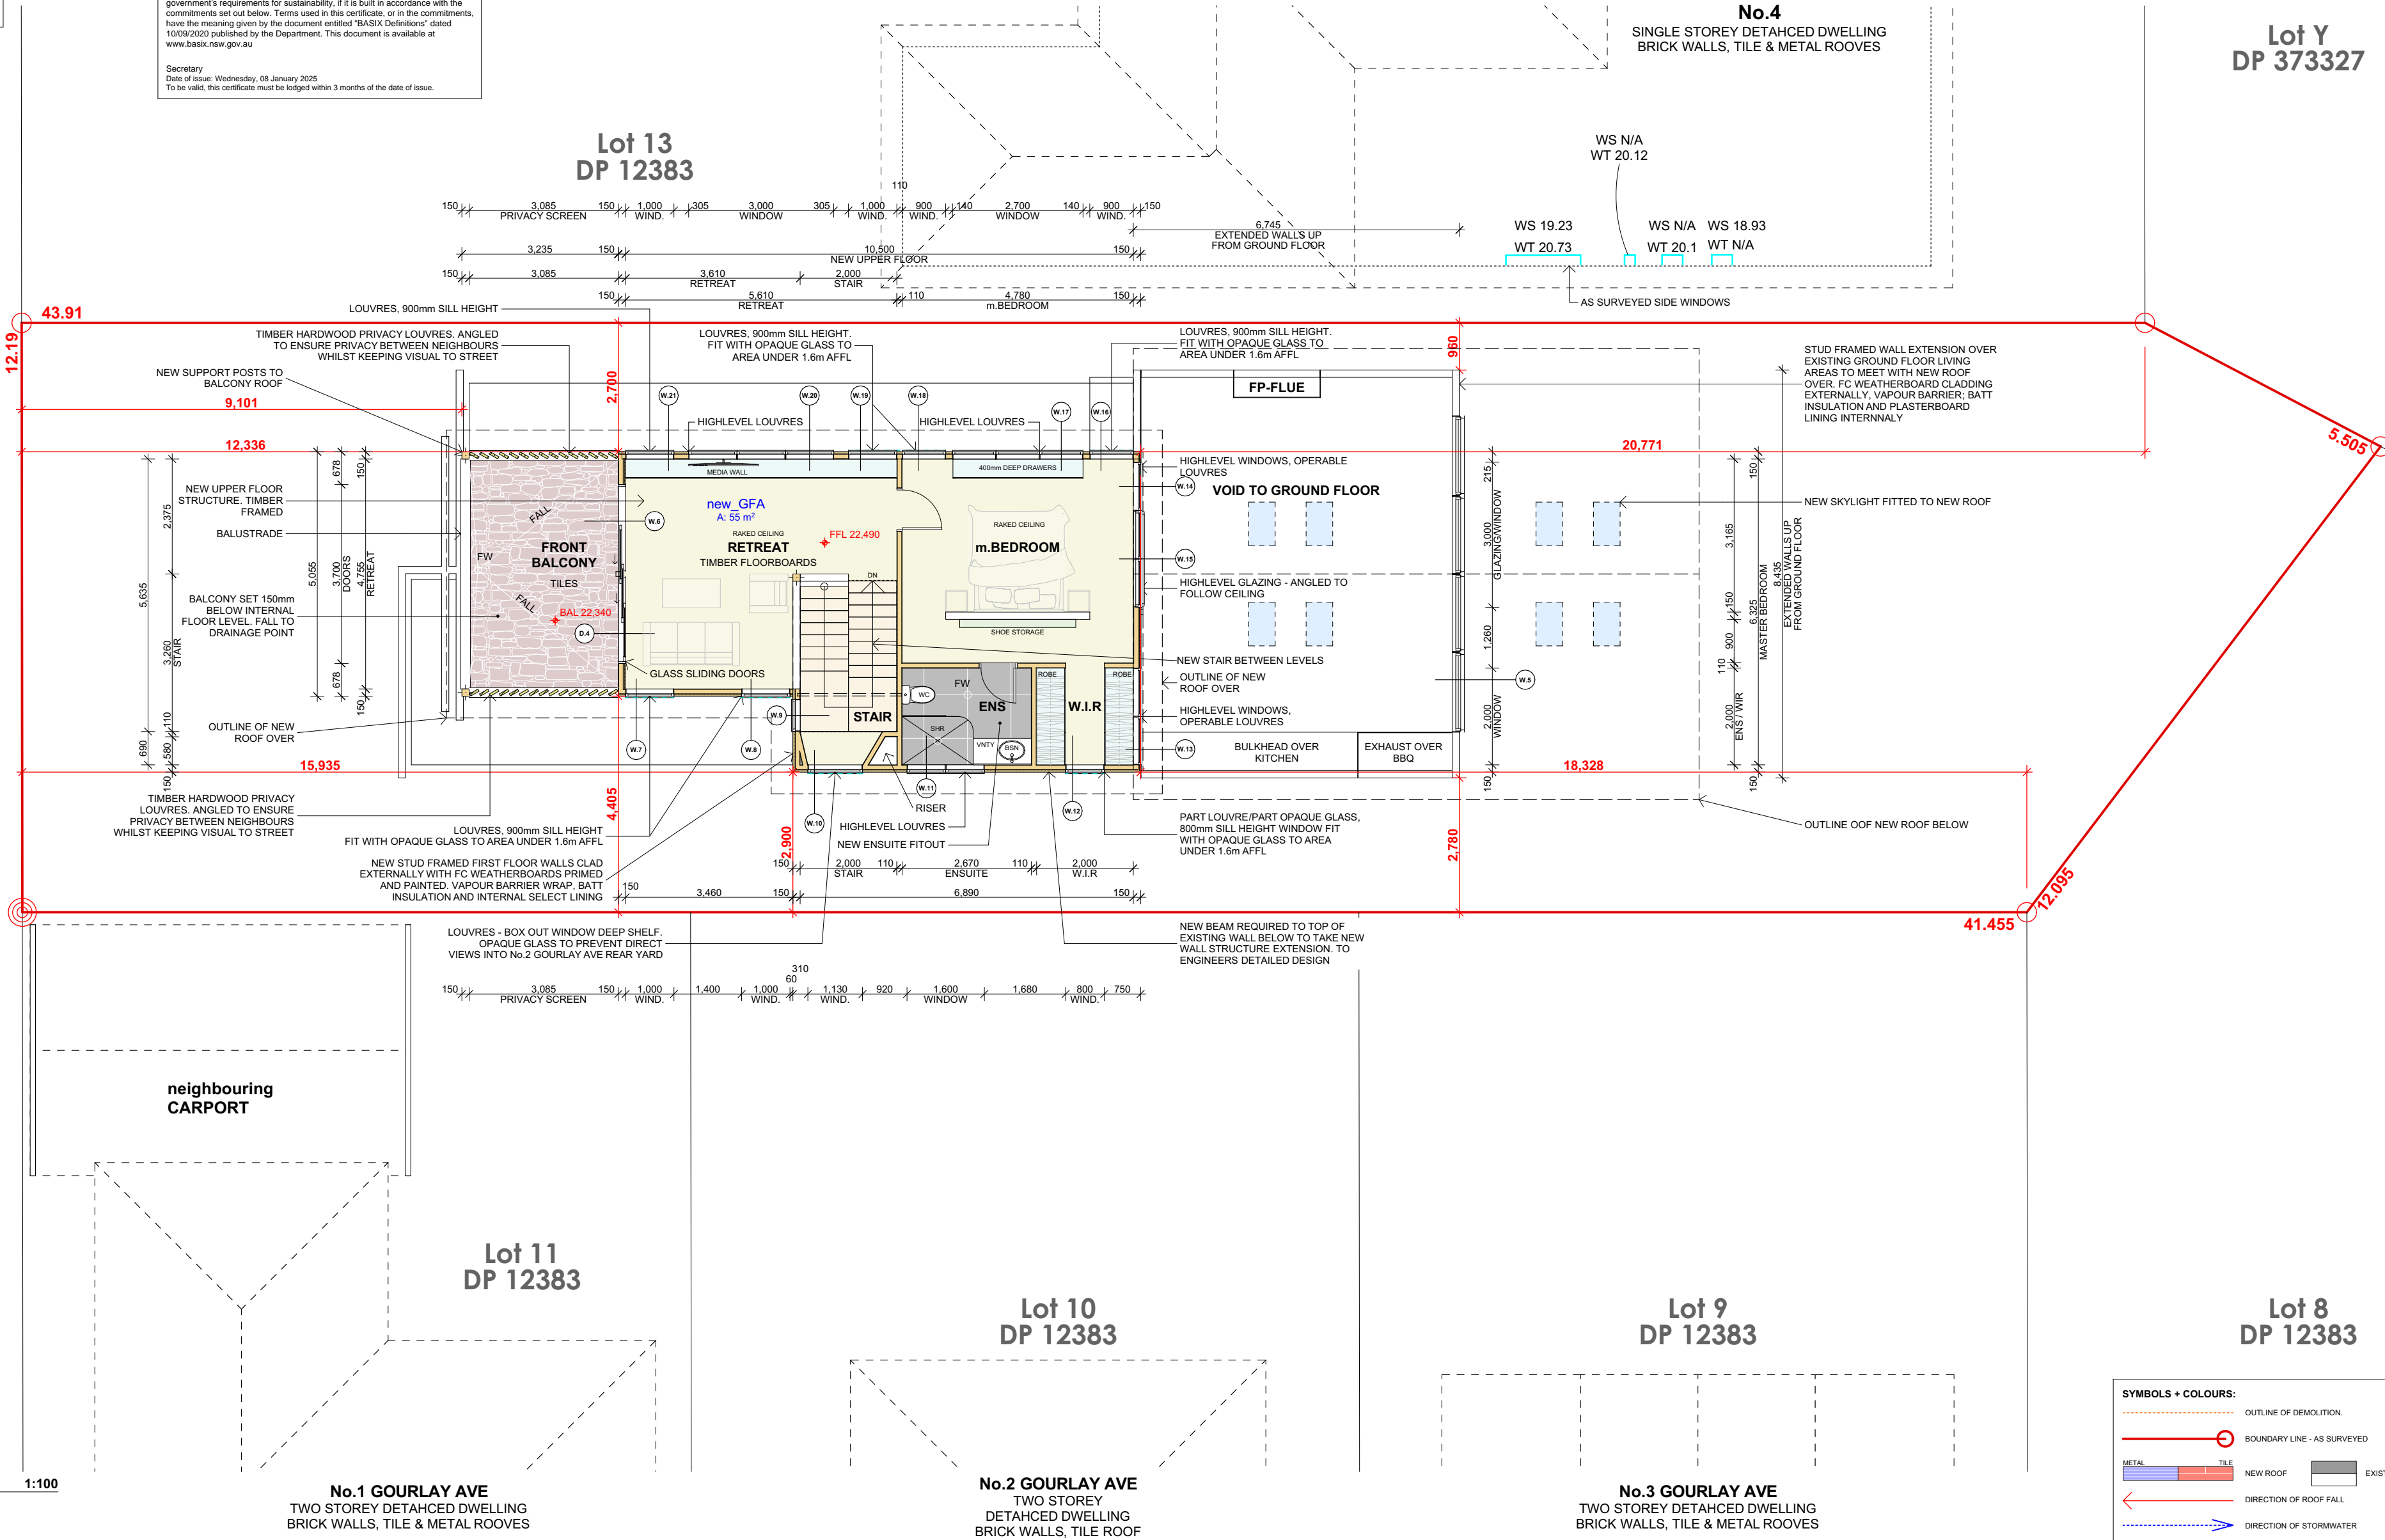
Secretary
Date of issue: Wednesday, 08 January 2025
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Lot 13
DP 12383

Lot Y
DP 373327

NEW STREET EAST

BENCH MARK
NAIL IN KERB
RL 19.87 AHD




3. PROPOSED FIRST FLOOR PLAN 1:100

No.1 GOURLAY AVE
TWO STOREY DETACHED DWELLING
BRICK WALLS, TILE & METAL ROOVES

No.2 GOURLAY AVE
TWO STOREY
DETACHED DWELLING
BRICK WALLS, TILE ROOF

No.3 GOURLAY AVE
TWO STOREY DETACHED DWELLING
BRICK WALLS, TILE & METAL ROOVES

Lot 8
DP 12383

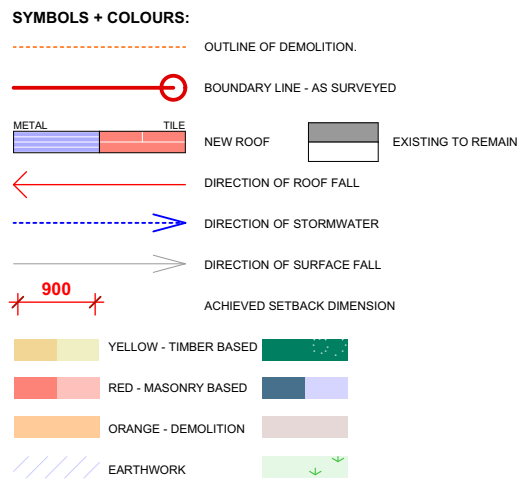

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Designer

HARGROVES DESIGN CONSULTANTS

M: 0410 669 148
E: jacqui@hargroves.com.au

DATE

DEC 2021

TITLE

PROPOSED NEW FIRST FLOOR

PLAN

Sheet No

DA-104

Issue

H

DRAWN R.P.

91.35m² OF NEW ROOF AREA

112.15m² (20.3%) OF DEEP SOIL
LANDSCAPING AREA

REFER TO ENGINEERS STORMWATER
DESIGN TO DRAINAGE AND DISCHARGE
LAYOUT

ALL NEW ROOF AREAS TO HAVE METAL
GUTTERS TO COLLECT WATER RUNOFF
TO UNDERGROUND UPVC PIPE (min.
100dia). ENSURE APPROPRIATELY
DIVERTED TO NEW RAINWATER TANK
and OVERFLOW TO APPROVED
DISCHARGE POINT.
ALL TO ENGINEER'S SPECIFICATION AND
IN ACCORDANCE WITH THE MOST
CURRENT EDITION OF AS3500

STORMWATER FROM RAINWATER TANK
OVERFLOW TO CONNECT TO EXISTING
SITE STORMWATER SYSTEM.
DIVERTED TO EXISTING STREET
DISCHARGE POINT, WHERE LOCATED
ADJACENT TO SITE - ALL TO ENGINEER'S
SPECIFICATION AND DETAILED DESIGN,
AND COUNCIL'S CONDITIONS OF
CONSENT.

NORTHERN and REAR LOW CORNER OF
SITE TO BE FITTED WITH ABSORPTION
TRENCH THAT COLLECTS AND SLOW
RELEASES WATER INTO GARDENS and
ANY EXCESS INTO THE SITE
STORMWATER SYSTEM TO MITIGATE
SURFACE WATER AND PREVENT
NEIGHBOURING SITES BEING
INUNDATED

BUSHFIRE ASSESSMENT BAL-12.5

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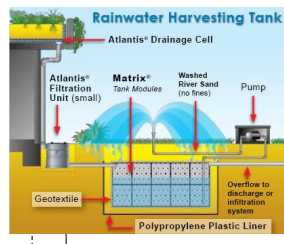
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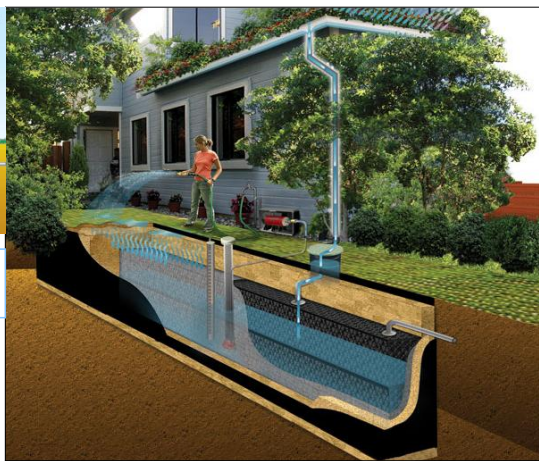
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Alterations and Additions

Certificate number: A1779439




PROPOSED SUBDECK
RAINWATER HARVESTING TO
MEET 2,000L REQUIREMENTS



No.4
SINGLE STOREY DETACHED DWELLING
BRICK WALLS, TILE & METAL ROOVES

Lot 13
DP 12383

Lot Y
DP 373327

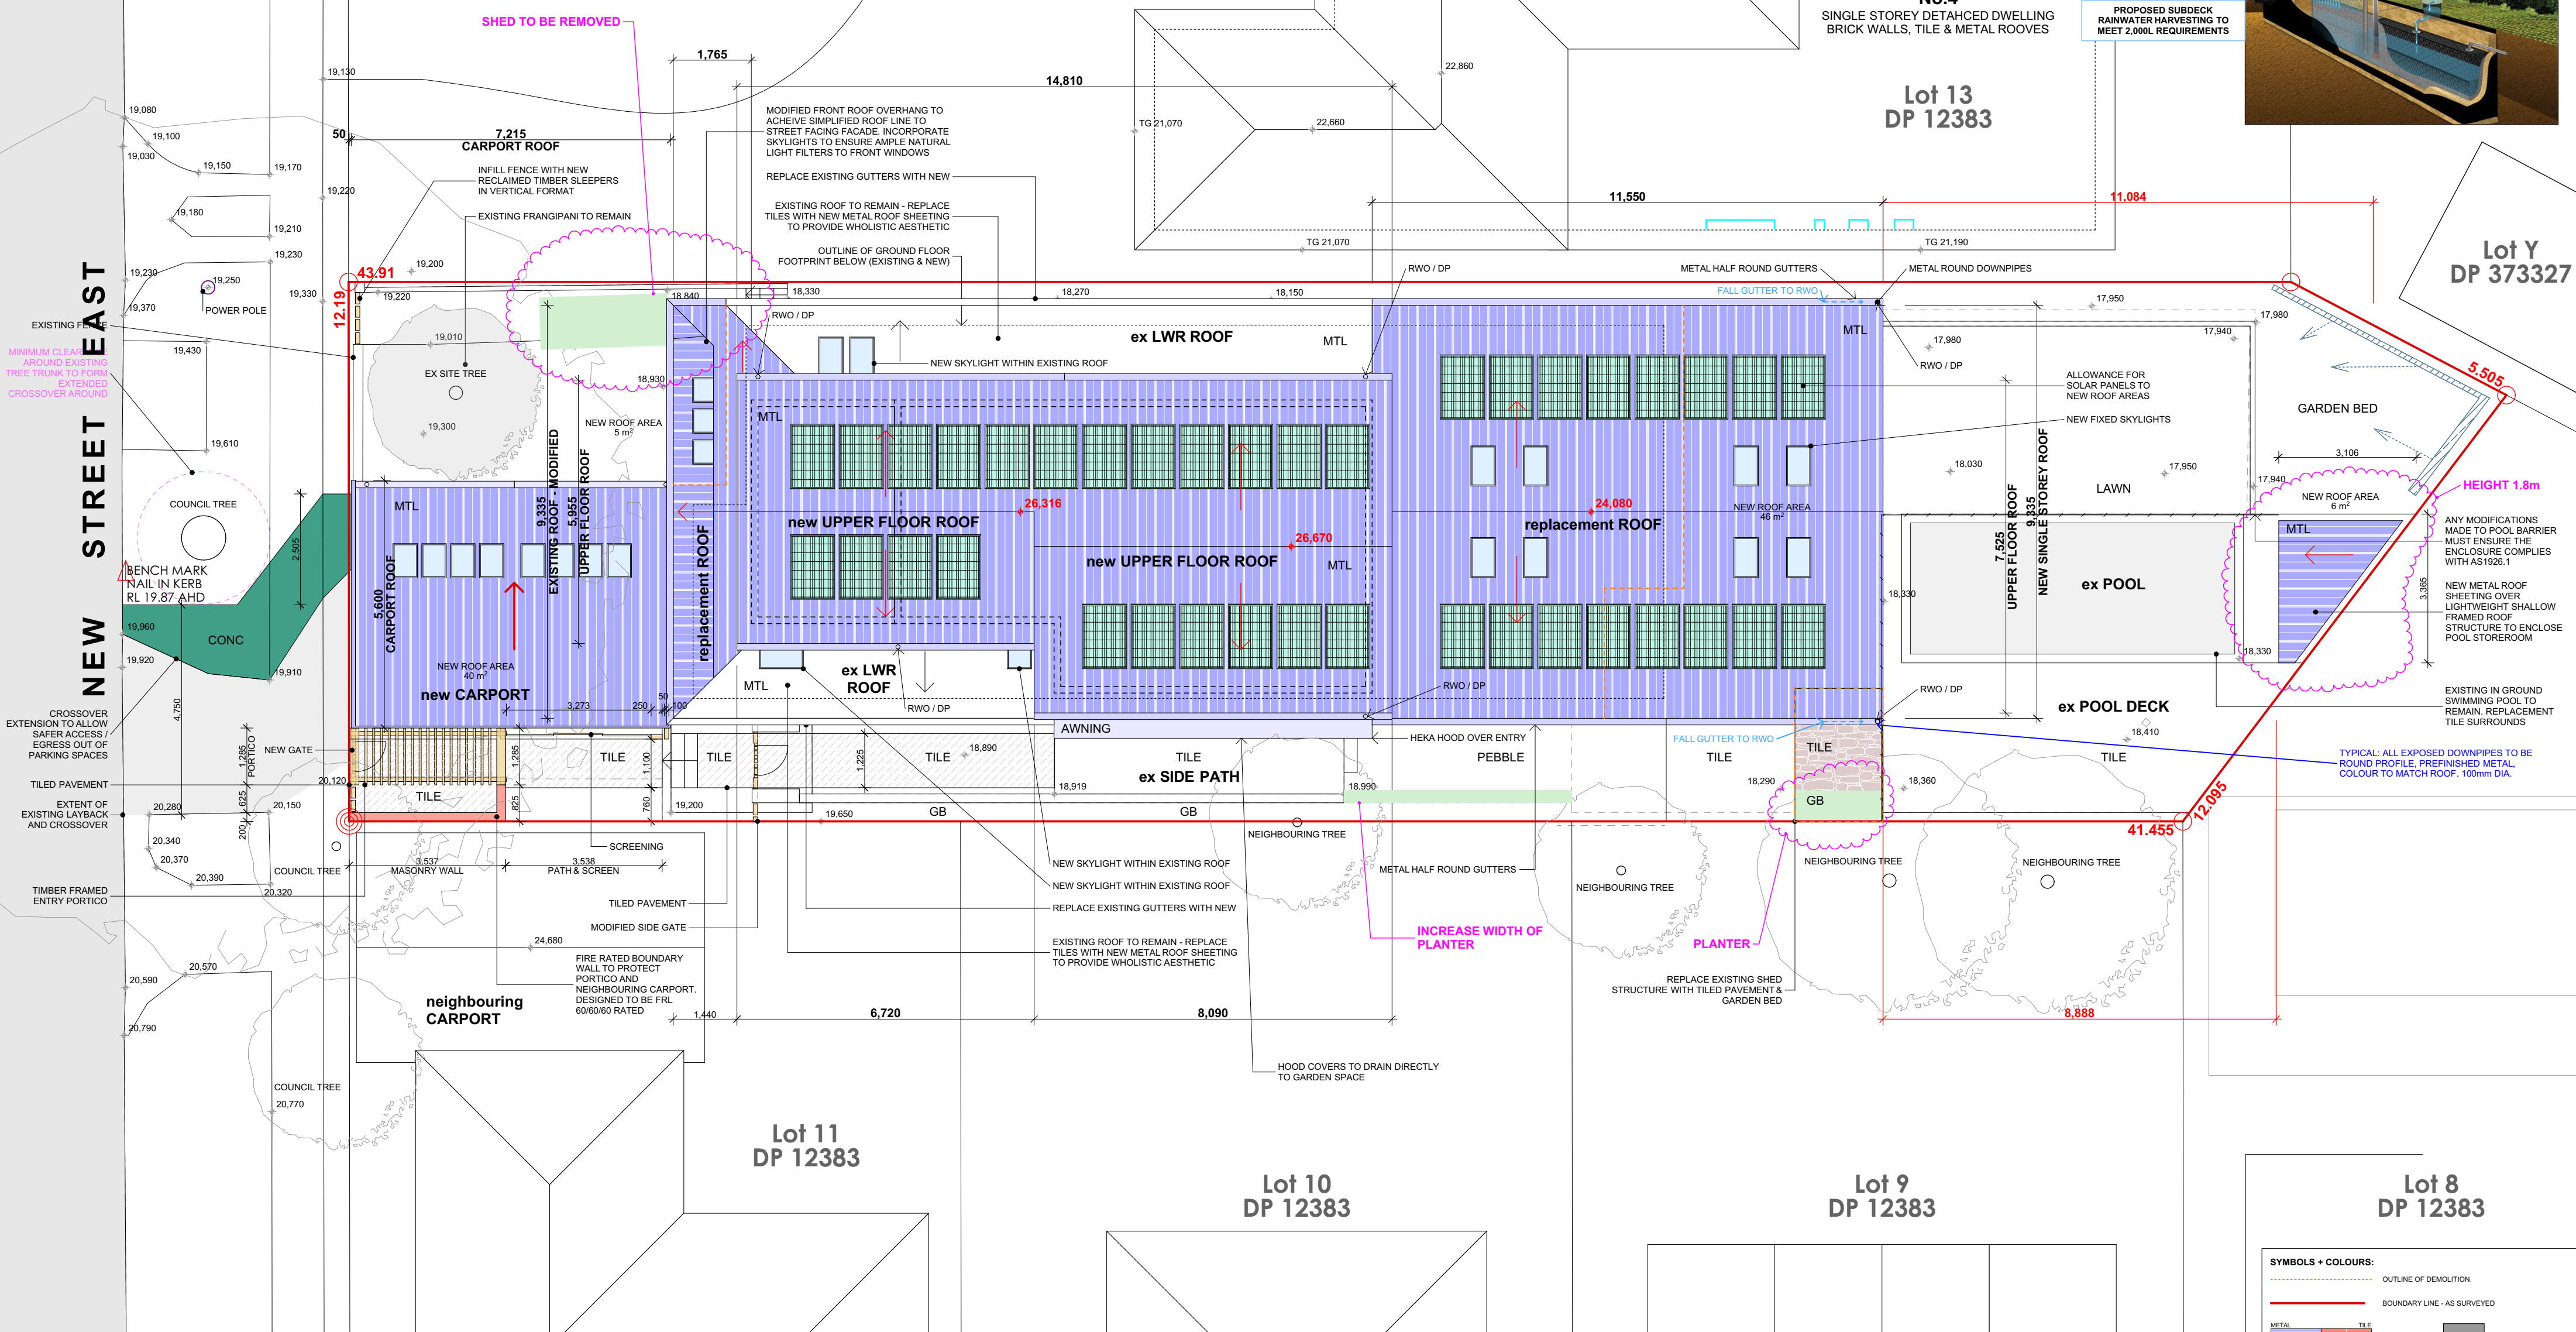


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Lot 8
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PROJECT
ALTERATIONS and ADDITIONS:
- Ground Floor Addition; New First Floor Addition; Internal and External Modifications; Rectifications and Improvements; and Landscape Concept
2 NEW STREET EAST, BALGOWLAH NSW, 2093




CLIENT
M & N DeGARIS

Designer
HARGROVES DESIGN CONSULTANTS
M: 0410 669 148
E: jacqui@hargroves.com.au

DATE
DEC 2021
SCALE
AS NOTED
DRAWN
R.P.

TITLE
**PROPOSED ROOF PLAN incl.
STORMWATER CONCEPT**

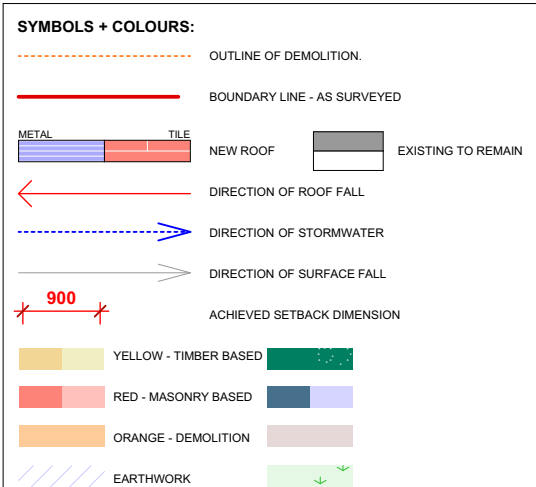Sheet No
DA-106
Issue
J

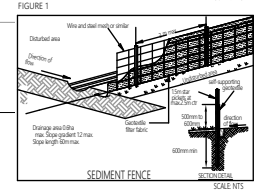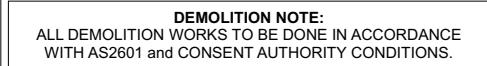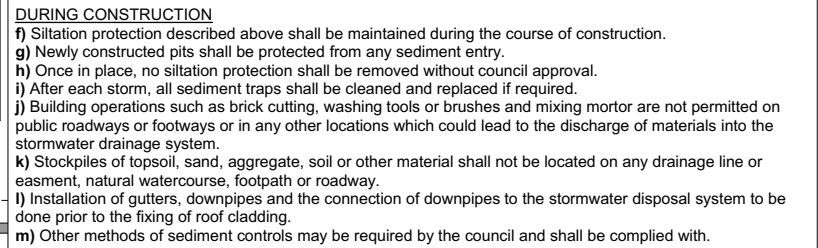

Designer: **HARGROVES DESIGN CONSULTANTS**

M: 0410 669 148
E: jacqui@hargroves.com.au

DATE	OCT 2024	CONSTRUCTION MANAGEMENT PLAN incl. Sediment / Erosion Control	Sheet No	DA-107	Issue	H
SCALE	AS NOTED @ A3					
DRAWN	R.P					

Required construction level

Figure 1. The effect of the number of trials on the number of correct responses. The number of correct responses was significantly higher than the number of incorrect responses for all groups. The number of correct responses was significantly higher than the number of incorrect responses for all groups. The number of correct responses was significantly higher than the number of incorrect responses for all groups.

Alterations and Additions



G	RP	REVISED UPPER FLOOR PROPOSAL FOR CLIENT APPROVAL	20.11.2024						
F	RP	REVISED UPPER FLOOR PROPOSAL FOR CLIENT APPROVAL	15.11.2024						
E	RP	REVISED UPPER FLOOR PROPOSAL FOR CLIENT APPROVAL	14.11.2024						
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ISSUE	BY	DESCRIPTION	DATE	ISSUE	BY	DESCRIPTION	DATE		

DEVELOPMENT APPLICATION
- NOT FOR APPROVALS or CONSTRUCTION

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
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<p>LOT & DP</p> <p>LOT 12; DP 12383</p>	<p>COUNCIL</p> <p>NORTHERN BEACHES COUNCIL</p> <p>MANLY</p>
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ALTERATIONS and ADDITIONS:
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2 NEW STREET EAST, BALGOWLAH NSW, 2093

Designer
HARGROVES DESIGN CONSULTANTS
M: 0410 669 148
E: jacqui@hargroves.com.au

DATE	DEC 2021	TITLE	Sheet No	Issu
SCALE	AS NOTED @ A2	PROPOSED SIDE ELEVATIONS & SECTION	DA-111	J
DDMMYY	01 12 21			

Project address	
Project name	Balgowlah Residence - ALTS & ADDS
Street address	1 NEW STREET EAST - BALGOWLAH 2093
Local Government Area	Northern Beaches Council
Plan type and number	Deposited Plan 12383
Lot number	12
Section number	-
Project type	
Dwelling type	Dwelling house (detached)
Type of alteration and addition	The estimated development cost for my renovation work is \$50,000 or more, and does not include a pool (prior app).
N/A	N/A
Certificate Prepared by	
(please complete before submitting to Council or PCA)	
Name / Company Name:	RP Design Studio
ABN (if applicable):	



Fixtures and systems		
Hot water		
The applicant must install the following hot water system in the development: gas instantaneous.		
Lighting		
The applicant must ensure a minimum of 40% of new or altered light fixtures are fitted with fluorescent, compact fluorescent, or light-emitting-diode (LED) lamps.		
Fixtures		
The applicant must ensure new or altered showerheads have a flow rate no greater than 9 litres per minute or a 3 star water rating.		
The applicant must ensure new or altered toilets have a flow rate no greater than 4 litres per average flush or a minimum 3 star water rating.		
The applicant must ensure new or altered taps have a flow rate no greater than 9 litres per minute or minimum 3 star water rating.		
Construction		
Insulation requirements		
The applicant must construct the new or altered construction (floor(s), walls, and ceiling(s)) in accordance with the specifications listed in the table below, except that a) additional insulation is not required where the area of new construction is less than 2m ² , b) insulation specified is not required for parts of altered construction where insulation already exists.		
Construction	Additional insulation required (R-value)	Other specifications
floor above existing dwelling or building	nil	N/A
external wall: brick veneer	R1.16 (or R1.70 including construction)	
external wall: framed (weatherboard, fibre, metal clad)	R1.30 (or R1.70 including construction)	
raked ceiling, pitched/skillion roof: framed	ceiling: R2.50 (sp), roof: foil/sarking	medium (solar absorbance 0.475 - 0.70)

Glazing requirements						
Windows and glazed doors glazing requirements						
Window/door number	Orientation	Area of glass including frame (m ²)	Overshadowing height (m)	Overshadowing distance (m)	Shading device	Frame and glass type
D.3	N	15.7	0	0	eave/ verandah/ pergola/balcony >=450 mm	standard aluminium, single clear, (or U-value: 7.63, SHGC: 0.75)
W.5	N	7.58	0	0	eave/ verandah/ pergola/balcony >=450 mm	standard aluminium, single clear, (or U-value: 7.63, SHGC: 0.75)
W.13	N	1.2	0	0	eave/ verandah/ pergola/balcony >=450 mm	standard aluminium, single pyrolytic low-e, (U-value: 5.7, SHGC: 0.47)
W.14	N	1.8	0	0	eave/ verandah/ pergola/balcony >=450 mm	standard aluminium, single pyrolytic low-e, (U-value: 5.7, SHGC: 0.47)
W.15	N	1.51	0	0	eave/ verandah/ pergola/balcony >=450 mm	standard aluminium, single pyrolytic low-e, (U-value: 5.7, SHGC: 0.47)

D.1	E	2.31	0	0	eave/ verandah/ pergola/balcony >=450 mm	standard aluminium, single clear, (or U-value: 7.63, SHGC: 0.75)
W.3	E	2.23	0	0	eave/ verandah/ pergola/balcony >=450 mm	standard aluminium, single pyrolytic low-e, (U-value: 5.7, SHGC: 0.47)
W.4	E	1.63	0	0	eave/ verandah/ pergola/balcony >=450 mm	standard aluminium, single clear, (or U-value: 7.63, SHGC: 0.75)
W.7	E	1.5	0	0	eave/ verandah/ pergola/balcony >=450 mm	standard aluminium, single pyrolytic low-e, (U-value: 5.7, SHGC: 0.47)
W.8	E	1.5	0	0	eave/ verandah/ pergola/balcony >=450 mm	standard aluminium, single pyrolytic low-e, (U-value: 5.7, SHGC: 0.47)
W.2	S	1.2	0	0	eave/ verandah/ pergola/balcony >=450 mm	standard aluminium, single clear, (or U-value: 7.63, SHGC: 0.75)
W.6	S	1.96	0	0	eave/ verandah/ pergola/balcony >=450 mm	standard aluminium, single clear, (or U-value: 7.63, SHGC: 0.75)
W.9	S	0.44	0	0	eave/ verandah/ pergola/balcony >=450 mm	standard aluminium, single clear, (or U-value: 7.63, SHGC: 0.75)

D.2	W	1.72	0	0	eave/ verandah/ pergola/balcony >=450 mm	aluminium, single Lo-Ton low-e, (U-value: 5.6, SHGC: 0.36)
W.16	W	1.35	0	0	eave/ verandah/ pergola/balcony >=450 mm	aluminium, single Lo-Ton low-e, (U-value: 5.6, SHGC: 0.36)
W.17	W	1.62	0	0	eave/ verandah/ pergola/balcony >=450 mm	aluminium, single Lo-Ton low-e, (U-value: 5.6, SHGC: 0.36)
W.18	W	1.35	0	0	eave/ verandah/ pergola/balcony >=450 mm	aluminium, single Lo-Ton low-e, (U-value: 5.6, SHGC: 0.36)
W.19	W	1.5	0	0	eave/ verandah/ pergola/balcony >=450 mm	aluminium, single Lo-Ton low-e, (U-value: 5.6, SHGC: 0.36)
W.20	W	1.8	0	0	eave/ verandah/ pergola/balcony >=450 mm	aluminium, single Lo-Ton low-e, (U-value: 5.6, SHGC: 0.36)
W.21	W	1.5	0	0	eave/ verandah/ pergola/balcony >=450 mm	aluminium, single Lo-Ton low-e, (U-value: 5.6, SHGC: 0.36)

Glazing requirements			
Skylights			
The applicant must install the skylights in accordance with the specifications listed in the table below.			
The following requirements must also be satisfied in relation to each skylight:			
Each skylight may either match the description, or, have a U-value and a Solar Heat Gain Coefficient (SHGC) no greater than that listed in the table below.			
External awnings and louvers must fully shade the skylight above which they are situated when fully drawn or closed.			
Skylights glazing requirements			
Skylight number	Area of glazing inc. frame (m ²)	Shading device	Frame and glass type
S1	1.08	external adjustable awning or blind	aluminium, moulded plastic single clear, (or U-value: 6.21, SHGC: 0.808)
S2	0.54	external adjustable awning or blind	aluminium, moulded plastic single clear, (or U-value: 6.21, SHGC: 0.808)
S3	0.3	no shading	aluminium, moulded plastic single clear, (or U-value: 6.21, SHGC: 0.808)
S4	1.08	external adjustable awning or blind	aluminium, moulded plastic single clear, (or U-value: 6.21, SHGC: 0.808)
S5	1.08	external adjustable awning or blind	aluminium, moulded plastic single clear, (or U-value: 6.21, SHGC: 0.808)

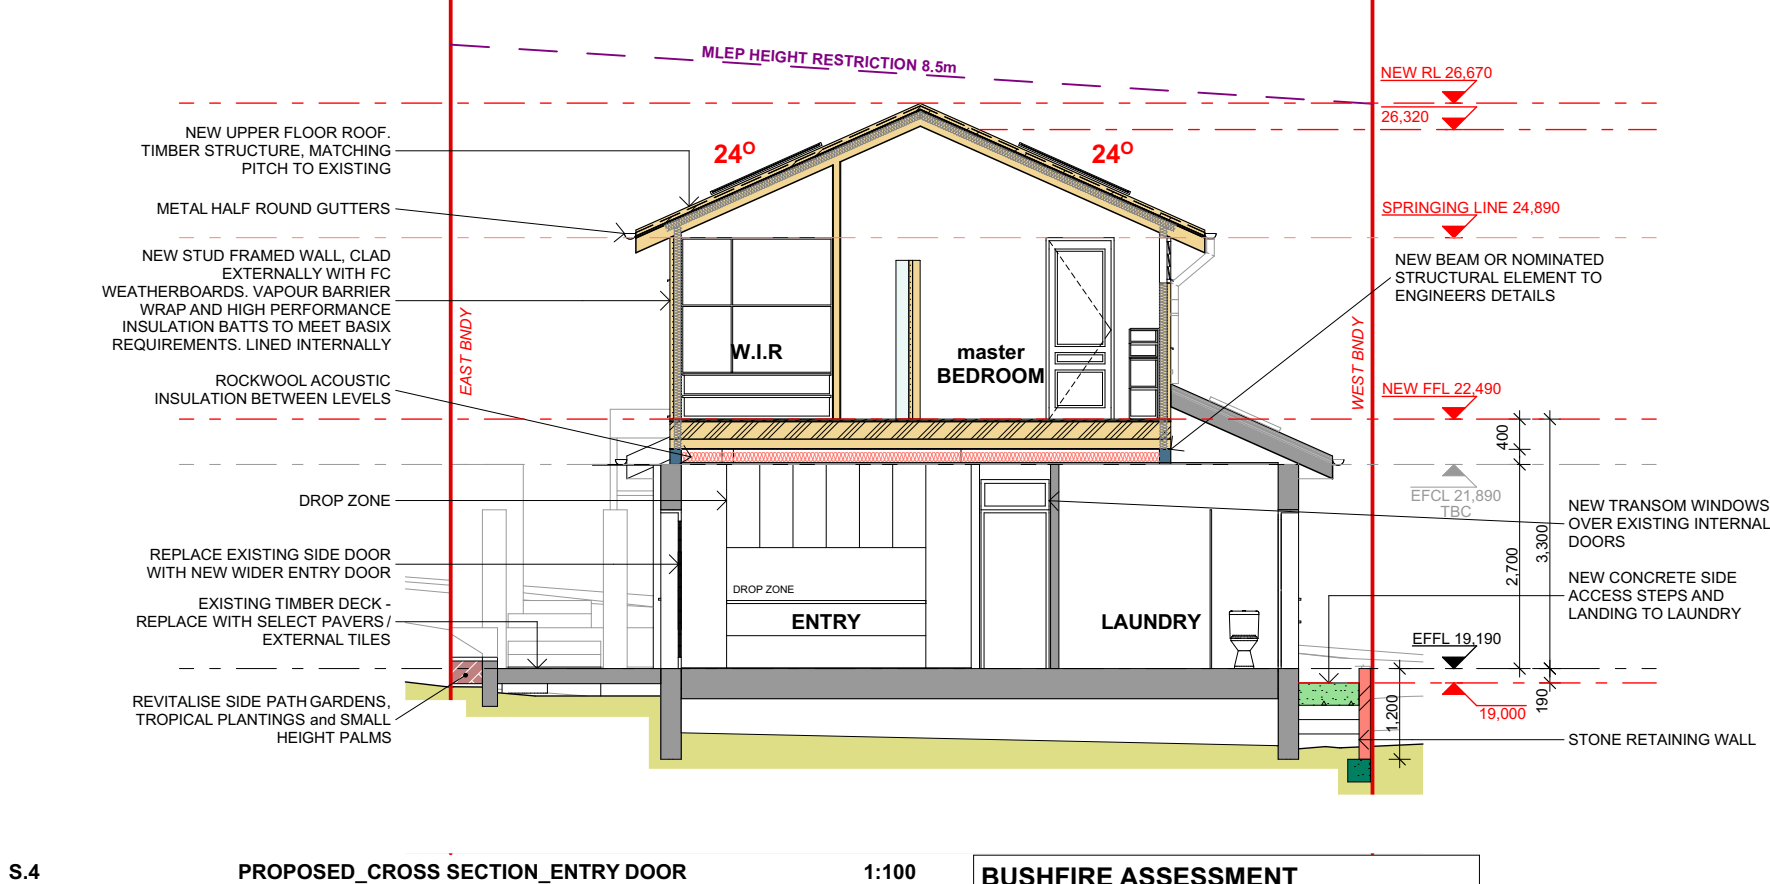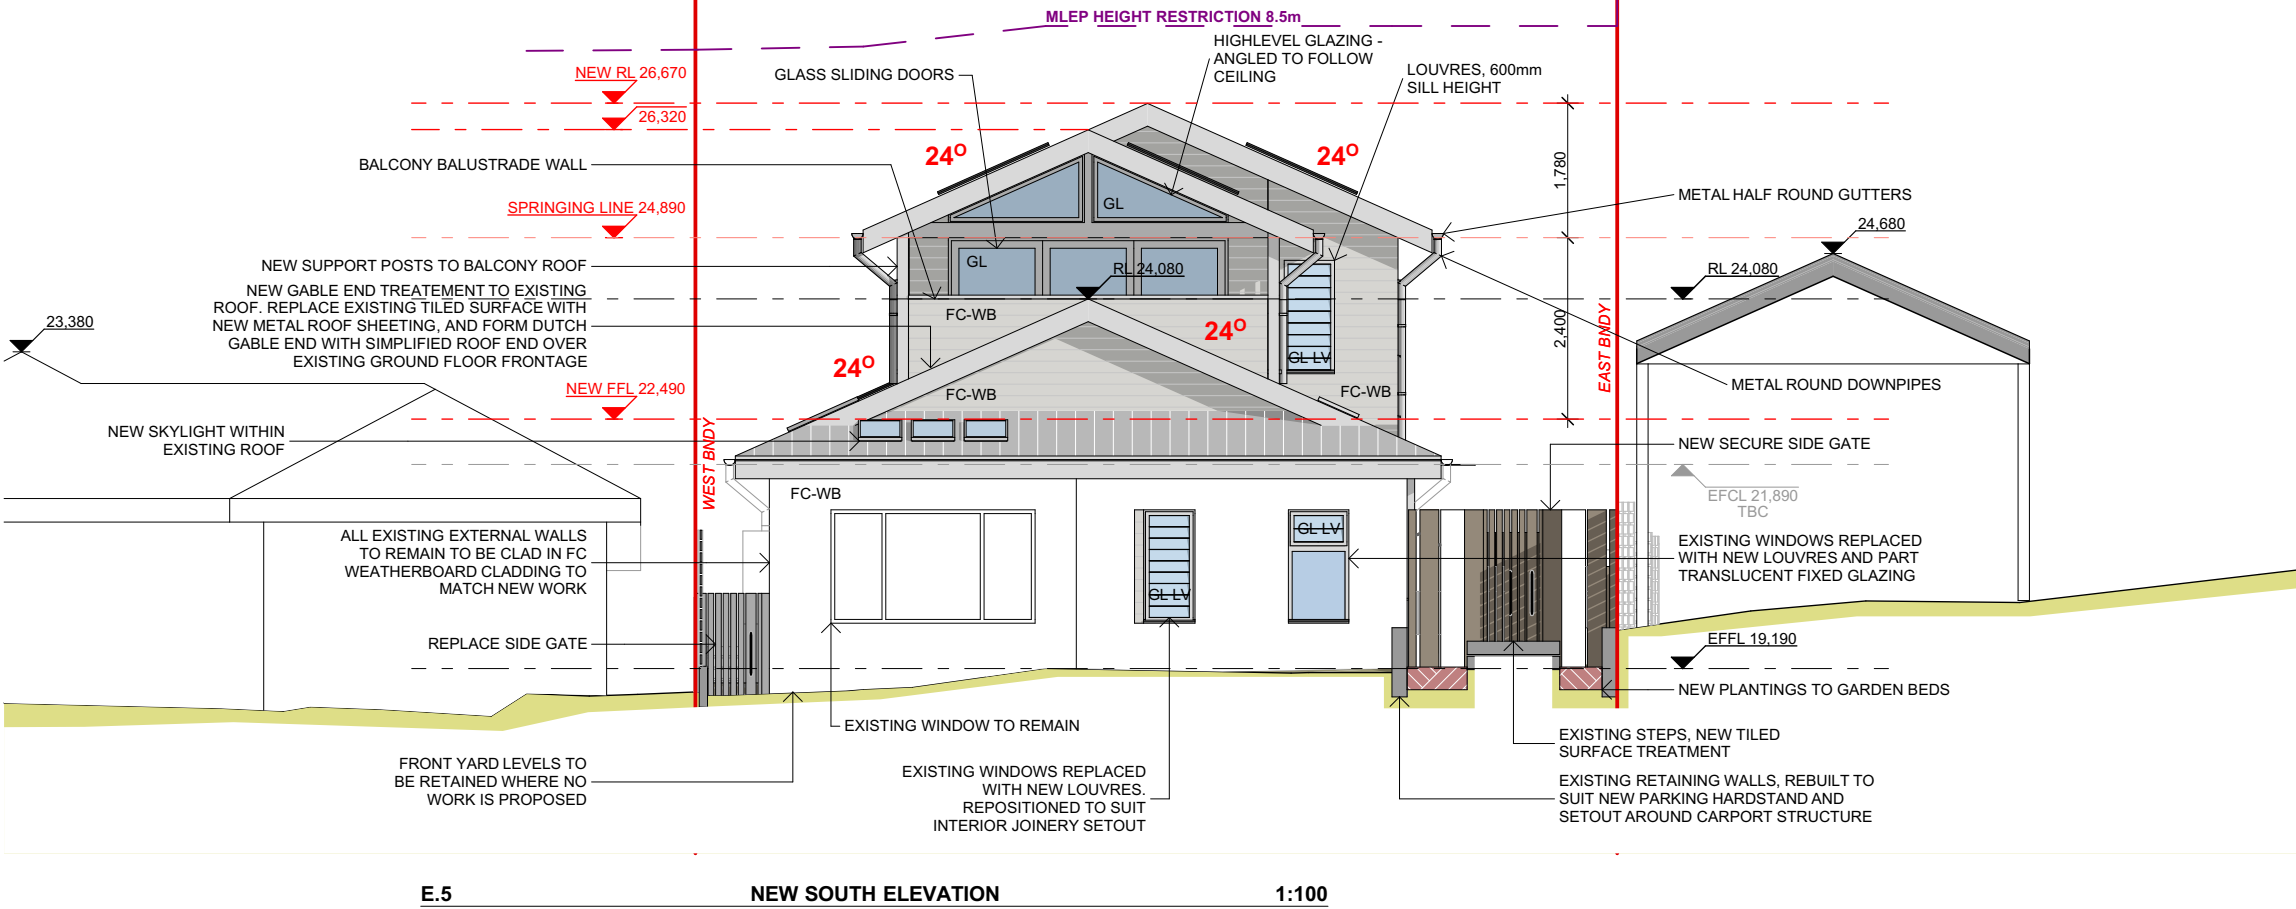



**BUSHFIRE ASSESSMENT
BAL-12.5**

Required construction level

The Highest Bushfire Attack Level to the proposed new works was determined to be BAL 12.5 from the eastern aspect. The proposed new works are required to comply with section 3 and 5 BAL 12.5 of AS 3959 - 2018 Construction of buildings in bushfire prone areas or the NSW Standard National Standard Steel Framed Construction in Bushfire Areas 2021 as appropriate for BAL 12.5 construction.

The additional construction requirements detailed within section 7.5.2 of PRP 2019 are also applicable.

Note: Certain provisions of AS 3959 are varied in NSW based on the findings of the Victorian Bush Fires Royal Commission and bush industry research. PRP 2019 section 7.5.2 provides a NSW State Variation that BAL 12.5 decks and subfloor areas are constructed to section 7.7 BAL 29 requirements except that any wall enclosing the subfloor space need only comply with the wall requirements for BAL 12.5.

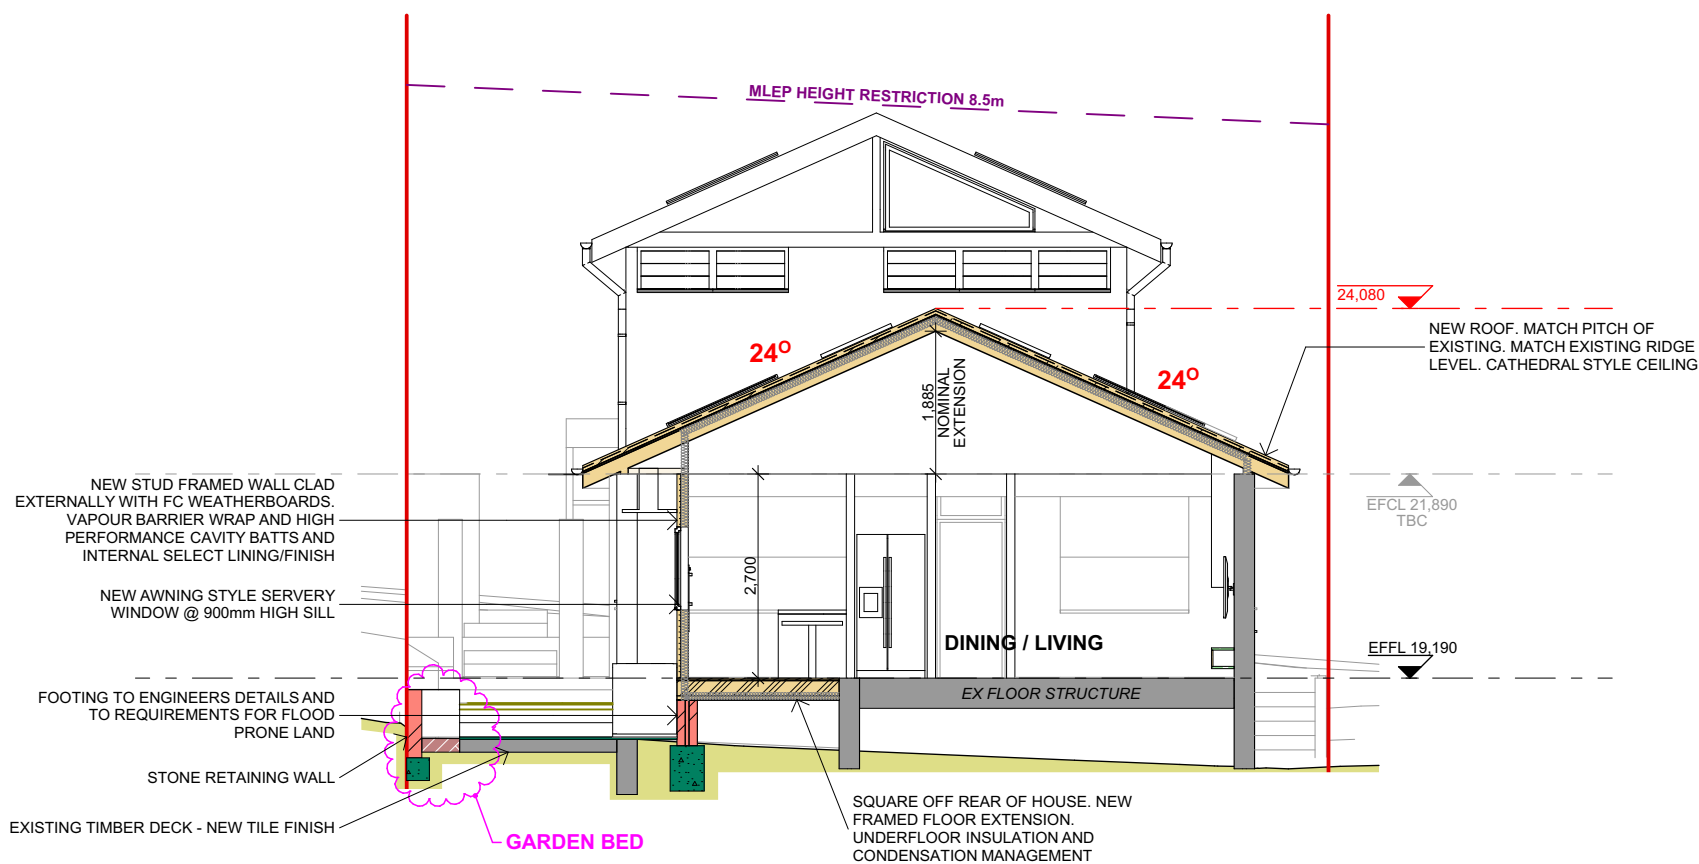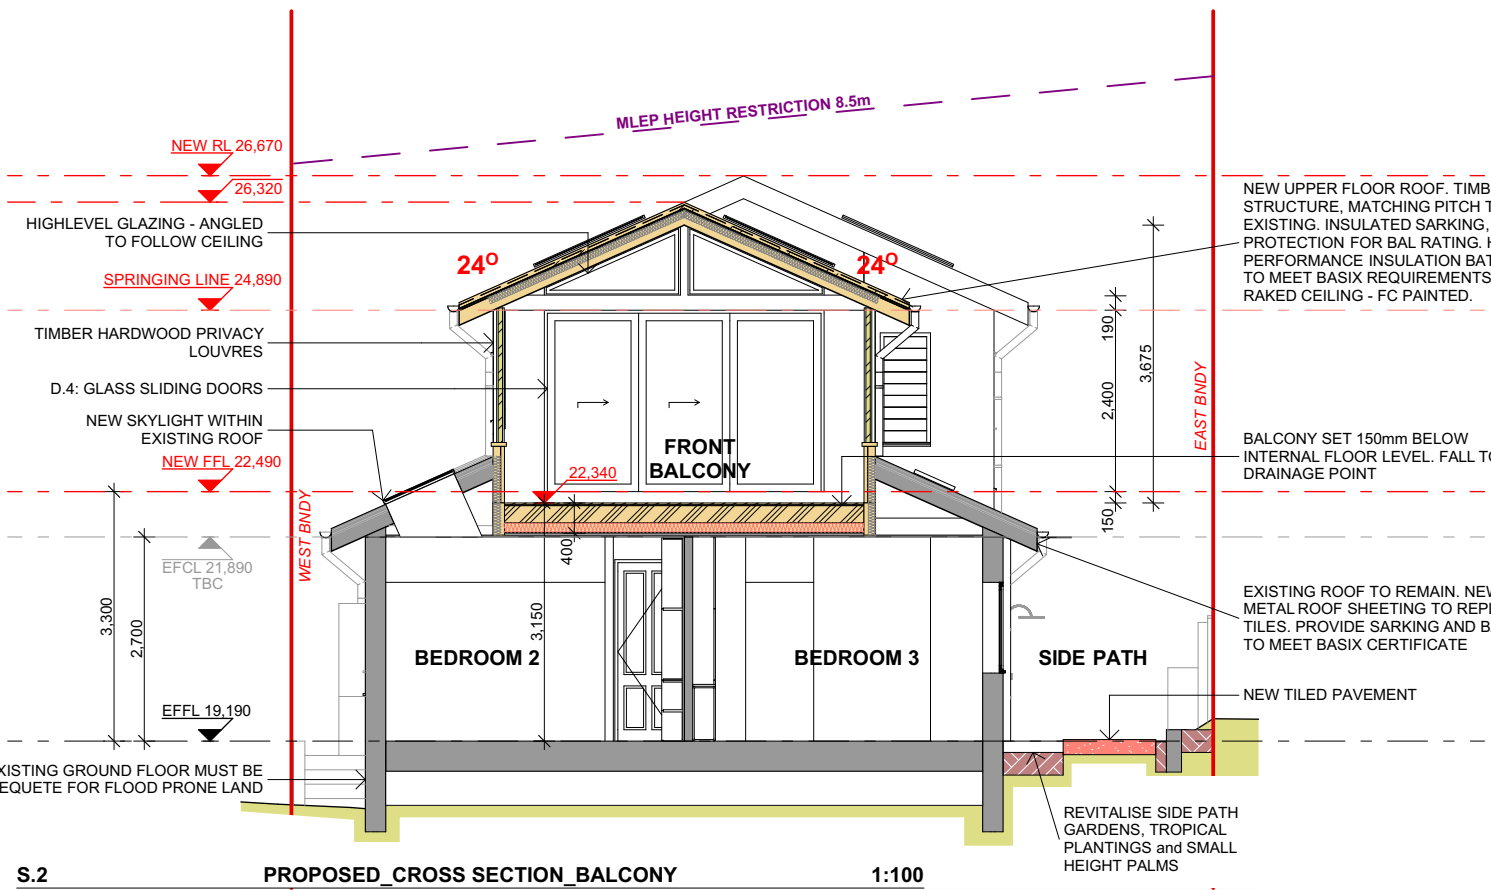

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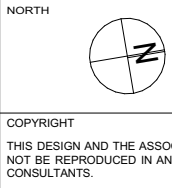
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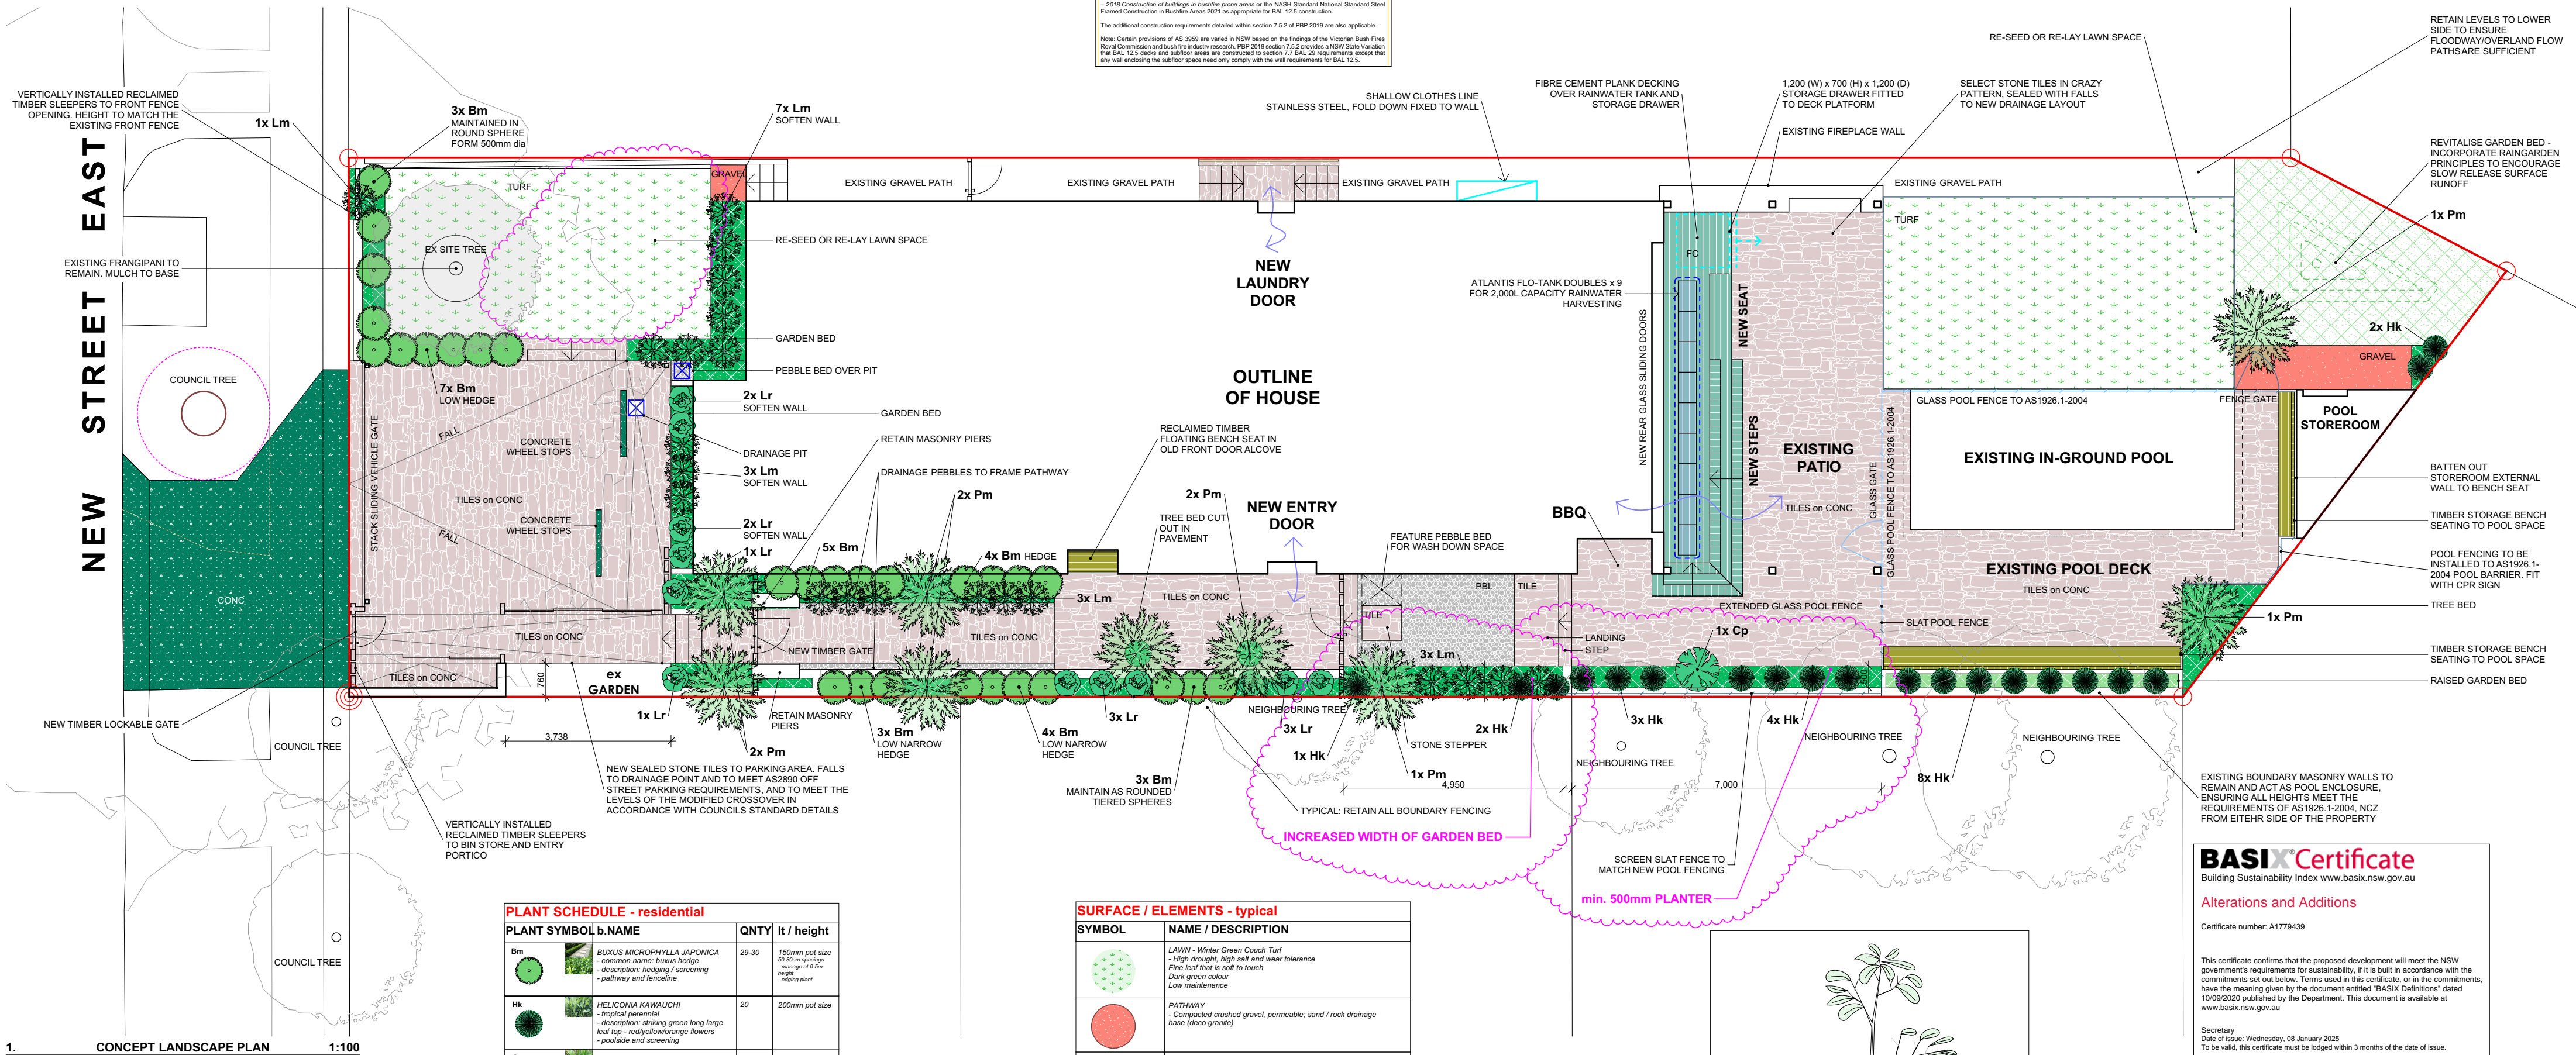








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





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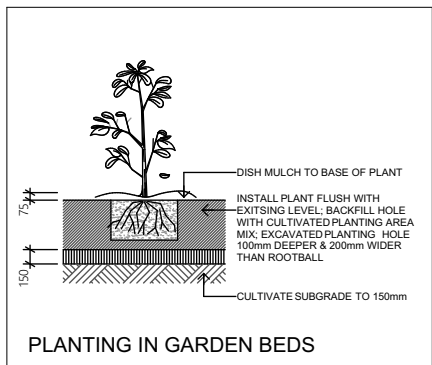
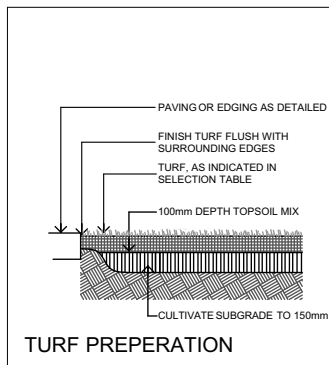
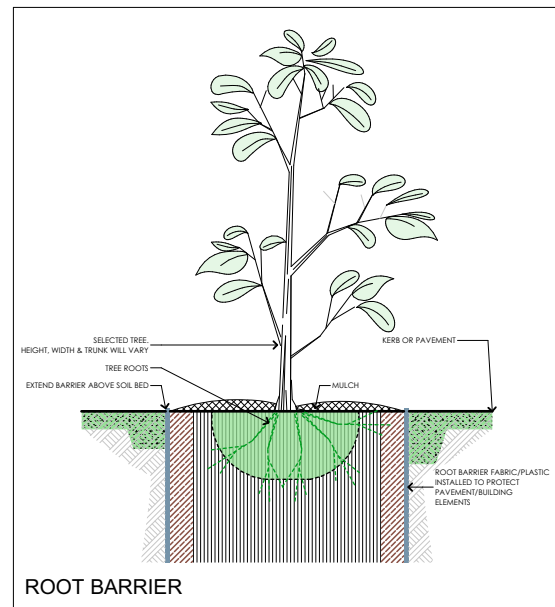
DESIGNER HARGROVES DESIGN CONSULTANTS		M: 0410 669 148 E: jacqui@hargroves.com.au	
DATE	DEC 2021	TITLE	PROPOSED SOUTH ELEVATION, CROSS SECTIONS & BASIX
SCALE	AS NOTED @ A2		
DRAWN	R.P.		
Sheet No	DA-112	Issue	J

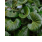

PLANT SCHEDULE - residential			
PLANT SYMBOL	b.NAME	QNTY	It / height
Bm	 BUXUS MICROPHYLLA JAPONICA common name: <i>buxus hedge</i> -description: <i>hedging / screening</i> -pathway and fence line	29-30	150mm pot size 50-60cm screenings -average at 1.5m height -edging plant
Hk	 HELICONIA KAWAUCHI - tropical perennial -description: <i>striking green long large leaf top - red/yellow/orange flowers</i> -pooldside and screening	20	200mm pot size
Cp	 CYCAS PALM , small variety -description: <i>ornamental tropical plant</i> -pooldside	1	200mm pot size
Lm	 LIRIOPE MUSCARI -common name: <i>just right Liriope</i> -description: <i>native strappy leaf grass</i> -fence line and pooldside	20	200mm pot size
Lr	 LIGULARIA REINFORMIS -common name: <i>tractor seat plants</i> -description: <i>ornamental leaf plant</i> -feature garden and pathway	10	14mm pot size
Pp	 CUNNINGHAMIA -common name: <i>banglow palm</i> -description: <i>slow growing, slender trunk</i> -entry framing	9	300mm pot size

NOTES:
1. All tree stock to be sourced in accordance with tests and measurements contained within AS2303-2015 – Tree Stock for Landscape Use.

SURFACE / ELEMENTS - typical	
SYMBOL	NAME / DESCRIPTION
	LAWN - Winter Green Couch Turf - High drought, high salt and wear tolerance - Fine leaf that is soft to touch Dark green colour Low maintenance
	PATHWAY - Compacted crushed gravel, permeable; sand / rock drainage base (sicc granite)
	PLANTING AREA, MULCH TO TREE BASE AND EXISTING PLANTS, APPROPRIATE FOR HEALTHY GROWTH. - Topsoil, planting mixture & pebble or mulch topping as required - permeable
	DECKING STEPS AND LANDING OVER RAINWATER TANK - WITH STORAGE DRAWER - James HARDIE - Fibre Cement Plank in White
	EDGING TREATMENT - metal / corten shapacore edging with stakes
	TILES / PAVERS - Stone - sealed - in crazy pattern



BASIX[®] Certificate
Building Sustainability Index www.basix.nsw.gov.au

Alterations and Additions

Certificate number: A1779439

This certificate confirms that the proposed development will meet the NSW government's requirements for sustainability, if it is built in accordance with the commitments set out below. Terms used in this certificate, or in the commitments have the meaning given by the document entitled "BASIX Definitions" dated 10/09/2020 published by the Department. This document is available at www.basix.nsw.gov.au

Secretary
Date of issue: Wednesday, 08 January 2025
To be valid, this certificate must be lodged within 3 months of the date of issue

CONCEPT PLAN FOR DEVELOPMENT APPLICATION

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LOT & DF	Sum of Squares	Mean Square	F	Pr > F	R-Square	Adj R-Square
Model	10.000	1.000	1.00	0.375	0.500	0.400
Error	10.000	0.500				
Total	20.000					
Corrected Total	10.000					

LOT 12; DP 12383

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2 NEW STREET EAST, **BALGOWLAH NSW, 2093**

CLIENT
M & N DeGARIS

Designer

HARG

DATE	DEC 202
SCALE	AS NOTE @ 42

Designer
HARGROVES DESIGN CONSULTANTS

E: jacqui@hargroves.com.au

DATE	DEC 2021	TITLE	Sheet No
SCALE	AS NOTED @ 1/2"	CONCEPT LANDSCAPE PLAN	DA-113

REFERENCES

STANTS

0410 669 148

roves.com.au

Sheet No DA-113