# **WASTE MANAGEMENT REPORT**

**Demolition, Construction and Operational Waste Assessment** 

Site Address

22-24 Raglan Street, MANLY

Client

**Lighthouse Project Group** 

Proposed Development

**Proposed Shop Top Housing** 

Date

27/10/2025

Reference

25100485



### **DOCUMENT CONTROL**

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### INTRODUCTION

This Site Waste Minimisation and Management Plan (SWMMP) Report has been prepared on behalf of para-Ere Holdings Pty Ltd Care of Lighthouse Project Group and should be read in conjunction with the plans encompassing Job No. 25-02 prepared by Carlisle Architects.

This development application is prepared an amendment to an existing Development Consent (DA2022/2256 - Alterations and Additions with change of use [shop top housing]) to allow for the provision of affordable housing.

The report summarises the waste minimisation and management practices intended to be implemented as part of the construction of a multi-storey shop top housing development and its operational use.

#### 1.1 **SUMMARY**

The proposal is for a redevelopment of the site comprising the demolition of an existing building and the subsequent erection of a multi storey shop top housing building, above a common basement level, being an eight storey building presenting to Raglan Street containing fifteen apartments.

All vehicular access into the development is provided via a driveway towards the south eastern end of the Raglan Street frontage, which provides access to the basement car parking level. The basement level will accommodate 21 car spaces, garbage room, storage and plant. The basement will be accessed from all levels of the building via a lift or staircase.

The development also proposes associated garbage storage areas at ground floor with collection at ground level from a designated kerbside loading area.

This report is an outline of the waste minimisation and management policies and procedures to be implemented by contractors during the construction phase and the property manager/owners corporation during the post construction (operational phase) of the development.

These policies and procedures will set a framework for all parties to minimise generation of residual (non-recyclable) waste, and to take advantage of the opportunities for re-use of waste materials by ensuring that efficient recovery and segregation measures for all waste materials are provided.

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## 2 SITE CHARACTERISTICS

### 2.1 SITE DESCRIPTION

The site is identified legally as Lot 100 of Deposited Plan 1009880. It is commonly known as 22-24 Raglan Street, Manly. The subject site has an area of 712.96  $m^2$ .

Please refer to the below aerial image.



Figure 1 - Aerial Image

#### 2.2 SITE ANALYSIS

The site is located within a well established area with largely residential developments. There is existing commercial/residential development on the site with associated light infrastructure.

The subject site has a road frontage to Raglan Street with this frontage to be used for general service vehicle access. .

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### 3 DESCRIPTION OF PROPOSAL

### 3.1 PROPOSED DEVELOPMENT

The proposed development includes the site clearing, excavation and the construction of a multi-storey residential flat building and ancillary site works.

The proposed building will include the following:

- Parking over ground floor and basement level;
- One building with a total of one building cores;
- Lift motor, plant, service and garbage rooms;
- Ground floor commercial tenancy; and
- Eight upper levels consisting of a total of 15 units

### 3.2 SITE ACCESS

The subject site has frontages to Raglan Street. Vehicular access to the site is via a shared driveway on the southern edge of the site, adjacent to Raglan Street.

#### 3.3 SITE SERVICES

The site has access to all necessary essential services including water, sewer, electricity and telecommunications.

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## **PURPOSE OF THE REPORT**

#### 4.1 **AIMS**

The aim of the SWMMP is to outline measures to minimise and manage waste and resource recovery during the construction phase and the post construction (operational) phase.

The goal of this document is in line with the DCP as well as the waste hierarchy (avoid, reduce, reuse, recycle, recover (energy), treat and dispose), shown in Figure 2, and aims to:

- Minimise the amount of waste generated;
- Maximise the reuse, recycling and reprocessing of construction waste materials; and
- Minimise the volume of material disposed to landfill.

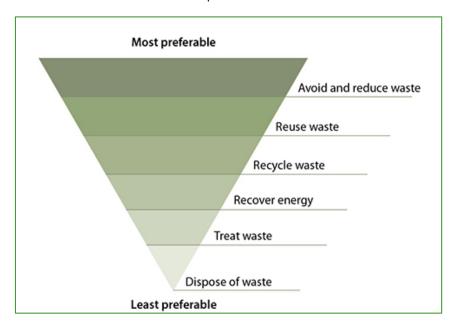


Figure 2 - Waste Heirarchy

The SWMMP will describe;

- Volume and type of waste and recyclables to be generated
- Storage and treatment of waste and recyclables on the development site
- Disposal of residual wastes and reprocessing options for recyclables
- Procedures for post construction (operational) management after handover of the development

#### 4.2 **OBJECTIVES**

The objective of the SWMMP is to provide a planning system to effectively manage waste and resource recovery associated with this development, including;

- Promote improved project management
- Minimise waste generation
- Maximise reuse and resource recovery
- Minimise the environmental impacts associated with residual waste generated by this development
- Ensure the appropriate storage and collection of residual waste

To ensure ongoing waste management systems are compatible with collection services offered by commercial waste transporters and the Northern Beaches Council.

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### 4.3 LEGISLATIVE DRIVERS

Table 1 - Environmental Legislation specific to waste management

Legislation/Guidelines	Description
Protection of the Environment Operations Act 1997	This Act is the primary NSW environment protection legislation covering air, noise, water, land and waste management
Waste Avoidance and Resource Recovery Act 2001	Sets NSW framework for waste hierarchy and allows the preparation of waste strategies addressing specific waste streams and setting landfill diversion and resource recovery targets
Waste Avoidance and Resource Recovery Strategy 2014-2021	Proposes priority areas for waste management and resource recovery. Details current targets
Northern Beaches Development Control Plan and Northern Beaches DA Guidelines Resources and Waste Management Planning	Aims to facilitate sustainable waste management within the Northern Beaches Shire LGA in a manner consistent with ESD principles.
Model Waste Not DCP Chapter 2008 (DECC)	Provides a framework chapter for NSW LGA's to address Waste Not DCP
Better Practice Guide for Resource Recovery in residential Developments 2019 (NSW EPA)	Provides guideline for addressing waste management in medium or high density residential developments

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## 5 DEMOLITION AND CONSTRUCTION PROVISIONS

### 5.1 STAKEHOLDER ROLES AND RESPONSIBILITIES

The project shall be managed by the project delivery team as per the list presented below.

During the construction period, all personnel including the Project Manager, Site Supervisor, Work Assistants and engaged Contractors have responsibilities in the development of a positive environmental management culture and for ensuring all activities are conducted in a manner which is consistent with the SWMP. Specific project responsibilities in relation to environmental management are shown below:

Table 2 - Roles and Responsibilities

Role	Responsibilities
Manager	
	Approving the Site Waste Management Plan (SWMP)
	Approving any revisions to the SWMP
	Approving appointment of the Project Manager
	Periodic management review of the SWMP and its implementation
	Investigating any serious incidents, complaints or non-conformances and ensuring necessary corrective action is implemented
Project Mana	nger
	Day-to-day management of site
	Assisting in preparing and implementing the SWMP
	Instructing project personnel on how to comply with environmental policy and procedures
	Ensuring the Site Supervisor is aware of and complies with the site waste management obligations as detailed within this SWMP
	Ensuring that employees, contractors and sub-contractors are aware of, and comply with, the conditions of approval and requirements of the SWMP relevant to the respective activities
	Arranging periodic monitoring and inspection by suitably trained personnel
	Regular site inspections and the active pursuit of opportunities to enhance waste outcomes
	Monthly evaluation of how effectively waste controls are performing
	Maintaining environmental performance records
	Engaging consultants where required to provide support in relation to implementing the SWMP
Site Supervis	or
	Managing employees/contractors and construction activities on a daily basis to ensure the appropriate environmental controls are implemented and maintained in accordance with the requirements of the SWMP
	Ensuring all staff are inducted into the site and undertake daily tool box talks
	Undertake daily site inspections of environmental controls and maintain records of waste management actions
	Reporting any waste management concerns or incidents immediately to the Project Manager
	Implementing any corrective actions issued as a result of any site inspections, audits or meetings.
Works Assist	ants and Contractors
	Implementing the SWMP as it applies to their works
	Reporting any waste management concerns or incidents immediately to the Site Supervisor

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#### 5.2 MANAGEMENT OF ASBESTOS AND OTHER HAZARDOUS MATERIALS

Hazardous waste materials are considered to include any waste that poses a hazard or potential harm to human health or the environment, particularly asbestos waste and asbestos containing material (ACM).

During the construction phase of the development, there must be a commitment to engage qualified and certified contractors to remove all contaminated/hazardous materials (e.g. asbestos) and dispose of all contaminated/hazardous waste at an appropriately licenced facility, where applicable.

In the event that any contaminated or hazardous materials are unexpectedly uncovered during excavation works, the Site Manager is to stop work immediately and contact the relevant hazardous waste contractor prior to further works being undertaken in the area.

The following general mitigation measures will apply:

- Contaminated material stockpiled on site will be minimised as far as possible and should be stored on HDPE liner, in a bunded location which is protected from inclement weather;
- Sediment fences should be installed around the base of stockpiles and the stockpiles should be covered.
   Where excavated material requires validations, samples should be taken for NATA laboratory testing as per the requirements of the contamination assessment prior to restoration works, backfilling exercises and disposal;
- Any trucks carrying contaminated materials should be securely and completely covered immediately after loading the materials (to prevent windblown emissions and spillage) and must be licensed by the NSW Environmental Protection Authority (EPA);
- Decontamination of all equipment prior to demobilisation from the site is important so that contaminated materials are not spread off-site.

#### 5.3 MANAGEMENT OF EXCAVATION WASTE

Excavation waste consists of material generated from excavation activities such as site preparation and levelling and the excavation of foundations, basements, tunnels and service trenches. This will typically consist of soil and rock.

All excavated material generated on this site may be re-used in the landscaping or used on other sites as fill material, provided no contamination is present. If sandstone is found to be present, this may be sold or incorporated into the building design.

The following measures and safeguards will apply to the development for excavated material:

- Wherever practical, excavation material will be reused as part of the development;
- Excavation material that is not natural (virgin) material will be transported to an approved landfill site or offsite recycling depot;
- A waste classification assessment of the fill material should be undertaken prior to it being acceptable for waste disposal purposes;
- Transportation

#### 5.4 WASTE CONTRACTORS AND SERVICE PROVIDERS

The following is an indicative only list of contractors generally based around the Sydney area that provide various services for handling the recycling, reuse and disposal of demolition and construction waste from the proposed project. Logs are to be maintained detailing the amount and type of waste, destination and contractors details.

Waste Material	Company	Details
Concrete, blockwork,	Benedict Industries	W: www.benedict.com.au
bricks, porcelain, bitumen/asphalt	Primarily a rubble recycling company but	
bitumen/asphait	manages a wider range of waste streams as per	Recycling sales:
	below. Benedict will separate loads by hand or	recycling sales.

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Products.   Non-recyclable elements will go to landfill.   Materials accepted:   Clean concrete, blockwork, brick, mortar (masony), porcelain   Rubble+soil   Mixed load - concrete rubble and mixed in non-recyclables (find mixed demolition waste, vegetation, timber, plastics)   Electrical cable   Cardboard   Clean timber   Crean waste   Clean and laminated MDF, laminated timbers, stumps and plastics will generally go to landfill.   Stumps and plastics will generally go to landfill   Steel loads - not mixed with other materials that requires sorting   Benedict do not accept paints, liquids or food waste.   Bingo Industries   Primarily a rubble recycling service similar to Benedict Industries, but they also provide their own bins.   Boral Recycling   Provides concrete, cement, asphalt, timber, roof tiles, bricks and masonry blocks removal and disposal.   Concrete Recyclers   Provides concrete, brick, asphalt waste removal   Primarily a rubble recyclers   Provides concrete, brick, asphalt waste removal   Primarily a rubble recyclers   Provides concrete, brick, asphalt waste removal   Primarily a rubble recyclers   Provides concrete, brick, asphalt waste removal   Primarily a rubble recyclers   Provides concrete, brick, asphalt waste removal   Primarily a rubble recyclers   Provides concrete, brick, asphalt waste removal   Primarily a rubble recyclers   Provides concrete, brick, asphalt waste removal   Primarily a rubble recyclers   Provides concrete, brick, asphalt waste removal   Primarily a rubble recyclers   Primarily a rub	Chipping Norton NSW 2170
Materials accepted:  Clean concrete, blockwork, brick, mortar (masony), porcelain  Rubble+ soil  Mixed load - concrete rubble and mixed in non-recyclables (incl mixed demolition waste, vegetation, timber, plastics)  Electrical cable  Cardboard  Clean timber  Clean and laminated MDF, laminated timbers, stumps and plastics will generally go to landfill-Steel loads - not mixed with other materials that requires sorting  Benedict do not accept paints, liquids or food waste.  Bingo Industries  Primarily a rubble recycling service similar to Benedict industries, but they also provide their own bins.  Boral Recycling  Provides concrete, cement, asphalt, timber, roof tiles, bricks and masonry blocks removal and disposal.  Concrete Recyclers  Provides concrete, brick, asphalt waste removal  Mand K Demolition Group  Demolition, asbestos removal, strip outs and any other earthmoving service.  Plasterboard / Gypsum  Mixed load - concrete industries, but should be a visual service in the provide of the provides concrete, brick, asphalt waste removal  V: www.concreterecyclers.com.au  P: 02 9882 7400  W: http://www.mkdemogroup.com.au  visit they/www.mkdemogroup.com.au  Pilsterboard / Gypsum  Jaoo Rubbish  A: various locations around Australia,	Chipping Norton NSW 2170
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disposal.  Concrete Recyclers Provides concrete, brick, asphalt waste removal  M and K Demolition Group Demolition, asbestos removal, strip outs and any other earthmoving service.  P: 1300 134 002  A: 14 Thackeray St, Camellia NSW 2142, W: ww.concreterecyclers.com.au P: 02 8832 7400  A: Tusmore St, Punchbowl NSW 2196 W: http://www.mkdemogroup.com.au  Plasterboard / Gypsum  1300 Rubbish  A: various locations around Australia,	
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P: 02 8832 7400  M and K Demolition Group Demolition, asbestos removal, strip outs and any other earthmoving service.  Plasterboard / Gypsum P: 02 8832 7400  A: Tusmore St, Punchbowl NSW 2196 W: http://www.mkdemogroup.com.au A: various locations around Australia,	llia NSW 2142,
M and K Demolition Group Demolition, asbestos removal, strip outs and any other earthmoving service.  Plasterboard / Gypsum  A: Tusmore St, Punchbowl NSW 2196 W: http://www.mkdemogroup.com.au  A: various locations around Australia,	s.com.au
Demolition, asbestos removal, strip outs and any other earthmoving service.  W: http://www.mkdemogroup.com.au  Plasterboard / Gypsum  1300 Rubbish  A: various locations around Australia,	
other earthmoving service.  Plasterboard / Gypsum  1300 Rubbish  A: various locations around Australia,	wl NSW 2196
	group.com.au
	nd Australia,
General rubbish removal (waste and recycling) incl. Sydney area	
from residential and commercial buildings, construction sites and deceased and hoarding  W: www.1300rubbish.com.au	n.au
affected estates, including gyprock.  P: 1300 78 22 47	
Gyprock  A: various locations in Sydney area (Gyprock Trace Bunnings)	dney area (Gyprock Trade,
Only new, clean Gyprock products / plasterboard waste is accepted.  W: https://www.gyprock.com.au/about-us/plasterboard-recycling	
Do not provide bins.  P: 13 17 44	7
ReGyp A: 330 Captain Cook Drive, Kurnell NSW 2231	e. Kurnell NSW 2231
Regyp provide and collect their own bins for W: http://www.regyp.com.au/waste	
new and old plasterboard per below:  P: 1300 473 497	
<ul> <li>Plasterboard and cornice off-cuts</li> <li>Plasterboard with paint or wallpaper</li> </ul>	
Non-laminated plasterboard tiles	
Gypsum blocks, gypsum prefab wall     panels e.g. RFC rapid wall	
Chemical precipitate gypsum (e.g. flue gas desulphurisation)	

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	Suitable industrial gypsum waste	
	Redmondis  Accepted materials:  Chemical & FGD gypsum and other construction materials including  Scrap metal,  Organic waste,  Paper  Glass  Plastics	W: www.remondis.com.au E: info@remondis.com.au P: 02 9032 7100 Nearest facilities in: A: 32-36 Christie Street, St. Marys NSW 2760 (depot) P: 02 9623 4733 A: Bay Road 2, Taren Point NSW 2229 (transfer station) P: 02 9526 2642
Asbestos	M and K Demolition Group As above	As above
Green Waste	Jim's Asbestos Removal Licensed asbestos removalists.	W: https://www.jimsasbestos removal.com.au/locations/asbestosremoval- sydney P: 13 15 46  A: 4-6 Tollis Place, Seven Hills NSW 2147; 210 Martin Road, Badgerys Creek NSW 2171
	Green waste off-site composting  Benedict Industries	W: www.anlscape.com.au Ph. 13 14 58 As above
	As above	
Paints	Paintback Taking unwanted paint and packaging for innovative reuse and responsible disposal. Further information regarding acceptable paints can be found on the website.	A: various sites in Western Sydney, e.g. Liverpool Community Recycling Centre, 99 Rose Street, Liverpool NSW 2170  W: https://www.paintback.com.au P: 1300 390 380
Metal	Benedict Industries  As above	As above
	Kimbriki Resource Recovery Centre Items must be at least 80% metal	As above
	Liberty Group  Mixed metals recycling, full site clean-up and bin services.  Also have other recycling services.	A: various locations in Sydney area, nearest at 79-81 Stephen Road, Botany NSW 2019 W: https://www.libertygfg.com/recycling E: recycling@libertyonesteel.com P: 02 8335 8470
	Redmondis As above	As above
	Veolia All waste metal in large volumes	A: various sites across Australia W: https://www.veolia.com/anz/ourservices/ ourservices/recycling-wasteservices/ construction-demolition-waste P: 13 29 55

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Timber	Benedict Industries	As above
	As above	
	Boral Recycling	As above
	As above	
Cardboard/Polystyrene	<u>Brandown</u>	A: Lot 90 Elizabeth Drive, Kemps Creek NSW 2170
	Privately owned and operated resource recovery	W: http://www.brandown.com.au
	centre. General solid waste (non-putrescible), landfill and quarry.	E: info@brandown.com.au
	ianum and quarry.	P: 02 9826 1256
	Cleanaway	A: various locations across Australia
	Sustainability for recycling, reuse, repurposing, treating or shredding across the following areas:	W: https://www.cleanaway.com.au/
	Redmondis	As above
	As above	
Soft plastics from	Cleanaway	As above
packaging	As above	
	Redmondis	As above
	As above	
	Suez	A: multiple locations across Australia;
	Sustainability across the following areas:  • Commercial Waste Management	Chullora Resource Recovery Park: 15 Muir Rd, Chullora NSW 2190
	Waste Removal & Disposal     General Waste Management	W: https://www.suez.com.au/
	<ul> <li>Commercial Waste Recycling</li> <li>Advanced Resource Recovery Technology</li> <li>Diversion Solutions</li> <li>Households &amp; Small Business</li> <li>Collection &amp; Disposal</li> <li>General Waste Management</li> <li>Skip Bins</li> </ul>	P: 13 13 35 (general enquiries)
Skip Bin Hire	Bingo Industries	As above
	As above.	
	Provides skip bins 2 m³ and 30 m3.	
	Bins Express	A: PO Box 505 Merrylands NSW 2160
	Provides skip bins between 1.5 m3 and 13.5 m3,	W: https://www.binsexpress.com.au
	available 7 days a week.	E: info@binsexpress.com.au
	Servicing Sydney metro area.	
	Jims Skip Bins	A: multiple locations across Australia
	Provides skip bins between 2 m³ and 9 m³.	W: www.jimsskipbins.com.au
	Recycle at least 90% of all wastes collected.	E: admin@jims.net
		P: 13 15 46
	<u>Suez</u>	As above
	As above	

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### 6 CONSTRUCTION PHASE

#### 6.1 GENERAL OUTLINE

The management of the site will be the responsibility of the project manager, who will administer waste handling systems, as specified by Northern Beaches Council, SafeWork NSW and as detailed in this report.

The construction phase of this development is to comply with the aims and objectives outlined in Section 4 of this report.

The construction phase will involve constructing carparking on the basement level, lift motor, plant, service and garbage room, a multi-level residential flat building, associated light infrastructure and ancillary site works.

#### 6.2 CONSTRUCTION PHASE OPERATIONAL MEASURES

#### TRAINING AND SITE INDUCTIONS

All staff employed during the construction stage of the development must undertake site-specific induction training regarding the procedures for waste management.

Employees of the head contractor will undertake a specific induction outlining their duties and how they are to enforce the waste management procedures.

Induction training will include the following at a minimum:

- Legal obligations;
- Emergency response procedures on site;
- Waste storage locations and separation of waste;
- Litter management in transit and on site;
- The implications of poor waste management practices;
- Correct use of general-purpose spill kits;
- Responsibility and reporting (including identification of personnel responsible for waste management and individual responsibilities).

### WASTE REDUCTION THROUGH MATERIALS SELECTION AND ORDERING

- Selection of all materials will be undertaken by architectural contractors;
- Prefabrication of materials off-site where possible is to be encouraged;
- Materials sizing and requirements are to be accurately calculated to minimise waste from over-ordering;
- Materials ordering process is to minimise material packaging wherever possible;
- Material Safety Data Sheets (MSDS) are to accompany all materials delivered to site, where required, to ensure that safe handling and storage procedures are implemented.
- Where possible limit unnecessary excavation of site material;
- Selection of construction materials giving preference for longer life items and their potential for re-use;
- Reuse of formwork;
- Planned work staging with emphasis on reuse of materials;
- Use of naturally ventilating buildings to reduce ductwork;
- Reducing packaging waste on-site by returning packaging to suppliers where possible, purchasing in bulk and requesting cardboard or metal drums rather than plastics;
- Requesting metal straps or similar, rather than shrink wrap and using returnable packaging such as pallets and reels;
- Reduction of PVC use;
- Use of low VOC (volatile organic compounds) paints, floor coverings and adhesives;
- Use of fittings and furnishings that have been recycled or incorporate recycled materials;

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> the use of building materials, fittings and furnishings with consideration to their longevity, adaptation, disassembly, reuse and recycling potential.

#### SITE PROCEDURES

- Excavated materials will be used onsite where possible;
- Green waste will be mulched and reused in landscaping either onsite or taken to licensed facility;
- Concrete, tiles and bricks will be reused or recycled offsite;
- Steel will be recycled offsite; all other metals will be recycled where economically viable;
- Framing timber will be reused on-site or recycled off-site;
- Windows, doors and joinery will be recycled off-site where possible;
- Plumbing, fittings and joinery will be recycled off-site where possible;
- Plasterboard will be re-used in landscaping on-site or returned to the supplier for recycling where possible;
- Glass to be recycled where feasible;
- All solid waste timber, brick, concrete, rock, plasterboard and other materials that cannot be reused or recycled will be taken to an appropriate facility for treatment to recover further resources or for disposal to landfill in an approved manner;
- All asbestos, hazardous and/or intractable wastes are to be disposed of in accordance with WorkCover Authority and EPA requirements;
- Provision for the collection of batteries, fluorescent tubes, smoke detectors and other recyclable resources will be provided on site;
- Beverage container recycling will be provided on-site for employee use;
- All waste and recycling will be disposed of via council approved systems.

#### 6.3 LOCATION AND DESIGN OF WASTE MANAGEMENT FACILITIES

#### **GENERAL REQUIREMENTS**

All waste management facilities onsite should:

- Be conveniently located to enable easy access for on-site movement and collection;
- Be incorporated with other loading/unloading facilities;
- Have sufficient space for the quantity of waste generated and careful source separation of recyclable materials;
- Have sufficient space to contain any on-site treatment facilities, such as compaction equipment;
- Have adequate weather protection and, where required, be enclosed or undercover;
- Be secure and lockable, where feasible;
- Be well-ventilated and drained to the sewer;
- Be clearly sign-marked to ensure appropriate use.

### **WASTE AND RECYCLING RECEPTACLES**

Skip bins should be provided for the separate storage of each type of construction material generated on site. This will assist in maximising source separation and resource recovery, while reducing the costs and quantity of materials disposed of at landfill.

The size and quantity of the receptacles should be appropriate to the nature of waste generated and the available storage area.

Separate receptacles for the safe disposal of hazardous waste types (i.e. light bulbs, batteries, etc) will also be provided where applicable.

Where possible, additional bins will be provided in common areas for the collection of commingled recyclables such as beverage containers (glass, plastic, aluminium), paper products, recyclables food containers, etc.

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#### SAFETY AND SIGNAGE

The following safety measures should be considered for the waste storage area:

- Location should not interfere with sight lines of drivers entering or leaving the site;
- Skip bins should be clearly visible and located in well-lit areas;
- Safe paths of travel should be designated using reflective tape, barriers and cones;
- Skip bins must be secured and must not be over-filled to reduce risk of injury through bins moving and falling objects.

Standard signage will be installed in all waste areas, with all skip bins colour coded and labelled appropriately on all sides to allow clear identification of the type of waste to be deposited into each bin.

#### **SPACE AND SITING REQUIREMENTS**

The waste storage area will be located adjacent to the Raglan Street entrance to the site to enable access and allow sufficient space for the required skip bins and servicing requirements. The storage area will also need to be flexible in order to cater for change of use throughout construction works.

Where space is restricted, dedicated stockpile areas will be allocated onsite, with regular transfers to the dedicated skip bins for sorting and collections.

The position of the designated waste holding area onsite may change according to building works and the progression of the development.

Access, visual amenity and WHS will always be integral to the selection of waste storage area locations. Any stockpile locations will take into account slope and drainage factors to avoid contamination of stormwater drains during rain events.

#### SERVICING AND TRANSPORT

The frequency of waste removal from site will be determined by the volume of materials deposited into the dedicated skip bins. Skip bins will be monitored on a daily basis by the Construction Site Manager to ensure they do not overflow. If skip bins are reaching capacity, removal and replacement should be organised for within 24 hours.

All skip bins leaving the site will be covered with a suitable tarpaulin to reduce spillage of waste while in transit.

All waste collection for construction works will be conducted between approved hours as per Council requirements (typically between 7am and 7pm Monday to Friday, and between 7am and 1pm on Saturdays). All waste generated on site will be transported to an approved and appropriately licensed resource recovery facility and/or landfill site.

Project manager to retain all weighbridge or re-processing facility dockets to ensure responsible disposal and recycling options are being employed by contractors;

All waste generated is to be documented and handled in accordance with Table 3 Construction Volumes and Reuse/Recycling Potential

### 6.4 CONSTRUCTION WASTE VOLUMES AND REUSE POTENTIAL

Construction waste volumes have been calculated using available data and industry standard figures available for the construction of similar developments. An estimation is provided below, however the figures are indicative.

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Table 3 - Construction Volumes and Reuse/Recycling Potential

	Estimated	Estimated	Wast	Waste Management Strategy	iteav	Approximate	Estimated Amount of
Material	Volume (m <sup>3</sup> )	Weight (t)		,	;	Recovery Rate	Material Diverted from
			Re-Use	Recycle	Landfill		Landfill (t)
Bricks	2,167.50	2,601.00	Full bricks retained and set Broken Bricks stored for aside for re-use collection to crushing		N/A	100%	2,601.00
Concrete	2,217.00	3,325.50	Re-use for filling, levelling and road base	Slabs/footings broken up on site and stored for collection/crushing	N/A	100%	3,325.50
Timber	277.80	52.78	De-Nail useful pieces and set aside for re-use	Unused larger pieces recycled for timber salvage	Transported to Green Waste processing facility	33%	17.42
Plasterboard	249.00	49.80	Stored for recycling	Stored for recycling	N/A	100%	49.80
Metal	135.00	67.50	Stored for recycling	Stored for recycling	N/A	100%	67.50
Tiles	0.00	0.00	Full tiles set aside for re- use	Broken tiles stored for collection to be crushed and use for road base	N/A	100%	0.00
Green Waste	90.099	99.00	Processed on site and stored to be used as mulch and/or compost in future gardens	N/A	Dispose of non re-useable vegetation to processing facility	%08	79.20
Other Waste	465.00	139.50	Separated in to re-usable materials	Separated in to recyclable materials	Transported to Waste Facility	20%	69.75
	Estimated Total Waste Amoun	Waste Amounts					
Estimated Total Volume of Waste Generated (m <sup>3</sup> )	of Waste Generate	d (m³)	6,171.30				
Estimated Total Weight of Waste Generated (t)	of Waste Generated	1 (t)	6,335.08				

6,210.17

Estimated Total Weight of Waste Diverted from Landfill (t)

Estimated Percentage of Waste Diverted from Landill

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### 6.5 RECYCLING OF MATERIALS

Construction materials generated during the construction phase of the proposed development will need to be managed in accordance with the provisions of current legislation.

Generally, this will include segregation by material type classification in accordance with NSW EPA (2014) Waste Classification Guidelines, Part 1: Classifying Waste and disposal at facilities appropriately licensed to receive the particular materials.

The nearest locations to the subject site for licenced facilities can be sourced via <a href="www.businessrecycling.com.au">www.businessrecycling.com.au</a>.

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# **POST CONSTRUCTION (OPERATIONAL) PHASE**

The following assessment of waste volumes is an estimate only and will be influenced by building management, cleaning arrangements, individual tenant's attitude and obligation regarding waste disposal and recycling.

#### 7.1 WASTE AND RECYCLING GENERATION RATES

Northern Beaches Council's Waste Management Guidelines identified the below waste storage requirements.

Waste Type	Waste Generation Requirements (Based on 9 (nine) units
Waste (Garbage)	5 x 240 L MGB
Recycling – Paper and Cardboard	4 x 240 L MGB
Recycling – Glass, Plastic and Metals	4 x 240 L MGB
Green Waste - Food and Organics	2 x 240 L MGB

During operation, it is the responsibility of the building manager/waste caretaker to monitor the number of bins required for development. Volumes of Waste, recycling and organics generated by the development may change according to future tenant's attitudes to waste disposal and recycling, building occupancy levels or changes to building management.

Any requirements for adjusting the capacity of the waste facilities can be achieved by changing the number of bins, the bin sizes or collection frequencies. Prior to these being undertaken, building management will be required to negotiate any changes to bins or collections with the Council and or their contractor.

#### 7.2 WASTE DISPOSAL PROCESSES

All residents will be provided with a waste storage cupboard in each unit. The waste storage cupboard is to be located within the kitchen area and be capable of storing a minimum of 40L of waste and to enable a minimum of 20L of recycling waste to be stored in a separate container and not in plastic bags.

Suitable space is to be provided within the kitchen area to allow for a 7L kitchen caddy to collect food waste. Suitable space is to be provided for other recyclable items such as light globes and batteries.

Once these have been filled, the resident will then transport the waste to the waste room on the basement level. The bins will be clearly labelled to identify the respective materials that are acceptable in the relevant bin.

Recyclable materials must not be bagged and must be separated in to cardboard and other recyclable materials. Larger cardboard boxes and other cardboard objects should not be placed in the MGB, but transported to the individual garage storage area for each unit to allow for bulky waste collection.

Each individual residential dwelling shall be no more than 75 metres from the nearest waste room. This distance should be shortened to 50 metres for aged or disabled residents.

All equipment movements in the garbage room and from the garbage room to the loading space are to be managed by the building manager or custodial staff.

The waste caretaker shall be responsible for ensuring the waste rooms and related equipment are kept in a clean and working order.

The waste caretaker shall also ensure that the waste, FOGO and recycling bins are provided in the waste collection point area on the relevant servicing days by the required times. Once serviced the bins are to be moved back to the main Waste room.

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Occupational health and safety of bin transfers must be considered for larger bins (e.g. ability to safely move a bin that may weigh more than the person trying to move it).

#### 7.3 SOURCE SEPARATION - RESIDENTIAL

Best practice waste management includes the avoidance, reuse, and recovery of unwanted items, and the prevention of cross contamination of waste streams, which can be achieved through source separation.

The table below outlines what is typically included in various waste streams and how they can be managed. Various options can be accessed online to find other facilities that recover unwanted items.

Waste Stream	Description	Disposal Details
Waste		
General Waste	The remaining portion of the overall waste stream not recovered for reuse, processing or recycling.	Waste bins should always be lined with bags and the bags tied before removal. General waste should weigh approximately 3 kg or less.
		Waste bins should be accompanied by a commingled recycling bin in order to facilitate separation of general waste and recycling.
Food and Organic Waste	Separating organic or food waste from general waste may be considered to reduce the total amount of general waste produced.	Apartment style equipment such as organic household composter or worm farms are available for use where practical and space allows.
		On-site composting should be arranged with the building management.
Recycling		
Comingled	A mixture of items that are commonly recycled. Typically include food and beverage containers (e.g.,	Items for recycling must not be bagged and should be disposed of in loose form.
	aluminium, glass, steel, hard plastics, cartons). Also included cardboard and paper products.	Residential Apartments
	included cardboard and paper products.	Residents will have receptacles within their individual units for collection and storage of at least one day of recycling.
		Recycling bins are typically placed under the kitchen sink next to the general waste bin. Additional recycling bins can be placed in other areas as required.
		Once full residents will dispose of their recycling materials directly into the recycling MGBs provided in the waste holding room on each level for the individual building cores.
		Recycling bins will usually be used for all recycling materials (commingled recycling). Residents are encouraged to make use of any container refund scheme and separate eligible containers from the commingled recycling material.
Other Waste		
Green Waste	Green waste consists of unwanted organic materials that are easily biodegradable and/or compostable (e.g., lawn clippings, branches)	Green waste is not typically produced from this type of development other than from surrounding landscaped areas or potted plants.
		Green waste is usually removed by the designated maintenance contractor. The engaged contractor will be required to send this material to a composting or resource recovery facility rather than to a landfill if locally available.

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separated and securely stored for collection by a

specialist waste contractor.

Hard Waste/Bulky Bulky items may be stored in a designated room Items that are to too large to place into general rubbish collection. This includes disused and/or which is located in the basement level. Items broken furniture, mattresses, white goods, etc. Residents are to liase with building management to arrange for pickup and removal. Electronic Waste Discarded e-waste, electronic components and Building manager is to arrange collection for e-waste materials such as computers, mobile phones, recycling as needed by residents. keyboards, etc. Hazardous and other Other recyclable items that require special recovery It is an expectation that the building management waste may include ink cartridges, batteries, chemical assist with disposal of hazardous, electronic or liquid waste and any paint or chemicals as required and waste, fluorescent tubes, etc. requested. Hazardous waste must be handled with due care,

#### 7.4 COMMERCIAL - SOURCE SEPARATION

The Northern Beaches Council's 'Waste Management Guidelines' has been referenced to calculate the total number of bins required for the retail and commercial areas.

The Premises type of Retail Store (Non-food) has been utilised for the commercial tenancy. Calculations are based on generic figures; waste generation rates may differ according to the tenants' waste management practice.

On completion of each trading day or as required, nominated retail staff/cleaners will transport their general waste and recycling to the retail waste room on the ground floor and place general waste and recycling into the appropriate collection bins.

To ensure the proper management and disposal of waste, tenants must be made aware of the following practices:

- All general waste should be bagged and general waste bins should be plastic lined;
- Bagging of recyclables is not permitted;
- All interim waste storage is located BOH during operations;
- Individual recycling programs are recommended for retailers to ensure commingled recycling is correctly separated;
- Any food and beverage tenant will make arrangements for storing used and unused cooking oil in a bunded storage area:
- The operator will organise grease interceptor trap servicing;
- A suitable storage area needs to be provided and effectively bunded for chemicals, pesticides and cleaning products;
- All flattened cardboard will be collected and removed to the waste room recycling MGB

It is the responsibility of the building manager to monitor the number of bins required for the development. As waste volumes may change according to the development's management, customer base and retail tenancy attitudes to waste disposal and recycling, bin numbers and sizes may need to be altered to suit the building operation. Seasonal peak periods i.e. public and school holidays should also be considered.

nercial		Waste Gen. rate (L/100m²/Day)	NLA (m²)	Days	Waste (L/Week)	Collections per week	MGB Size (L)	Number of MGB
omu	Carbage	50	39	6	117	1	240	1
Ů	Recycling	50	39	6	117	1	240	1

Figure 3 - Commercial Waste Generation Rates

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Any commercial common areas, such as tea/lunch rooms or the like are to be provided with a comingled MGB for the collection and short term storage of recyclable glass, aluminium, steel and plastic items. Staff are to ensure the correct sorting of waste streams in to the respective receptacle.

Commercial waste will be stored within a separate waste room with lockable doors. Residential tenants will not have access to the commercial waste and the commercial tenancies will not have access to the residential waste.

Commercial waste will be transported to the waste collection point prior to collection and moved back to the commercial bin holding area as soon as possible after collection. Commercial bin movements will be in line with the requirements outlined in this report for bin movements.

#### 7.4 EDUCATION AND IMPROVED PRACTICES

On-going education is important to ensure people continue to use the facilities as originally intended. All body corporate and leasing contracts should contain clauses pertaining to waste management arrangements and use of any associated equipment.

Educational materials encouraging correct separation of general waste and recyclables must be provided to each resident. This should include the correct disposal process for bulky waste such as old furniture, large discarded items, and other materials including electronic and chemical wastes.

It is recommended that the building caretaker provides information in multiple languages to support correct behaviours, and to minimise the possibility of contamination in communal waste bins.

#### 7.4.1 SIGNAGE

Signage and education are essential components to support best practice waste management including resource recovery, source separation, and diversion of waste from landfill.

All receptacles, bins and other refuse management equipment will have adequate signage. Standard signage will be provided in and around waste collection and storage areas.

Signage should include:

- Clear and correctly labelled waste and recycling bins,
- Instructions for separating and disposing of waste items. Different languages should be considered,
- Locations of, and directions to, the waste storage areas with directional signs, arrows, or lines,
- The identification of all hazards or potential dangers associated with the waste facilities, and
- Emergency contact information should there be issues with the waste systems or services in the building.

The building manager is responsible for waste room signage including safety signage. Appropriate signage must be prominently displayed on doors, walls and above all bins, clearly stating what type of waste or recyclables is to be placed in each bin.

It is the Building Management's responsibility to ensure that all signage conforms to the relevant Australian Standards.

#### 7.4.2 POLLUTION PREVENTION

Building management shall be responsible for the following to minimise dispersion of site litter and prevent stormwater pollution to avoid impact to the environment and local amenity:

- Promoting adequate waste disposal into the bins
- Securing all bin rooms (access to be provided to residents, staff and contractors)
- Prevent overfilling of bins, keep all bin lids closed and bungs leak-free
- Taking action to prevent dumping or unauthorised use of waste areas
- Require collection contractor/s to clean up any spillage when clearing bins

### 7.5 WASTE TRANSPORT ROUTES FROM UNIT TO WASTE ROOM/WASTE CHUTES

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The transfer of waste from individual units to the communal waste holding rooms should minimise manual handling and distances where possible, ensuring the safest and most direct route,

The routes are to be consistent with the following:

- Allow for a continuous route that is wholly within the property boundary;
- All routes are to comply, where required, with Australian Standard 1428, NCC and relevant legislation;
- Be constructed of solid materials with a non-slip surface;
- Door widths within the travel path are to comply with the NCC and relevant access legislation;
- Be a minimum of 300mm wider than the largest bin used on site;
- Not exceed a grade of 1:14;
- Allow for the use of lifts as required by access standards and legislation;
- Minimise travel distances wherever possible

#### 7.7 WASTE HOLDING ROOMS

The storage of residential waste will be within the Waste Holding Rooms located in the basement as shown in the submitted plans. The residential waste rooms will be provided with a key lock or similar device to prevent access by commercial tenants or other, unrelated people.

Waste MGB's will be stored in a stacked arrangement with a minimum of 300mm distance provided between each MGB and a minimum of 1,500mm between the opposing rows of MGB's to allow for the logistical movement of the MGB's for collection.

This room shall be constructed in accordance with the Northern Beaches Council Development Control Plan, ensuring compliance with the National Construction Code and at a minimum be of approved solid impervious material and shall be cement rendered internally to a smooth even smooth even surface coved at all intersections.

The ceiling of the waste room will be finished with a rigid smooth faced non-absorbent material capable of being cleaned. The walls, floor and ceilings of the garbage room shall be finished with a light colour.

Provision for cleaning and bin washing facilities are to be provided within the Bin Holding Room. A hot and cold water tap and drainage with connection to the sewer are to be provided within the waste holding room.

Hose cocks shall be protected or located so that they cannot be damaged. The hose cocks must be easily accessible, even when the room is at capacity.

A hose of adequate length and fitted with a nozzle is to be connected to the hose cock to allow for adequate cleaning of the waste room and receptacles.

The floors of the Waste Holding Rooms are to be constructed of a minimum of 75mm thick concrete, finished with a two-pack epoxy or similar substance and be graded so that any water is directed to a sewer connected floor waste to ensure that the Bin Holding Area does not discharge flow in to the stormwater system.

All corners are to be coved and sealed for a minimum height of 100mm above the ground level.

The size of the waste room will be sufficient to house the recommended number of mobile garbage bins for the development. The minimum sizes for the proposed bins are identified in Appendix B.

A close fitting and self-closing door openable from within the room must be fitted to the waste room. The waste room will be constructed so, as to prevent the entry of vermin.

The doors are to be sized to comply with the requirements of AS1428 – Design for Access and Mobility.

The room will be adequately ventilated, well lit, and appropriately signposted to distinguish paper/cardboards recycling bins from container recycling bins and residual waste (garbage) bins.

The waste room must be ventilated by either:

- Permanent unobstructed natural ventilation openings direct to the external air, not less than 5% of the floor area,
- Mechanical exhaust ventilation system exhausting at a rate of 5L/m² floor area, with a minimum rate of 100L/s min.

22-24 Raglan Street, MANLY Reference Number: 25100485

Mechanical exhaust systems shall comply with AS1668.4 and not cause any inconvenience, noise of odour problem.

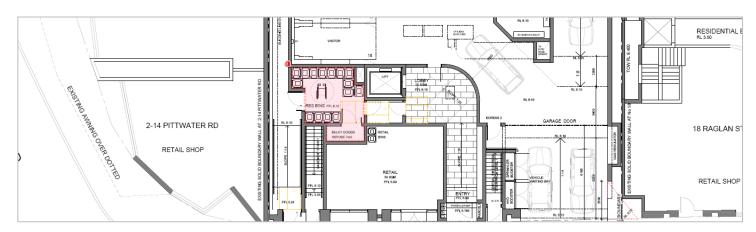


Figure 4 - Waste Bin Room No. 1 Location

The waste room will be provided with artificial light controlled by switches located both outside and inside the room.

Where storage and drainage racks are provided, they will be constructed of galvanised metal or other approved materials which are durable, impervious and no-corrosive.

Racks should be installed at least 50mm clear of walls with the lowest racks installed at least 300mm above the floor. Racks should be designed to prevent receptacles/containers placed thereon from coming in to contact with the walls.

Clear and easy to read "NO STANDING" and "DANGER" signs must be fixed to the external face of each waste and recycling room as appropriate. Clear and easy to read signs designating the storage of recyclables and general waste must be fixed to the internal walls as appropriate.

The location of the waste rooms have been designed to be easily accessible with door clearances that are consistent with AS1428.1.

The waste room will not affect the amenity of any adjacent properties and has been designed as an integrated part of the overall design.

#### 7.8 BIN MOVEMENTS

The transfer of bins should minimise manual handling where possible and is to be completed by the waste caretaker or building management.

The travel paths from the waste holding rooms to the temporary collection point are to comply with the following:

- Allow for a continuous route that is wholly within the property boundary.
- Be free from obstruction and obstacles such as steps and kerbs.
- Be constructed of solid materials with a non-slip surface.
- Be a minimum of 300mm wider than the largest bin used on site.
- Not exceed a grade of 1:14 (for 240L MGBs), and 1:30 (for 660L MGBs and larger) if the bins are moved manually.
- Should not exceed the maximum operating grade of a bin moving device if one is used to transfer bins.
- If the transfer of bins is longer than 10m, then a bin moving device should be used.

Where required, the property management is responsible for supplying all equipment required for moving bins including bin lifters, bin moving devices, and waste transfer bins. This equipment must be new and appropriate for the site.

The building management is responsible for suppling all equipment required for moving bins this includes any bin lifters, bin moving devices and waste transfer bins. This equipment must be new and appropriate for the site. The building management should contact the relevant suppliers to provide equipment recommendations.

The bin transport equipment or tug is to have a storage area where it can be securely locked to prevent use by unauthorised persons, theft or vandalism.

22-24 Raglan Street, MANLY

Reference Number: 25100485

Once the site becomes operational, it will be the responsibility of the building proprietors/strata for maintaining, repairing, and replacing waste management equipment

#### SERVICING (COLLECTION) 7.9

As per the provisions of the Development Control Plan, it is intended that the waste be collected as per Council's policy from a designated kerbside location in Raglan Street.

The property's caretaker will ensure that all Residential bins are prepared and presented in the kerbside location adjacent to the subject site.

The travel space between the waste holding areas and the collection point is to be generally level and is expected to allow for easy transfer of the MGBs. The waste and recycling MGB's will be presented at kerbside location by 5:00am on the designated collection day. MGB's will be returned to the waste bin rooms as soon as practicable following servicing.

Responsibility for regular transfer of bins and bulky waste from the waste room to/from collection areas or around a site, rests with the Owners/Strata/managing body or delegated person.

All waste and recycling mobile garbage bins are to be maintained in serviceable condition and at the agreed bin numbers at all times. Bin cleaning and regular bin number audits must be conducted by the managing body and a site may be audited by Council.

Occupational health and safety of bin transfers must be considered for the bins (e.g. ability to safely move a bin that may weigh more than the person trying to move it).

The owners corporation shall be responsible for the operation of any waste system, its ongoing maintenance and the presentation of the required bins for collection

The waste and recycling MGB's will be presented at the temporary loading bay area by 5:00am on the designated collection day. MGB's will be returned to the waste bin rooms as soon as practicable following servicing.

### 7.10 BULKY WASTE

The development will provide adequate storage space within the individual storage/carparking areas for residents to temporarily store unwanted bulky items until suitable disposal/transport options can be arranged by Building management.

Council's Waste Management Guidelines required a minimum of 4 m<sup>2</sup> for 10 sole occupancy units (SOU). Given that the development has 15 dwellings the Waste Management Guidelines propose 6 m2 the storage of bulky waste. The proposed development provides in excess of this for each unit.

Given the individual tenants monitoring of the bulky waste within their storage area, the proposed area is considered to be sized appropriately as this will allow for the building management to organise bulky waste collection on an as needed basis. The dedicated bulky waste area has been located in an area which provides for ease of access to the waste collection area within the building.

Residents will need to liaise with building management regarding the transportation of bulky items and the availability of the bulky waste room. It is the caretaker's responsibility to arrange collection dates with Council or a Private Contractor and then coordinate with the residents.

#### 7.11 OCCUPATIONAL HEALTH AND SAFETY

Transferring refuse bins and using refuse management equipment are considered hazardous tasks. Therefore, building management must ensure that a full risk assessment of equipment, surfaces and related gradients is completed prior to occupation of the development.

Building Management must provide procedural documentation to appropriate personnel prior to delivery of equipment and occupancy of the development.

Building management is to ensure the provision of equipment manuals, training, health and safety procedures, risk assessments and personal protective equipment to staff / contractors in order to control hazards associated with all waste management activities.

Transferring and collection of bulky waste is to be completed in accordance with OH and S requirements, a risk assessment of the individual bulky waste item and the overall circumstances. Where possible bulky waste should only be transferred via mechanical or mechanised equipment.

Where possible, with larger items, bulky waste should be dis-assembled or broken down in to smaller components to allow for easier transport to the relevant collection point.

Manual handling is to be limited wherever feasible.

#### 7.12 STAKEHOLDER ROLES AND RESPONSIBILITIES

Roles and responsibilities of stakeholders within the proposed development are outlined in table 5.

Table 4 - Stakeholder responsibilities

Stakeholder Role	Outline of Responsibilities
Strata management	<ul> <li>Ensuring that all waste service providers submit monthly reports on all equipment movements and waste quantities/weights;</li> </ul>
	Organising internal waste audits/visual assessments on a regular basis
	<ul> <li>Purchasing any on-going waste management equipment or maintenance of equipment once building is operational; and</li> </ul>
	Managing any non-compliances/complaints reported through waste audits.
Building Manager or Waste	Maintaining and cleaning chute doors on each level;
Caretaker	Coordinating general waste and recycling collections;
	Cleaning and transporting bins as required;
	Organising replacement or maintenance requirements for bins;
	Organising, maintaining and cleaning the waste holding area;
	Organising bulky goods collection when required
	Investigating and ensuring prompt clean-up of illegally dumped waste materials.
	<ul> <li>Preventing storm water pollution by taking necessary precautions (securing bin rooms, preventing overfilling of bins)</li> </ul>
	Abiding by all relevant WH&S legislation, regulations, and guidelines;
	<ul> <li>Providing staff/contractors with equipment manuals, training, health and safety procedures, risk assessments, and PPE to control hazards associated with all waste management;</li> </ul>
	<ul> <li>Assessing any manual handling risks and preparing a manual handling control plan for waste and bin transfers;</li> </ul>
	Ensuring site safety for residents, children, visitors, staff and contractors; and
	<ul> <li>Ensuring effective signage, communication and education is provided to occupants, tenants, maintenance staff, and cleaning contractors.</li> </ul>
	<ul> <li>Purchasing all equipment required to implement this Waste Management Plan prior to the occupation of the building to be provided to the strata.</li> </ul>
Council/Waste Collection Contractor	<ul> <li>Provide a reliable and appropriate waste collection service;</li> <li>Provide feedback to building managers/residents regarding contamination of recyclables; and</li> <li>Work with building managers to customise waste systems where possible.</li> </ul>
Gardening / Landscaping Contractor	<ul> <li>Removal of all garden organic waste generated during gardening maintenance activities for recycling at an offsite location.</li> </ul>
Residents	<ul> <li>Dispose of all general waste and recycling in the allocated MGBs provided;</li> <li>Ensure adequate separation of general waste and recycling; and</li> <li>Compliance with the provisions of Council and the Waste Management Plan.</li> </ul>

# **APPENDIX A**



# Signange for Waste Areas

Indicative representation of signage











# **APPENDIX B**



# **Proposed Equipment**

Waste Management Equipment

### **Dimensions - Weights - Standards**

■ Nominal volume: 240 litres

■ Net weight: approx 13 kg


■ Max load: 96 kg


Permitted total weight: 110 kg

■ A 1060 mm ■ D 730 mm ■ G 550 mm

■ B 990mm ■ E 585 mm ■ C 660 mm ■ F 400 mm

Measurements to be used as a guide only - variations will occur

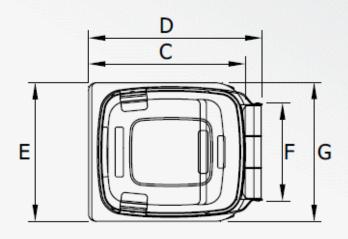

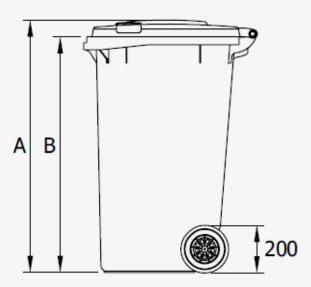

# **APPENDIX C**



## **Architectural Plans**

Site, Floor Plan, Elevations and Sections

# 22-24 RAGLAN STREET, MANLY

### DEVELOPMENT APPLICATION SUMMARY

SITE AREA: 713 sqm

LOW & MID-RISE HOUSING POLICY

SHOP-TOP HOUSING WITH 15% IN-FILL AFFORDABLE HOUSING

FSR CONTROL: 2.2:1 + 30%.

GFA CONTROL =  $2.2 \times 713 + 30\% = 2040 \text{ sqm}$ 

BUILDING HEIGHT CONTROL: 24m + 30% = 31.2m

### DRAWING SET

No.	REV	TITLE	SCALE AT A1	
DA-00	В	TITLE SHEET		
DA-01	В	SITE ANALYSIS, SITE PLAN	1:200	
DA-02	В	BASEMENT PLAN	1:100	
DA-03	В	GROUND FLOOR PLAN	1:100	
DA-04	В	LEVEL 01 PLAN	1:100	
DA-05	В	LEVEL 02 PLAN	1:100	
DA-06	В	LEVEL 03 PLAN	1:100	
DA-07	В	LEVEL 04 PLAN	1:100	
DA-08	В	LEVEL 05 PLAN	1:100	
DA-09	В	LEVEL 06 PLAN	1:100	
DA-10	В	LEVEL 07 PLAN	1:100	
DA-11	В	ROOF PLAN	1:100	
DA-20	В	SOUTH ELEVATION	1:100	
DA-21	В	NORTH ELEVATION	1:100	
DA-22	В	EAST ELEVATION	1:100	
DA-23	В	WEST ELEVATION	1:100	
DA-30	В	SECTION AA	1:100	
DA-31	В	SECTION BB	1:100	
DA-32	В	SECTION CC	1:100	
DA-33	В	SECTION DD	1:100	
DA-40	В	GFA DIAGRAMS	NTS	
DA-41	В	LANDSCAPE AREAS	NTS	
DA-42	В	SOLAR ACCESS	NTS	
DA-43	В	CROSS VENTILATION DIAGRAMS	NTS	
DA-50	В	PERSPECTIVES 01	NTS	
DA-51	В	PERSPECTIVES 02	NTS	
DA-60	В	SHADOW DIAGRAMS 01	NTS	
DA-61	В	SHADOW DIAGRAMS 02	NTS	
DA-62	В	SHADOW DIAGRAMS 03	NTS	
DA-63	В	SHADOW DIAGRAMS 04	NTS	
DA-70	В	ADAPTABLE UNITS PLANS	1:50	
DA-80	В	PHOTOMONTAGE 01	NTS	
DA-81	В	PHOTOMONTAGE 02	NTS	
DA-90	В	BASIX COMMITMENTS		

# APARTMENT AREAS AND MIX

	UNIT No	AREA (sqm)	BEDS	STORAGE (sqm)	
		(34111)	i	(39111)	
Level Gr					
2070. 0.	Retail	39			
Level 1					
	01	130	2	10.3	AFFORDABLE UNIT
	02	150	3	10.3	AFFORDABLE UNIT
	03	50	1	7	AFFORDABLE UNIT
Level 2					
	04	144	3	10.5	
	05	146	3	10.3	
	06	50	1	6	
Level 3			İ		
	07	128	2	8	ADAPTABLE UNIT
	08	131	2	8	
Level 4					
	09	128	2	8	ADAPTABLE UNIT
	10	131	2	8	
Level 5					
	11	128	2	8	ADAPTABLE UNIT
	12	131	2	8	
Level 6					
	13	128	2	12.6	ADAPTABLE UNIT
	14	131	2	8	
Level 7					
	15	180	3	20.2	

TOTAL GFA: 2038m2

TOTAL RESIDENTIAL AREA: 1886m2

TOTAL AFFORDABLE HOUSING AREA: 330m2 (16% OF TOTAL GFA)



DEVELOPMENT APPLICATION

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BASIX CERTIFICATE No 1820270M

NatHERS CERTIFICATE No #HR-NOSJEI-01

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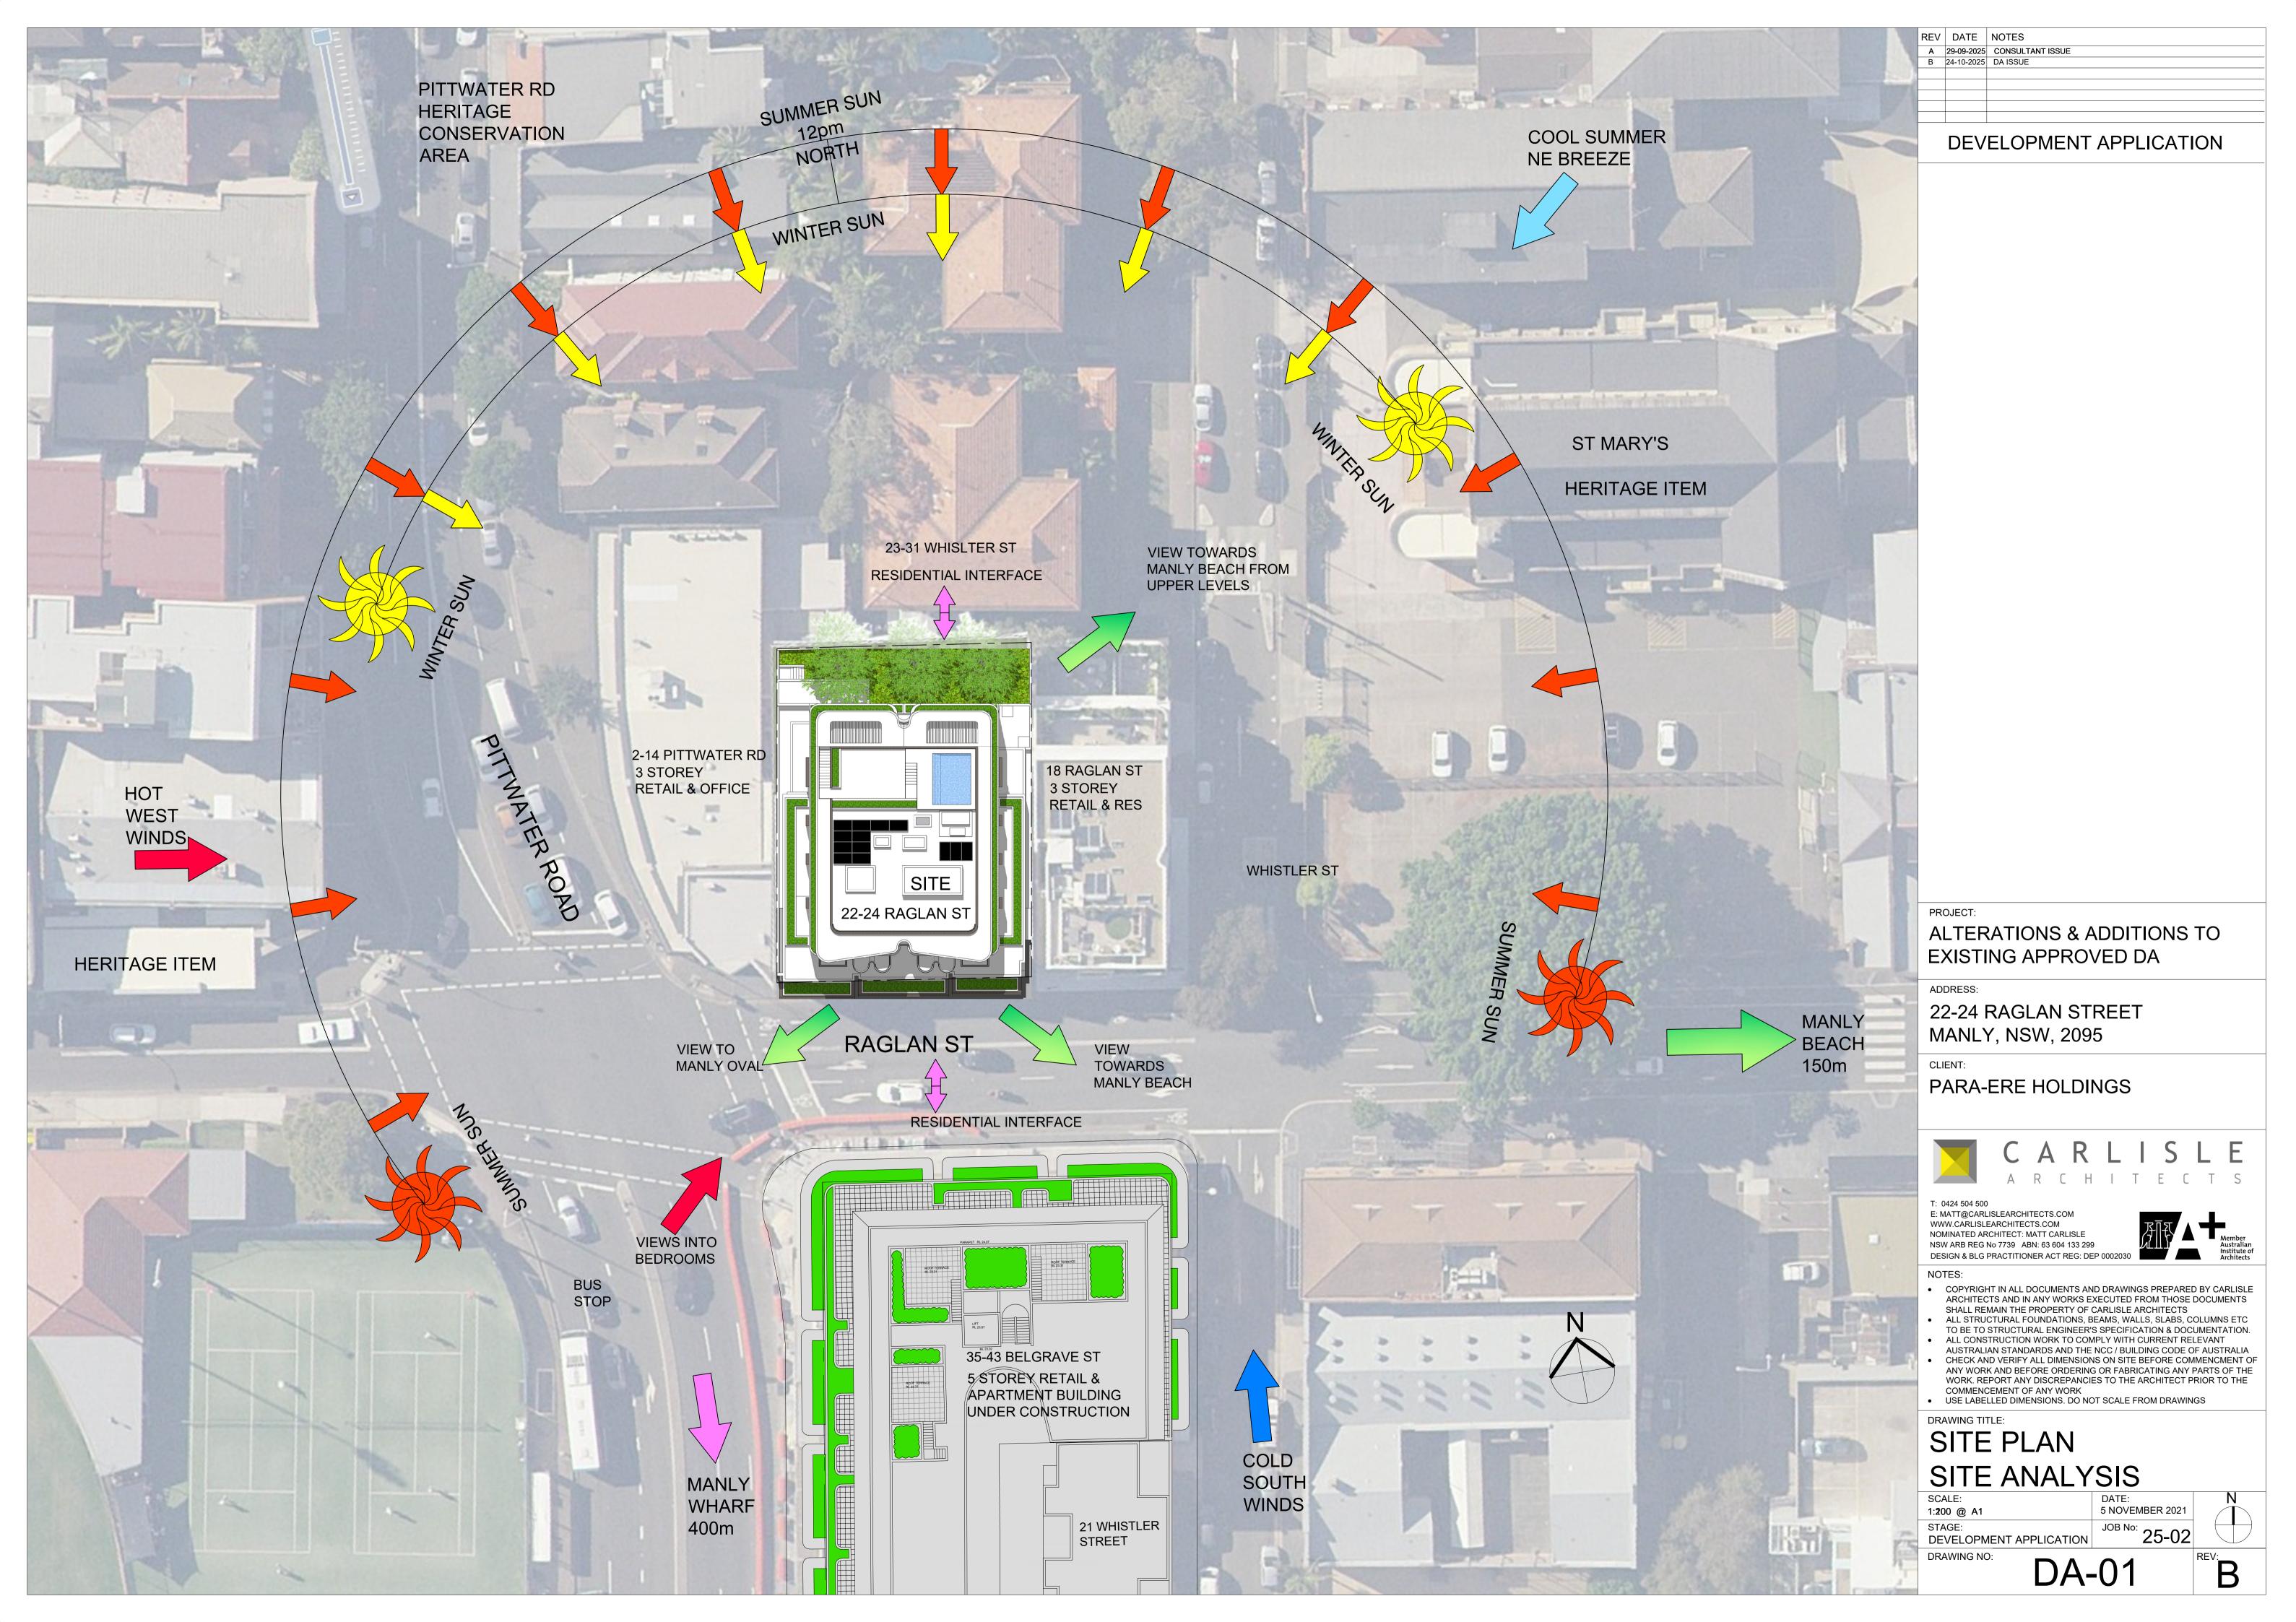
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# TITLE SHEET

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**DA-00** 







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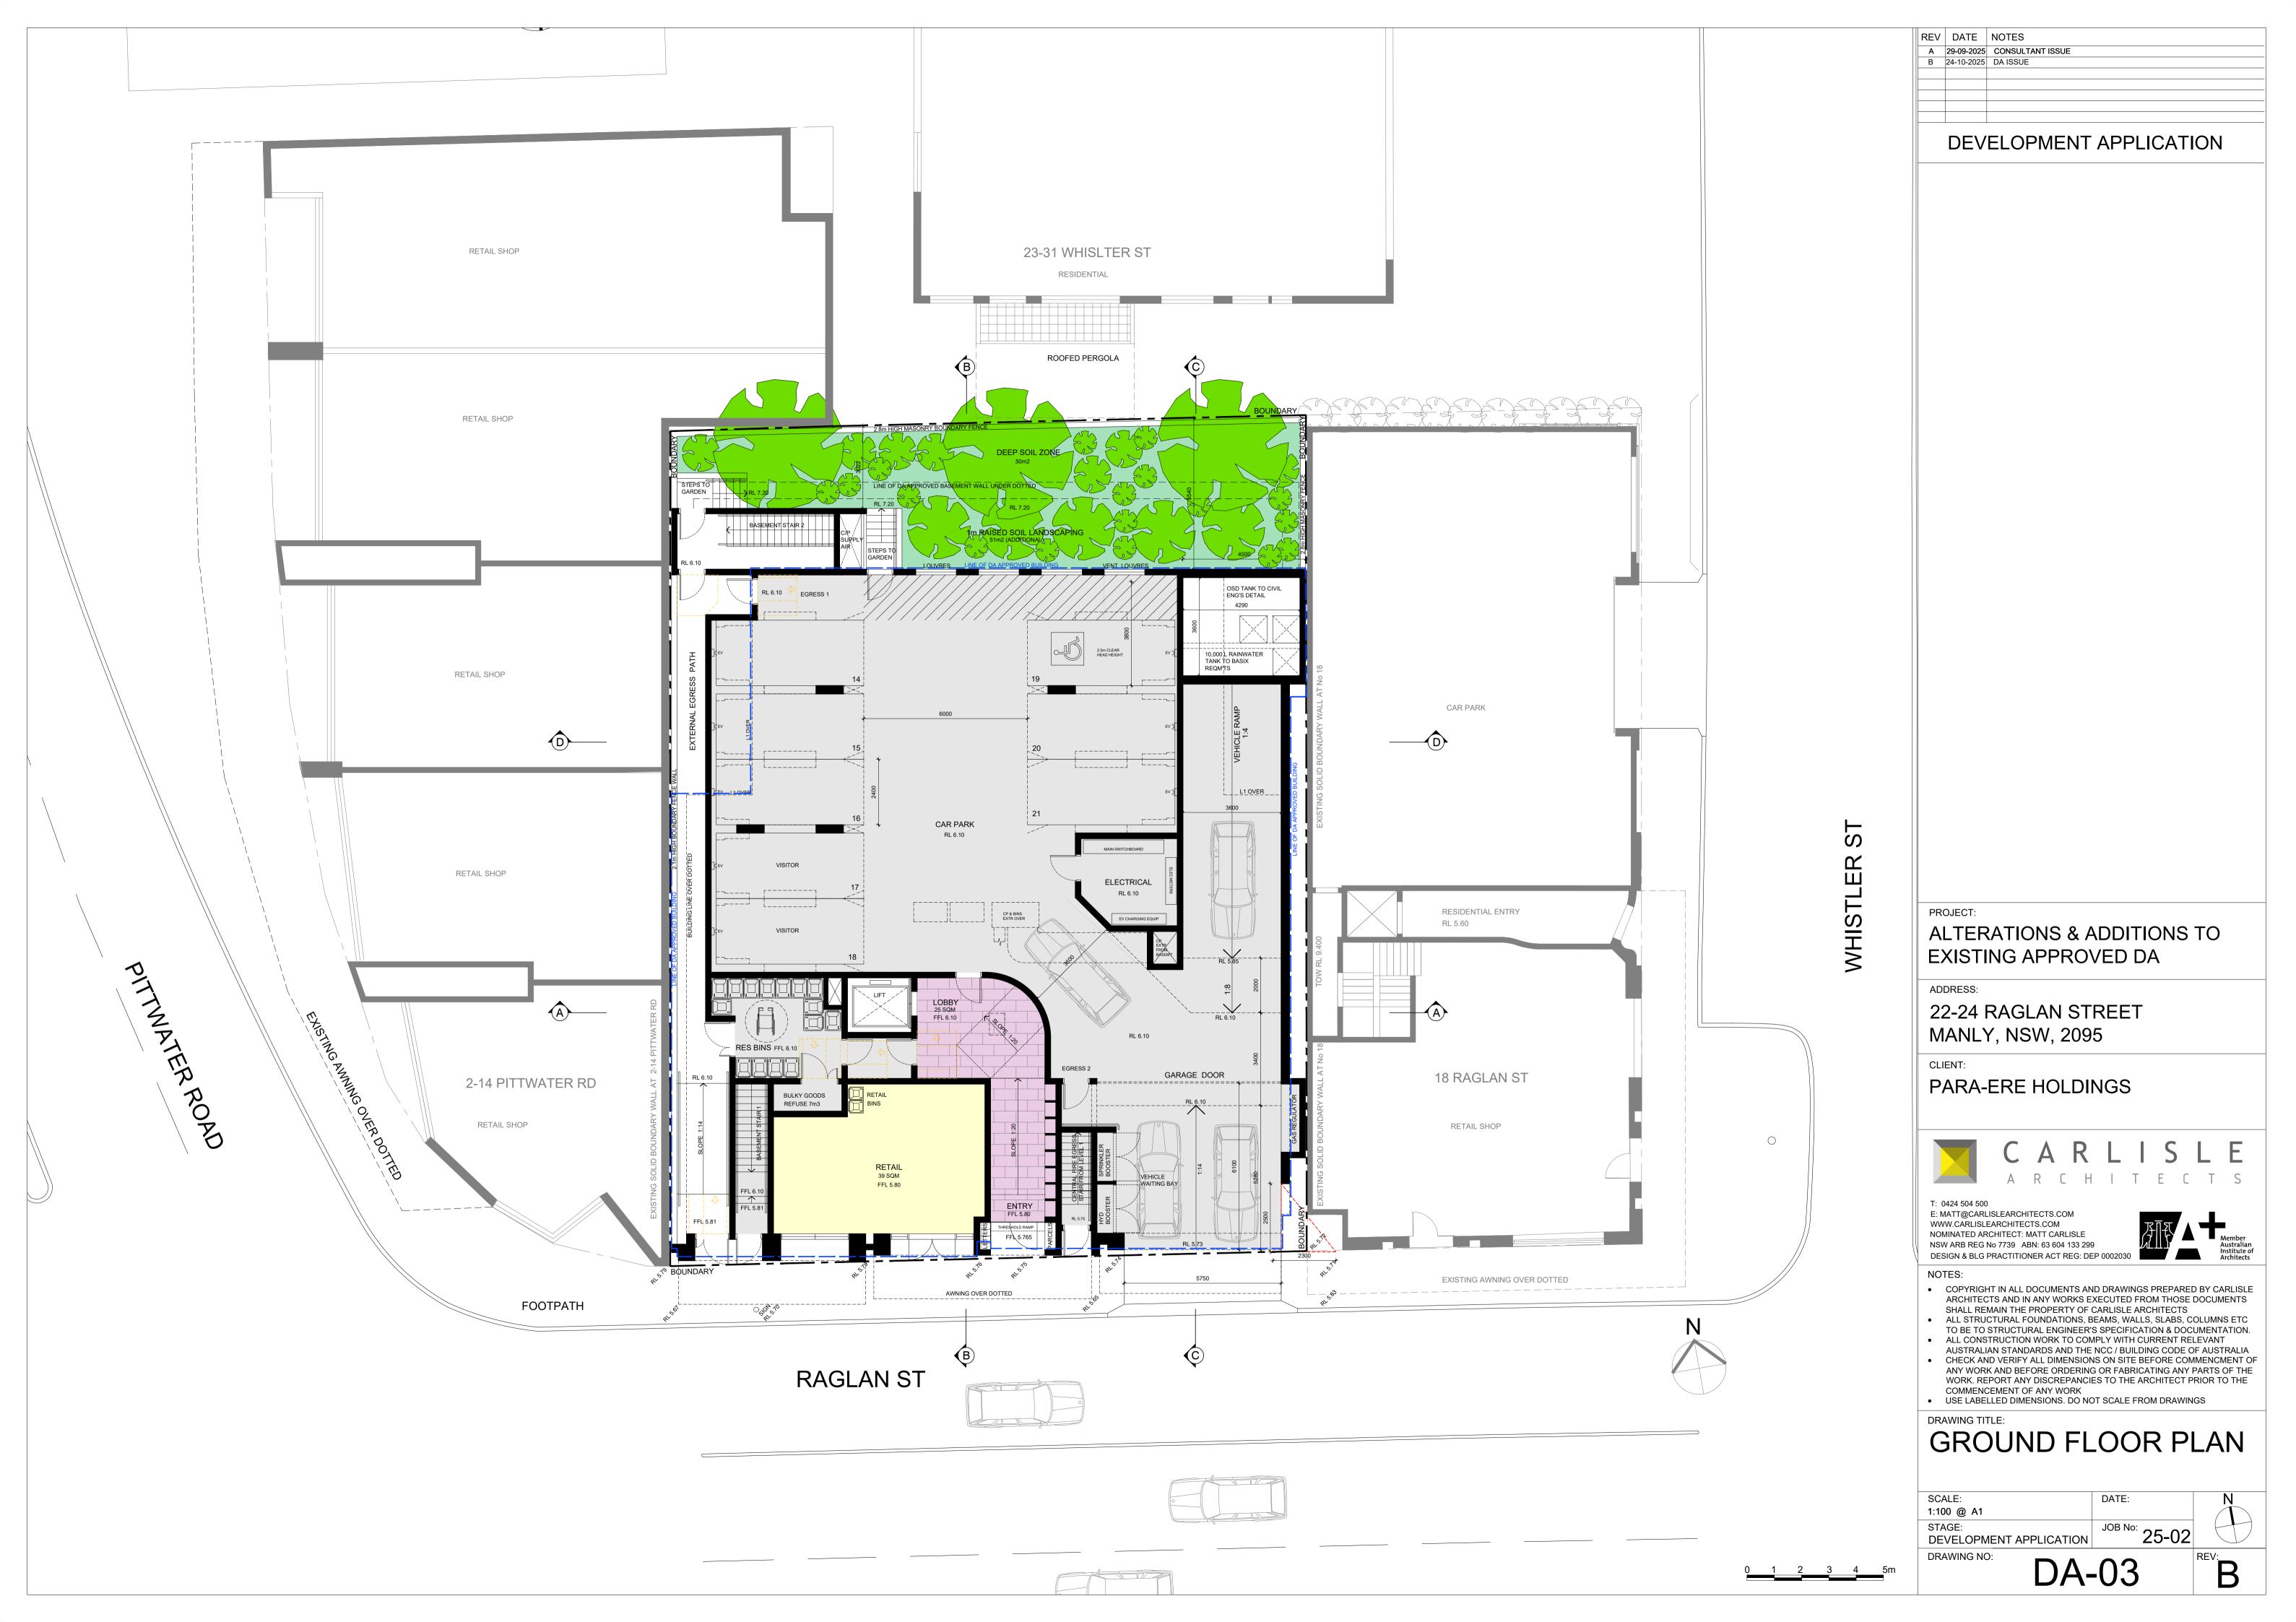
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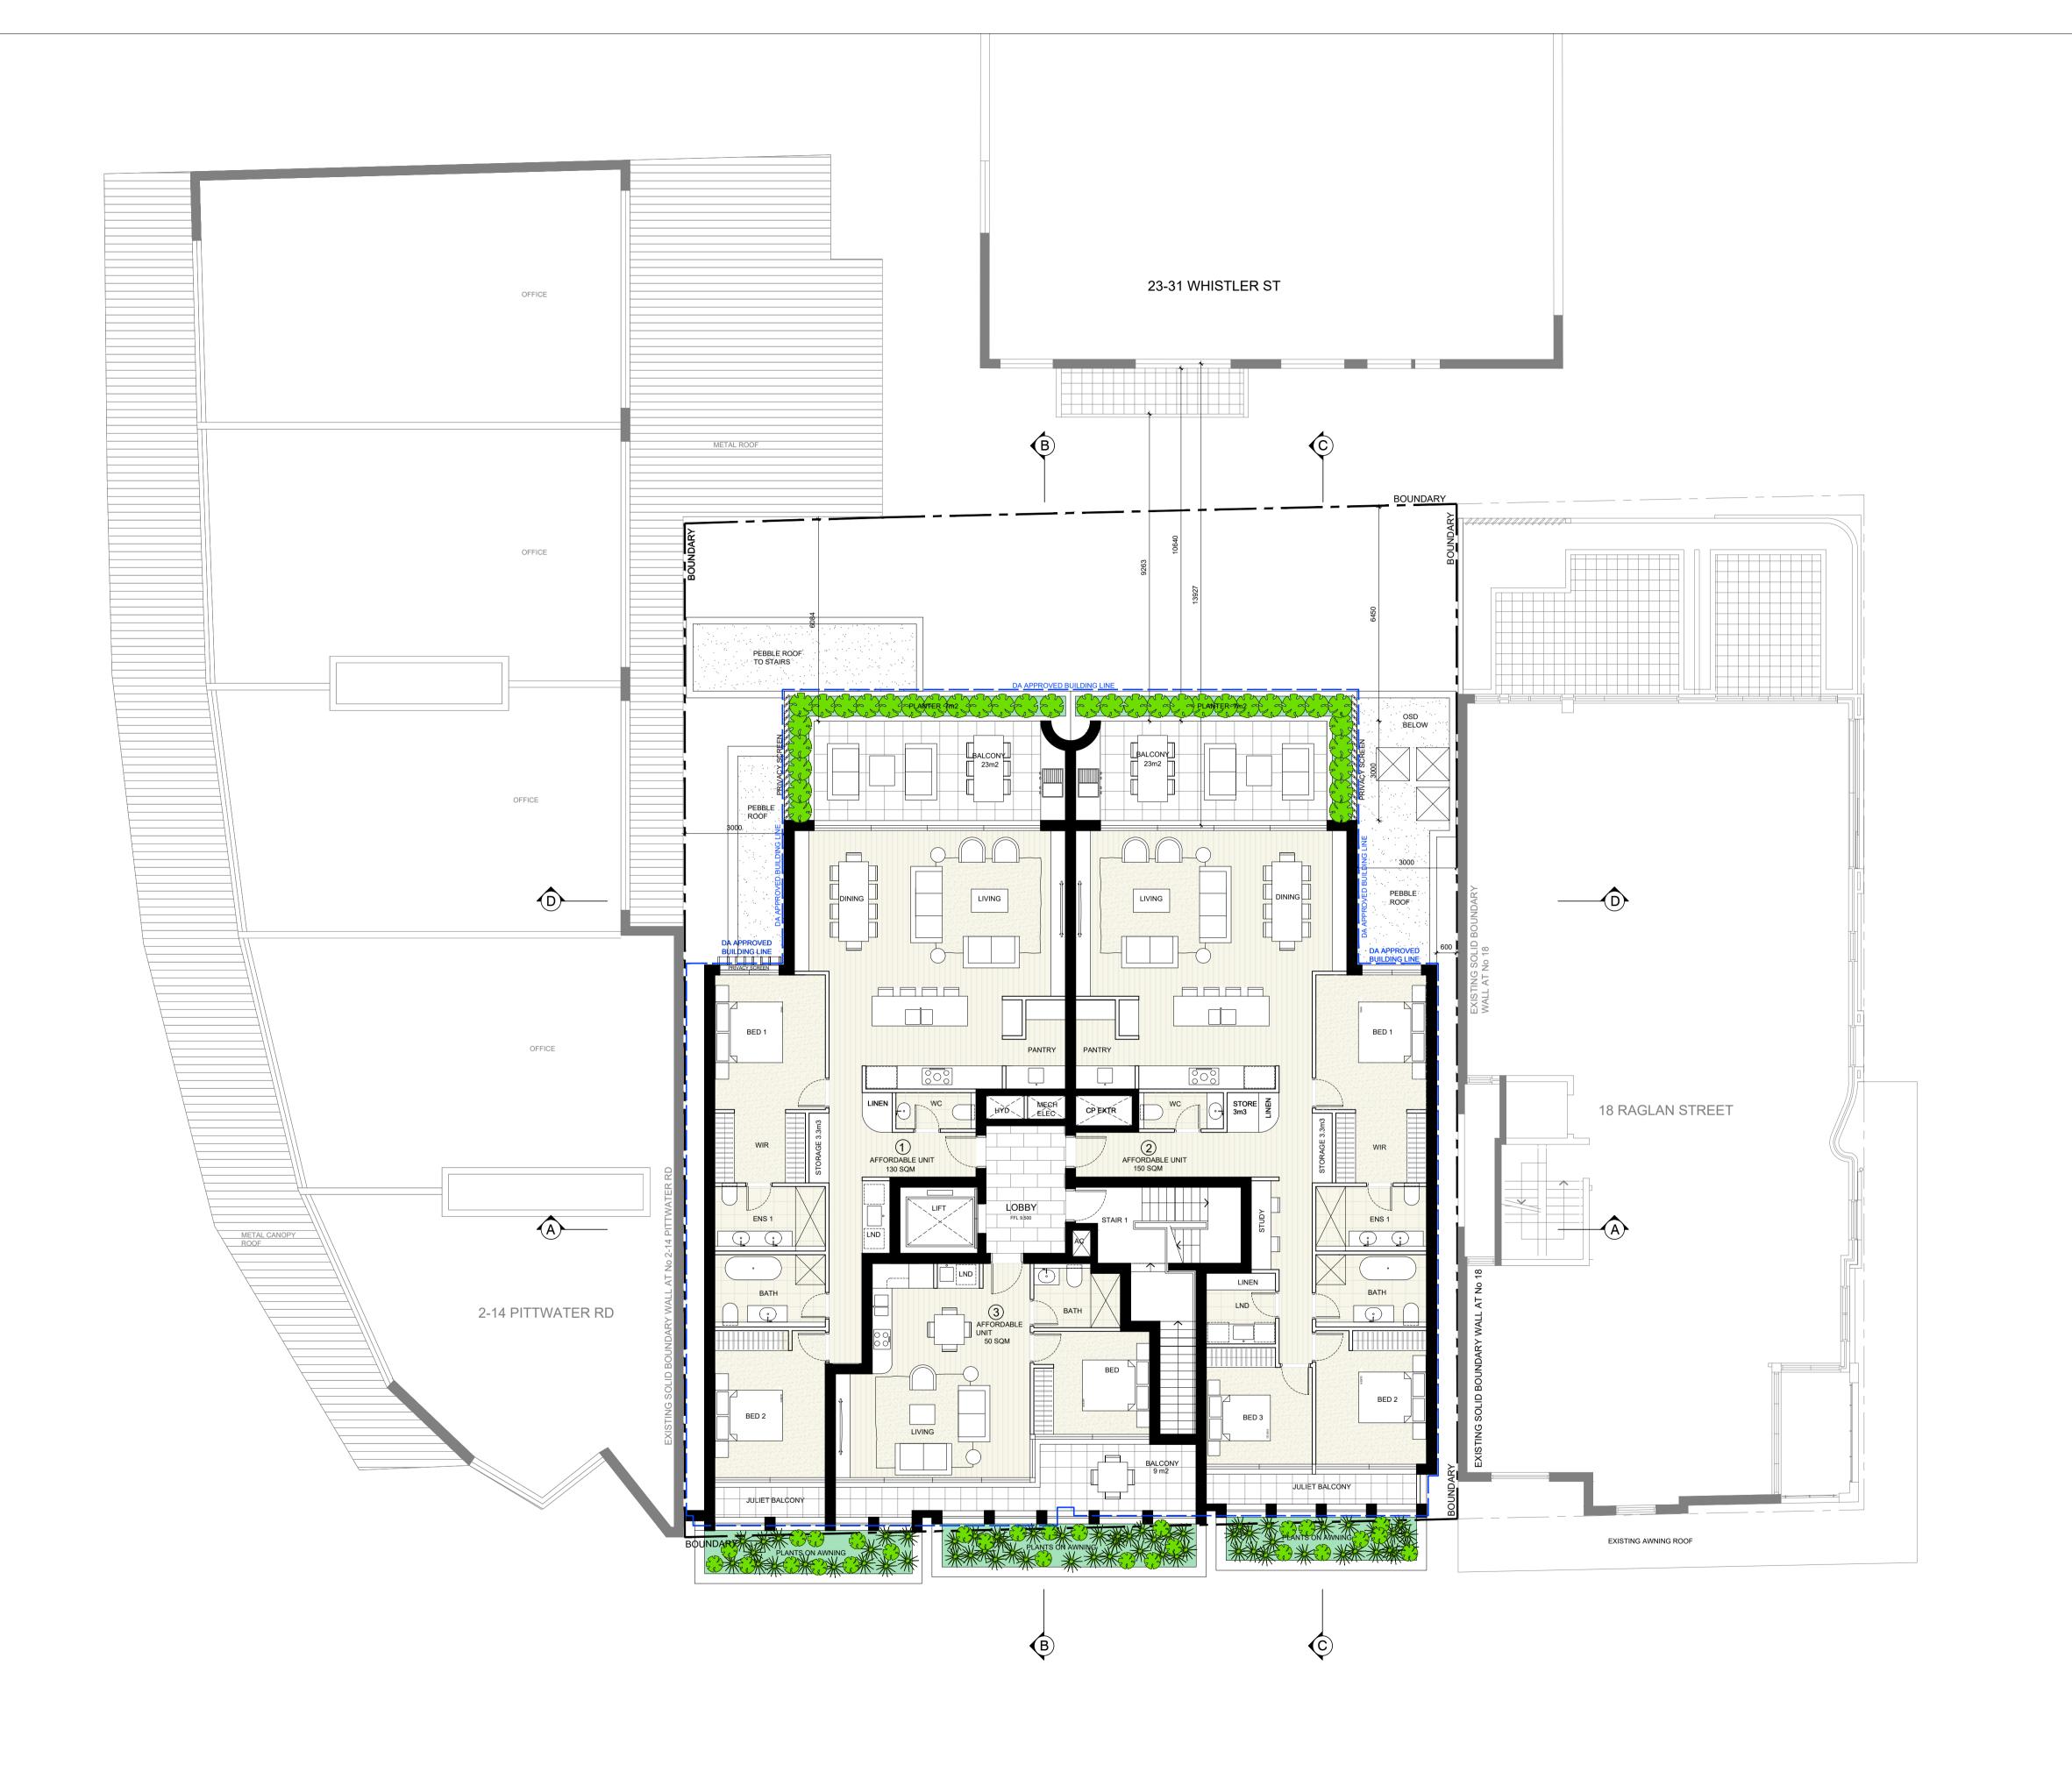
# BASEMENT PLAN

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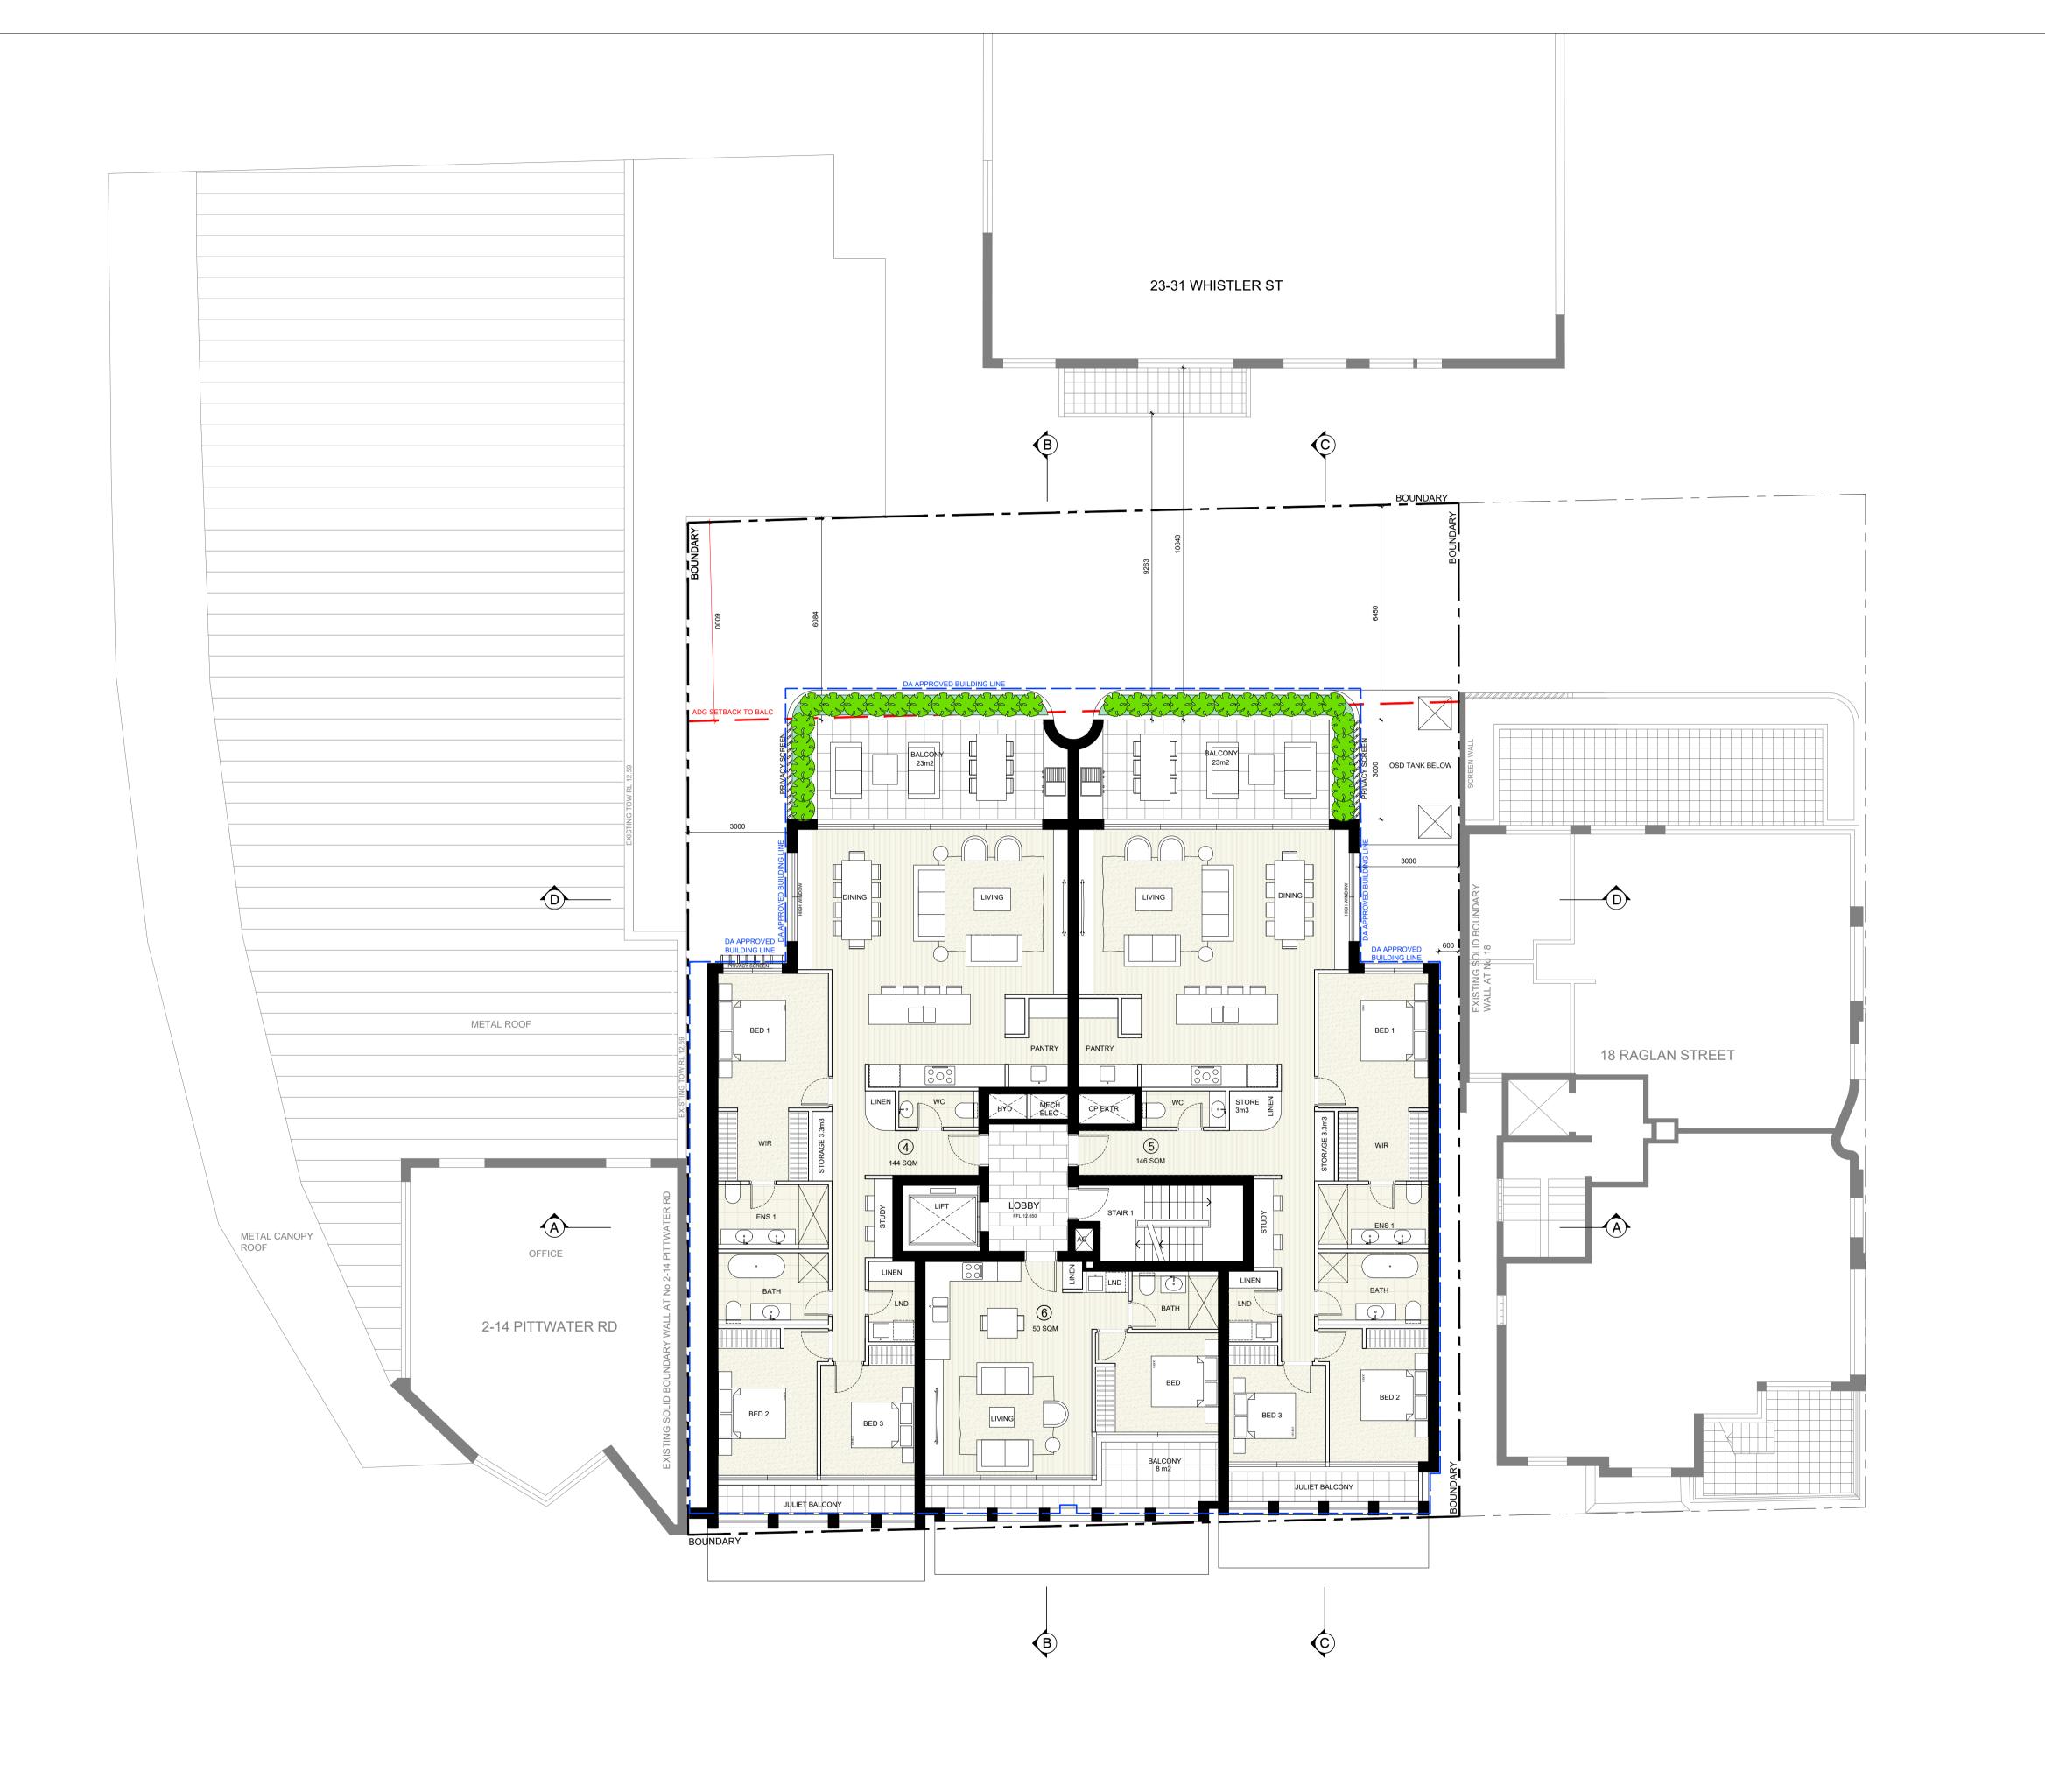
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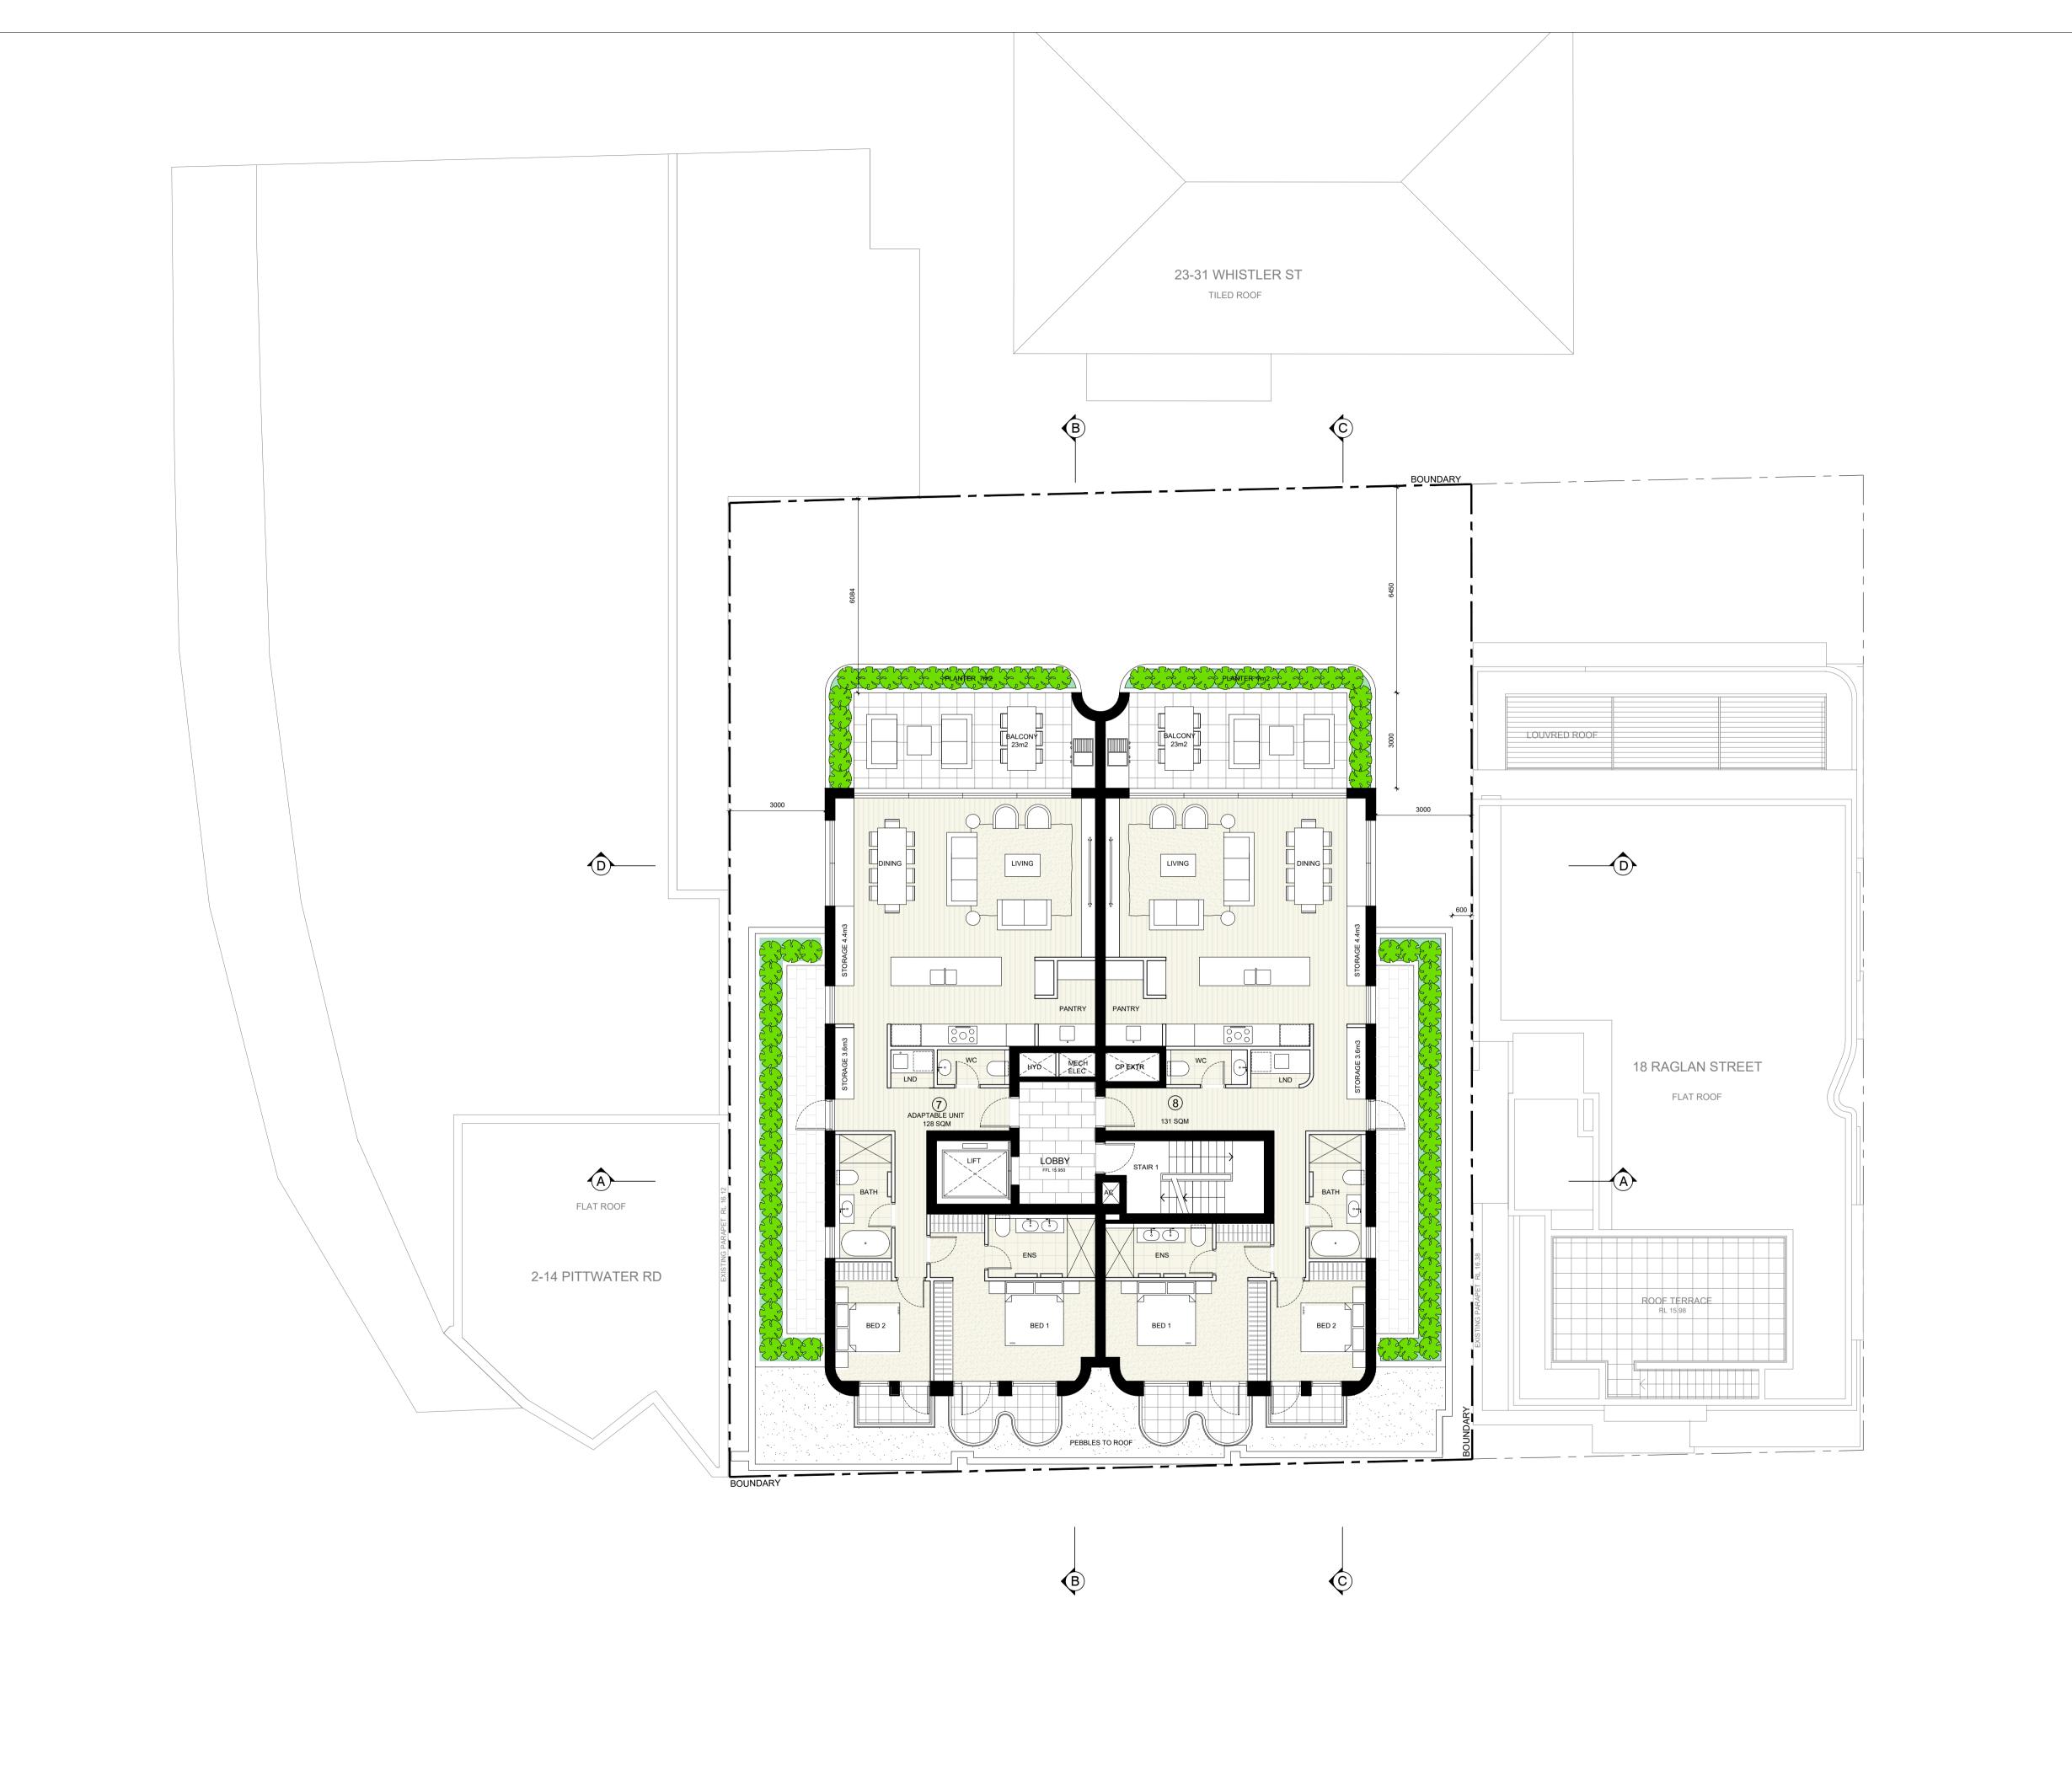
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LEVEL 02 PLAN

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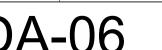
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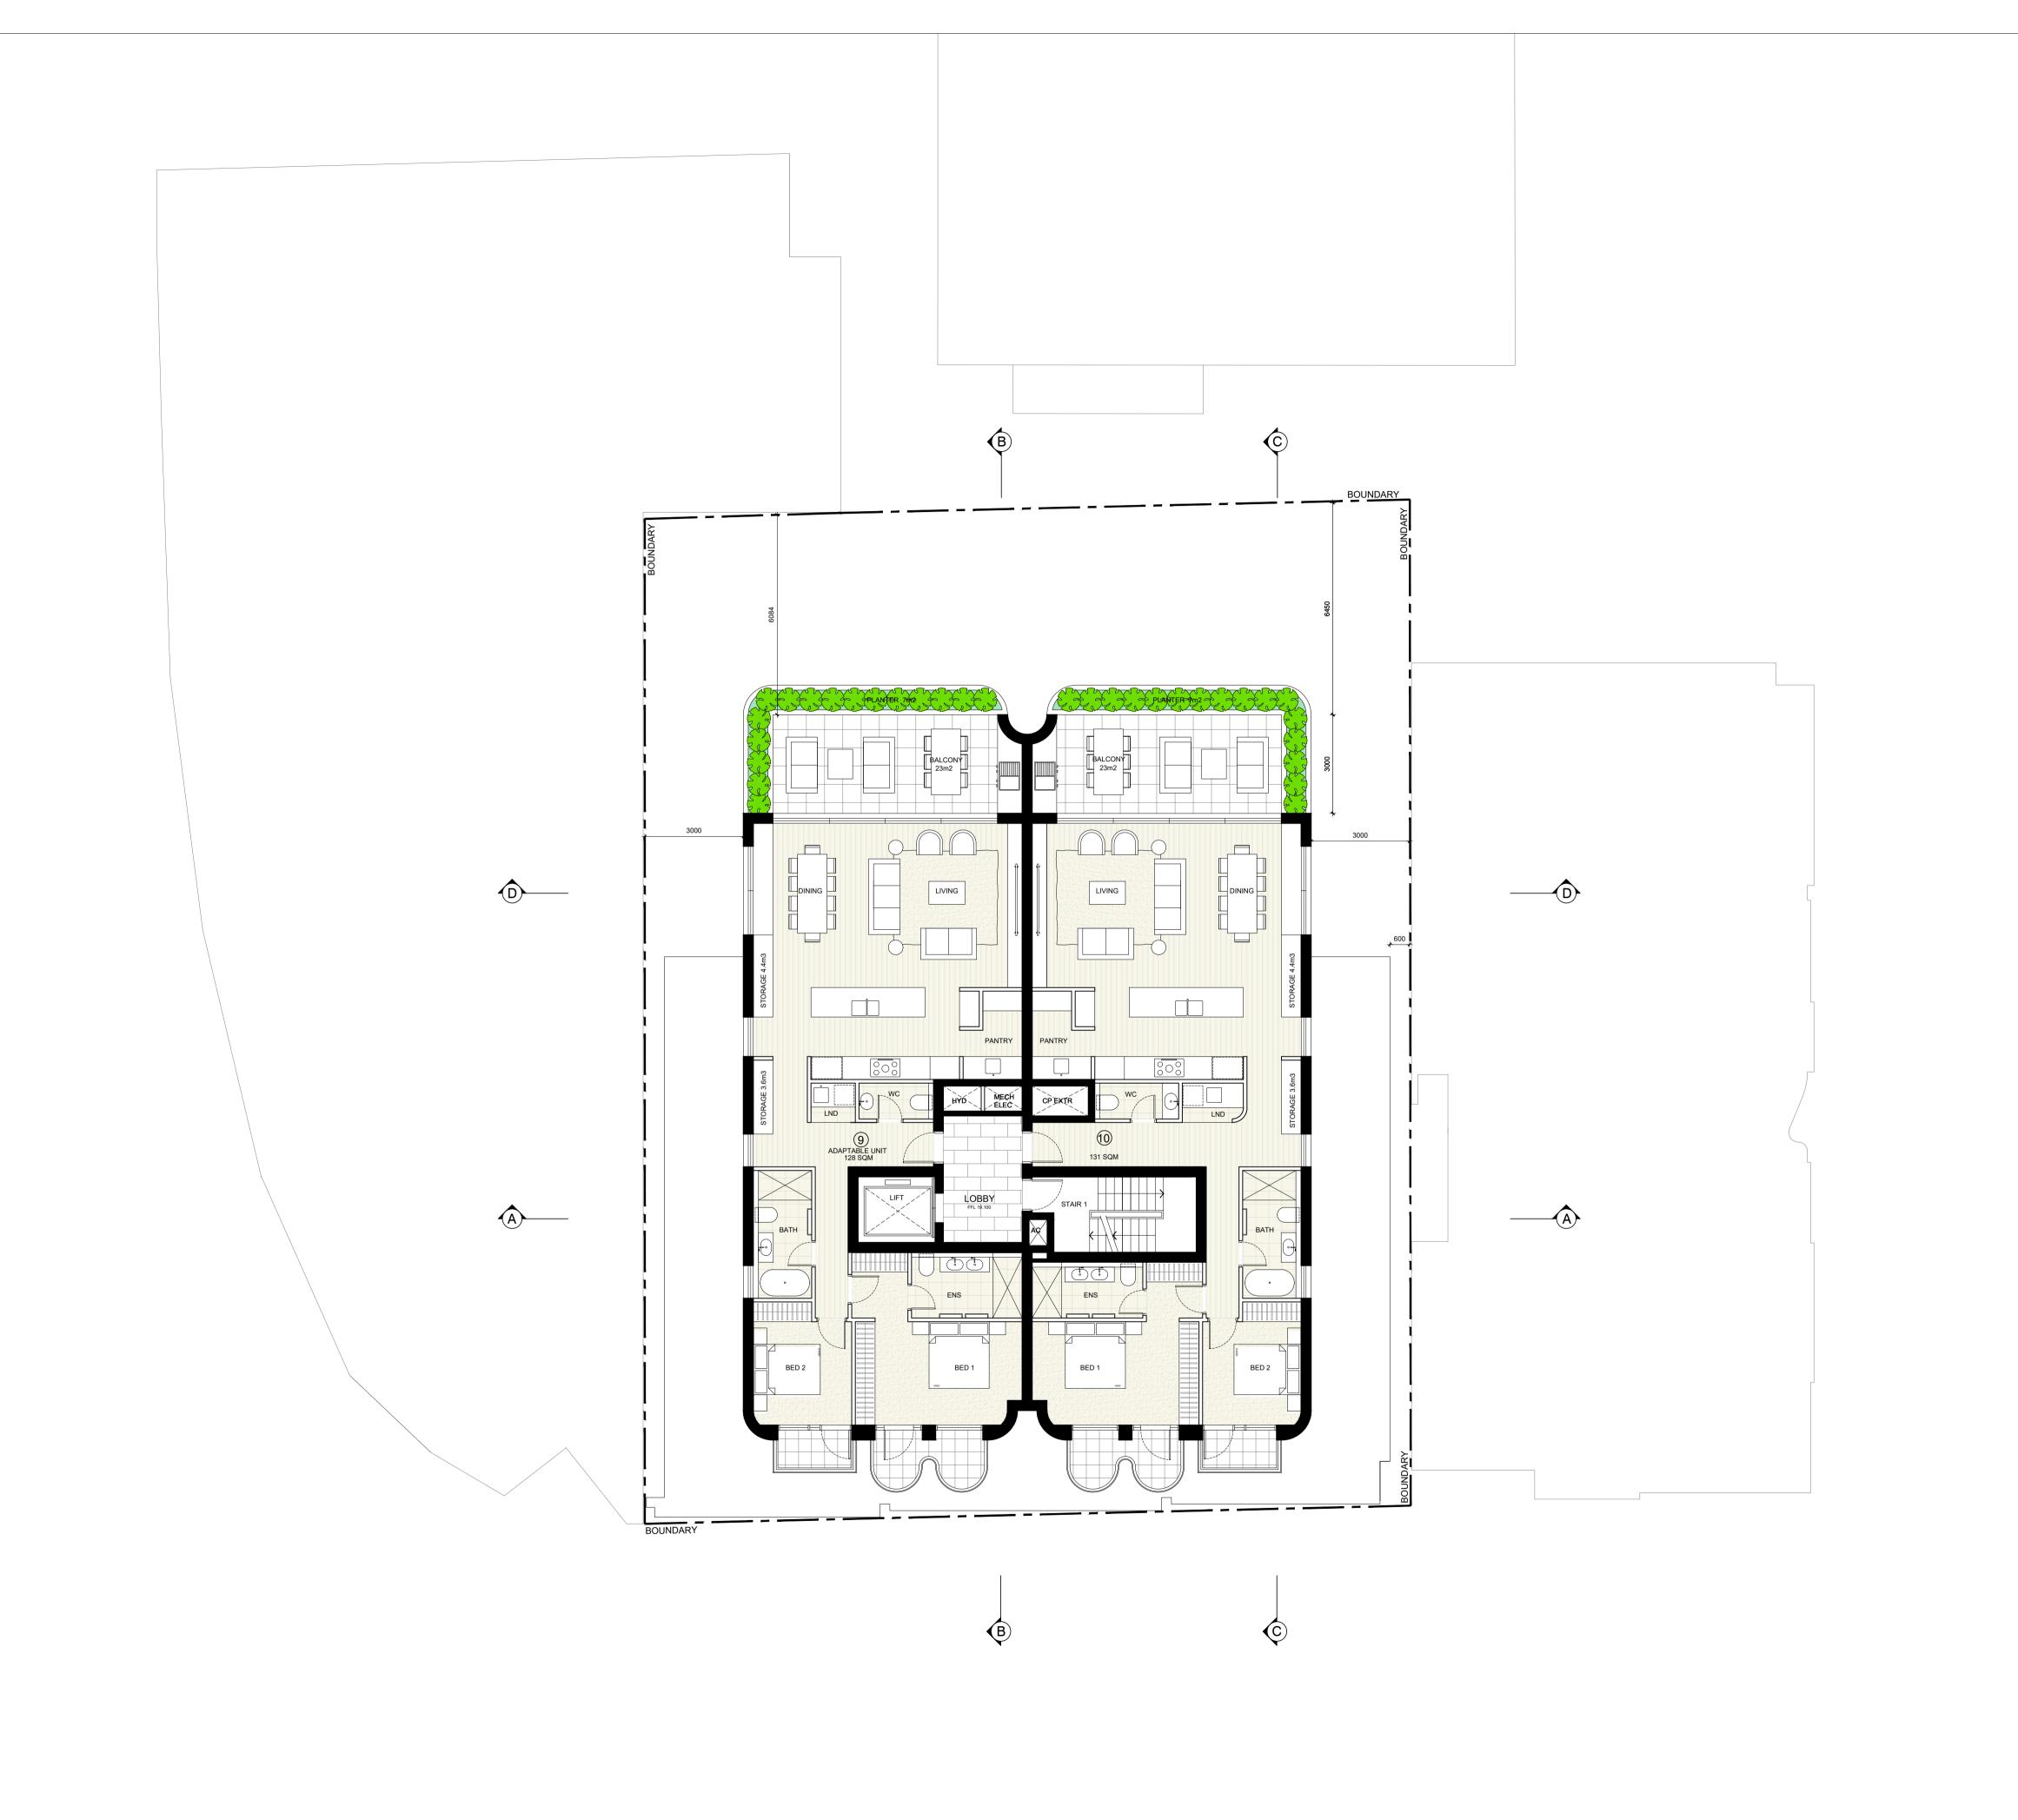
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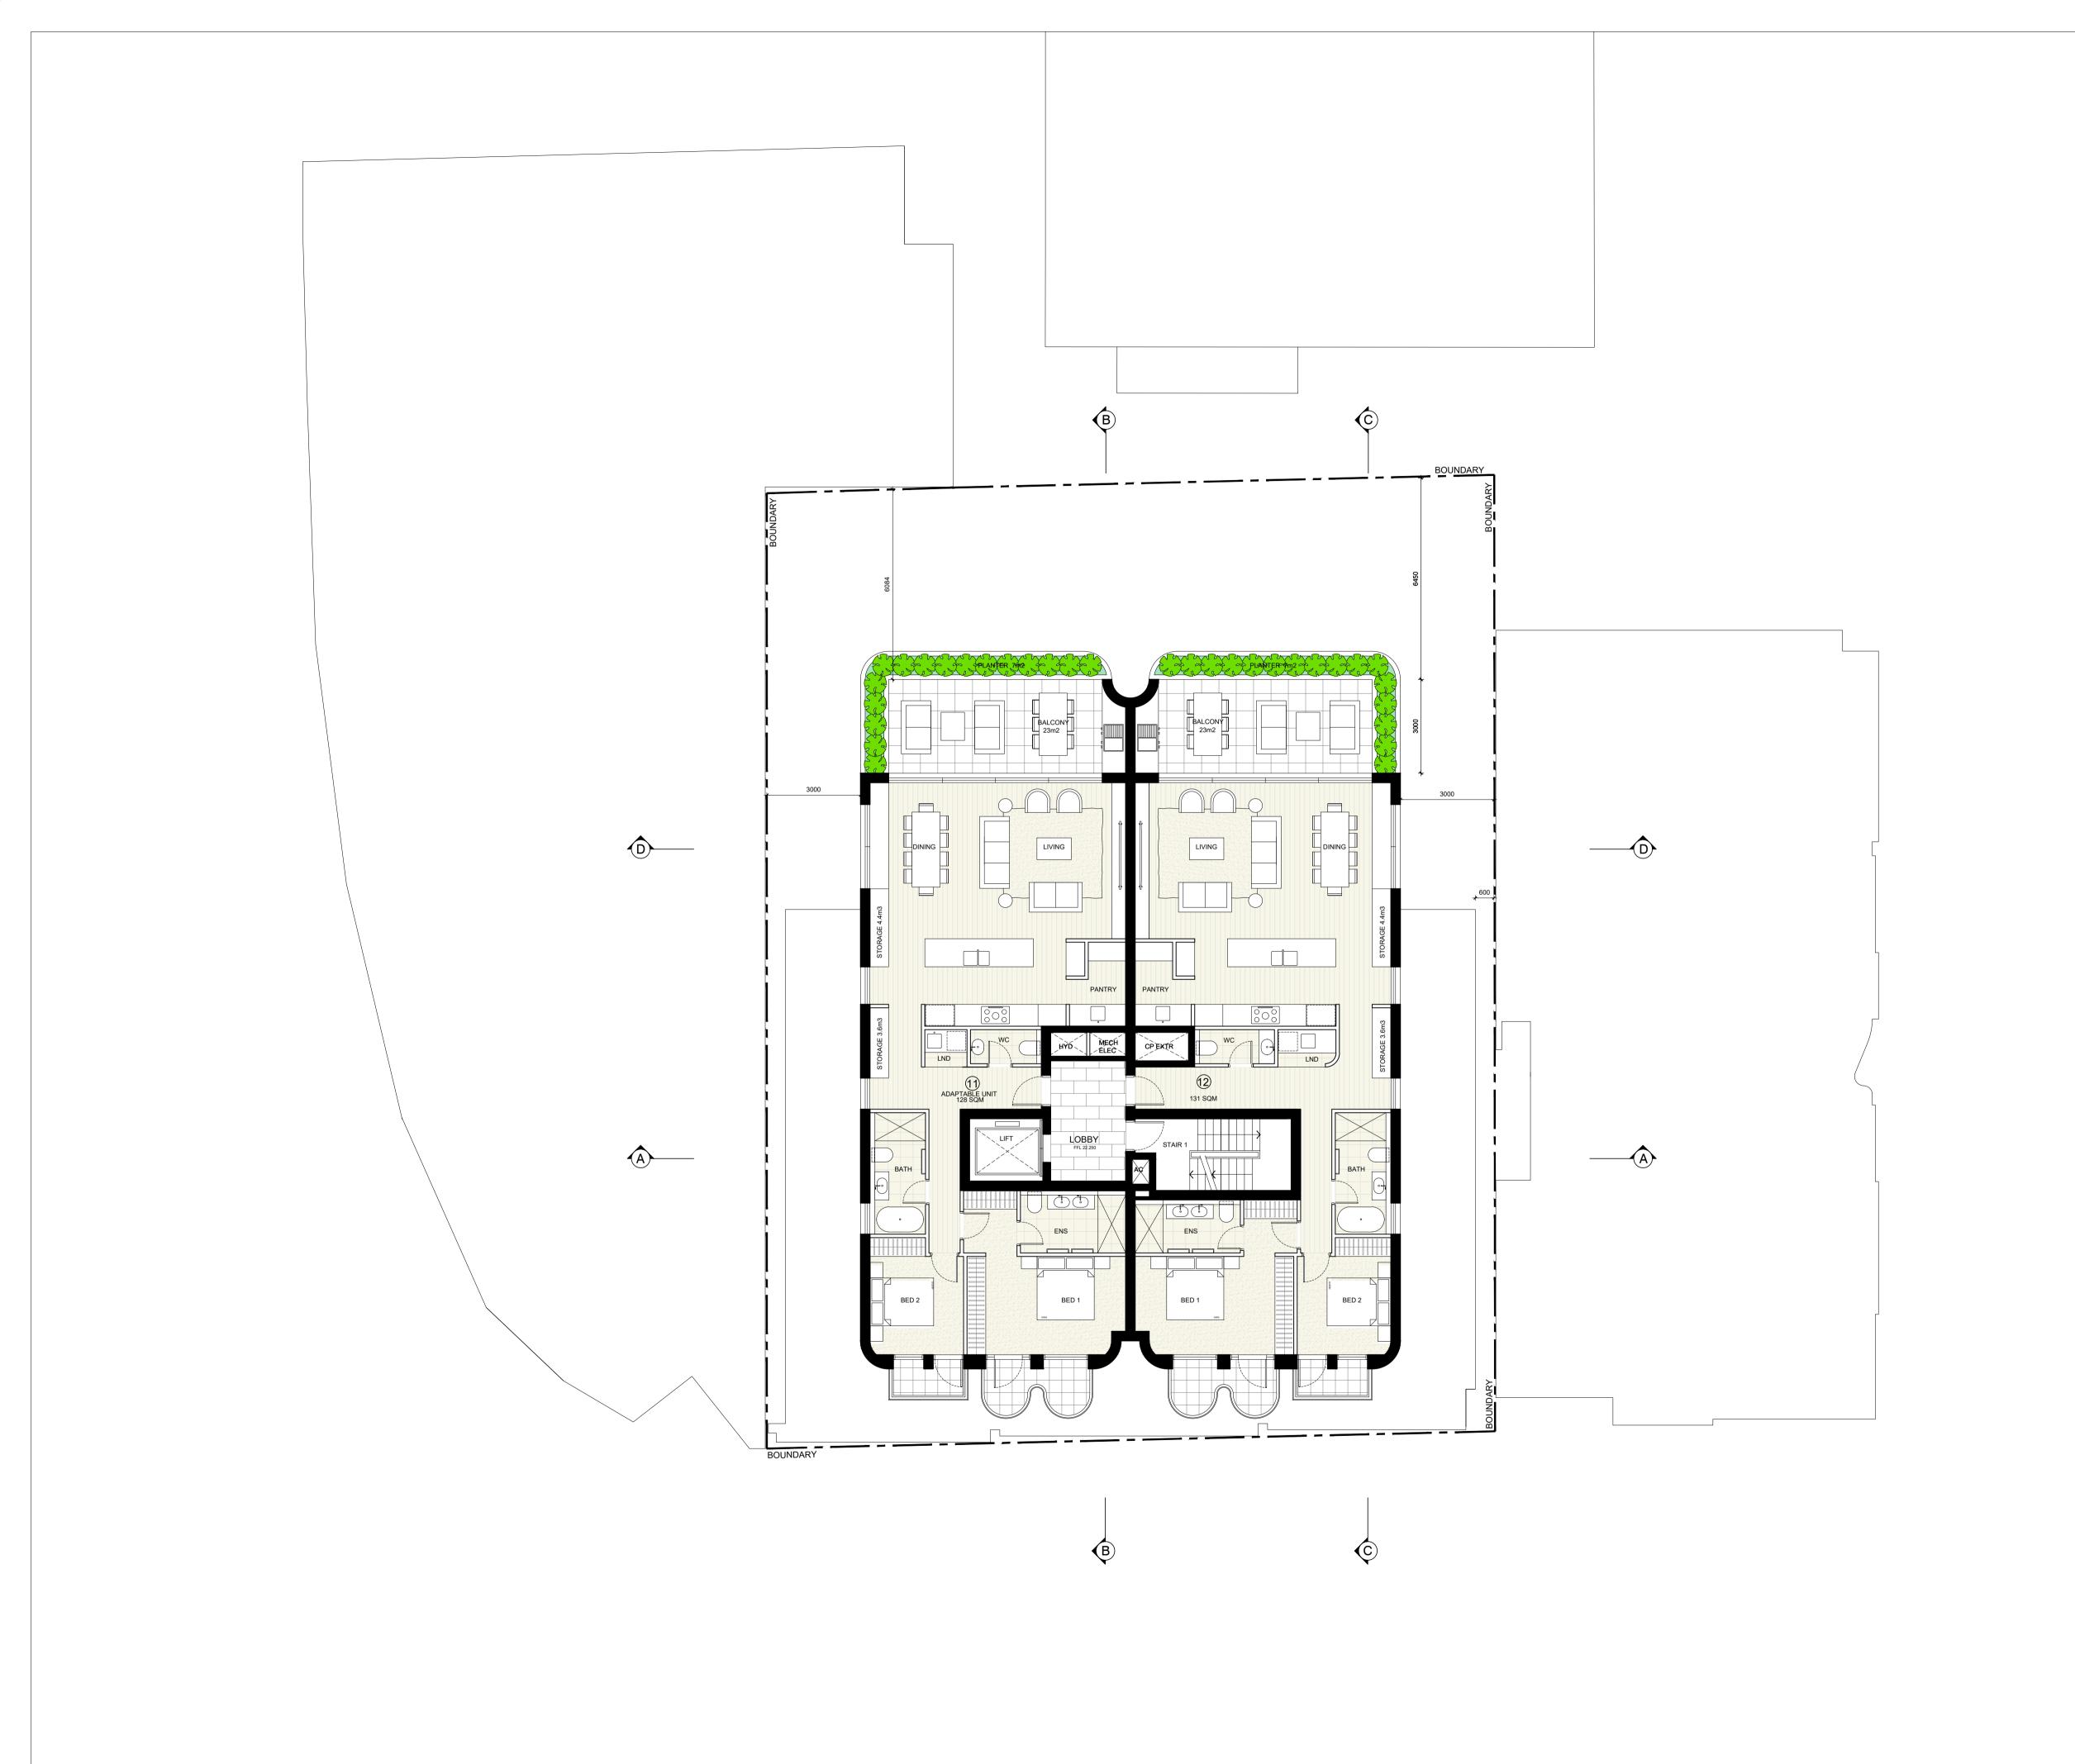
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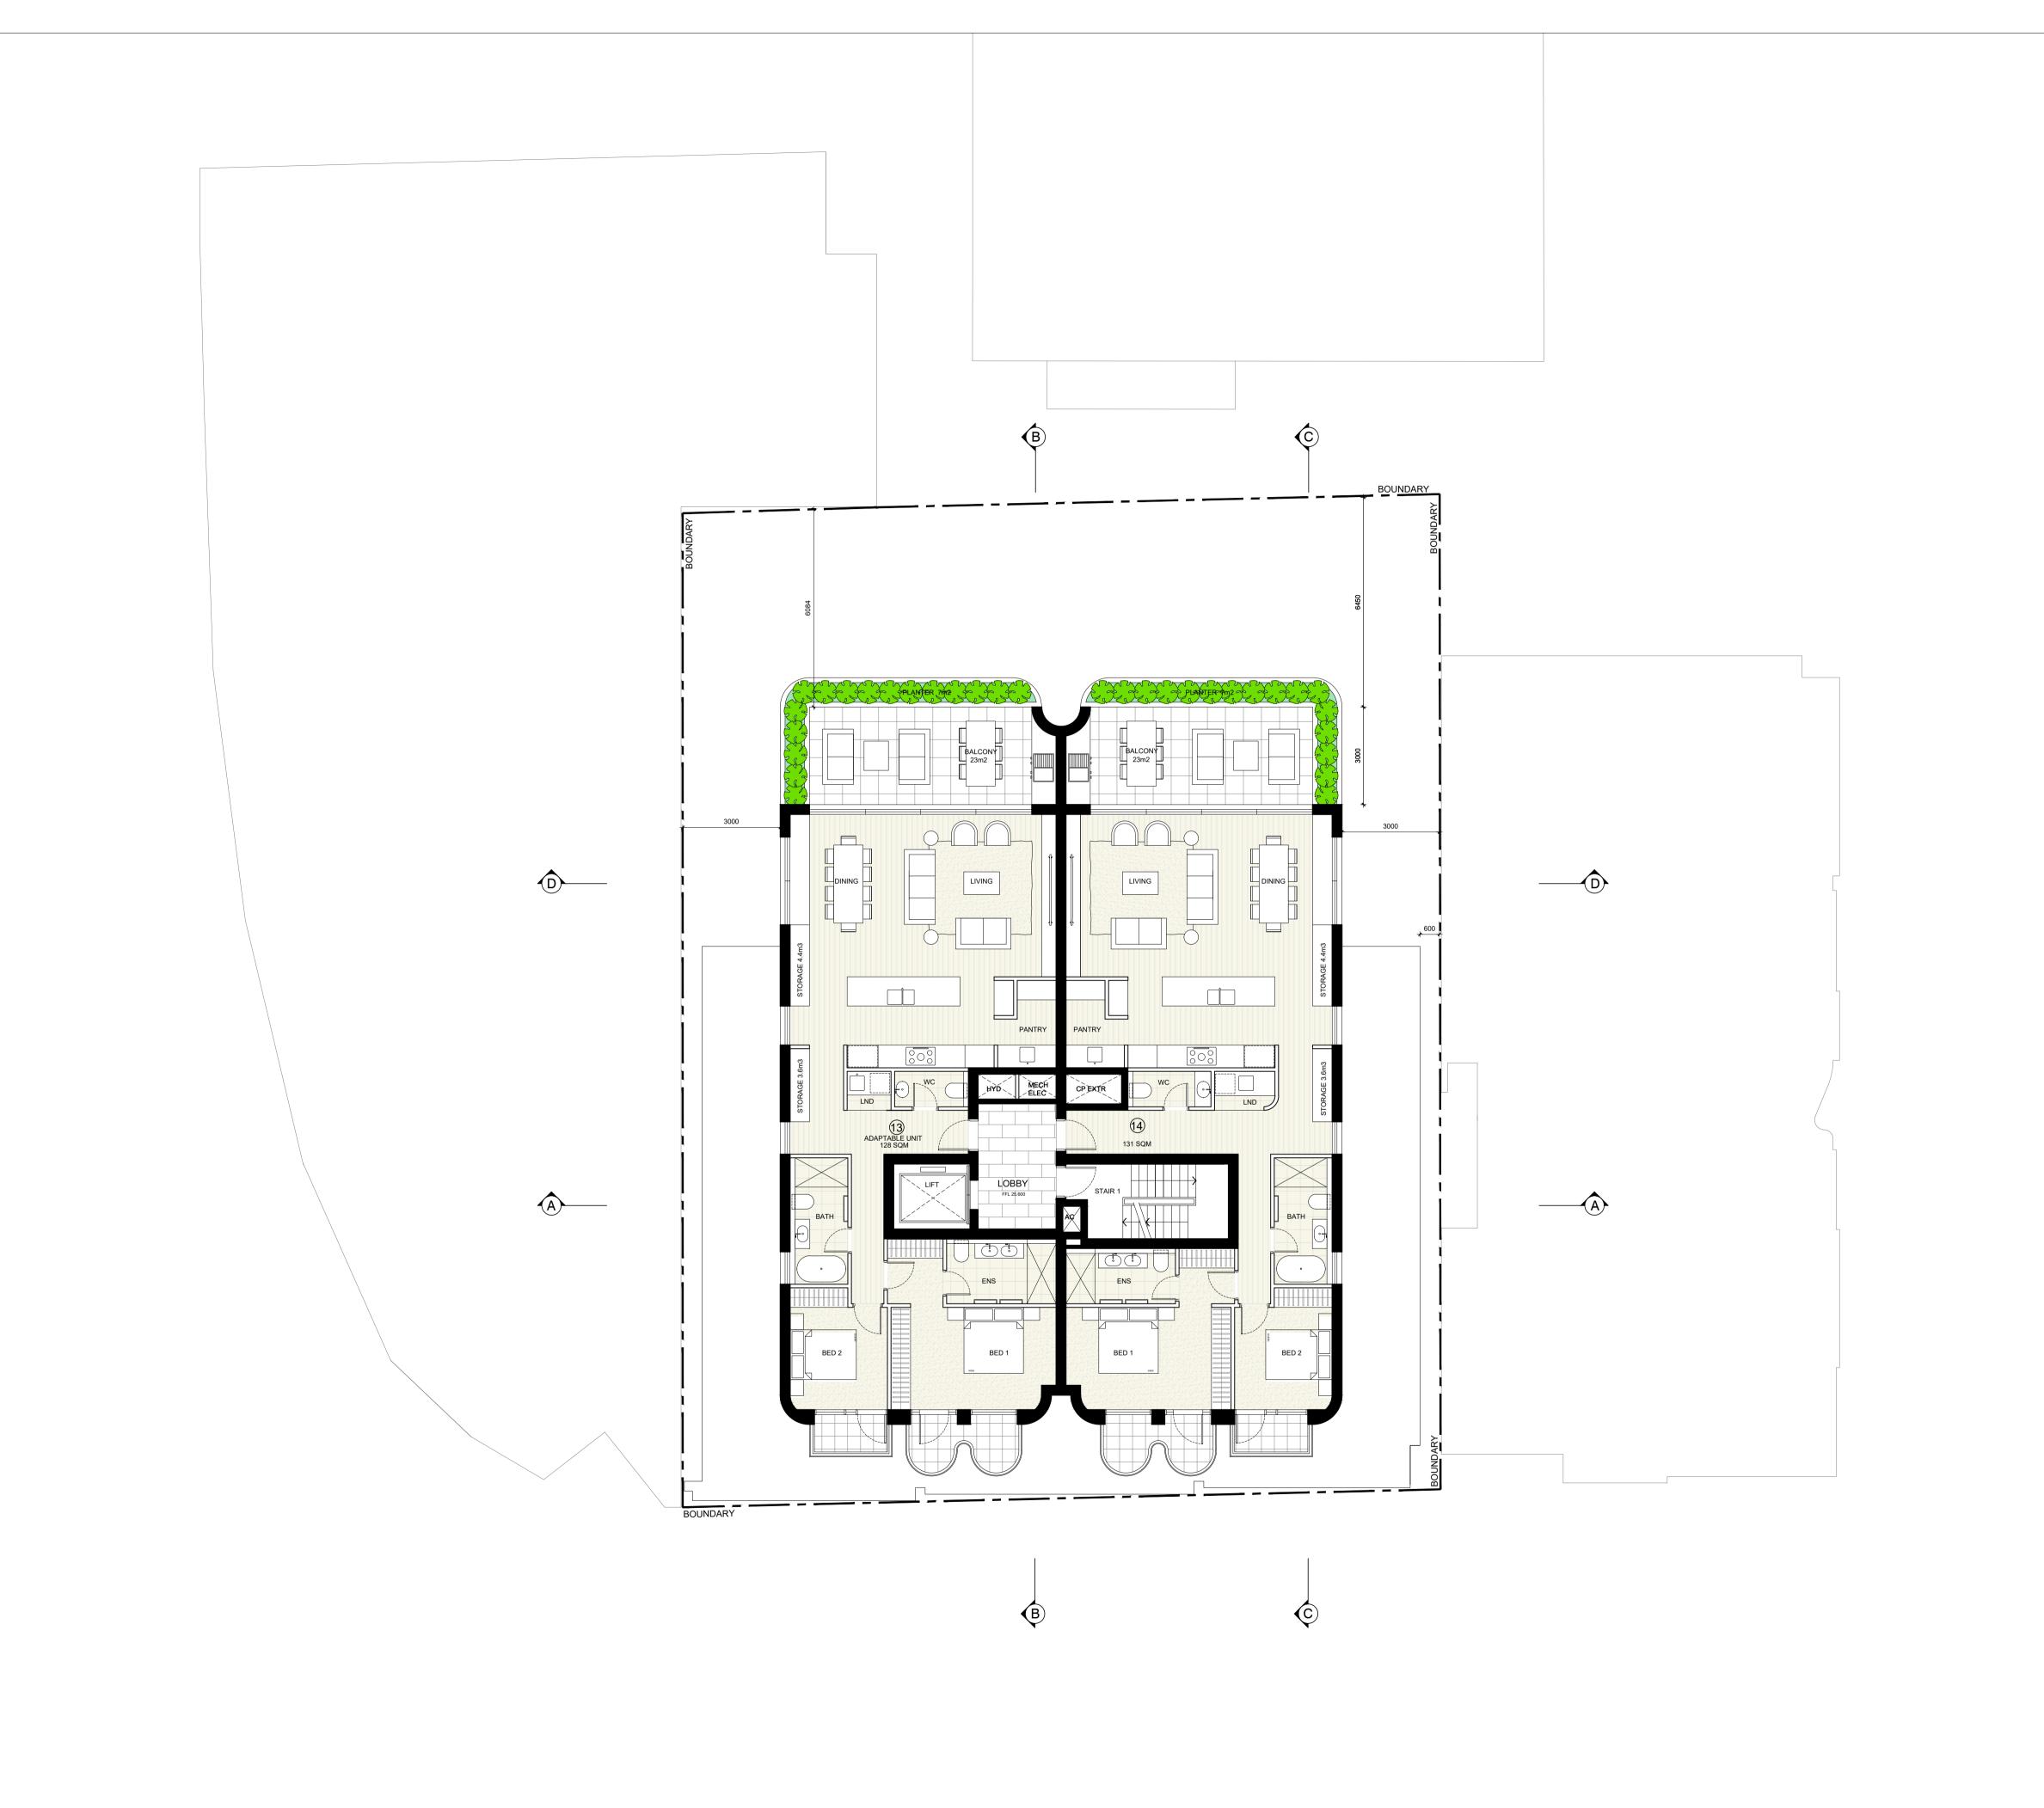
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22-24 RAGLAN STREET MANLY, NSW, 2095

CLIENT:

PARA-ERE HOLDINGS



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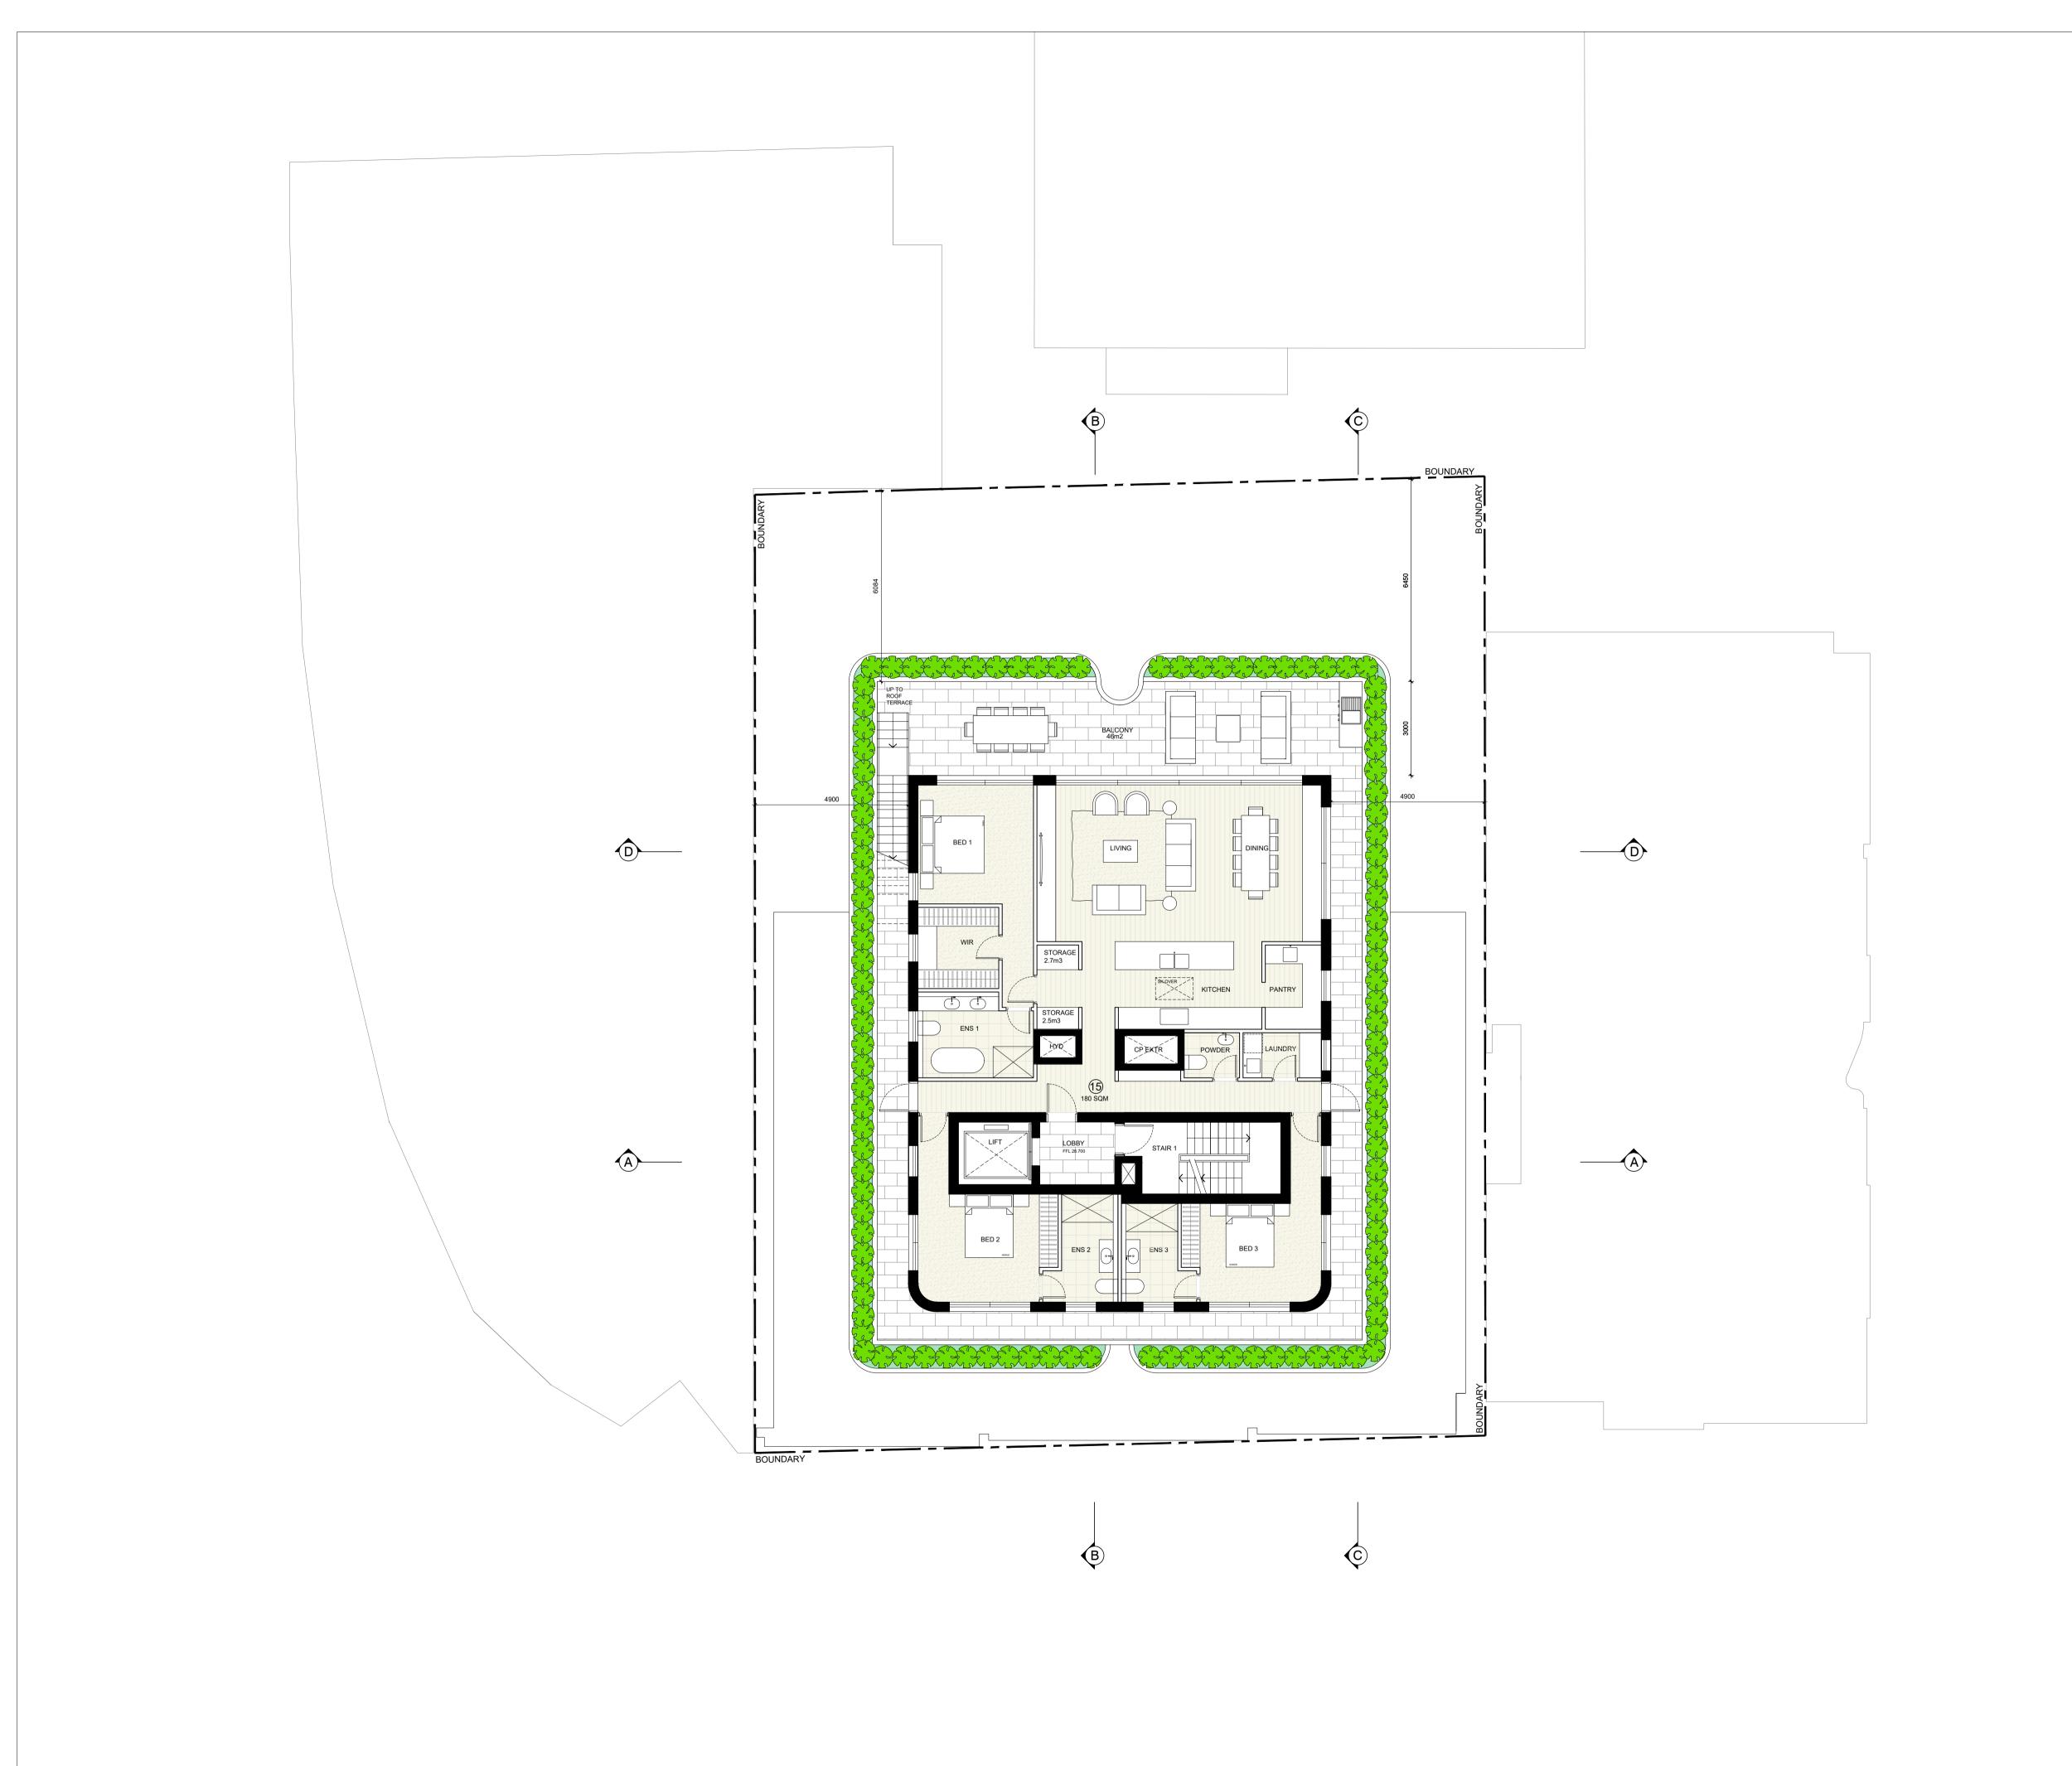
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## LEVEL 06 PLAN

SCALE: 1:100 @ A1 DEVELOPMENT APPLICATION

DRAWING NO:



DEVELOPMENT APPLICATION

REV DATE NOTES

A 29-09-2025 CONSULTANT ISSUE
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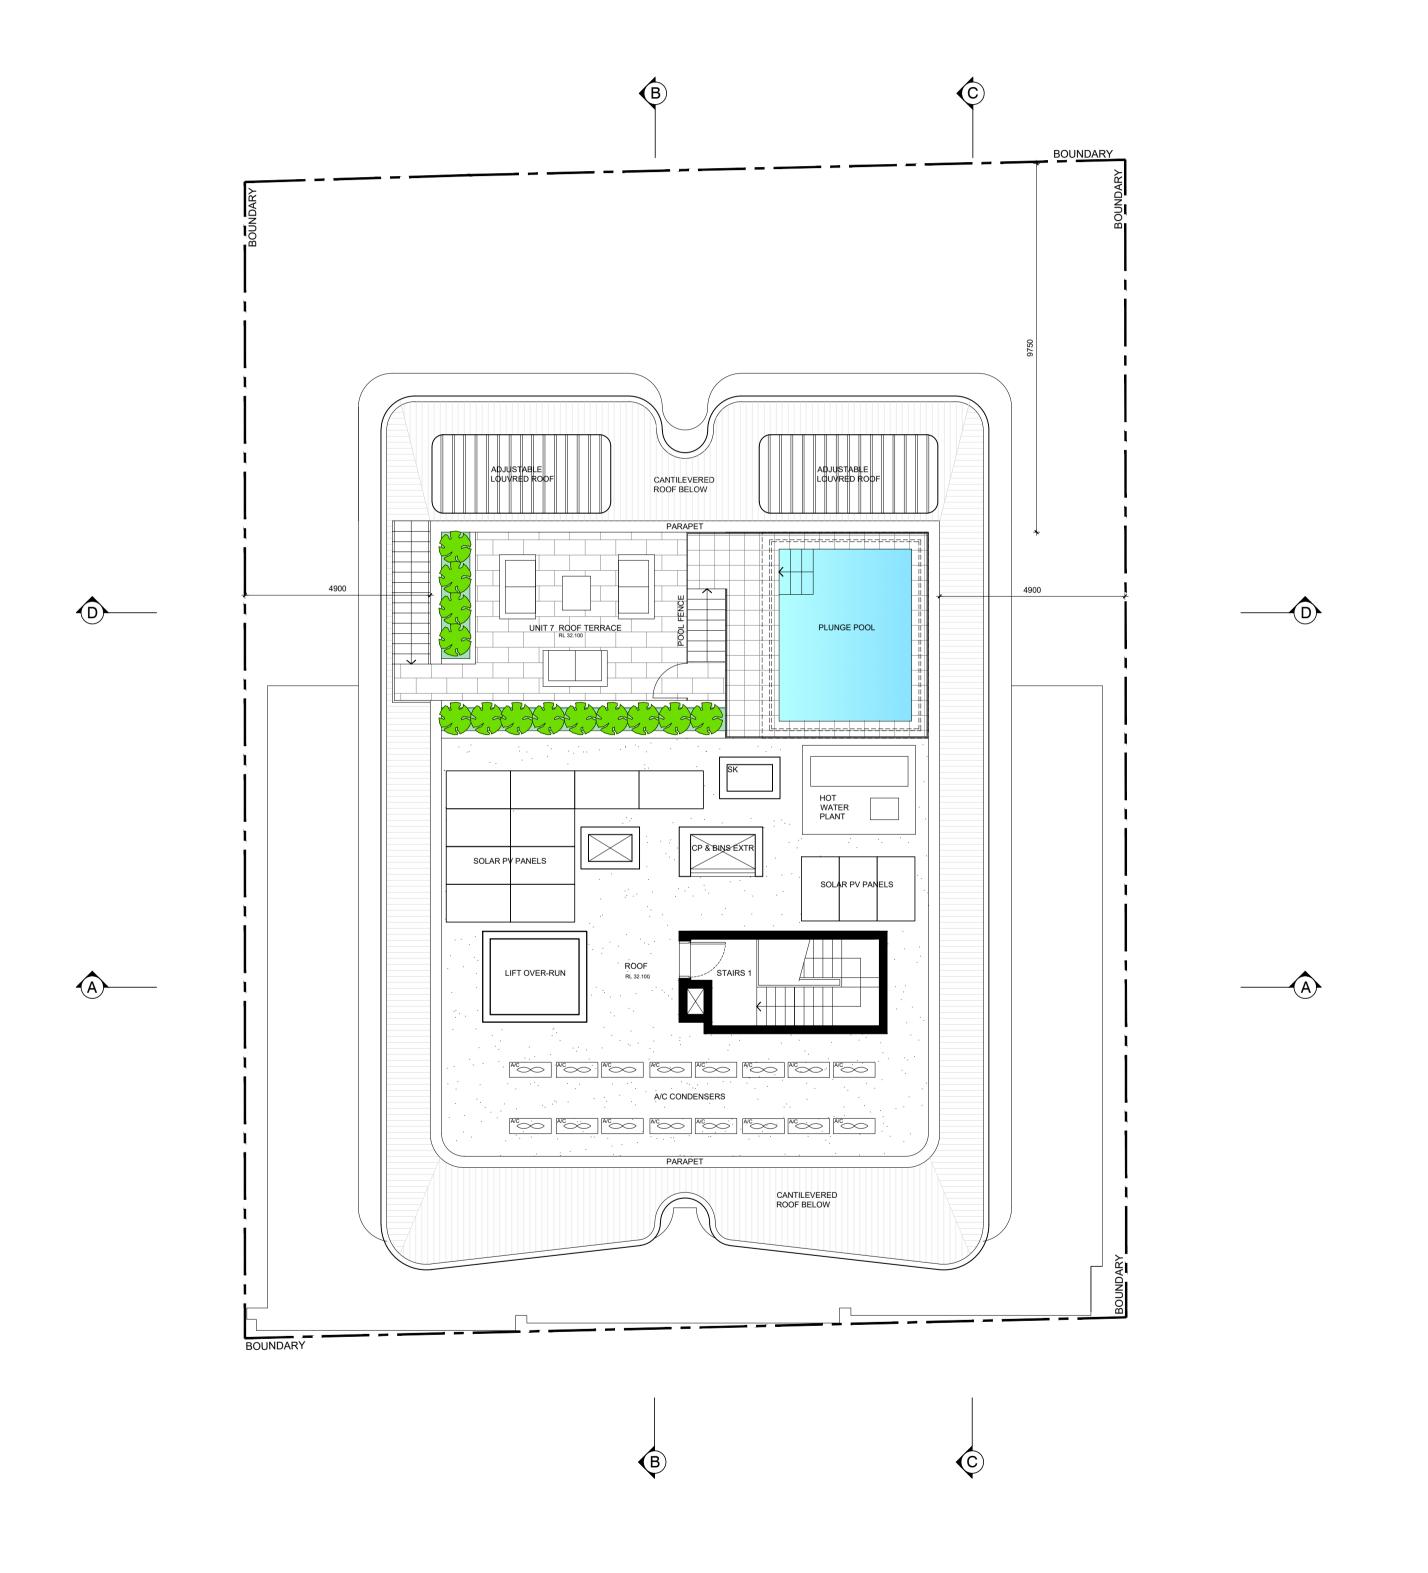
## LEVEL 07 PLAN

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B

DA-10



#### DEVELOPMENT APPLICATION

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DRAWING TITLE:

DRAWING NO:

## **ROOF PLAN**

SCALE: 1:100 @ A1 DEVELOPMENT APPLICATION

JOB No: 25-02

DA-11



SOUTH ELEVATION

DATE:

DEVELOPMENT APPLICATION DRAWING NO:






22 REV: B

DRAWING NO:



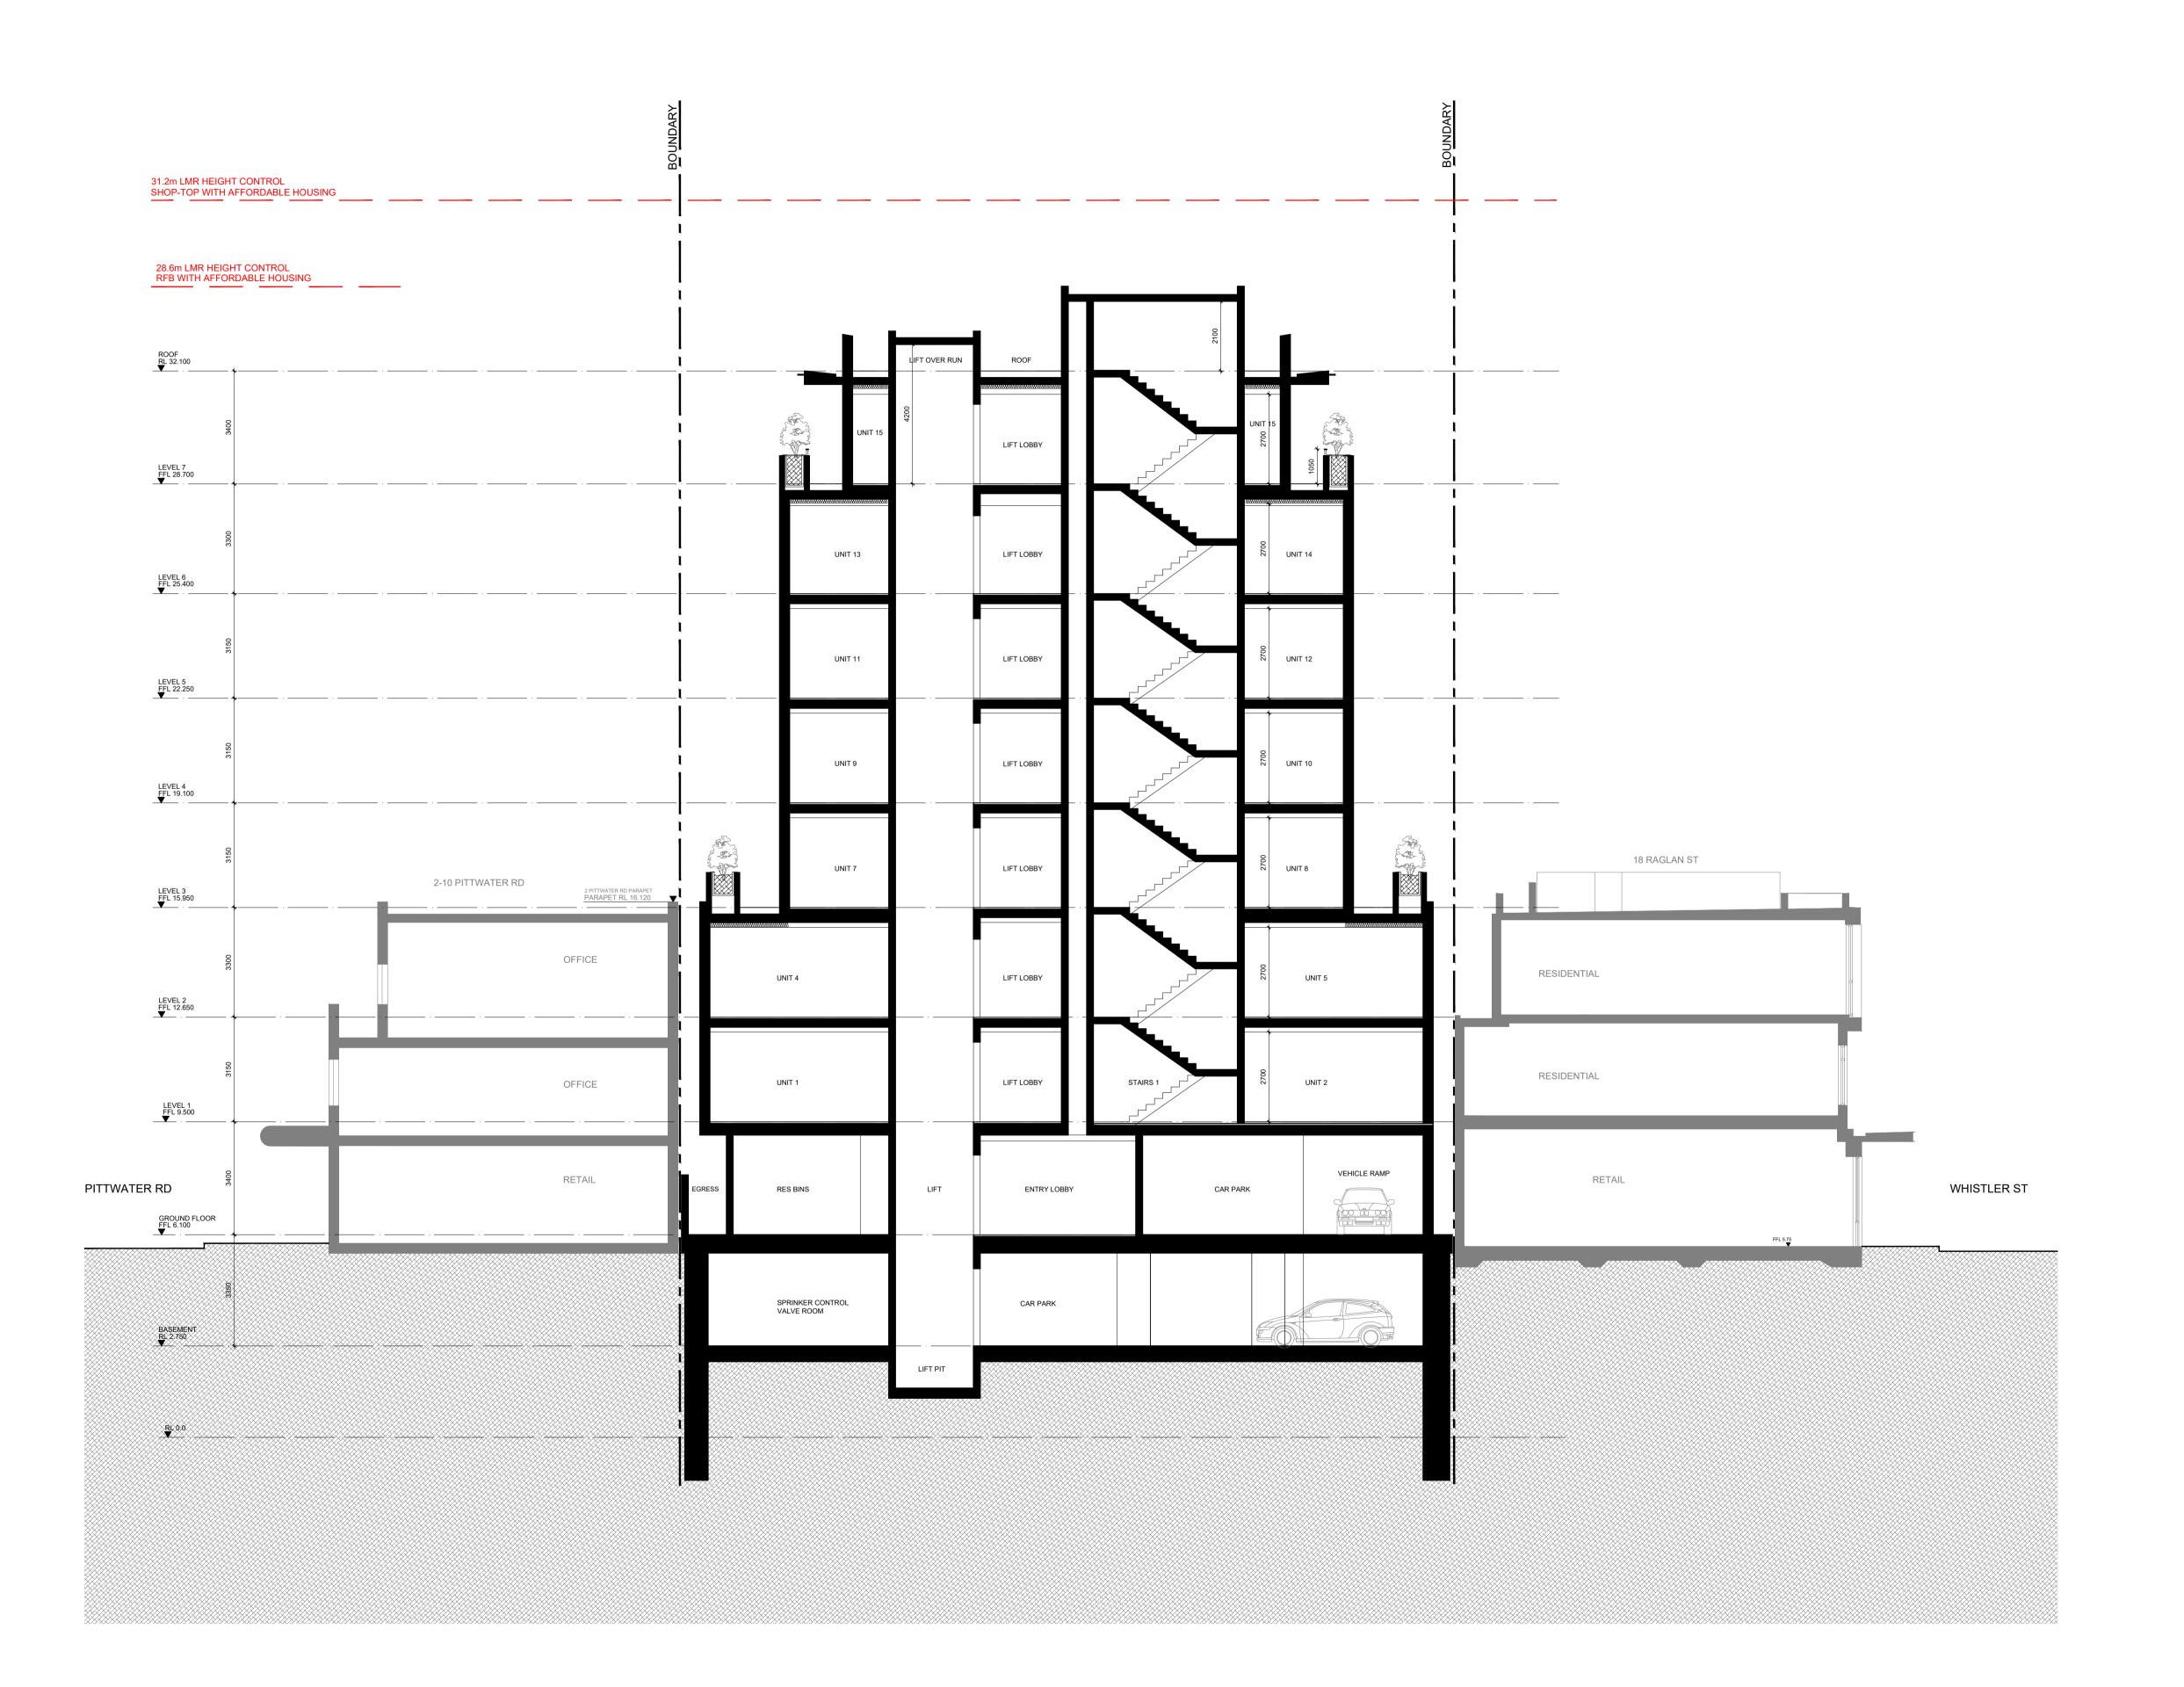

#### DEVELOPMENT APPLICATION

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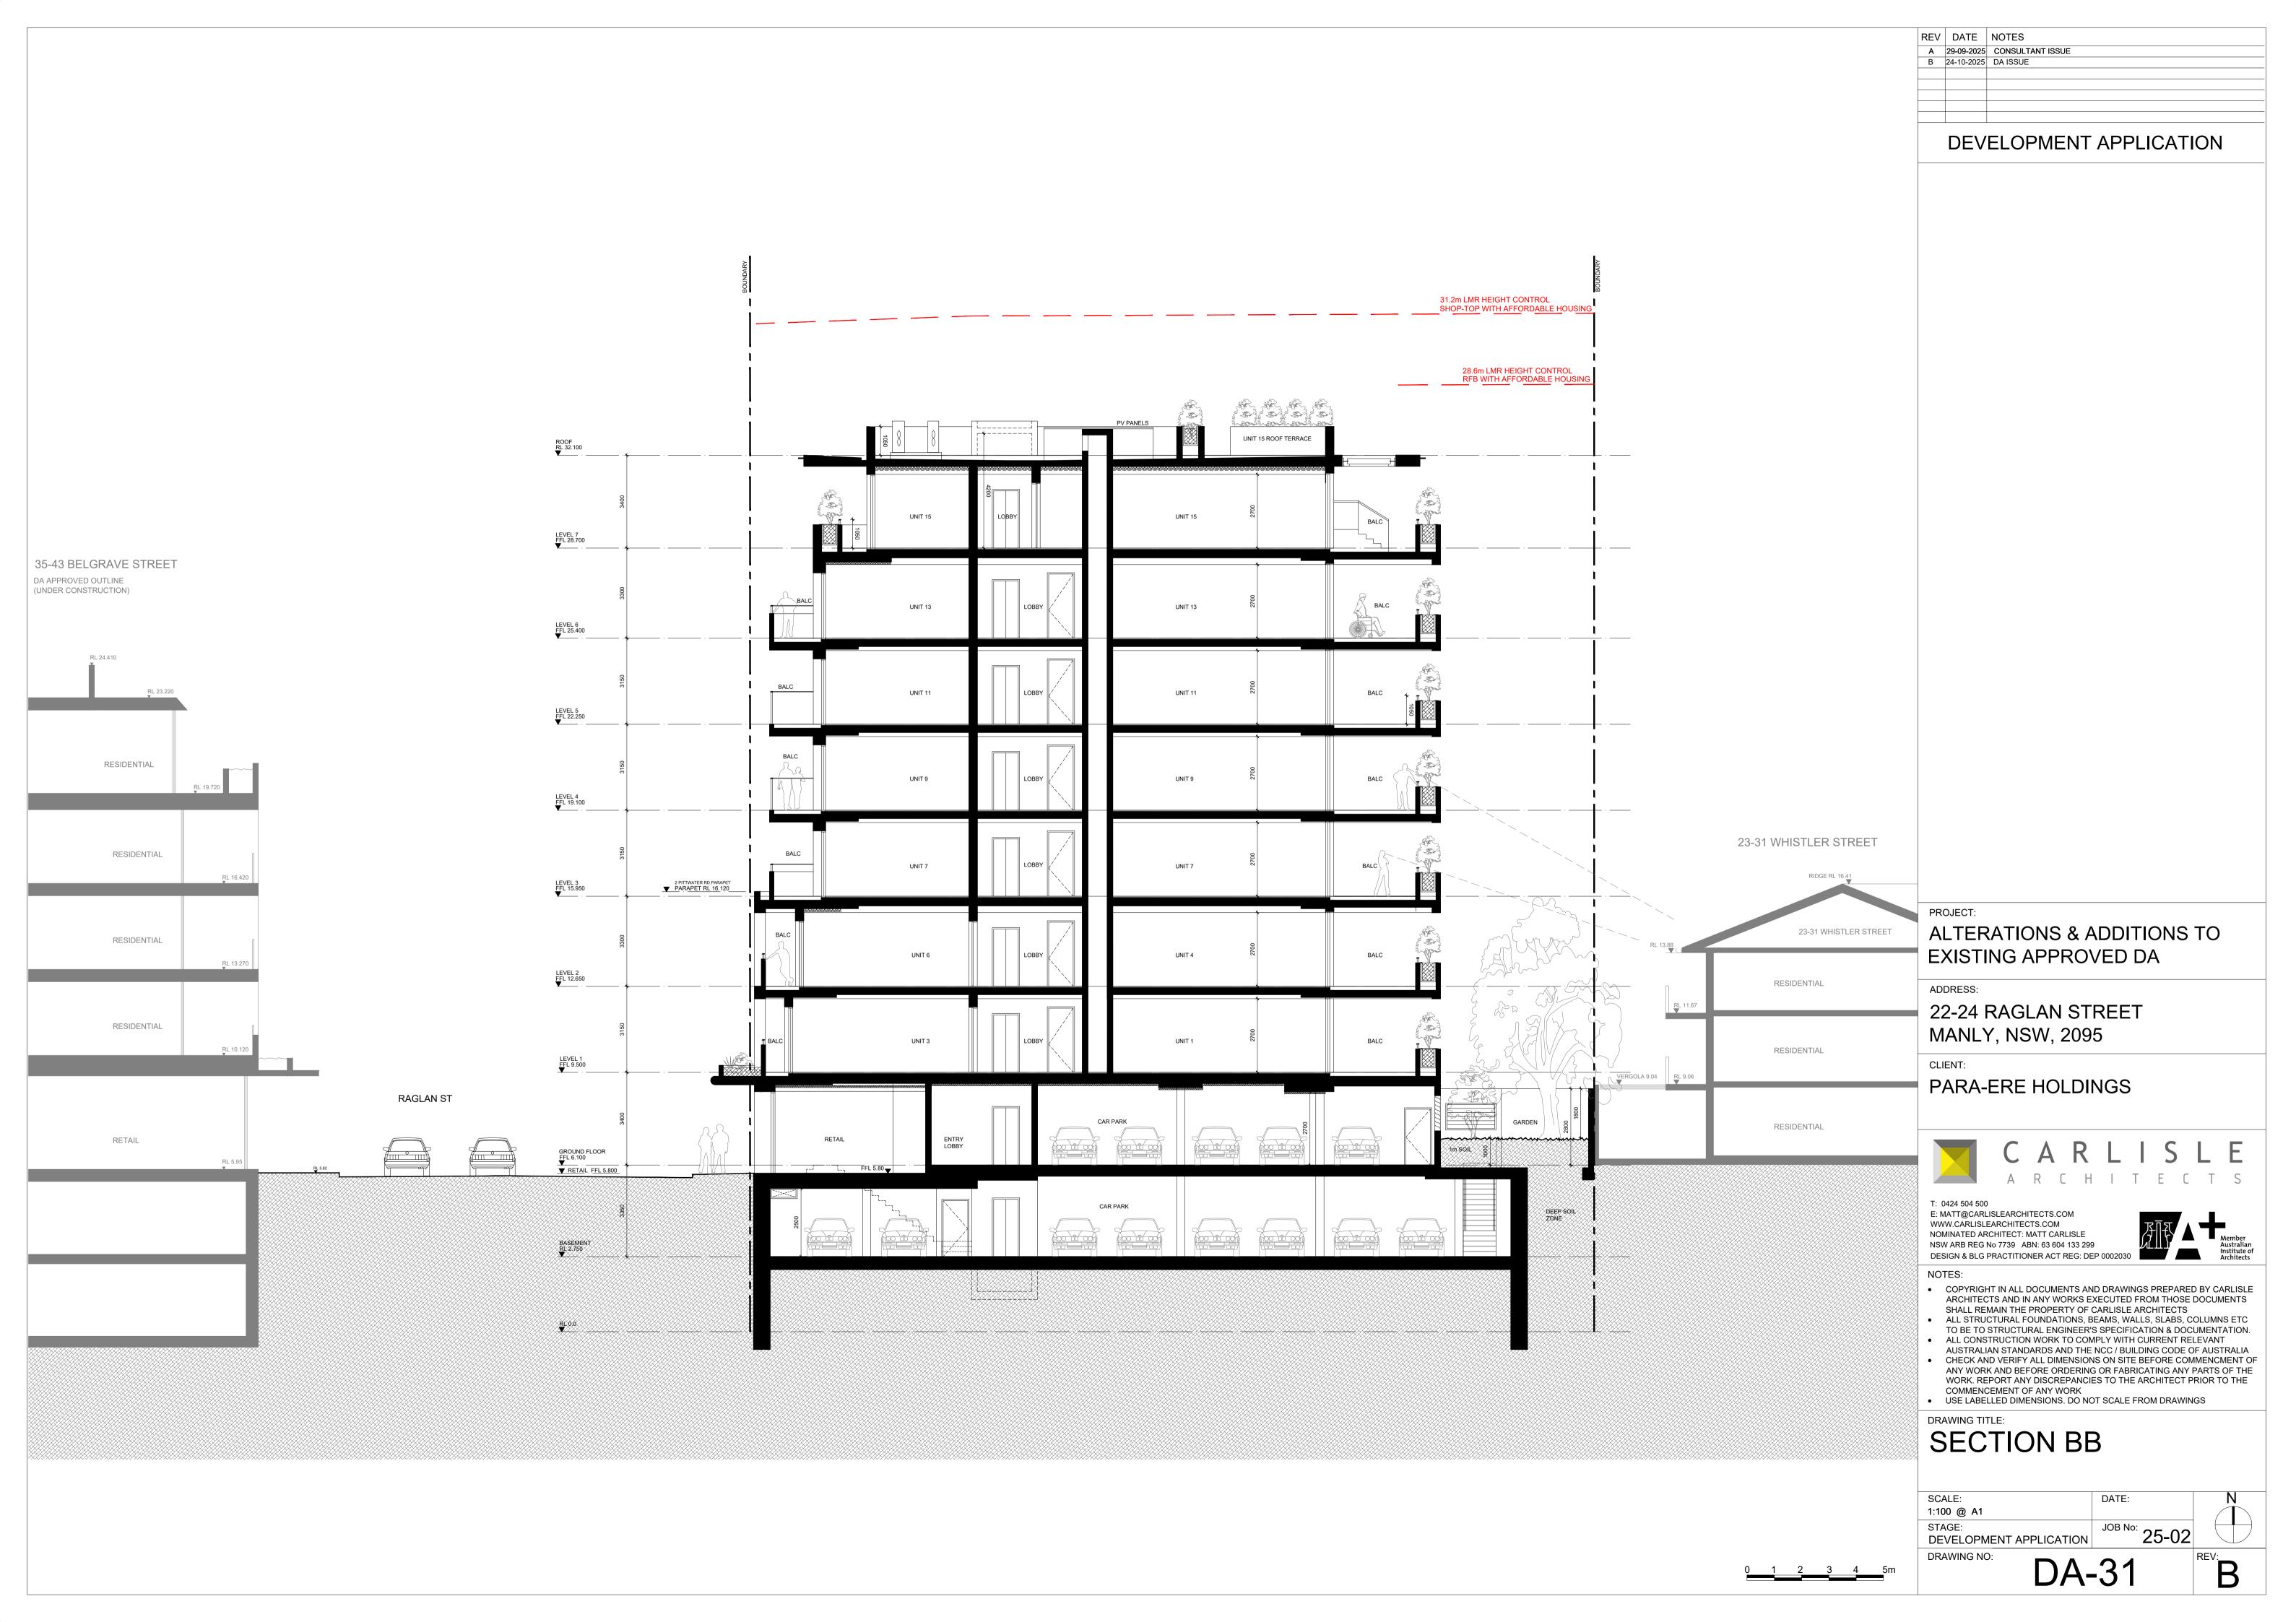
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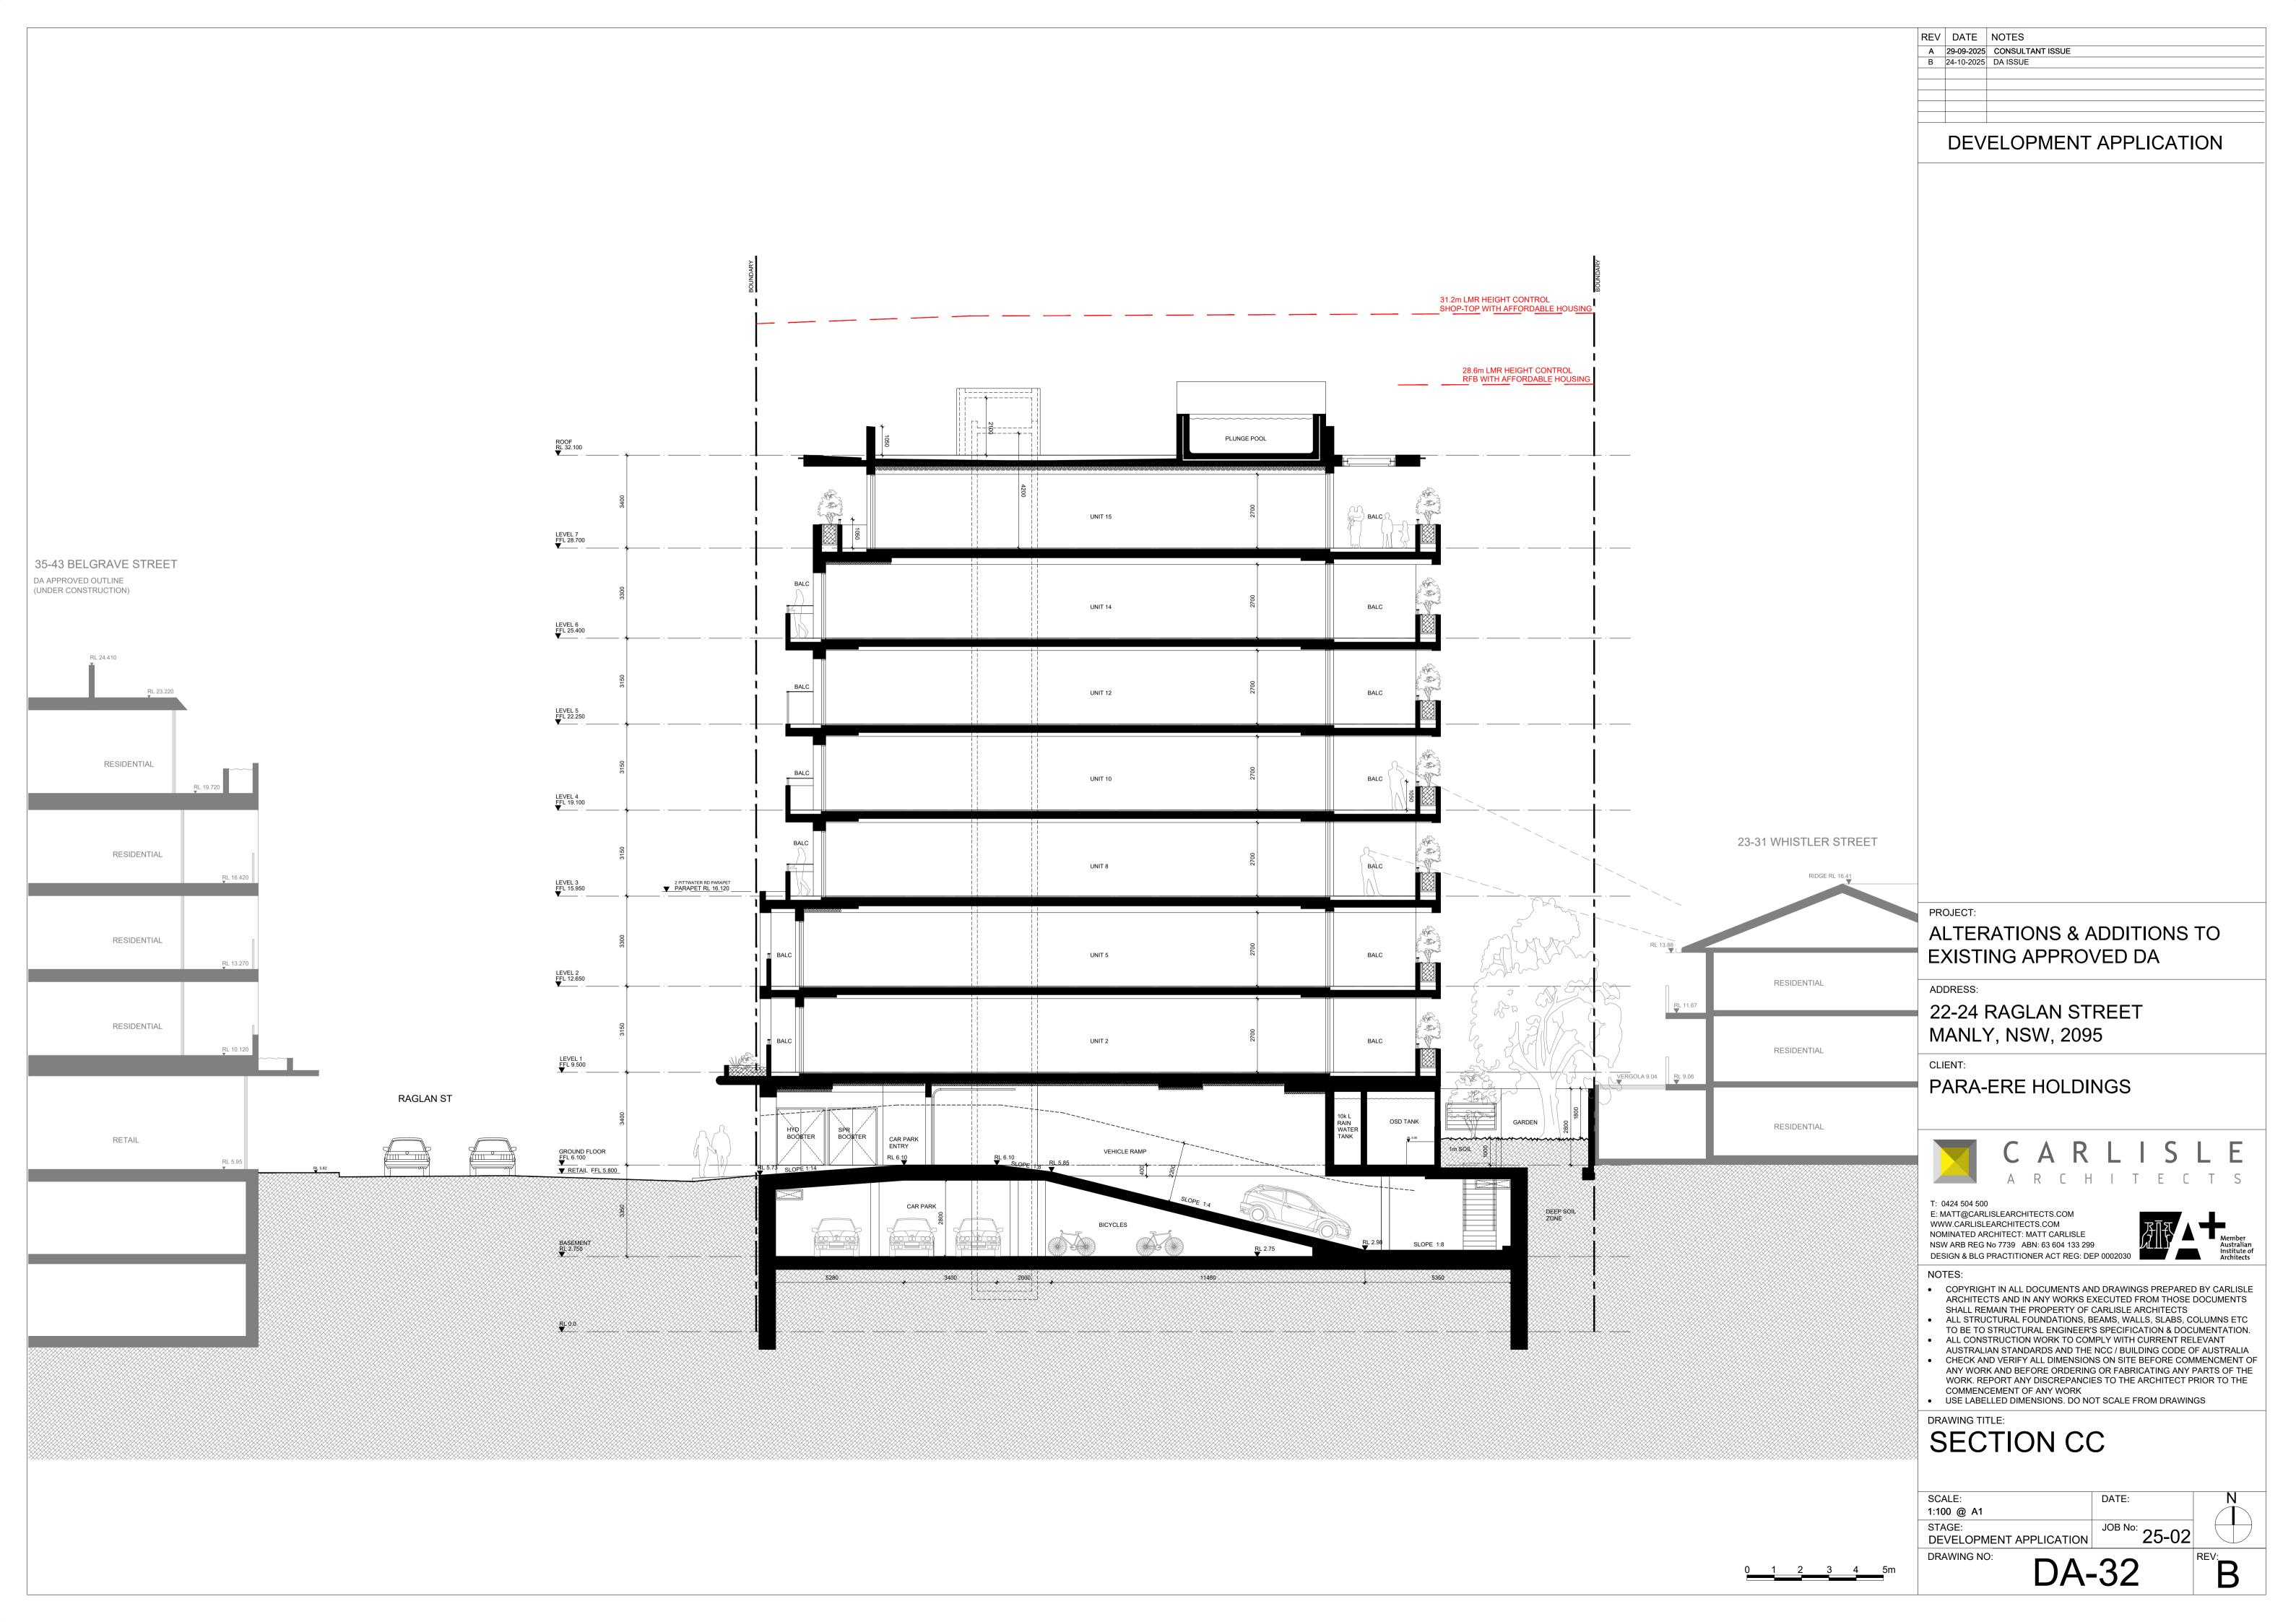
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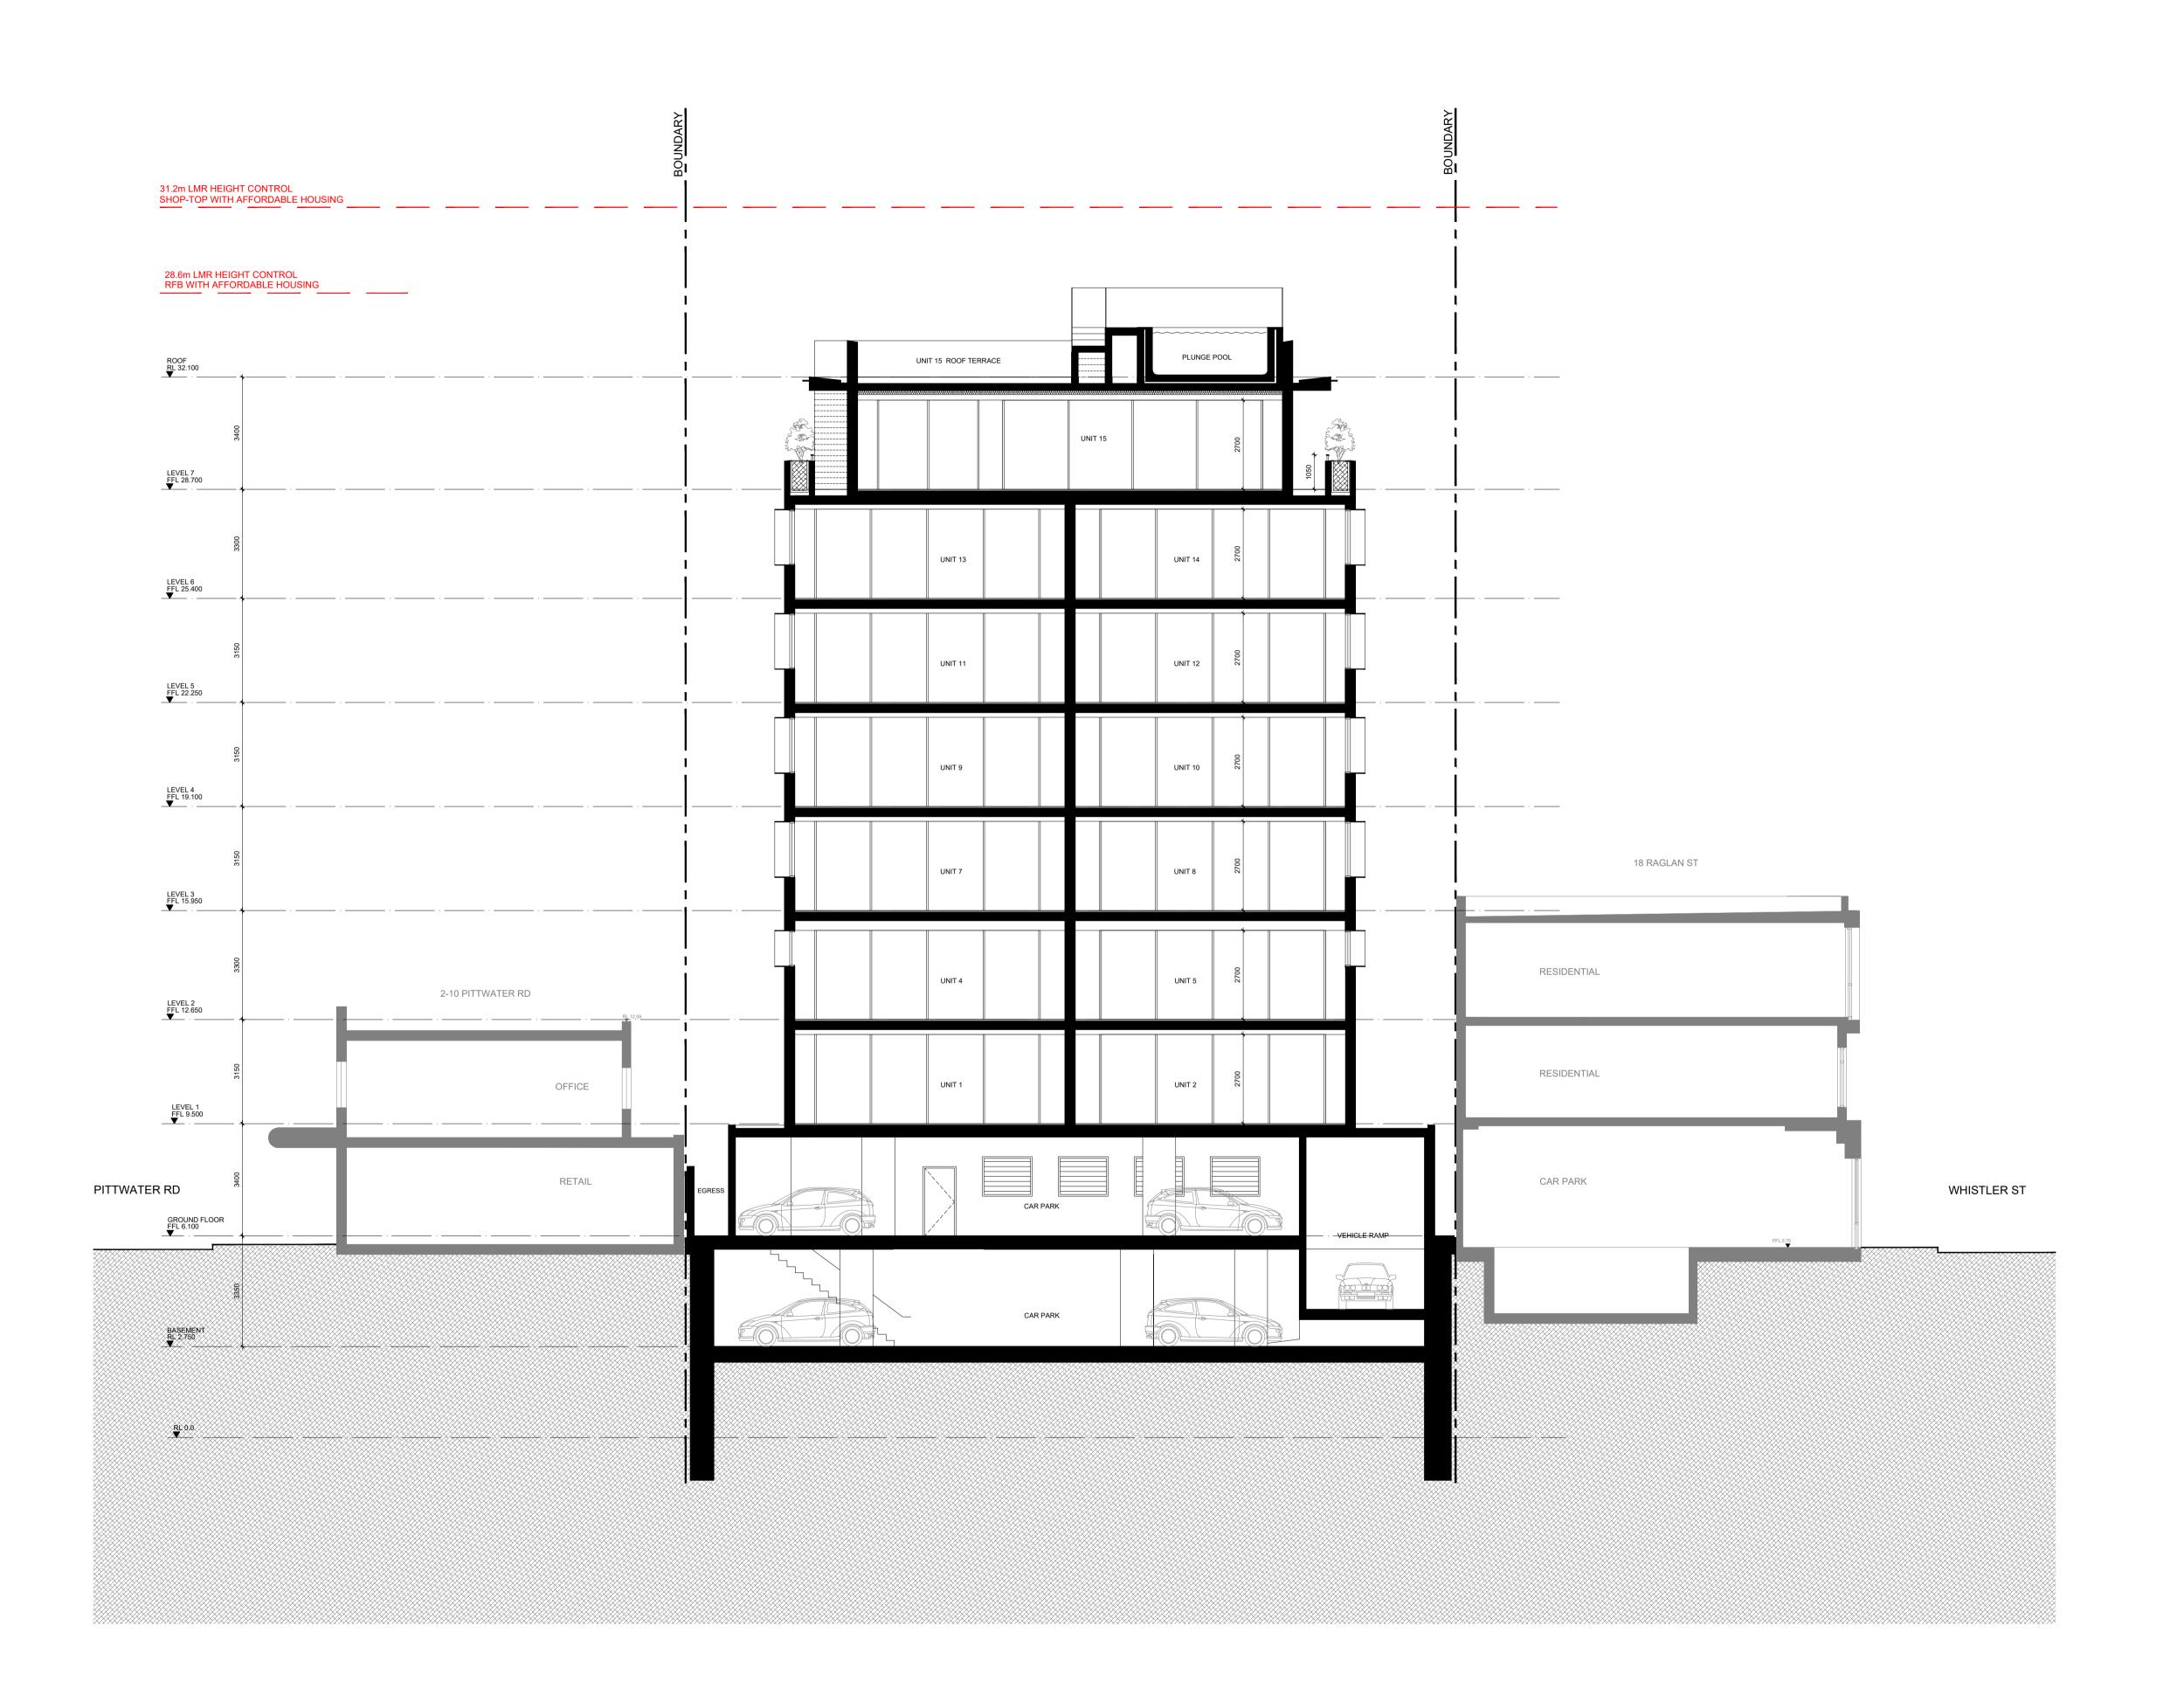
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SCALE: 1:100 @ A1 DEVELOPMENT APPLICATION DRAWING NO:

DATE: JOB No: 25-02







 REV
 DATE
 NOTES

 A
 29-09-2025
 CONSULTANT ISSUE

 B
 24-10-2025
 DA ISSUE

### DEVELOPMENT APPLICATION

PROJECT:

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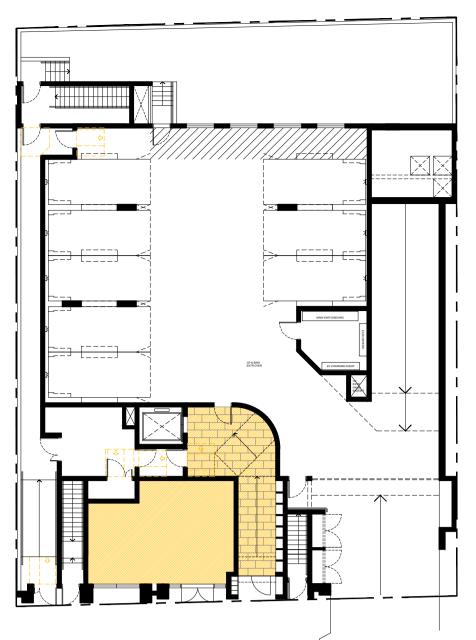
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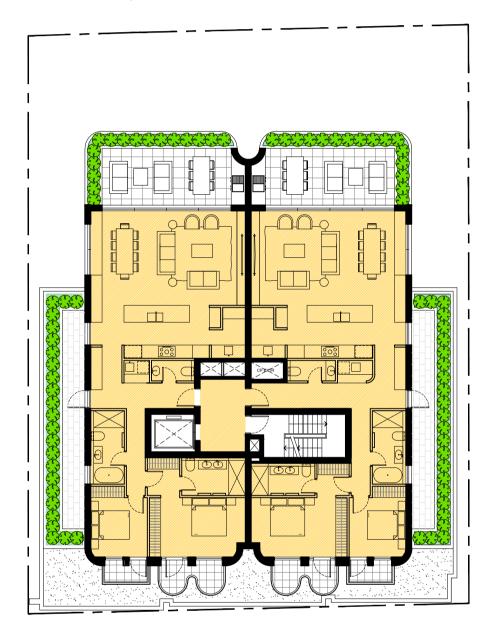
SCALE:
1:100 @ A1
STAGE:
DEVELOPMENT APPLICATION
DRAWING NO:

JOB No: 25-02


DA-33




**GROUND FLOOR** GFA: 64 sqm




LEVEL 03 GFA: 270 sqm

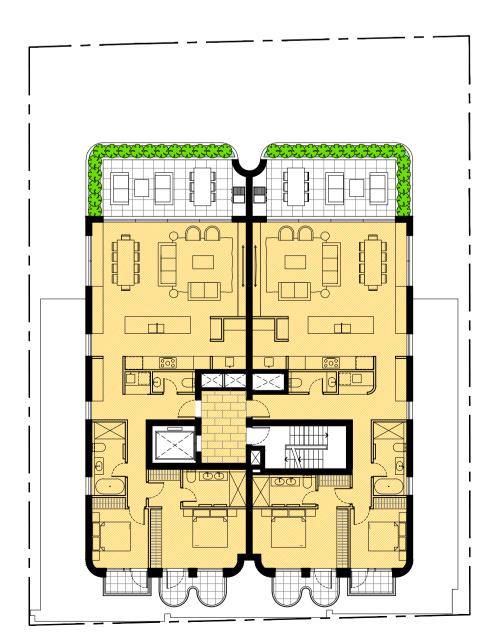


LEVEL 06 GFA: 270 sqm

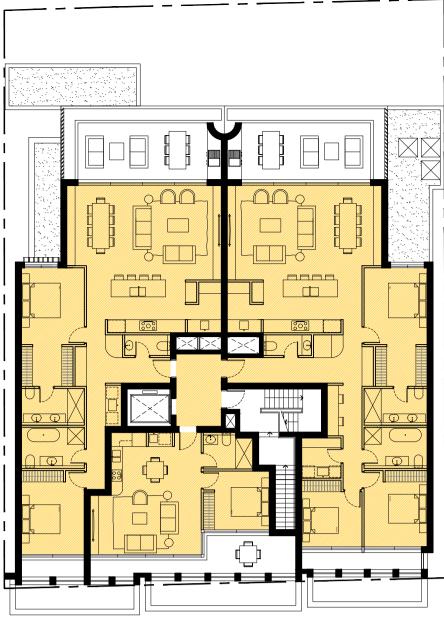


LEVEL 01 GFA: 350 sqm

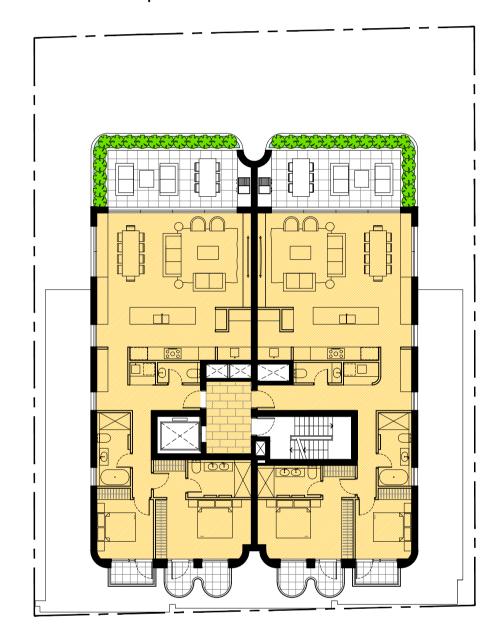


LEVEL 04 GFA: 270 sqm

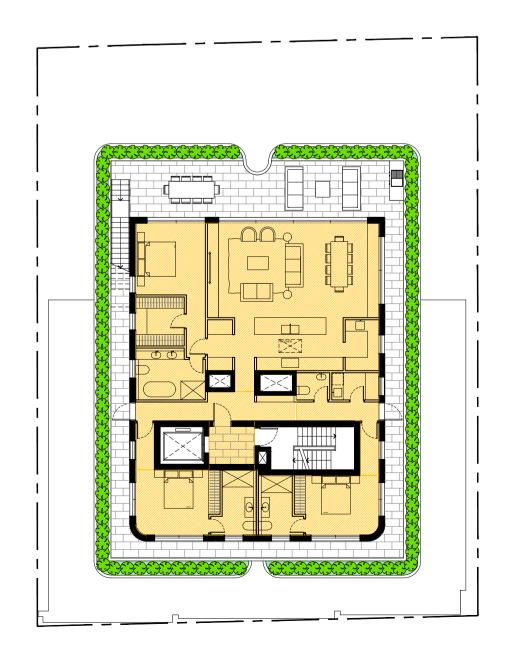

LEVEL 07 GFA:184 sqm

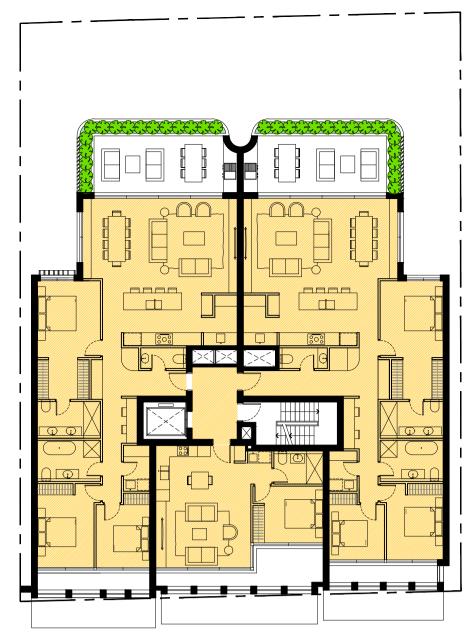

LEVEL 02 GFA: 360 sqm

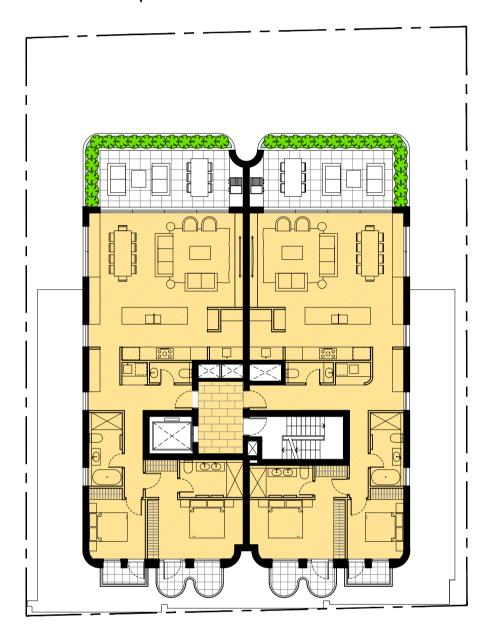

LEVEL 05 GFA: 270 sqm

#### **GFA CALCULATIONS**

SITE AREA: 713sqm LMR HOUSING FSR CONTROL FOR SITE: FSR 2.2:1

TOTAL INFILL AFFORDABLE HOUSING PROPOSED: 330 sqm (16% x TOTAL GFA) (UNIT1, UNIT 2, UNIT 3)

INFILL AFFORDABLE HOUSING FSR BONUS: 30%

TOTAL FSR CONTROL  $2.2 + (30\% \times 2.2) = 2.86:1$ TOTAL GFA CONTROL:  $2.86 \times 713 = 2039 \text{ sqm}$ 

TOTAL GFA PROPOSED: 2038 sqm

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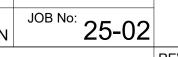
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## GFA DIAGRAMS


SCALE: 1:200 @ A1 DEVELOPMENT APPLICATION


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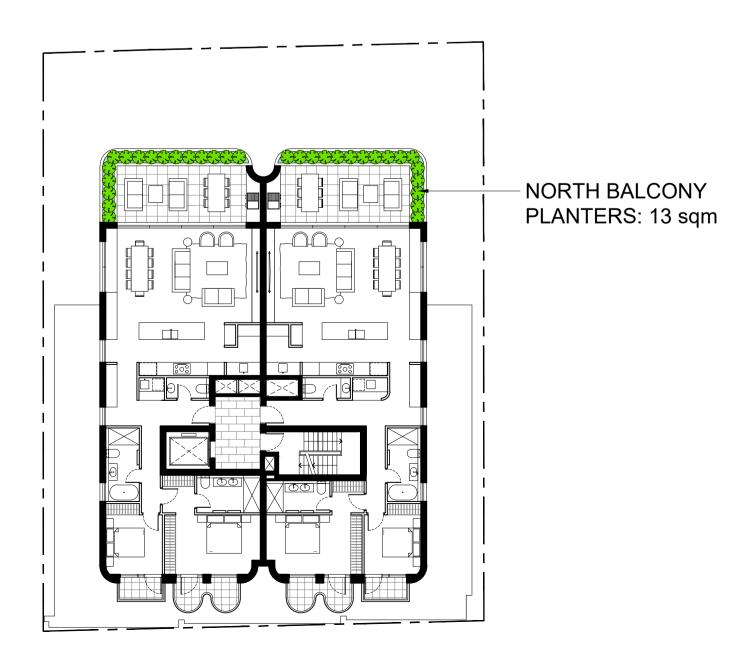






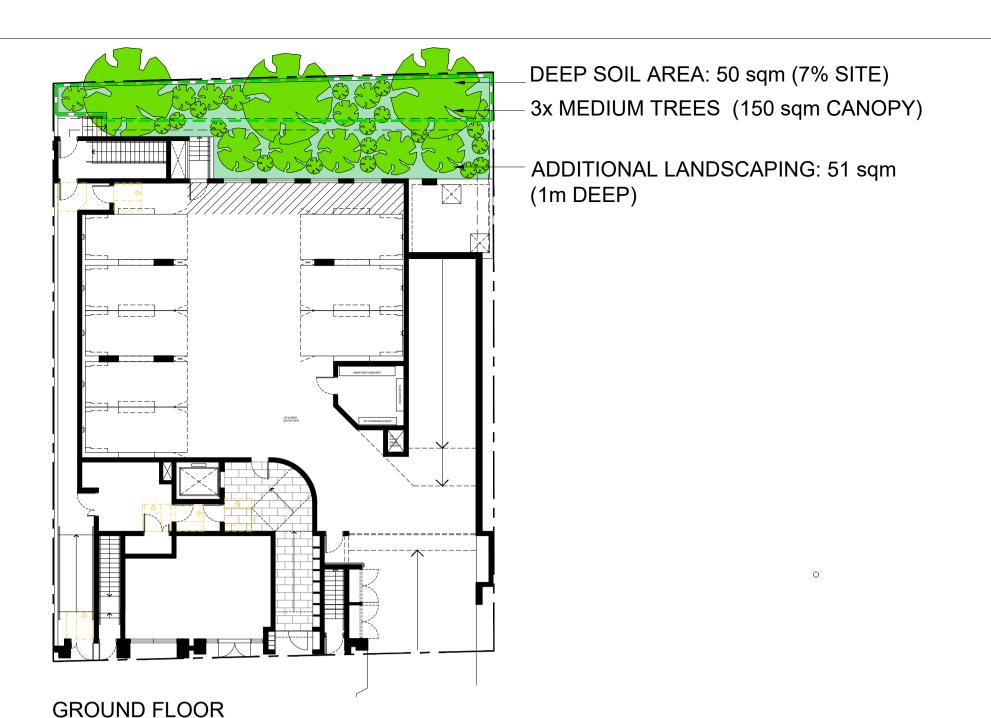


LEVEL 03 LANDSCAPED AREA: 35 sqm

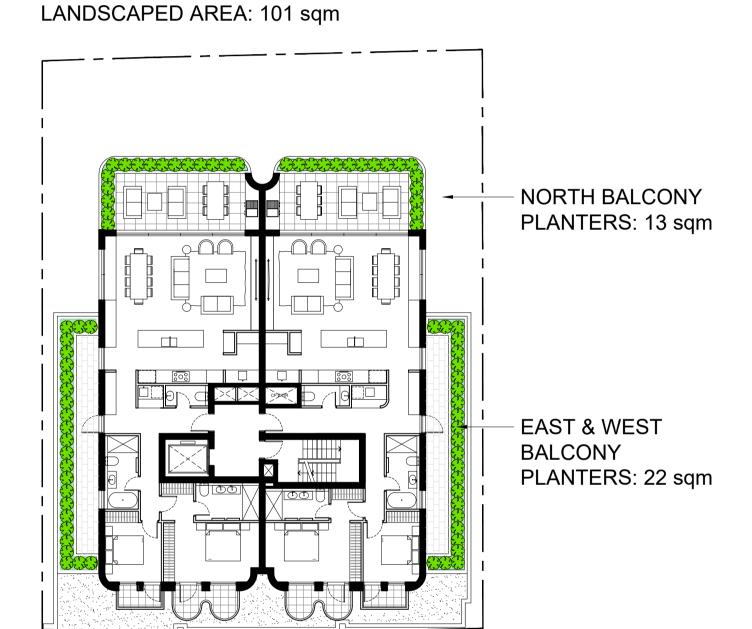


LEVEL 06 LANDSCAPED AREA: 13 sqm




LEVEL 01 LANDSCAPED AREA: 38 sqm

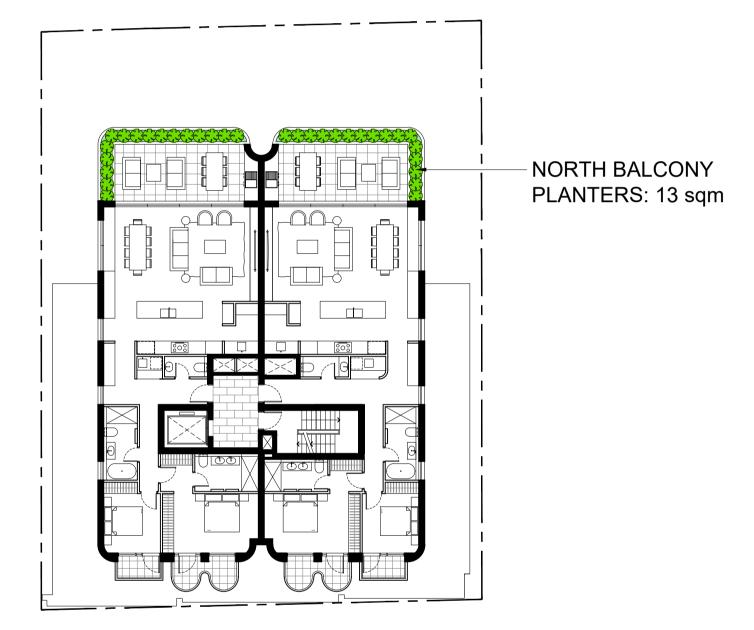


LEVEL 04 LANDSCAPED AREA: 13 sqm

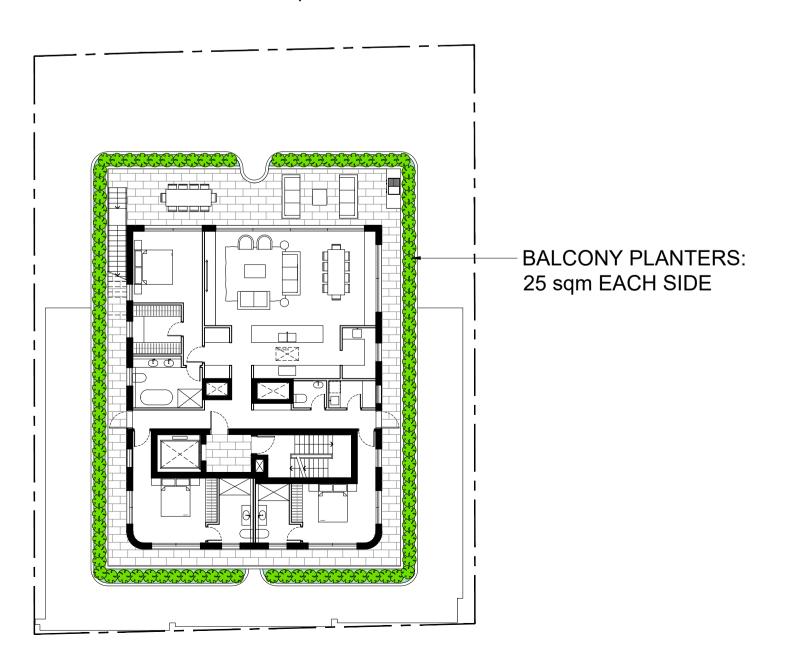


LEVEL 07 LANDSCAPED AREA: 50 sqm

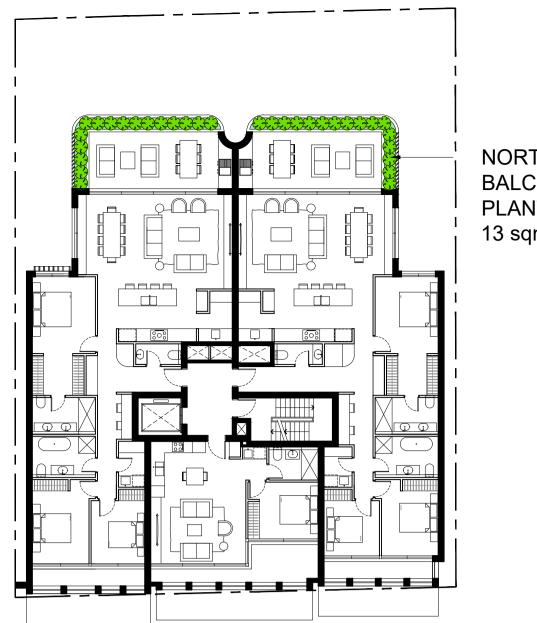

LANDSCAPED AREA: 13 sqm

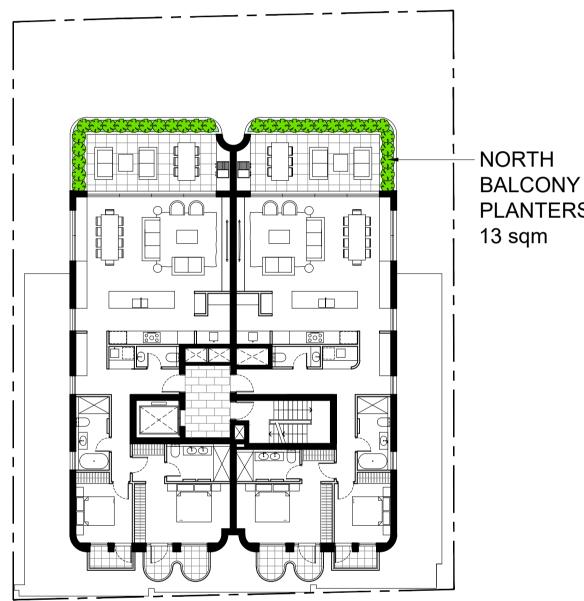


LEVEL 05 LANDSCAPED AREA: 13 sqm

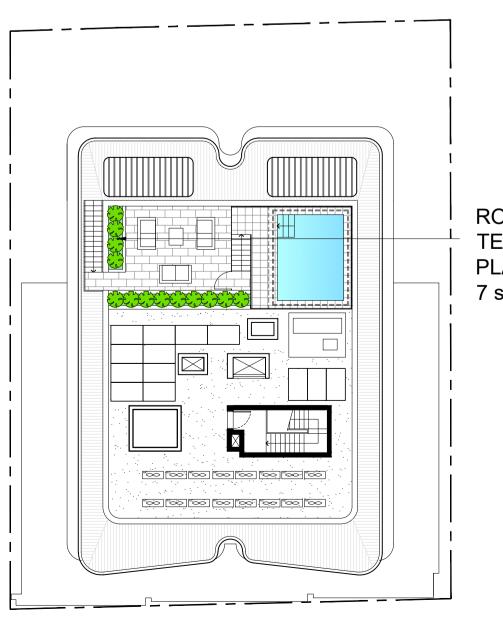


ROOF TERRACE LEVEL



LEVEL 02

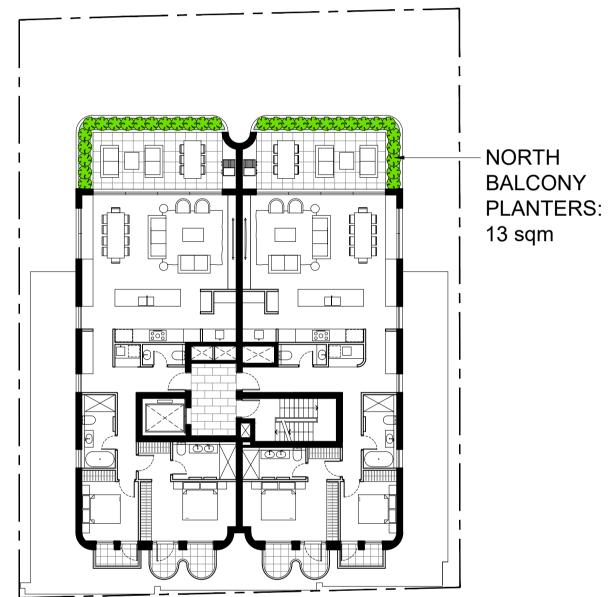

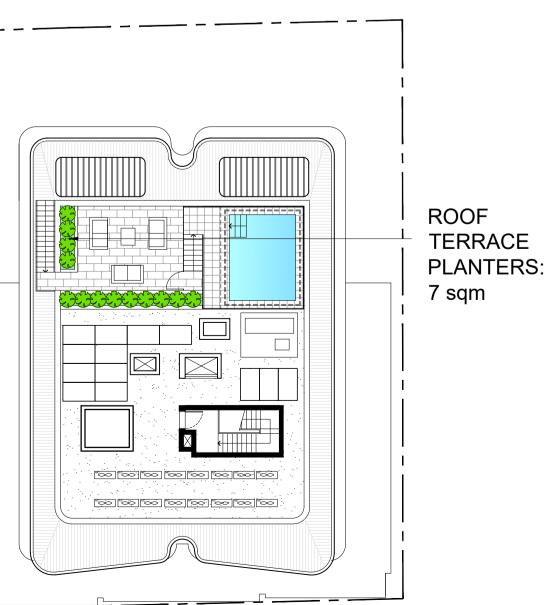

LANDSCAPED AREA: 7 sqm

REV DATE NOTES A 29-09-2025 CONSULTANT ISSUE B 24-10-2025 DA ISSUE

#### DEVELOPMENT APPLICATION

#### LOW & MID-RISE TREE CANOPY GUIDE

SITE AREA: 713 sqm

ON SITES WHERE ADG APPLIES: DEEP SOIL AREA REQUIRED: 7% SITE AREA (50 m2)

TREE CANOPY REQUIRED: 15% SITE AREA (107m2)

SMALL TREE: MED TREE: LARGE TREE:

6m SPREAD, 28m2 CANOPY 8m SPREAD, 50m2 CANOPY 12m SPREAD, 113m2 CANOPY

TREE CANOPY PROPOSED:

3 MEDIUM TREES (150m2 CANOPY)

#### LANDSCAPE AREAS PROVIDED

**GROUND LEVEL:** 

101 sqm

INCLUDING DEEP SOIL AREA: 50 sqm (7% SITE) & ADDITIONAL 51 sqm 1m DEEP CONNECTING DIRECTLY TO DEEP SOIL

**UPPER LEVEL BALCONIES:** 

157 sqm

STREET AWNING:

(600mm DEEP)

(300mm DEEP)

25 sqm

TOTAL SOFT LANDSCAPING PROVIDED:

283 sqm (40% SITE AREA)

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## LANDSCAPE AREAS


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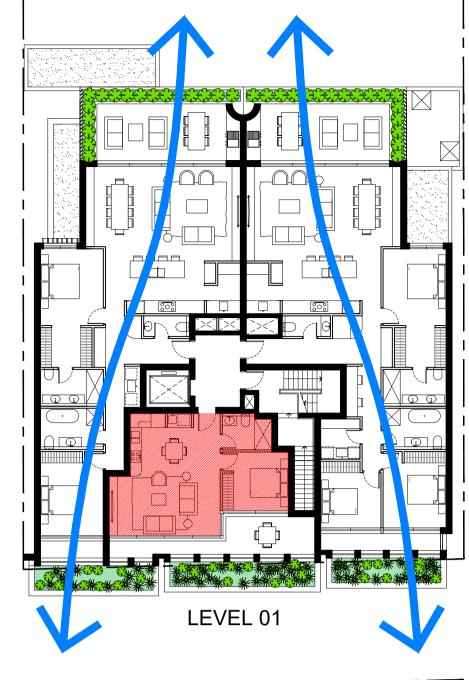
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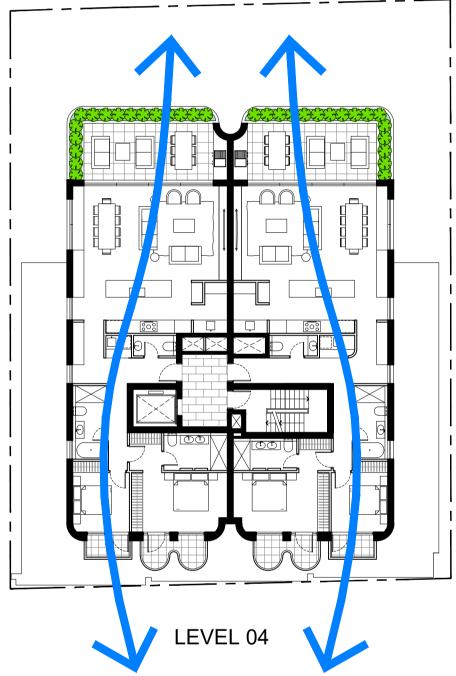
DEVELOPMENT APPLICATION


JOB No: 25-02









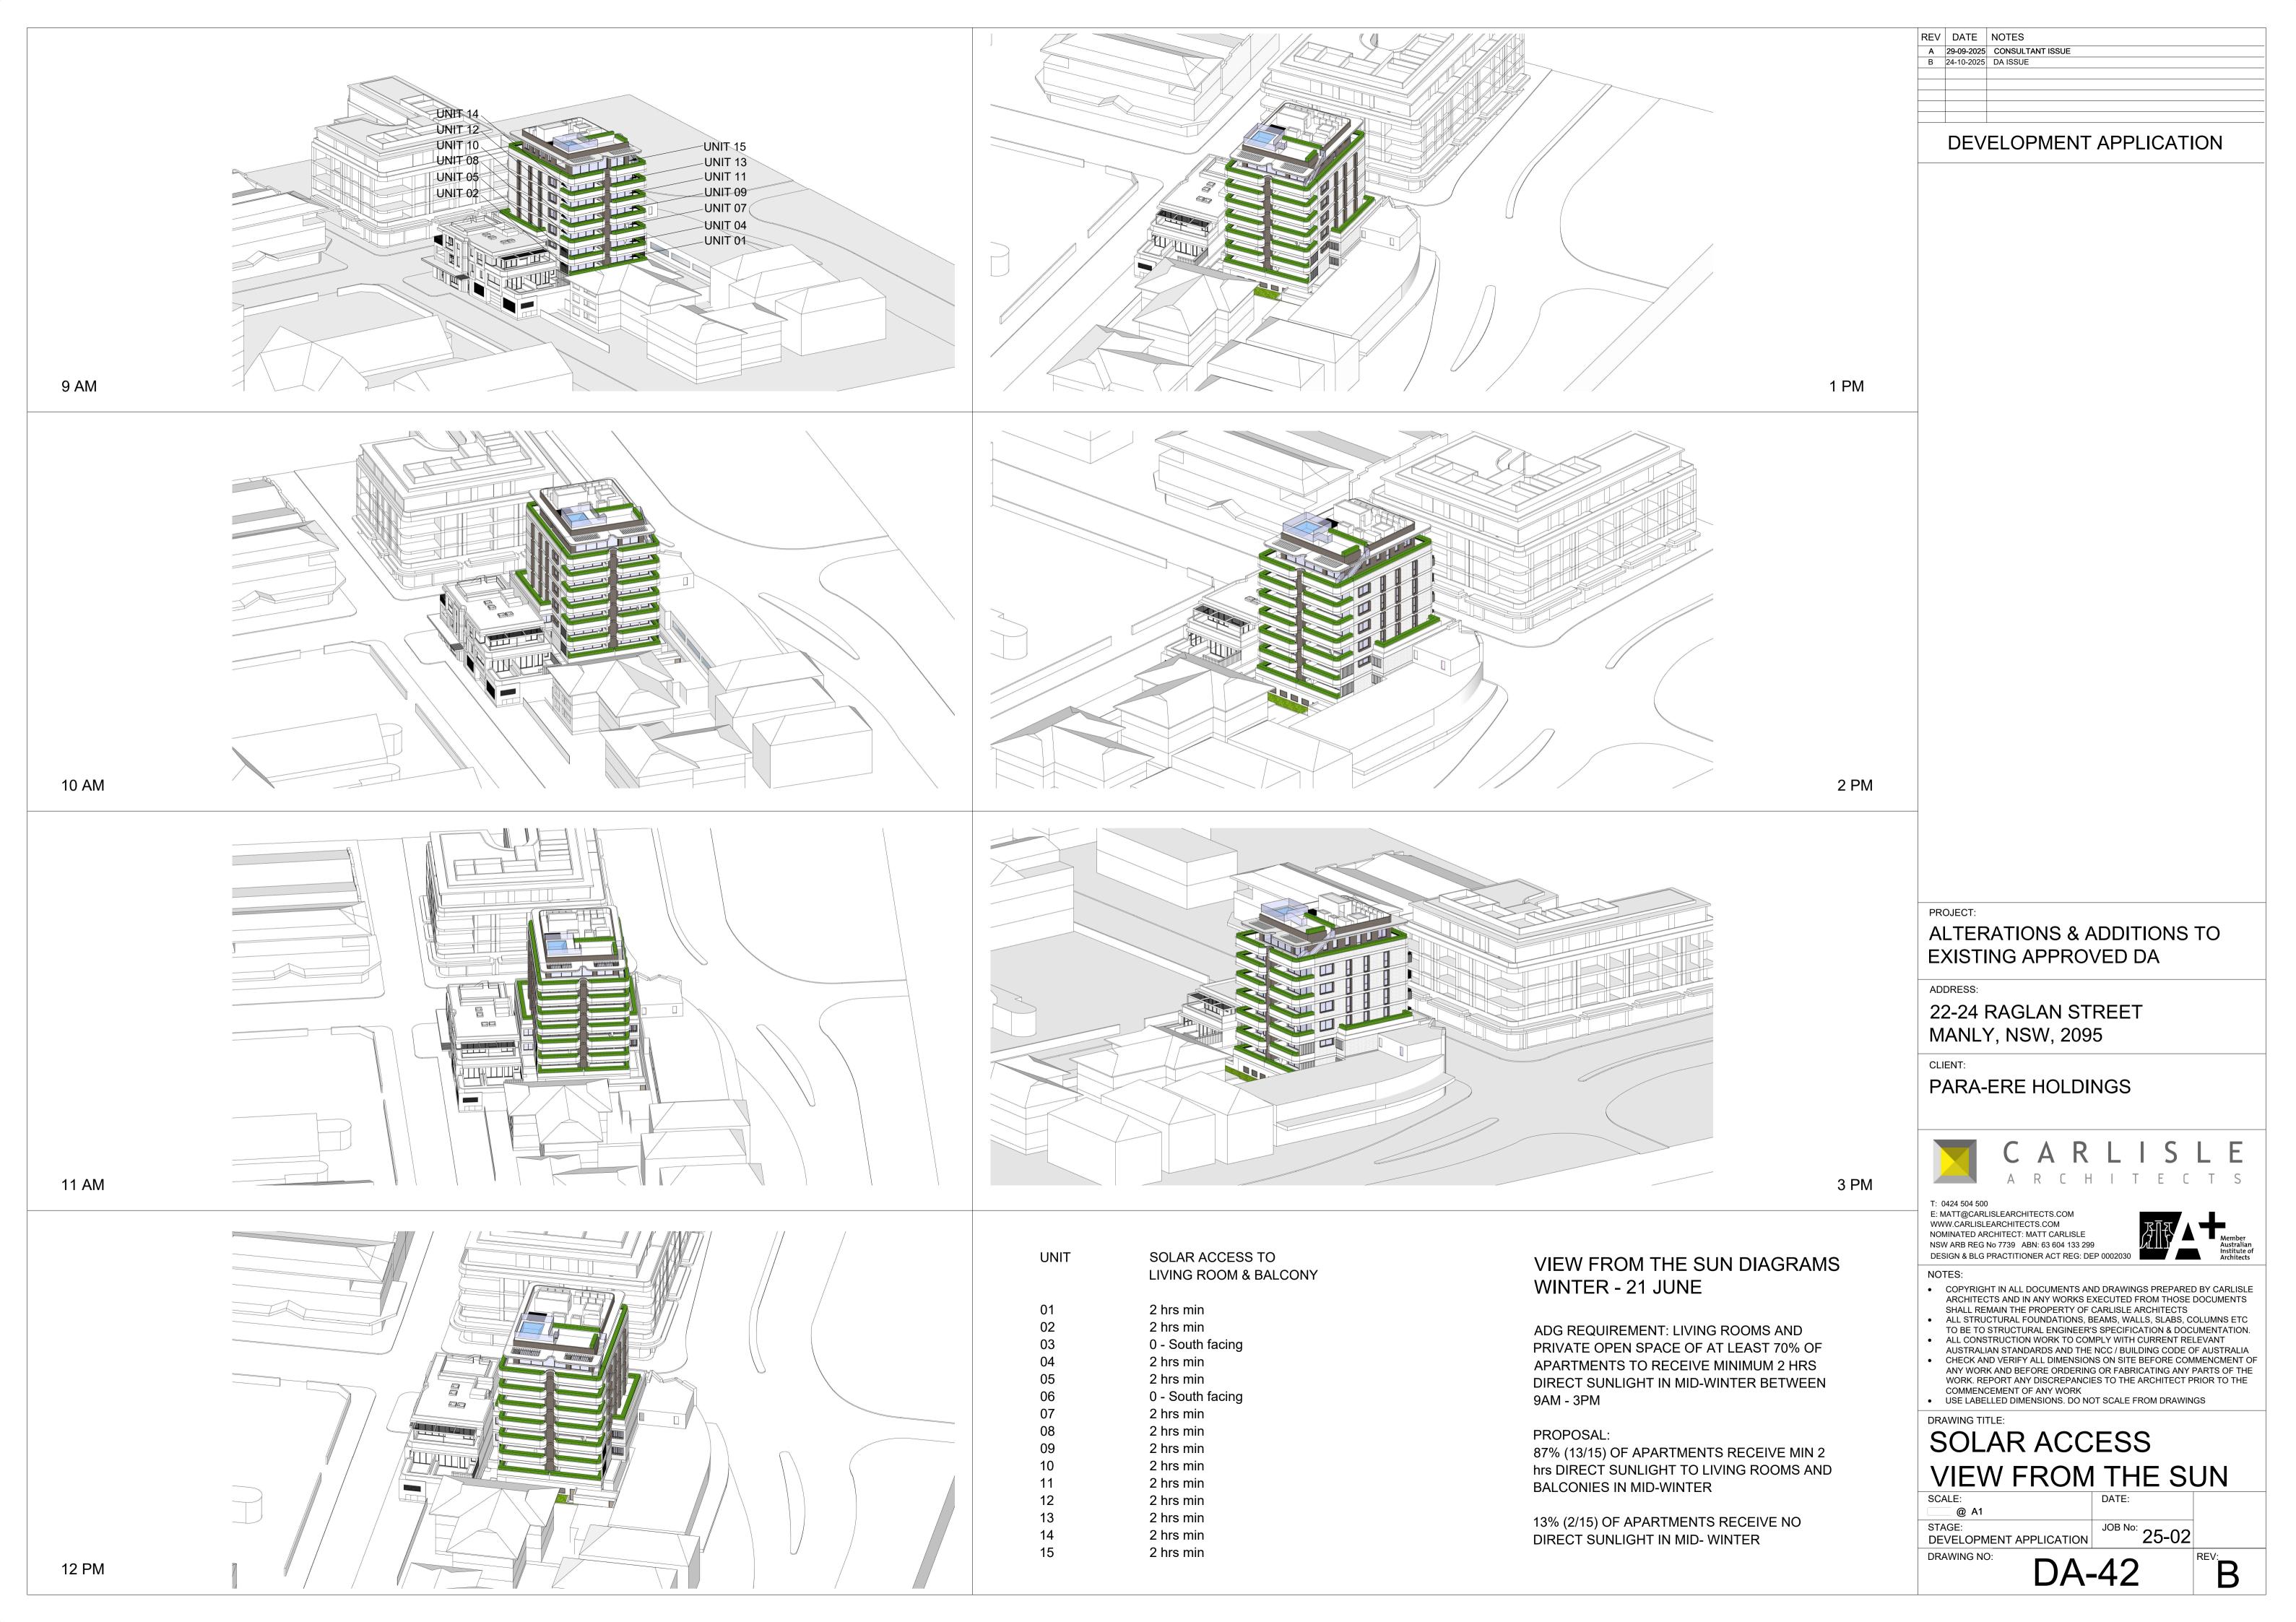

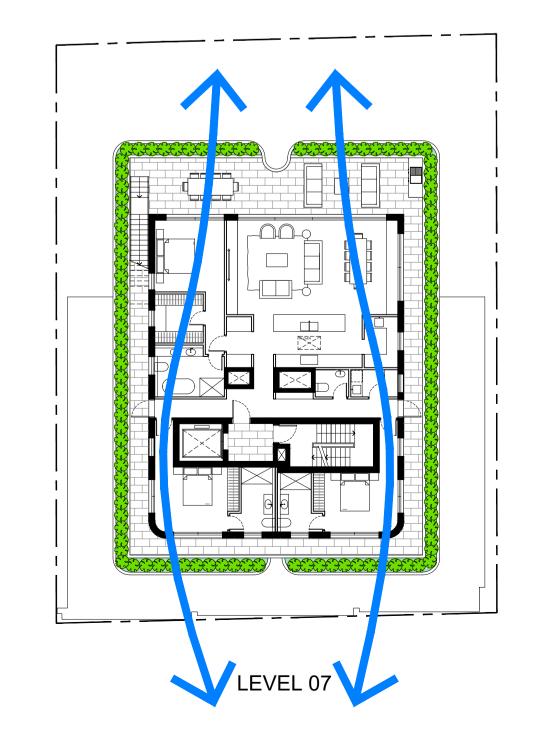

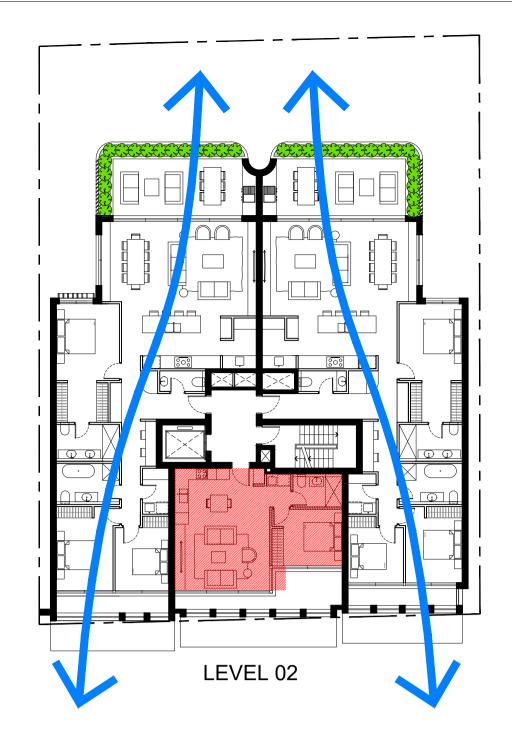

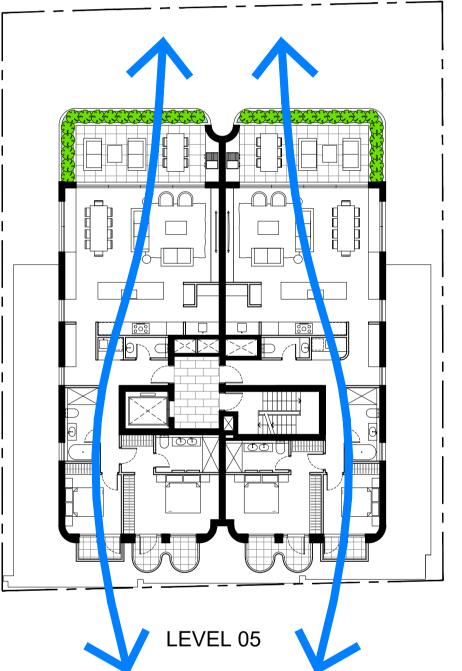

## ADG CROSS VENTILATION REQUIREMENTS

AT LEAST 60% OF APARTMENTS TO BE NATURALLY CROSS VENTILATED IN THE FIRST 9 STOREYS

PROPOSED APARTMENTS:

87% (13 / 15) OF APARTMENTS ARE NATURALLY CROSS VENTILATED

DEVELOPMENT APPLICATION

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## **CROSS VENTILATION** DIAGRAMS

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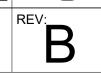
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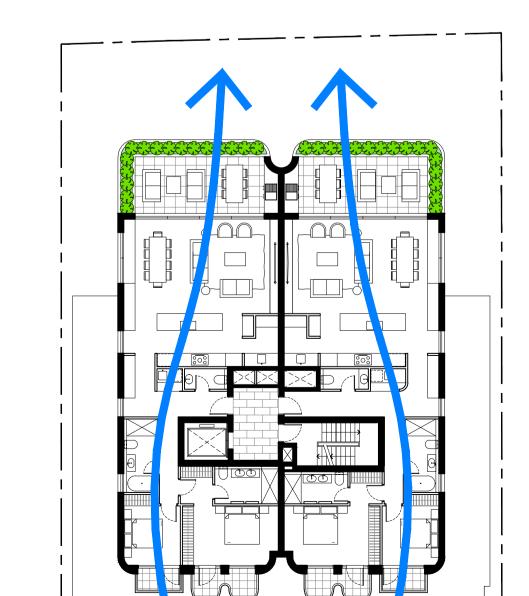












LEVEL 06

LEVEL 03



VIEW LOOKING WEST FROM RAGLAN STREET AND WHISTLER STREET CORNER



VIEW LOOKING EAST FROM RAGLAN STREET AND BELGRAVE STREET CORNER

REV DATE NOTES

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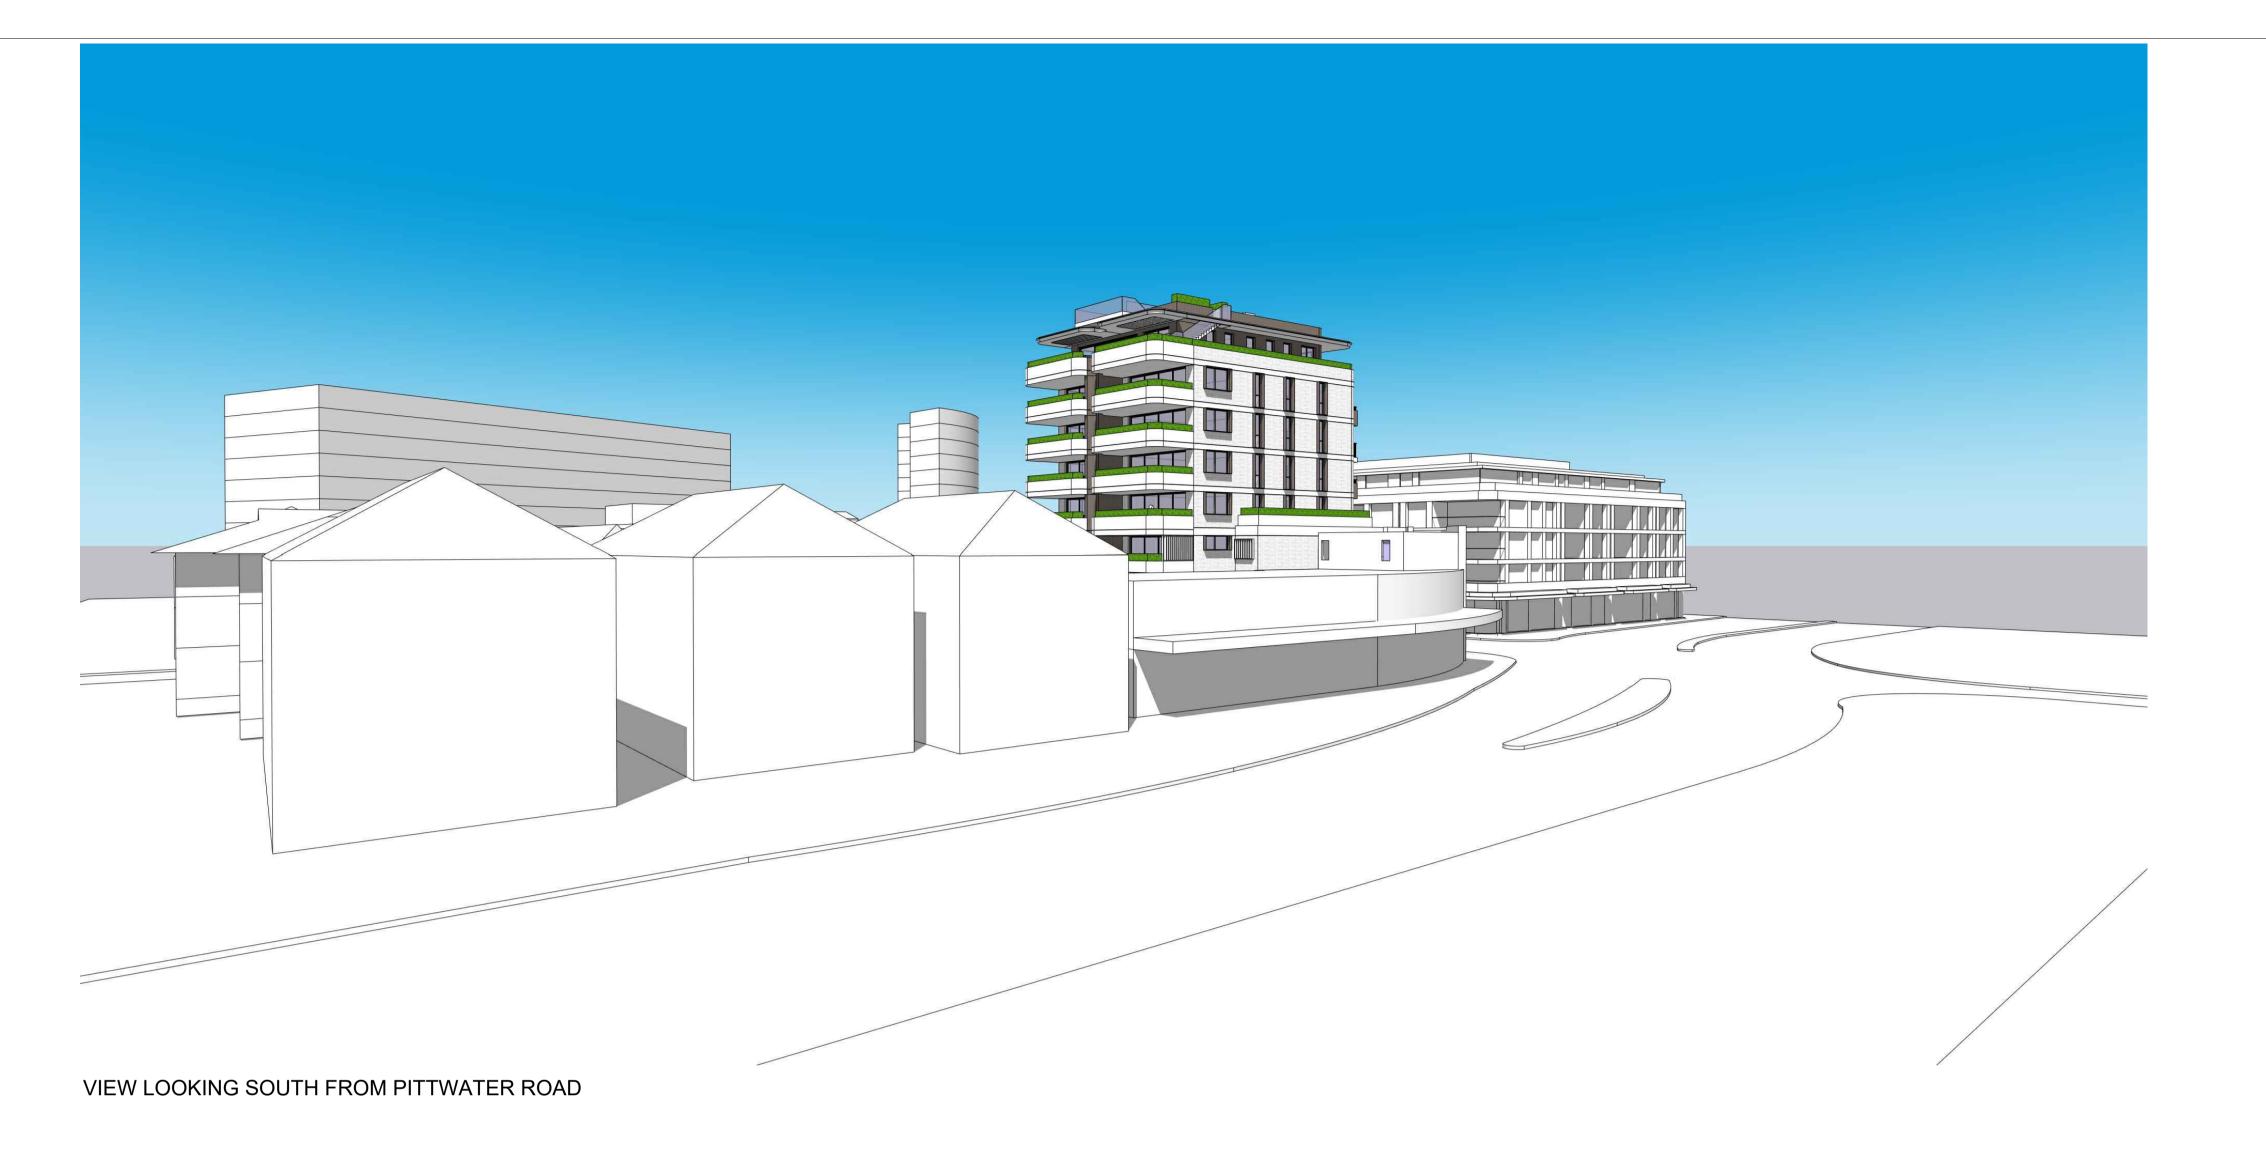
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## PERSPECTIVES 01

SCALE: 1:100 @ A1 DEVELOPMENT APPLICATION

DA-50





#### DEVELOPMENT APPLICATION

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## PERSPECTIVES 02

SCALE: 1:100 @ A1 STAGE: DEVELOPMENT APPLICATION

JOB No. 25-02

B

**DA-51** 

**EXISTING DA APPROVAL** (3 STOREYS)

MID-WINTER - 21 JUNE

9 AM

10 AM

11 AM

**EXISTING DA APPROVAL** 


MID-WINTER - 21 JUNE

(3 STOREYS)

**EXISTING DA APPROVAL** 


MID-WINTER - 21 JUNE

(3 STOREYS)

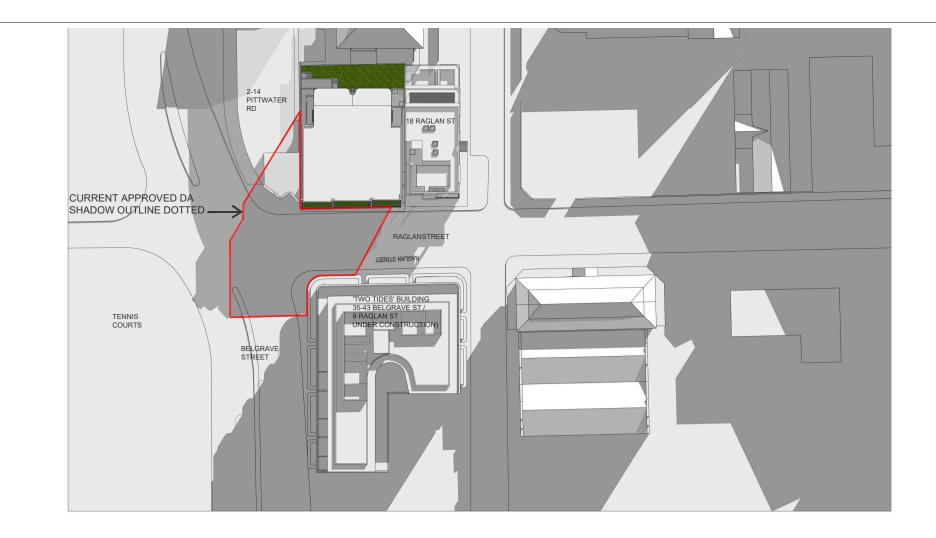

MID-WINTER - 21 JUNE

AND ADDITIONS

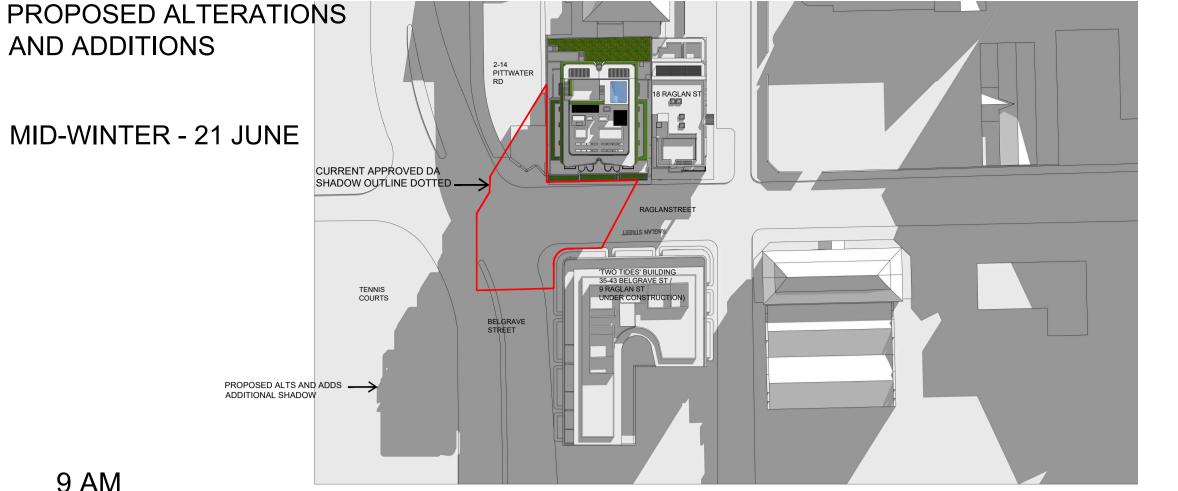

9 AM

DEVELOPMENT APPLICATION

#### IMPORTANT NOTE

REV DATE NOTES

B 24-10-2025 DA ISSUE

A 29-09-2025 CONSULTANT ISSUE

AT THE TIME OF PREPARATION OF THESE SHADOW DIAGRAMS, THE BUILDING OPPOSITE THE PROPOSAL AT 35-43 BELGRAVE STREET (AKA 'TWO TIDES', 9 RAGLAN ST MANLY) HAD NOT BEEN CONSTRUCTED ABOVE GROUND LEVEL.

AS SUCH, THESE SHADOW DIAGRAMS ARE BASED SOLELY ON THE STAMPED DA APPROVED DRAWINGS BY SJB ARCHITECTS PUBLICLY AVAILABLE ON NB COUNCIL WEBSITE AND NOT ON A SURVEYED AS-BUILT CONSTRUCTION. THE 'TWO TIDES' BUILDING MAY BE CONSTRUCTED DIFFERENTLY TO THE STAMPED DA APPROVED DRAWINGS.

CARLISLE ARCHITECTS TAKES NO RESPONSIBILITY FOR ANY DISCREPANCY IN SHADOWS BASED ON THE ASSUMED 'TWO TIDES' BUILDING FORM AND ROOM LAYOUTS REPRESENTED IN THESE DRAWINGS AND THE FINAL AS-CONSTRUCTED BUILDING.

THESE SHADOW DIAGRAMS ARE FOR USE FOR THE DA APPLICATION OF 22-24 RAGLAN STREET TO NORTHERN BEACHES COUNCIL ONLY AND NOT TO BE RELIED UPON BY ANY THIRD PARTIES.

CARLISLE ARCHITECTS TAKES NO RESPONSIBILITY FOR, AND **GUARANTEES NO ACCURACY FOR THESE SHADOW** DIAGRAMS TO THIRD PARTIES OR POTENTIAL PURCHASERS OF 'TWO TIDES' APARTMENTS. POTENTIAL PURCHASERS OF 'TWO-TIDES' ARE TO UNDERTAKE THEIR OWN INVESTIGATIONS REGARDING ANY POTENTIAL OVER-SHADOWING AND ARE NOT TO RELY ON THESE SHADOW DIAGRAMS

## LIMITED CERTIFICATION CARLISLE ARCHITECTS CERTIFY THAT THESE SHADOW

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Mouther Certite

**ARCHITECT** NSW ARB REG 7739

**ALTERATIONS & ADDITIONS TO EXISTING APPROVED DA** 

ADDRESS:

22-24 RAGLAN STREET MANLY, NSW, 2095

CLIENT:

PARA-ERE HOLDINGS



E: MATT@CARLISLEARCHITECTS.COM

WWW.CARLISLEARCHITECTS.COM NOMINATED ARCHITECT: MATT CARLISLE NSW ARB REG No 7739 ABN: 63 604 133 299 DESIGN & BLG PRACTITIONER ACT REG: DEP 00020



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**SHADOW DIAGRAMS 1** JUNE 21 - PLAN VIEW

DRAWING NO:

DEVELOPMENT APPLICATION


JOB No: 25-02

REV:

DA-60


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**EXISTING DA APPROVAL** (3 STOREYS) MID-WINTER - 21 JUNE

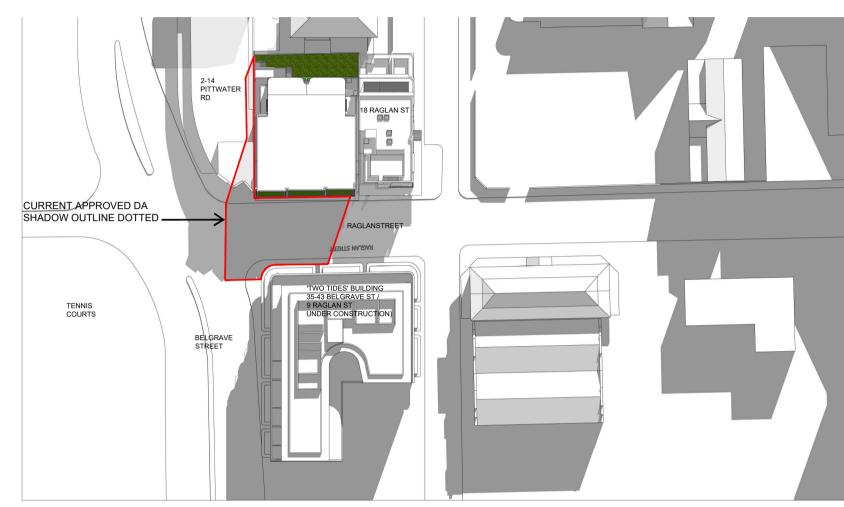


PROPOSED ALTERATIONS **AND ADDITIONS** 

MID-WINTER - 21 JUNE

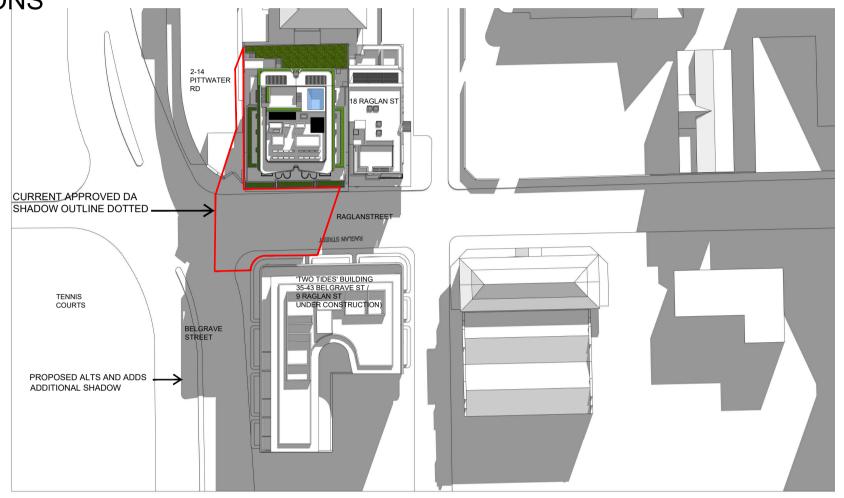


10 AM

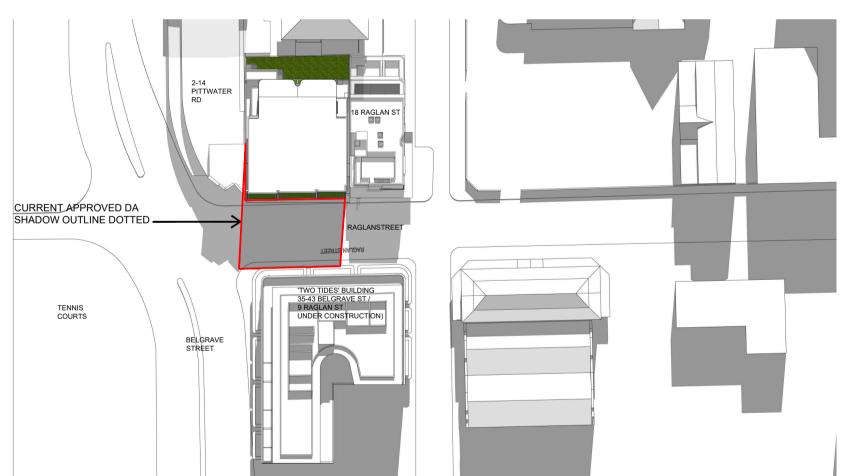

PROPOSED ALTERATIONS **AND ADDITIONS** 

MID-WINTER - 21 JUNE

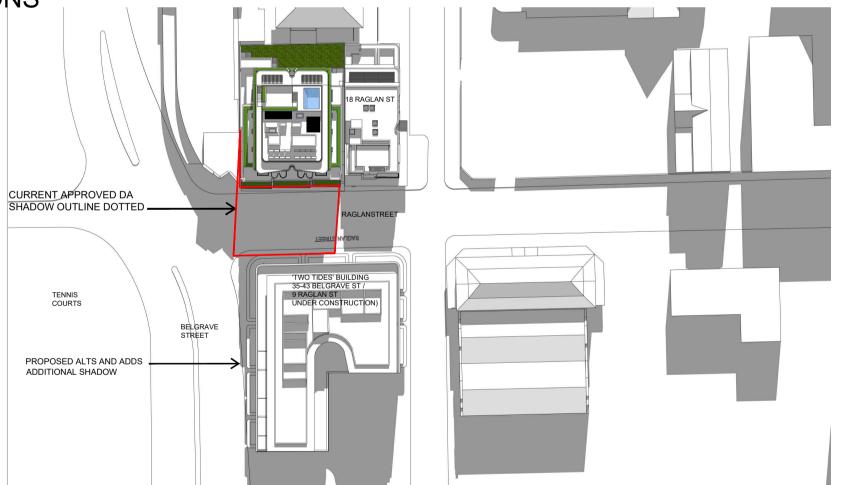

11 AM



CURRENT APPROVED DA SHADOW OUTLINE DOTTED -TENNIS COURTS

PROPOSED ALTERATIONS **AND ADDITIONS** 

MID-WINTER - 21 JUNE

CURRENT APPROVED DA SHADOW OUTLINE DOTTED. PROPOSED ALTS AND ADDS ADDITIONAL SHADOW

12 PM




PROPOSED ALTERATIONS MID-WINTER - 21 JUNE ADDITIONAL SHADOW CURRENT APPROVED DA

1 PM

PROPOSED ALTERATIONS **AND ADDITIONS** 

MID-WINTER - 21 JUNE

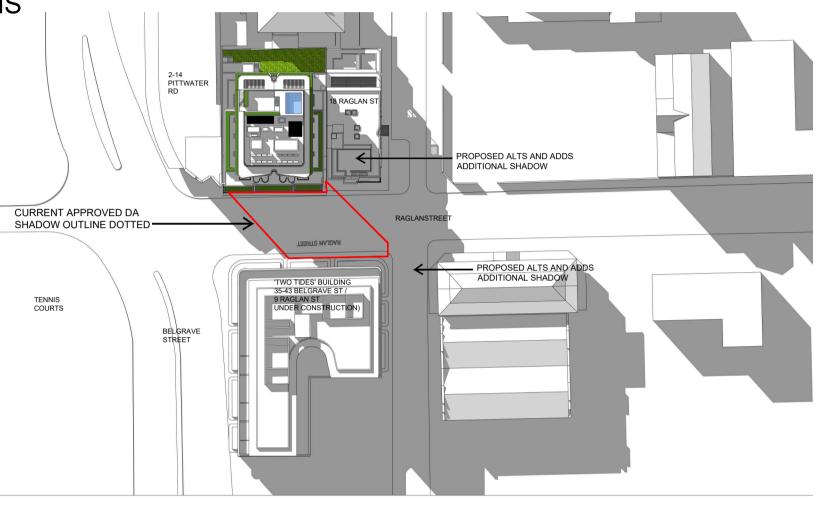


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**EXISTING DA APPROVAL** (3 STOREYS) MID-WINTER - 21 JUNE


2 PM

3 PM

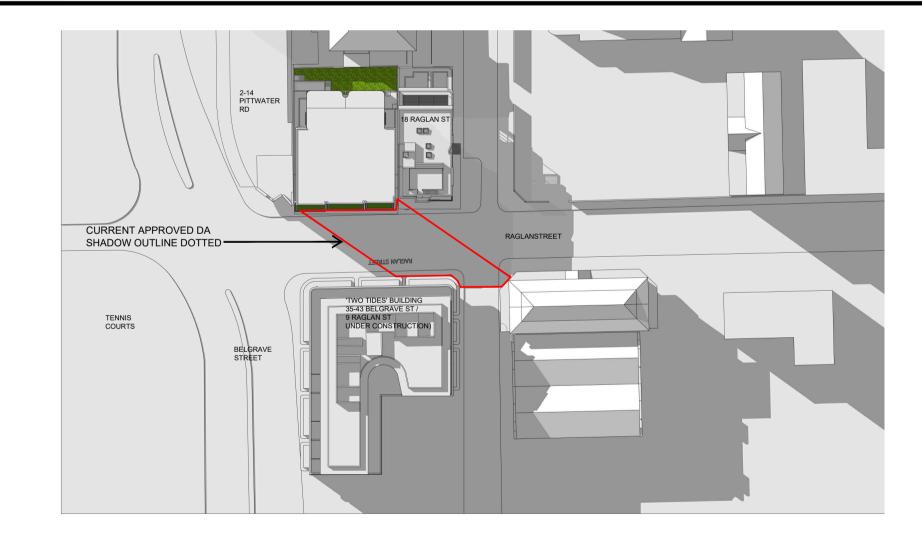

PROPOSED ALTERATIONS **AND ADDITIONS** 

MID-WINTER - 21 JUNE

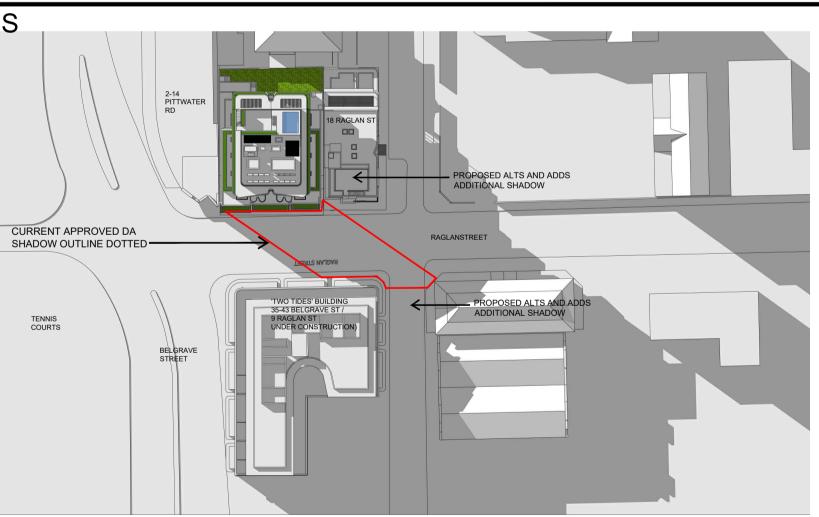

3 PM

REV DATE NOTES

A 29-09-2025 CONSULTANT ISSUE B 24-10-2025 DA ISSUE

DEVELOPMENT APPLICATION

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**ARCHITECT** 

NSW ARB REG 7739

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CLIENT:

PARA-ERE HOLDINGS



E: MATT@CARLISLEARCHITECTS.COM WWW.CARLISLEARCHITECTS.COM NOMINATED ARCHITECT: MATT CARLISLE





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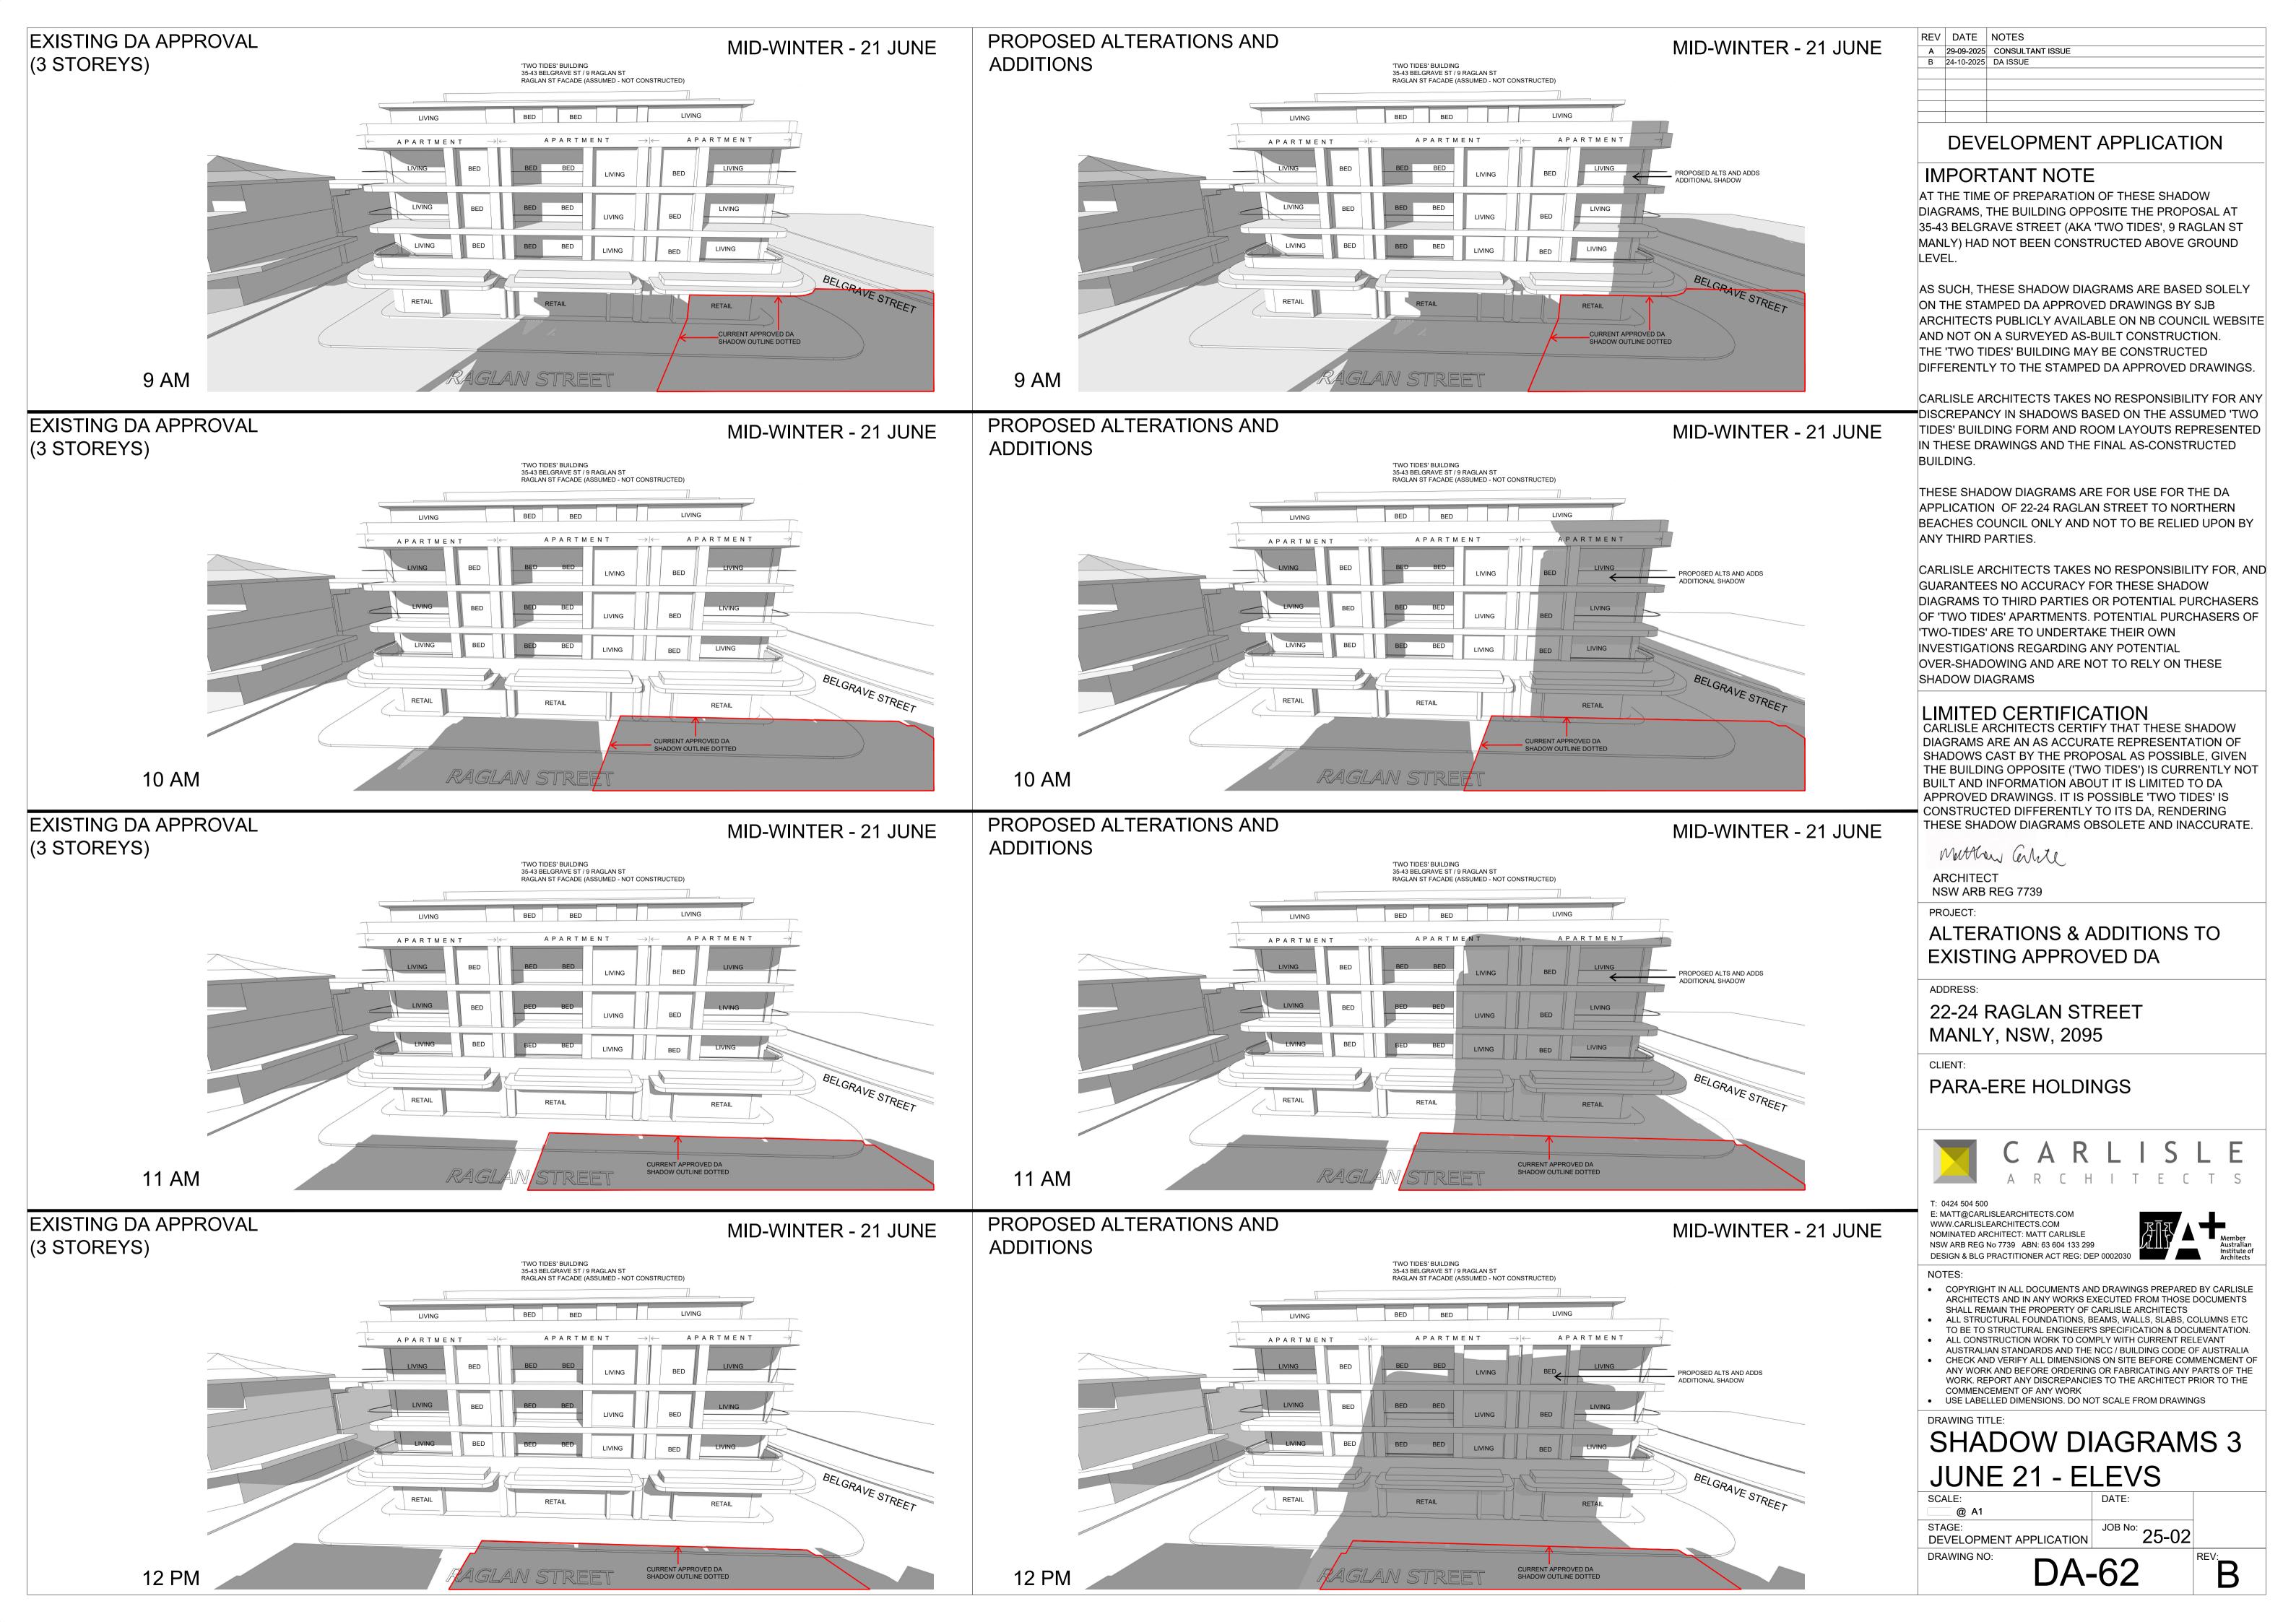
## SHADOW DIAGRAMS 2 JUNE 21 - PLAN VIEW


JOB No: 25-02


DA-61

B

DEVELOPMENT APPLICATION




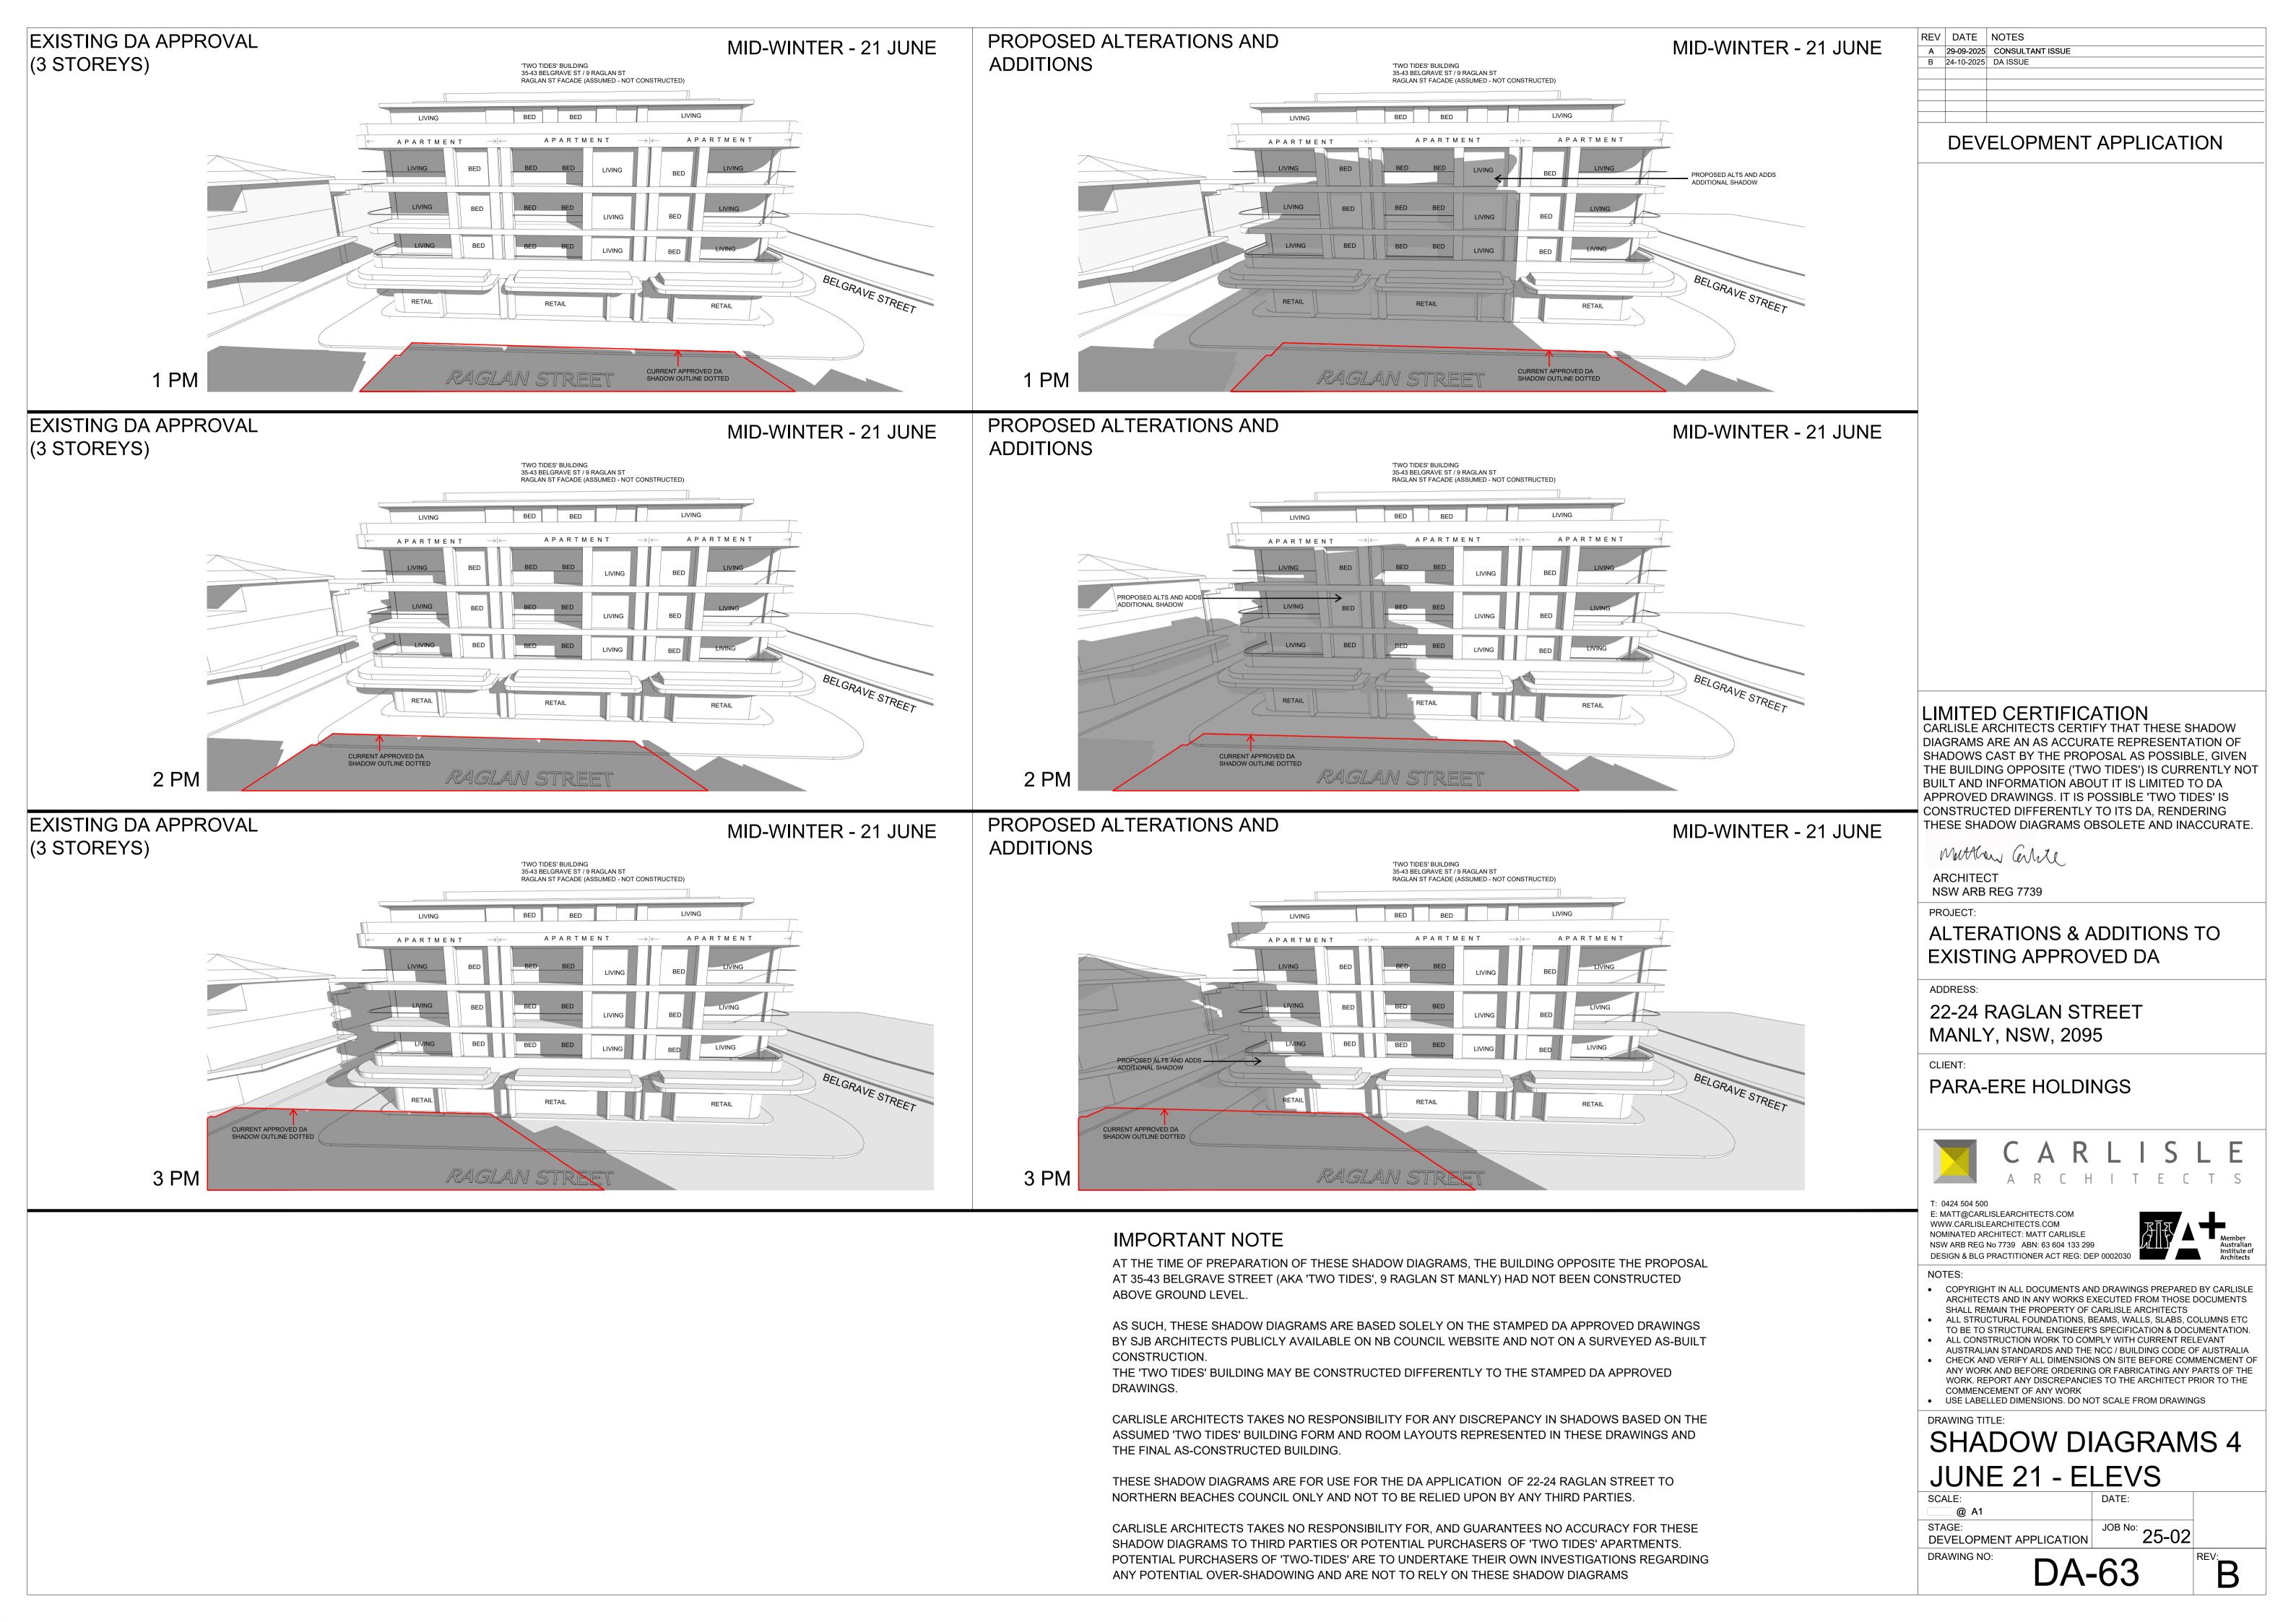

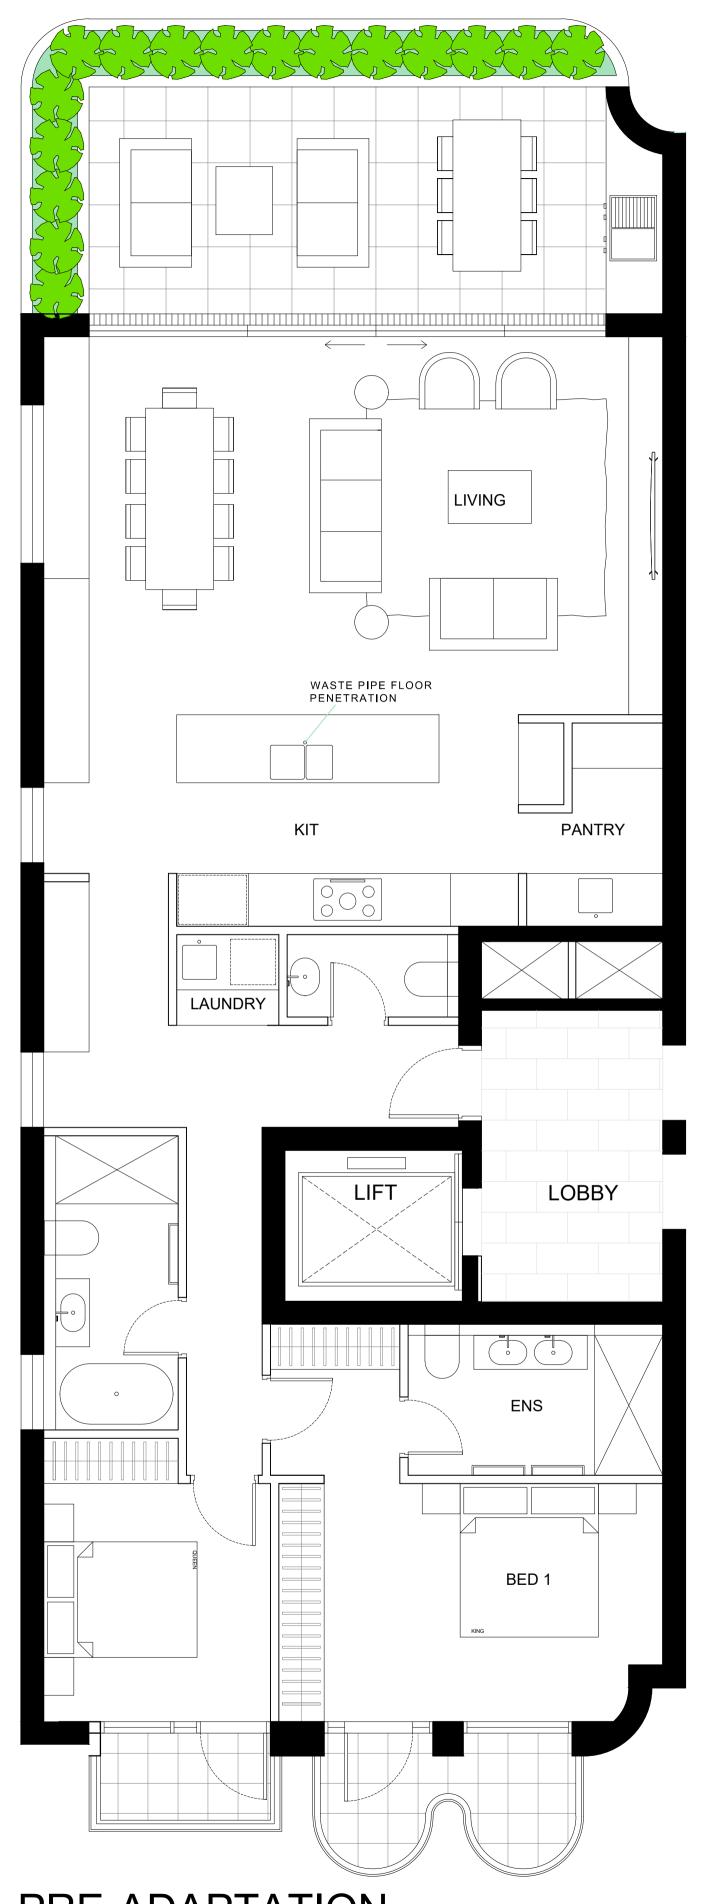

PRE-ADAPTATION

UNITS 7, 9, 11, 13

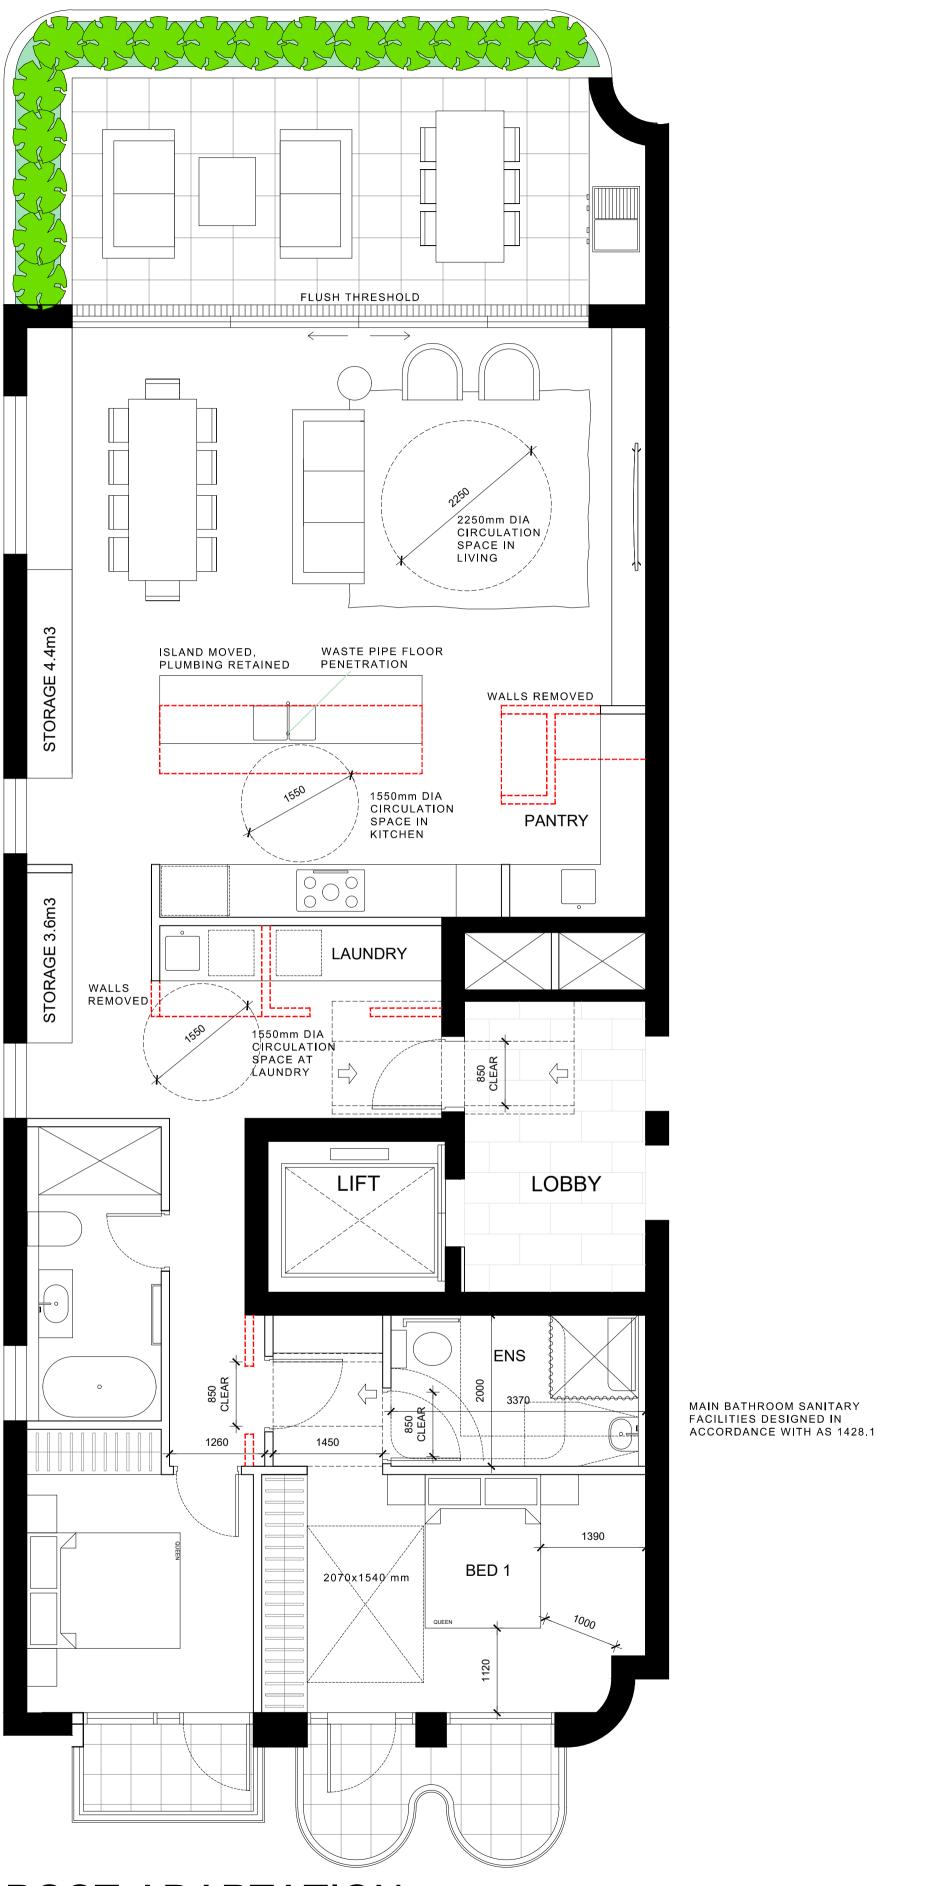

POST-ADAPTATION

UNITS 7, 9, 11, 13

DRAWING NO:

REV DATE NOTES A 29-09-2025 CONSULTANT ISSUE B 24-10-2025 DA ISSUE

#### DEVELOPMENT APPLICATION

### **ALTERATIONS & ADDITIONS TO EXISTING APPROVED DA**

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## ADAPTABLE UNITS

SCALE: 1:\_50 @ A1 DEVELOPMENT APPLICATION





DEVELOPMENT APPLICATION

### **ALTERATIONS & ADDITIONS TO** EXISTING APPROVED DA

ADDRESS:

22-24 RAGLAN STREET MANLY, NSW, 2095

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## PHOTOMONTAGE 1

SCALE: 1:100 @ A1

DRAWING NO:

DEVELOPMENT APPLICATION **DA-80** 



 REV
 DATE
 NOTES

 A
 29-09-2025
 CONSULTANT ISSUE

 B
 24-10-2025
 DA ISSUE

DEVELOPMENT APPLICATION

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ADDRESS:

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### PARA-ERE HOLDINGS



T: 0424 504 500 E: MATT@CARLISLEARCHITECTS.COM WWW.CARLISLEARCHITECTS.COM NOMINATED ARCHITECT: MATT CARLISLE NSW ARB REG No 7739 ABN: 63 604 133 299



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## PHOTOMONTAGE 2

SCALE: 1:100 @ A1 STAGE: DEVELOPMENT APPLICATION

JOB No: 25-02

DA-81