# PROPOSED RESIDENTIAL DEVELOPMENT 21 BASSETT STREET MONA VALE

#### STORMWATER MANAGEMENT PLANS

#### **GENERAL NOTES:**

- . THESE THE PLANS SHALL BE READ IN CONJUCTION WITH OTHER RELEVANT CONSULTANTS'S PLANS, SPECIFICATIONS, CONDITIONS OF DEVELOPMENT CONCEST AND CONSTRUCTION CERTIFICATE REQUIREMENTS. WHERE DISCREPANCIES ARE FOUND NASTASI CONSULING GROUP MUST BE CONTACTED IMMEDIATELY FOR VERIFICATION.
- WHERE THESE PLANS ARE NOTED FOR DEVELOPMENT APPLICATION PURPOSES ONLY, THEY
  SHALL NOT BE USED FOR OBTAINING A CONSTRUCTION CERTIFICATE NOR USED FOR
  CONSTRUCTION PURPOSES.
- . SUBSOIL DRAINAGE SHALL BE DESIGNED AND DETAILED BY THE STRUCTURAL ENGINEER. SUBSOIL DRAINAGE SHALL NOT BE CONNECTED INTO THE STORMWATER SYSTEM IDENTIFIED ON THESE PLAN UNLESS APPROVED BY NASTASI CONSULING GROUP ENGINEERS.

#### STORMWATER CONSTRUCTION NOTES:

ALL WORK SHALL BE CARRIED OUT IN ACCORDANCE WITH AS/NZS 3500 (CURRENT EDITION) AND THE REQUIREMENTS OF THE LOCAL COUNCIL'S POLICIES AND CODES

THE MINIMUM SIZE OF THE STORMWATER DRAINS SHALL NOT BE LESS THAN DN 90 FOR CLASS 1 BUILDINGS AND DN 100 FOR OTHER CLASSES OF BUILDING OR AS REQUIRED BY REGULATORY AUTHORITY

THE MINIMUM GRADIENT OF STORMWATER DRAINS SHALL BE 1%, UNLESS NOTED OTHERWISE

COUNCIL'S TREE PRESERVATION ORDER IS TO BE STRICTLY ADHERED TO . NO TREES SHALL BE REMOVED UNTIL PERMIT IS OBTAINED

PUBLIC UTILITY SERVICES ARE TO BE ADJUSTED AS NECESSARY AT THE CLIENT'S EXPENSE

ALL PITS TO BE BENCHED AND STREAMLINED. PROVIDE STEP IRONS FOR ALL PITS OVER 1.2m DEEP  $\,$ 

ALL PITS IN AN EASEMENT OR TRAFFICABLE AREA ARE TO BE PRE-CAST OR CASTIN-SITU OR APPROVED EQUIVALENT

MAKE SMOOTH JUNCTION WITH ALL EXISTING WORK

VEHICULAR ACCESS AND ALL SERVICES TO BE MAINTAINED AT ALL TIMES TO ADJOINING PROPERTIES AFFECTED BY CONSTRUCTION

SERVICES SHOWN ON THESE PLANS HAVE BEEN LOCATED FROM INFORMATION SUPPLIED BY THE RELEVANT AUTHORITIES AND FIELD INVESTIGATIONS AND ARE NOT GUARANTEED COMPLETE NOR CORRECT. IT IS THE CLIENT & CONTRACTOR'S RESPONSIBILITY TO LOCATE ALL PRIOR TO CONSTRUCTION

ANY VARIATION TO THE WORKS AS SHOWN ON THE APPROVED DRAWINGS ARE TO BE CONFIRMED BY NASTASI CONSULING GROUP PRIOR TO THEIR COMMENCEMENT

#### RAINWATER RE-USE NOTES:

- RAINWATER SUPPLY PLUMBING TO BE CONNECTED TO OUTLETS WHERE REQUIRED BY BASIX CERTIFICATE (BY OTHERS)
- TOWN WATER CONNECTION TO RAINWATER TANK TO THE SATISFACTION OF THE REGULATORY AUTHORITY. THIS WAY REQUIRE PROVISION OF:
   1.PERMANENT AIR GAP
   2.2 BACKET ON PERMANENT AIR GAP
   2.3 BACKET ON PERMANENT
- 3. NO DIRECT CONNECTION BETWEEN TOWN WATER SUPPLY AND THE RAINWATER SUPPLY
- 4. AN APPROVED STOP VALVE AND/OR PRESSURE LIMITING VALVE AT THE RAINWATER TANK
- 5. PROVIDE AT LEAST ONE EXTERNAL HOSE COCK ON THE TOWN WATER SUPPLY FOR FIRE
- 6. PROVIDE APPROPRIATE FLOAT VALVES AND/OR SOLENOID VALVES TO CONTROL TOWN WATER SUPPLY INLET TO TANK IN ORDER TO ACHIEVE THE TOP-UP INDICATED ON THE TYPICAL DETAIL
- ALL PLUMBING WORKS ARE TO BE CARRIED OUT BY LICENSED PLUMBERS IN ACCORDANCE WITH AS/NZS3500.1 NATIONAL PLUMBING AND DRAINAGE CODE
- 8. PRESSURE PUMP ELECTRICAL CONNECTION TO BE CARRIED OUT BY A LICENSED ELECTRICIAN
- 9. ONLY ROOF RUN-OFF IS TO BE DIRECTED TO THE RAINWATER TANK. SURFACE WATER INLETS
- 10. PIPE MATERIALS FOR RAINWATER SUPPLY PLUMBING ARE TO BE APPROVED MATERIALS TO ASINZE3500 PART 1 SECTION 2 AND TO BE CLEARLY AND PERMANENTLY IDENTIFIED AS 'RAINWATER'. THIS MAY BE ACHIEVED FOR BELOW GROUND PIPES USING IDENTIFICATION TAPE (MADE IN ACCORDANCE WITH AS2648) OR FOR ABOVE FROUND PIPES BY USING ADHESIVE PIPE MARKERS (MAKE IN ACCORDANCE WITH AS1345)
- 11. EVERY RAINWATER SUPPLY OUTLET POINT AND THE RAINWATER TANK ARE TO BE LABELED 'RAINWATER' ON A METALLIC SIGN IN ACCORDANCE WITH AS131619
- 12. ALL INLETS AND OUTLETS TO THE RAINWATER TANK ARE TO HAVE SUITABLE MEASURES PROVIDED TO PREVENT MOSQUITO AND VERMIN ENTRY.

#### **EROSION AND SEDIMENT NOTES:**

- THESE THE PLANS SHALL BE READ IN CONJUCTION WITH EROSION AND SEDIMENT CONTROL DETAILS AS ATTACHED
- 2. THE CONTRACTOR SHALL IMPLEMENT ALL SOIL EROSION AND SEDIMENT CONTROL MEASURE AS NECESSARY AND TO THE SATISFACTION OF THE RELEVANT LOCAL AUTHORITY PRIOR TO THE COMMENCEMENT ANY DURING CONSTRUCTION. NO DISTURBANCE TO THE SITE SHALL BE PERMITTED OTHER THAN IN THE IMMEDIATE AREA OF THE WORKS AND NO MATERIAL SHALL BE REMOVED FROM THE SITE WITHOUT THE RELEVANT LOCAL AUTHORITY APPROVAL. ALL EROSION AND SEDIMENT CONTROL DEVICES TO BE INSTALLED AND MAINTAINED IN ACCORDANCE WITH STANDARDS OUTLINED IN NSW DEPARTMENT OF HOUSING'S "MANAGING URBAN STORMWATER SOILS AND CONSTRUCTIONS"
- 3. TOPSOIL SHALL BE STRIPPED AND STOCKPILED OUTSIDE HAZARD AREA SUCH AS DRAINAGE LINES. THIS TOPSOIL SHALL BE RESPREAD LATER ON AREAS TO BE REVEGETATED AND STABILIZED ONLY. TOPSOIL SHALL NOT BE RESPREAD ON ANY OTHER AREA UNLESS SPECIFICALLY INSTRUCTED BY THE SUPERINTENDENT. IF THEY ARE TO REMAIN LONGER THAN ONE MONTH STOCK PILES SHALL BE PROTECTED FROM EROSION BY COVERING THEM WITH A MULCH AND HYDROSEEDING AND, IF NECESSARY, BY LOCATING BANKS OR DRAINS DOWNSTREAM OF A STOCKPILE TO RETARD SILT LADEN RUNOFF
- 4. THE CONTRACTOR SHALL REGULARLY MAINTAIN ALL EROSION AND SEDIMENT CONTROL DEVICES AND REMOVE ACCUMULATED SILT FROM SUCH DEVICES SUCH THAT MORE THAN 60% OF THEIR CAPACITY IS NOT LOST. ALL THE SILT IS TO BE PLACED OUTSIDE THE LIMIT OF WORKS. THE PERIOD FOR MAINTAINING THESE DEVICES SHALL BE AT LEAST UNTIL ALL DRISTURBED AREAS ARE REVEGETATED AND FURTHER AS MAY BE DIRECTED BY SUPERINTENDENT. OR COUNCIL
- VEHICULAR TRAFFIC SHALL BE CONTROLLED DURING CONSTRUCTION CONFINING ACCESS WHERE POSSIBLE TO NOMINATED STABILISED ACCESS POINTS
- THE CONTRACTOR SHALL IMPLEMENT DUST CONTROL BY REGULAR WETTING DOWN DISTURBED AREA
- 7. ALL DRAINAGE PIPE INLETS TO BE CAPPED UNTIL
- DOWNPIPES CONNECTED
- PITS CONSTRUCTED AND PROTECTED WITH SILT BARRIER

#### MINIMUM PIPE COVER NOTES:

LOCATION	MINIMUM COVER		
NO SUBJECT TO VEHICLE LOADING	100mm SINGLE RESIDENTIAL		
SUBJECT TO VEHICLE LOADING	450mm WHERE NOT IN A ROAD 600mm		
UNDER A SEALED ROAD			
UNSEALED ROAD	750mm		
PAVED DRIVEWAY	100mm PLUS DEPTH OF CONCRETE		

SEE AS2032 INSTALLATION OF UPVC PIPES FOR FURTHER INFORMATION.

CONCRETE PIPE COVER SHALL BE IN ACCORDANCE WITH AS3725-1989 LOADS ON BURIED CONCRETE PIPES, HOWEVER A MINIMUM COVER OF 450mm WILL APPLY.

WHERE INSUFFICIENT COVER IS PROVIDED, THE PIPE SHALL BE COVERED AT LEAST 50mm THICK OVERLAY AND SHALL BE PAVED WITH AT LEAST: 150 mm REINFORCED CONCRETE WHERE SUBJECT TO HEAVY VEHICLE TRAFFIC 75mm THICKNESS OF BRICK OR 100mm OF CONCRETE PAVING WHERE SUBJECT TO LIGHT VEHICLE TRAFFIC; OR

 $50 \mathrm{mm}$  THICK BRICK OR CONCRETE PAVING WHERE NOT SUBJECT TO VEHICLE TRAFFIC

#### SURFACE STORMWATER PIT NOTES:

PIT DEPTH (mm)	MINIMUM PIT SIZE (mm)		
UP TO 600 mm	450 x 450		
FROM 600mm TO LESS THAN 900mm	600 x 600		
FROM 900mm	900 x 900		

ALL BASEMENT PIT TO BE FITTED WITH HEAVY DUTY CLASS C GRATE & FRAME

<u>LEGEND</u>				
	DENOTES BELOW GROUND ON-SITE DETENTION TANK			
+ + + + + + + + + + + + + + + + + + +	DENOTES ON-SITE DETENTION BASIN			
oDP	DENOTES Ø100 DOWNPIPE (U.N.O)			
olP	DENOTES INSPECTION OPENING WITH SCREW DOWN LID AT FINISHED SURFACE LEVEL			
●PB	DENOTES PLANTER BOX DRAINS			
FD ● FD	DENOTES SURFACE DRAINAGE GRATES			
Œ	DENOTES CLEANING EYE			
×	STORMWATER PIT - SOLID COVER			
	STORMWATER PIT - GRATED INLET			
	DENOTES GRATED DRAIN			
<u> </u>	DENOTES ABSORPTION TRENCH			
M	DENOTES NON RETURN VALVE			
>>>>	DENOTES OVERLAND FLOW PATH			
IL	INVERT LEVEL			
TK	TOP OF KERB			
RL	REDUCED LEVEL/SURFACE LEVEL			
RL 17.09 +	PROPOSED FINISH SURFACE LEVEL			
	DENOTED Ø100mm PVC (SEWER GRADE) @1% MIN. FALL U.N.O FOR RAINWATER RE-USE			
<u>100</u> <b>}</b>	DENOTED Ø100mm PVC (SEWER GRADE) @1% MIN. FALL U.N.O			
	DENOTED Ø150mm PVC (SEWER GRADE) @1% MIN. FALL U.N.O			
<u>225</u>	DENOTED Ø225mm PVC (SEWER GRADE) @0.5% MIN. FALL U.N.O			
— G —	DENOTE AGG PIPE			
	DENOTE RAINWATER TANK			

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#### SCHEDULE OF DRAWINGS

COVER SHEET & NOTES	SW00
DRAINAGE PLAN	SW01
STORMWATER DETAILS	SW02

#### **LOCATION MAP**





## NASTASI CONSULTING GROUP PTY LTD

RESIDENTIAL - COMMERCIAL - INDUSTRIAL - INFRASTRUCTURE STRUCTURAL - CIVIL - STORMWATER - GEOTECHNICAL - SURVEYING - SITE SERVICES OPERATING IN - NSW - QLD - VIC - TAS

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WATTLE COURT

SITE ADDRESS:
21 BASSETT STREET MONA VALE

DRAWING TITLE:

STATUS:


CONCEPT PLAN FOR APPROVAL

ENGINEER: CHECKED: DATE: 03.09.2025

PROJECT NO: SHEET NO: REVISION: 48763 SW00 A


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**COVER SHEET & NOTES** 

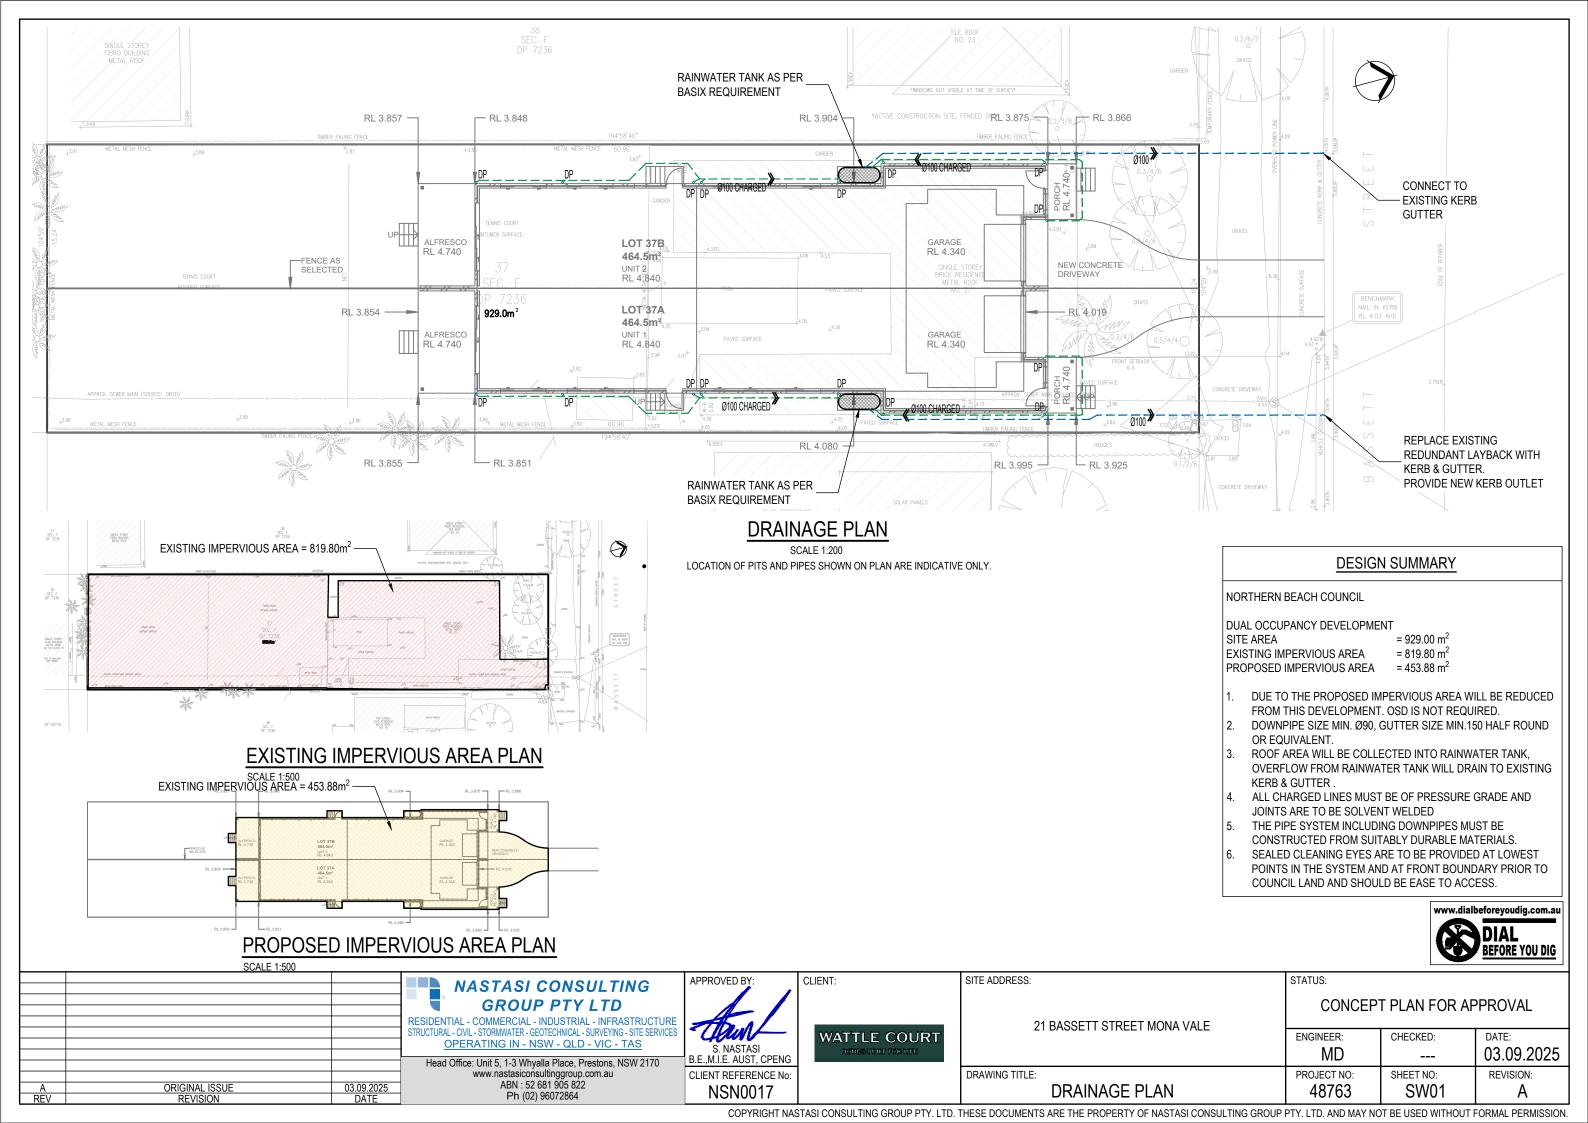


#### **RAINWATER TANK NOTES:**

- 1. A FIRST FLUSH DEVICE IN ACCORDANCE WITH MANUFACTURER'S SPECIFICATIONS SHALL BE FITTED TO RAINWATER TANK SYSTEM TO FLUSH OUT THE FIRST 0.5mm OF RUN-OFF FROM THE ROOF AREA THAT DRAINED INTO THE TANK (E.G. 0.5L/m2).
- 2. PUMP SIZE & SPECIFICATION TO BE NOMINATED BY MANUFACTURER.
- 3. DIMENSIONS ARE INDICATIVE ONLY. EXACT DETAILS TO MANUFACTURER'S SPECIFICATIONS.

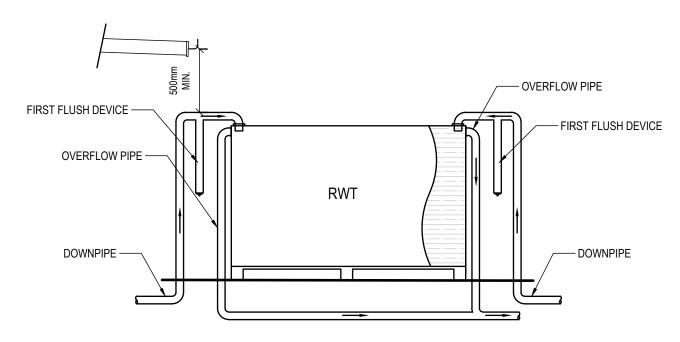


## RAINWATER TANK DETAIL

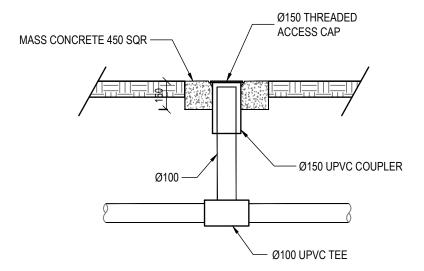


### **CLEANNING EYE DETAILS**

SCALE 1:20

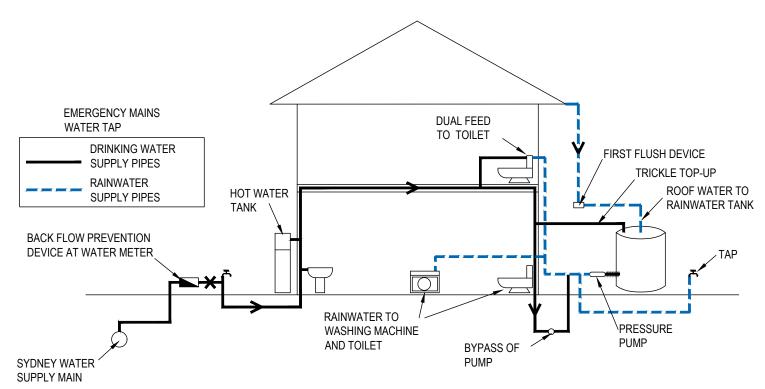

## RAINWATER TANK RE-USE DIAGRAM NTS

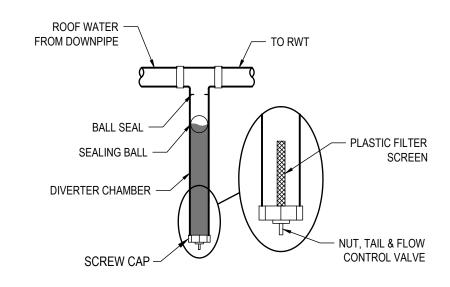

### FIRST FLUSH DEVICE DETAIL

SCALE 1:20



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			Head Office: Unit 5, 1-3 Whyalla Place, Prestons, NSW 2170 www.nastasiconsultinggroup.com.au	B.E.,M.I.E. AUST, CPENG CLIENT REFERENCE No:	000000000 G-0000 0000000	DRA
A REV	ORIGINAL ISSUE REVISION	03.09.2025 DATE	ABN : 52 681 905 822 Ph (02) 96072864	NSN0017		

	SITE ADDRESS:	STATUS:		
21 BASSETT STDEET MONA VALE	21 BASSETT STREET MONA VALE	CONCEPT PLAN FOR APPROVAL		
	21 BAGGETT GTREET WORK WILE	ENGINEER:	CHECKED:	DATE:
		MD		03.09.2025
	DRAWING TITLE: STORMWATER DETAILS	PROJECT NO: 48763	SHEET NO: SW02	REVISION:
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