

ACTION PLANS

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DEVELOPMENT APPLICATION

These plans are for Complying Development Certificate Approval only.


NO.	DRAWING NAME
DA00	COVER
DA01	NOTATION
DA02	SAFTEY NOTES
DA03	SITE ANALYSIS
DA04	SITE / ROOF / SEDIMENT EROSION / WASTE MANAGEMENT / STORMWATER CONCEPT PLAN
DA05	EXISTING LOWER GROUND FLOOR PLAN
DA06	EXISTING GROUND FLOOR PLAN
DA07	EXISTING FIRST FLOOR PLAN
DA08	PROPOSED GROUND FLOOR PLAN
DA09	PROPOSED FIRST FLOOR PLAN
DA10	NORTH / EAST ELEVATION
DA11	SOUTH / WEST ELEVATION
DA12	SOUTH ELEVATION - BOUNDARY FENCE
DA13	LONG / CROSS SECTION
DA14	DRIVEWAY + POOL LONG SECTION
DA15	AREA CALCULATIONS
DA16	WINTER SOLSTICE 9 AM
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DA19	SAMPLE BOARD
DA20	BASIX COMMITMENTS





ITEM DETAILS	DEVELOPMENT APPLICATION									
ADDRESS	132 AVALON PARADE, AVALON BEACH 2107									
LOT & DP/SP	LOT 2 DP 512940									
COUNCIL	NORTHERN BEACHES COUNCIL (P	NORTHERN BEACHES COUNCIL (PITTWATER)								
SITE AREA	886.4m²									
FRONTAGE	18.288m			_						
CONTROLS	PERMISSIBLE / REQUIRED	EXISTING	PROPOSED	COMPLIANCE						
	m / m² / %	m / m² / %	m / m² / %							
<u>LEP</u>										
LAND ZONING	R2	R2	UNCHANGED	YES						
MINIMUM LOT SIZE	700m ²	886.4m²	UNCHANGED	YES						
MAXIMUM BUILDING HEIGHT	8.5m	6.609m	8.34m	YES						
<u>HAZARDS</u>										
ACID SULFATE SOILS	CLASS 5	N/A	N/A	N/A						
BIODIVERSITY	IDENTIFIED	N/A	N/A	N/A						
<u>DCP</u>										
SIDE BOUNDARY ENVELOPE	3.5m	N/A	N/A	-						
SIDE BOUNDARY SETBACKS	E: 2.5m	E: 0.210m	E: 1.025m	YES						
FRONT BOUNDARY SETBACK	6.5m	7.932m	6.5m	YES						
SECONDARY FRONT BOUNDARY SETBACK	3.25m	1.33m	3.313m	YES						
REAR BOUNDARY SETBACK	6.5m	18.53m	19.34m	YES						
LANDSCAPE OPEN SPACE	60% (531.84m²)	69% (609.96m ²)	54% (479.65m ²)	NO						
LANDSCAPE OPEN SPACE 6% IMPERVIOUS TREATMENT	6% (53.184m²)	-	6% (53.184m²)	YES						
LANDSCAPE OPEN SPACE	60% (531.84m²)	69% (609.96m ²)	60% (532.83m²)	YES						
PRIVATE OPEN SPACE	80m²	80m²	80m²	YES						

132 Avalon Parade, Avalon Beach NSW, 2107

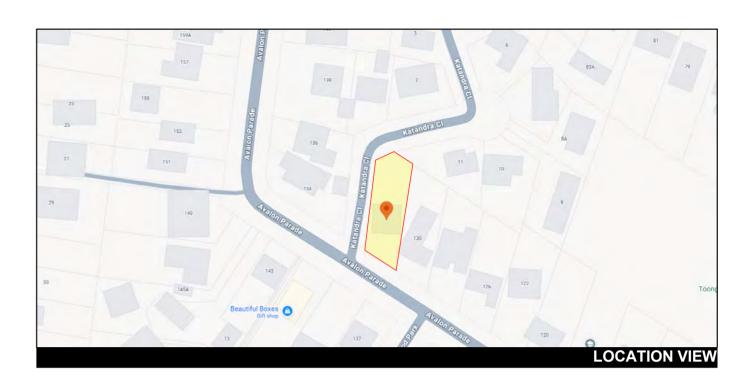

NCC 2022 & AS COMPLIANCES SPECIFICATIONS

- STRUCTURE - PART H1 & SECTION 2 OF NCC

- STRUCTURAL PROVISIONS - PART H1D2 & PART 2.2 OF NCC

- SITE PREPARATION - PART H1D3 & SECTION 3 OF NCC

- EARTHWORKS - PART 3.2 OF NCC - DRAINAGE - PART 3.3 OF NCC

- TERMITE RISK MANAGEMENT - PART 3.4 OF NCC

- FOOTINGS & SLABS - PART H1D4 & SECTION 4 OF NCC - FOOTINGS, SLABS & ASSOCIATED ELEMENTS - PART 4.2 OF NCC

- MASONRY - PART H1D5 & SECTION 5 OF NCC

- MASONRY VENEER - PART 5.2 OF NCC - CAVITY MASONRY - PART 5.3 OF NCC

- UNREINFORCED SINGLE LEAF MASONRY - PART 5.4 OF NCC - ISOLATED PIERS - PART 5.5 OF NCC

- MASONRY COMPONENTS & ACCESSORIES - PART 5.6 OF NCC - WEATHERPROOFING OF MASONRY - PART 5.7 OF NCC

- FRAMING - PART H1D6 & SECTION 6 OF NCC

- SUB FLOOR VENTILATION - PART 6.2 OF NCC

- STRUCTURAL STEEL MEMBERS - PART 6.3 OF NCC

- ROOF AND WALL CLADDING - PART H1D7 & SECTION 7 OF NCC

- SHEET ROOFING - PART 7.2 OF NCC - ROOF TILES & SHINGLES - PART 7.3 OF NCC

- GUTTERS & DOWNPIPES - PART 7.4 OF NCC

- TIMBER & COMPOSITE WALL CLADDING - PART 7.5 OF NCC

- GLAZING - PART H1D8 & SECTION 8 OF NCC - WINDOWS & EXTERNAL GLAZED DOORS - PART 8.2 OF NCC - GLASS - PART 8.3 OF NCC

- GLAZING HUMAN IMPACT - PART 8.4 OF NCC

- DAMP & WEATHERPROOFING - PART H2 OF NCC

- FIRE SAFETY - PART H3 & SECTION 9 OF NCC

- FIRE SEPARATION OF EXTERNAL WALLS - PART 9.2 OF NCC - FIRE PROTECTION OF SEPARATING WALLS & FLOORS - PART 9.3 OF NCC

- FIRE PROTECTION OF GARAGE TOP DWELLINGS - PART 9.4 OF NCC

- SMOKE ALARMS & EVACUATION LIGHTING - PART 9.5 OF NCC

- HEALTH & AMENITY - PART H4 & SECTION 10 OF NCC

- WET AREA WATERPROOFING - PART 10.2 OF NCC - ROOM HEIGHTS - PART 10.3 OF NCC

- FACILITIES - PART 10.4 OF NCC

- LIGHT - PART 10.5 OF NCC - VENTILATION - PART 10.6 OF NCC

- SOUND INSULATION - PART 10.7 OF NCC

- CONDENSATION MANAGEMENT - PART 10.8 OF NCC

- SAFE MOVEMENT & ACCESS - PART H5 & SECTION 11 0F I - STAIRWAY & RAMP CONSTRUCTION - PART 11.2 OF NCC - BARRIERS & HANDRAILS - PART 11.3 OF NCC

- ANCILLARY PROVISIONS - PART H7 & SECTION 12 OF NCC - CONSTRUCTION IN ALPINE AREAS - PART 12.2 OF NCC

- ATTACHMENT OF FRAMED DECKS & BALCONIES TO EXTERNAL WALLS OF BUILDINGS USING A WALING PLATE - PART 12.3 OF NCC - HEATING APPLIANCES, FIREPLACES, CHIMNEYS & FLUES - PART 12.4 OF NCC

- SWIMMING POOLS - PART H7P1 & NSW H7D2 OF NCC

- CONSTRUCTION IN BUSHFIRE PRONE AREAS - PART NSW H7D4 OF NCC

- ENERGY EFFICIENCY - PART H6 & SECTION 13 OF NCC - BUILDING FABRIC - PART 13.2 OF NCC - EXTERNAL GLAZING - PART 13.3 OF NCC

- BUILDING SEALING - PART 13.4 OF NCC

- CEILING FANS - PART 13.5 OF NCC - WHOLE OF HOME ENERGY USAGE - PART 13.6 OF NCC

- SERVICES - PART 13.7 OF NCC

- POOL FENCING & OTHER PROVISIONS - REGULATIONS, & AS 1926 - DEMOLITION WORKS TO COMPLY WITH AS 2601-2001 THE DEMOLITION OF STRUCTURES.

- WATERPROOFING OF WET AREAS TO COMPLY WITH AS 3740:2021

- ALL PLUMBING & DRAINAGE WORK TO COMPLY WITH AS 3500:2021 - ALL PLASTERBOARD WORK TO COMPLY WITH AS 2588:2018

- ALL STRUCTURAL STEEL WORK TO COMPLY WITH AS 4100:2020 & AS 1554.1:2014

- ALL CONCRETE WORK TO COMPLY WITH AS 3600:2018 - ALL ROOF SHEETING WORK TO COMPLY WITH AS 1562.1:2018

- ALL SKYLIGHTS TO COMPLY WITH AS 4285:2019 - ALL CERAMIC TILING TO COMPLY WITH AS 3958.1-2007 & 3958.2-1992

- ALL GLAZING ASSEMBLIES TO COMPLY WITH AS 2047-2014 & AS 1288:2021 - ALL TIMBER RETAINING WALLS ARE TO COMPLY WITH AS 1720, AS 1170

- ALL RETAINING WALLS ARE TO COMPLY WITH AS 3700:2018 & AS 3600:2018 - ALL CONSTRUCTION IN BUSHFIRE-PRONE AREAS TO COMPLY WITH AS 3959:2018

IMPORTANT NOTATION FOR BUILDERS

- All dimensions are to be confirmed on-site by the builder/subcontractor, any incongruencies must be reported to the Designer in writing before the commencement of any work.
- No Survey has been made on the boundaries. All bearings, distances, and areas have been taken from the contour survey plan. A Survey must be carried out to confirm the exact boundary locations.
- No construction work shall commence until a site survey confirming the site boundaries has been completed. The contractor is to ensure that the approved boundary setbacks are confirmed and used, the boundary setbacks take precedence over all other dimensions. The Survey work must be performed by a registered Surveyor. - In the event of encountering any discrepancies on these drawings, specification, or subsequent instructions issued,
- the Builder/Subcontractor shall contact the designer in writing before proceeding further with any work. The builder/subcontractor is responsible to ensure that all materials installed on-site are fit for purpose and comply with the NCC and relevant Australian Standards. The builder is to obtain written confirmation of material selection by the
- All construction, control joints, and expansion joints in the walls, floors, and other locations shall be in strict accordance with the structural engineering details. No joints or breaks other than specified are allowed without written permission from the Engineer
- Measurements for the fabrication of secondary components such as windows, doors, internal frames, structural steel components, and the like, are not to be taken from these documents. Measurements must be taken on-site to suit the work as constructed
- All structural components shall be in strict accordance with details and specifications as prepared by a suitably qualified structural engineer.
- All existing structures need to be examined for structural adequacy, and it is the Contractor's responsibility to ensure that a certificate of structural adequacy is available prior to the start of any work.

SPECIFICATION

Client prior to ordering.

- "Approval" obtained by either an 'Accredited Certifying Authority' or 'Local Council'.
- The Owner will directly pay all fees associated with the following:
- Building approval from council or accredited certifier, any footpath and kerb deposits with the local council, insurance fees to Building Services Corporation, Long Service Leave levy fees and approval fees by water and sewerage authority. All other fees are to be paid by the builder. The amount of any local authority deposits which are forfeited due to damage or other causes, will be deducted from payments due to the builder.
- -The Builder is to provide at his/her own expense adequate Public Risk Insurance and arrange indemnification under the Workers Compensation Act. Works insurance to be as stated in the contract conditions
- All tenderers are to visit the site to satisfy themselves as to the nature and extent of the Works, facilities available and difficulties entailed in the works as Variations will not be allowed due to work arising owing to neglect of this clause.
- These drawings shall be read in conjunction with all structural and other consultant's drawings and specifications and with any such written instructions as may be issued during the course of the contract.
- Set out dimensions shown on this drawing shall be verified by the builder on site before commencement of any work.
- Dimensions shall not be obtained by scaling the drawings, use figured dimensions. All dimensions are in millimetres. - The Builder is to ensure all construction, levels and other items comply with the conditions of the Building Approval.
- Any detailing additional to that which is supplied shall be resolved between the Owner and the Builder, to the Owner's approval. Except for any structural details or design, which is to be supplied by the Engineer.
- All work to be carried out in a tradesman like manner and in accordance with the standards, codes and regulations of Standards Australia, the National Construction Code and any statutory authority having jurisdiction over the works. - All structural work is to be in accordance with the structural details prepared by a suitably qualified structural engineer, including but not limited to all piers, footings, concrete slabs, retaining walls, steelworks, formwork, underpinning additional structural loads, timber framing, wind bracing and associated connections. Builder to obtain prior to finalising the tender, unless previously obtained by owners.
- All brickwork is to be selected by the Owner, and is to comply with AS 1640.
- All masonry is to comply with AS 3700.
- Provide all metalwork and flashings necessary to satisfactorily complete the works.
- All timber construction to be in accordance with AS 1684 Residential timber-framed construction. Level and grade where necessary under timber floors to provide a minimum clearance of 300mm under bearers or 400mm under joists. Adequate precautions shall be taken to ensure that the surface and/or seepage water does not collect or remain under floor area
- Sustainable timbers, and not rainforest or old growth timber will be used. Recycled timber or second hand timbers are to be sourced and used in preference to plantation timbers, if available and suitable
- All glazing installation is to comply with AS 1288, AS 2047 and in accordance with manufacturers recommendations. - All wall and ceiling linings in wet areas to be plasterboard and villaboard, or equal. A breathable wall wrap is to be provided to all external walls. Timber cladding is to be battened out from timber frame to provide an 'air' gap to prevent condensation. Workmanship is to comply with the relevant Australian Standards or installed in accordance with manufacturer's specifications. All bathrooms and wet areas to be waterproofed with a flexible membrane to manufacturer's specifications and to AS 3740, Part H4D2 and Section 10; Part 10.2 of the 2022 NCC.
- All Architraves and skirtings to the profile as selected by owner, and painted or stain finish as selected
- All plumbing and drainage work to be installed and completed by a licensed tradesman and in accordance with the statutory body having authority over the works. Connect all waste to Sydney Water sewer line
- Connect all stormwater to existing system or street drainage system in accordance with AS 3500, Part H2D2 and Section 3: Part 3.3 of the 2022 NCC.
- Smoke detector alarms are to be installed in accordance with AS 3786, Part H3D6 and Section 9; Part 9.5 of the 2022
- If a member which provides structural support to the works is subject to termite attack, management measures are to comply with AS 3660 and Section 3; Part 3.4 of the 2022 NCC. Termite management system to be installed to manufacturer's specifications
- Stairs and Balustrades to comply with Part H5D2, H5D3 and Section 11; Part 11.2 and 11.3 of the 2022 NCC. Provide a handrail along the full length of the flight and a slip resistant finish to the edge of the nosings to comply with 3.9.1 and 3.9.2 of the NCC. No horizontal elements to facilitate climbing between 150mm and 760mm where floor to level below is more than 4m
- Electrical works to be in accordance with SAA wiring rules and be done by a licenced tradesperson. Obtain electrical layout prior to proceeding. All electrical power (GPO's) and light outlets to be determined by the Owner
- Painting: All paints or other coatings shall be of the best quality materials & of approved manufacture. All priming materials shall be of an approved brand acceptable to the manufacturer of the finishing coats to be used. External iginery intended to be painted shall be primed on all faces at the place of assembly. Where new work or alteration work adjoins existing painted surfaces allow for repainting existing surfaces to provide uniform appearance.
- ZERO-VOC or LOW-VOC paints and primers only are to be used.
- Any work indicated on the plans but not specified and any item not shown on the plans which is obviously necessary as part of proper construction and/or finish, is to be considered as shown and specified and is to be undertaken as part of the contract. Variations will not be permitted without prior written approval by the owners
- The Builder shall provide sediment and siltration control measures as required by Council, and maintain them throughout the duration of the works
- A legible copy of the plans bearing approval stamps, must be maintained on the job site at all times. Hours of construction shall be restricted to the times as required by the building approval.
- The Builder is to arrange for all inspections required by the relevant authorities and/or lending institutions, to their

- The Builder is to obtain approval for interruptions to existing services and minimise the duration and number of interruptions. Any interruptions to existing services and equipment is to be undertaken by appropriately qualified tradespersons
- The Builder shall restore, reinstate or replace any damage to existing structures or landscaping caused by the
- Provide protection to existing trees to remain, or as required by the Approval Conditions.

GENERAL NOTATION

- Approved means by the 'relevant local authority' or council?
- All work and materials to comply with the current Australian standards at the time of commencement, where
- The builder is to comply with all ordinances, local authority regulations and the requirements of all services supply authorities having jurisdiction over the works.
- All new downpipes are to be connected to the existing stormwater system.
- All timber sizes and concrete details to be confirmed by the builder prior to commencement of any work
- All gutters, downpipes to be colorbond.
- All wall and ceiling linings to be plasterboard or cement render as selected, and villa board in wet areas. To comply with relevant Australian standards, and installed in accordance with manufacturers specification

NCC 2022 & AS COMPLIANCES SPECIFICATIONS

- Structure Part H1 & Section 2 of NCC
- Structural Provisions PART H1D2 & PART 2.2 of NCC
- Site Preparation Part H1D3 & Section 3 of NCC
- Earthworks Part 3.2 of NCC
- Drainage Part 3.3 of NCC
- Termite Risk Management Part 3.4 of NCC
- Footings & Slabs Part H1D4 & Section 4 of NCC
- Footings, Slabs & Associated Elements Part 4.2 of NCC
- Masonry Part H1D5 & Section 5 of NCC
- Masonry Veneer Part 5.2 of NCC
- Cavity Masonry Part 5.3 of NCC
- Unreinforced Single Leaf Masonry Part 5 4 of NCC
- Isolated Piers Part 5.5 of NCC
- Masonry Components & Accessories Part 5.6 of NCC
- Waetherproofing of Masonry Part 5.7 of NCC
- Framing Part H1D6 & Section 6 of NCC
- Sub Floor Ventilation Part 6.2 of NCC
- Structural Steel Members Part 6.3 of NCC
- Roof & Wall Cladding Part H1D7 & Section 7 of NCC
- Sheet Roofing Part 7.2 of NCC - Roof Tiles & Shingles - Part 7.3 of NCC
- Gutters & Downpipes Part 7.4 of NCC
- Timber & Composite Wall Cladding Part 7.5 of NCC
- Glazing Part H1D8 & Section 8 of NCC
- Windows & External Glazed Doors Part 8.2 of NCC
- Glass Part 8.3 of NCC
- Glazing Human Impact Part 8.4 of NCC
- Damp & Weatherproofing Part H2 of NCC
- Fire Safety Part H3 & Section 9 of NCC
- Fire Separation of External Walls Part 9.2 of NCC
- Fire Protection of Separating Walls & Floors Part 9.3 of NCC - Fire Protection of Garage Top Dwellings - Part 9.4 of NCC
- Smoke Alarms & Evacuation Lighting Part 9.5 of NCC
- Health & Amenity Part H4 & Section 10 of NCC
- Wet Area Waterproofing Part 10.2 of NCC Room Heights - Part 10.3 of NCC
- Facilities Part 10.4 of NCC
- Light Part 10.5 of NCC
- Ventilation Part 10.6 of NCC
- Sound Insulation Part 10.7 of NCC Condensation Management - Part 10.8 of NCC
- Safe Movement & Access Part H5 & Section 11 of NCC - Stairway & Ramp Construction - Part 11.2 of NCC
- Barriers & Handrails Part 11.3 of NCC
- Ancillary Provisions Part H7 & Section 12 of NCC
- Construction in Alpine Areas Part 12.2 of NCC
- Attachment of Framed Decks & Balconies to External Walls of Buildings Using a Waling Plate Part 12.3 of NCC Heating Appliances, Fireplaces, Chimneys & Flues - Part 12.4 of NCC
- Swimming Pools Part H7P1 & NSW H7D2 of NCC
- Construction in Bushfire Prone Areas Part NSW H7D4 of NCC
- Energy Efficiency Part H6 & Section 13 of NCC - Building Fabric - Part 13.2 of NCC
- External Glazing Part 13.3 of NCC
- Building Sealing Part 13.4 of NCC
- Ceiling Fans Part 13.5 of NCC
- Whole of Home Energy Usage Part 13.6 of NCC
- Services Part 13.7 of NCC

- Pool Fencing & other provisions Regulations & AS 1926
- Demolition Works to comply with AS 2601-2001 The Demolition of Structures.
- Waterproofing of Wet Areas to comply with AS 3740:2021
- All plumbing & drainage work to comply with AS 3500:2021
- All plasterboard work to comply with AS 2588:2018
- All structural steel work to comply with AS 4100:2020 & AS 1554.1:2014
- All concrete work to comply with AS 3600:2018
- All roof sheeting work to comply with AS 1562.1:2018
- All skylights to comply with AS 4285:2019
- All ceramic tiling to comply with AS 3958.1-2007 & 3958.2-1992
- All glazing assemblies to comply with AS 2047-2014 & AS 1288:2021
- All timber retaining walls to comply with AS 1720, AS 1170 - All retaining walls to comply with AS 3700:2018 & AS 3600:2018
- All construction in bushfire-prone areas to comply with AS 3959:2018





THIS SET OF DRAWING SHOULD BE READ & KEPT IN ITS ENTIRETY. NO INDIVIDUAL PAGE SHOULD BE SEPARATED FROM THE REST OF THE SET. EACH NOTATION LISTED ON THIS PAGE APPLY TO ALL PAGES OF THIS SET.

SAFTEY NOTES

THESE NOTES MUST BE READ AND UNDERSTOOD BY ALL INVOLVED IN THE PROJECT. THIS INCLUDES (but is not excluded to): OWNER, BUILDER, SUB-CONTRACTORS, CONSULTANTS, RENOVATORS, OPERATORS, MAINTENORS, DEMOLISHERS.

1. FALLS, SLIPS, TRIPS

a) WORKING AT HEIGHTS

DURING CONSTRUCTION

Wherever possible, components for this building should be prefabricated off-site or at ground level to minimise the risk of workers falling more than two metres. However, construction of this building will require workers to be working at heights where a fall in excess of two metres is possible and injury is likely to result from such a fall. The builder should provide a suitable barrier wherever a person is required to work in a situation where falling more than two metres is a possibility.

DURING OPERATION OR MAINTENANCE

For houses or other low-rise buildings where scaffolding is appropriate: Cleaning and maintenance of windows, walls, roof or other components of this building will require persons to be situated where a fall from a height in excess of two metres is possible. Where this type of activity is required, scaffolding, ladders or trestles should be used in accordance with relevant codes of practice, regulations or legislation. For buildings where scaffold, ladders, trestles are not appropriate: Cleaning and maintenance of windows, walls, roof or other components of this building will require persons to be situated where a fall from a height in excess of two metres is possible. Where this type of activity is required, scaffolding, fall barriers or Personal Protective Equipment (PPE) should be used in accordance with relevant codes of practice, regulations or legislation.

b) SLIPPERY OR UNEVEN SURFACES

FLOOR FINISHES Specified

If finishes have been specified by designer, these have been selected to minimise the risk of floors and paved areas becoming slippery when wet or when walked on with wet shoes/ feet. Any changes to the specified finish should be made in consultation with the designer or, if this is not practical, surfaces with an equivalent or better slip resistance should be chosen.

FLOOR FINISHES By Owner

If designer has not been involved in the selection of surface finishes, the owner is responsible for the selection of surface finishes in the pedestrian trafficable areas of this building. Surfaces should be selected in accordance with AS HB 197:1999 and AS/ NZ 4586:2004.

STEPS, LOOSE OBJECTS AND UNEVEN SURFACES

Due to design restrictions for this building, steps and/ or ramps are included in the building which may be a hazard to workers carrying objects or otherwise occupied. Steps should be clearly marked with both visual and tactile warning during construction, maintenance, demolition and at all times when the building operates as a workplace. Building owners and occupiers should monitor the pedestrian access ways and in particular access to areas where maintenance is routinely carried out to ensure that surfaces have not moved or cracked so that they become uneven and present a trip hazard. Spills, loose material, stray objects or any other matter that may cause a slip or trip hazard should be cleaned or removed from access ways. Contractors should be required to maintain a tidy work site during construction, maintenance or demolition to reduce the risk of trips and falls in the workplace. Materials for construction or maintenance should be stored in designated areas away from access ways and work areas.

2. FALLING OBJECTS

LOOSE MATERIALS OR SMALL OBJECTS

Construction, maintenance or demolition work on or around this building is likely to involve persons working above ground level or above floor levels. Where this occurs one or more of the following measures should be token to ovoid objects falling from the area where the work is being carried out onto persons below.

- 1. Prevent or restrict access to areas below where the work is
- being carried out.
- Provide toeboards to scaffolding or work platforms.
- Provide protective structure below the work area.
 Ensure that all persons below the work area have Personal
- 4. Ensure that all persons below the work area have Person

Protective Equipment (PPE).

BUILDING COMPONENTS

During construction, renovation or demolition of this building, parts of the structure including fabricated steelwork, heavy panels and many other components will remain standing prior to or after supporting parts are in place. Contractors should ensure that temporary bracing or other required support is in place at all times when collapse which may injure persons in the area is a possibility. Mechanical lifting of materials and components during construction, maintenance or demolition presents a risk of falling objects. Contractors should ensure that appropriate lifting devices are used, that loads are properly secured and that access to areas below the load is prevented or restricted.

3. TRAFFIC MANAGEMENT

For building on a major road, narrow road or steeply sloping road: Parking of vehicles or loading/ unloading of vehicles on this roadway may cause a traffic hazard. During construction, maintenance or demolition of this building designated parking for workers and loading areas should be provided. Trained traffic management personnel should be responsible for the supervision of these areas. For building where on-site loading/ unloading is restricted: Construction of this building will require loading and unloading of materials on the roadway. Deliveries should be well planned to ovoid congestion of loading areas and trained traffic management personnel should be used to supervise loading/ unloading areas. For all buildings: Busy construction and demolition sites present a risk of collision where deliveries and other traffic are moving within the site. A traffic management plan supervised by trained traffic management personnel should be adopted for the work site.

4. SERVICES

GENERAL

Rupture of services during excavation or other activity creates a variety of risks including release of hazardous material. Existing services are located on or around this site. Where known, these ore identified on the plans but the excel location and extent of services may vary from that indicated. Services should be located using on appropriate service (such as Dial Before You Dig), appropriate excavation practice should be used and, where necessary, specialist contractors should be used. Locations with underground power: Underground power lines MAY be located in or around this site. All underground power lines must be disconnected or carefully located and adequate warning signs used prior to any construction, maintenance or demolition commencing. Locations with overhead power lines: Overhead power lines MAY be near or on this site. These pose a risk of electrocution if struck or approached by lifting devices or other plant and persons working above ground level. Where there is a danger of this occurring, power lines should be, where practical, disconnected or relocated. Where this is not practical adequate warning in the form of bright coloured tape or signage should be used or a protective barrier provided.

5. MANUAL TASKS

Components within this design with a moss in excess of 25kg should be lifted by two or more workers or by mechanical lifting device. Where this is not practical, suppliers or fabricators should be required to limit the component mass. All material packaging, building and maintenance components should clearly show the total moss of packages and where practical all items should be stored on site in a way which minimises bending before lifting. Advice should be provided on safe lifting methods in all areas where lifting may occur. Construction, maintenance and demolition of this building will require the use of portable tools and equipment. These should be fully maintained in accordance with manufacturer's specifications and not used where faulty or (in the case of electrical equipment) not carrying a current electrical safety tag. All safety guards or devices should be regularly checked and Personal Protective Equipment should be used in accordance with manufacturer's specification.

6. HAZARDOUS SUBSTANCES

ASBESTOS

For alterations to a building constructed prior to 1990: If this existing building was constructed prior to:

if this existing building was constructed prior to 1990 - it therefore may contain asbestos

1986 - it therefore is likely to contain asbestos

either in cladding material or in fire retardant insulation material. In either case, the builder should check and, if necessary, take appropriate action before demolishing, culling, sanding, drilling or otherwise disturbing the existing

POWDERED MATERIALS

Many materials used in the construction of this building con cause harm if inhaled in powdered form. Persons working on or in the building during construction, operational maintenance or demolition should ensure good ventilation and wear Personal Protective Equipment including protection against inhalation while using powdered material or when sanding, drilling, cutting or otherwise disturbing or creating powdered material.

TREATED TIMBER

The design of this building may include provision for the inclusion of treated limber within the structure. Dust or furnes from this material can be harmful. Persons working on or in the building during construction, operational maintenance or demolition should ensure good ventilation and wear Personal Protective Equipment including protection against inhalation of harmful material when sanding, drilling, cutting or using treated timber in any way that may cause harmful material to be released. Do not burn treated timber.

VOLATILE ORGANIC COMPOUNDS

Many types of glue, solvents, spray packs, paints, varnishes and some cleaning materials and disinfectants have dangerous emissions. Areas where these are used should be kept well ventilated while the material is being used and for a period after installation. Personal Protective Equipment may also be required. The manufacturer's recommendations for use must be carefully considered at all times.

SYNTHETIC MINERAL FIBRE

Fibreglass, rockwool, ceramic and other material used for thermal or sound insulation may contain synthetic mineral fibre which may be harmful if inhaled or if it comes in contact with the skin, eyes or other sensitive parts or the body. Personal Protective Equipment including protection against inhalation of harmful material should be used when installing, removing or working near bulk insulation material.

TIMBER FLOORS

This building may contain timber floors which have an applied finish. Areas where finishes are applied should be kept well ventilated during sanding and application and for a period after installation. Personal Protective Equipment may also be required. The manufacturer's recommendations for use must be carefully considered at all times.

7. CONFINED SPACES

EXCAVATION

Construction of this building and some maintenance on the building will require excavation and installation of items within excavations. Where practical, installation should be carried out using methods which do not require workers to enter the excavation. Where this is not practical, adequate support for the excavated area should be provided to prevent collapse. Warning signs and barriers to prevent accidental or unauthorised access to all excavations should be provided.

ENCLOSED SPACES

For buildings with enclosed spaces where maintenance or other access may be required: Enclosed spaces within this building may present a risk to persons

entering for construction, maintenance or any other purpose. The design documentation calls for warning signs and barriers to unauthorised access. These should be maintained throughout the life of the building. Where workers are required to enter enclosed spaces, air testing equipment and Personal Protective Equipment should be provided.

SMALL SPACES

For buildings with small spaces where maintenance or other access may be required: Some small spaces within this building will require access by construction or maintenance workers. The design documentation calls for warning signs and barriers to unauthorised access. These should be maintained throughout the life of the building. Where workers are required to enter small spaces they should be scheduled so that access is for short periods. Manual lifting and other manual activity should be restricted in small spaces.

8. PUBLIC ACCESS

Public access to construction and demolition sites and lo areas under maintenance causes risk to workers and public. Warning signs and secure barriers to unauthorised access should be provided. Where electrical installations, excavations, plant or loose materials are present they should be secured when not fully supervised.

9. OPERATIONAL USE OF BUILDING RESIDENTIAL BUILDINGS

This building has been designed as a residential building. If it, at a later date, it is used or intended to be used as a workplace, the provisions of the Work Health and Safely Act 2011 or subsequent replacement Act should be applied to the new use

NON-RESIDENTIAL BUILDINGS


For non-residential buildings where the end-use has not been identified: This building has been designed to requirements of the classification identified on the drawings. The specific, use of the building is not known at the time of the design and a further assessment of the workplace health and safety issues should be undertaken at the time of fit-out for the end-user. For non-residential buildings where the end-use is known: This building has been designed for the specific use as identified on the drawings. Where a change of use occurs at a later dale a further assessment of the workplace health and safety issues should be undertaken.

10. OTHER HIGH RISK ACTIVITY

All electrical work should be carried out in accordance with Code of Practice: Managing Electrical Risks at the Workplace, AS/ NZ 3012 and all licensing requirements. All work using Plant should be carried out in accordance with Code of Practice: Managing Risks of Plant at the Workplace. All work should be carried out in accordance with Code of Practice: Managing Noise and Preventing Hearing Loss at Work. Due to the history of serious incidents it is recommended that particular care be exercised when undertaking work involving steel construction and concrete placement. All the above applies.





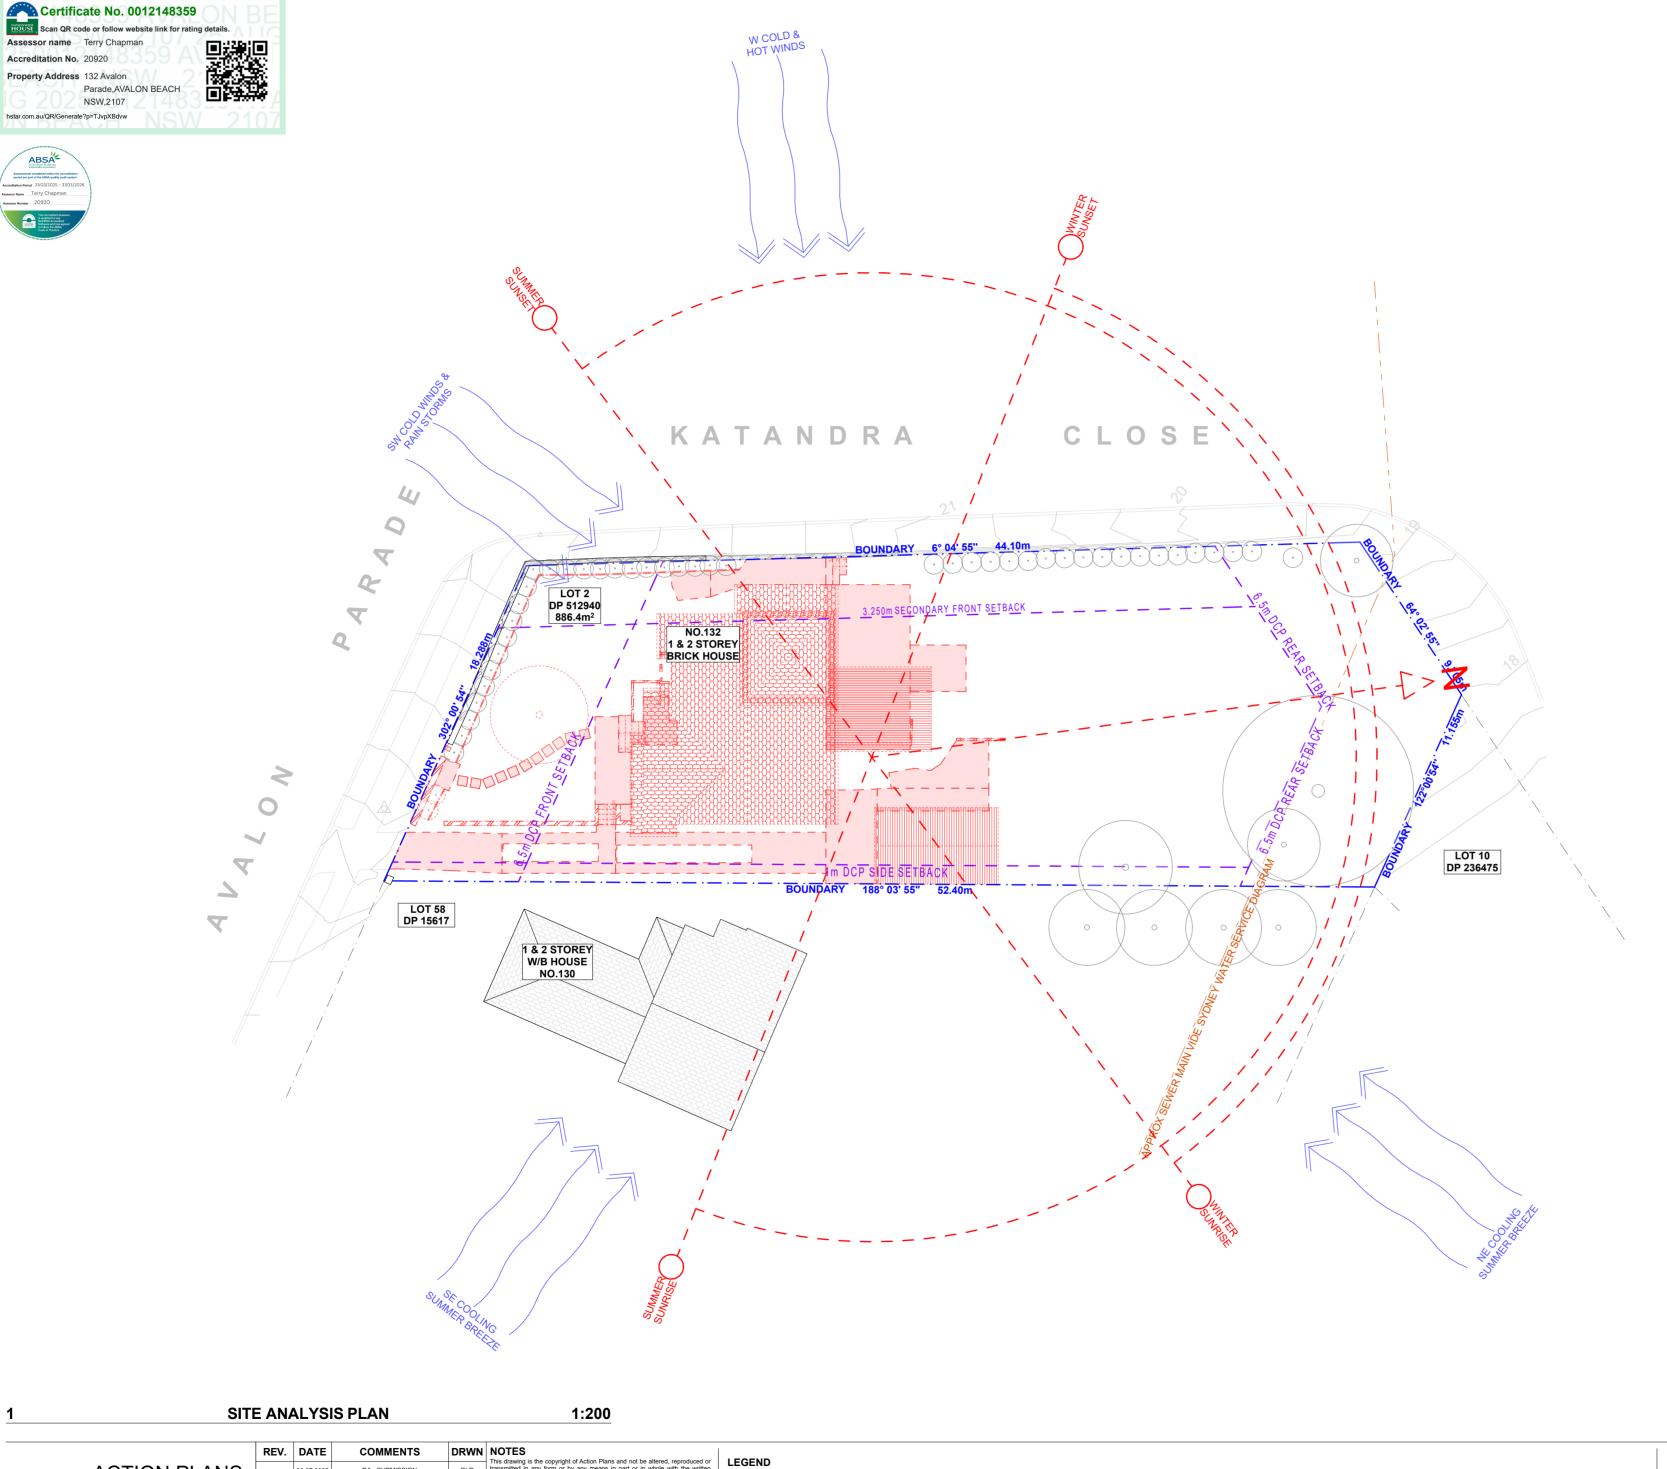







NOTE: ALL DEMOLISHED ELEMENTS TO ENG. SPECIFICATIONS AND AS. 2601 - 2001

DRAWING NAME

SITE ANALYSIS

ACTION PLANS m: 0426 957 518 e:operations@actionplans.com.au w: www.actionplans.com.au

DRWN NOTES

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All errors and omissions are to be verified by the Builder/Contractor/client and referred to the designer prior to the commencement of works.

EXISTING DEMOLISHED PROPOSED

≠EXISTING RL

CLIENT Sue & Jason Boyle

PROJECT ADDRESS

132 Avalon Parade, Avalon Beach NSW, 2107

DATE Monday, 4 August 2025


DRAWING NO.


DA03

SCALE

1:200 @A2



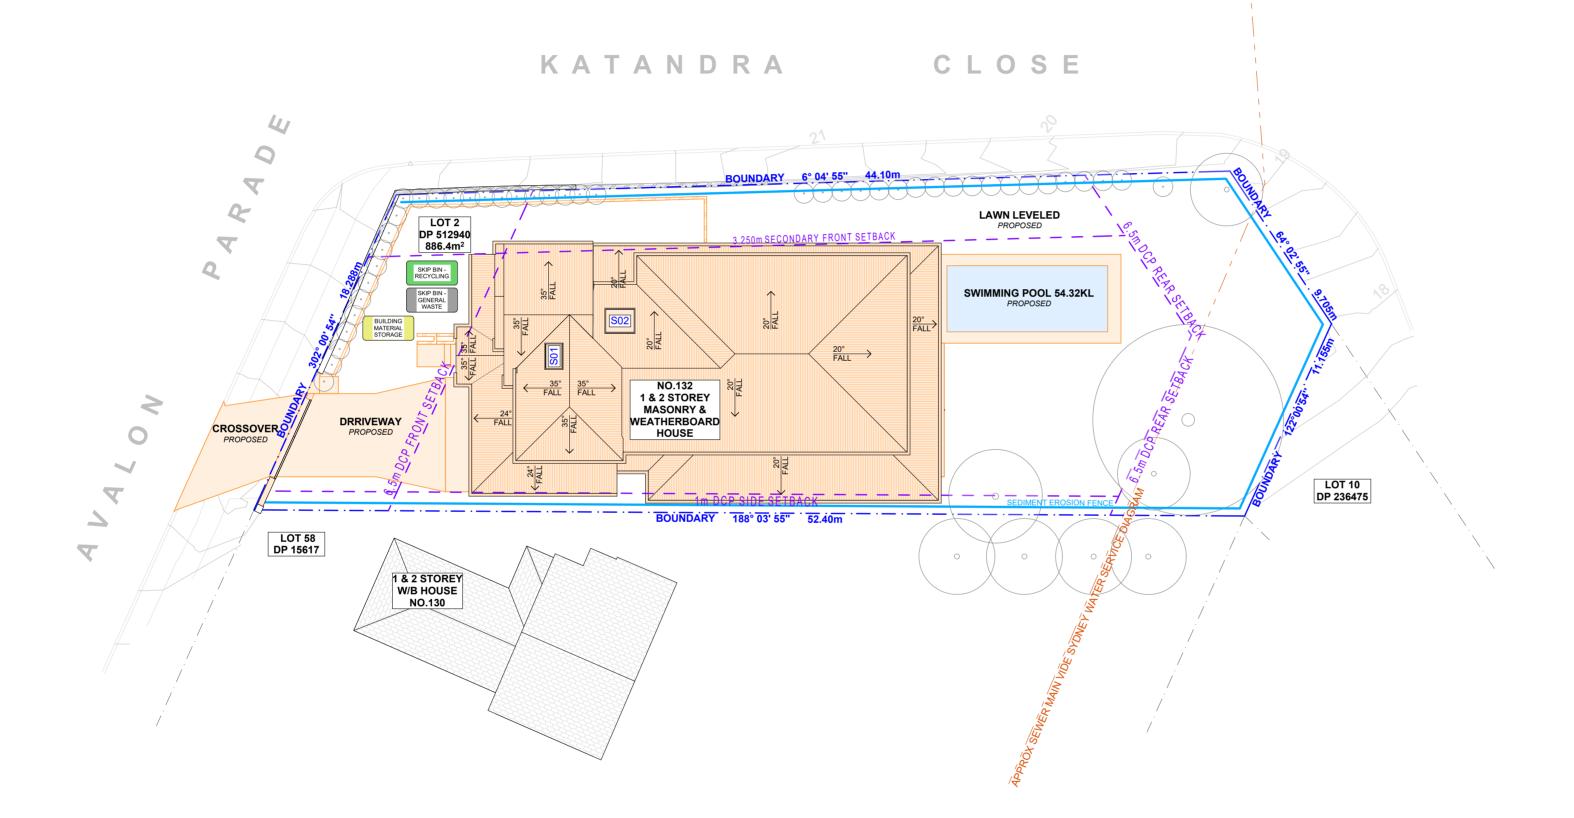

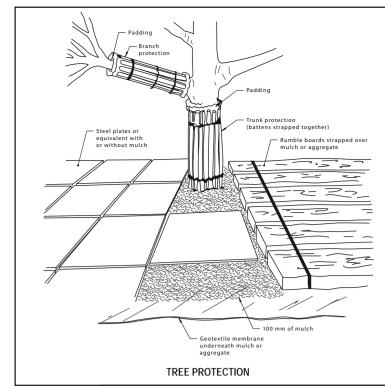

NOTES REGARDING BOUNDARY THE INFORMATION SHOWN ON THIS PLAN IS FOR

DESIGN PURPOSES ONLY. THE POSITION OF BOUNDARY LINES HAVE BEEN ESTABLISHED BY A SURVEY TO MEET THE IDENTIFICATION REQUIREMENTS FOR COUNCIL AND NOT FOR REGISTRATION WITH THE LAND REGISTRATION SERVICES NSW NOR MAY THIS PLAN BE USED FOR ANY OTHER PURPOSE. SUBSEQUENT REGISTERED OR OTHER SURVEYS MAY AFFECT THE DEFINED BOUNDARY POSITIONS IN THIS AREA. ANY DIFFERENCES OF THIS NATURE ARE BEYOND THE PURPOSES OF THIS PLAN. THIS PLAN IS FOR THE ABOVE STATED PURPOSES ONLY. RESTRICTIONS ON THE TITLE HAVE NOT BEEN INVESTIGATED. IF FURTHER DEVELOPMENT IS CONTEMPLATED OR CONSTRUCTION INTENDED THEN IT IS IMPORTANT THAT A SURVEY SET OUT IS CARRIED OUT.

DUST CONTROL:

TO REDUCE DUST GENERATED BY WIND ACTION, THE REMOVAL OF THE TOP SOIL IS TO BE MINIMISED. TO PREVENT DUST GENERATION, WATERING DOWN OF THE SITE, ESPECIALLY DURING THE MOVEMENT OF MACHINERY IS REQUIRED. WHERE EXCAVATING INTO ROCK, KEEP THE SURFACE MOIST TO MINIMISE DUST. CONSTRUCT A GRAVEL ENTRY/EXIT POINT USING BLUE METAL AND RESTRICT ALL VEHICLE MOVEMENTS
WITHIN THE SITE TO A MINIMUM. ENSURE WIND BREAKS, SUCH AS EXISTING FENCES ARE MAINTAINED DURING THE CONSTRUCTION PHASE UNTIL NEW LANDSCAPING IS PROVIDED OR REINSTATED. PREVENT DUST BY COVERING STOCKPILES

SEDIMENT NOTE:

1. ALL EROSION AND SEDIMENT CONTROL MEASURES TO BE INSPECTED AND MAINTAINED DAILY BY THE SITE

2. MINIMISE DISTURBED AREAS, REMOVE EXCESS SOIL FROM EXCAVATEDAREA AS SOON AS POSSIBLE. 3. ALL MATERIAL STOCKPILE TO BE CLEAR FROM DRAINS, GUTTERS AND FOOTPATHS, OR WITHIN SEDIMENT FENCE AREA.

4. DRAINAGE TO BE CONNECTED TO STORMWATER AS SOON AS POSSIBLE. IF STORED ON SITE, IT MUST BE FILTERED BEFORE RELEASING INTO STORMWATER SYSTEM OR WATERWAYS.
5. ROADS AND FOOTPATHS TO BE SWEPT DAILY.

STOCKPILES:
ALL STOCKPILES ARE TO BE KEPT ON-SITE WHERE POSSIBLE. ANY MATERIALS PLACED ON THE FOOTPATHS OR NATURE STRIPS REQUIRE COUNCIL'S PERMISSION.

ALL STOCKPILES ARE TO BE PLACED AWAY FROM THE DRAINAGE LINES AND STREET GUTTERS. IT IS BEST TO LOCATE THESE ON THE HIGHEST PART OF THE SITE IF POSSIBLE. PLACE WATERPROOF COVERING OVER STOCKPILES.

IF REQUIRED PROVIDE DIVERSION DRAIN & BANK AROUND STOCKPILES.

GUTTER PROTECTION:

PROVIDE PROTECTION TO DOWNHILL GRATE IN GUTTER BY MEANS OF SAND BAGS OR BLUE METAL WRAPPED IN GEOTEXTILE FABRIC. WHEN SOIL OR SAND BUILDS UP AROUND THIS SEDIMENT BARRIER, THE MATERIAL SHOULD BE RELOCATED BACK TO THE SITE FOR DISPOSAL.

NOTE: SITE BOUNDARY IS TO BE IDENTIFIED BY A REGISTERED SURVEYOR AND CLEARLY MARKED ON SITE PRIOR TO COMMENCEMENT OF ANY CONSTRUCTION WORKS.

> NOTE: ALL PROPOSED STORMWATER TO CONNECT WITH EXISTING

SITE / ROOF / SEDIMENT EROSION / WASTE MANAGEMENT / STORMWATER CONCEPT PLAN 1:200



REV. DATE COMMENTS DRWN NOTES NOTES

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All errors and omissions are to be verified by the Builder/Contractor/client and referred to the designer prior to the commencement of works.



_EXISTING RL PROPOSED RL



Sue & Jason Boyle

2107

PROJECT ADDRESS

132 Avalon Parade,

Avalon Beach NSW,

DATE Monday, 4 August

DA04

DRAWING NO. **DRAWING NAME**

SITE / ROOF / SEDIMENT EROSION / WASTE MANAGEMENT / STORMWATER CONCEPT PLAN








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w: www.actionplans.com.au



PROJECT ADDRESS

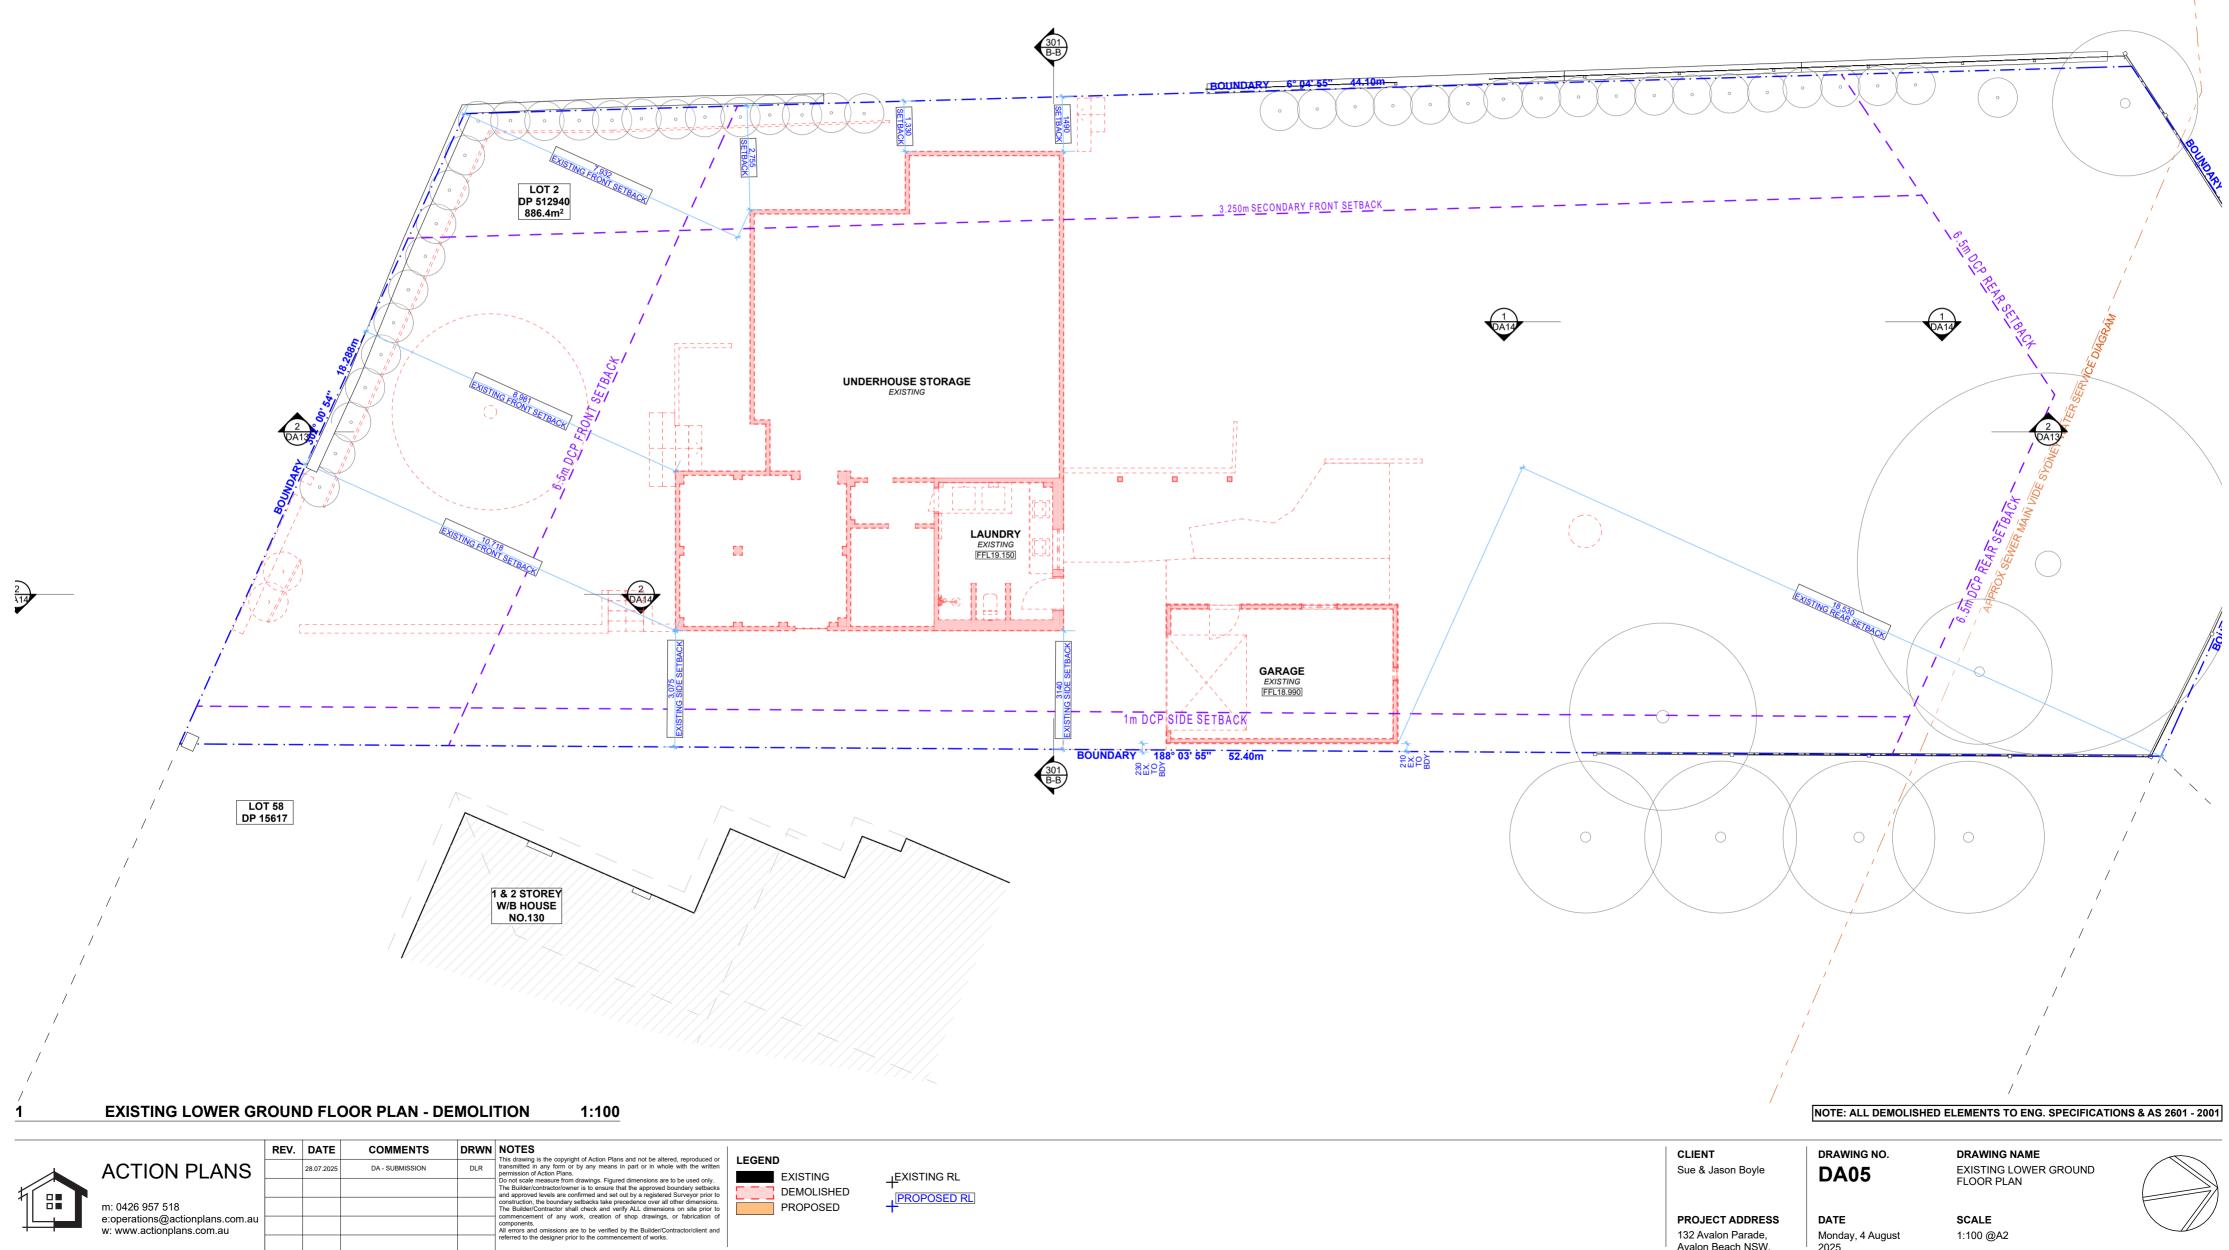132 Avalon Parade, Avalon Beach NSW, 2107

DATE

Monday, 4 August

SCALE

1:100 @A2


EXISTING

DEMOLISHED PROPOSED


+EXISTING RL



KATANDRA CLOSE

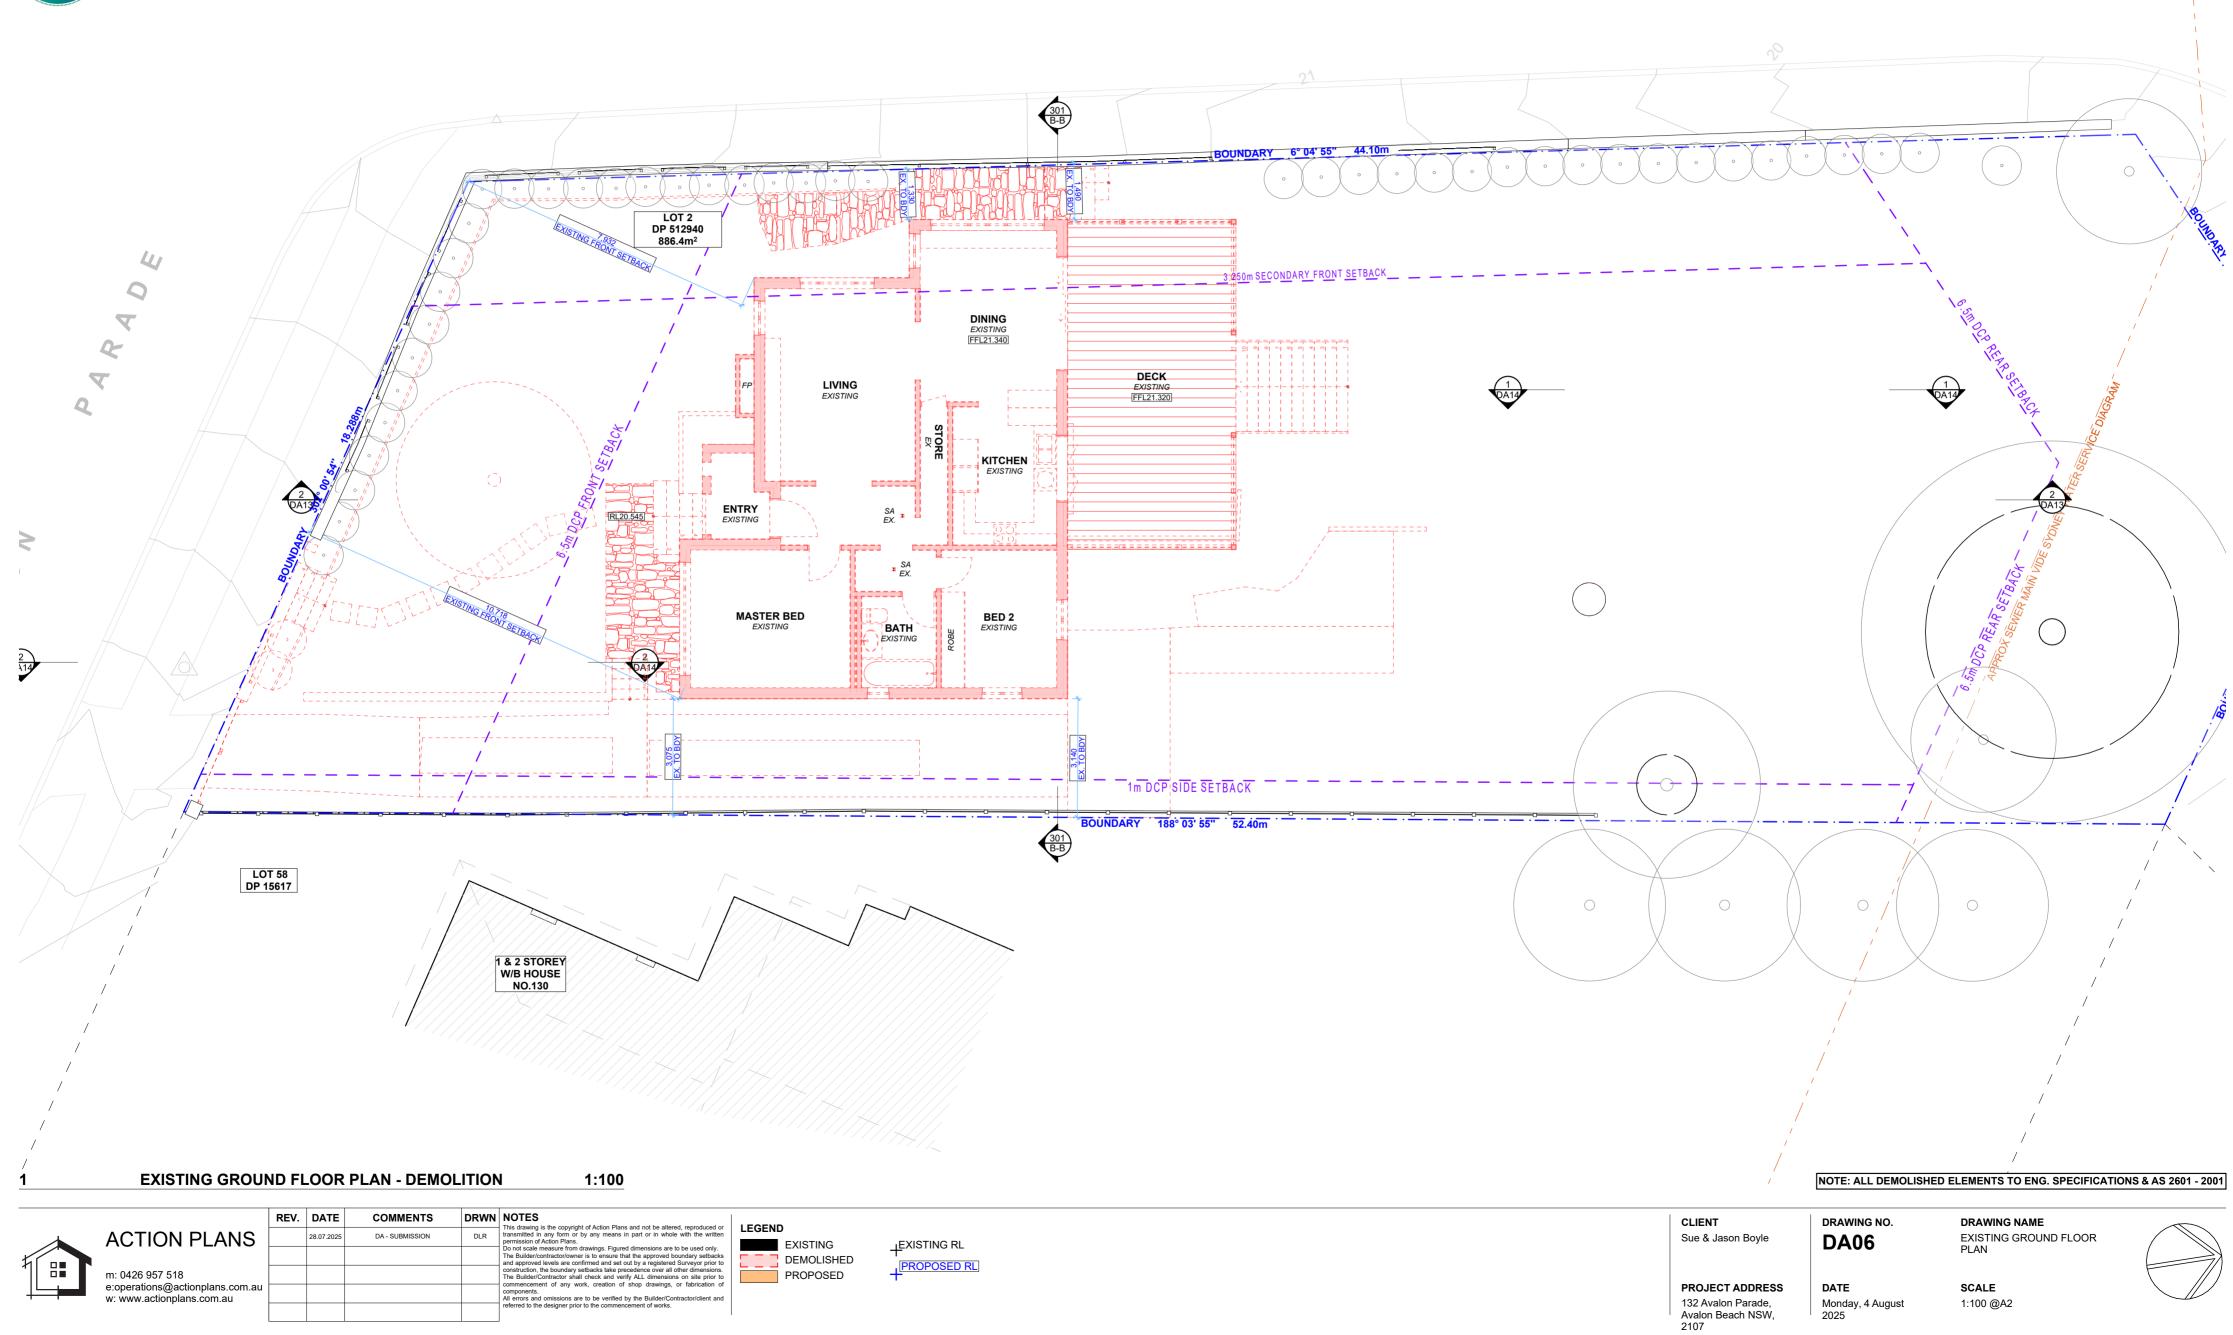



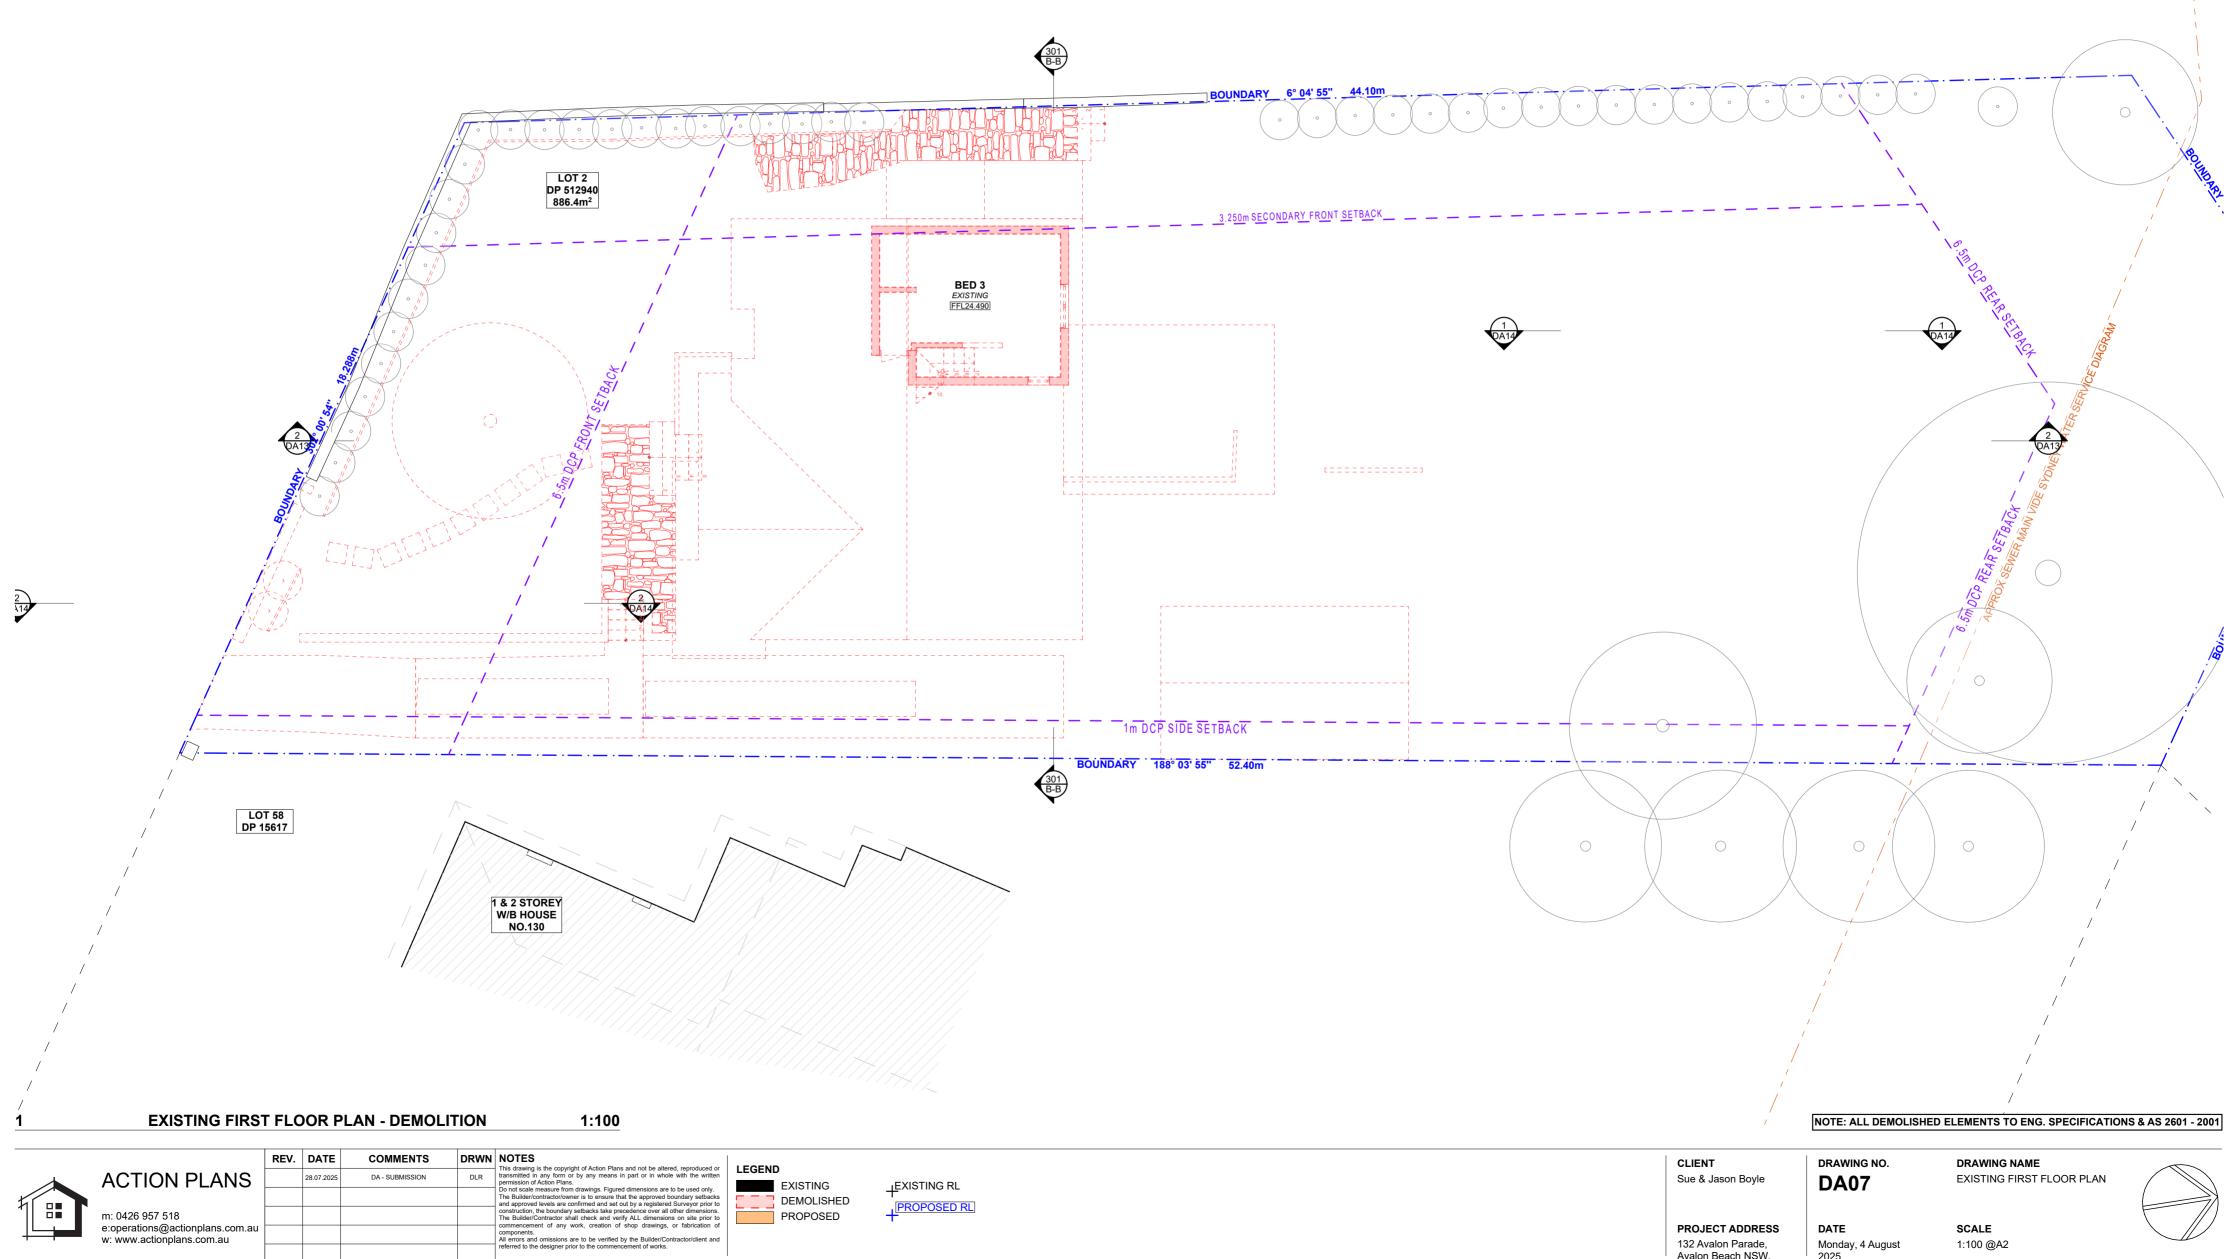


132 Avalon Parade, Avalon Beach NSW, 2107

Monday, 4 August 2025

1:100 @A2



KATANDRA CLOSE

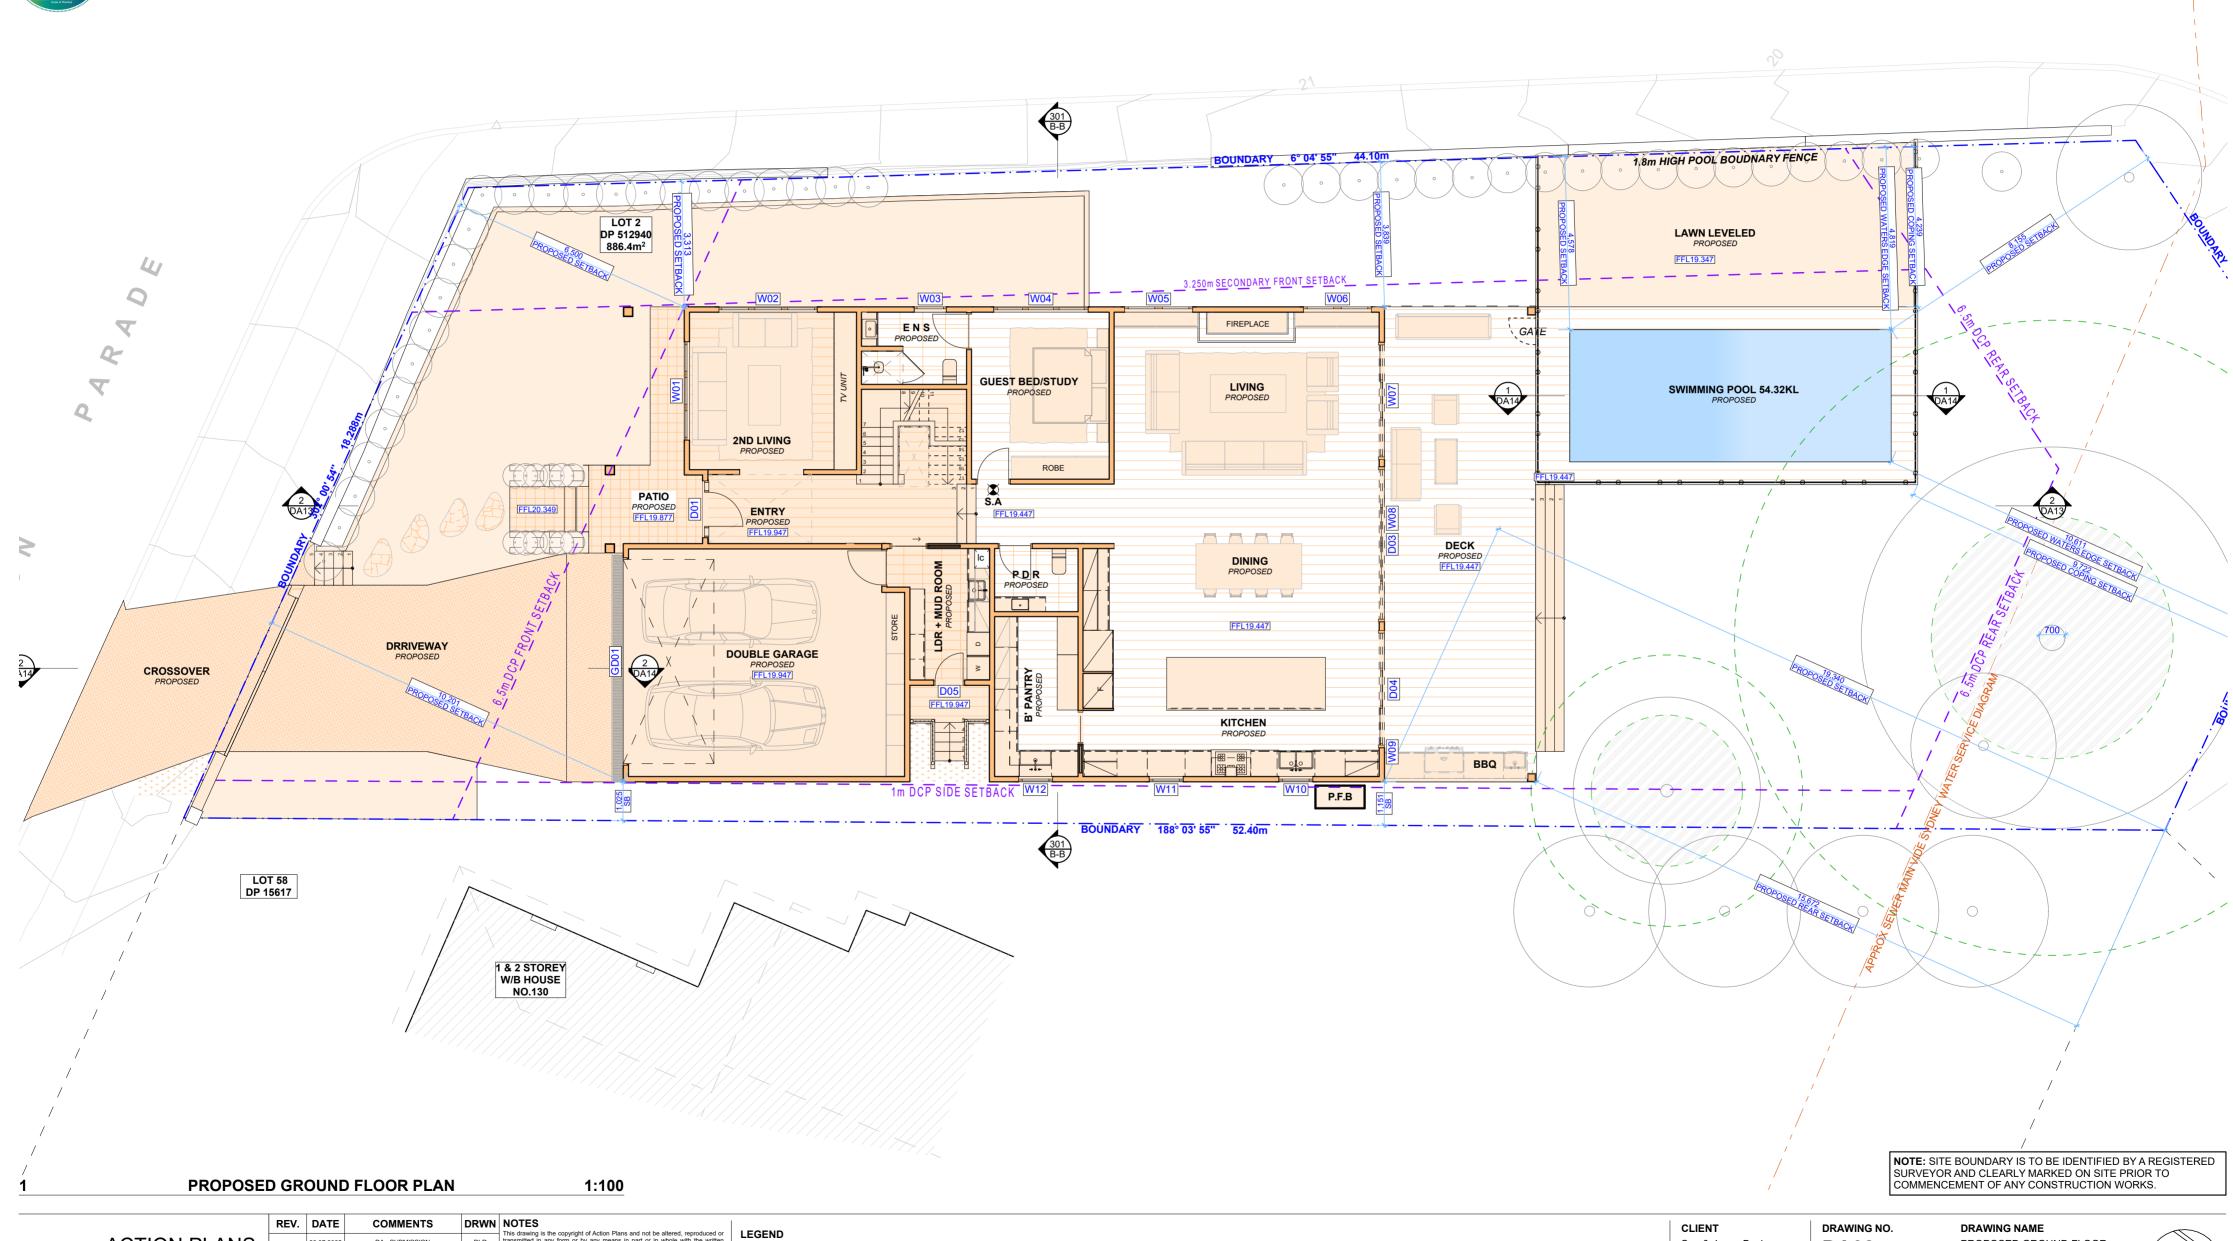




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≠EXISTING RL PROPOSED RL Sue & Jason Boyle

132 Avalon Parade,

Avalon Beach NSW, 2107

DA08

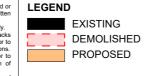PROPOSED GROUND FLOOR

PROJECT ADDRESS DATE Monday, 4 August

SCALE 1:100 @A2






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DATE

Monday, 4 August

SCALE

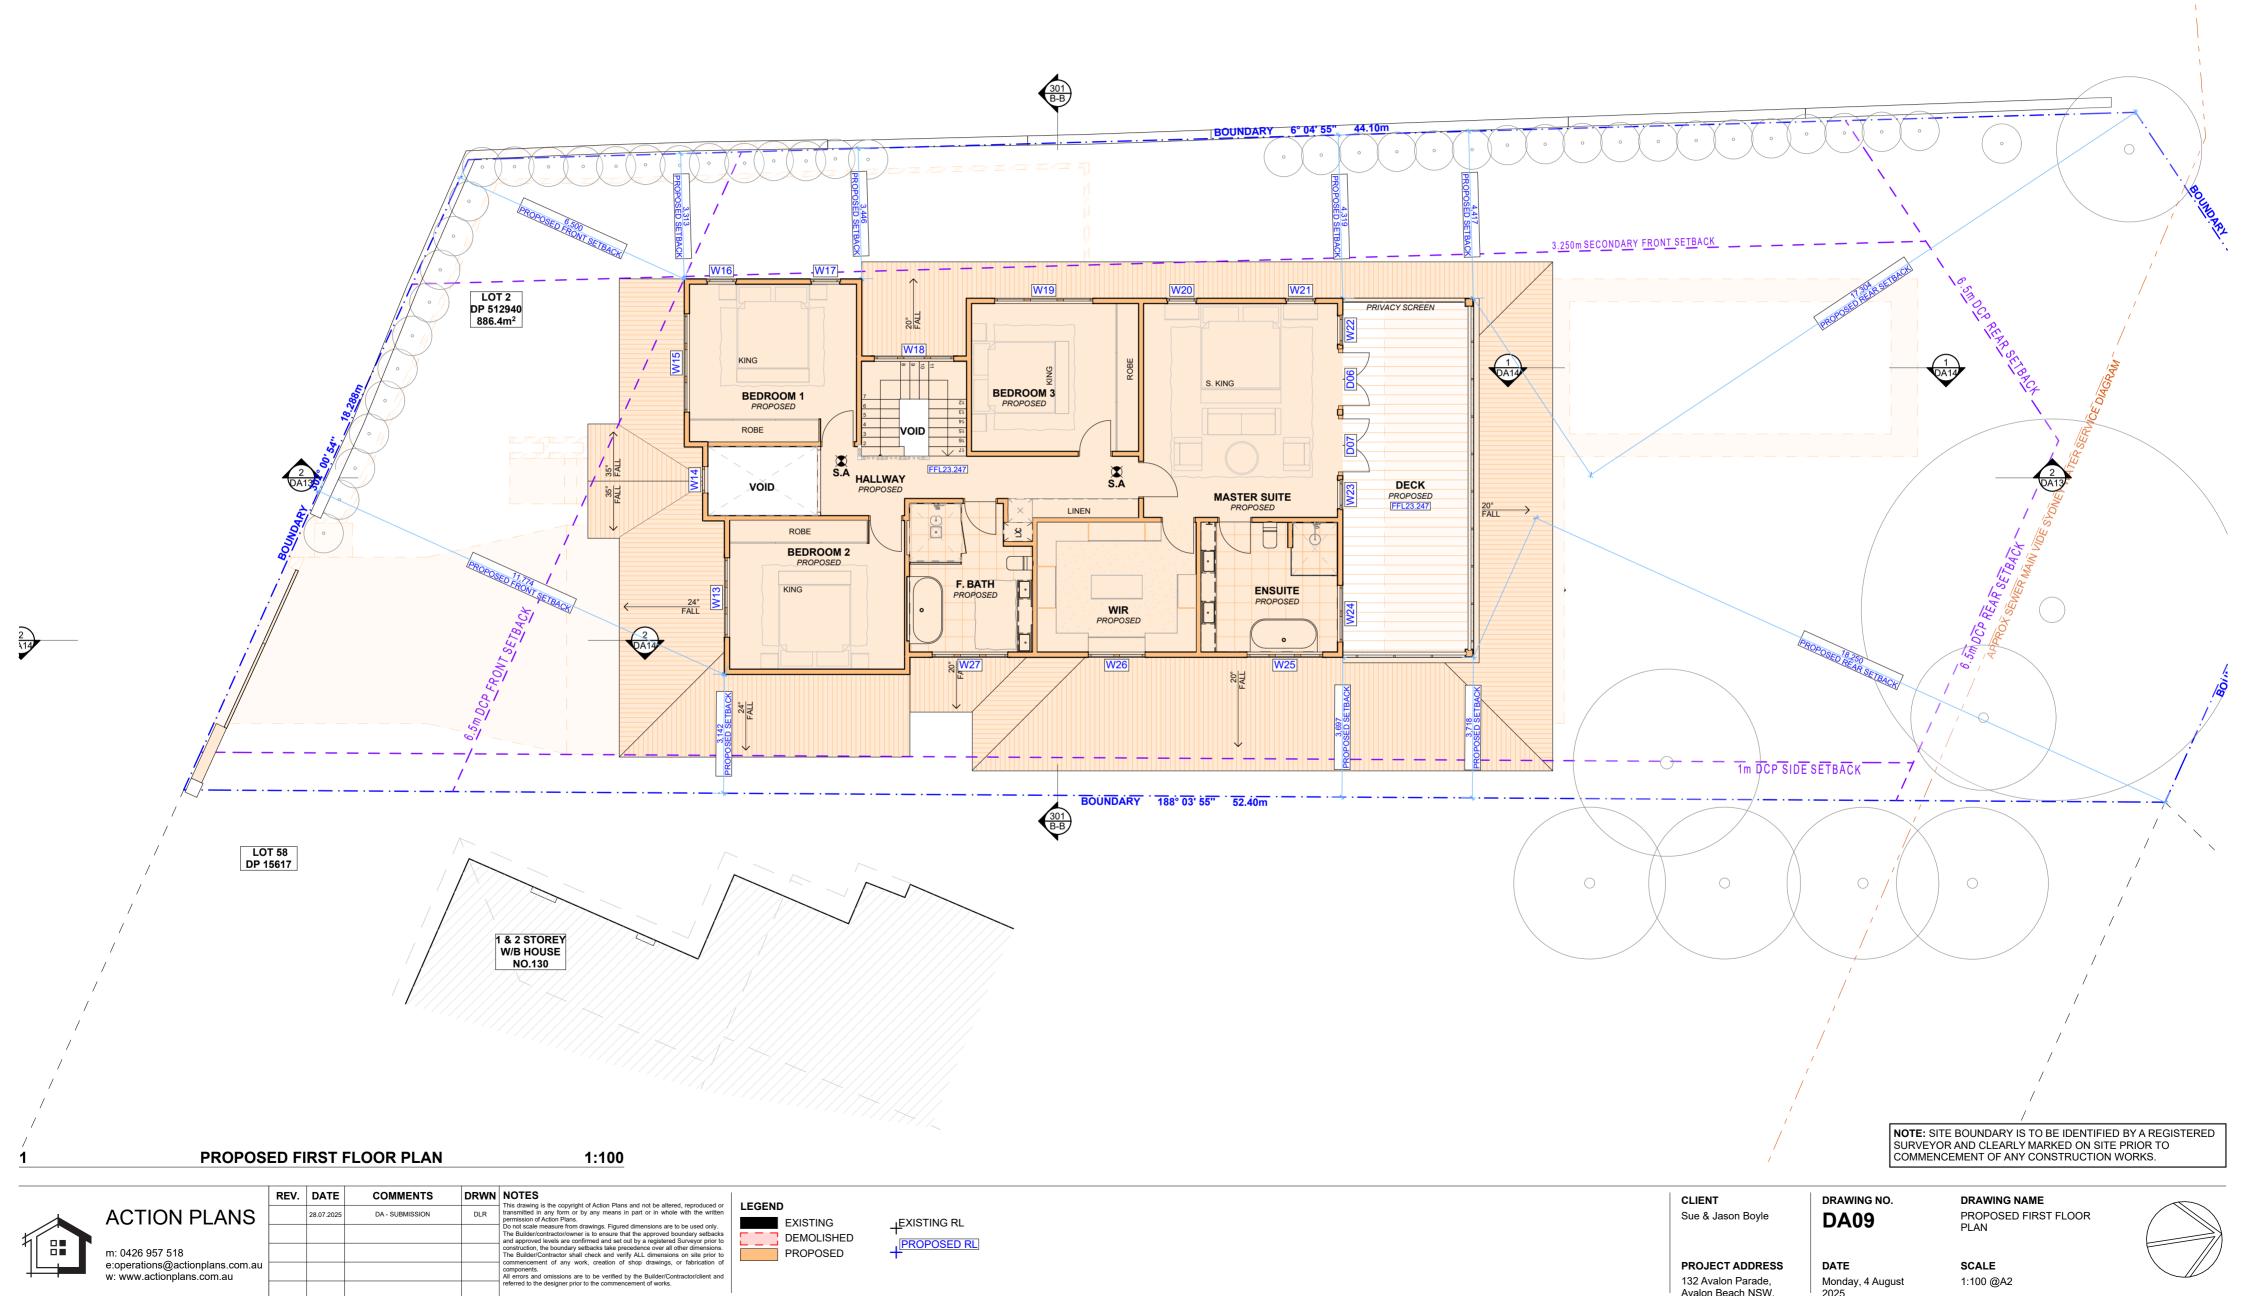
1:100 @A2

DEMOLISHED

PROPOSED

PROPOSED RL



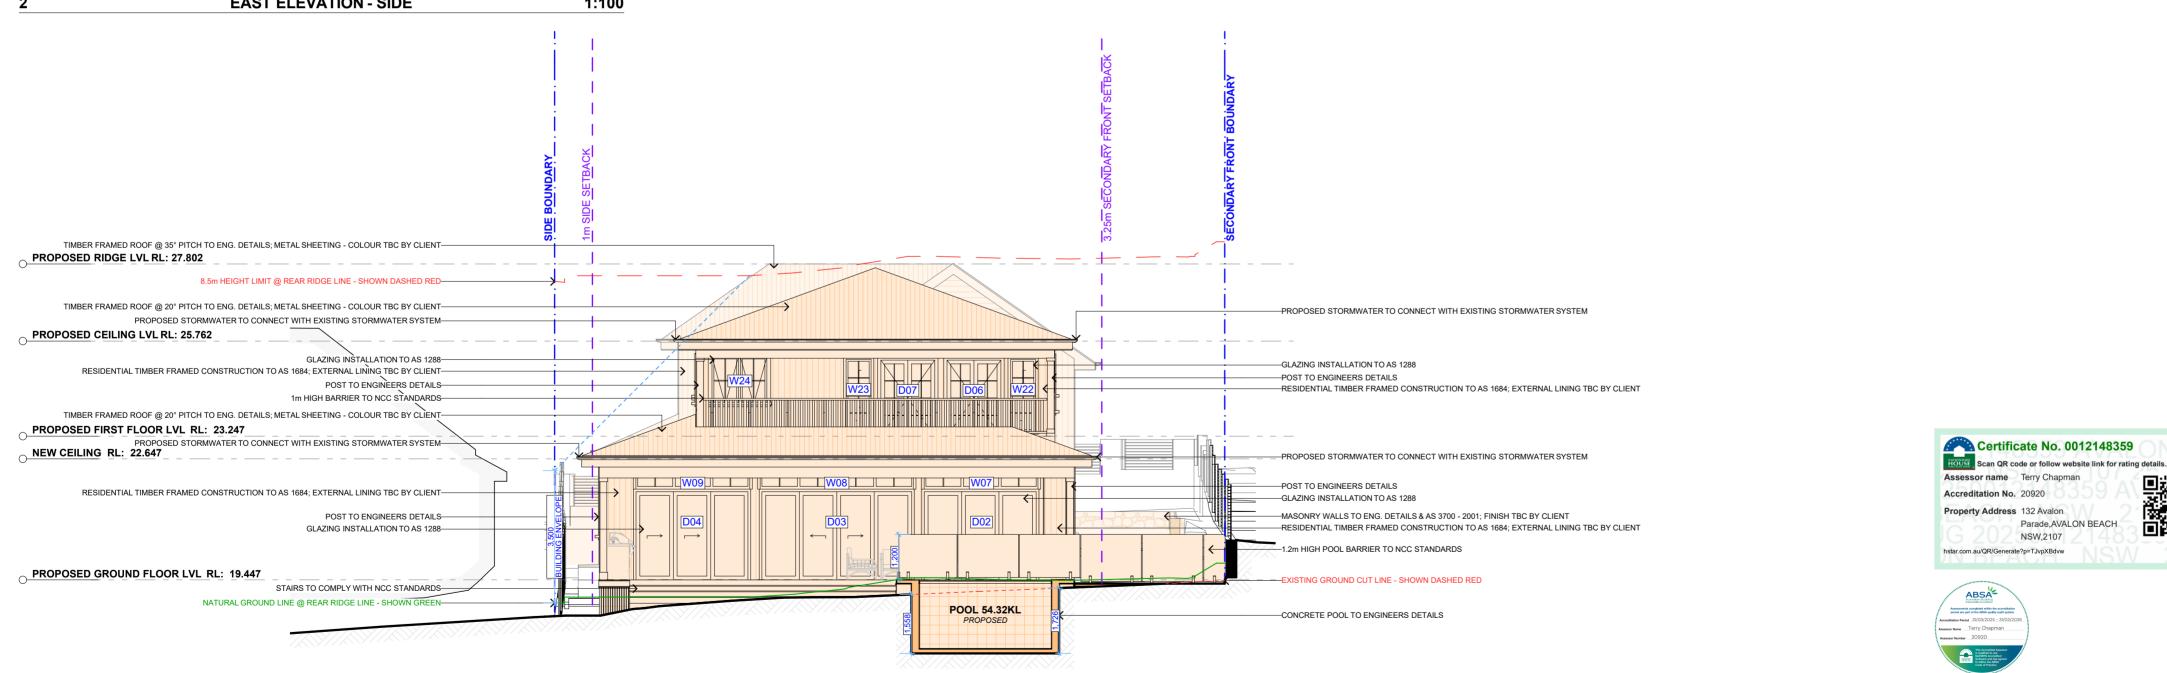

SURVEYOR AND CLEARLY MARKED ON SITE PRIOR TO COMMENCEMENT OF ANY CONSTRUCTION WORKS.

DRAWING NO. DRAWING NAME NORTH / EAST ELEVATION **DA10**



NOTE: SITE BOUNDARY IS TO BE IDENTIFIED BY A REGISTERED

NORTH ELEVATION - REAR 1:100

		REV.	DATE	COMMENTS	DRWN	NOTES
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1						Do not scale measure from drawings. Figured dimensions are to be used only. The Builder/contractor/owner is to ensure that the approved boundary setbacks and applevels are confirmed and set out by a registered Surveyor prior to construction, the bou
	m: 0426 957 518 e:operations@actionplans.com.au w: www.actionplans.com.au					setbacks take precedence over all other dimensions. The Builder/Contractor shall check and verify ALL dimensions on site prior to commencement of
						any work, creation of shop drawings, or fabrication of components. All errors and omissions are to be verified by the Builder/Contractor/client and referred to the
	•					designer prior to the commencement of works.

LEGEND EXISTING PROPOSED -- DEMOLISHED

EXIST. RL ▼ PROP. RL

PROJECT ADDRESS 132 Avalon Parade, Avalon

CLIENT

Sue & Jason Boyle


Beach NSW, 2107

DATE

Monday, 4 August 2025

SCALE 1:100 @A2



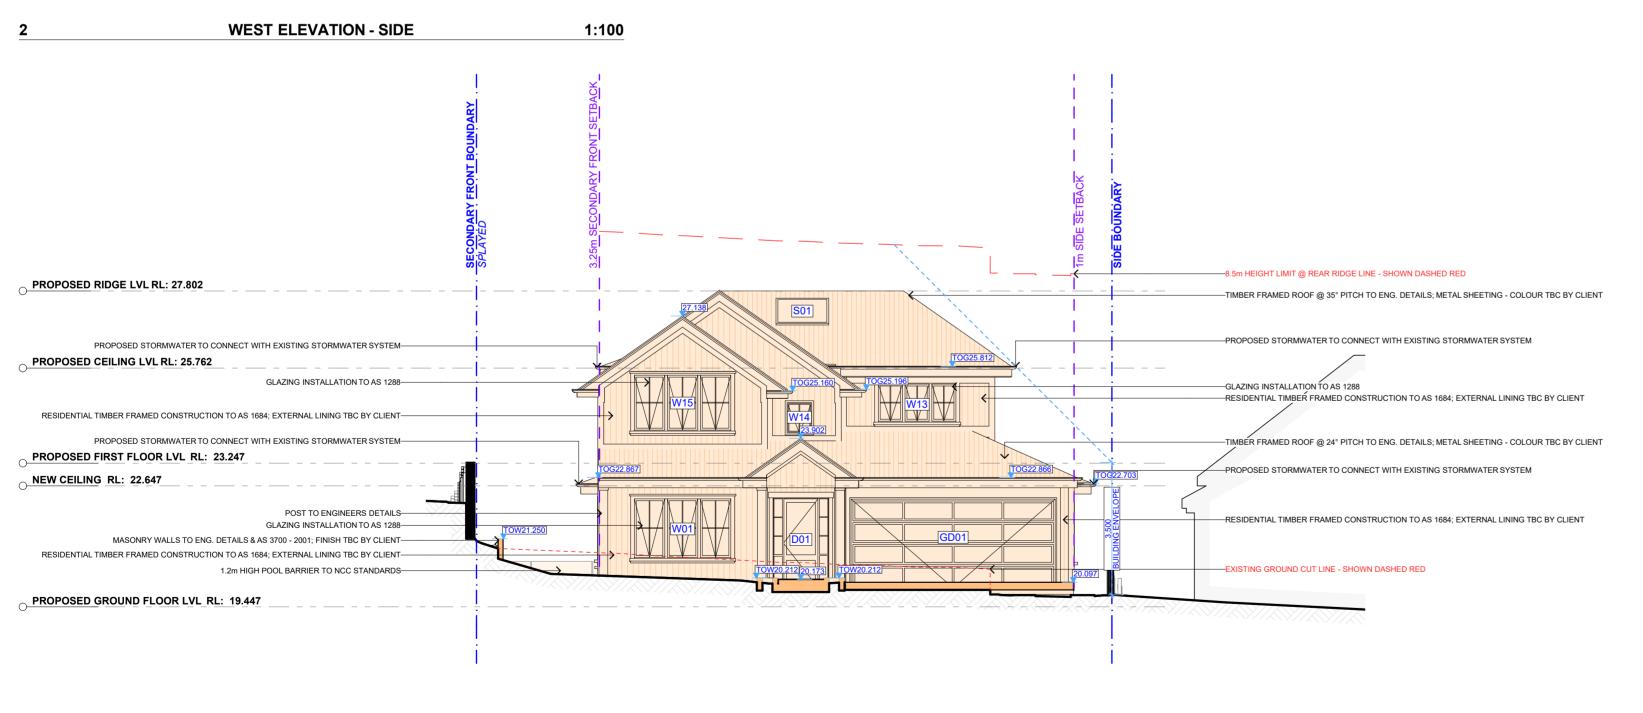

Certificate No. 0012148359

Scan QR code or follow website link for rating details.

Assessor name Terry Chapman

Accreditation No. 20920

Property Address 132 Avalon

Parade, AVALON BEACH

NSW,2107


hstar.com.au/QR/Generate?p=TJvpXBdvw

Accordance Today Control Contr

SOUTH ELEVATION - PRIMARY ROAD

1:100

		REV.	DATE	COMMENTS	DRWN	NOTES
	ACTION PLANS		28.07.2025	DA - SUBMISSION	DLR	This drawing is the copyright of Action Plans and not be altered, reproduced or transmitted in any form or by any means in part or in whole with the written permission of Action Plans.
						Do not scale measure from drawings. Figured dimensions are to be used only. The Builder/contractor/owner is to ensure that the approved boundary setbacks and applevels are confirmed and set out by a registered Surveyor prior to construction, the boundary set and the set of
	m: 0426 957 518 e:operations@actionplans.com.au w: www.actionplans.com.au					setbacks take precedence over all other dimensions. The Builder/Contractor shall check and verify ALL dimensions on site prior to commencement of
						any work, creation of shop drawings, or fabrication of components. All errors and omissions are to be verified by the Builder/Contractor/client and referred to the
	'					designer prior to the commencement of works.

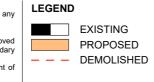

EXIST. RL

PROP. RL

CLIENT
Sue & Jason Boyle

PROJECT ADDRESS

Beach NSW, 2107

132 Avalon Parade, Avalon

DA11

DRAWING NO.

DRAWING NAMESOUTH / WEST ELEVATION


 DATE
 SCALE

 Monday, 4 August 2025
 1:100 @A2







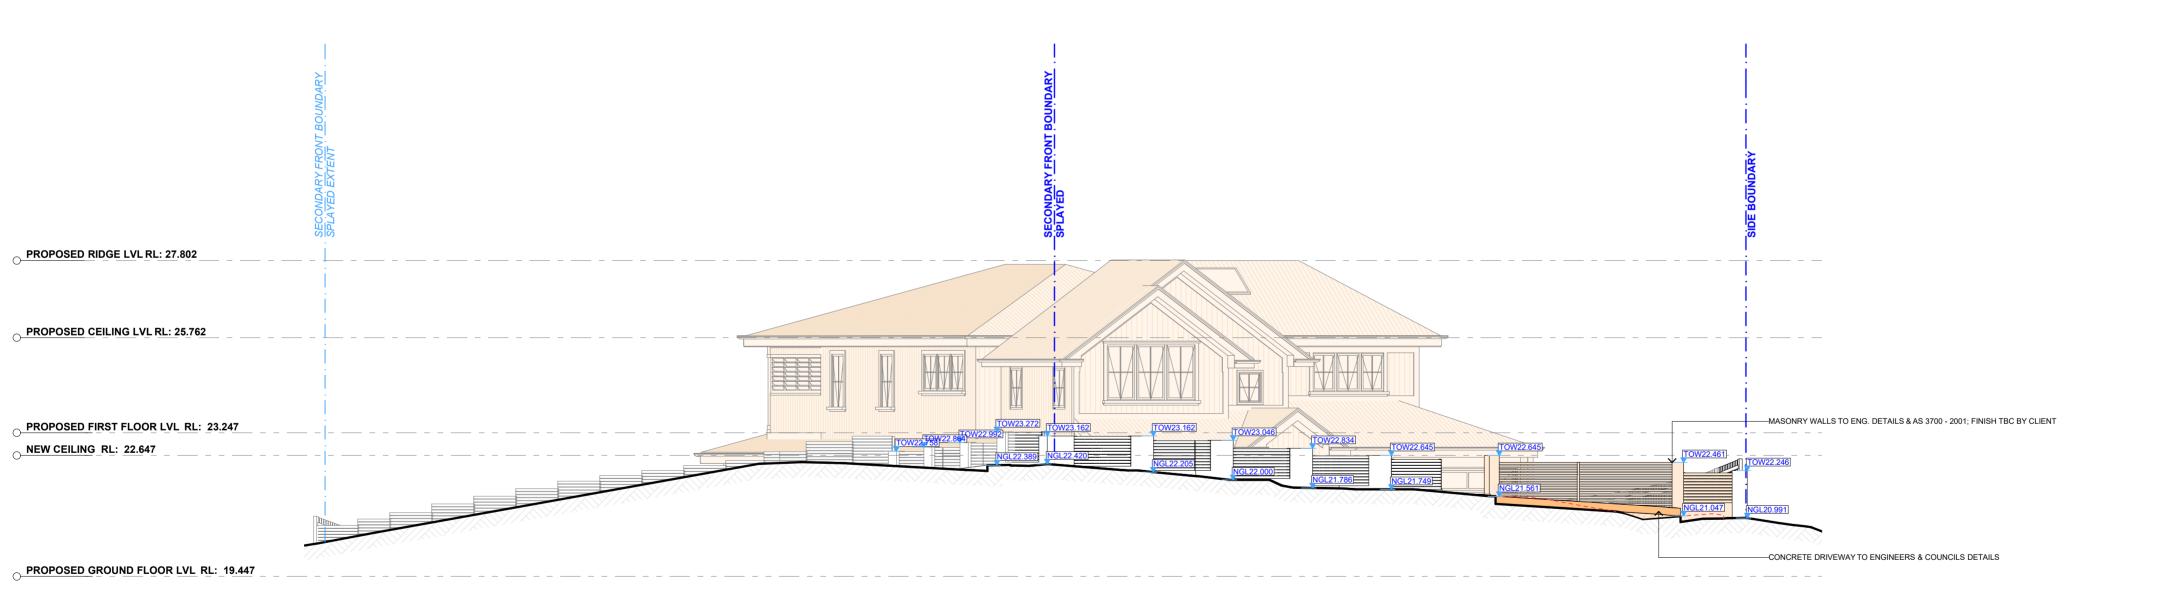

SOUTH ELEVATION - BOUNDARY FENCE (PARRALEL W/FRONT BOUNDARY LINE)

DRWN NOTES

COMMENTS

LEGEND

1:100

EXISTING PROPOSED - - - DEMOLISHED

EXIST. RL ▼ PROP. RL

DRAWING NO. CLIENT Sue & Jason Boyle

PROJECT ADDRESS

Beach NSW, 2107

132 Avalon Parade, Avalon

DA12

DATE

DRAWING NAME SOUTH ELEVATION - BOUNDARY **FENCE**

SCALE Monday, 4 August 2025 1:100 @A2

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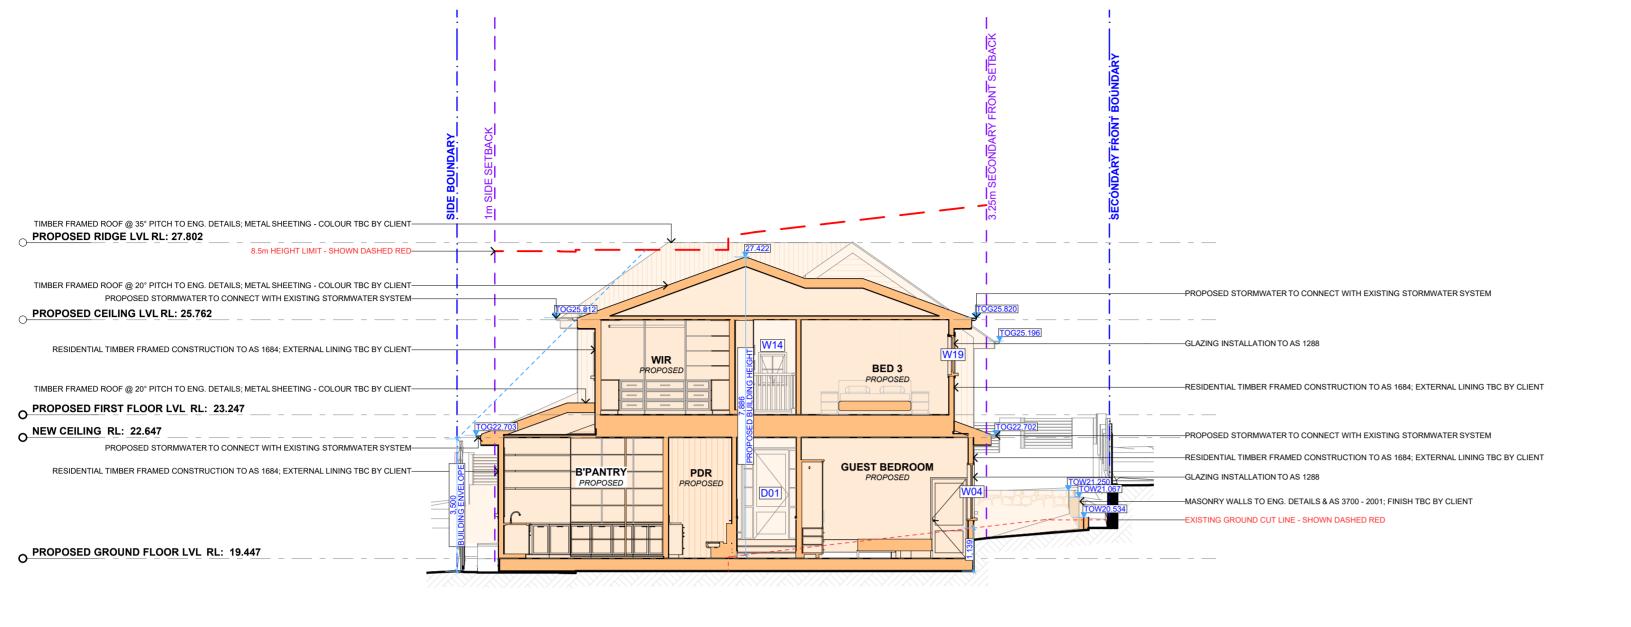
Do not scale measure from drawings. Figured dimensions are to be used only. The Builder/contractor/owner is to ensure that the approved boundary setbacks and approved levels are confirmed and set out by a registered Surveyor prior to construction, the boundary setbacks take precedence over all other dimensions.


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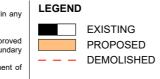






2 LONG SECTION AA 1:100

		REV.	DATE	COMMENTS	DRWN	NOTES
→ ACTION P	ACTION PLANS		28.07.2025	DA - SUBMISSION	DLR	This drawing is the copyright of Action Plans and not be altered, reproduced or transmitted in any form or by any means in part or in whole with the written permission of Action Plans. Do not scale measure from drawings. Figured dimensions are to be used only.
1						The Builder/contractor/owner is to ensure that the approved boundary setbacks and ap levels are confirmed and set out by a registered Surveyor prior to construction, the bo
m: 0426 957 518	m: 0426 957 518 e:operations@actionplans.com.au w: www.actionplans.com.au					setbacks take precedence over all other dimensions. The Builder/Contractor shall check and verify ALL dimensions on site prior to commencement of
						any work, creation of shop drawings, or fabrication of components. All errors and omissions are to be verified by the Builder/Contractor/client and referred to the
·						designer prior to the commencement of works.

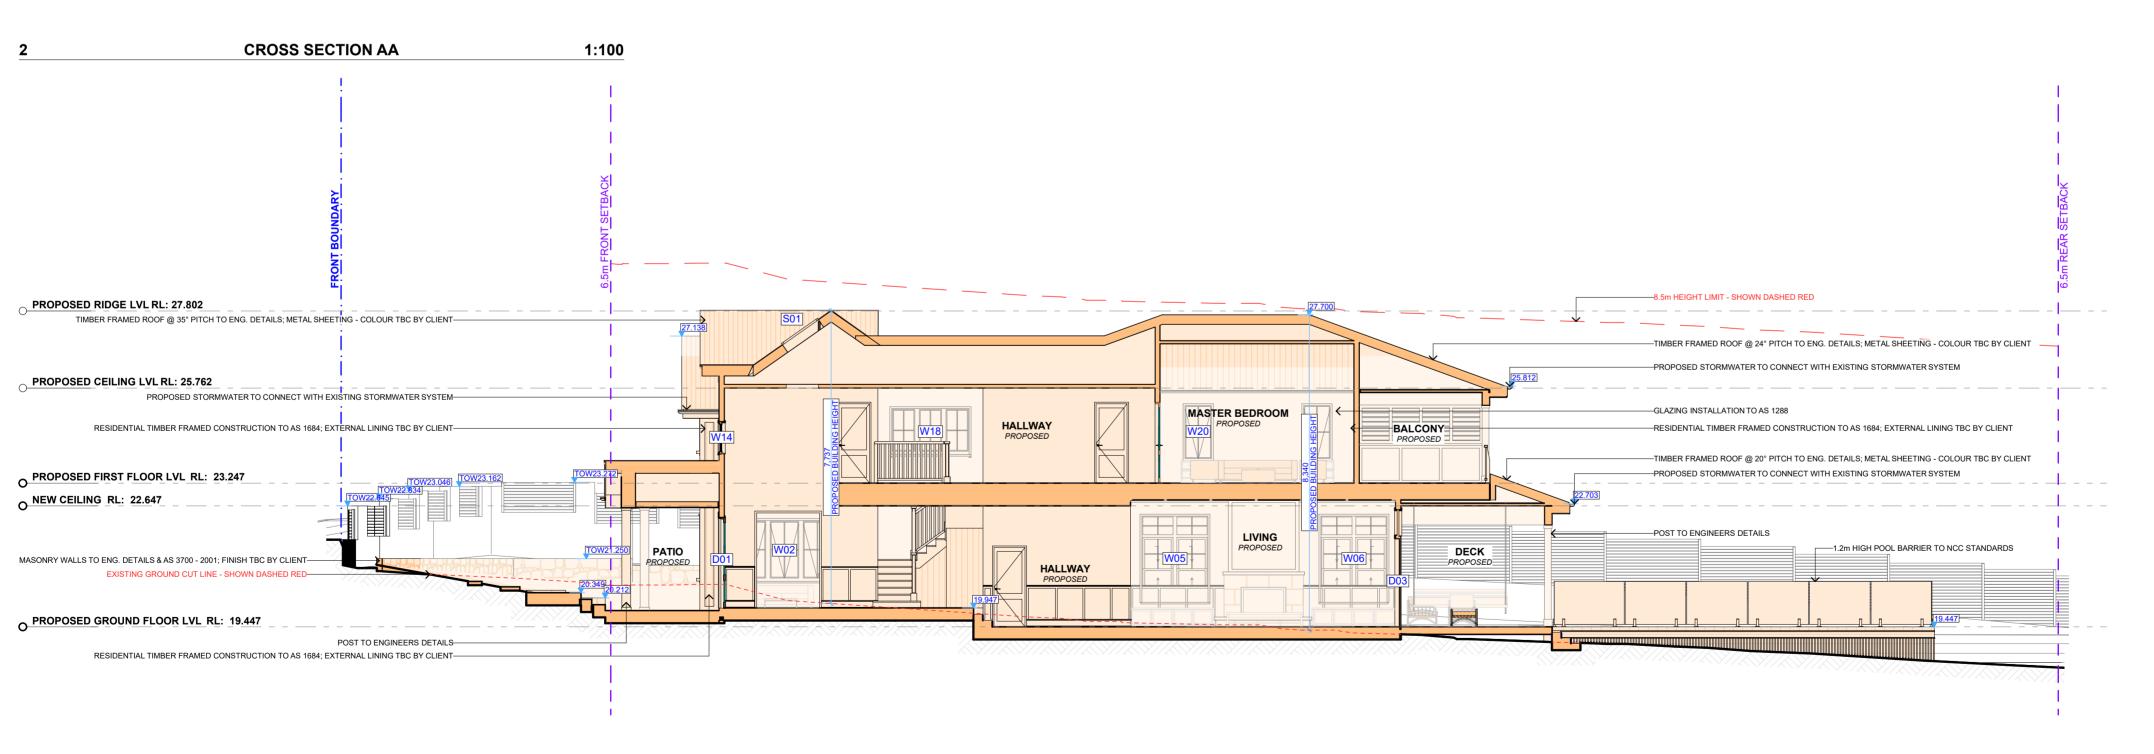

EXIST. RL

PROP. RL

CLIENT
Sue & Jason Boyle

PROJECT ADDRESS

Beach NSW, 2107

132 Avalon Parade, Avalon

DA13

DATE

Monday, 4 August 2025


DRAWING NO.

LONG / CROSS SECTION

DRAWING NAME

SCALE 1:100 @A2



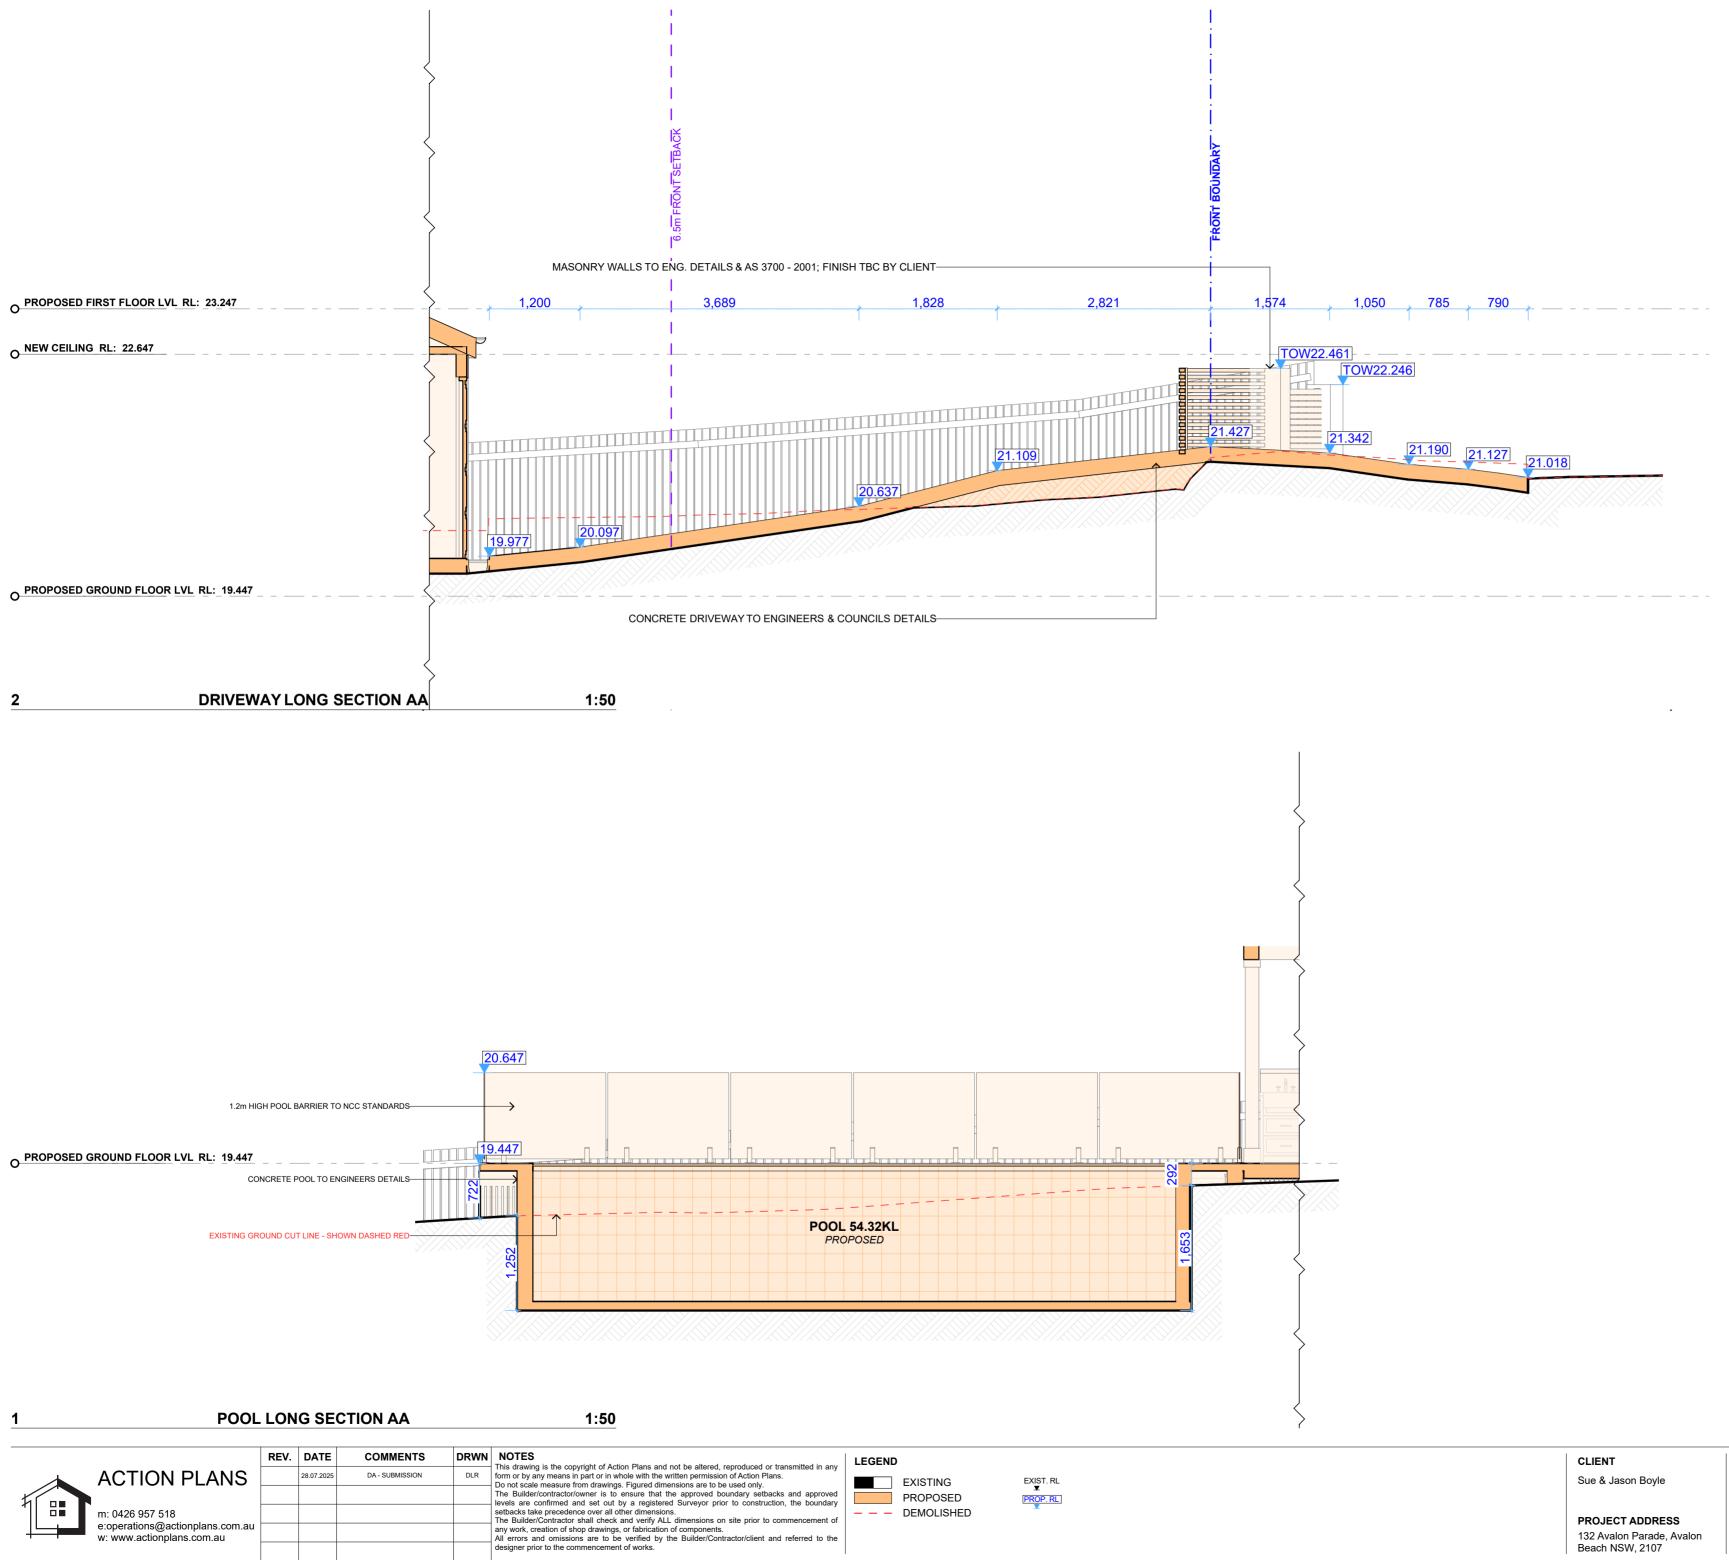

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Certificate No. 0012148359 Parade, AVALON BEACH



DRAWING NO.

132 Avalon Parade, Avalon

Beach NSW, 2107

DA14

Monday, 4 August 2025

DATE


DRIVEWAY + POOL LONG SECTION

DRAWING NAME


SCALE 1:50 @A2





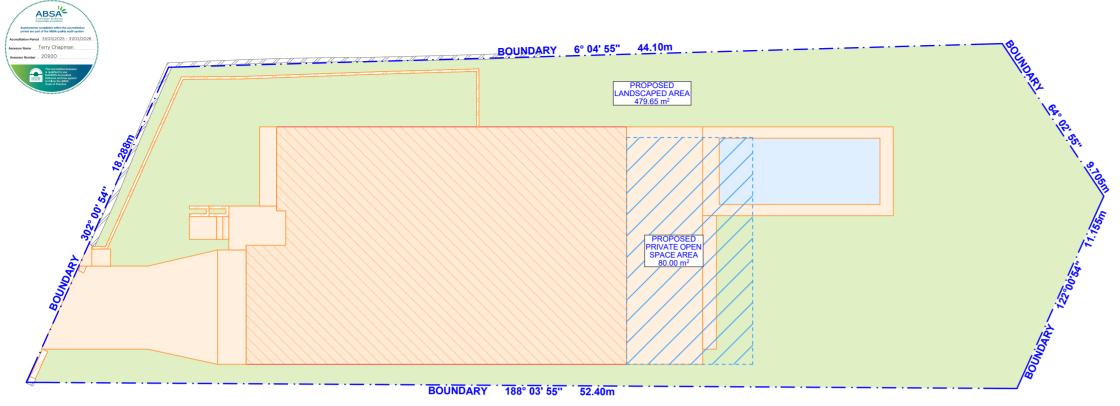

PROPOSED AREA CALCULATIONS PLAN

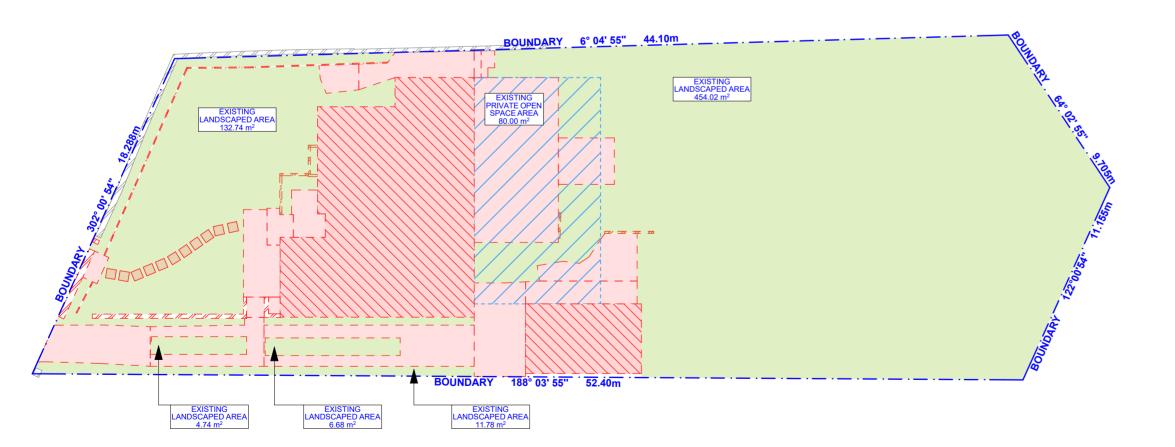

1:200

1:200

EXISTING AREA CALCULATIONS PLAN

		REV.	DATE	COMMENTS	DRWN	NOTES
*	ACTION PLANS		28.07.2025	DA - SUBMISSION	DLR	This drawing is the copyright of Action Plans and not be altered, reproduced or transmitted in any form or by any means in part or in whole with the written permission of Action Plans.
	7.01.01.1.27.1.10					Do not scale measure from drawings. Figured dimensions are to be used only. The Builder/contractor/owner is to ensure that the approved boundary setbacks and approved levels are confirmed and set out by a registered Surveyor prior to
	m: 0426 957 518					construction, the boundary setbacks take precedence over all other dimension. The Builder/Contractor shall check and verify ALL dimensions on site prior commencement of any work, creation of shop drawings, or fabrication.
	e:operations@actionplans.com.au w: www.actionplans.com.au					components. All errors and omissions are to be verified by the Builder/Contractor/client and
	·					referred to the designer prior to the commencement of works.

LEGEND

CONTROL TABLE							
SITE AREA 886.4m ²							
	CONTROL	EXISTING	PROPOSED				
LANDSCAPED AREA	AREA 2 = 60% (531.84m ²)	69% (609.96m²)	54% (479.65m²)				
LANDSCAPED AREA IMPERVIOUS VARIATION	6% (53.184m²)	-	6% (53.184m²)				
LANDSCAPED AREA TOTAL	AREA 2 = 60% (531.84m²)	69% (609.96m²)	60% (532.83m²)				
PRIVATE OPEN SPACE AREA	80m²	80m²	80m²				

LEGEND

LANDSCAPED AREA

EXISTING BUILDING FOOTPRINT

HARD SURFACE - EXISTING

HARD SURFACE - TO BE DEMOLISHED

PROPOSED BUILDING FOOTPRINT

HARD SURFACE - PROPOSED

PRIVATE OPEN SPACE AREA

CLIENTSue & Jason Boyle

DA15


DRAWING NAME
AREA CALCULATIONS

PROJECT ADDRESS 132 Avalon Parade, Avalon Beach NSW, 2107 DATE SCALE
Monday, 4 August 1:200 @A2
2025







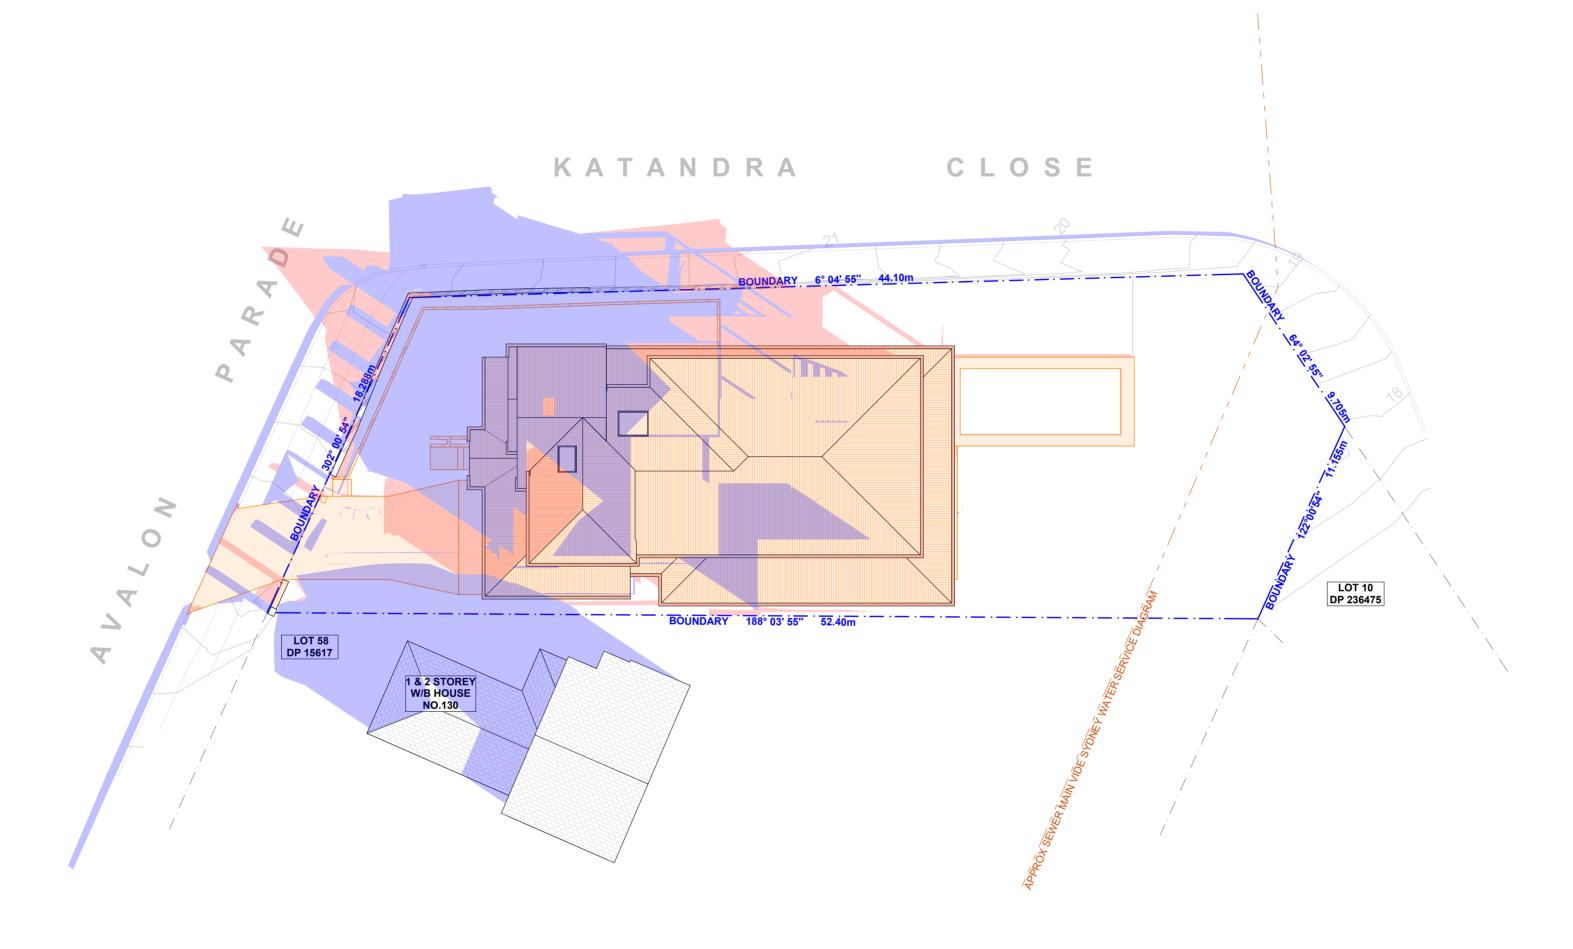

1 WINTER SOLSTICE 9AM 1:200



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au					components. All errors and omissions are to be verified by the Builder/Contractor/client and				
					referred to the designer prior to the commencement of works.				



CLIENT
Sue & Jason Boyle

DA16

DRAWING NAMEWINTER SOLSTICE 9 AM

PROJECT ADDRESS

132 Avalon Parade,
Avalon Beach NSW,
2107

DATE

Monday
2025


DATEMonday, 4 August
2025

SCALE 1:200 @A2







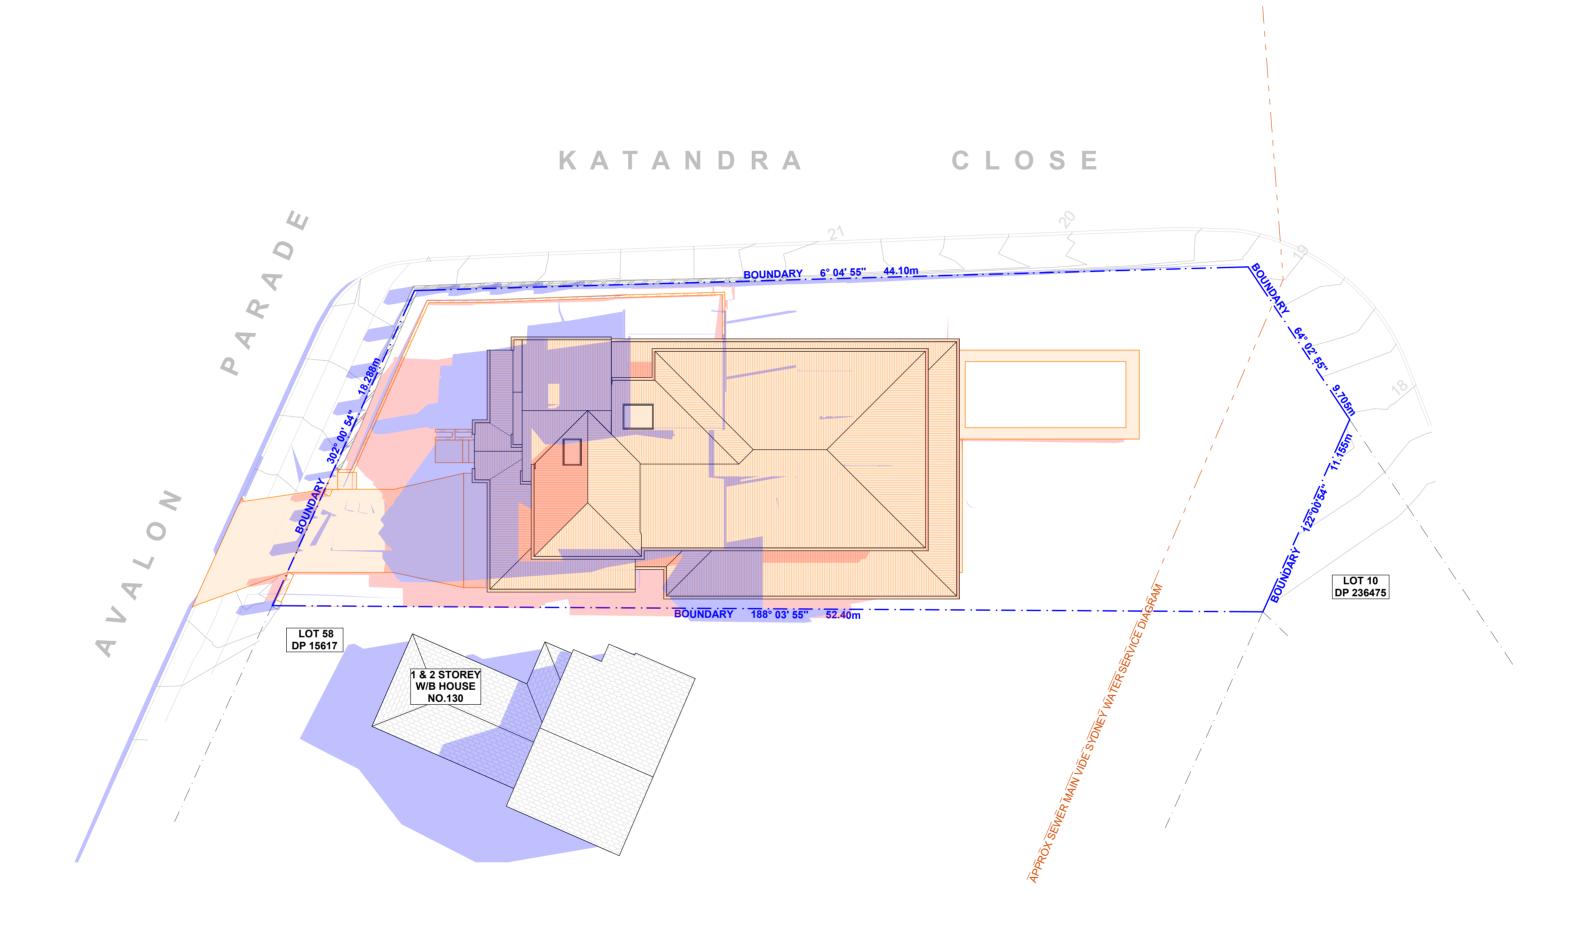

1 WINTER SOLSTICE 12PM 1:200



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		28.07.2025	DA - SUBMISSION	DLR	 This drawing is the copyright of Action Plans and not be altered, reproduced or transmitted in any form or by any means in part or in whole with the written permission of Action Plans.
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ı					components. All errors and omissions are to be verified by the Builder/Contractor/client and
					referred to the designer prior to the commencement of works.



CLIENT
Sue & Jason Boyle

DA17

DRAWING NAME
WINTER SOLSTICE 12 PM

PROJECT ADDRESS

132 Avalon Parade,
Avalon Beach NSW,
2107

DATE


Monday, 4 August
2025

SCALE 1:200 @A2







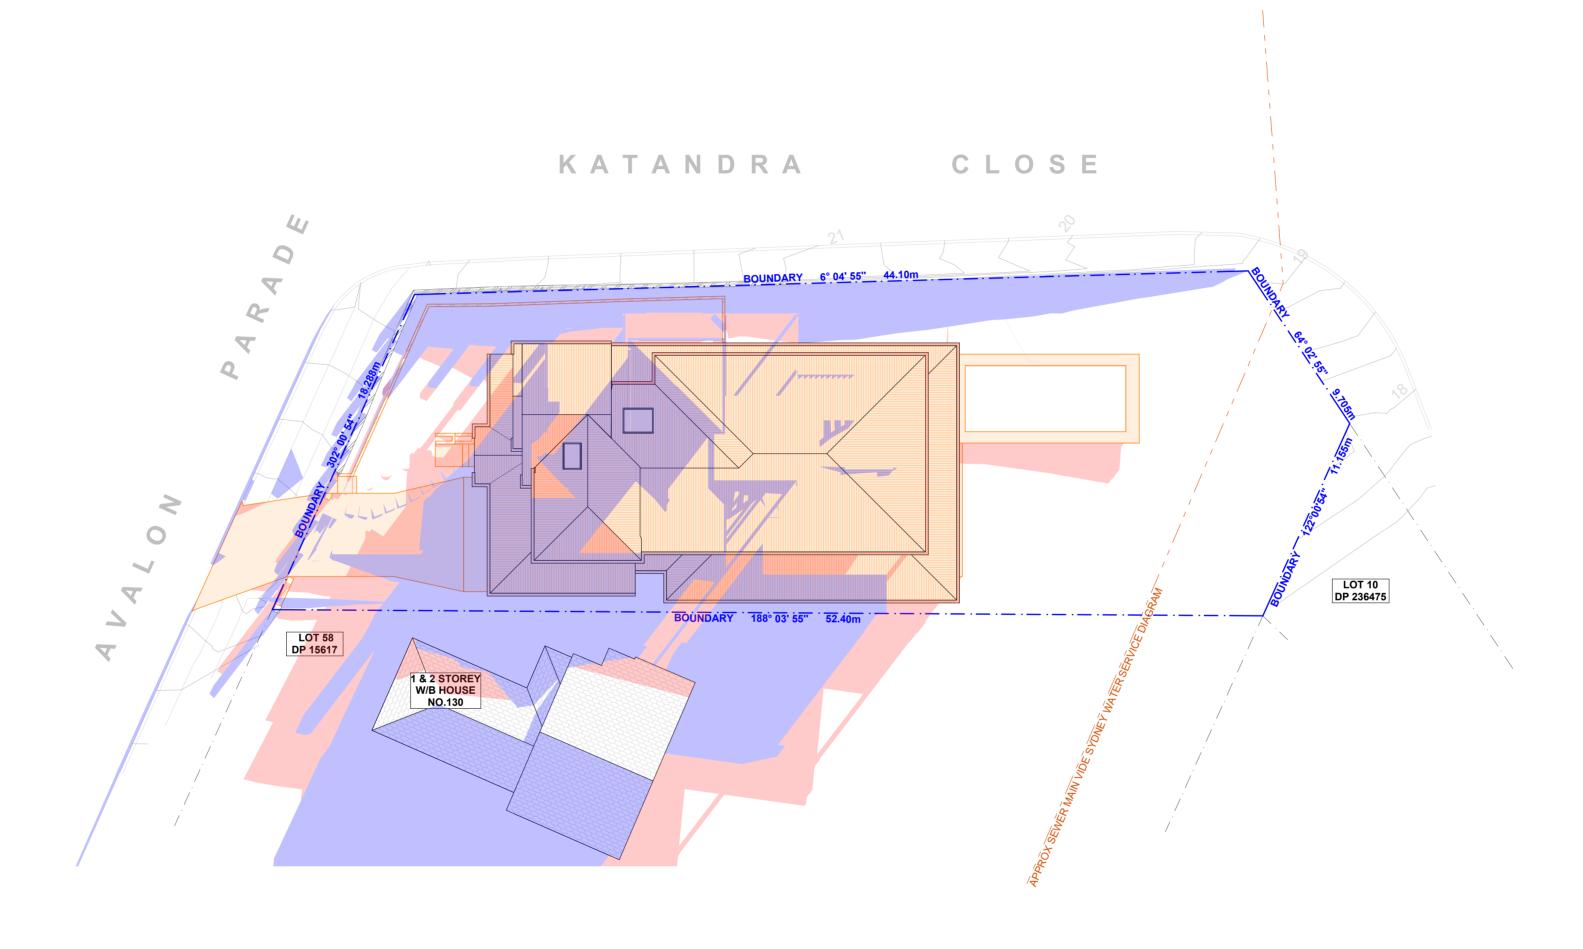

1 WINTER SOLSTICE 3PM 1:200



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				components. All errors and omissions are to be verified by the Builder/Contractor/client and
				referred to the designer prior to the commencement of works.



CLIENT
Sue & Jason Boyle

DA18

DRAWING NAMEWINTER SOLSTICE 3 PM

PROJECT ADDRESS
132 Avalon Parade,
Avalon Beach NSW,
2107

DATE Monday, 4 August 2025


DRAWING NO.

SCALE 1:200 @A2







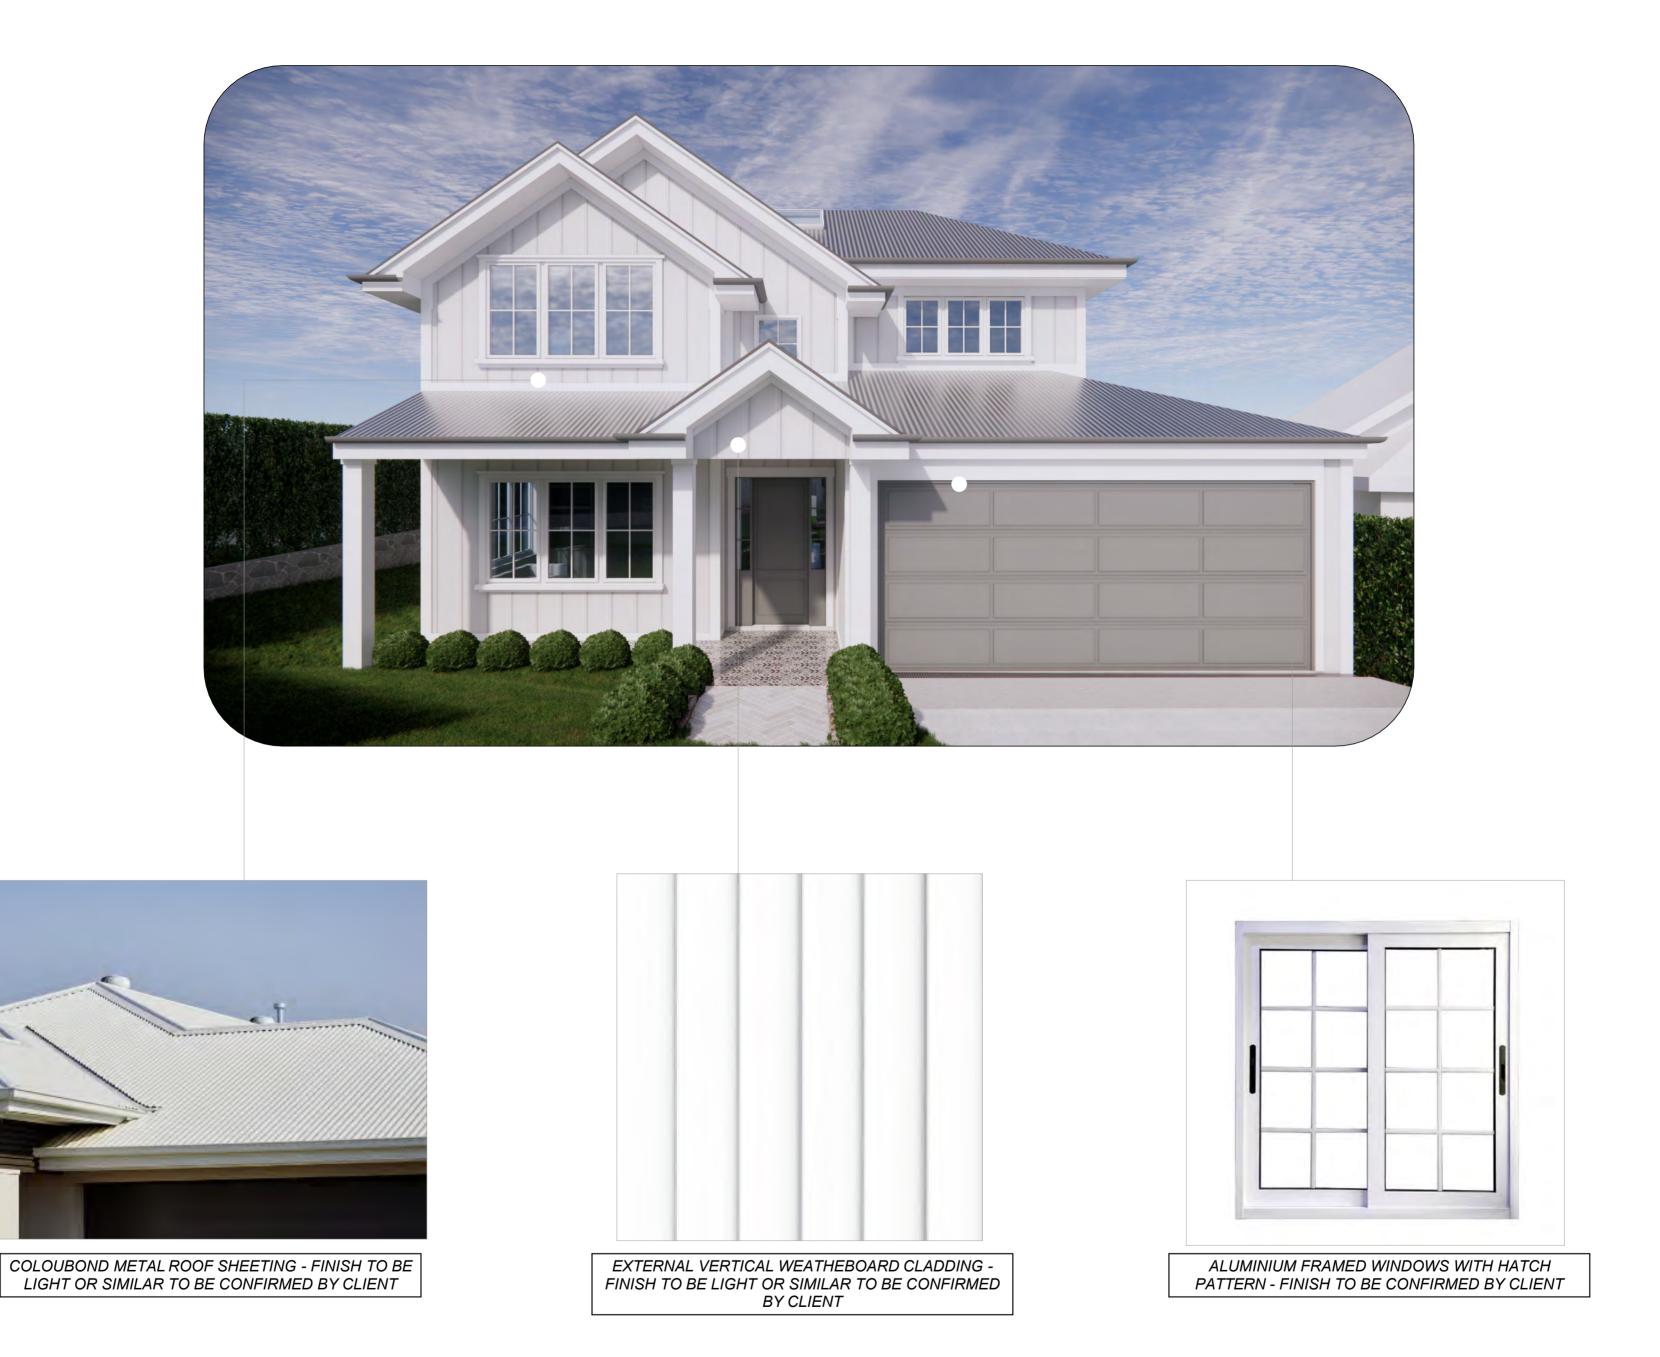



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28.07.2025	5 DA - SUBMISSION DLR		This drawing is the copyright of Action Plans and not be altered, reproduced or transmitted in any form or by any means in part or in whole with the written permission of Action Plans.		
					Do not scale measure from drawings. Figured dimensions are to be used only. The Builder/contractor/owner is to ensure that the approved boundary setbacks and approved levels are confirmed and set out by a registered Surveyor prior to
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u					components. All errors and omissions are to be verified by the Builder/Contractor/client and
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LEGEND

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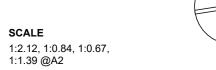
DATE

DA19

DRAWING NO.

DRAWING NAME SAMPLE BOARD

Monday, 4 August 2025





Paciv Poquiroments Summary, Single Dwelling									
New Dwelling				Basix Requirements Summary - Single Dwelling Prepared by Chapman Environmental Services					
132 Avalon Parade			www.cesenergy.com.au					PMAN	
Avalon Beach	NSW	2107	1300 004 914				ENVIRONMEN	NTAL SERVICES	
Water Target		40	Water Score		40				
Energy Target		72	Energy Score		73				
NA 11 0 0 1 1 /N	4.1 / 2)					C. D. II		_	
Max H & C Loads are (N	IJ/m²)	30	Actual H & C Loads are ((IVIJ/m²)	30	Star Rating		7	
				asix Commit					
Landscaping	Total area o	f garden & I	awn (m²) 350		Area of indi	genous/low water use pla	ants (m²)	0	
Fixtures	tures Shower heads 4 star (> 6 but <= 7.5 L/min) Toilets 4 star All taps 4 star								
	Minimum R	ainwater tar	nk size (L) 3000		Collect run off from roof area of at least (m²) 3169				
Alternative Water			Laundry connection					Spa top up	
rate: native trate:	Toilet connection Yes		Yes		es	Pool top up Yes		n/a	
	I Marria a al res	-l (I.I.)	542 Dool door					,	
Pool	Max pool vo		54.3 Pool does Electric heat pump	not require	a cover I	Pool pump must have	a timer		
	Troor neating	5	•						
	Hot water s		Gas instantaneous				Rating 5 star		
	Bathroom v		Individual fan, ducted to Individual fan, ducted to			with Manual switch on/off			
	Laundry ven		Individual fan, ducted to			with Manual switch on/off with Manual switch on/off			
F	Cooling - liv		1-phase airconditioning		 	Rating EER 3.0 - 3.5			
Energy	Cooling - be		1-phase airconditioning			Rating EER 3.0 - 3.5		Zoned	
	Heating - liv		1-phase airconditioning			Rating EER 3.0 - 3		zoned	
	Heating - be		1-phase airconditioning			Rating EER 3.0 - 3			
	Alternate Energy Photovoltaic system abl Gas cooktop & electric oven O				door clothesline required door clothesline required peak kilowatts of electricity No indoor clothesline required				
	Todas cooktor	o & ciccinc c	, ven	dtdoor cloth	conne requi	cu j	VO III GOOT CIC	Arresinie required	
			rmal Performance Asses	sment Based					
Floor Types	Concrete sla	ab on ground	<u> </u>	with	R2.3 under	slab insulation			
Floor Consulator	Tiles	Wet Areas			Timber	Living Areas & Bedroon	ns		
Floor Coverings	Carpet	n/a			Concrete	Garage			
	Timber framed Fibro clad on battens with Sarking and R2.5 bulk insulation Colour Light							Light	
External Walls			d direct fix - Garage		with Sarking only Colour Light				
lotomal Malla									
Internal Walls	Walls Plasterboard with R2.5 bulk insulation - Garage, Upper Bath & Laundry internal walls only						dry internal walls only		
Ceiling (floor over)	Timber abov	ve plasterbo	ard	with	R2.5 bulk in	sulation - Garage interna	l ceilings only	У	
Ceilings (roof over)	Timber abov	ve plasterbo	ard	with	R6 0 hulk in	sulation - Exclude garage	only		
		ve plasterbo	ui u.	VVICII			Office		
Roof	Metal			with	R1.3 roof bl	anket	Colour	Light	
	TF single glazed clear			Awning Wind	ows	HTAWD-035-045-001 U-Value 3.50 or less SHGC 0.47 +/- 5%			
	Awning Windo	ows - To W3. W	13, W24, W25, W26 & W27	D-Hung Windows		HTAWD-035-056-001 U-Value 3.30 or less SHGC 0.54 +/- 5%		ess SHGC 0.54 +/- 5%	
	, willing will do	,,,,,,,,,,,,,,,,,,,,,,,,,,,,,,,,,,,,,,,	13, 112 1, 1123, 1123 & 1127						
	Double Hung -	To W4 only							
	TF double g	lazed clear		Fixed Windows		A&L-049-001-001 U-Value 2.60 or less SHGC 0.65 +/- 5%		ess SHGC 0.65 +/- 5%	
Windows and Doors				Awning Windows		HTAWD-025-045-001 U-Value 2.50 or less SHGC 0.47 +/- 5%			
	To all glazed windows and doors unless noted otherwise			D-Hung Windows		HTAWD-025-045-001 U-Value 2.40 or less SHGC 0.47 +/- 5%			
				Sliding Door		HTAWD-025-045-001 U-Value 2.50 or less SHGC 0.46 +/- 5% WDR-006-001-001 U-Value 2.30 or less SHGC 0.44 +/- 5%			
				Hinged Door	linged Door WDR-006-001-001		U-Value 2.30 01 less SHGC 0.44 +/- 5%		
	AF = Aluminium Framed TB = Thermally Broken Aluminium Framed TF = Timber Framed								
	-	•	dicates downlights, then these			/ fluorescent			
	Any exhaust fans noted are to be fitted with self-closing dampers or be otherwise sealed All insulation specified must be installed in accordance with Part 3.12.1.1 of the BCA If there is a discrepancy between this document and the Nathers Certificate, then the Nathers Certificate shall take precedence								
	if there is a discrepancy section and document and the Nathers certificate, then the Nathers certificate shall take precedence								
Notes	Ceiling Fans (1	400mm) requi	ed to the Living Dining Area, 2	2nd Living & Bed	drooms				

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	ACTION PLANS	
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	REV.	DATE	COMMENTS	DRWN	
		28.07.2025	DA - SUBMISSION	DLR	This drawing is the copyright of Action Plans and not be altered, reproduced or transmitted in any form or by any means in part or in whole with the written permission of Action Plans.
					Do not scale measure from drawings. Figured dimensions are to be used only. The Builder/contractor/owner is to ensure that the approved boundary setbacks and approved levels are confirmed and set out by a registered Surveyor prior to
u					construction, the boundary setbacks take precedence over all other dimensions. The Builder/Contractor shall check and verify ALL dimensions on site prior to commencement of any work, creation of shop drawings, or fabrication of
					components. All errors and omissions are to be verified by the Builder/Contractor/client a
					referred to the designer prior to the commencement of works.

LEGEND

CLIENT Sue & Jason Boyle

DRAWING NO. **DA20**

DATE

DRAWING NAME BASIX COMMITMENTS



Monday, 4 August 2025 @A2

SCALE

