Bernie Cohen & Associates Pty Ltd Trading as

ESSENTIAL CERTIFIERS

ACN 100386650 ABN 84047117254



C C No	CONSTRUCTION CERTIFICATE			
CC2011-00175	This certificate is issued by a Private Certifying Authority and verifies that if the applicant cames out the proposed work in accordance with the plans and specifications that are approved the work will comply with the Environmental Planning and Assessment Regulation 2000			
COUNCIL	PITTWATER			
APPLICANT				
Name	Pittwater RSL Club C/- Paynter Dixon Constructions			
Address	320 Liverpool Road, ASHFIELD 2131			
Contact no (telephone/fax)	97975555			
OWNER				
Name	Pittwater RSL Club			
Address	80-82 Mona Vale Road, MONA VALE 2103			
Contact no (telephone/fax)	99973833			
SUBJECT LAND				
Address	80-82 Mona Vale Road, MONA VALE 2103			
DESCRIPTION OF DEVELOP	MENT			
Type of Work	Building work Demolition work			
Description	Construct a new bowlers amenities building with an extended outdoor terrace area			

Essential Certifiers Liverpool Certificate No CC2011-00175

perc \$30 20/8/10

Page 1 of 4

COUNCIL'S D/A CONSENT

Development Consent No

N0503/09

D A Approval Date

20/01/2010

BUILDING CODE OF AUSTRALIA

BUILDING CLASSIFICATION

9b

BUILDER or OWNER/BUILDER

Name

Paynter Dixon Constructions P/L

Contractor Licence No

N/A

\$ VALUE OF WORK

Building

\$1,250,000 00

DATE C C APPLICATION RECEIVED

Date Received

17/08/2010

DETERMINATION

Decision

Approved

Date of Decision

23/08/2010

ATTACHMENTS

- Pittwater Council fees receipt No 284071 dated 5/8/10
- Design Statement for architectural plans by Bergstrom Architects dated 5/8/10
- Structural Design Certificate by Taylor Thompson Whitting dated 9/8/10
- Hydraulic & Fire Services Design Statements by Wood & Grieve Engineers dated 30/7/10
- Electrical Services statement of design by Haron Robson dated 9/8/10
- On-site detention volume compliance by Taylor Thompson Whitting dated 16/8/10
- Noise Emission Assessment by Acoustic Logic Consultancy dated 2/8/10
- Schedule of Finishes by Bergstrom Architects dated 2/8/10
- Food Premises Design Certificate compliance dated 30/7/10
- Section J compliance certificate by Club's Sustainable Futures Pty Ltd dated 4/8/10
- Equipment Layout Plan by Quantum Design International Job PRL 1/18
 - Drawing No BC-100 Issue G dated 9/6/10
- Stormwater Concept Plan by Taylor Thompson Whitting Job 091087
 - Drawing No SKC01 Revision P2 dated 6/11/09
- Mechanical Services Plan by Engineered Environments Pty Ltd Job J1853
 - Drawing No M-01 & M-02 Issue A dated 9/7/10
- Electrical Services Plan by Haron Robson Electrical Job PRL 1/25 13335
 - Drawing No 06/ES01 to 06/ES06 Issue A dated 9/8/10
- Hydraulic Services Plan by Wood & Grieve Pty Ltd Job 22179-SYD
 - Drawing No H-001, H-200, H-400 Revision 0 dated 30/7/10
 - Drawing No H-300 Revision 1 dated 16/7/10
- Structural Plans by Taylor Thompson Whitting Job 091087 B
 - Drawing No S0001 & S0002 Revision A dated 29/7/10
- \$30 00 cheque to Pittwater Council for CC lodgement fee

IMPORTANT NOTE It is the applicant's responsibility to ensure the mandatory PCA site sign supplied herewith, is displayed at this building site throughout construction

Essential Certifiers Liverpool Certificate No CC2011-00175

PLANS AND SPECIFICATIONS APPROVED

List plan no(s) and specifications reference

Architectural Plans by Bergstrom Architects - Job PRL 1/25

- Drawing No WD 100 - Revision P1 - dated 3/8/10

- Drawing No WD 101, 200, 201 - Revision P3 - dated 3/8/10

RIGHT OF APPEAL

under S109K where the Certifying Authority is a Council an applicant may appeal to the Land and Environmental Court against the refusal to issue a Construction Certificate or imposition of conditions on the consent within 12 months from the date of the decision

ACCREDITATION BODY

BUILDING PROFESSIONALS BOARD 10 Valentine Street, Parramatta NSW 2150

CERTIFICATE

Certificate Final

I certify that the work if completed in accordance with these plans and specifications (with such modifications verified by the Certifying Authority as may be shown on that documentation) will comply with the requirements of the Environmental Planning and Assessment Regulation 2000 as referred to in Section 81A(5) of the Environmental Planning and Assessment Act 1979

CERTIFYING AUTHORITY

Name of Certifying Authority

Essential Certifiers Liverpool

Name of Accredited Certifier

Bernie Cohen

Accreditation No

BPB0067

Contact No

(02) 9612-5000

Address

Level 1, 405 Hume Highway, Liverpool NSW 2170

SIGNED



essentialcertifiers

Bernie Cohen and Associates Pty Ltd T/As Essential Certifiers ABN 84 047 117 254

Level 1 • 405 Hume Highway Liverpool NSW 2170 PO BOX 208 Casula Mail NSW 2170 T 02 9612 5000 F 02 9612 5050 essentialcertifiers com au

- . ACCREDITED CERTIFIERS
- CONSTRUCTION CERTIFICATES
- INSPECTIONS
- FIRE SAFETY SERVICES
- BUILDING CODE CONSULTANCY

ESSENTIAL FIRE SAFETY MEASURES

The following is a list of essential fire safety measures that are applicable to this building under Clause 166 of the EP&A regulations 2000


Schedule of Proposed Essential Fire Safety Measures

Essential Service	Australian Standard	Building Code of Australia
Emergency Lighting	AS 2293 1 2005	E4 4
Exit Signs	AS 2293 1 2005	E4 8
Portable fire extinguishers	AS 2444 - 2001	E1 6

Note All existing and proposed fire safety measures are to be assessed annually and a copy referred to the relevant local council and to the NSW Fire Brigades The Annual Fire Safety Statement is to be prominently displayed in each building

80-82 Mona Vale Road MONA VALE 8/20/2010 CC 2011-00175

APP	ROX. DA	TE BU	ILDING V	VORK	B TO COMMENCE LATE AUGUST 2010
HON	IE BUILO	ING A	T 1989 I	REQUIR	REMENTS
Princ	ipal Certi	fying A	uthority h	es been	n advised of the requirements of CI 78C of the Regulation
1	Yes		No		N/A - reason
	Home Bu	iding Ad	1989 requi	rements	in case of building work that involves residential building work
(a)	in the c	With) ur in ann	in the mea ork by a Bo	ning of th	he Home Building Act 1989) attached as follows
(0)	(1)	a stat	emeni deta	iling the i	Roonsee's name and contractor Roence number, and
	(II)	docum		ience tha	at the floensee has compiled with the applicable requirements of that
(b)	in the c	ase of w	ork done by		
	(i) (ii)				person's name and owner-builder permit number, or se owner of the land, to the effect that the reasonable market cost of
	(ig	the let	bour and m	eteckijs is	rivolved in the work is less than the amount prescribed for the
14	A certifica				of owner-builder work in Section 29 of the Act. ran approved insurer under Part 6 of the Home Building Act 1989
\	to the offe	ect that a	person la t	ne holder	r of an insurance contract issued for the purposes of that Part person has compiled with the requirements of that Part.
					DECLARATION
	l the Prin	ıcipai Cei	tilying Auti	ortly for	have the legal authority (express or implied) to engage a the building works described in this document and verify ining to such work is correctly stated on this form
00	mmence bu	ailding wo	irk in accon	lance wi	n to the relevant Local Council two (2) days prior to the intention to th S81A(2)(c) of the EP&A Act and verify that no building work will Date the Building Work is to Commence" section of this document
indica indica	Mowing res Ited below) My intent k	ponsibilit i in carry o depart i	ies, ensure out building rom the ses	the Buik work in ued Devi	Certifying Authority stipulated on this form, I agree to undertake the der contacts the PCA at the specified stages of development (as a accordance with a current Development Approval; to notify the PCA relopment Approval as soon as the intention arises, and to verify all to Certifying Authority are bone fide and correct in detail
86	ecified stag	ges of de	veiopment,	but not ii	on the approved Construction Certificate to contact the PCA at the Imited to these stages in order to obtain an inspection as follows
					ork*Wet Areas*Completion*Any other stage as specified by the PCA.
16	ully underst	and that	failure to do	so may	result in the PSA-lessing a Notice of Intention to Serve an Order
Own	er's or To	ennant'	s Signat	ire	X DI Jimou
		2,	1-1	10	
Date	d				Company March 18 1 Visit
Print	Name		XXW	CĘ.	SMITH a. VIAWATER BL CLUTE
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		10	ONV	· V	INCE NSW 2103
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PCAI	orm07v0	l doc			

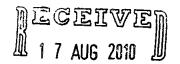



Bernie Cohen and Associates Pty Ltd T/As Essential Certifiers Liverpool ABN 84047117254

PO Box 208 Casula Mall NSW 2170 P 02 9612 5000 Level 1 405 Hume Highway F 02 9612 5050 Liverpool NSW 2170 E info@essentialcertifers com au

www essentialcertifiers com au

CONSTRUCTION CERTIFICATE APPLICATION FORM

Construction Certificate In accordance with Clause 139 Part 8 Division 2 of the Environmental Planning and Assessment Regulations 2000

Owners Declaration

I/we understand that this engagement shall be subject to the Torms and Conditions in the fee proposal (E sny)

Uwe as owners/applicants of the land to which the application relates. I/we consent to the making of the application. I/we also give consent for officers/certifiers of Essential Certifiers Liverpool to enter the land to carry out inspections rotating to this application.

tive declare that live will notify Essential Certifiers Liverpool to carry out any critical stage inspection or make arrangements with the Builder to carry out this function on my/our behalf as a condition of my/our Building contract.

PART F - D Builders Details Downer Builders Details Name PAYNTER DIXON CONST License No/ Owner Builder Permit No Rd Address 320 LIVERPOOL ASHFIELD Phone 9797 5555 Mobile 0408 292 322 Fax 97996149 Email PART G - Description of Development Describe the work to be carried out NEW BOWLERS' AMENITIES BUILDING Cost of Development \$ / 25M Your Ref Number of Stories Number of Structures **Building Classification** Has development consent been granted for the development? No Consent Number No 503/09 Date of Determination 20 Jan 2010 Yes Council Area PITTWATER COUNCIL Has a Section 96 Modification been granted for the development? No Yes Modification Number Date of Modification



SCHEDULE OF DETAILS FOR THE **AUSTRALIAN BUREAU OF STATISTICS**

CONSTRUCTION CERTIFICATE NUMBER

PARTICULARS OF THE PROPOSAL

ΔII	New	Buildings
~"	11011	Dununigo

Area of subject site (m²) 39,240 m²

Does the site contain dual occupancy?

当天

Current use of existing building/s on the subject site (if vacant, state 'vacant') EXISTING RSL CLUB # ASSOCIATED USES.

Floor area of existing building/s in m² except if being demolished 7095m²

Gross floor area in m² of proposed addition/s or new building/s. If multiple buildings please itemise

STAGE!

Proposed use of all parts of the addition/s or new building/s STAGE I CANTEEN, KITCHEN, COOL RM., FREEZER, SERVERY, OFFICE)

Residential Dwellings Only

Number of pre existing dwellings	Number of dwellings to be demolished	とし
Number of proposed new dwellings	Number of storeys of proposed dwelling	$I^{}$

Materials Used in Building

Tick the box alongside which best describes the material/s to be used in the construction of the proposed new work/s

WALLS		ROOF		FRAME		FLOOR	
Brick Veneer		Aluminium	1	Timber		Concrete	
Full Brick		Concrete	L^{-}	Steel		Timber	
Single Brick		Concrete Tiles		Other (describe below)		Other (describe below)	
Concrete Block	/	Fibrous Cement	П		Ī		1
Concrete/Masonry		Fibreglass	T				\top
Concrete		Masonry Shingle	T				
Steel		Terracotta Shingle	1				
Fibrous Cement		Tiles - other	Ţ				
Hardiplank		Slate	\vdash		1		$\dagger \lnot$
Timber/Weatherboard		Steel					
Cladding/Aluminium		Terracotta Tiles			Τ-		$\dagger \lnot \dagger$
Curtain Glass		Other (describe below)	1			 	\vdash
Other (describe below)							\vdash
							

Tivater Island

5/2011 Face the IE-Wi

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720 (NEE-11 F) -E-F1912 NSW 243

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5 August, 2010

Paynter Dixon Constructions 320 Liverpool Road Ashfield, NSW 2131

Attn Mr Tony Fucile

Dear Tony,

Re Design Statement for Pittwater RSL – Construction Certificate for the Bowler's Lounge

This design statement is to accompany the Construction Certificate application submitted to the Principal Certifying Authority for the new Bowler's Lounge facilities to be built adjacent to the existing Bowler's Amenities block and is limited to architectural design work as detailed in the below listed drawings and does not include any design work by other consultants or architectural works generally documented within specifications

The following documentation was issued by Bergstrom Architects for the Construction Certificate application on 03 08 2010,

- WD100 Revision P2 Location Plan & Drawing List,
- WD101 Revision P3 Ground Floor Plan,
- WD200 Revision P3 Elevations,
- WD201 Revision P3 Sections,
- Schedule of External Finishes, Revision A

The submitted documents generally comply with the following provisions of the BCA,

- Section C Fire Resistance,
- Section D Access & Egress,
- Section J- Energy Efficiency Compliance with this section is based on the space within the new Bowler's Lounge being non-conditioned

The submitted documents generally comply with the following DA Conditions of Consent issued by Pittwater Council on 20/01/2010 under DA No N0503/09,

- A1, B5, B43, B48, B52, B53, C2, C4, C7, C8, C10, C11



The submitted architectural drawings generally comply with DA Condition C9, we note that a management procedure will be in place for serving people with disabilities from the servery counter as an alternative solution to lowering a section of the servery counter

For compliance with other DA Conditions, please refer to documentation provided by engineers and other consultants

Kind regards,

Tom Bergstrom

Bergstrom Architects Pty Ltd (ACN 095 092 989)



ENQUIRIES PROJECT NO DAVID STEBLINA 22179-SYD H

30th July 2010

Paynter Dixon Constructions 320 Liverpool Road Ashfield NSW 2131

Attention

Tony Fucile

Dear Tony

RE

PITTWATER RSL CLUB BOWLERS LOUNGE - HYDRAULIC & FIRE SERVICES - DESIGN STATEMENT- DA NO N0503/09

We confirm that the Hydraulic & Fire Services design, as prepared by Wood & Grieve Engineers for the above mentioned project has been designed in accordance with the Building Code of Australia (BCA 2009) in particular Section J Part J7 and Sections E1 3 and E1 4 the Australian Standards AS 3500 AS5601 AS2419 1

The Hydraulic & Fire services drawings applicable to this statement are as follows

Dwg No	Revision	Drawing name
H 001 0 SPECIFICATION NOTES AND LEGEND		
H 200	0	SEWER DRAINAGE LAYOUT 1 OF 2
H 300	1	SEWER DRAINAGE LAYOUT 2 OF 2
H-400	0	COLD & HOT WATER GAS SANITARY PLAN

We trust that the above information is sufficient for your present purposes. Should you require any further information, please do not hesitate to contact the undersigned

Yours faithfully

David Steblina

for Wood & Grieve ENGINEERS

DOCUMENT M \TECH\22100\79\H_QA_DESIGN_002 DOC (DMS)

'vital experience'

Page 1 of 1

Wood & Grieve Engineers ABN 75 900 165 652 Perh Melbourne Sydney Brisbane Albany Busselton L3 454-456 Pacific Highway St Leonards New South Wales 2065 Phone +61 2 8484 7000 Fax +61 2 8484 7100 Email sydney@wge com au Web www.wge.com.au

Wood & Grieve Pty Ltd ACN 008 808 786 as trustee for the Wood & Grieve Unit Trust trading as Wood & Grieve Engineers







Paynter Dixon Constructions Pty Ltd Locked Bag 9 ASHFIELD NSW 2131

Attention

Tony Fucile

PITTWATER RSL CLUB - BOWLERS LOUNGE AMENITIES PRL-1/25 **RE** ELECTRICAL SERVICES STATEMENT OF DESIGN

The Electrical Services in the new and refurbished areas covered under DA Number NO123/09 and as described on our drawings 13335 06/ES01 A to 13335 06/ES06 A inclusive have been documented in accordance with the following

- The Emergency and Exit Sign Lighting System has been designed in accordance with Clause E4 2 to E4 8 of the Building Code of Australia 2010, and AS 2293 1 2005 utilising 'pictogram" legend and exit signs
- The Lighting and Power Installation has been designed in accordance with Section J, Part 6 of the Building Code of Australia 2010
- The Internal Lighting has been designed in accordance with Australian Standard AS 1680 0-2005 Interior lighting Circulation Spaces and Other General Areas and Part F4 4 of the Building Code of Australia

When the Electrical Services Contractor has completed the installation, testing and commissioning of the systems he shall have to provide a Statement of Compliance that the systems have been installed, tested and found to operate in accordance with the requirements of the Building Code of Australia and the relevant Australian Standards

Should you have any questions on this matter please do not hesitate to contact the undersigned at this office

Yours faithfully

HARON ROBSON PTY LTD

Tom Russell Director

trussell@haronrobson.com au

Taylor Thomson Whiting (NSW) Pty Ltd Consulting Engineers ACN 113 578 377 48 Chandos Street St Leonards NSW 2065 PO Box 738 Crows Nest NSW 1585 T 61 2 9439 7288 F 61 2 9439 3146 ttwsyd@ttw com au www.ttw.com.au

Memo Transmittal

Project Stormwater, Pittwater RSL Club,	Job No 091087 B	
From	Date	Record No
Kelvın HOLEY	16/08/2010	1
Transportation Method		Page No
Email and Facsimile		1 of 1

Distribution	Attention	Email Fax	
Paynter Dixon Constructions Pty Ltd	Mr Tony Fucile	(02) 9716 6870	

Subject

Bowlers club onsite detention volume

Tony,

I confirm that the futsal design as shown on Northrop drawing C4 01 revision 5 provides an On-Site Detention volume of 70000L which is able to accommodate the future extension to the bowlers club

- Bowlers club extension detention volume required 24000L
- Futsal court detention volume required 24000L*
- Futsal court design detention provided 70000L 2x35000L tanks
- * based on Northrop drawing DA01 revision 1

Regards Kelvin Holey BEng (Civil and Enviro) Dip Eng Prac, Dip Civ Eng



ACOUSTIC LOGIC CONSULTANCY noise and vibration consultants abn 11 068 954 343

Reference 2009852/0208A/R0/VF

2 August, 2010

Paynter Dixon Constructions Pty Ltd 320 Liverpool Road **ASHFIELD NSW 21310**

No Pages 1

ATTN MR TONY FUCILE

PITTWATER RSL CLUB - OUTDOOR TERRACE AND PROPOSED BOWLERS AMENITIES BUILDING - NOISE EMISSION ASSESSMENT OF EXHAUST FAN

It is proposed to install a kitchen exhaust fan on the roof above the proposed amenities building kitchen

The proposed fan has a noise level of 55 dB(A) at 3m in a free field. The resultant noise level at the nearest residential property would be less than 28 dB(A), which would be inaudible at all times of fan operation and comply with the noise emission criteria stipulated in report 2009852/1102A/R1/TT

We trust this information is satisfactory. Please contact us should you have any further queries

Yours faithfully,

ACOUSTIC LOGIC CONSULTANCY PTY LTD

1/ Tathe

Victor Fattoretto

SCHEDULE OF Finishes - Issue A

Pittwater RSL Club_Bowler s Lounge

SCHEDULE OF FINISHES

EXTERNAL FINISHES

Pittwater RSL Club Bowler's Lounge

80-82 Mona Vale Road Mona Vale NSW 2103

Date Revision 02 08 10 Issue A

Prepared By

Bergstrom Architects Pty Ltd

ABN 75 095 092 989

Suite 9, Level 2, 9 Myrtle Street, NORTH SYDNEY, NSW 2065

2/08/10

1 of 2

 $SCHEDULE\ OF\ Finishes-Issue\ A$

Pittwater RSL Club_Bowler s Lounge

Note:

FINISH	ES SCHEDULE		
Code	Item/Location	Name/description	Contact Details
1 Walls			
	General walls Render and paint finish	Dulux Rattle snake P14B6	Dulux
l		(To match existing Amenities block)	
2 Doors			
	Solid core doors	Dulux Nick's nook P18D6 (To match existing Amenities block)	Dulux
3 Steel	paint colours		
	General steel	Dulux Spanish eyes PG1F9 (Gloss) (To match existing Amenities block)	Colorbond
4 Roof			
	Ritek – Ecotek roof panels	Top Layer-Prefinished Colorbond Trimdek Steel sheeting- Woodland Grey Underside- Colorbond Custom Orb sheeting- Shale Grey	Ritek (02) 9531 5664

2/08/10

2 of 2

Attachment F1

Food Premises Design Certificate of Compliance

PREMISES

Pittwater RSL Club

ADDRESS

Foley Rd, Pittwater NSW

DEVELOPMENT APPLICATION No

DA - N0503/09 (Consent Number)

CONSTRUCTION CERTIFICATE No

Pursuant to the provisions of Section 93 of the Local Government Act 1993 I hereby certify that the design of the new/alterations to the existing food premises as shown in the plans and specifications listed below meet the requirements and intent of the following '

- (a) The above mentioned Construction Certificate and Development Consent,
- (b) Australian Standard AS 4674, Design, construction and fit-out of food premises,
- (c) The Food Act 2003,
- (d) Food Regulation 2004
- (e) Food Safety Standards 3 1 1, 3 2 2 & 3 2 3

I also certify that the design has included due consideration of the following

- (a) The provisions of the Building Code of Australia (BCA) and Councils Ventilation Code relating to Mechanical Ventilation and the position of all proposed air intakes and discharge points relative to the amenity of the neighborhood
- (b) The provisions of the BCA relating to toilet and other sanitary facilities for patrons and staff
- (c) The minimization of likely contamination of food and the provision of temperature control as required by the Food Safety Standards
- (d) Compliance with Councils Code for Waste Handling in Buildings

I am an appropriately qualified practicing food & beverage design person competent in the area of Food Premises Design and as such can certify under Section 93 of the Local Government Act 193, that the design complies with the above requirements I am covered by indemnity insurance to the satisfaction of the building owner

Date of Development Consent (Compulsory)

20th January 2010

Date/s of Construction Certificate (Compulsory)

Full Name of Certifier

Bruce W Smith

Registration Number

703546

Qualifications & Experience 11

Refer Attached

Address of Certifier

17 Lochiel Rd, Engadine NSW 2233

Phone Numbers

Bus 02 94520 8300 Mobile 0407 421 983 Fax 02 9520 4300

Signature

Date 30th July 2010

Name of Employer (Self or Company) Quantum Design International Pty Ltd

Certified Drawing numbers and revision list (attach a separate list if necessary) 111

Quantum Design International Pty Ltd - Drawing PRL-BC-100-G dated 9 06-2010

Following the completion of construction and installation of equipment, Certification (Attachment F2) must be submitted to the satisfaction of the Principal Certifying Authority before occupancy will be granted iv

Notes

Certification of Mechanical Ventilation Systems Waste Management Plans and for major food complex (hotel food courts, clubs etc) Food Management Plan must be submitted separately in the format by those responsible

Please submit a Curriculum Vitae with your Certification

List and attach drawings nos and revisions and specifications including plans elevations and sectional details of design and construction of the premises and the layout of equipment

Any proposal to depart from the prescribed design requirements must be justified with this submission to the satisfaction of the Principle Certifying Authority

Updated 04/06/2007

CURRICULUM VITAE

Bruce William Smith FCSI

Since the inception of Quantum Design International Pty Ltd in 1995 Bruce has brought together highly experienced staff, resources and external expertise to cater for the high degree of experience required within the Hospitality Industry

Prior to joining Quantum Design International Bruce was contracted to TAFE NSW for a period of two years as the Senior F & B Facilities Manager responsible for the development and conversion of their teaching kitchens to the new National Core Curriculum During his time with TAFE NSW Bruce provided lectures on all aspects of facilities design. In the period from 1983 to 1993 Bruce was the Managing Director of Catering Design Australia a leading Australian company providing foodservice consultancy services to both Australian and International companies. For a period of ten years prior to this position Bruce held a number of executive positions with Noyes Bros Pty Ltd culminating as Australian General Manager F&B Division a Hawker Siddley subsidiary company - England. Mr Smith has been continuously active within the Hospitality Industry since 1963

- Registered Foodservice Consultant No 703546
- Mr Smith is the International Chairperson, (FCSI) Council for Professional Standards
- Asian / Pacific representative of Foodservice Consultants Society International (FCSI,)
- Committee member of Australian Standards BD-095 (AS 4674 Construction and fit-out of food premises)
- Past President of the Commercial Kitchen Equipment Contractors Association (CKECA)
- Executive Food Marketing Member of the Catering Institute of Australia (CIA)
- Member of Refrigeration Contractors Association Australia (RACCA)
- Justice of the Peace Appointment 7th September 1977
 No 7700084
- Current licences held Foodservice Consultant #703546
 - Refrigeration Engineers Trade Certificate
 Refrigeration & Air Conditioning Gold Card
 - CFC Gas User (O P Act 1989)
 - Electrical / Refrigeration

Dated 14th July 2008



HYDRAULIC SERVICES NOTES

- THE HYDRAULIC SERVICES DRAWINGS ARE TO BE READ IN CONJUNCTION WITH FOLLOWING DOCUMENTS WHICH FORM AN INTEGRAL PART OF THE HYDRAULIC SERVICES CONTRACT: - HEAD CONTRACT PRELIMINARIES FOR RELATED CONDITIONS & REQUIREMENTS,
- HYDRAULIC SERVICES SPECIFICATION, - ARCHITECTURAL PLANS, SECTIONS & ELEVATIONS, - STRUCTURAL DRAWINGS, MECHANICAL SERVICES DESIGN & SHOP DRAWINGS.
- ELECTRICAL DRAWINGS INCLUDING POWER DISTRIBUTION & LIGHTING. - ACOUSTIC REPORT THE HYDRAULIC SERVICES CONTRACTOR SHALL BE RESPONSIBLE
- FOR OBTAINING COPIES OF THE ABOVE DOCUMENTS DIRECT FROM THE HEAD CONTRACTOR - PAYNTER DIXON. - THE COMPLETE HYDRAULIC SERVICES INSTALLATION SHALL BE COMPLETED IN ACCORDANCE WITH THE REQUIREMENTS OF THE FOLLOWING WHETHER DEPICTED ON THE DRAWINGS OR NOT:
- AS 3500 "THE NATIONAL PLUMBING & DRAINAGE CODE" AS 2419 "FIRE HYDRANT INSTALLATIONS" AS 2441 "FIRE HOSE REEL INSTALLATIONS" - AS/NZS 5601 "GAS INSTALLATION CODE"
- REQUIREMENTS OF ALL STATUTORY AUTHORITIES HAVING JURISDICTION. - THE CONTRACTOR SHALL REMAIN RESPONSIBLE FOR LIAISING WITH ALL OTHER TRADES TO ENSURE THAT CO-ORDINATION OF
- SERVICES IS UNDERTAKEN & THAT FINAL INTEGRATION OF SERVICES IS ACHIEVED. - ALL EXISTING SERVICES SHOWN ARE IN APPROXIMATE LOCATION ONLY THE CONTRACTOR SHALL BE RESPONSIBLE FOR DETERMINING THE EXACT LOCATION OF ALL EXISTING SITE
- SERVICES PRIOR TO COMMENCEMENT OF SITE WORKS. - THE CONTRACTOR SHALL REMAIN RESPONSIBLE FOR OBTAINING ALL NECESSARY INFORMATION RELATING TO THE LOCATION OF ALL MAIN INFRASTRUCTURE SERVICES INCLUDING SEWER, WATER, GAS, COMMUNICATIONS & POWER PRIOR TO COMMENCEMENT OF EXCAVATION WORKS.
- THE CONTRACTOR SHALL FAMILIARISE THEMSELVES WITH SITE/GROUND CONDITIONS, GROUND LEVELS, PROPOSED FLOOR LEVELS & SERVICES INVERT LEVELS PRIOR TO THE COMMENCEMENT OF SITE WORKS.
- THE CONTRACTOR SHALL IDENTIFY AT AN EARLY STAGE OF THE CONTRACT ANY DISCREPANCIES WITH THE DRAWINGS & SPECIFICATION THAT ARE AFFECTED BY EXISTING SERVICES LOCATIONS & GROUND CONDITIONS.
- THE CONTRACTOR IS REQUIRED TO PROVIDE DETAILED & ACCURATE AS-CONSTRUCTED DRAWINGS AT PRACTICAL
- THE CONTRACTOR IS REQUIRED TO PROVIDE COMPREHENSIVE PREVENTIVE MAINTENANCE & WARRANTY OF ALL NEW SERVICES & EQUIPMENT TOGETHER WITH ATTENDANCE TO DEFECTS DURING THE REQUIRED DEFECTS LIABILITY PERIOD.

- THE PROGRAM OF THE WORKS SHALL BE IN ACCORDANCE WITH THE HEAD CONTRACTORS CONSTRUCTION PROGRAM. THE CONTRACTOR IS TO FAMILIARIZE THEMSELVES WITH THE CONSTRUCTION PROGRAM & ANY PLANNED STAGING TO ENSURE THAT ALL MATERIALS & LABOUR IS PROVIDED AS REQUIRED. MINIMUM GRADE FOR GRAVITY STORMWATER DRAINAGE SHALL
- CONFORM TO AS 3500 PART 3 AS FOLLOWS, UNO 1% FOR 100mm & 150mm DIAMETER 0.5% FOR 225mm DIAMETER 0.4% FOR 300mm DIAMETER 0.35% FOR 375mm DIAMETER
- MINIMUM DEPTH OF COVER FOR STORMWATER PIPES 300mm FOR NON-TRAFFICABLE AREAS 450mm FOR TRAFFICABLE AREAS
- 600mm FOR HEAVY VEHICLE TRAFFIC AREAS MINIMUM GRADES FOR GRAVITY SANITARY DRAINAGE SHALL BE AS FOLLOWS, UNO 65ø 2.5%
- 80ø 1.65% 100¢ 1.65% 125¢ 1.25%
- 150¢ 1.00% 225¢ 0.65% 300¢ 0.4%
- THE CONTRACTOR SHALL ALLOW FOR & PAY ALL FEES & CHARGES FOR CONNECTION TO EXISTING AUTHORITIES INFRASTRUCTURE
- ALL DOMESTIC COLD WATER & HOT WATER SERVICES OFF TAKES ARE TO BE FITTED WITH SEPERATE CONTROL VALVES WHETHER SHOWN ON THE DRAWING OR NOT - COLD WATER & HOT WATER PIPES CHASED IN WALL, DROPPING
- &/OR RISING TO VARIOUS FIXTURES NO HORIZONTAL CHASING STRUCTURAL ENGINEER APPROVAL IS REQUIRED FOR ALL CORE HOLE DRILLING ALL ELECTRICAL WORKSUNDER HYDRAULIC SERVICES TRADE
- SHALL BE CARRIED OUT BY LICENCED ELECTRICIAN - CURRENT AUSTRALIAN STANDARDS, BCA & RELEVANT REGULATIONS SHALL BE USED AT THE TIME OF INSTALLATION - PROVIDE ADEQUATE PIPE SUPPORT TO ALL NEW SERVICES &
- ADDITIONAL SUPPORT TO EXISTING SERVICES AS REQUIRED PROVIDE ALL NECESSARY LABELING OF PIPEWORK PROVIDE ALL NECESSARY COMMISSIONING & TESTING AT
- PRACTICAL COMPLETION - PROVIDE ALL MATERIAL APPROVALS CERTIFICATES IN THE OPERATING MAINTENANCE MANUAL
- INSTALL FIRE STOPPING COLLARS & PRODUCTS TO ALL PVC & INSULATED PIPES PASSING THROUGH FLOOR SLABS, FIRE WALLS & FIRE CEILINGS

LINETYPES

SEWER DRAINAGE - STORMWATER TRADE WASTE DRAINAGE GREASE WASTE SUCTION — — — — VENT PIPE

---- COLD WATER --- HOT WATER HOT WATER RETURN - · · - ww - WARM WATER

____ GAS

LEGEND

STOP VALVE GAS BALL VALVE

SOLENOID VALVE GAS REGULATING VALVE

UNDERGROWND GAS BALL VALVE & CAST IRON PATH BOX

NON RETURN VALVE / SPRING CHEICK VALVE DOUBLE CHECK VALVE /

FLOOR WASTE BUCKET TRAIPFLOOR WASTE RAIN WATER WILET

PUMP CLEAROUT

OVERFLOW GLULLY GAS METER WATER METERR

FILTER

RISER / DROPPER SIZE LABEL

SERVICE CONTINUATION

REFER DRAWING No. H01

DOUBLE HEAD FIRE HYDRANT

PIPE DROPPER (BEND)

PIPE DROPPER (TEE)

PIPE RISER / DROPPER

AIR ADMITTANCE VALVE

AUSTRALIAN HEIGHT DATUM

PIPE CAPPED OFF

BOUNDARY TRAP

TUNDISH

BASIN

PIPE RISER / DROPPER (TEE)

FIRE HYDRANT

FIRE HOSE REEL

BOUNDARY TRAP STORMWATER PIT WITH SOLID COVER STRAINER STORMWATER PIT WITH GRATED COVER

SEWER MANHOLE STOP VALVE & CAST IRON PATH BOX - SERVICE TYPE / STACK No.

PRESSURE LIMITING VALVE REFLUX VAILVE

BACK FLOW PREVENTION DEVICE THERMOSTALTIC MIXING VALVE

HOSE TAP

FLEXIBLE JOINNI / CONNECTION

BT/FW BUCKET TRAP / FLOOR WASTE BALANCING VALVE

707

CONDENSATE DRAIN CAST IRON CEILING LEVEL CLEAR OUT

CLEANERS SINK CW COLD WATER DCV DOUBLE CHECK VALVE

DIESEL EXHAUST

ABBREVIATIONS

DH/HYD DOUBLE HEAD FIRE HYDRANT LL LOW LEVEL DOWN PIPE NATURAL GAS EXISTING OVER FLOW FLOOR DRAIN OFG OVER FLOW GULLY FINISHED FLOOR LEVEL POLYVINYL CHLORIDE PIPE FIRE HYDRANT REDUCED LEVEL FIRE HYDRANT BOOSTER FHVA RPZD REDUCED PRESSURE ZONE DEVICE VALVE ASSEMBLY FIRE HOSE REEL RELIEF VENT FIRE SPRINKLER RAIN WATER OUTLET FIXTURE UNITS SHOWER FLOOR WASTE SINK GAS BALL VALVE SOIL STACK GRATED DRAIN STORMWATER GAS FLUE SYDNEY WATER CORPORATION GROUND LEVEL STORMWATER PIT GAS METER TUNDISH

GATE VALVE TMV THERMOSTATIC MIXING VALVE GREASE WASTE TEMPERATURE PRESSURE RELIEF VALVE GREASE WASTE VENT PIPE TTD TRAPPED TUNDISH GWV HIGH LEVEL URINAL

HIGH POINT VENT PIPE HOSE TAP HOT WATER HOT WATER RETURN

INVERT LEVEL INSPECTION OPENING INDUCT PIPE MICA FLAP

ISOLATION VALVE

HOT WATER UNIT

WATER CLOSET WATER METER WARM WATER

0 CONSTRUCTION ISSUE HL DMS 30.07.10 REV. DESCRIPTION DRAWN APP'D DATE CLIENT: PAYNTER DIXON Paynter Dixon Construction Pty Limited

Tel (02) 9797 5555 Fax (02) 9799 6149 ARCHITECT :

> bergstrom ARCHITECTS pty. ltd. BERGSTROM ARCHITECTS PTY. LTD. (ABN 75 095 092 989) SUITE 9, LEVEL 2, 9 MYRTLE STREET,

320 Liverpool Road, Ashfield NSW 2131

NORTH SYDNEY NSW 2065 Ph. 02.8920.1499 Fax. 02.8920.1599

COUNCIL COPY

ESSENTIAL CERTIFIERS LIVERPOOL

Stormwater Details C.C. NO: 1115 WARNING A comprehensive check of the Stormwater Design has not been carried out & the approval of the drawings by Essential Certifiers does not relieve the Hydraulic

Engineer of their responsibility to ensure that the Stormwater complies with Councils

Stormwater policy

A.C.N. 008 808 786 Level 3, 454-456 Pacific MELBOURNE Highway, St Leonards SYDNEY Phone: 02 8484 7000 Fax: 02 8484 7100 BRISBANE Email: sydney@wge.com.au WOOD & GRIEVE ENGINEERS Web: www.wge.com.au

PITTWATER RSL CLUB BOWLER'S LOUNGE

HYDRAULIC SERVICES NOTES AND LEGEND


CONSTRUCTION ISSUE


DESIGNED : DMS APPROVED FOR TENDER : DRAWN: HL SCALE: NTS DMS CAD FILE: H-001.dwg PLOT DATE/TIME: 30.07.10 03:51 PM



PROJECT No. DRAWING No. REVISION 22179-SYD 0

A1 DRAWING - BUILDING SERVICES GROUP

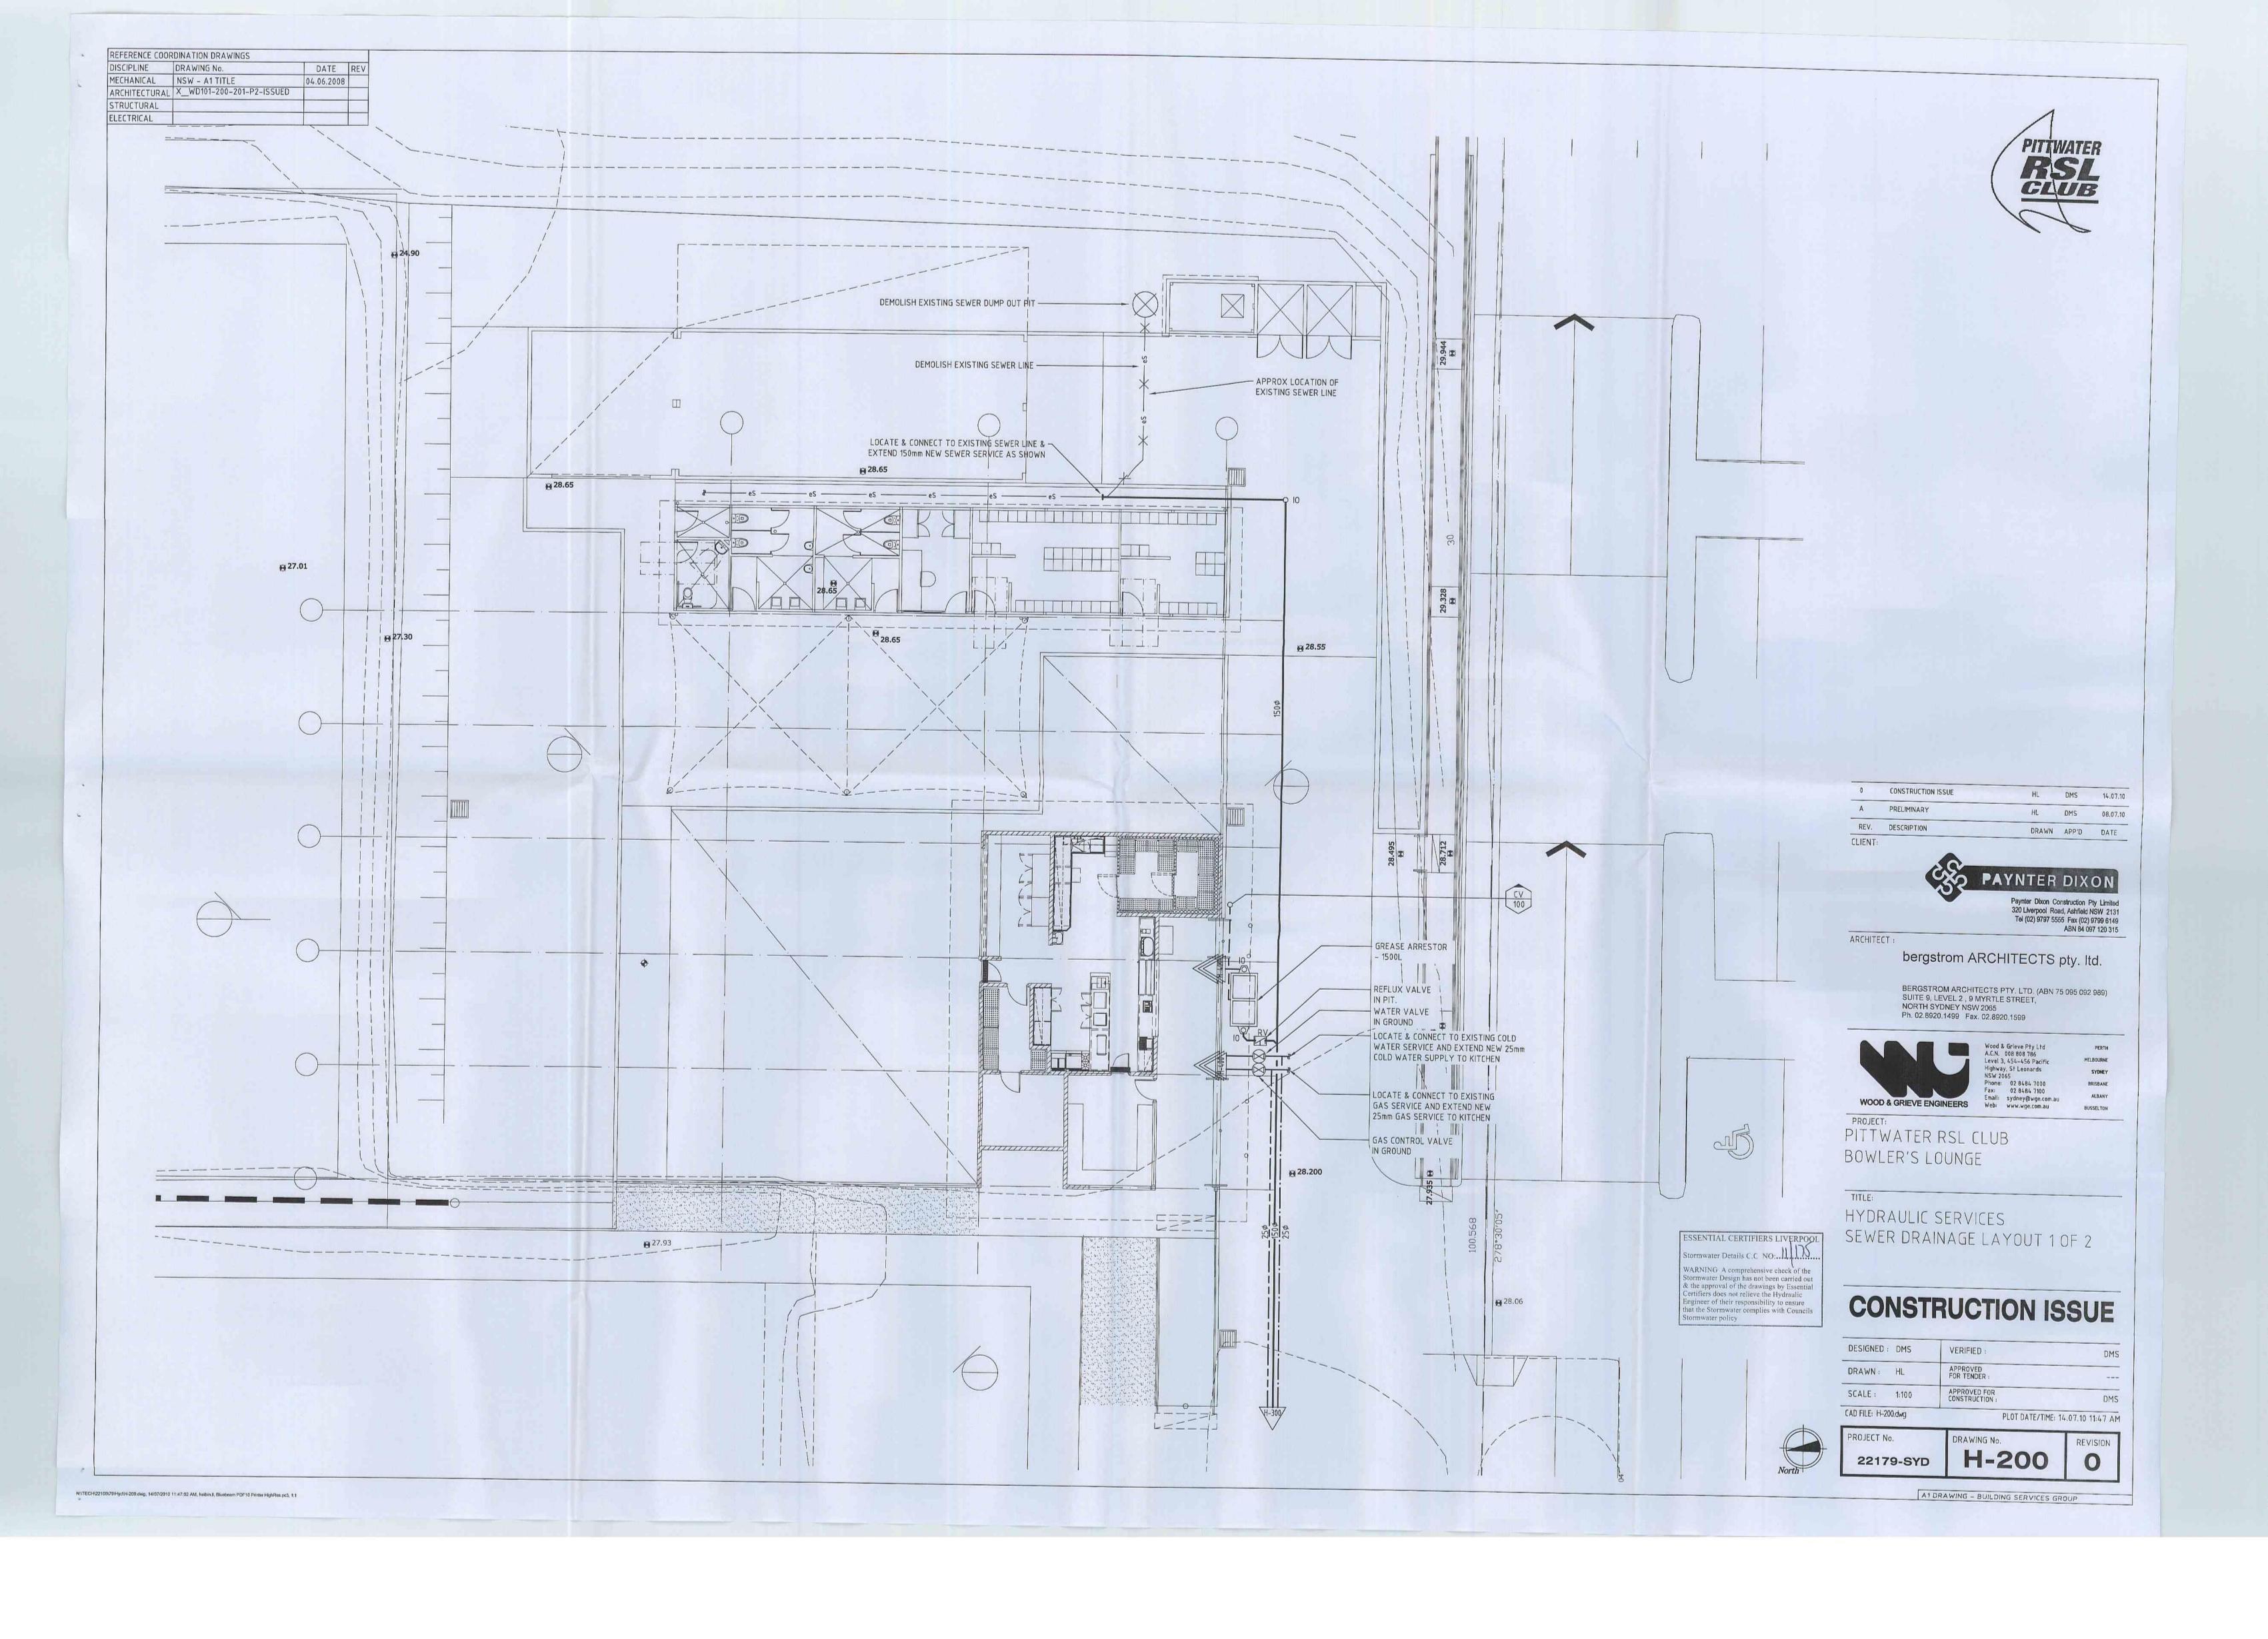


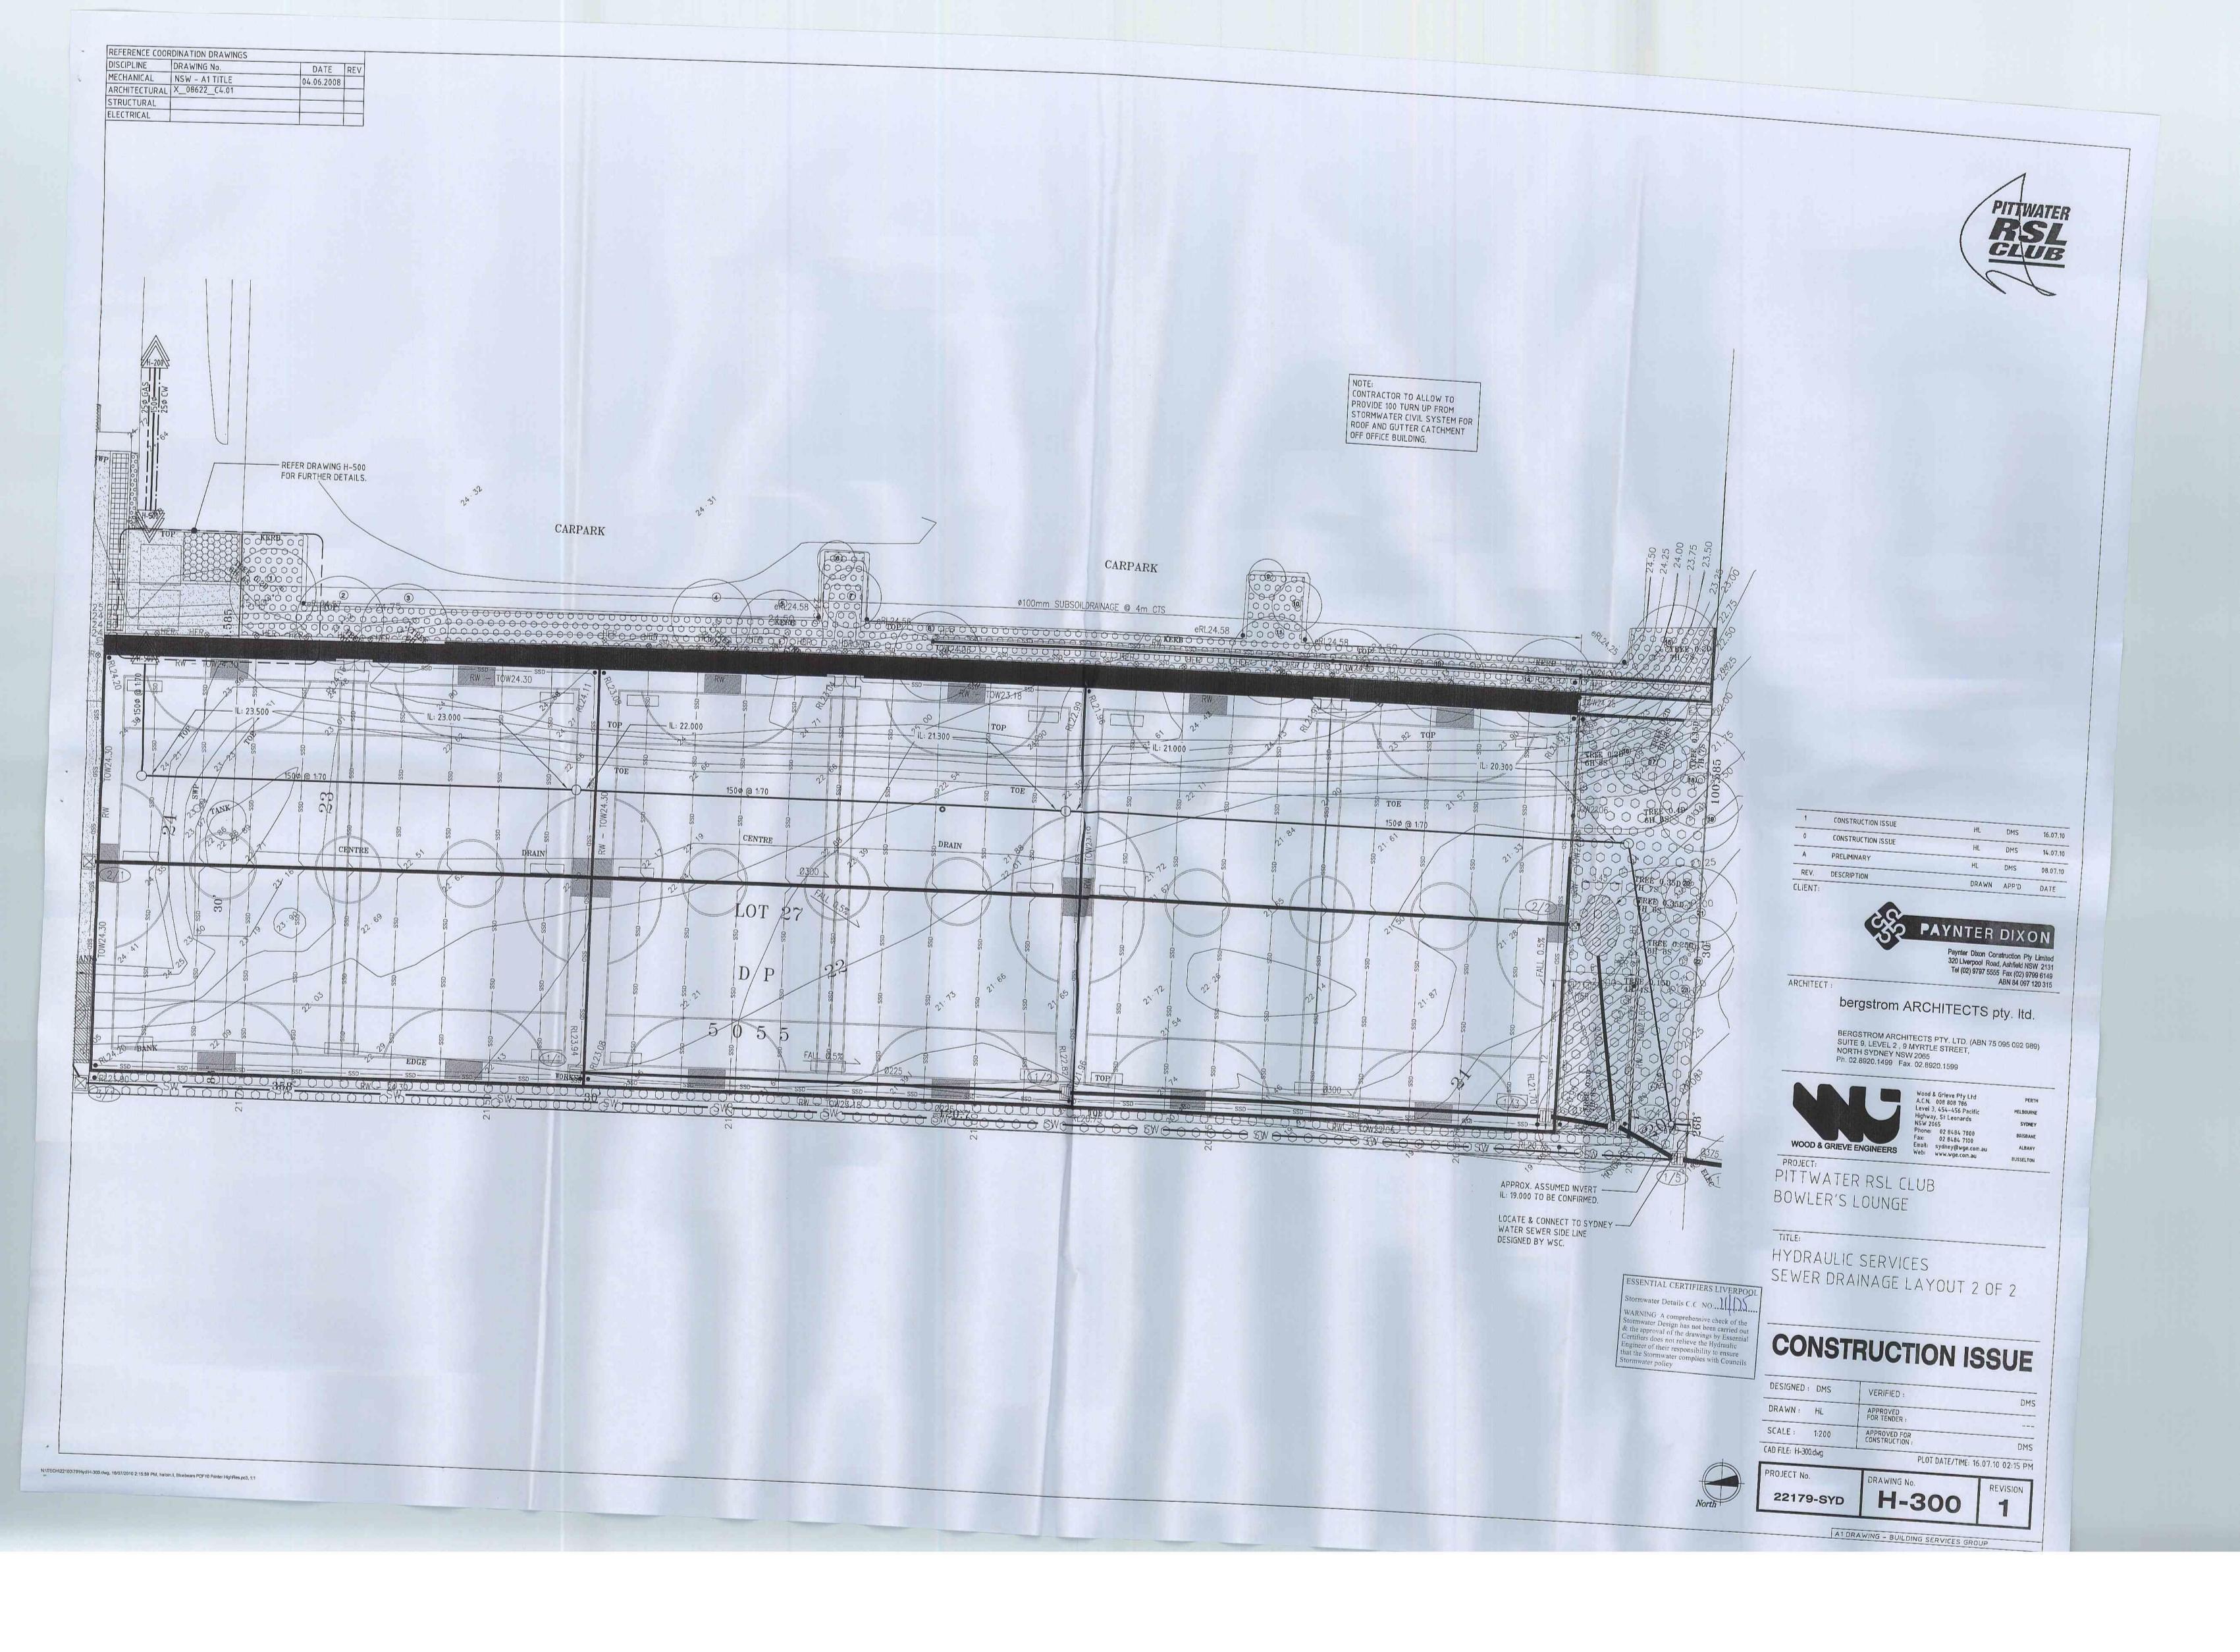

DISCIPLINE	DRAWING No.	DATE	REV
MECHANICAL	NSW - A1 TITLE	04.06.2008	116
ARCHITECTURAL	X_PRL-BC-100-F	04.00.2000	
STRUCTURAL			
ELECTRICAL			

N:IXECFI22100/79/Hyd/H-400.dwg, 14/07/2010 11:40:17 AM, halbin.ll, Bluebeam PDF10 Printer HighRes.pc3, 1:1



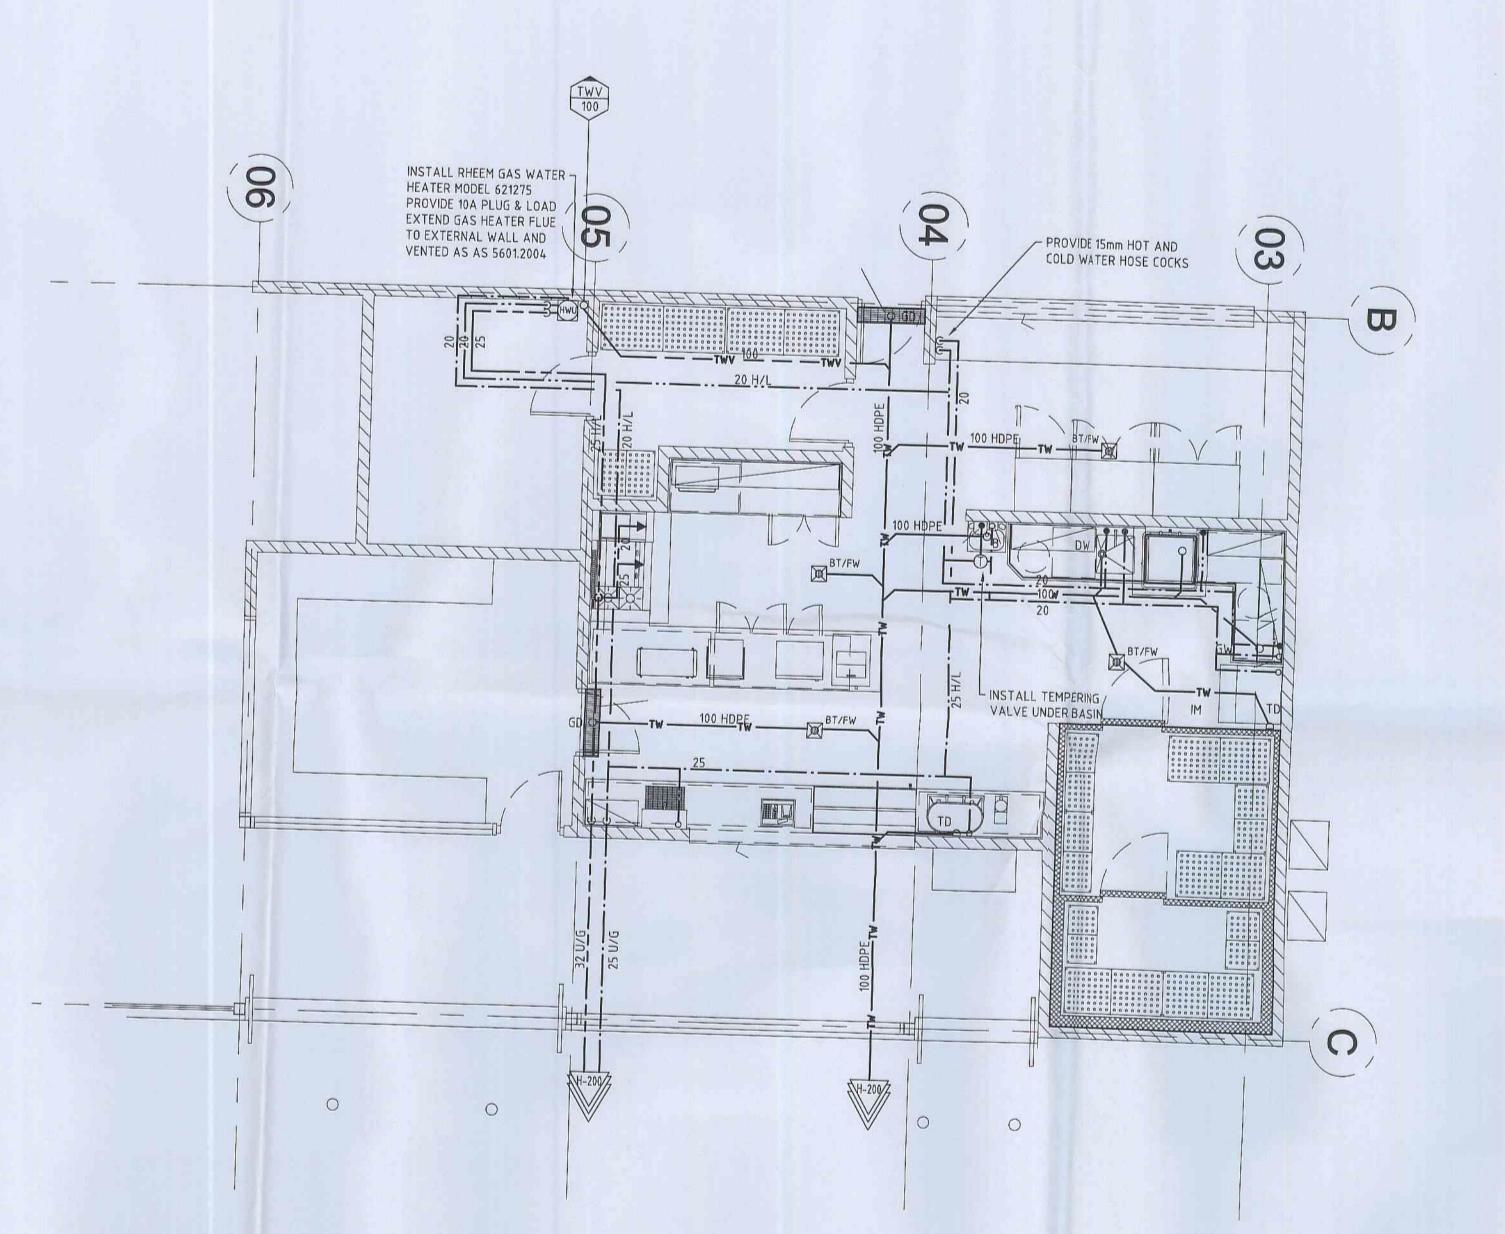

0	CONSTRUCTION ISSUE	HL	DMS	14.07.10
_ A	PRELIMINARY	HL	DMS	08.07.10
REV.	DESCRIPTION	DRAWN	APP'D	
CLIENT:		DRAWN	APP'0	DATE



ARCHITECT : bergstrom ARCHITECTS pty. ltd.

BERGSTROM ARCHITECTS PTY. LTD. (ABN 75 095 092 989) SUITE 9, LEVEL 2, 9 MYRTLE STREET, NORTH SYDNEY NSW 2065 Ph. 02.8920.1499 Fax. 02.8920.1599



PROJECT:
PITTWATER RSL CLUB BOWLER'S LOUNGE

ESSENTIAL CERTIFIERS LIVERPOOL HYDRAULIC SERVICES WARNING A comprehensive check of the Stormwater Design has not been carried out & the approval of the drawings by Essential Certifiers does not relieve the Hydraulic Engineer of their responsibility to ensure that the Stormwater complies with Councils Stormwater policy

COLD & HOT WATER, GAS SANITARY DRAINAGE PLAN


CONSTRUCTION ISSUE

DMS	VERIFIED:	DESIGNED : DMS
	APPROVED FOR TENDER :	DRAWN: HL
DMS	APPROVED FOR CONSTRUCTION:	SCALE: 1:50



REVISION H-400 22179-SYD

A1 DRAWING - BUILDING SERVICES GROUP

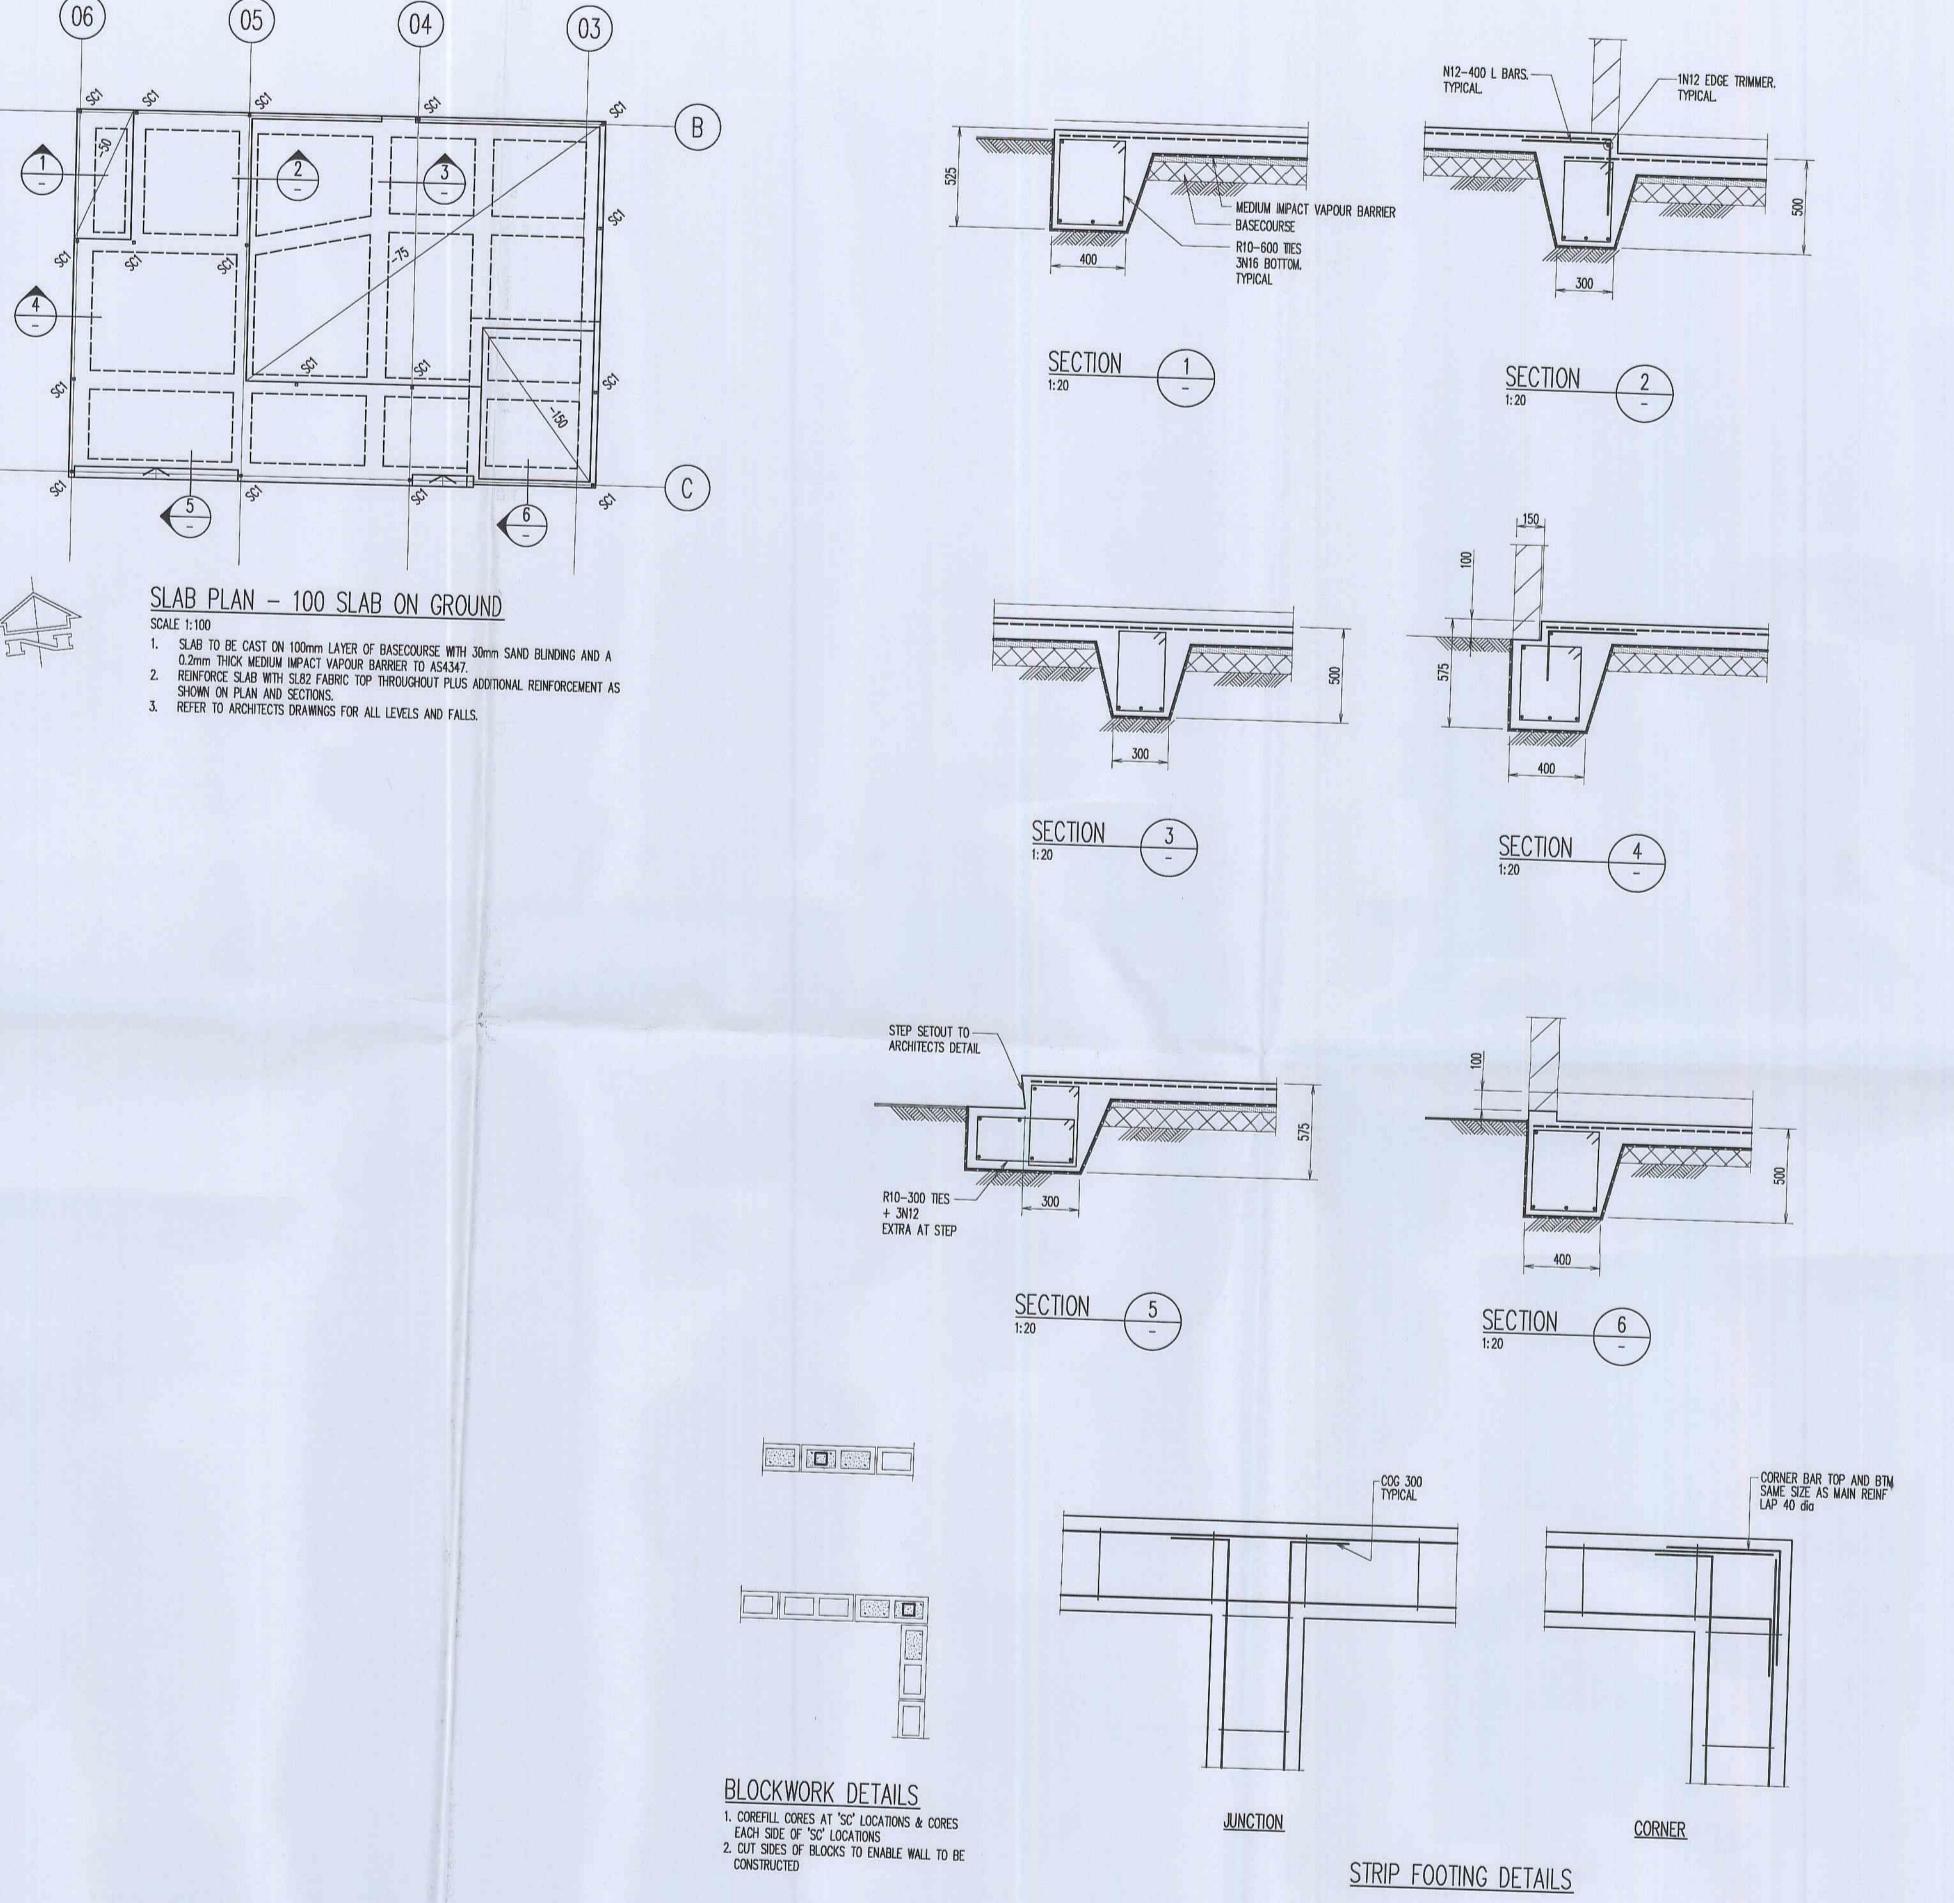

REINFORCEMENT NOTES millimetres of the reinforcement. Slabs - 20 top, 20 bottom, 3. Cover to reinforcement ends to be 50 mm u.n.o. required , Lap 450. U.N.O. bar dia. unless noted otherwise. 7. All cogs to be standard cogs unless noted otherwise. 8. Fabric end and side laps are to be placed strictly in maximum of 3 layers at any location. FABRIC LAPS REINFORCEMENT LEGEND 1. Penotes the extent of area covered by bars. 2. — Denotes a change in bar shape and/or length. 3. B3 Indicates to repeat bars tagged thus B3 etc.
LAY BARS IN DIRECTION INDICATED BY ARROW. 4. Bars shown staggered on plan are to be placed alternately. 5. ALT. denotes bars of different length and/or shape to be laid alternately. 13N16 Indicates 10 bars at 250 centres plus 3 bars placed one per space ABBREVIATIONS USED ON DRAWINGS : U.N.O. - Unless Noted Otherwise E.W. - Each Way N.S.O.P. - Not Shown On Plan E.F. - Each Face N.S.O.E. - Not Shown On Elevation N.F. - Near Face L.V. – Bar Lengths Vary N.T.S. - Not To Scale DOMESTIC/RESIDENTIAL CONSTRUCTION NOTES 3. All earthworks shall be in accordance with the latest edition of

"Guidelines on Earthworks for Commercial and Residential Developments

— AS 3798". 4. All footings and slabs are to comply with the latest edition of the "Residential Slab and Footing Code AS 2870.1" and any special requirements from council. Classification for clay sites shall be obtained from council or geotechnical investigations. 5. Subsoil drains (agricultural drains) shall not be placed adjacent to footings. Excavations for services parallel to the edge of the slub or footing shall not extend below a line drawn at 45 degrees to the horizontal for clay and 30 degrees for sand from the bottom of the edge beam or from the base of bored or bulk piers. All subsoil drains must be installed with consistant falls and to the manufacturers recommendations. All water collected by sub-surface drains must discharge by gravity to stormwater lines or to an approved alternative. Also these drains must have access for flushing silt out for future maintenance and shall comply with local government requirements. 6. All timber framing including bracing shall be constructed in accordance with AS 1684.4 Residential timber—framed construction. Part 4: Simplified — Non-cyclonic areas" unless noted otherwise in the drawings, specifications or timber notes. 7. The building owner is responsible for the building and site maintenance as detailed in the CSIRO pamphlet 10—19 Guide to Home Owners on Foundation Maintenance and Footing Performance. The builder shall give the owner a copy of this document. SLAB ON GROUND NOTES Strip all topsoil from the construction area. All stripped topsoil
is to be removed from the site unless directed otherwise. 2. Before placing fill, proof roll exposed subgrade with 6 passes of a 10 tonne minimum roller to test subgrade and then remove soft spots (areas with more than 3mm movement under roller). Soft spots to be replaced with select fill as per table: SIEVE APERTURE (mm) TO AS1152 PERCENTAGE PASSED (BY MASS) 100 to 30 50 to 15 Plasticity index to be > or = 2% and < or = 15% Non dispersive (a rating of nil as defined by the "dispersion" test AS1289.3.8.1) 3. Compact fill areas and subgrade under buildings and pavements to minimum 98% standard maximum dry density in accordance with AS 1289 5.1.1. Compaction under buildings to extend 2m minimum beyond building footprint.

4. All basecourse material to comply with RTA specification No 3051 and compacted to minimum 98% modified standard dry density in accordance with AS 1289 5.2.1.

centrally over column.

N. Hot rolled ribbed bar grade D500N

grade R250N

R. Plain round bar SL. Square mesh

RL. Rectangular mesh

COUNCIL COPY

TENDER NOTES These drawings are preliminary drawings issued for tender as an indication of the extent of works only. They are not a complete construction set of drawings 2. To determine the full extent of work, these drawings shall be read in conjunction with the architectural drawings and other contract

documents. Allow for all items shown on architectural and other drawings as not all items are shown on the structural drawings. 3. Should any ambiguity, error, omissions, discrepancy, inconsistency or other fault exist or seem to exist in the documents, immediately notify in writing to the Superintendent. 4. Rates shown on the drawings are for the final structure in place and do not allow for any wastage, rolling margins, over supply, fabrication or construction requirements etc.

ISSUE FOR NOT TO BE USED FOR CONSTRUCTION

This drawing is copyright and is the property of TAYLOR THOMSON WHITTING (NSW) Pty Ltd and must not be used without authorisation. GENERAL NOTES 1. Fix reinforcement as shown on drawings. The type and grade is indicated by a symbol as shown below. On the drawings These drawings are for structural purposes only and are to be read in conjunction with the specification, architectural this is followed by a numeral which indicates the size in drawings, other contract documentation and the requirements of the relevant authorities. Verify all setting out dimensions with the Architect.
 Do not obtain dimensions by scaling the structural elements. Should any ambiguity, error, omission, discrepancy, inconsistency or other fault exist or seem to exist in the contract documents, immediately notify in writing to 2. Provide bar supports or spacers to give the following concrete the Superintendent. cover to all reinforcement unless otherwise noted on drawings. 5. Maintain the structure in a stable condition during construction. Temporary bracing/shoring shall be provided by the contractor to keep the structure and 40 when exposed to weather or ground. excavations stable at all times, ensuring that no part of the documented structure becomes overstressed. 4. Provide N12-450 support bars to top reinforcement as For all temporary batters obtain geotechnical engineers recommendations. 5. Maintain cover to all pipes, conduits, reglets, drip grooves etc 6. Laps in reinforcement shall be made only where shown on the All workmanship and materials shall be in accordance with the requirements of current SAA codes and the bylaws, drawings unless otherwise approved. Lap lengths shall be 40 ordinances or other requirements of the relevant building authorities. 7. All work is to be carried out in accordance with all Workcover requirements and occupational health and safety act regulations 8. Construction using these drawings shall not commence until a
Construction Certificate is issued by the Principal Certifying Authority. accordance with the manufacturers requirements to achieve a full tensile lap. Fabric shall be laid so that there is a DESIGN LOADS Floor Loads : Live Load = 3.0 KPa Dead Load = 1.0 KPa -Roof Live Load = 0.25 KPa Wind Loads : VR = 41 m/sWhere R = 500 years Region = A2 Terrain Category = 3 CONCRETE NOTES EXPOSURE CLASSIFICATION: External: B1 Internal: A1 CONCRETE Place concrete of the following characteristic compressive strength f'c as defined in AS 1379. AS 1379 f'c MPa Specified Slump Agg. Size 1. Use Type 'GP' cement, unless otherwise specified. 2. All concrete shall be subject to project assessment and testing to Consolidate by mechanical vibration. Cure all concrete surfaces as directed in the Specification. F.F. - Far Face 4. For all falls in slab, drip grooves, reglets, chamfers etc. refer to Architects drawings and specifications. 5. Unless shown on the drawings, the location of all construction joints shall be submitted to Engineer for review. 6. No holes or chases shall be made in the slab without the approval of the Engineer.
7. Conduits and pipes are to be fixed to the underside of the top For specifications other than those supplied, the contractor shall obtain and use the latest edition of the NATSPEC DOMESTIC specification. 8. Slurry used to lubricate concrete pump lines is not to be used in 2. Termite protection is to be in accordance with the latest edition of Protection of buildings from subterranean termites AS 3660.1". any structural members. 9. All slabs cast on ground require sand blinding with a Concrete 10. (170) Indicates Slab or Band thickness variation. FORMWORK The design, certification, construction and performance of the formwork, falsework and backpropping shall be the responsibility of the contractor. Proposed method of installation and removal of formwork is to be submitted to the superintendent for comment prior to work ESSENTIAL CERTIFIERS LIVERPOOF WARNING: A comprehensive check of the Structural Design has not been carried out & the approval of the drawings by Essential Certifiers does not relieve the Structural Engineer of their responsibility to ensure the structural adequacy of the project. A ISSUED FOR TENDER G.H. GJP 29.07.10 Rev Description Eng Draft Date PITTWATER RSL BOWLERS AMENITIES EXTENSION Sheet Subject SLAB PLAN AND DETAILS 5. Place sand blinding prior to placement of Concrete underlay.

bergstrom ARCHITECTS BERGSTROM ARCHITECTS PTY LTD. ABN: 75 095 092 989 SUITE 9, LEVEL 2, 9 MYRTLE STREET NORTH SYDNEY NSW 2060 PH. (02) 8920 1499 FAX: (02) 8920 1599

> TaylorThomsonWhitting Consulting Engineers


48 Chandos Street St.Leonards NSW 2065 T: +61 2 9439 7288 F: +61 2 9439 3146 twsyd@ttw.com.au Taylor Thomson Whilting (NSW) Pty Ltd. A.C.N. 113 578 377 1:100, 1:20 Job No

S0001

Plot File Created: Jul 29, 2010 - 9:02am

A1 1 2 3 4 5 8 7 8 9 10

091087 B

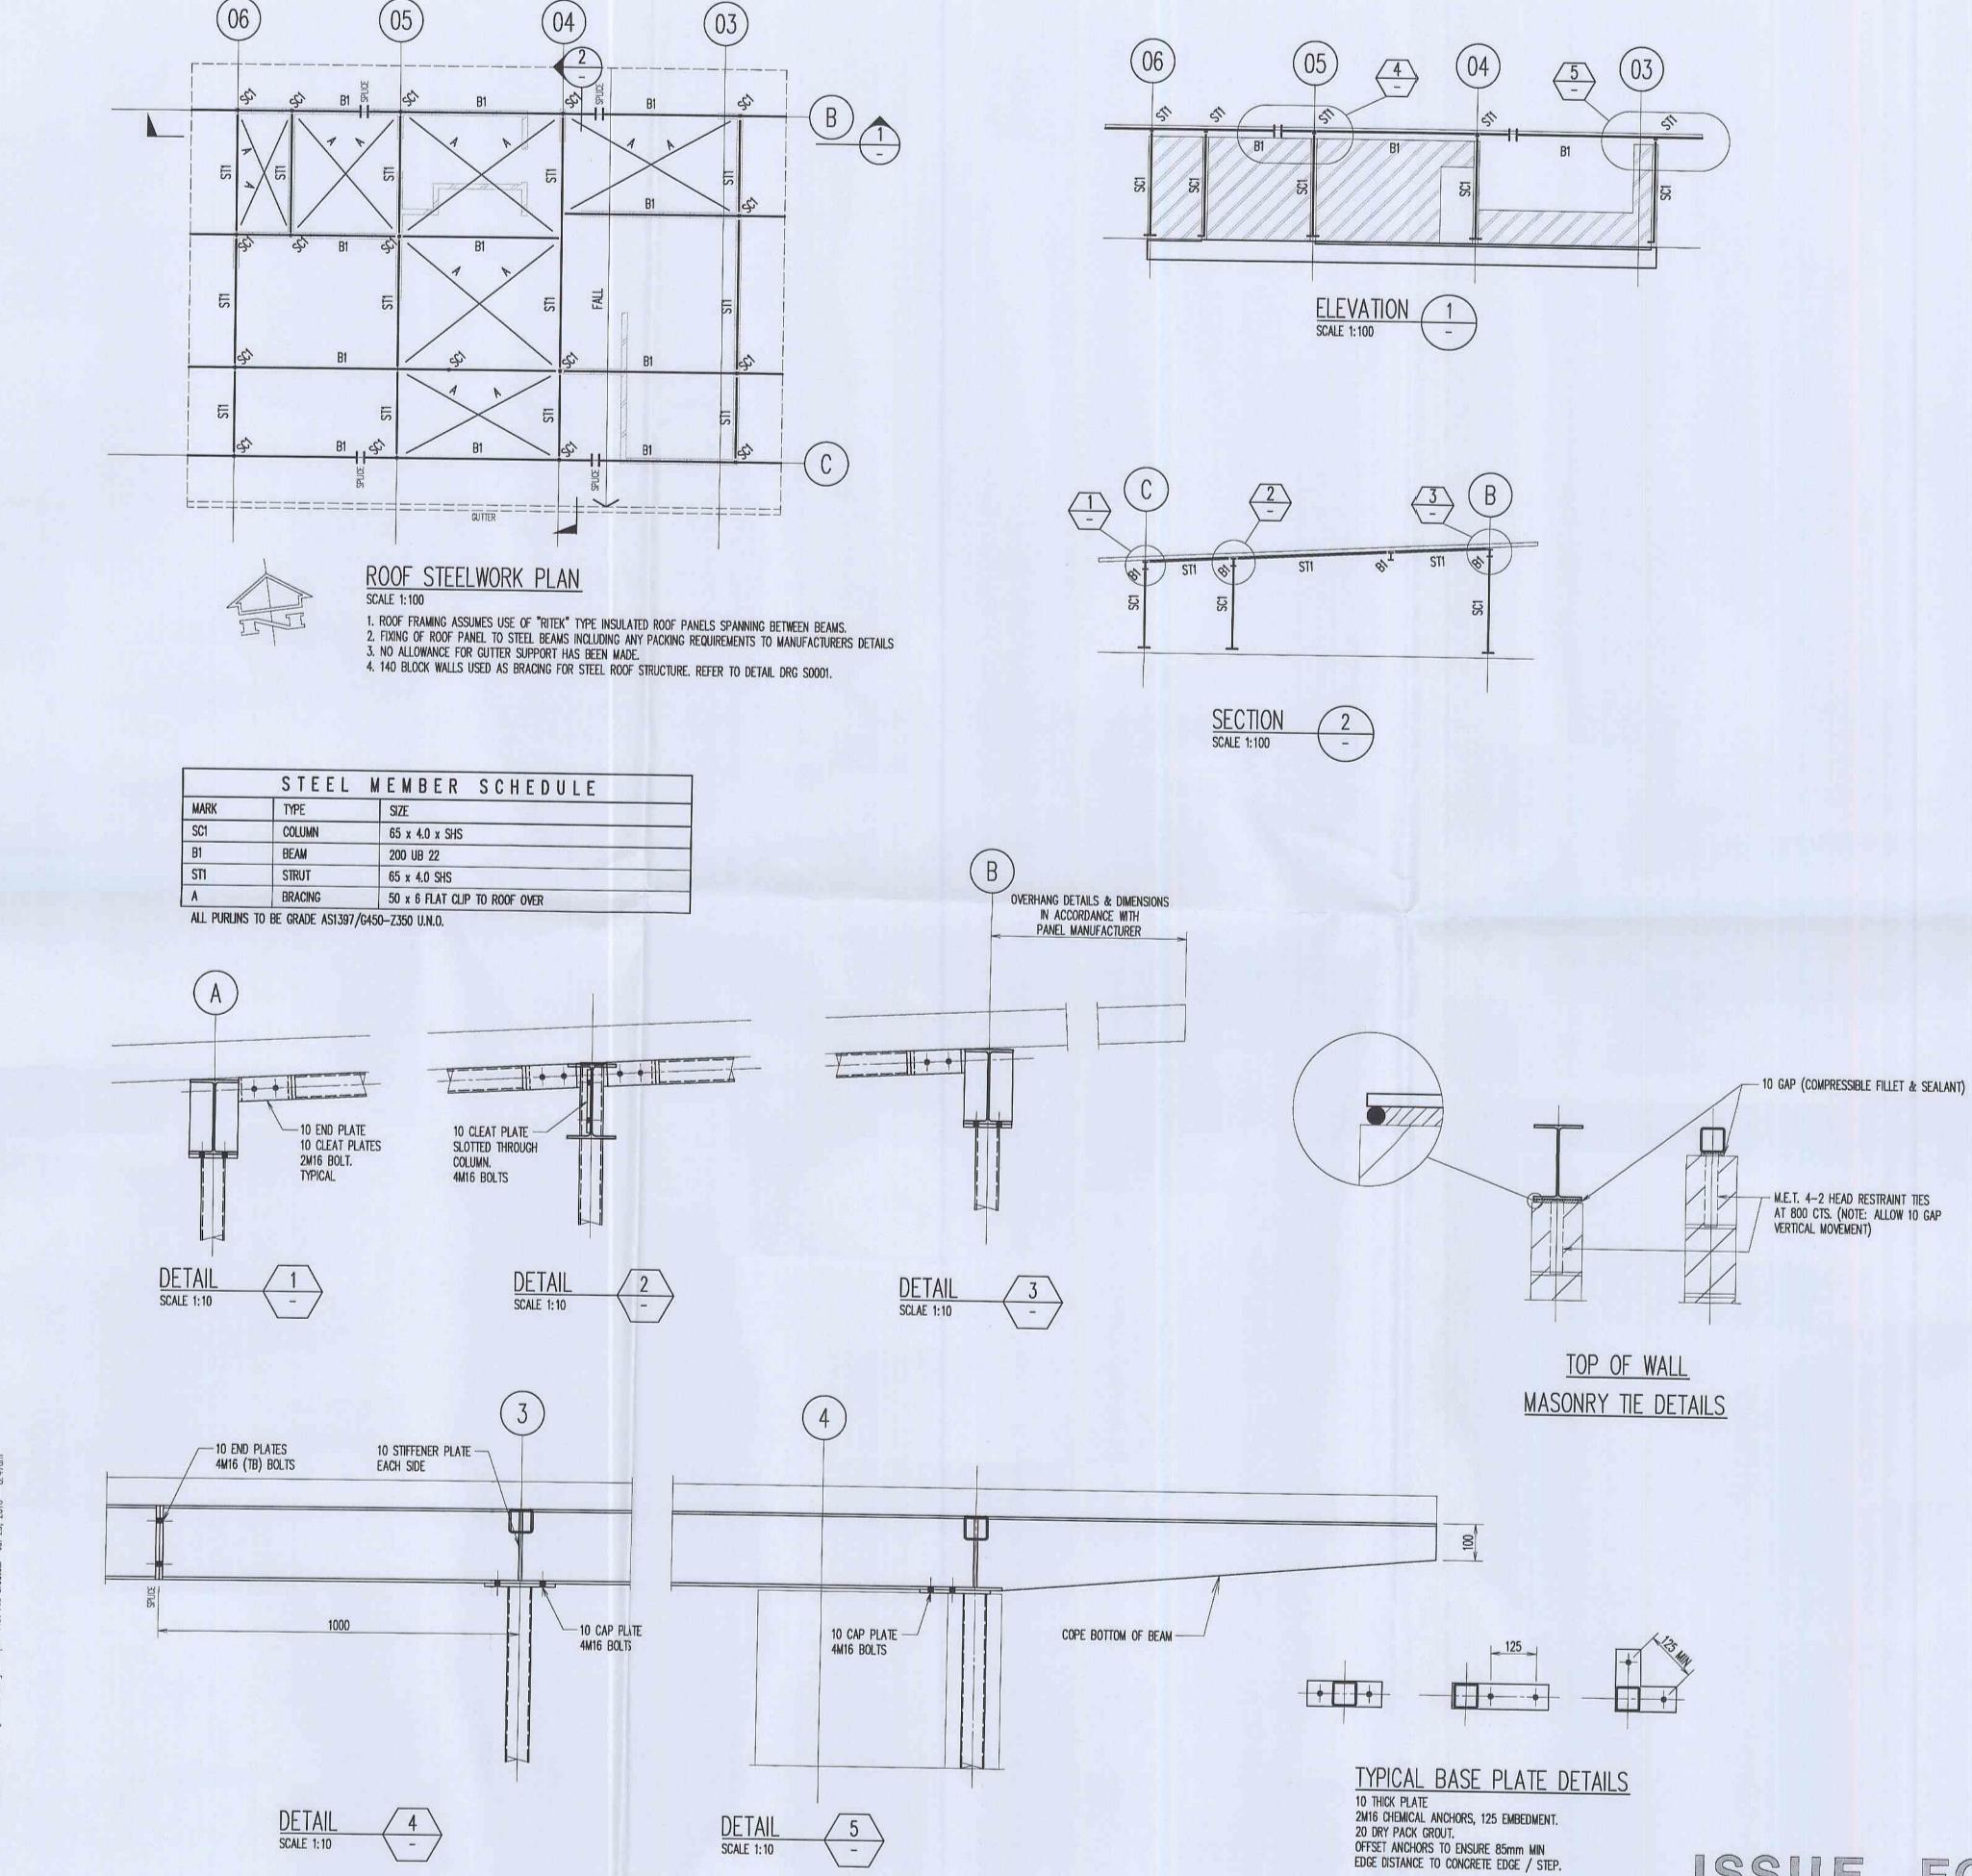

This drawing is copyright and is the property of TAYLOR THOMSON WHITTING (NSW) Pty Ltd and must not be used without authorisation. STRUCTURAL STEELWORK NOTES 1. Unless noted otherwise

(a) Use 10mm thick gusset, fin & end plates welded all round.
(b) All welds 6mm continuous fillet made with E48XX electrode or W50X c) All bolts 20mm dia. (d) All bolts grade 8.8/s. (including purlin / girt bolts)
(e) All holding down bolts are grade 4.6 U.N.O
(f) All bolts, including holding down bolts are to be hot dip galvanized. All fillet welds to be category GP. (h) Butt weld all flanges at end plates and at all mitre cuts. Gussets to end plates to be butt welded. All butt welds shall be full penetration, grade SP. (i) All connections to have a minimum of 2 bolts.
(j) Studs fabricated to AS1554.2

All shear studs (composite slab to steel) grade 410 MPa.
All threaded studs (steel to steel) grade 380 MPa.
(k) Turnbuckles to be quality grade 'S' to AS2319 2. Bolting categories are identified on the drawings in the following

4.6/S Commercial bolts of grade 4.6 snug tightened. 8.8/S
8.8/TB high strength bolts of grade 8.8 snug tightened.
high strength bolts of grade 8.8 snug tightened.
high strength bolts of grade 8.8 fully tensioned to AS4100 as a bearing type joint high strength bolts of grade 8.8 fully tensioned to AS4100 as a friction type joint with faying surfaces

Note: Grade 8.8 bolts are NOT to be welded Chip all welds free of slag.
 Contractor is to confirm with Architect as to where exposed welds are to be ground flush / smooth Provide temporary bracing to maintain stability of steelwork during construction

 Do not grout under base plates until first level steelwork is plumb and fixed by welding or bolting.
 Submit all shop drawings to the Superintendent before commencing to the superintendent before commencing to the superintendent before commencing. Unless noted otherwise, the fixing of purlins, girts, bridging, sheeting and any other component shall be in accordance with the Manufacturer's specification and recommendations.

STEELWORK FINISHES - COMPLYING WITH AS/NZS 2312.1 Concrete Encased steelwork Do not prime.

Internal Non decorative — Category C 75 microns of Zinc rich epoxy External Decorative — Category C 75 microns of Zinc rich epoxy 200 microns of High—Build Epoxy MIO 75 microns of High Solids Polyurethane

EXTERNAL — Category D and steel in contact with masonry and concrete (HDG600) Hot dip galvanize — 600g/m2

ESSENTIAL CERTIFIERS LIVERPOO Structural Details C.C. No: WARNING: A comprehensive check of the Structural Design has not been carried out & the approval of the drawings by Essential Certiflers does not relieve the Structural Engineer of their responsibility to ensure the structural adequacy of the project. A ISSUED FOR TENDER

G.H. G.J.P 29.07.10

Eng Draft Date

PITTWATER RSL BOWLERS AMENITIES EXTENSION

Sheet Subject ROOF STEELWORK PLAN & DETAILS

bergstrom ARCHITECTS BERGSTROM ARCHITECTS PTY LTD. ABN: 75 095 092 989 SUITE 9, LEVEL 2, 9 MYRTLE STREET NORTH SYDNEY NSW 2060 PH. (02) 8920 1499

Rev Description

TaylorThomsonWhitting

Consulting Engineers 48 Chandos Street St.Leonards NSW 2065 T: +61 2 9439 7288 F: +61 2 9439 3146 ttwsyd@ttw.com.au Taylor Thomson Whitting (NSW) Pty Ltd A.C.N. 113 578 377

Authorised

1:100, 1:10

FAX: (02) 8920 1599

Drawing No Revision 091087 B S0002 Plot File Created: Jul 29, 2010 - 8:47am

TENDER NOTES

These drawings are preliminary drawings issued for tender as an indication of the extent of works only. They are not a complete construction set of drawings


2. To determine the full extent of work, these drawings shall be read in conjunction with the architectural drawings and other contract documents. Allow for all items shown on architectural and other drawings as not all items are shown on the structural drawings. Should any ambiguity, error, omissions, discrepancy, inconsistency or other fault exist or seem to exist in the documents, immediately notify in writing to the Superintendent.

Rates shown on the drawings are for the final structure in place and do not allow for any wastage, rolling margins, over supply, fabrication or construction requirements etc.

ISSUE FOR NOT TO BE USED FOR CONSTRUCTION

A1 0 1 2 3 4 5 6 7 8 9 10

MECHANICAL SERVICES

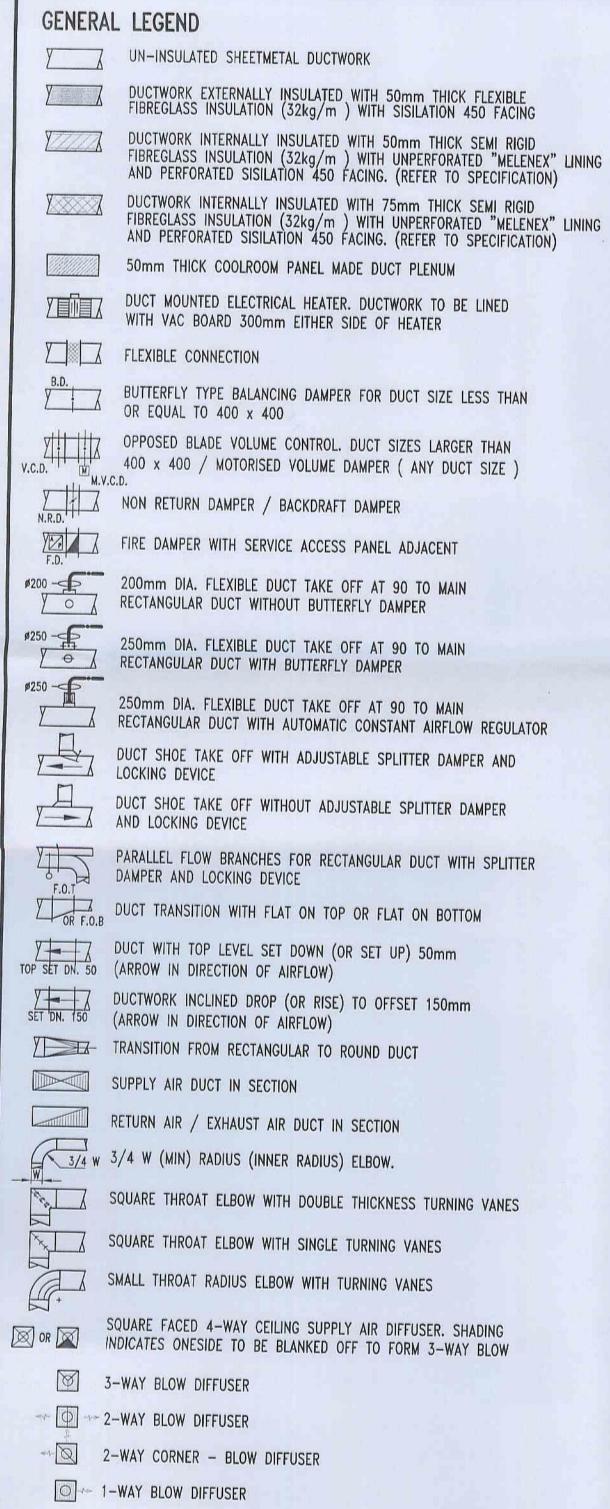

CIRCULAR DIFFUSER

FLEX. DUCT CONNECTED TOILET EXHAUST GRILLE,

SQUARE CEILING RELIEF AIR GRILLE

SMOKE EXHAUST, GRILLE OR RETURN AIR GRILLE

ACCESS PANEL IN FALSE CEILING, BY BUILDER

A/C CONTROL / SWITCH PANEL (WALL / FLOOR MOUNTED) (MCC)
POSITION OF TEMPERATURE SENSOR (1500 ABOVE FLOOR LEVEL)

● A/O/M POSITION OF AUTO / OFF / MANUAL SWITCH (1500 ABOVE FLOOR LEVEL)

DOOR WITH DOOR GRILLE AT LOW LEVEL

25mm UNDERCUT DOOR BY BUILDER INSULATED / ACOUSTIC FLEX

✓ ✓ UN-INSULATED FLEX


GENERAL NOTES

- 1 ALL DUCT DIMENSIONS ARE CLEAR AIRWAY SIZES.
- NOMINAL DUCT LENGTHS SHOWN ON DRAWINGS. ADJUSTMENT OF DUCT LENGTHS TO SUIT ALTERNATIVE CONSTRUCTION TO BE MADE BY DUCTWORK MANUFACTURER.
- 3 ALL DIMENSIONS AND DETAILS TO BE SITE MEASURED AND VERIFIED BEFORE
- 4 PAINT MATT BLACK ALL SHEETMETAL, FLEXIBLE DUCTWORK AND INSULATION VISIBLE THROUGH OUTLETS.
- ALL EQUIPMENT TO BE MOUNTED ON SUITABLE SUPPORTS OR PLINTHS ETC.
- ALL CONDENSATE DRAINS & DRAINS FROM SAFETY DRIP TRAY TO BE PIPED TO TRAPPED DRAIN POINTS.
- 7 SEAL AROUND OUTLETS INSTALLED DIRECTLY ONTO SHEETMETAL DUCTWORK USING "NO MORE GAPS" OR SIMILAR SEALANT.
- DOUBLE THICKNESS TURNING VANES TO BE INSTALLED IN ALL SQUARE BENDS UNLESS OTHERWISE NOTED. VANES IN DUCTWORK INTERNALLY INSULATED TO BE FABRICATED FROM PERFORATED METAL WITH INSULATION FILL.
- ALL SHEETMETAL DUCTWORK & FLEX. DUCT TO COMPLY WITH AS:4254 2002.
- 10 ENSURE ALL DUCTWORK, PIPEWORK AND CONDUIT ARE CLEAR OF ACCESS
- 11 ALL SETOUT DIMENSIONS AND THROAT RADII ETC. ARE WORKED OFF SHEETMETAL SIZES AND NOT AIRWAY SIZES.
- 12 ALL INTERNALLY INSULATED DUCTWORK TO BE ONE GAUGE HEAVIER THAN THE STANDARD FOR APPLICABLE SIZE. KITCHEN EXHAUST DUCTWORK TO BE FABRICATED FROM MINIMUM 1.2mm THICK SHEETMETAL.
- 13 SEAL OFF ALL GAPS AROUND FILTERS BY BLANKING PANEL INSIDE FILTER MIXING PLENUM BOX.
- 14 ALL DUCTWORK TO BE CO-ORDINATED WITH EXISTING STRUCTURAL, HYDRAULIC, AND ELECTRICAL SERVICES IN CEILING SPACES.
- 15 THE MECHANICAL CONTRACTOR TO VERIFY ALL DIMENSIONS AND LEVELS ON SITE PRIOR TO THE COMMENCEMENT OF SHOP DRAWINGS AND FABRICATION OF FITTINGS.
- 16 ANY ERRORS, OMMISIONS OR DISCREPANCIES BETWEEN DRAWINGS & SPECIFICATIONS ARE TO BE REPORTED TO THE CONSULTANT. 17 DIMENSIONS AND SET OUT OF ALL EQUIPMENT AND PLATFORM SHOWN ARE PRELIMINARY
- AND FOR REFERENCE ONLY. FINAL DETAIL TO BE CONFIRMED BY MECHANICAL CONTRACTOR PRIOR TO INSTALLATION/CONSTRUCTION. 18 ACCESS PANELS IN PLASTERBOARD CEILING WHERE NECCESSARY TO BE PROVIDED BY
- BUILDER FOR SERVICES ACCESS TO DUCTWORK & AIR BALANCE OF SYSTEM. QUANTITY & EXACT LOCATION TO BE CONFIRMED ON SITE WITH PROJECT MANAGER
- 19 FAN EXTERNAL STATIC PRESSURES, FAN MOTOR SIZES, PUMP HEAD & PUMP MOTOR SIZES. LISTED IN ANY EQUIPMENT SCHEDULES ARE INDICATIVE ONLY FOR TENDER PURPOSES. FINAL FIGURES TO BE CHECKED AND VERIFIED BY THE MECHANICAL CONTRACTOR TO SUIT PURCHASED EQUIPMENT AND APPROVE BY MECHANICAL CONSULTANT.
- 20 ALL MOTORS AND CONTROL DEVICES FOR OUTDOOR APPLICATION TO BE WATER-PROOF AND WEATHER-PROOF TYPE CONSTRUCTION OR WATER / WEATHERPROOF COVERED.
- 21 THE MECHANICAL CONTRACTOR IS TO ALLOW FOR ALL ADDITIONAL BALANCING DAMPERS FOR DUCTWORK SYSTEMS AS REQUIRED TO EFFECTIVELY BALANCE THE SYSTEM.
- 22 SUPPLY AIR QUANTITY OF EACH OUTLET FROM EXISTING SUPPLY AIR DISTRIBUTION SYSTEM WHERE APLICABLE TO BE CHECKED AND CONFIRMED BY MECHANICAL CONTRACTOR PRIOR TO COMMENCEMENT OF MODIFICATION WORK AND TO BE PROPORTIONALLY RE-BALANCED ON COMPLETION.
- 23 ALL DUCT JOINTS OF DUCTWORK FOR OUTDOOR APLICATION TO BE SEALED WATER PROOF. DUCTWORK TO BE EXTERNALLY OR INTERNALLY RE-INFORCED, BEADING OR CROSS BREAKING TO PREVENT WATER POOLING ON THE SURFACE OF DUCTWORK. ALL HARDWARE FOR OUTDOOR DUCT SYSTEM, EG. BOLTS/NUTS, SASH CATCHES, HINGES ETC. TO BE BRASS OR ANTI-CORROSION TYPE.


FAN SCHEDULE

KEF-1
ROOF
G/F KITCHEN / CANTEEN
1120
300
HERITAGE CENTRIFUGAL VERTICAL
EXHAUST ROOF UNIT
FANTECH OR EQUAL
CHD556 OR EQUAL
DIRECT
0.55
415 / 3 / 1.8
960
STANDARD
55 55
56
30


* Static pressures indicated are for TENDER purposes only. Final figures to be checked & verified by Mech. contractor & approved by Mech. consultant.

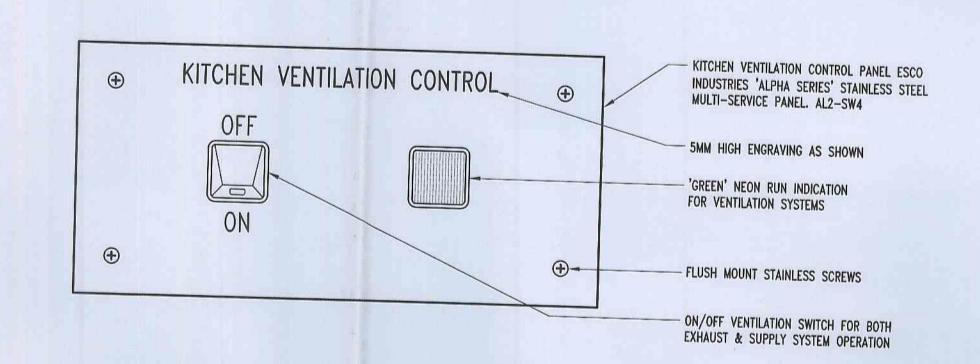

KITCHEN VENTILATION CONTROL PANEL DETAIL

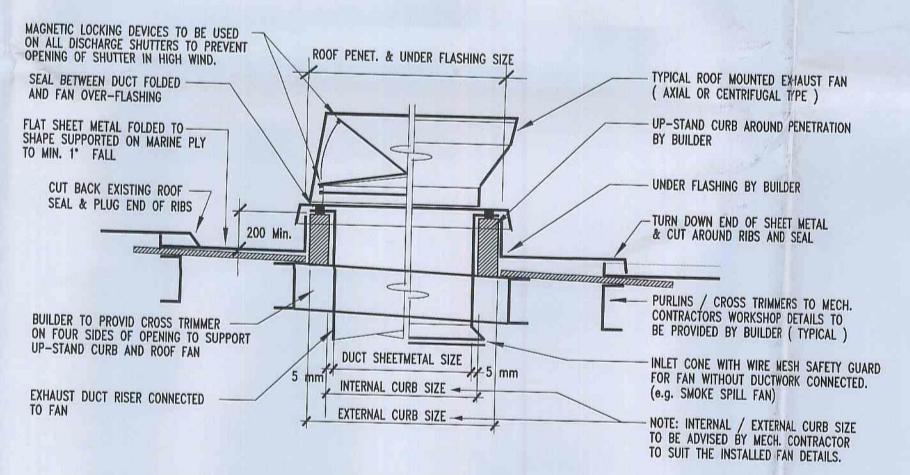

TYPICAL DETAIL OF ROOF PENETRATION AND UP-STAND CURB FOR ROOF MOUNTED FANS

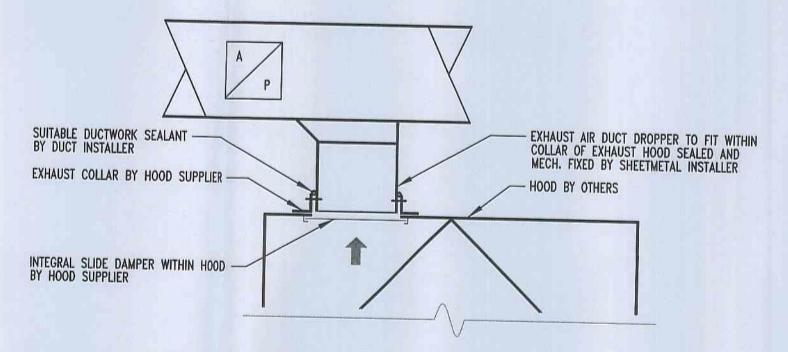

TYPICAL DETAIL OF EXHAUST DUCT CONNECTION TO KITCHEN EXHAUST HOOD


DESCRIPTION OF WORKS

- SUPPLY AND INSTALL KITCHEN EXHAUST FAN AS DETAILED - SUPPLY AND INSTALL SHEETMETAL DUCTWORK SYSTEM AS DETAILED
- SUPPLY AND INSTALL MANUAL CONTROLS AS INDICATED

WORK BY OTHERS


- DESIGN, SUPPLY AND INSTALL 2 OFF KITCHEN EXHAUST HOODS
- WIRING OF KITCHEN EXHAUST FAN FROM SWITCHBOARD BY OTHERS
- ROOF PENETATION & SUPPORT OF ROOF FAN



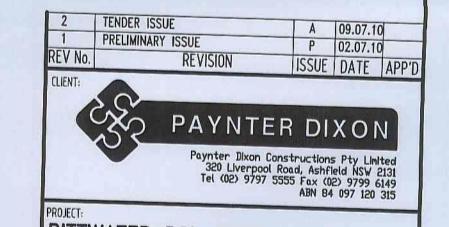


PITTWATER RSL CLUB BOWLER'S AREA KITCHEN 80-82 MONA VALE RD MONA VALE, NSW 2103 ALTERATIONS AND ADDITIONS TO EXISTING PREMISES




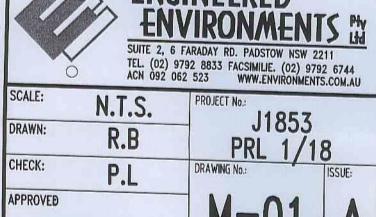

JUN '10

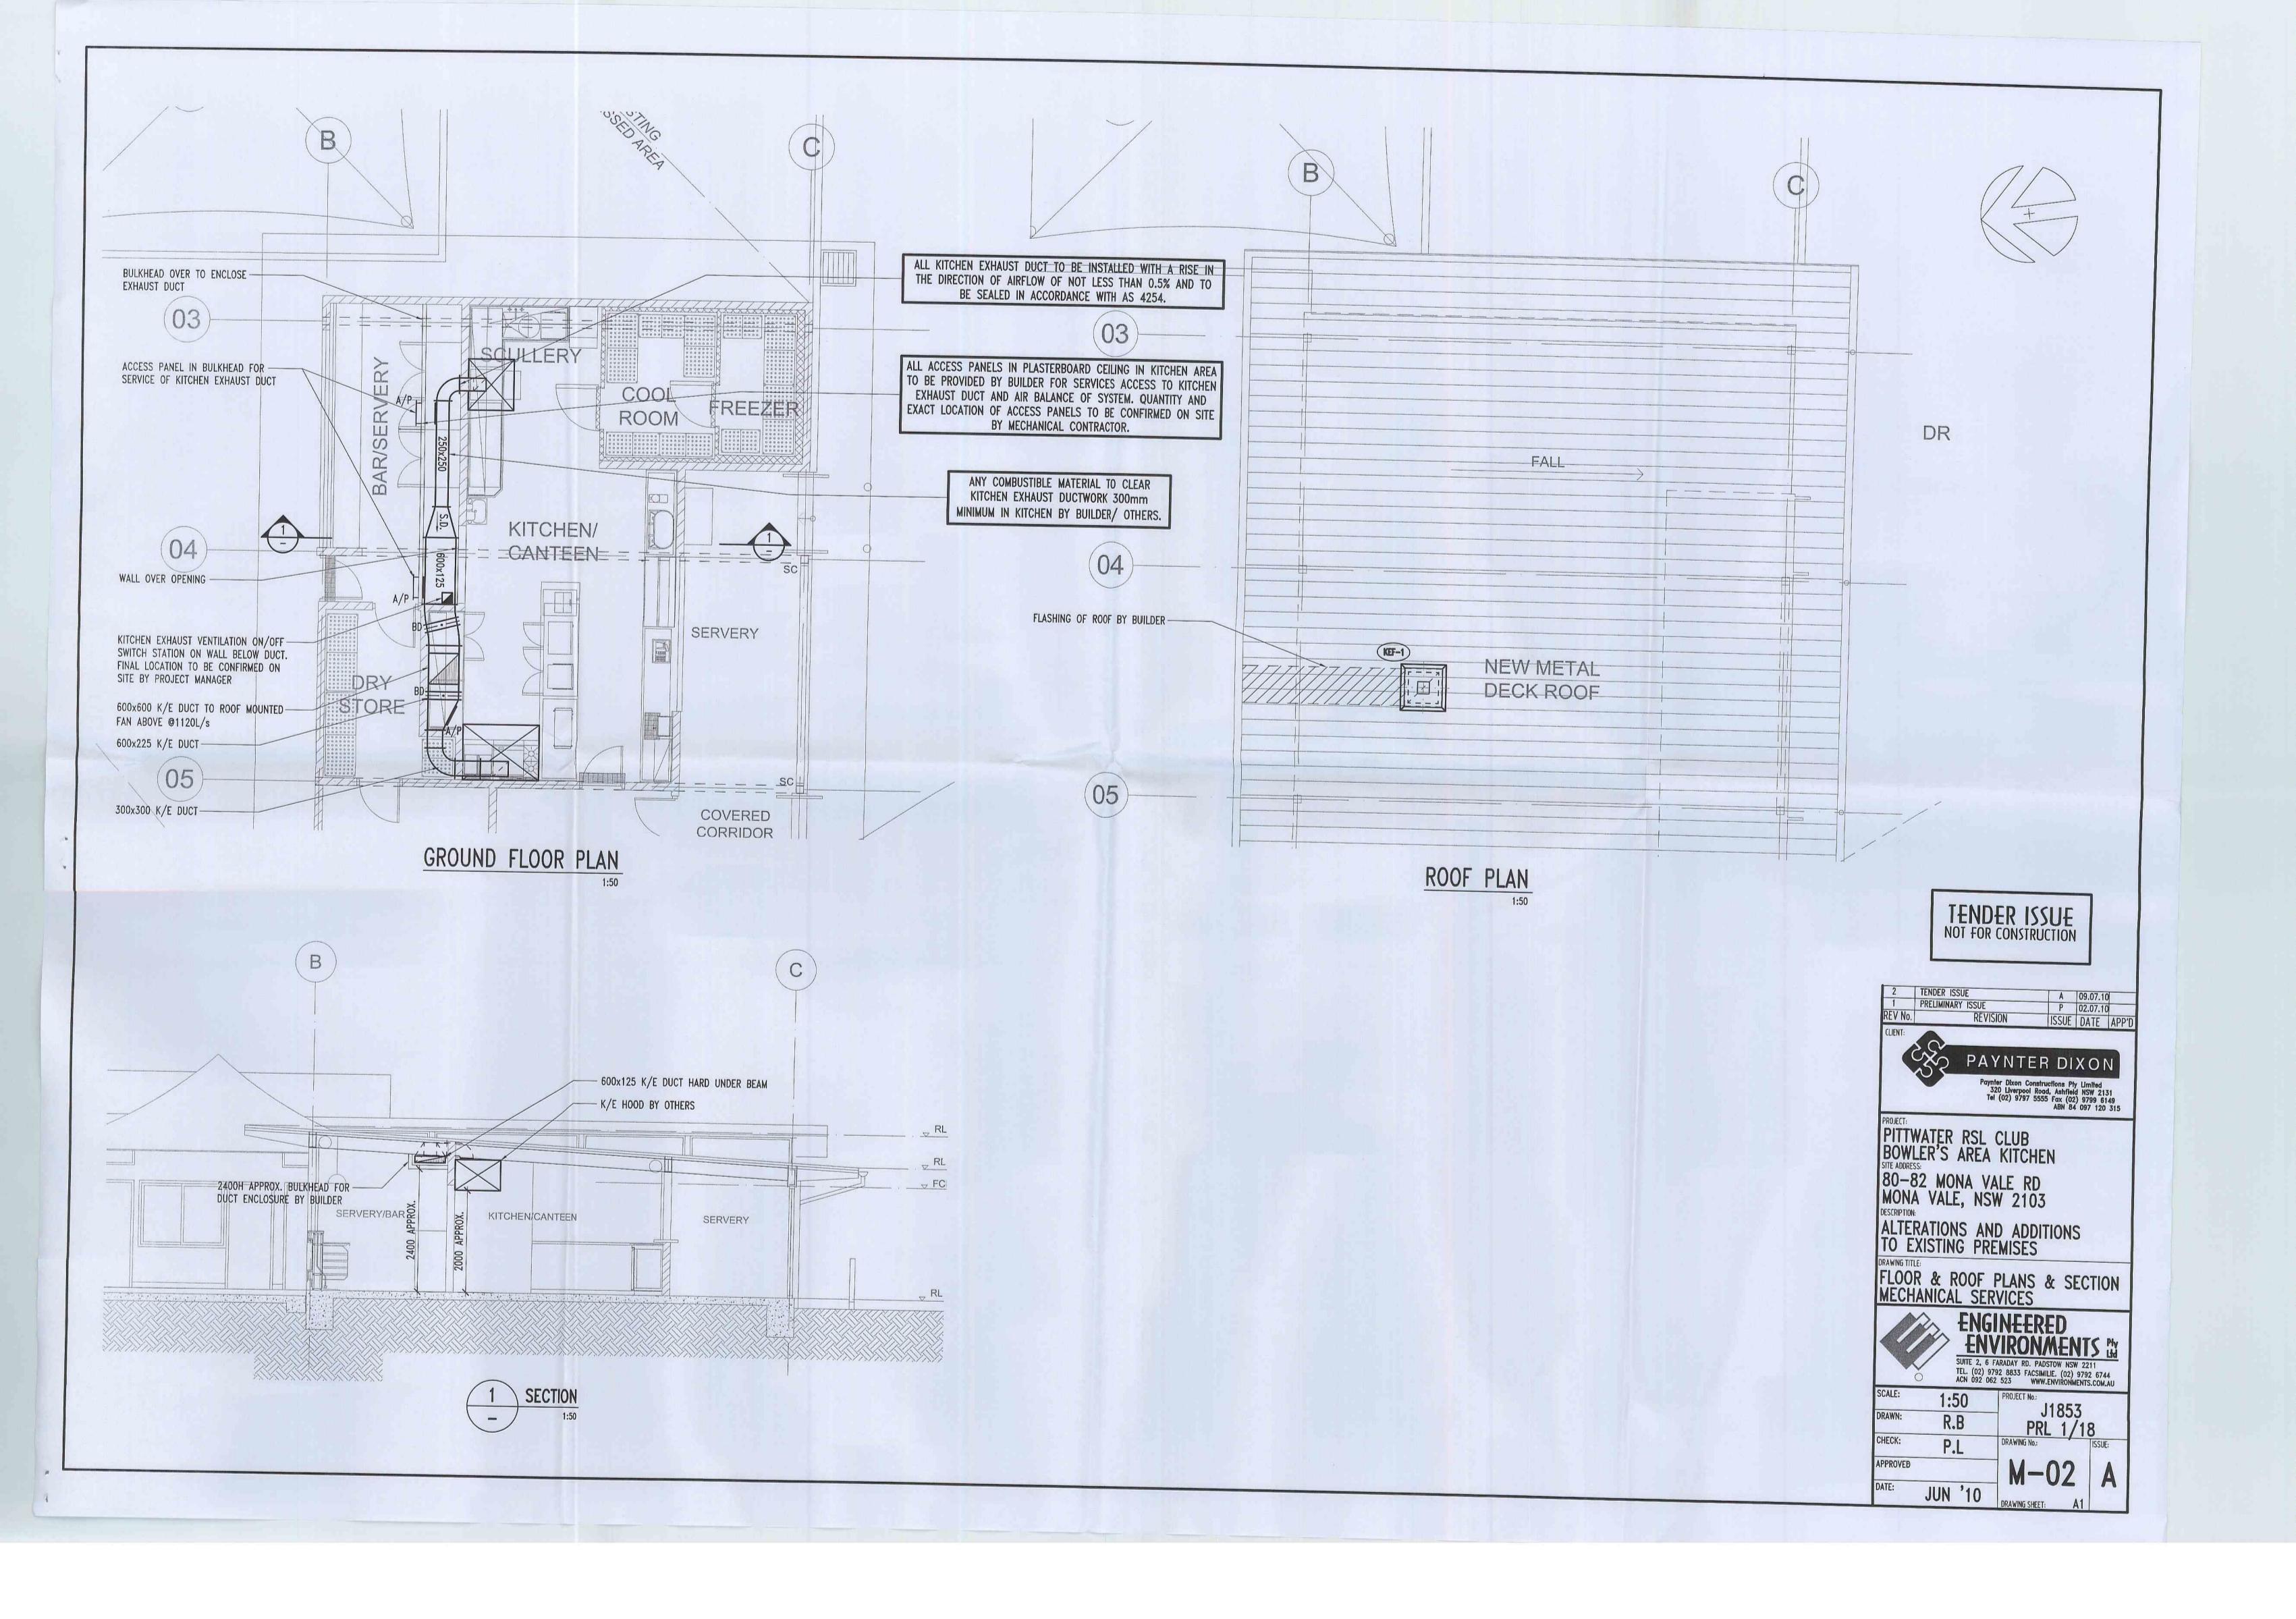

REFERENCE DOCUMENT REGISTER DRAWING No. REVISION OR DATE ARCH HYDRAULIC MECH INTERIOR DESIGN KITCHEN/BAR OTHER General lighting - Letter denotes discrete type - refer to separate luminaire schedule for details Fluorescent enclosed - nom. 1200 long Fluorescent enclosed - nom. 600 long Mains voltage light Wall mounted - check architects elevation drawing for mounting Q A Q A details. Height shown on electrical drawing are nominal only and are to be considered above finished floor level to top of luminaire unless stated otherwise. **Emergency lighting** Emergency light tungsten halogen Emergency light - fluorescent - nom. 1200 long Emergency light - fluorescent - nom, 600 long Emergency light - fluorescent - nom. 300 long Exit sign — single sided — Pictogram only — bar indicates face with pictogram Exit sign - single sided - Pictogram with right arrow - bar indicates face with pictogram Exit sign — single sided — Pictogram with left arrow - bar indicates face with pictogram Exit sign - double sided - Pictogram only Exit sign - double sided - Pictogram with right arrow Exit sign - double sided - Pictogram with left arrow Switching

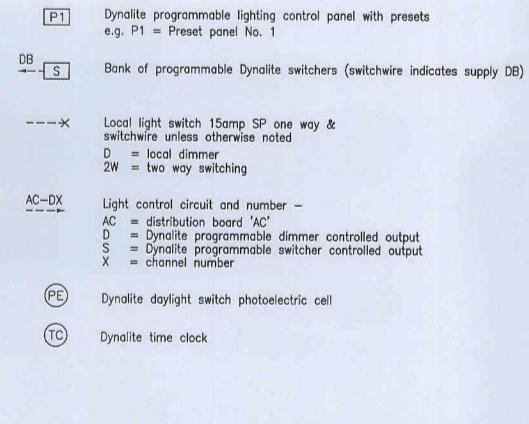


10m SCALE 1:100 @ A1


5m SCALE 1:50 @ A1

10m 5m

Pittwater RSL Club Bowler's Lounge Amenities

Legend

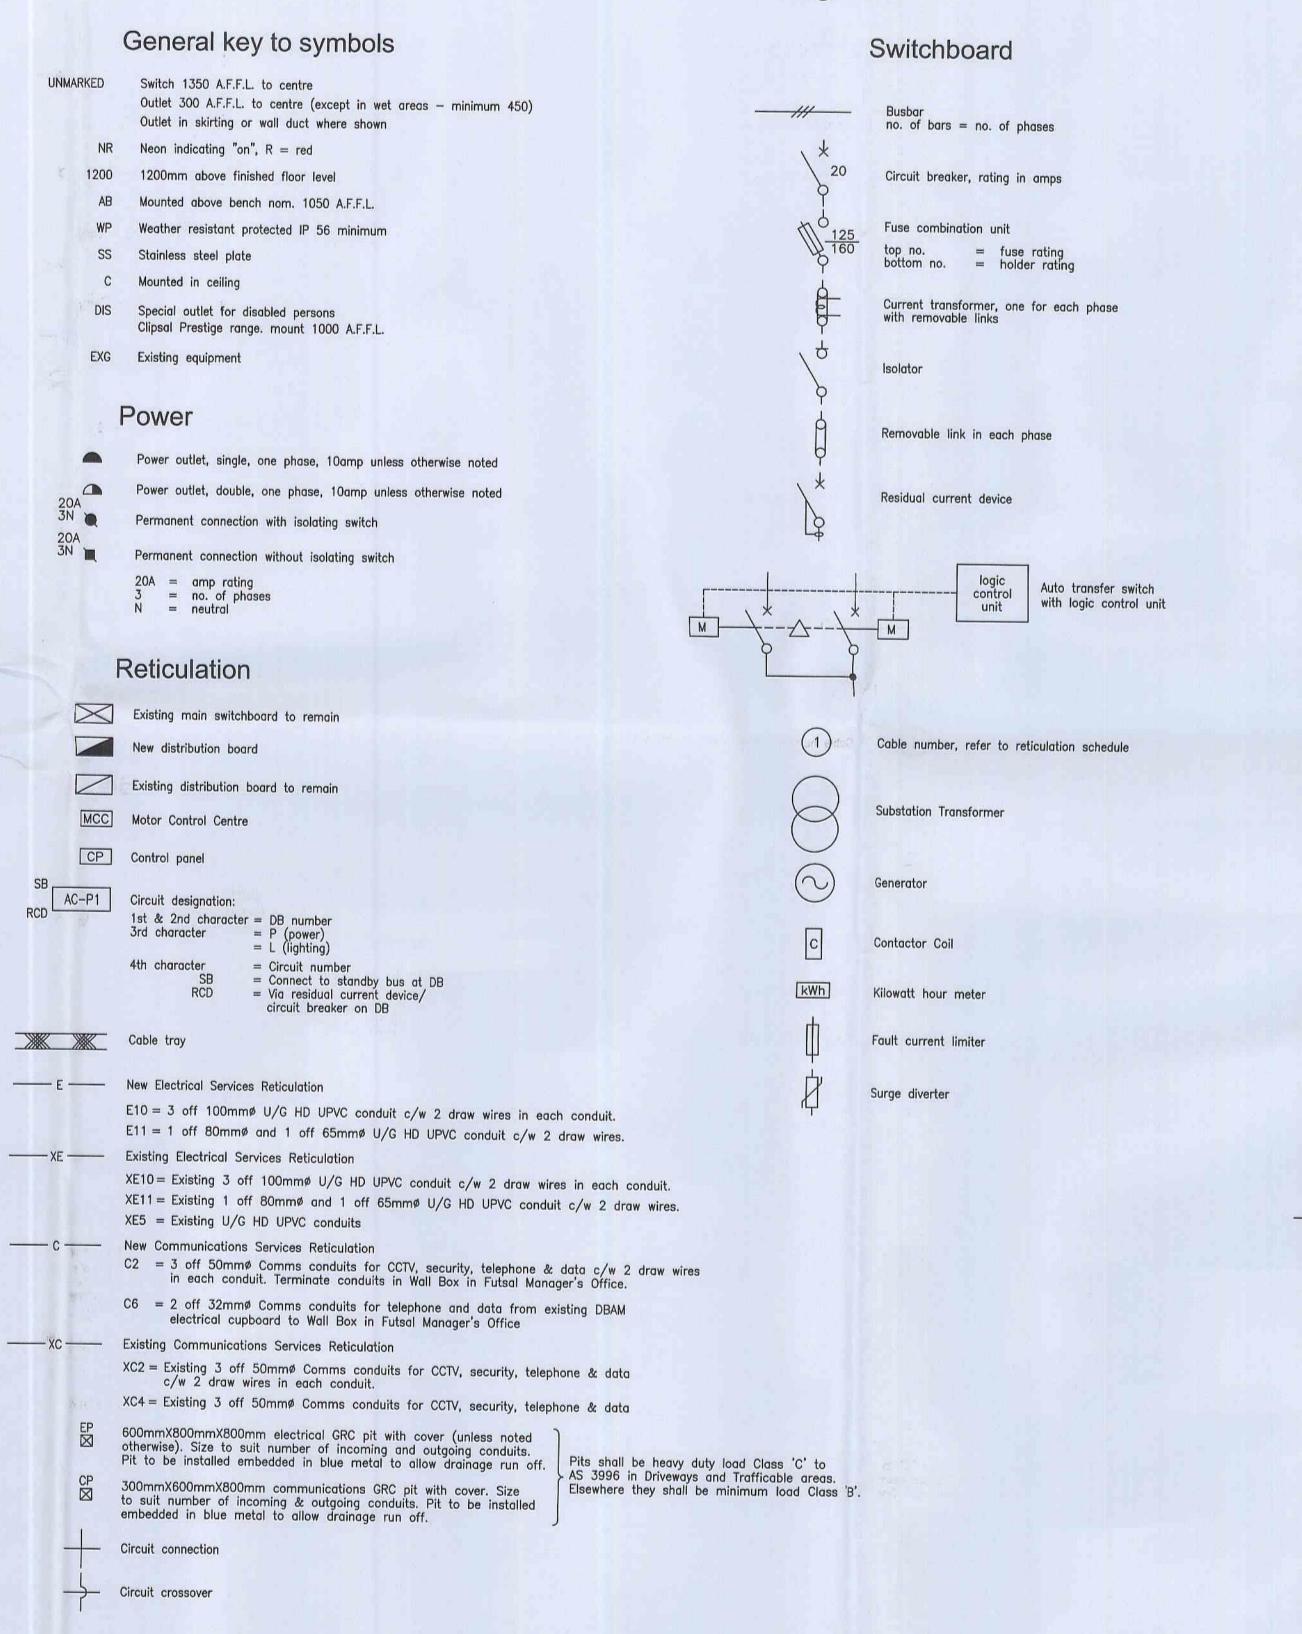

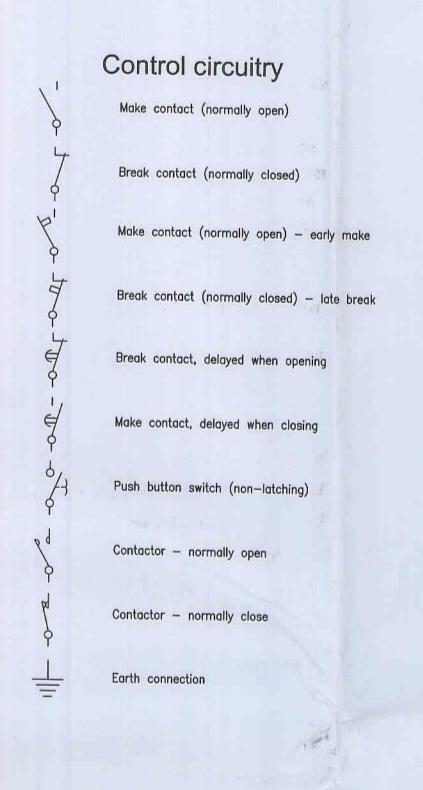

Smoke Alarm System

FP	Fire alarm panel
II)	Smoke alarm = lonisation
	Heat alarm
Zone n	Fire Alarm Zone n = Zone number

Communications

COUNCIL COPY

Communication cabling no. = no. of pairs

Twin telephone outlets
Provide wall box and 25mmø conduit with draw wire from outlets to Wall Box in Futsal Manager's Office.
Provide two (2) RJ45 outlets complete with Cat. 6a UTP 4 pair telephone cabling x 2 to nearest Comms floor distributor in Club Main Building.

CR Cash register outlet
Provide wall box and 25mmø conduit with draw wire from outlet to Wall Box in Futsal Manager's Office.

Existing telecommunications floor distributor in the Club.

Comms Wall Box —

minimum 200mm (H) X 300mm (W).

A TENDER ISSUE TO PDC

Amendments

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3. This drawing is an annexure to the specification & shall be read

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PITTWATER RSL CLUB
BOWLER'S LOUNGE AMENITIES

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ELECTRICAL SERVICES
LEGEND

Drawn Checked Approved Scale
G.V. N.T.S.

Project No. Date

PRL 1/25 13335


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JULY '10

NOTE: All symbols may not necessarily be used in the documents






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- Outlet locations are diagramatic only, refer to architect's drawings for exact location.
- No variations to the extent of the work shall be undertaken without prior written consent.
- This drawing is an annexure to the specification & shall be read in conjunction with the specification & schedules.
- The exact location of all equipment shall be determined on site and as directed by the Project Manager.
- 7. Remove all redundant equipment & cabling and make good.

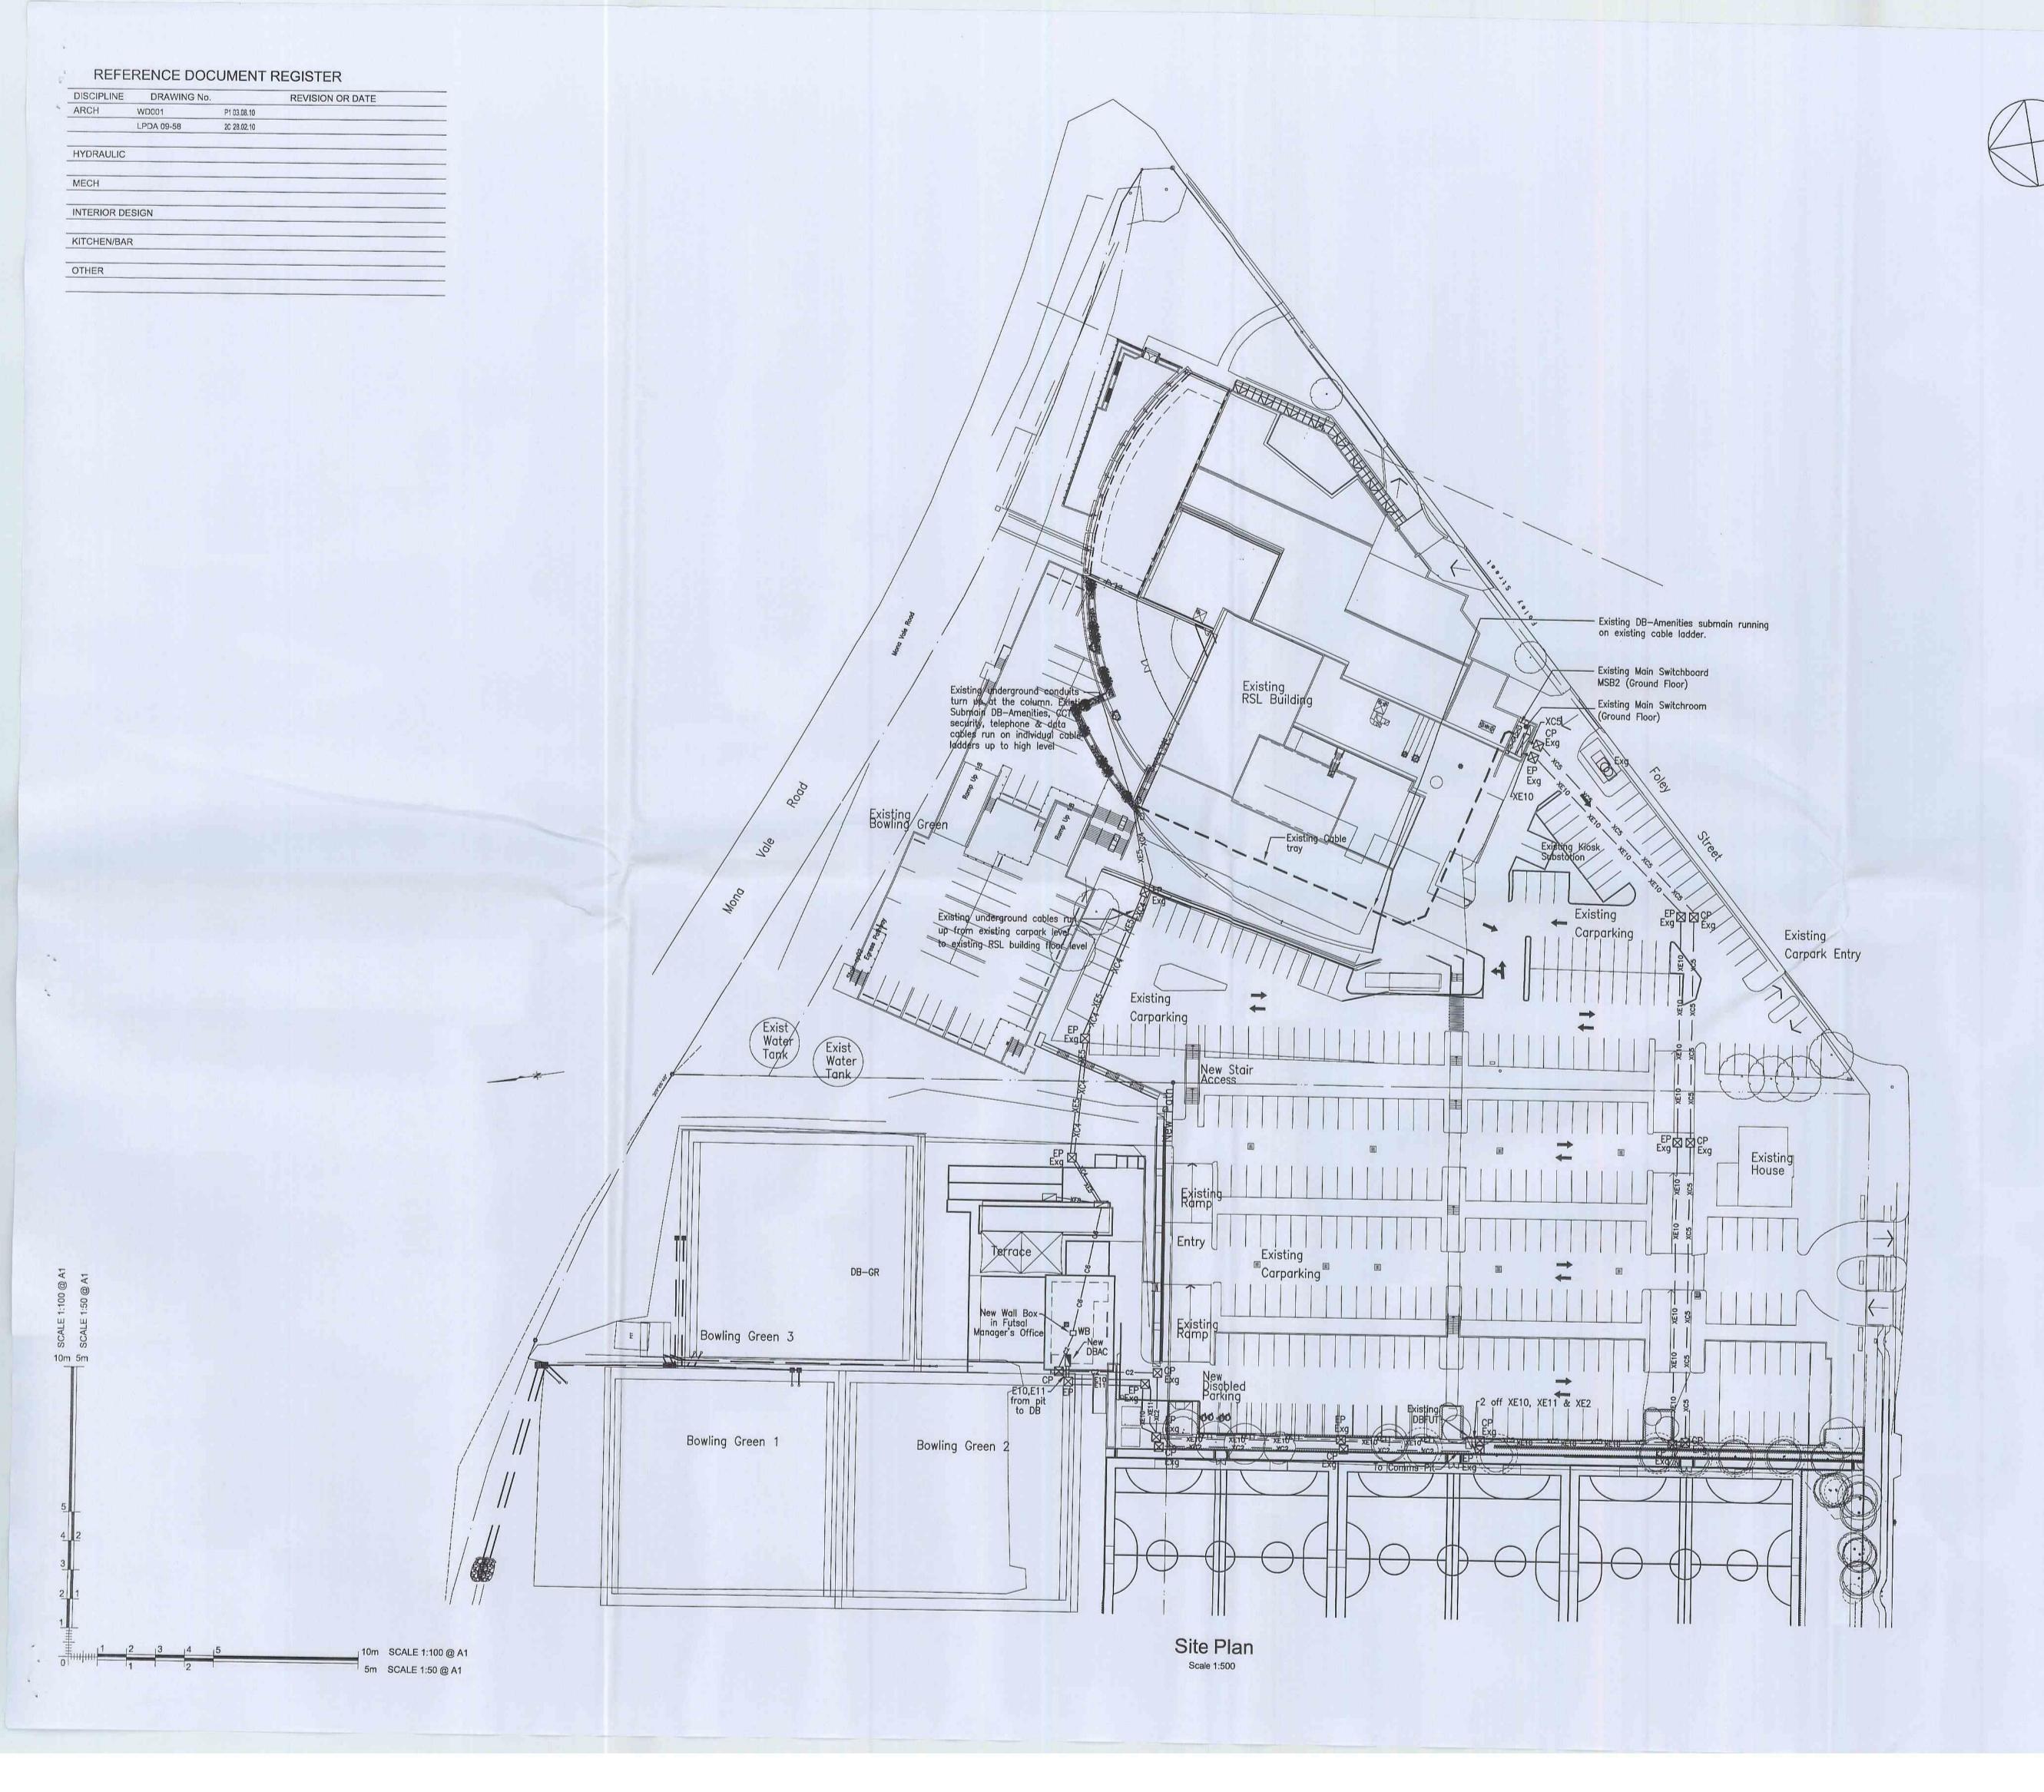

SCIPLINE CH	DRAWING No. WD101	P3 03.08.10	REVISION OR DATE
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ITCHEN/BAR			
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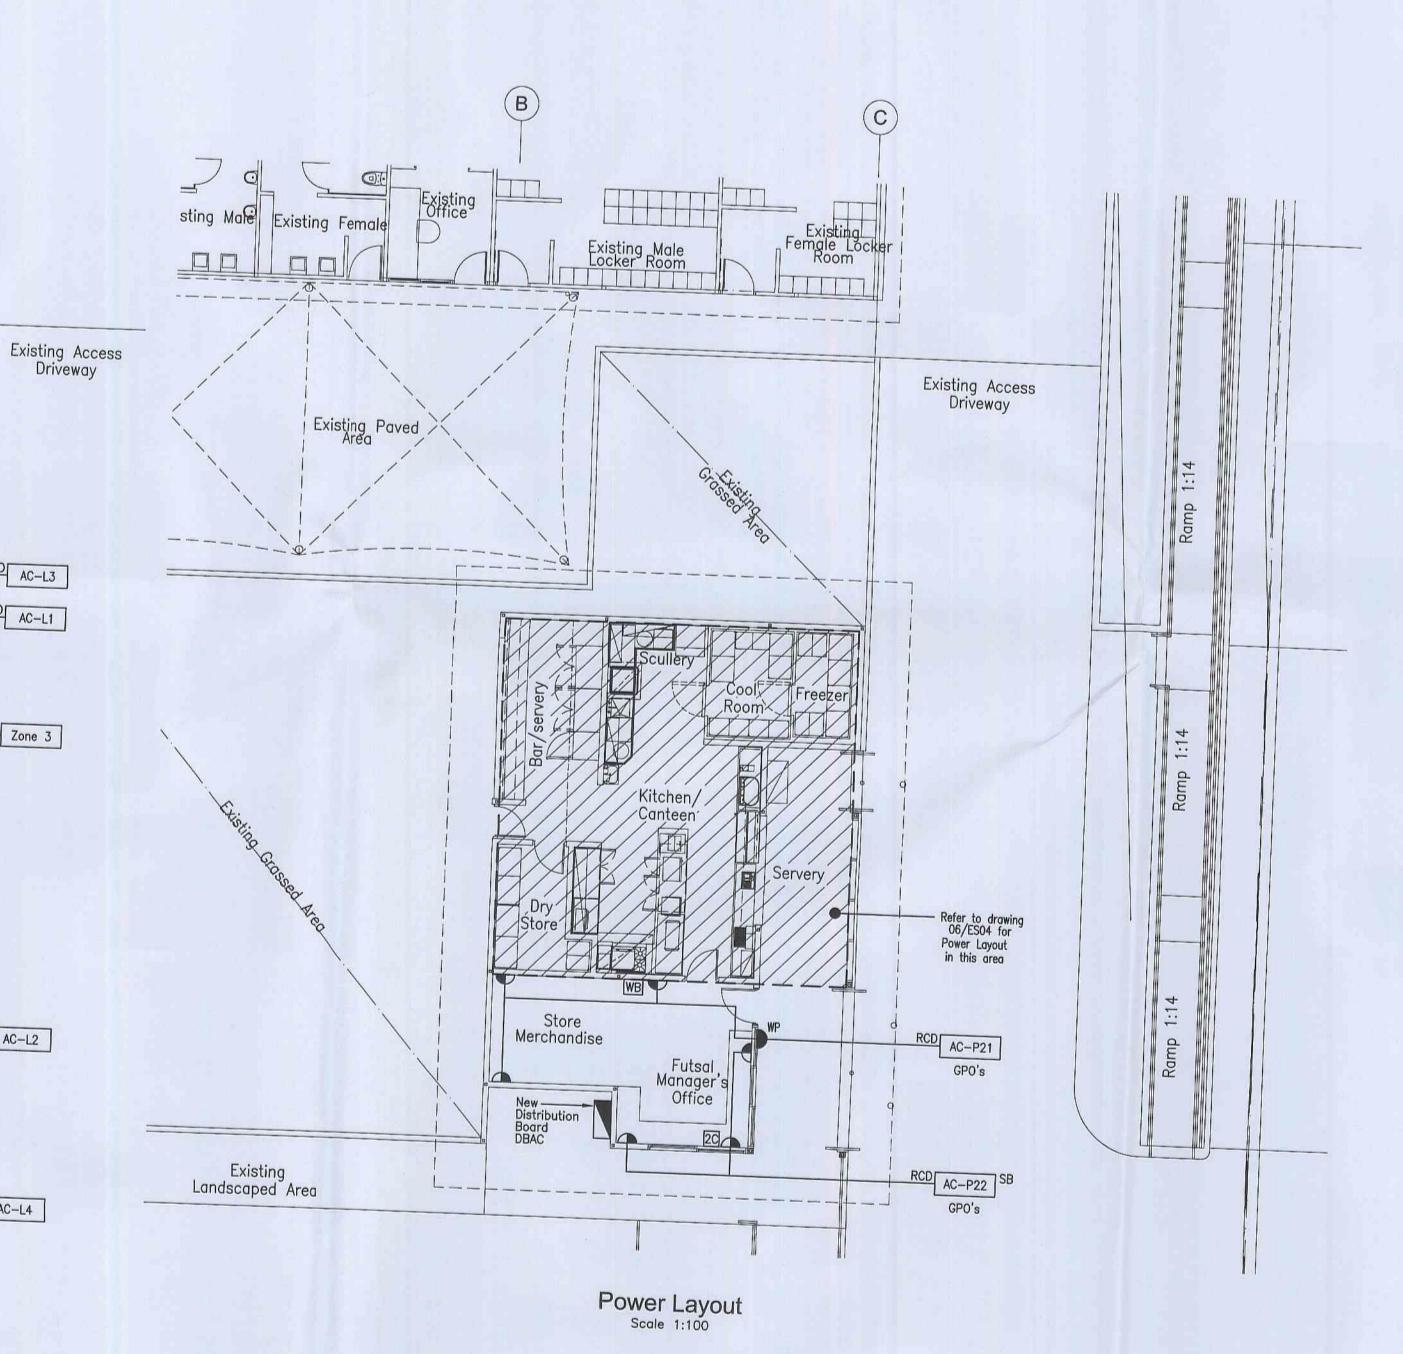
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- 4. No variations to the extent of the work shall be undertaken without prior written consent.
- This drawing is an annexure to the specification & shall be read in conjunction with the specification & schedules.
- The exact location of all equipment shall be determined on site and as directed by the Project Manager.
- 7. Remove all redundant equipment & cabling and make good.
- 8. Emergency lighting to be wired in accordance with AS 2293 and "Typical Wiring Diagrams for Exit Signs & Emergency Luminaires" shown on the drawings. All emergency & exit sign luminaires are to be wired via separate active from local lighting final sub-circuit breaker, via a test switch on the distribution board. When in test position, emergency and exit lights should operate and normal lighting remain on.
- Exit signs shall be mounted at between 2000 and 2700 AFFL or immediately above the door if higher then 2700. Exit signs shall, where possible, be wall mounted.
- Where exit signs are shown ceiling mounted or nominated as 'suspended' and ceilings are greater than 2700 AFFL, then exit signs shall be suspended on rods (painted to match ceiling colour) unless approved otherwise by the local government authority. In plantrooms & service areas chain suspension is acceptable.
- 11. Circuits which are identified with the letter 'SB' are to be connected to the standby chassis section of the nominated distribution
- Connect all lighting circuits to generator backed up section of distribution board DBAC.
- All light switches shall be controlled via Dynalite switching channels as shown on the lighting layout.
- 14. Final location of Light Preset Panel 'P2' shall be determined on site to the approval of the Project Manager.

09-08-10

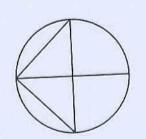

Lighting & Fire Alarm Layout

Zone 1 Manager's

l'm T

AC-P23 RCD

Notes: a) Connect alarms in Dry Stores, Bar/Servery, Scullery and Kitchen/Canteen to Fire Alarm Zone No.2.

RCD AC-L3

Zone 3

RCD AC-L2

AC-L4

PAYNTER DIXON

A TENDER ISSUE TO PDC

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Lighting Consultants

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181 FIRST AVENUE, FIVE DOCK, NSW 2046. PO BOX 963 FIVE DOCK, NSW 2046. Phone: +612 9819 7819 Fax: +612 9819 6665


PITTWATER RSL CLUB BOWLER'S LOUNGE AMENITIES

ELECTRICAL SERVICES LIGHTING, POWER & FIRE ALARM LAYOUT


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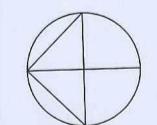
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06/ES03



REFERENCE DOCUMENT REGISTER DISCIPLINE DRAWING No. REVISION OR DATE ARCH HYDRAULIC MECH INTERIOR DESIGN KITCHEN/BAR G 09.06,10 OTHER

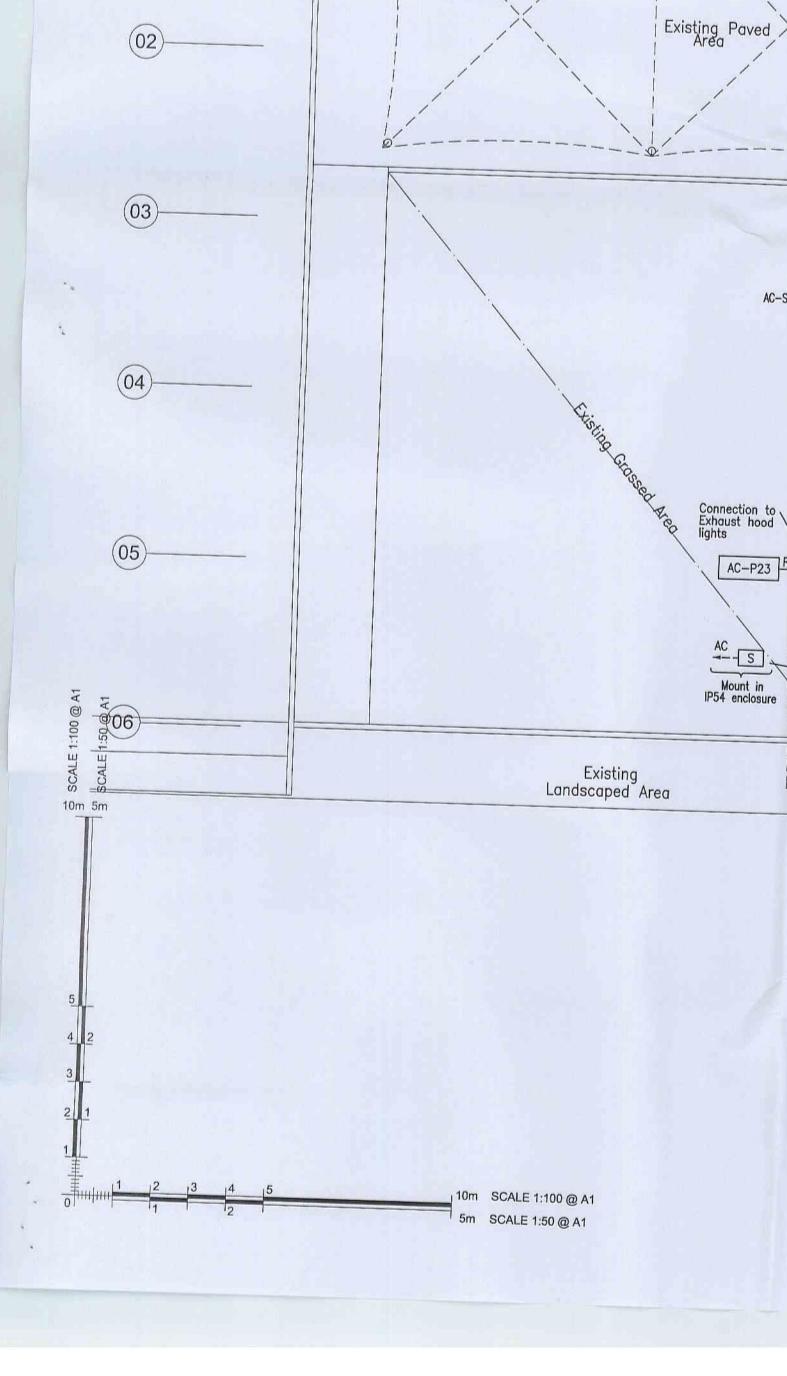

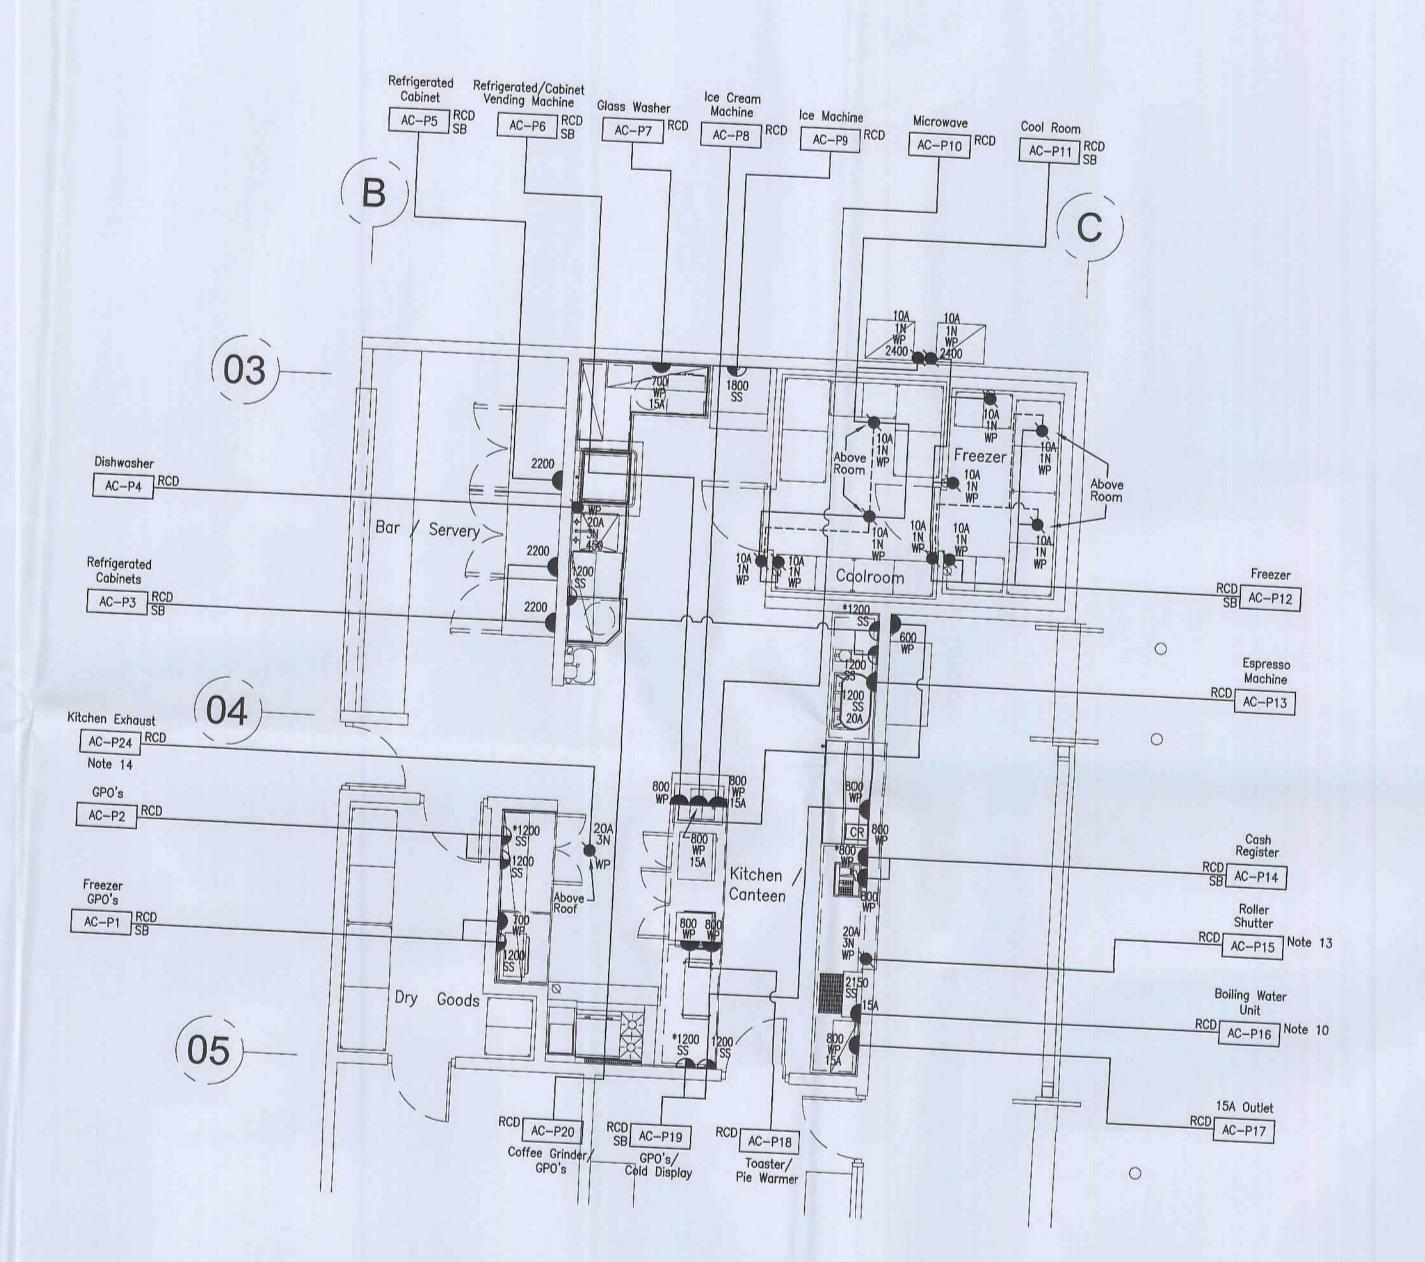

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- 2. Do not scale drawing. Verify all dimensions on site.
- 3. Outlet locations are diagramatic only, refer to architect's drawings for exact location.
- No variations to the extent of the work shall be undertaken without prior written consent.
- This drawing is an annexure to the specification & shall be read in conjunction with the specification & schedules.
- The exact location of all equipment shall be determined on site and as directed by the Project Manager.
- 7. Remove all redundant equipment & cabling and make good.
- Provide matching IP56 screw ring plugs for all weatherproof outlets and extend flexible leads from equipment to reach outlets as required.
- 9. Circuits which are identified with the letter 'SB' are to be connected to the standby chassis section of the nominated distribution board.
- See Detail No.1 on drawing ES06 for Typical Control Wiring Diagram for Boiling Water Unit.
- 11. All power outlets shown with an asterix adjacent to it shall be provided above bench for general purpose power as shown on the electrical services drawings.
- 12. The exact location of all equipment shall be determined on site by the Project Manager prior to installation of conduits and wiring, all services shall be co-ordinated with Kitchen/Bar Sub-Contractors approved workshop drawings.
- 13. Confirm roller shutter electrical requirements with Roller Shutter Supplier prior to carrying out any work on site.
- Terminate final sub-circuit in isolator. Extend wiring from isolator to exhaust fan and terminate wiring at both ends.

