

Construction Traffic Management Plan 33-35 Fairlight Street and 10-12 Clifford Avenue, Fairlight

24070

Prepared for Allen Group Developments

10 December 2024

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Document Information

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|------------------|---|
| Client | Allen Group Developments |
| Architect | Platform Architects |
| Project Location | 33-35 Fairlight Street and 10-12 Clifford Avenue, Fairlight |
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Table of Contents

| 1 | Intr | oduction | 5 | | |
|----|------|--|----|--|--|
| 1. | 1 | Background | 5 | | |
| 1. | 2 | Scope of Works 5 | | | |
| 1. | 3 | Reference Documents | 6 | | |
| 2 | Pro | posed Development | 7 | | |
| 3 | Exis | sting Conditions | 8 | | |
| 3. | 1 | Site and Surrounding Context | 8 | | |
| 3. | 2 | Road Network | 9 | | |
| 3. | 3 | Traffic Controls | 10 | | |
| 3. | 4 | Public Transport Services | 11 | | |
| 3. | 5 | Existing Traffic Conditions | 12 | | |
| 4 | Cor | nstruction Traffic Management | 13 | | |
| 4. | 1 | Site Contact | 13 | | |
| 4. | 2 | Construction Program | 13 | | |
| 4. | 3 | Work Hour | 13 | | |
| 4. | 4 | Truck Manoeuvre / Site Access | 14 | | |
| 4. | 5 | Truck Route | 15 | | |
| 4. | 6 | Site Setout | 16 | | |
| 4. | 7 | Fencing/Perimeter Separation | 16 | | |
| 4. | 8 | Materials Handling | 16 | | |
| 4. | 9 | Works Zone | 17 | | |
| 4. | 10 | Pedestrian Movement Plan (PMP) | 17 | | |
| 4. | 11 | Traffic Guidance Scheme | 17 | | |
| 4. | 12 | Construction Worker Parking | 17 | | |
| 4. | 13 | Site Induction | 18 | | |
| 4. | 14 | Protection of Adjoining Properties and Public Assets | 18 | | |
| 4. | 15 | Other Construction Management Principles | 18 | | |
| 5 | Wo | rk Impact | 20 | | |
| 5. | 1 | Public Notification & Communication | 20 | | |

| 5.2 | Spoil Management | 20 |
|-----|-------------------------------------|----|
| 5.3 | Road Serviceability | 20 |
| 5.4 | Impact on Public Transport Services | 20 |
| 5.5 | Impact on Emergency Vehicle Access | 20 |

Attachments

Attachment 1 Architectural Plan

Attachment 2 Traffic Guidance Scheme (TGS), Vehicle Management Plan (VMP) and Pedestrian Management Plan (PMP)

Attachment 3 Swept Path Analysis

Tables

| Table 1-1 | Consent Condition Requirements | Error! Bookmark not defined. |
|-----------|--------------------------------|------------------------------|
| Table 3-1 | Surrounding Road Network | 9 |
| Table 3-2 | Surrounding Traffic Controls | 10 |
| Table 3-3 | Bus Services Provision | 12 |
| Table 4-1 | Contact Details | 13 |
| Table 4-2 | Works Program | 13 |
| Table 4-3 | Works Zone | 17 |

Figures

| Figure 1-1 | Site | 5 |
|------------|----------------------------------|----|
| Figure 3-1 | Site Context | 8 |
| Figure 3-2 | Road Network | 9 |
| Figure 3-3 | Local Public Transport Locations | 11 |
| Figure 4-1 | Truck Route | 15 |
| Figure 4-2 | Site Setup | 16 |

1 Introduction

1.1 Background

This report has been prepared as part of a Development Application process at 33-35 Fairlight Street and 10-12 Clifford Avenue, Fairlight (Figure 1-1).

Figure 1-1 Site



Source: Mecone (Modified by Genesis Traffic)

1.2 Scope of Works

The purpose of this report is to satisfy the Lodgement Requirements from Northern Beaches Council, reproduced below:

Construction Traffic Management Plan

A Construction Traffic Management Plan must be prepared for constrained sites where access is difficult or for large projects that generate large volumes of construction traffic.

The plan is to include the impacts the proposal will have on the local road network. The plan must provide a description of the construction works, the traffic impacts on the local area and how these impacts will be addressed.

1.3 Reference Documents

Reference has been made to the following documents when preparing this report:

• Traffic Control at Worksites Technical Manual, TfNSW (Issue 6.1, 2022)

2 Proposed Development

The proposed development scheme involves a residential development with 15 apartments that now consolidates 4 sites with frontages to Fairlight Street and Clifford Avenue. Basement carpark will be provided onsite and accessed via Clifford Avenue.

Details of the proposed development scheme are indicated in the architectural plans reproduced in part in **Attachment 1**.

3 Existing Conditions

3.1 Site and Surrounding Context

The development site (Figure 3-1) is legally known as Lot 8B, 9B and 20B in DP3742 and SP20752, located at 33-35 Fairlight Street and 10-12 Clifford Avenue, Fairlight. The site occupies an area of 2,345m² and has frontages to Fairlight Street and Clifford Avenue. The site is occupied by 4 single dwellings at present, with vehicle access points located at Fairlight Street and Clifford Avenue. The site falls steeply from the north (Fairlight Street) to the south (Clifford Avenue).

Figure 3-1 Site Context



Source: Metromap (Modified by Genesis Traffic)

3.2 Road Network

The existing road network serving the site area (Figure 3-2) are detailed in Table 3-1:

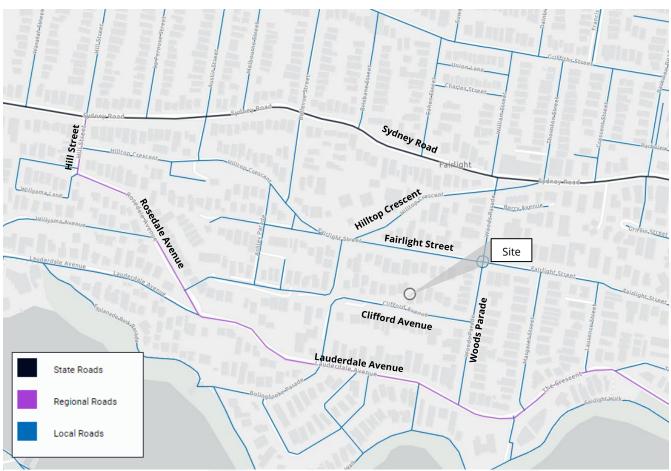


Figure 3-2 Road Network

Source: TfNSW (modified by Genesis Traffic)

| Table 3-1 | Surrounding Road Network |
|-----------|--------------------------|
|-----------|--------------------------|

| Road Name | Description |
|--------------|--|
| | · State Road |
| Sydney Road | · Speed limit 60km/h |
| Syulley Road | · 2 lanes in each direction |
| | No Stopping restriction along both sides of the street |
| | · Regional Road |
| Hill Street | · Speed limit 50km/h |
| | · 2 lanes in each direction |
| | Unrestricted on-street parking along both sides of the street |
| | |

| 1 | - | 1 |
|---|---|---|
| | 1 | 7 |

| | · Regional Road |
|------------------|---|
| Rosedale Avenue | • 1 lane in each direction |
| | Unrestricted on-street parking along both sides of the street |
| | · Regional Road |
| Lauderdale | · Speed limit 50km/h |
| Avenue | • 1 lane in each direction |
| | No Stopping restriction and Time restricted (2P) on-street parking along both sides of the street |
| | · Local Road |
| Hilltop Crescent | · Speed limit 50km/h |
| • | • 1 lane in each direction |
| | Unrestricted on-street parking along both sides of the street |
| | · Local Road |
| Woods Parade | · Speed limit 50km/h |
| | · 1 lane in each direction |
| | • Time restricted (2P) on-street parking along both sides of the street |
| | · Local Road |
| Fairlight Street | · 1 lane in each direction |
| | • Time restricted (2P) on-street parking along both sides of the street |
| | · Local Road (no through road) |
| Clifford Avenue | · 1 lane in each direction |
| | • Time restricted (2P) on-street parking along both sides of the street |
| | |

3.3 Traffic Controls

The traffic controls on the road system in the vicinity of the site are detailed in Table 3-2:

Table 3-2Surrounding Traffic Controls

| Traffic Control | Location |
|----------------------------|---|
| Traffic Signal | Intersection of Hill Street and Sydney Road |
| Roundabout | Intersection of Fairlight Street and Woods Parade |
| | · Intersections of: |
| Give-way / Stop Control | Woods Parade and Sydney Road |
| | Rosedale Avenue and Lauderdale Avenue |


Clifford Avenue and Woods Parade

No Right Turn · From Rosedale Avenue to Lauderdale Avenue

3.4 Public Transport Services

The local public transport services are illustrated in Figure 3-3.

Figure 3-3 Local Public Transport Locations

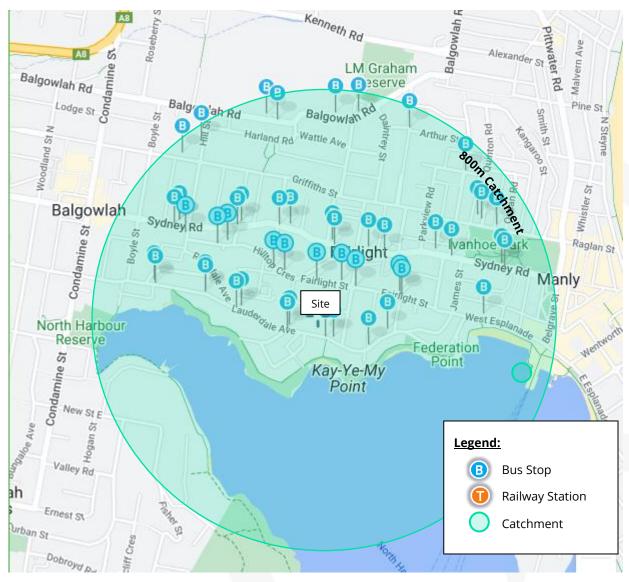

Source: Google Map (Modified by Genesis Traffic)

<u>Bus</u>

Local bus services are within walking distance (260m to the nearest bus stop) of the site, as follows (Table 3-3).

Table 3-3 Bus Services Provision

| Bus Line | Bus Route | Peak Frequency | |
|--|---|--------------------|--|
| 141 | Austlink to Manly via Frenchs Forest & Seaforth | 1-2 trips per hour | |
| 142 | Allambie Heights to Manly | 1-4 trips per hour | |
| 144 | Manly to Chatswood via St Leonards | 7 trips per hour | |
| 144N | Manly to North Sydney (Night Service) | 1trip per hour | |
| 150X Manly to Milsons Point (Express Service) | | 4-5 trips per hour | |
| 162 Seaforth to Manly | | 1 trip per hour | |
| 170X | Manly to City Wynyard (Express Service) | 3-4 trips per hour | |

3.5 Existing Traffic Conditions

Observation of traffic operations in the vicinity of the site indicates a moderate traffic demand but satisfactory operating circumstance during the peak periods. Immediately near the site, traffic access and turning movements on Fairlight Street and Clifford Avenue are not subject to perceptible delays. There is no apparent capacity constraint in the immediate local road network.

4 Construction Traffic Management

4.1 Site Contact

The contact person who is to have authority without reference to other persons to comply with instructions issued by the Council's Traffic Engineer or the Police is provided below (Table 4-1).

Table 4-1 Contact Details

| Details | |
|-------------|------------------------------------|
| Name | Andrea Giuffrida |
| Contact No. | 0423 034 934 |
| Email: | Andrea.giuffrida@lordsgroup.com.au |

4.2 Construction Program

Table 4-2 summarises the envisaged truck visitation levels for each work phase.

Table 4-2 Works Program

| Phase | Program | Largest Type of Truck | Estimated Trips per Day | Estimated Period (Weeks) |
|-------|------------------------------------|--------------------------|----------------------------|-----------------------------|
| 1 | Site Establishment | 6.4m SRV | 2-3 | 1 |
| 2 | Demolition (Early Demolition) | 20m T&D (8.8m MRV) | 10 | 16 |
| 3 | Excavation / Earthworks | 20m T&D | 10-18 | 16 |
| 4 | Construction / Concrete Pouring | 12.5m HRV | 20 | 20 |
| 5 | Fitout | 12.5m HRV | 10 | 16 |

<u>Abbreviation:</u>

- T&D = Truck and Dog
- HRV = Heavy Rigid Vehicle
- MRV = Medium Rigid Vehicle

SRV = Small Rigid Vehicle

4.3 Work Hour

The construction hours will accord with the consent condition.

4.4 Truck Manoeuvre / Site Access

Site Preparation / Early Demolition Stage

Fairlight Street:

• Smaller trucks will reverse into the site using the existing driveway, load demolished materials within the site, and depart in a forward manner.

Clifford Avenue:

- Trucks will stop within the Works Zone on Clifford Avenue for loading out over approximately 4 weeks until trucks can access the site (reverse-in and forward-out).
- A stand plant permit will be required for mobile crane operation to place an excavator on-site.

Demolition Stage

Once the site is prepared for truck access, trucks will approach the site via Clifford Avenue in a reverse manner, load materials and depart in a forward manner.

Excavation Stage

For the first 4 weeks, trucks will continue to approach and depart the site via Clifford Avenue in the same manner as the demolition stage. Once the site can accommodate internal truck turnaround, all truck movements will transition to a forward-in and forward-out arrangement.

Construction and Fitout Stage

- Fairlight Street: Trucks will rely on the Works Zone along the site frontage.
- Clifford Avenue: Trucks up to 8.8m long MRV can utilise the constructed driveway on Clifford Avenue in a reverse-in and forward-out movement for loading/unloading activities within the site. Any trucks longer than 8.8m MRV will rely on the Works Zone.

Note: All necessary oversized mobile crane/truck access will be subject to a separate permit issued by the Council before the planned event. Where reversing is necessary, all such vehicle movements should be undertaken under the supervision of accredited traffic controllers.

The manner in which vehicles access and depart the site is shown in detail on the Vehicle Movement Plan (VMP) in **Attachment 2**, while detailed swept path analysis demonstrating the nominated truck movements at the site frontages are shown in **Attachment 3**.

4.5 Truck Route

Truck movements associated with the construction processes will approach and depart the site via Fairlight Street and Clifford Avenue, as illustrated in Figure 4-1. No queuing of heavy vehicles is to occur on the surrounding streets unless previously approved by the Council.

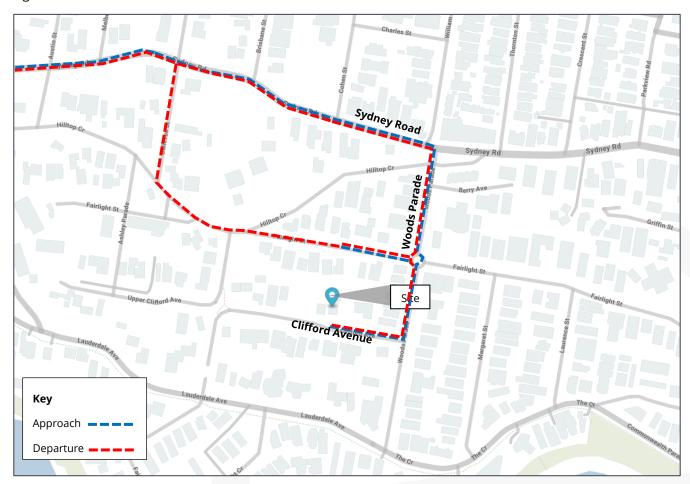


Figure 4-1 Truck Route

Source: Mecone (modified by Genesis Traffic)

4.6 Site Setout

A proposed site plan indicating the expected site access location, proposed truck loading area, site office, amenity and storage, are indicated in Figure 4-2.





Source: Metromap (modified by Genesis Traffic)

4.7 Fencing/Perimeter Separation

Class A fencing will be erected along the construction site perimeter to cordon off the site from pedestrian movements along site frontages and neighbouring properties where applicable.

4.8 Materials Handling

All materials must be loaded/off-loaded and stored within the site boundary at all times. During the excavation of the site, the excavated materials will be loaded/unloaded on site. No materials are to be stored outside the site boundary at any time.

4.9 Works Zone

Works Zone will be required on Clifford Avenue and Fairlight Street along site frontages at different stages throughout the construction. Table 4-3 outlines the requirements for the Works Zone at each phase.

| Table 4-3 | Works Zone |
|-----------|------------|
| | |

| Phase | Program | Works Zone (Yes/No) | Length of the Works Zone |
|-------|------------------------------------|--|-----------------------------|
| 1 | Site Establishment | Not required | - |
| 2 | Demolition (Early Demolition) | Yes, only during the early demolition stage on Clifford Avenue | 9m |
| 3 | Excavation / Earthworks | Not required | - |
| 4 | Construction / Concrete Pouring | Yes, Clifford Avenue and Fairlight Street | 20m each |
| 5 | Fitout | Yes, Clifford Avenue and Fairlight Street | 20m each |

4.10 Pedestrian Movement Plan (PMP)

In the event that Works Zone is required (early demolition, construction and fitout stages), pedestrian movements along the frontage footpath will be diverted to the opposite side of the street. In all other stages, pedestrian movements operate and maintain as per existing.

All construction-related traffic movements along the frontages will occur under the supervision of on-site trained personnel, with trucks escorted between the site access and associated frontage to ensure pedestrian safety. All trucks must always give-way to pedestrians on the footpath. Details of the Pedestrian Movement Plan (PMP) are provided in **Attachment 2**.

4.11 Traffic Guidance Scheme

The Traffic Guidance Scheme (TGS) set out a suite of site traffic management principles in accordance with the TfNSW Traffic Control at Work Sites Technical Manual Version 6.1 dated 28 February 2022. The control of traffic at work sites must be undertaken with reference to Workcover requirements and the contractor's Constructions Workplace Health and Safety Manuals.

The TGSs have been prepared by a Certified Traffic Controller in accordance with Australian Standards 1742.3. The site- specific TGSs are reproduced in **Attachment 2**.

4.12 Construction Worker Parking

There will be no on-site car parking available for workers during the earlier construction stage. Once the internal driveway and basement car park are built (and when construction activity is most intensive), workers can park in the basement.

Some unrestricted on-street parking will be available along the surrounding local streets for the workers. Given the proximity of the site to high-frequency public transport services, all workers will be encouraged at all times to utilise the highly accessible public transport system which exists in the vicinity of the site or to carpool wherever possible.

A tool drop-off and storage facility will be provided within the site. This would allow tradespeople to dropoff and store their tools and machinery, allowing them to use public transport to travel to/ from the site daily.

Workers will also be informed of appropriate tool/equipment drop-off and storage arrangements made within site sheds and amenities provided on-site. Bus and train schedules will be provided to all workers during site induction to demonstrate alternative modes of transport available.

4.13 Site Induction

All workers and visitors employed on the site by the appointed contractor (including sub-contractors) will be required to undergo formal 'site induction' processes and all inductions will be performed specifically to each trade according to SafeWork OH & S requirements.

The induction will include details of approved access routes to and from the construction site for site staff and delivery vehicles, parking arrangements, as well as standard environmental, WHS, driver protocols and emergency procedures. The agreed work hours must be included as part of this induction.

4.14 Protection of Adjoining Properties and Public Assets

The contractor will liaise with the electricity network operator to ensure that tiger tails are fitted to the overhead powerlines on Fairlight Street. The temporary covers must be visually inspected by the operator prior to commencing work each day. The contractor will contact the operator if the tiger tails have moved to allow the operator to replace the cable covers in their correct position.

When working near overhead powerlines, the contractor will have to comply with Workcover and maintain the minimum safe approach distances defined in the code.

4.15 Other Construction Management Principles

- 1. Removed or damaged parking signs shall be replaced immediately.
- 2. Damaged trees shall be repaired / replaced to the satisfaction of Council.
- Traffic and pedestrian control shall be in accordance with the TfNSW Traffic Control at Work Sites Technical Manual and Australian Standard AS1742.3 – Manual of uniform traffic control devices - Part 3 Traffic control for works on roads.
- 4. Reserving of on-street parking shall not occur without prior Council approval. All on-street parking spaces outside the site are to remain available for the use by the general public during the approved work hours unless Council signage is installed to the contrary.

- 5. Barricades, delineators (including bollards, witches hats, barrier boards etc.) shall not be placed in the kerbside parking lane outside or adjacent to the site to reserve on street parking spaces without the prior approval of Council.
- 6. A separate application to and approval from Council will be submitted for occupation of any road related area (traffic and parking lanes, verge, footpath etc.).

5 Work Impact

5.1 Public Notification & Communication

The nominated contractor shall prepare notification letters to advise the following neighbouring properties of the proposed construction works and timing thereof. A minimum notice period of 14 days shall be applicable for all external communications.

The nominated contractor shall also engage with the surrounding building teams at the time of construction to establish the extent of truck delivery movements with an aim to minimise overlapping movements on the same routes.

The following addresses will be notified by letterbox drop prior to the start of works, providing information relating to the project schedule:

| Adjacent to the site | 31, 37 Fairlight Street & 8,14 Clifford Avenue |
|----------------------|--|
| Opposite the site | 48, 50 Fairlight Street & 7,9 Clifford Avenue |

5.2 Spoil Management

Wheel wash station will be positioned at the entry/exit points to ensure that soil/excavated materials are not transported on wheels or tracks of vehicles or plant and deposited on surrounding roadways. All arriving and departing construction vehicles are to have their loads covered during demolition and excavation.

5.3 Road Serviceability

The nominated contractor will be responsible for ensuring that the road pavement, kerb, and gutter along each road frontage shall remain in clean and serviceable states during the course of the construction at no cost to Council.

5.4 Impact on Public Transport Services

The nominated heavy vehicle haulage routes will largely be limited to State Roads and Regional Roads which are designed to accommodate heavy vehicle movements. As such, there will be no adverse impact on existing public transport services.

While the nominated truck routes will overlap with bus routes during the construction period, it is not expected that estimated truck movements would have no material effect on the existing bus services.

5.5 Impact on Emergency Vehicle Access

A site personnel will be on-site regularly with contact details prominently displayed and visible from the road frontage. Access to the site and neighbouring sites by emergency vehicles would not be affected by the

construction activities. There will be no adverse impact on emergency vehicle access to the site or other neighbouring properties as a result of the proposed activities.



Attachment 1

Architectural Plans





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| А | 05/12/2024 | FOR DEVELOPMENT APPLICATION | JS |
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REVISION NOTES

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2/40 East Esplanade Manly, NSW 2095 Australia Phone: 02 8385 9759

> Nominated Architect: Bridie Gough 8280

MULTI-RESIDENTIAL DEVELOPMENT 33-35 Fairlight Street 10-12 Clifford Ave Fairlight NSW 2094 ALLEN GROUP DEVELOPMENTS

FOR DEVELOPMENT APPLICATION

drawing title

project

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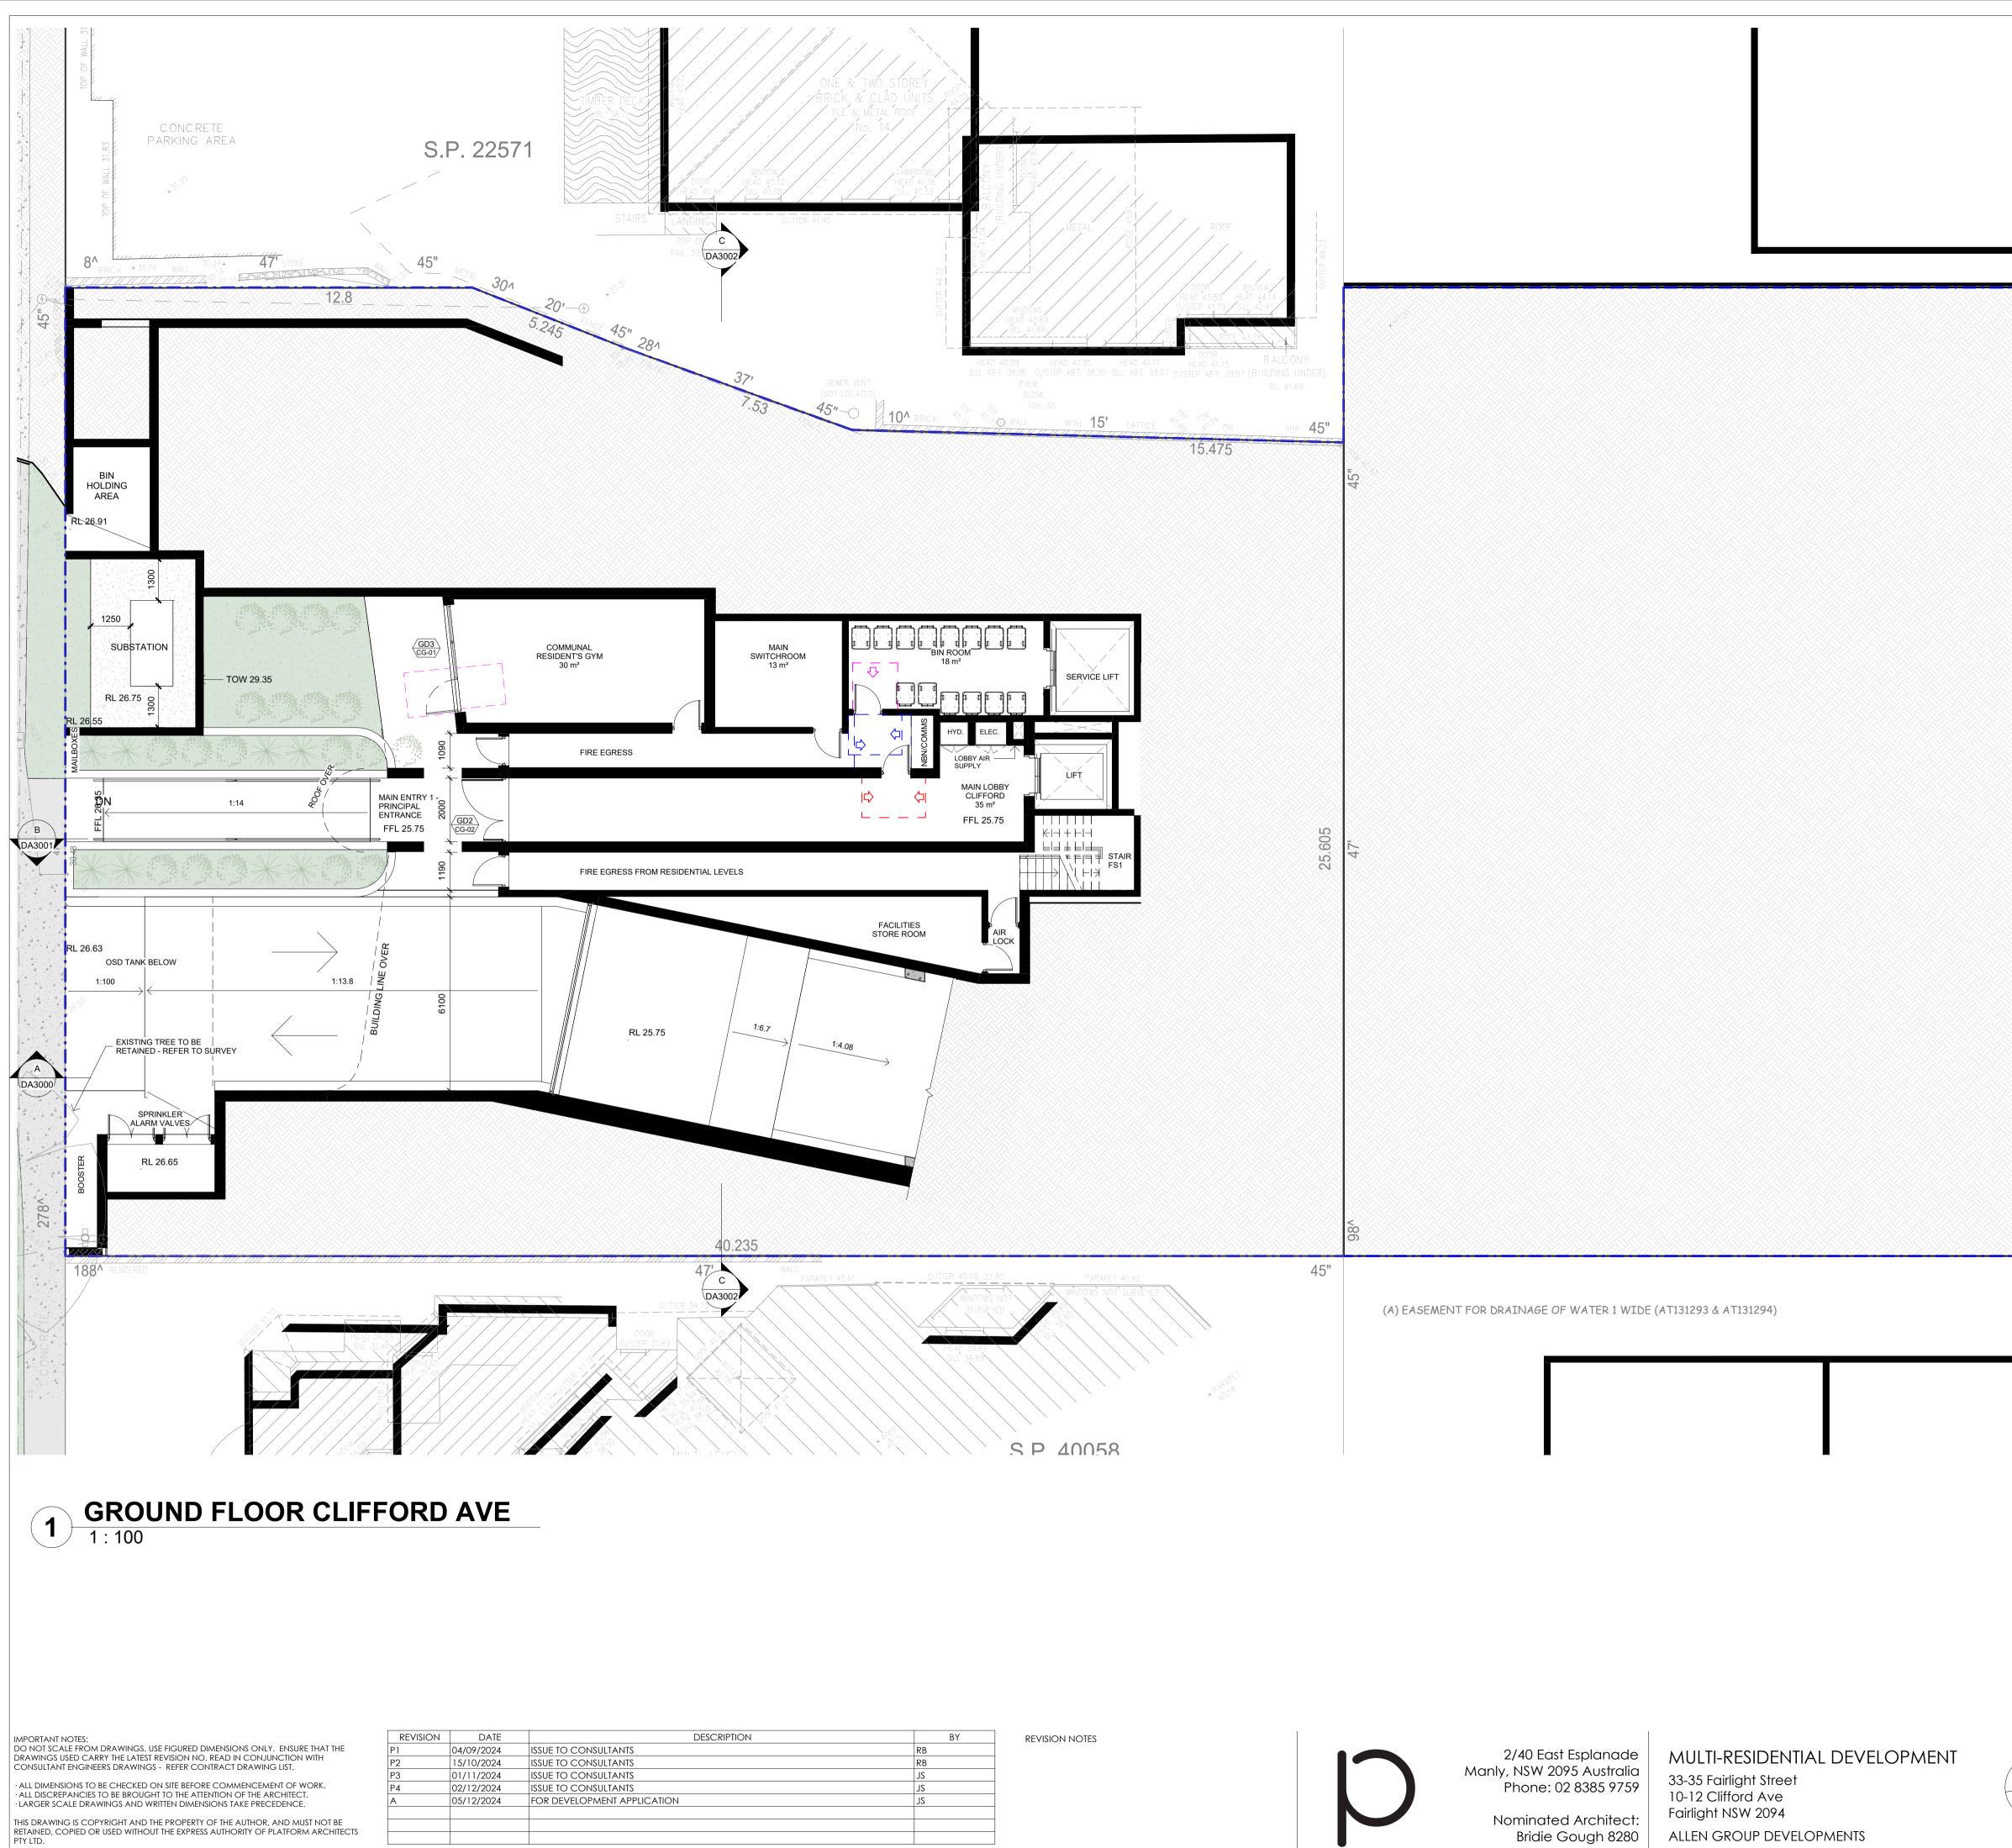
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NUMBER

revision A



37 FAIRLIGHT ST

31 FAIRLIGHT ST

FOR DEVELOPMENT APPLICATION



DRAWING TITLE Ground Floor Clifford Ave

PROJECT FSF2

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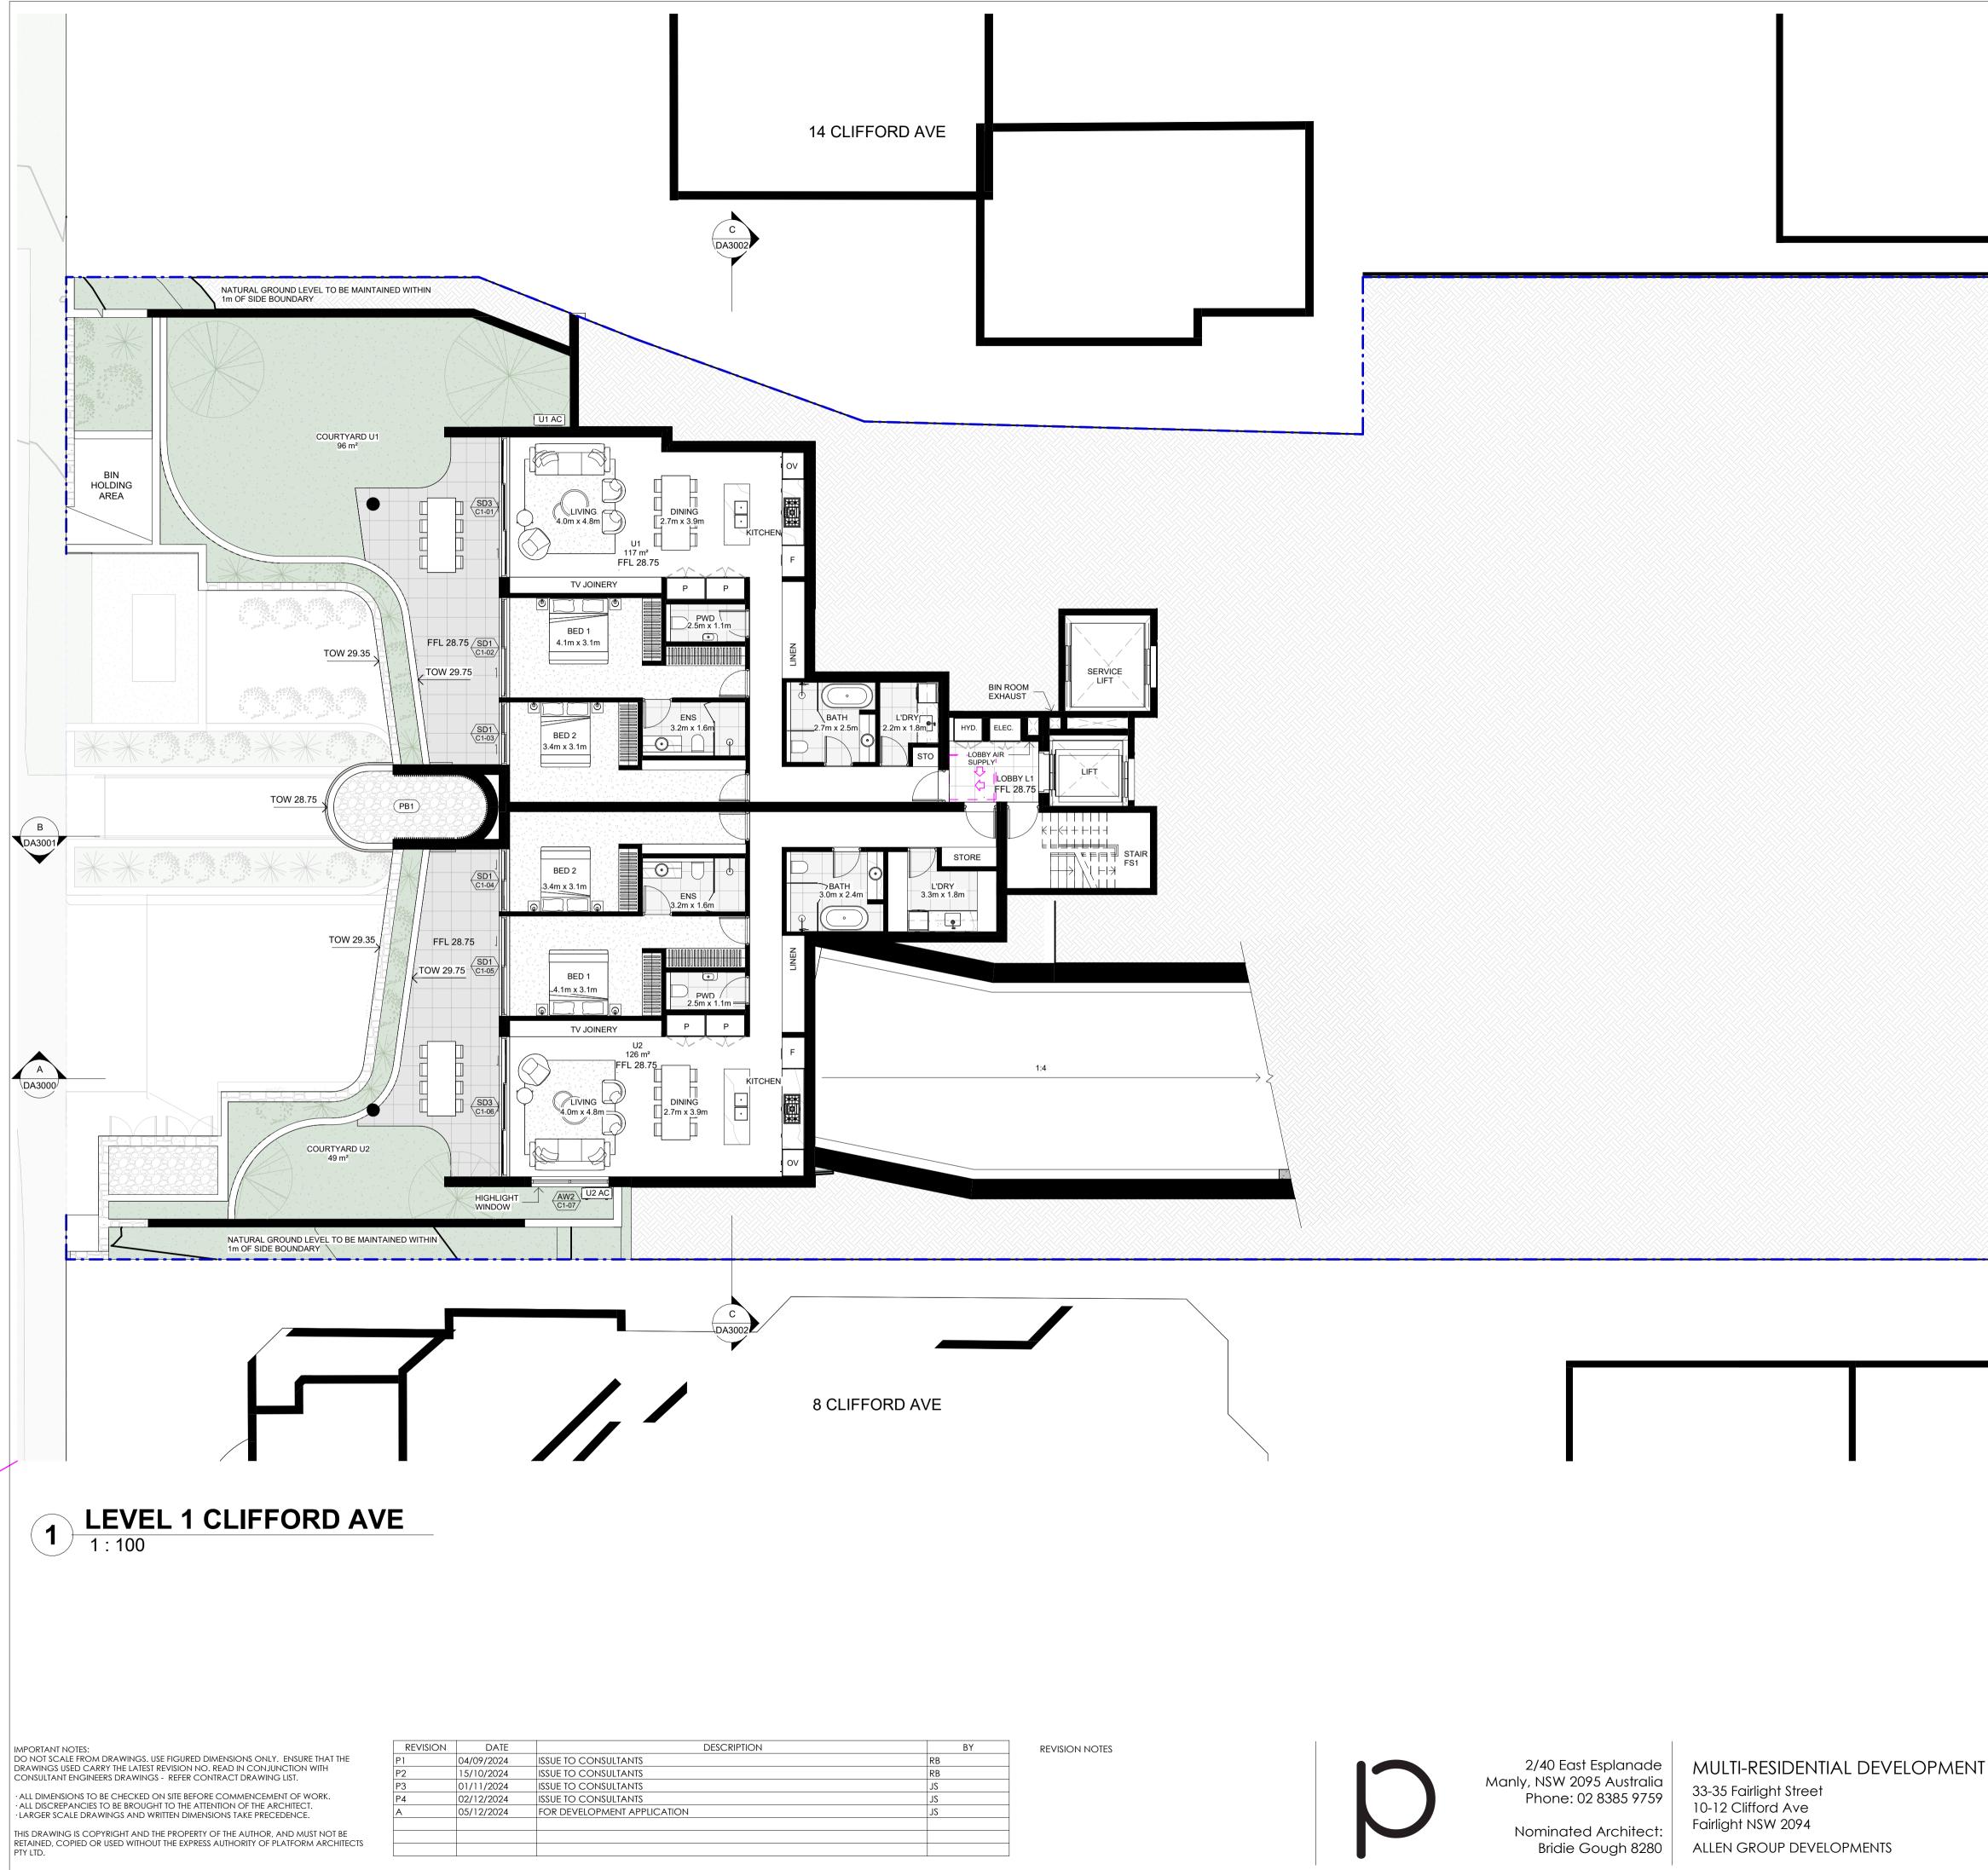
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37 FAIRLIGHT ST

FOR DEVELOPMENT APPLICATION

DRAWING TITLE Level 1 Clifford Ave PROJECT FSF2

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31 FAIRLIGHT ST


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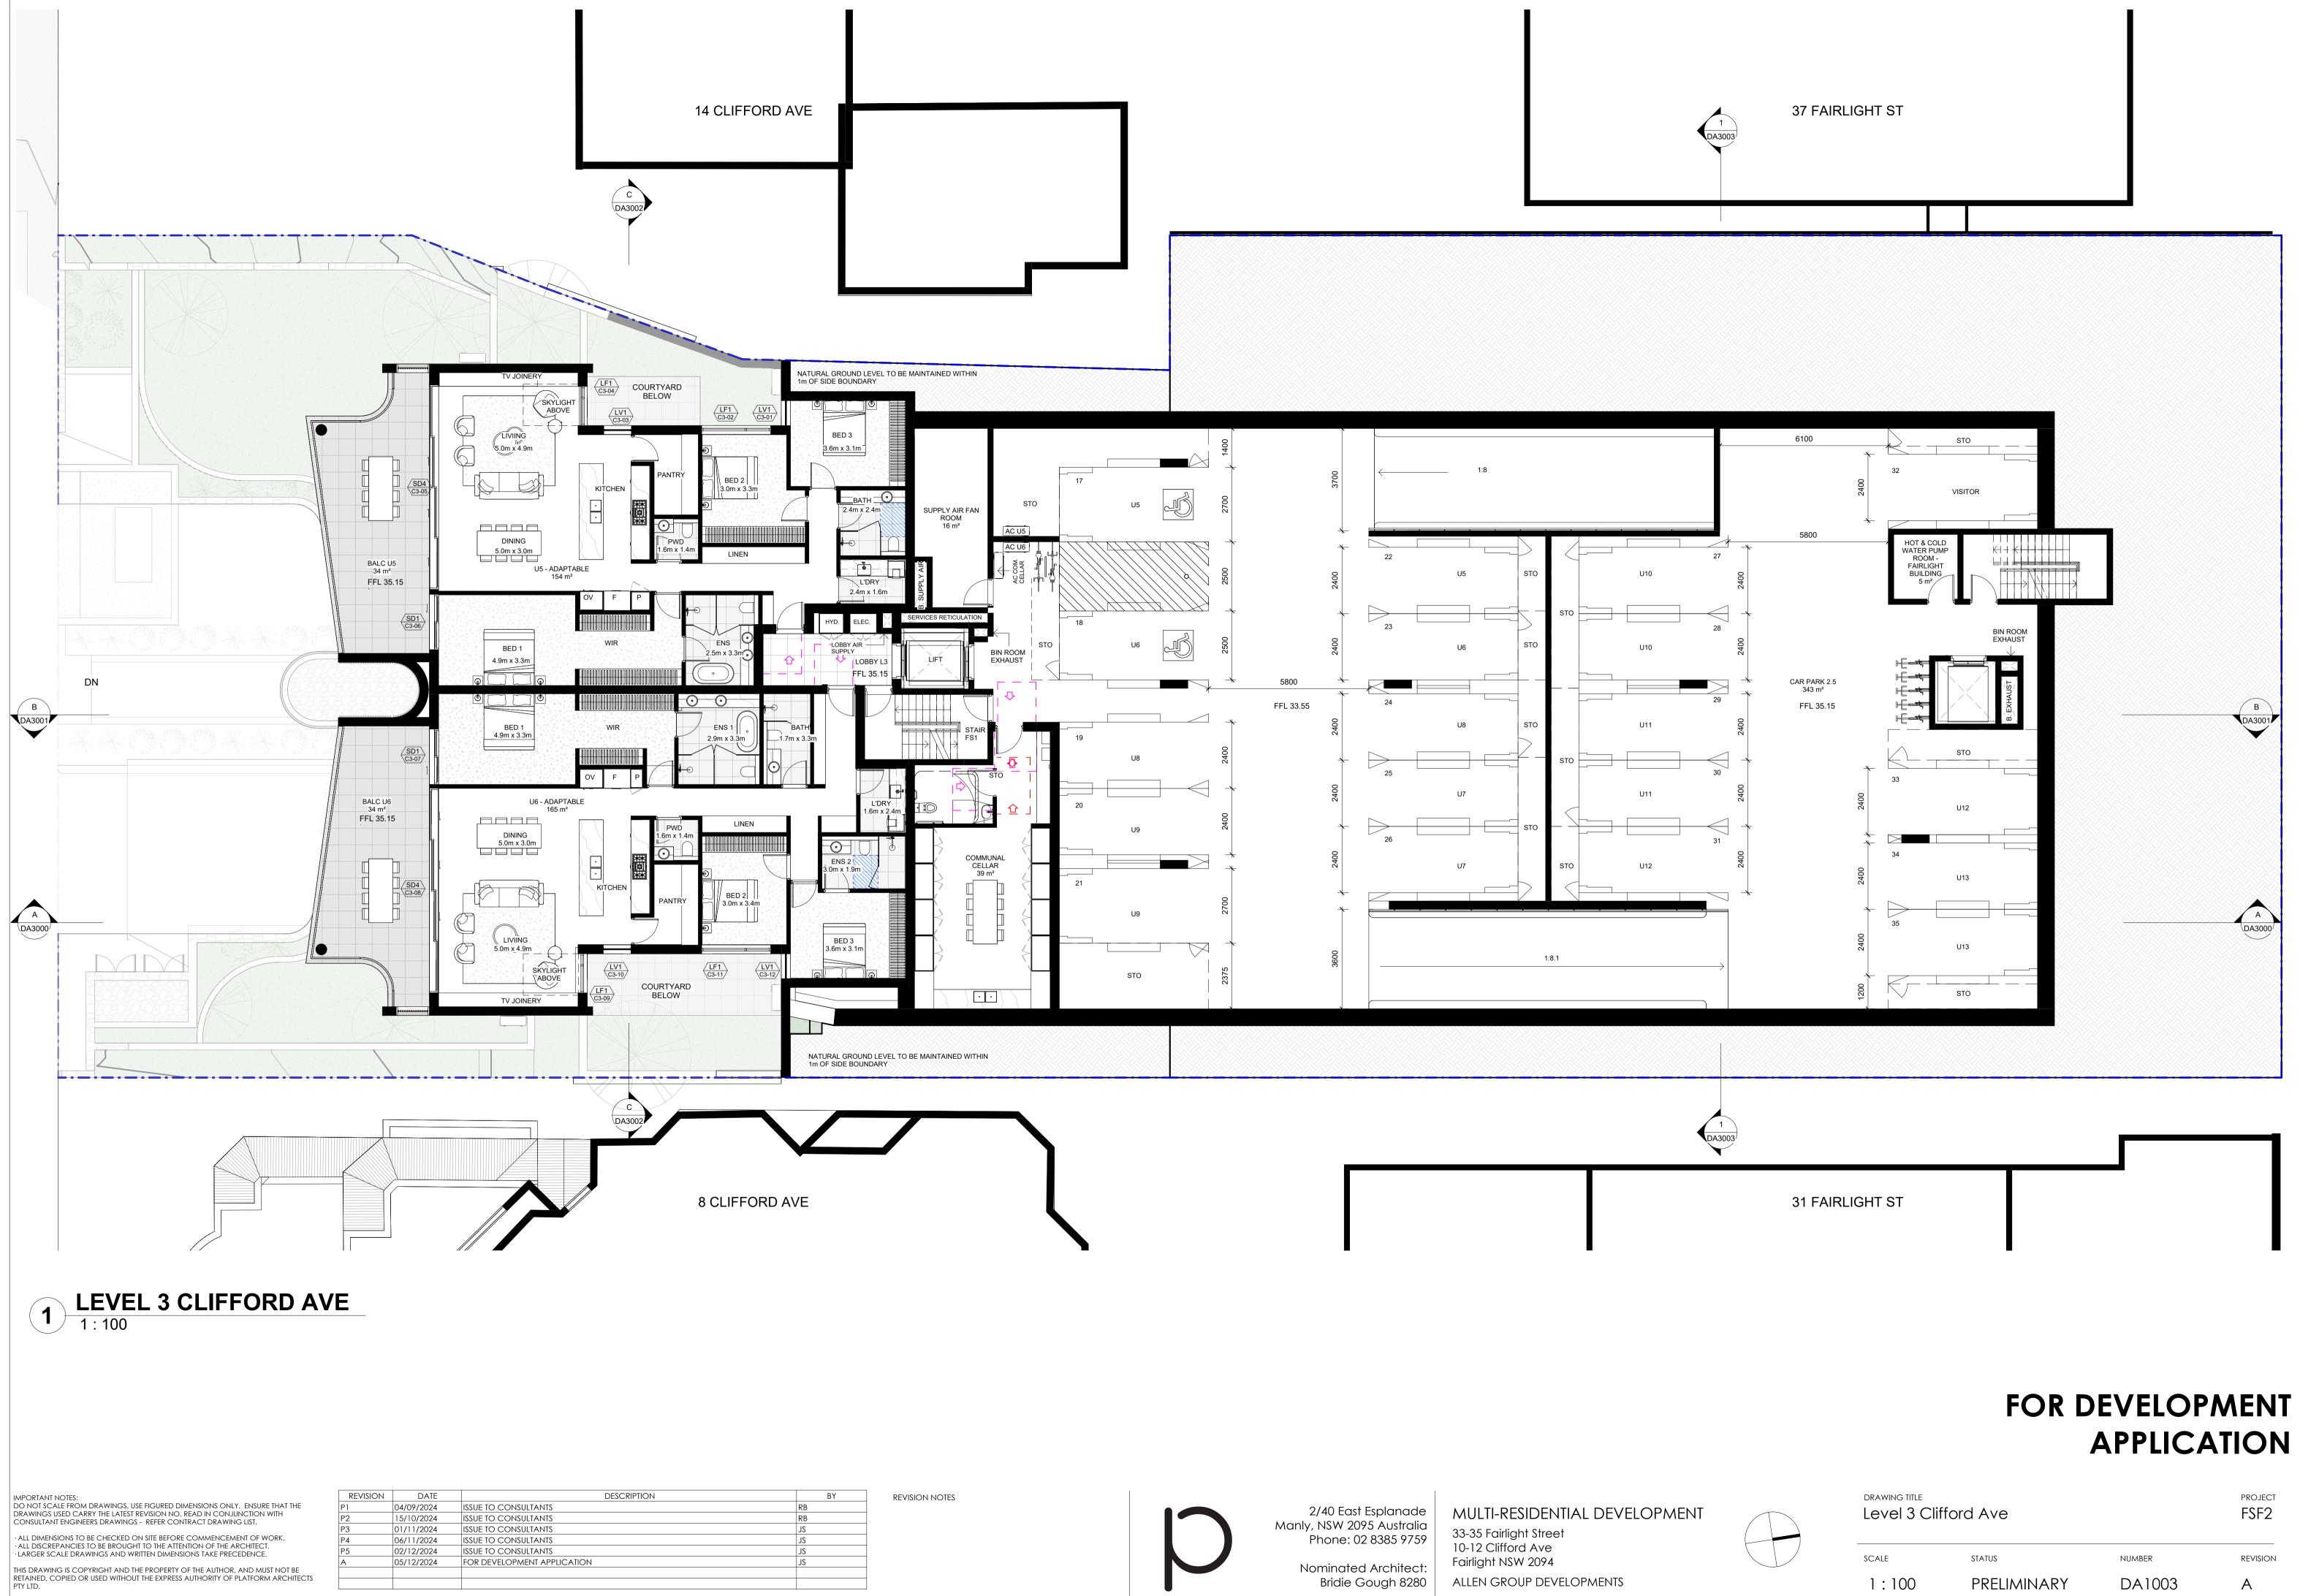
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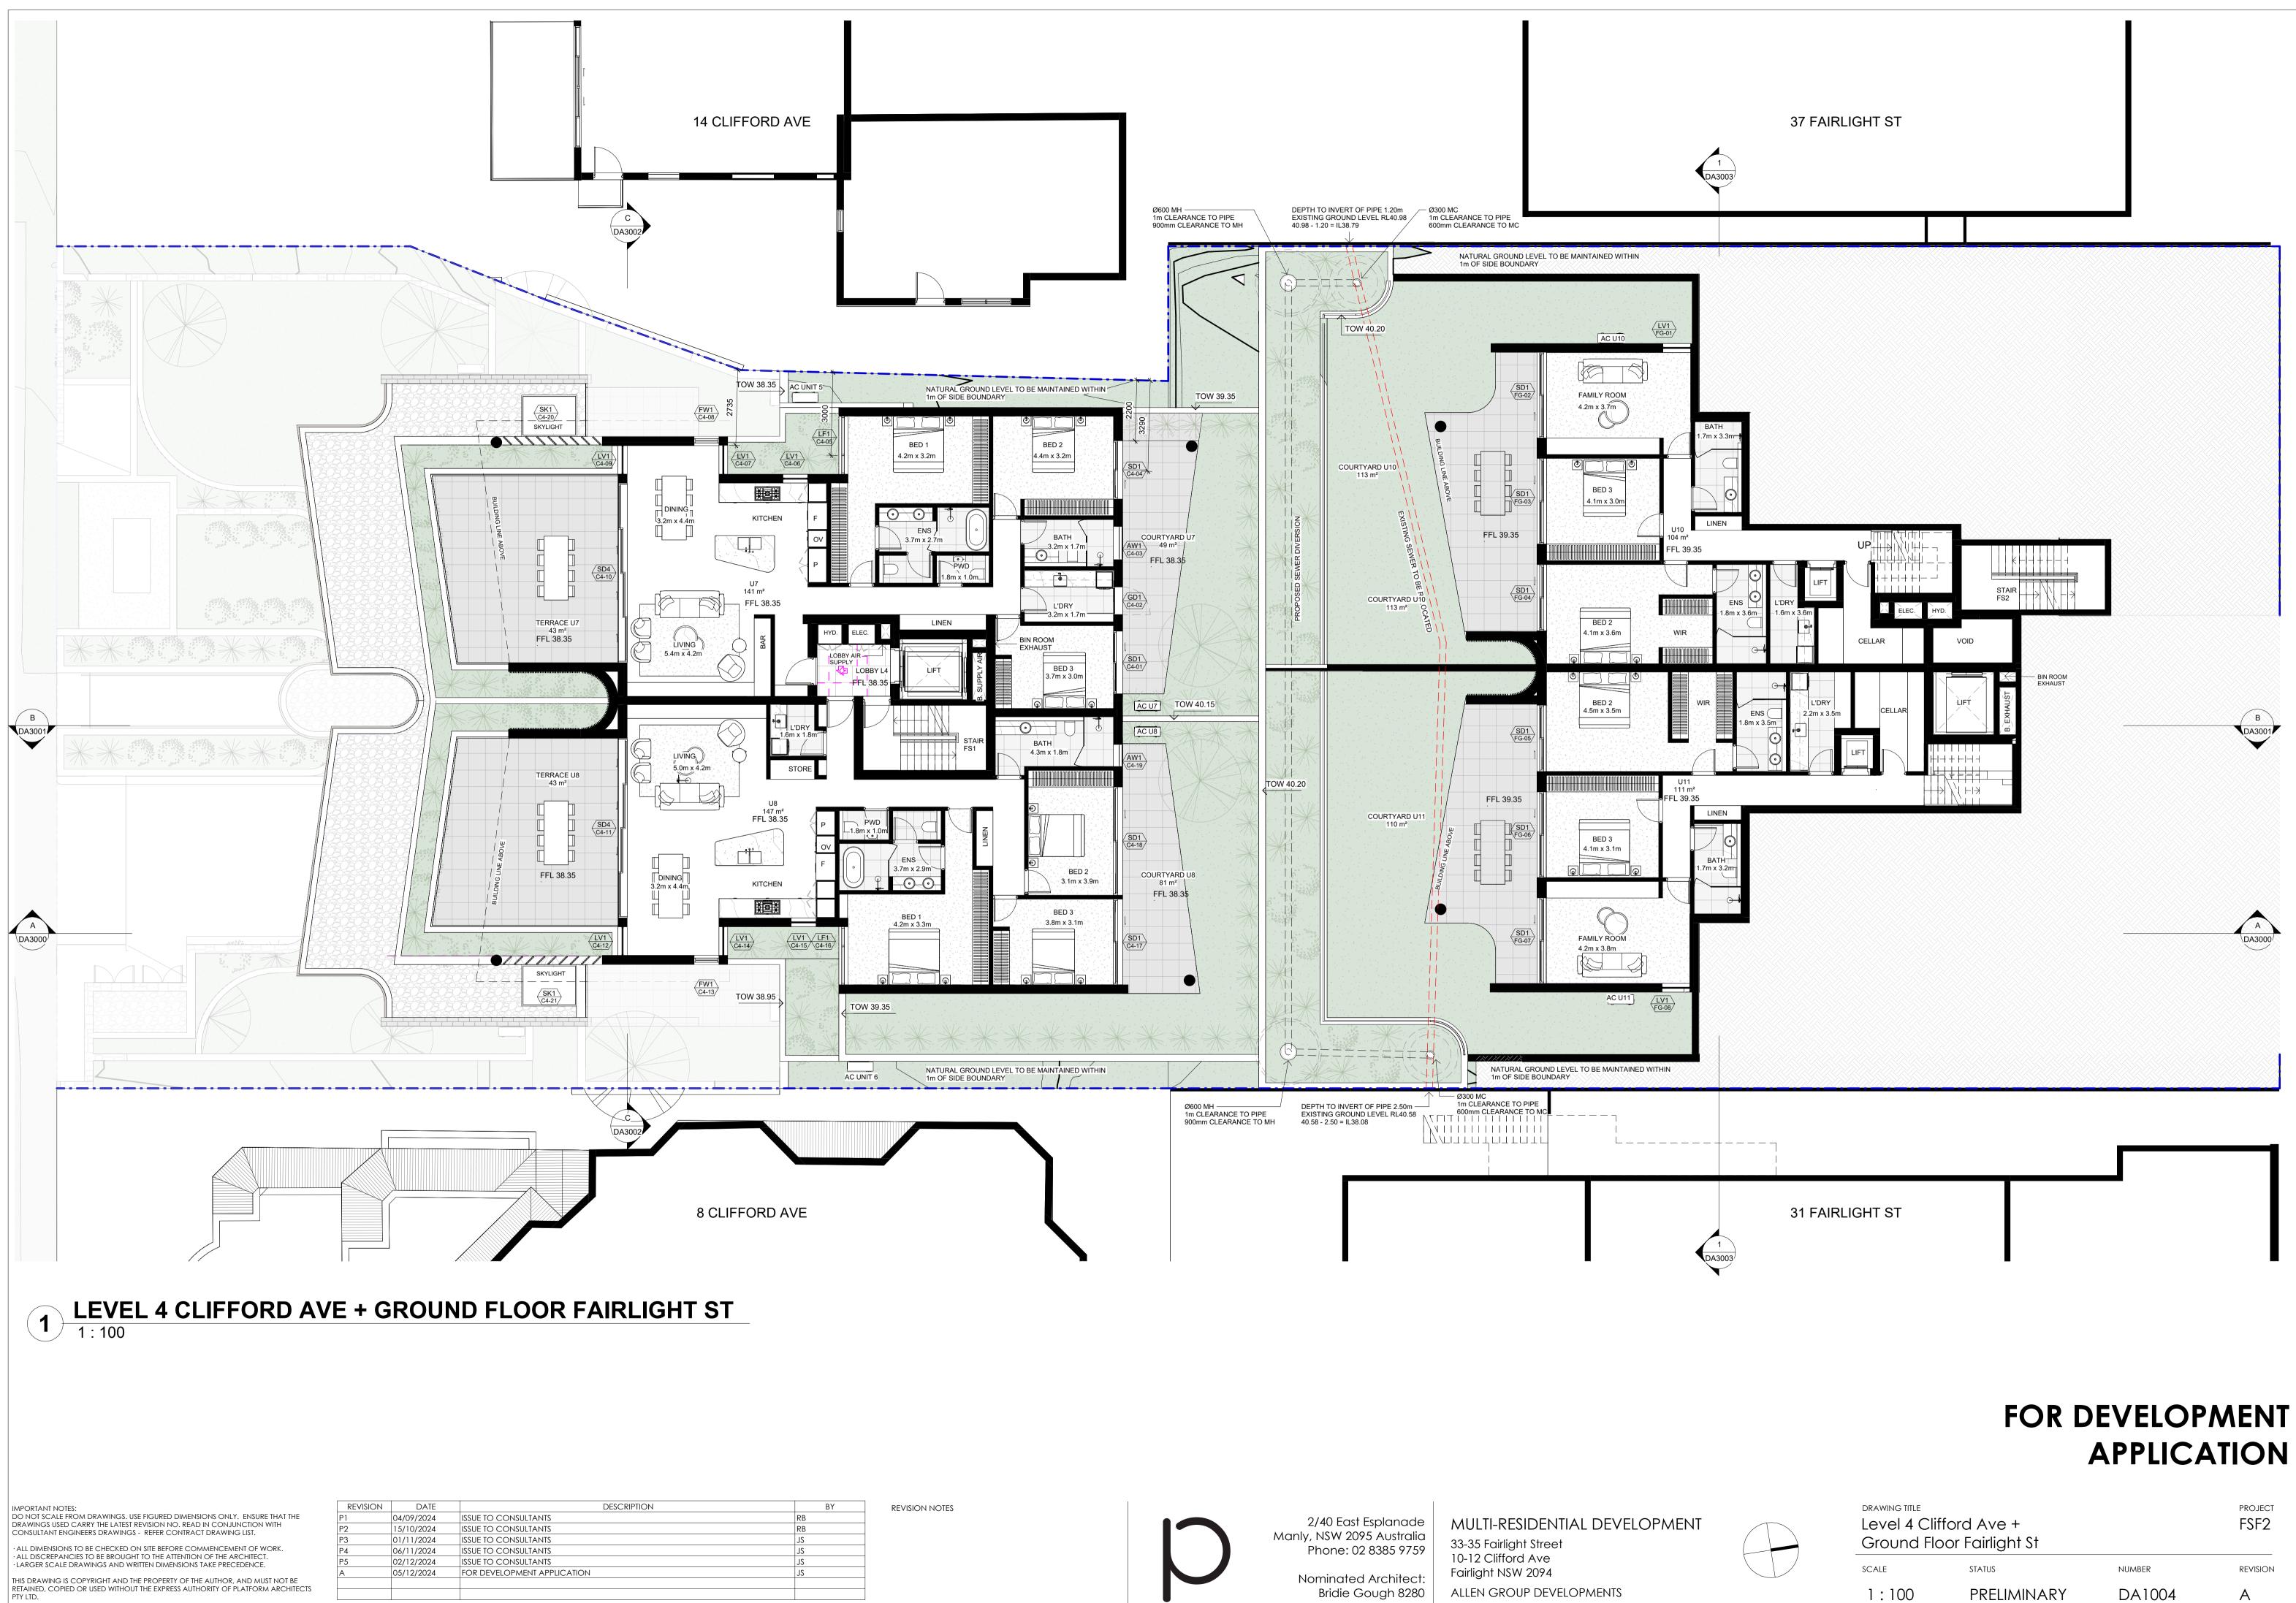


APPLICATION

PRELIMINARY



APPLICATION

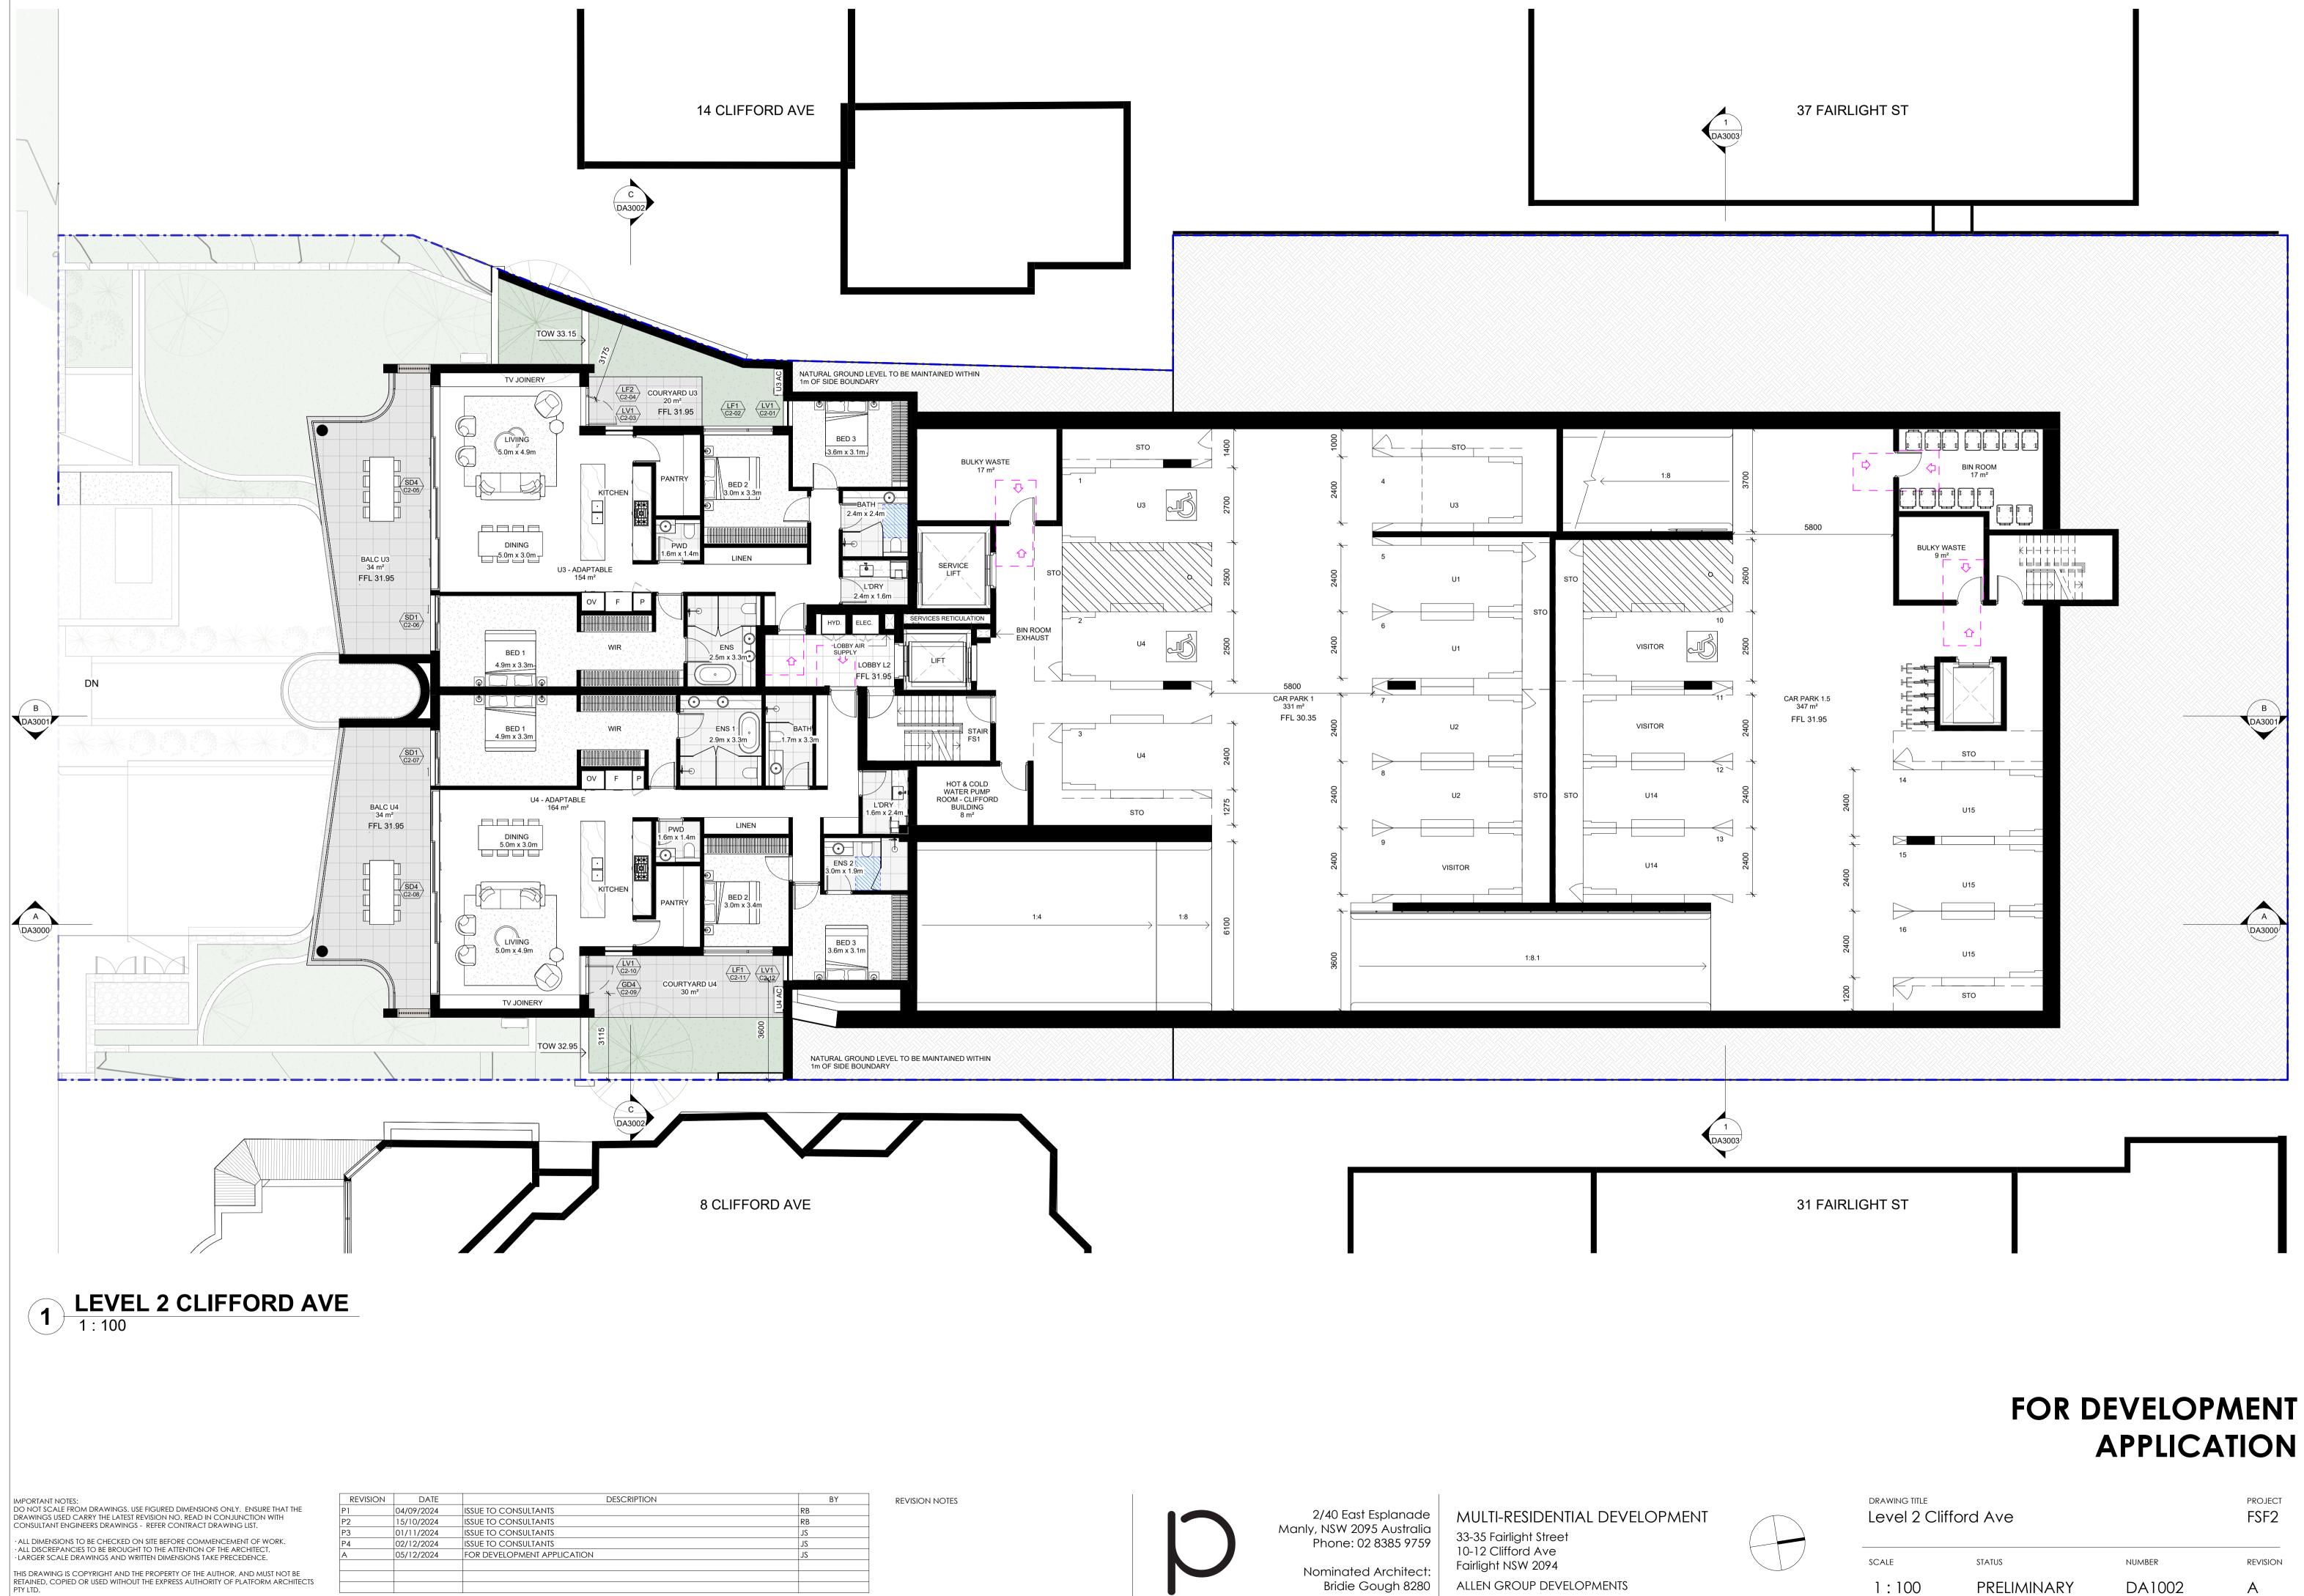


Bridie Gough 8280


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REVISION NOTES

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2/40 East Esplanade Manly, NSW 2095 Australia Phone: 02 8385 9759

> Nominated Architect: Bridie Gough 8280

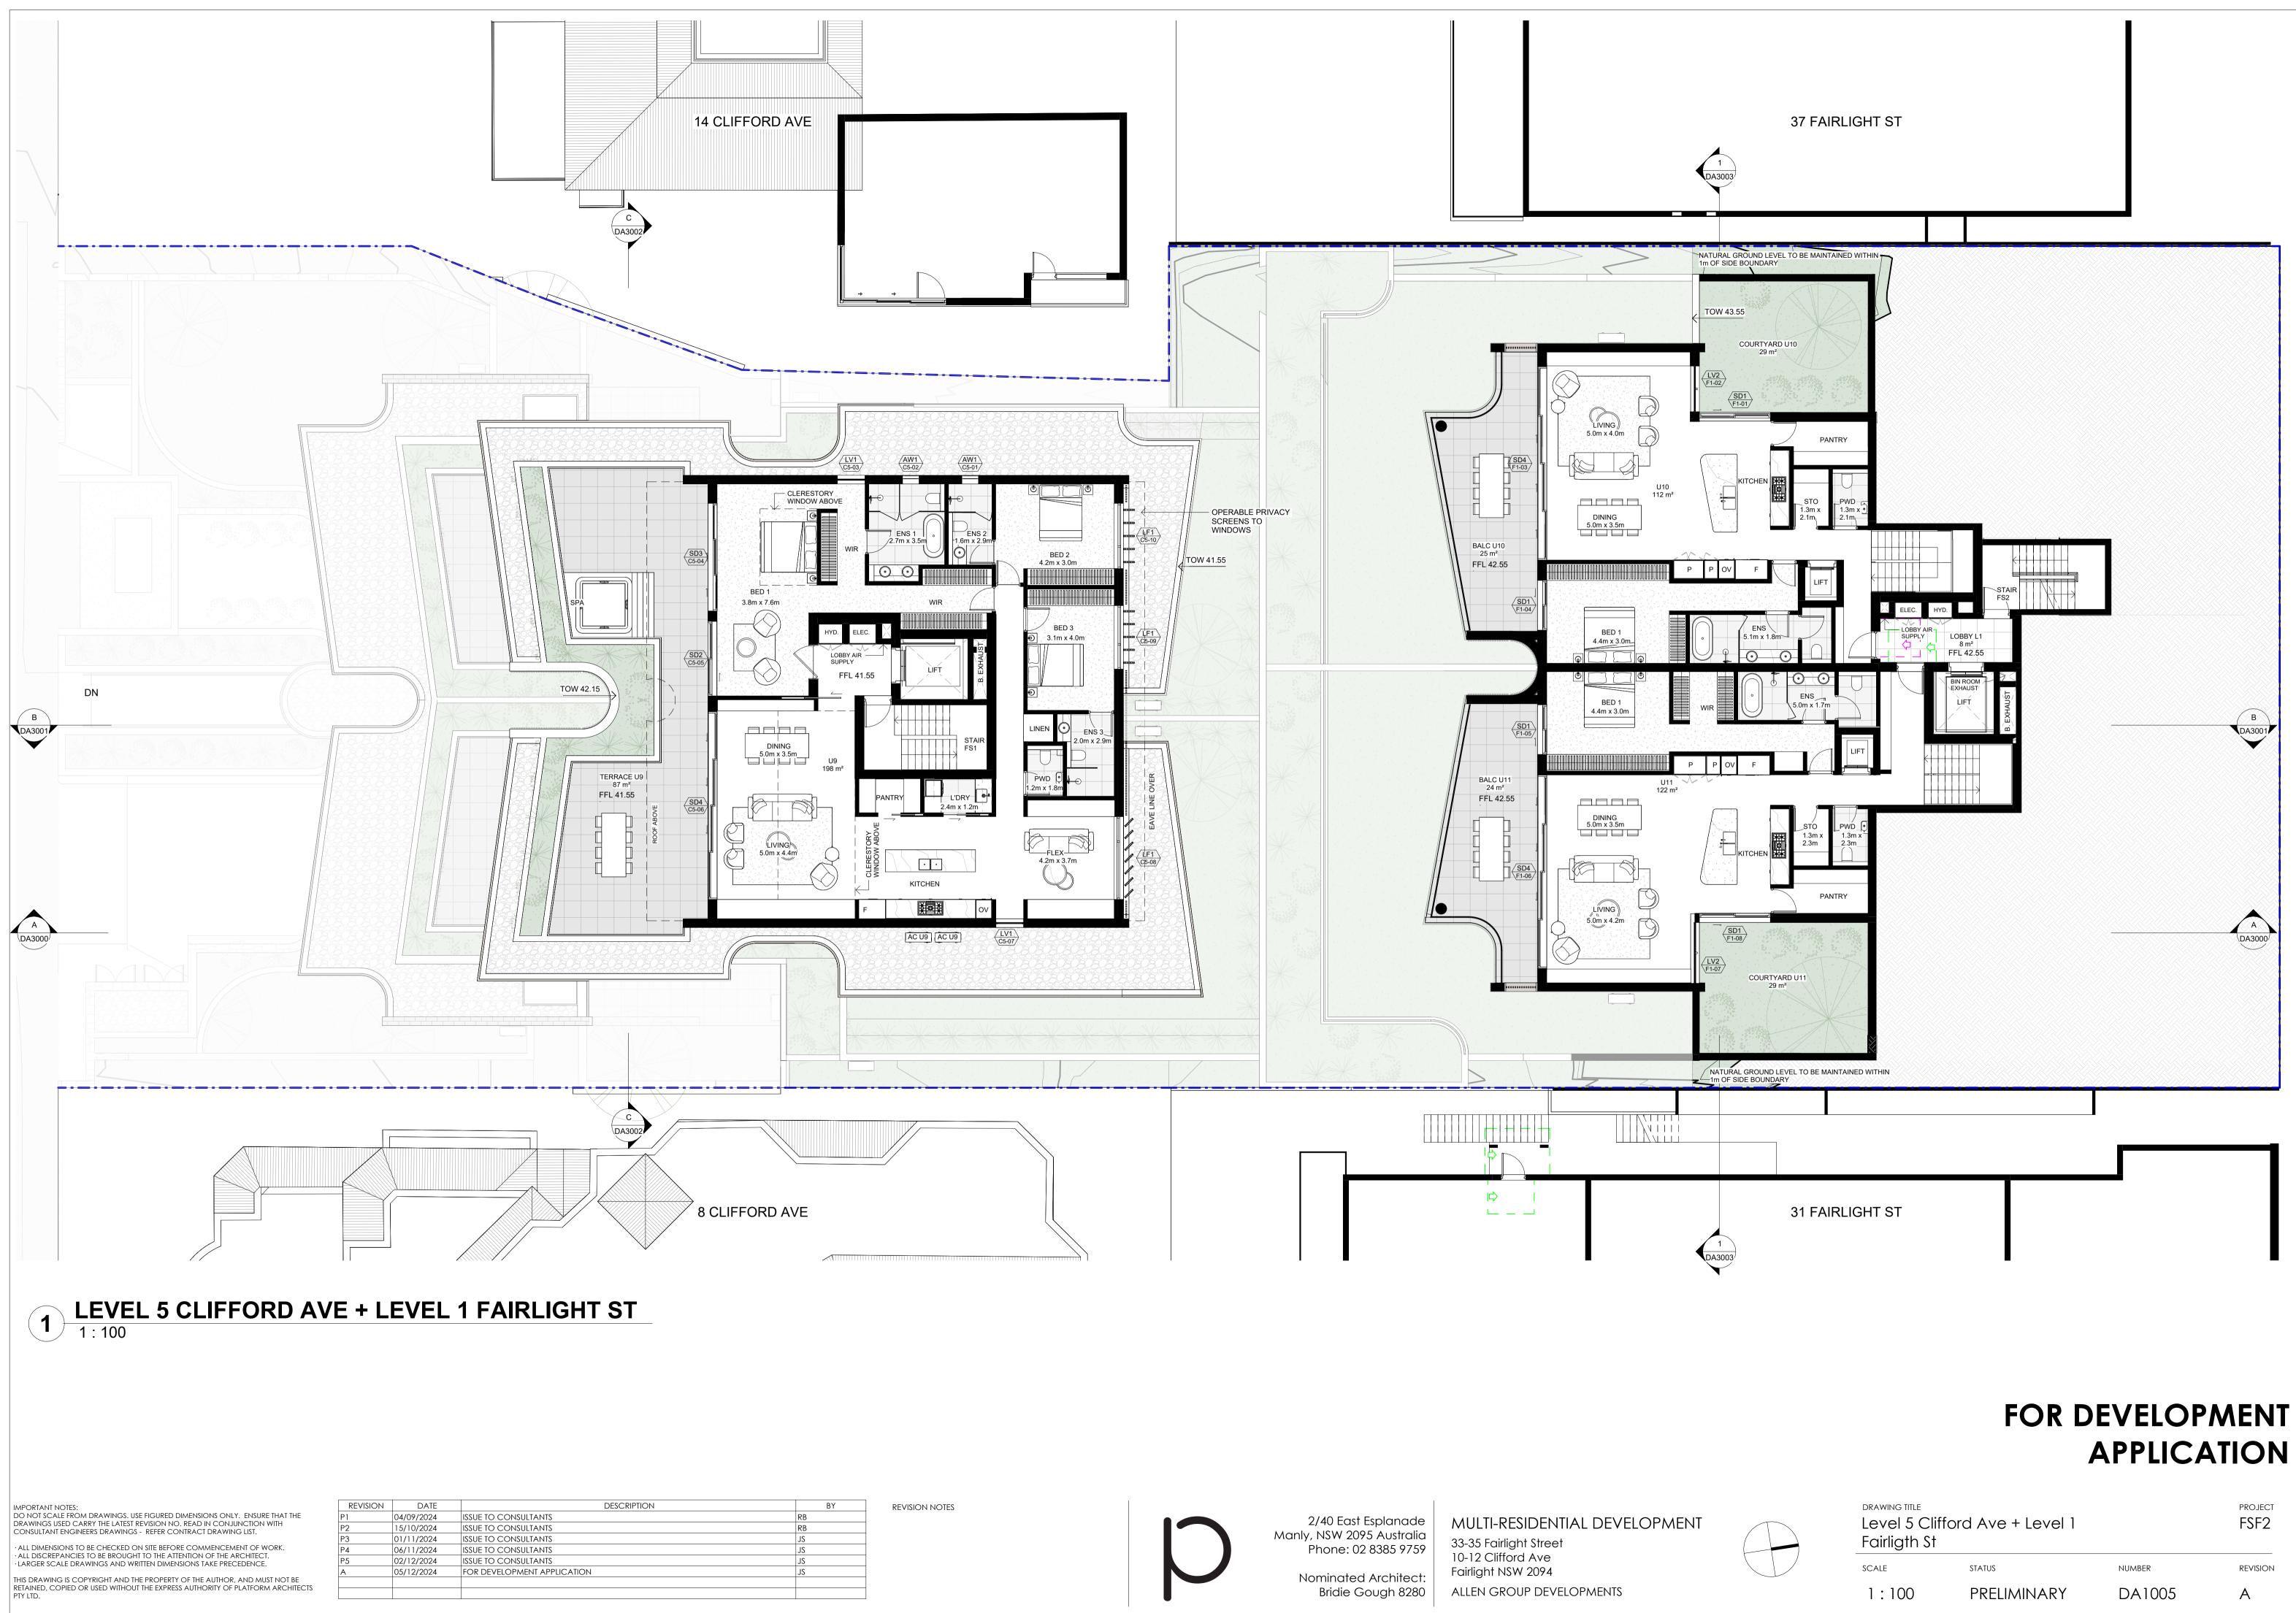MULTI-RESIDENTIAL DEVELOPMENT 33-35 Fairlight Street 10-12 Clifford Ave Fairlight NSW 2094 ALLEN GROUP DEVELOPMENTS

FOR DEVELOPMENT APPLICATION

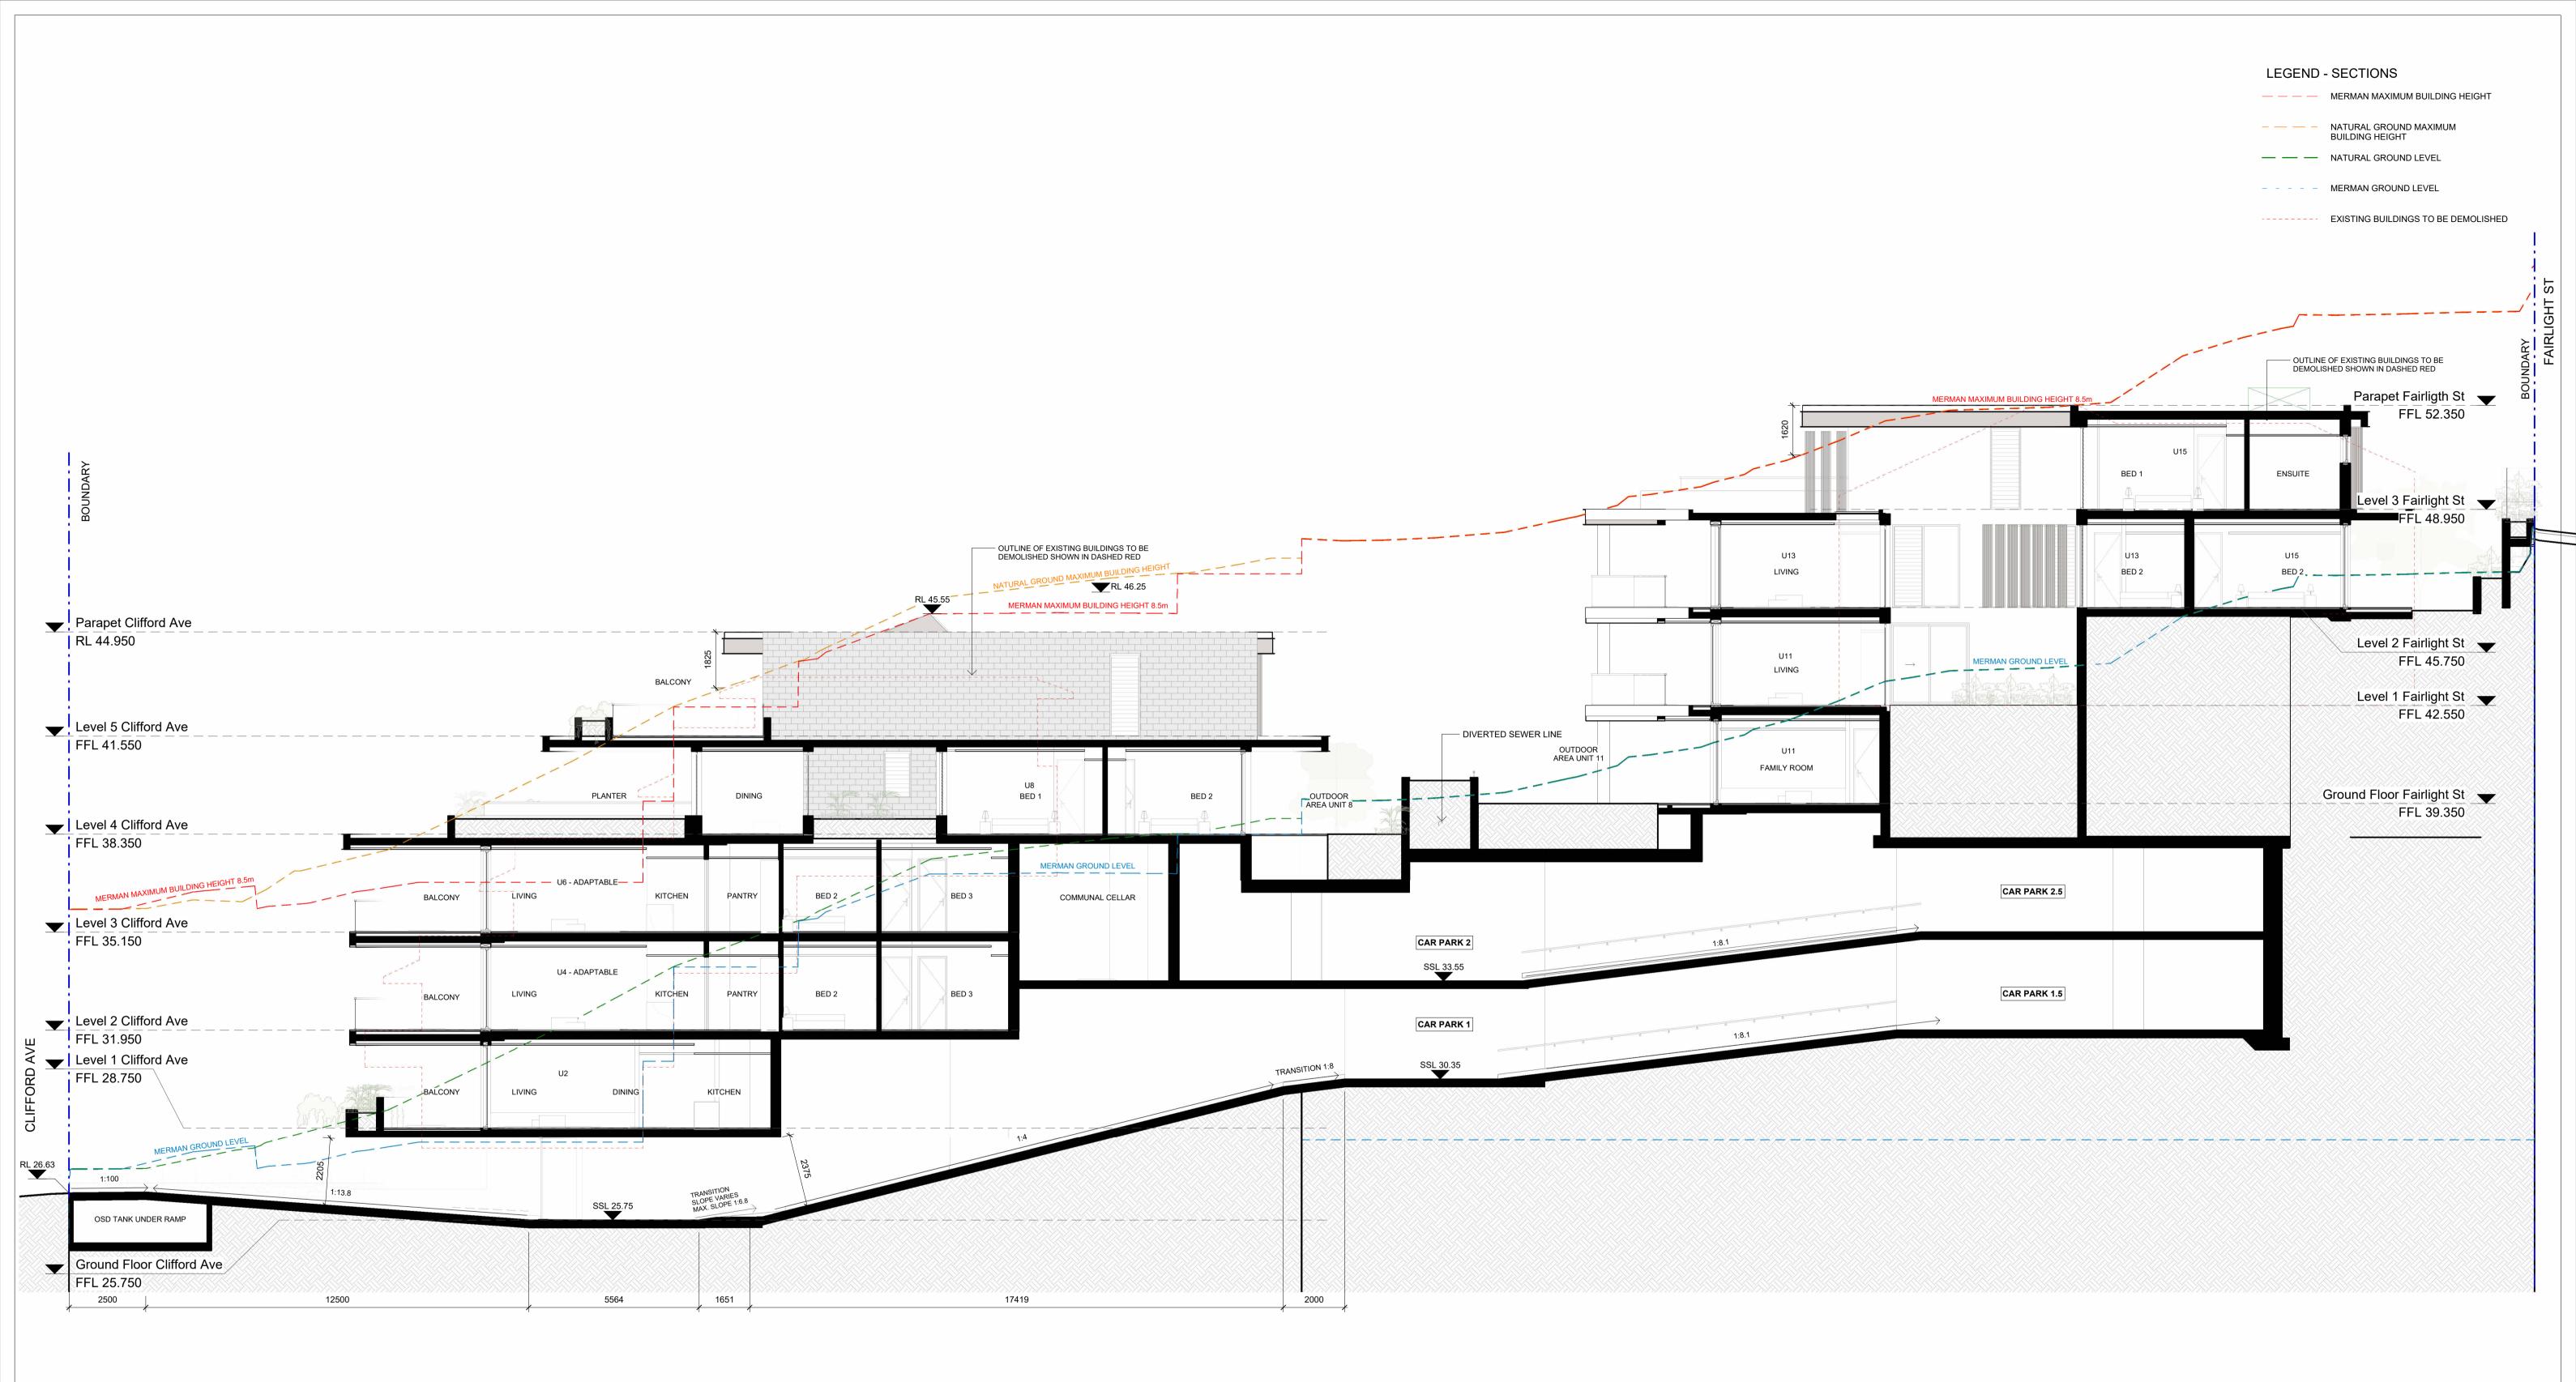DRAWING TITLE

project

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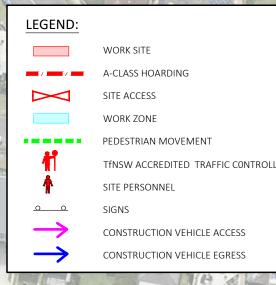
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Attachment 2

Traffic Guidance Scheme (TGS)

Vehicle Movement Plan (VMP)

Pedestrian Movement Plan (PMP)



CERTIFICATION

THE UNDERSIGNED HAS COMPLETED AND OBTAINED "PREPARE A WORK ZONE TRAFFIC MANAGEMENT PLAN" CARD NO. TCT1029978 DATE OF ISSUE: 19/09/2022 PREPARE A WORK ZONE TMP CARD YI YUN NG

NOTES:

ALL SIGNS SHALL BE MINIMUM SIZE A. ALL SIGNS SHALL BE CLASS 1 RETROREFLECTIVE. LOCATION OF SIGNS SHALL BE CONFIRMED ON-SITE TO ENSURE PROPRIATE VISIBILITY.

4. ALL SIGNAGE SHALL BE CLEAN, CLEARLY VISIBLE AND NOT OBSCURED.

 ALL TRAFFIC CONTROL PLANS SHALL BE IMPLEMENTED IN ACCORDANCE WITH THE TMSW "TRAFFIC CONTROL AT WORK SITES" MANUAL, VER 6 (TMSW 2020) AND AUSTRALIAN STANDARDS AS1742.3:2009 MANUAL OF UNIFORM TRAFFIC CONTROL DEVICES, PART 3: TRAFFIC CONTROL DEVICES FOR WORKS ON ROADS.

5. THIS TRAFFIC CONTROL PLAN SHALL BE SET UP BY A PERSON HOLDING AN "IMPLEMENT TRAFFIC MANAGEMENT PLAN" TICKET AND THE TINSW TRAFFIC CONTROL AT WORK SITES CHECKLIST SHALL BE COMPLETED PRIOR TO IMPLEMENTATION. THE ACCREDITED PERSONNEL SHALL IMPLEMENT THE APPROVED

7. THE ACCREDITED PERSONNEL SHALL IMPLEMENT THE APPROVED TCP BEFORE ANY PHYSICAL WORK COMMENCES. ENSURE A COPY OF THE TCP IS KEPT ON-SITE. THE ACCREDITTED PERSONNEL SHALL DRIVE THROUGH THE SITE BEFORE WORKS BEGIN TO ENSURE THAT THE TCP HAS BEEN IMPLEMENTED CORRECTLY AND THAT IT WILL WARN, INSTRUCT AND GUIDE ROAD USERS AS DESIGNED. ANY AMENDMENTS MADE TO THE PLAN MUST BE MARKED ON THE PLAN AND INITIALLED BY THE ACCREDITTED PERSONNEL.

A. IT IS THE RESPONSIBILITY OF AN ACCREDITTED PERSONNEL WITH A PREPARE A WORK ZONE TRAFFIC MANAGEMENT PLAN' TICKET TO

THE INTEGRITY OF ALL TRAFFIC CONTROL MEASURES THROUGH TO THE FINAL REMOVAL. THIS INCLUDES DAILY CHECKS OF ALL SIGNS AND DEVICES. THE CORRESPONDING RECORDS OF CHECKS SHALL BE KEPT ON FILE FOR AUDITING PURPOSES. - VEHICILI AB ACCESS AND SERVICING BEDUIJREMENTS SHALL BE

 - VEHICULAR ACCESS AND SERVICING REQUIREMENTS SHALL BE MAINTAINED AT ALL TIMES TO ADJACENT PROPERTIES AFFECTED BY TRAFFIC CONTROL MEASURES.
 - AT ALL TIMES AN UPTO-DATE COPY OF "TRAFFIC CONTROL AT

- AT ALL TIMES AN UP-TO-DATE COPY OF "TRAFFIC CONTROL AT WORK SITES" SHALL BE AVAILABLE FOR REFERENCE AND IMPLEMENTATION AS REQUIRED ON-SITE. ALL WORKERS WILL BE CONFINED TO THE DEDICATED WORKS AREA

SHOWN ON THE PLAN.

 IT IS THE CONTRACTOR'S DUTY TO ENSURE THAT THE APPROPRIATE MEASURES ARE TAKEN TO PROVIDE A SAFE ENVIRONMENT FOR VEHICLES AND PEDESTRIANS TO RELEVANT AUSTRALIAN STANDARDS WHEN THE WORKSITE IS LEFT UNATTENDED.

11. WHEN TRAFFIC CONTROLLER/S ARE NOT ON SITE, TRAFFIC CONTROLLER (11-34) AND PREPARE TO STOP (11-18) SIGNS SHALL BE COVERED OR REMOVED. 12. ROADWORK SIGNS SHALL BE COVERED OR REMOVED WHEN

WORKERS ARE NOT ON SITE. 13. NOT ALL DIMENSIONS SHOWN ARE TO SCALE. 14. ALL WORKERS MUST ADHERE TO THE APPLICABLE SAFE WORK

 ALL WORKERS MOST ADDREE TO THE APPLICABLE SAFE WORK DISTANCE AS DESCRIBED IN AS1742.3:2009
 ALL DISTANCES BETWEEN SIGNS SHALL BE IN ACCORDANCE WITH

SECTION 2.5.2 OF AS1742.3:2009, HOWEVER, MODIFICATIONS CAN BE MADE TO SUIT SITE CONDITIONS.

| 33-35 FAIRLIGHT STREET AND 10-12 CLIFFORD AV | /ENUE, FAIRLIGHT |
|--|-----------------------|
| PROPOSED MIXED-USE DEVELOPMENT | |
| TRAFFIC GUIDANCE SCHEME - TRUCK ACCESS DUR | RING EARLY DEMOLITION |
| DRAWING REF NO. 24070-v1.3-TGS | SHEET NO. 01 OF 03 |

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| | | | | GHT STREET | 40.0m | |
| | | | | | | |
| | N40.0 | | 40.0m CLIFFORD AVENU | | | |
| | | | | | 40.0m | 40.0m |
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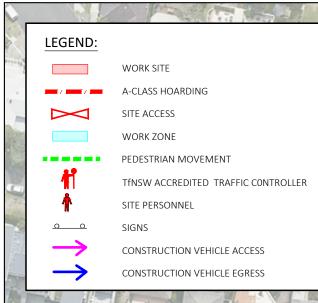
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DESIGNED BY RE A.XIA B. SCALE 0 10.0 20.0 A3

View.

ISSUE DATE 9 December 2024





CERTIFICATION

THE UNDERSIGNED HAS COMPLETED AND OBTAINED "PREPARE A WORK ZONE TRAFFIC MANAGEMENT PLAN" CARD NO. TCT1029978 DATE OF ISSUE: 19/09/2022 PREPARE A WORK ZONE TMP CARD YI YUN NG

NOTES:

ALL SIGNS SHALL BE MINIMUM SIZE A. ALL SIGNS SHALL BE CLASS 1 RETROREFLECTIVE. LOCATION OF SIGNS SHALL BE CONFIRMED ON-SITE TO ENSURE PROPRIATE VISIBILITY.

ALL SIGNAGE SHALL BE CLEAN, CLEARLY VISIBLE AND NOT BSCURED.

ALL TRAFFIC CONTROL PLANS SHALL BE IMPLEMENTED IN CCORDANCE WITH THE TRNSW "TRAFFIC CONTROL AT WORK SITES" AANUAL, VER 6 (TfNSW 2020) AND AUSTRALIAN STANDARDS AS1742.3:2009 MANUAL OF UNIFORM TRAFFIC CONTROL DEVICES, PART 8: TRAFFIC CONTROL DEVICES FOR WORKS ON ROADS.

OLDING AN "IMPLEMENT TRAFFIC MANAGEMENT PLAN" TICKET AND THE TFNSW TRAFFIC CONTROL AT WORK SITES CHECKLIST SHALL BE COMPLETED PRIOR TO IMPLEMENTATION.

THE ACCREDITTED PERSONNEL SHALL IMPLEMENT THE APPROVED TCP BEFORE ANY PHYSICAL WORK COMMENCES. ENSURE A COPY OF THE TCP IS KEPT ON-SITE. THE ACCREDITTED PERSONNEL SHALL DRIVE THROUGH THE SITE BEFORE WORKS BEGIN TO ENSURE THAT THE TCP HA BEEN IMPLEMENTED CORRECTLY AND THAT IT WILL WARN, INSTRUCT AND GUIDE ROAD USERS AS DESIGNED, ANY AMENDMENTS MADE TO TH PLAN MUST BE MARKED ON THE PLAN AND INITIALLED BY THE ACCREDITTED PERSONNEL.

8. IT IS THE RESPONSIBILITY OF AN ACCREDITTED PERSONNEL WITH A PREPARE A WORK ZONE TRAFFIC MANAGEMENT PLAN' TICKET TO NSURE THE FOLLOWING

 THE INTEGRITY OF ALL TRAFFIC CONTROL MEASURES THROUGH TO
 THE FINAL REMOVAL. THIS INCLUDES DAILY CHECKS OF ALL SIGNS AND DEVICES. THE CORRESPONDING RECORDS OF CHECKS SHALL BE KEPT ON FILE FOR AUDITING PURPOSES.

 - VEHICULAR ACCESS AND SERVICING REQUIREMENTS SHALL BE
 MAINTAINED AT ALL TIMES TO ADJACENT PROPERTIES AFFECTED BY TRAFFIC CONTROL MEASURES.

AT ALL TIMES AN UP-TO-DATE COPY OF "TRAFFIC CONTROL AT WORK SITES" SHALL BE AVAILABLE FOR REFERENCE AND IMPLEMENTATION AS REQUIRED ON-SITE. ALL WORKERS WILL BE CONFINED TO THE DEDICATED WORKS AREA

OWN ON THE PLAN. 10. IT IS THE CONTRACTOR'S DUTY TO ENSURE THAT THE APPROPRIATE MEASURES ARE TAKEN TO PROVIDE A SAFE ENVIRONMENT FOR VEHICLES

AND PEDESTRIANS TO RELEVANT AUSTRALIAN STANDARDS WHEN THE WORKSITE IS LEFT UNATTENDED. 11. WHEN TRAFFIC CONTROLLER/S ARE NOT ON SITE, TRAFFIC CONTROLLER (T1-34) AND PREPARE TO STOP (T1-18) SIGNS SHALL BE

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CTION 2.5.2 OF AS1742.3:2009. HOWEVER, MODIFICATIONS CAN BE E TO SUIT SITE CONDITIONS.

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| 33-35 FAIRLIGHT STREET AND | 10-12 CLIFFORD AVENUE | , FAIRLIGHT | | |
| PROPOSED MIXED-USE DEVEL | OPMENT | | | |
| TRAFFIC GUIDANCE SCHEME - | TRUCK ACCESS DURING D | EMOLITION AND EXCA | VATION | |
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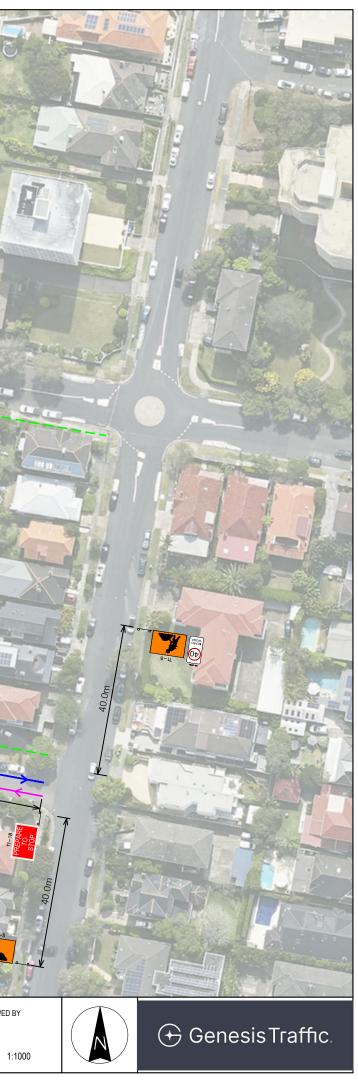
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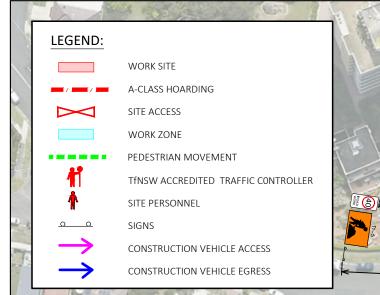
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| A.XIA | | | B.LO |
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CERTIFICATION

THE UNDERSIGNED HAS COMPLETED AND OBTAINED "PREPARE A WORK ZONE TRAFFIC MANAGEMENT PLAN" CARD NO. TCT1029978 DATE OF ISSUE: 19/09/2022 PREPARE A WORK ZONE TMP CARD YI YUN NG

NOTES:

ALL SIGNS SHALL BE MINIMUM SIZE A. ALL SIGNS SHALL BE CLASS 1 RETROREFLECTIVE. LOCATION OF SIGNS SHALL BE CONFIRMED ON-SITE TO ENSURE PROPRIATE VISIBILITY.

ALL SIGNAGE SHALL BE CLEAN, CLEARLY VISIBLE AND NOT SCURED.

ALL TRAFFIC CONTROL PLANS SHALL BE IMPLEMENTED IN CORDANCE WITH THE TFNSW "TRAFFIC CONTROL AT WORK SITES" AANUAL, VER 6 (TfNSW 2020) AND AUSTRALIAN STANDARDS AS1742.3:2009 MANUAL OF UNIFORM TRAFFIC CONTROL DEVICES, PART B: TRAFFIC CONTROL DEVICES FOR WORKS ON ROADS.

THIS TRAFFIC CONTROL PLAN SHALL BE SET UP BY A PERSON OLDING AN "IMPLEMENT TRAFFIC MANAGEMENT PLAN" TICKET AND THE TFNSW TRAFFIC CONTROL AT WORK SITES CHECKLIST SHALL BE COMPLETED PRIOR TO IMPLEMENTATION. THE ACCREDITTED PERSONNEL SHALL IMPLEMENT THE APPROVED

TCP BEFORE ANY PHYSICAL WORK COMMENCES. ENSURE A COPY OF THI TCP IS KEPT ON-SITE. THE ACCREDITTED PERSONNEL SHALL DRIVE THROUGH THE SITE BEFORE WORKS BEGIN TO ENSURE THAT THE TCP HA BEEN IMPLEMENTED CORRECTLY AND THAT IT WILL WARN, INSTRUCT AND GUIDE ROAD USERS AS DESIGNED, ANY AMENDMENTS MADE TO TH PLAN MUST BE MARKED ON THE PLAN AND INITIALLED BY THE ACCREDITTED PERSONNEL.

3. IT IS THE RESPONSIBILITY OF AN ACCREDITTED PERSONNEL WITH A PREPARE A WORK ZONE TRAFFIC MANAGEMENT PLAN' TICKET TO NSURE THE FOLLOWING

 THE INTEGRITY OF ALL TRAFFIC CONTROL MEASURES THROUGH TO
 THE FINAL REMOVAL. THIS INCLUDES DAILY CHECKS OF ALL SIGNS AND DEVICES. THE CORRESPONDING RECORDS OF CHECKS SHALL BE KEPT ON FILE FOR AUDITING PURPOSES. - VEHICULAR ACCESS AND SERVICING REQUIREMENTS SHALL BF

MAINTAINED AT ALL TIMES TO ADJACENT PROPERTIES AFFECTED BY TRAFFIC CONTROL MEASURES. AT ALL TIMES AN UP-TO-DATE COPY OF "TRAFFIC CONTROL AT WORK SITES" SHALL BE AVAILABLE FOR REFERENCE AND

IMPLEMENTATION AS REQUIRED ON-SITE. ALL WORKERS WILL BE CONFINED TO THE DEDICATED WORKS AREA

HOWN ON THE PLAN.

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IT IS THE CONTRACTOR'S DUTY TO ENSURE THAT THE APPROPRIATI MEASURES ARE TAKEN TO PROVIDE A SAFE ENVIRONMENT FOR VEHICLES AND PEDESTRIANS TO RELEVANT AUSTRALIAN STANDARDS WHEN THE WORKSITE IS LEFT UNATTENDED.

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ECTION 2.5.2 OF AS1742.3:2009. HOWEVER, MODIFICATIONS CAN BE DE TO SUIT SITE CONDITIONS.

| 33-35 FAIRLIGHT STREET AND 10-12 CLIFFORD AVENUE, FAIRLIGHT | | | | |
|---|--------------------|--|--|--|
| PROPOSED MIXED-USE DEVELOPMENT | | | | |
| TRAFFIC GUIDANCE SCHEME - TRUCK ACCESS DURING CONSTRUCTION AND FITOUT | | | | |
| DRAWING REF NO. 24070-V1.3-TGS | SHEET NO. 03 OF 03 | | | |

ISSUE DATE 9 December 2024

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FAIRLIGHT STREET

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| A.XIA | | | B.LO | |
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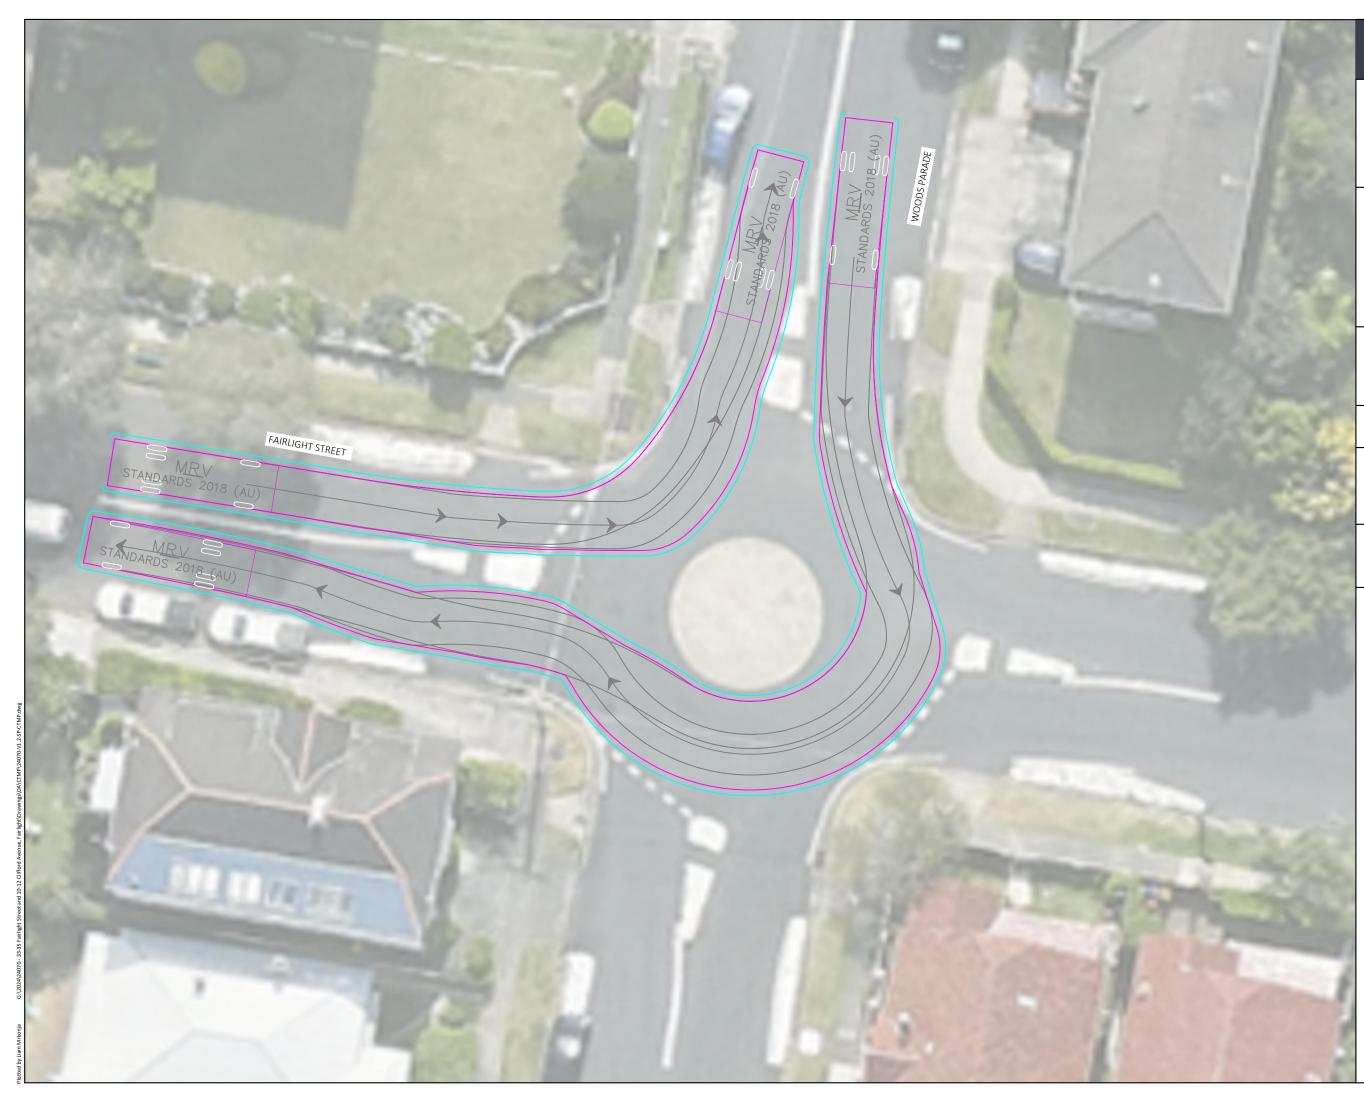
Attachment 3

Swept Path Analysis





| | 🕂 Genesis Traffic. |
|-----------------|---|
| | PROJECT 33-35 FAIRLIGHT STREET AND 10-12 CLIFFORD AVENUE, FAIRLIGHT |
| | TITLE OVERVIEW |
| | EARLY DEMOLITION |
| | SCALE 1:2000 A3 20.0 40.0 |
| YROAD | DESIGNED BY REVIEWED BY A.XIA, L.MRKONJA B.LO |
| | DRAWING REFERENCE (SOURCE): G:\2024\24070 - 33-35 FAIRLIGHT STREET AND 10-12 CLIFFORD AVENUE, FAIRLIGHT\DRAWINGS\DA\20241101 |
| | ISSUE DATE 9 December 2024 SHEET NO. 01 OF 14 |
| | DRAWING REF NO. 24070-V1.2-SP-CTMP |
| AIRLIGHT STREET | MAXIMUM CHANGE IN GRADE FOR CARS SHOULD BE 1:8 OVER 2m MINIMUM HEIGHT CLEARANCE OF 2.2m (TO SERVICES AND STRUCTURE) SHOULD BE PROVIDED ABOVE CIRCULATION AISLES AND PARKING SPACES MINIMUM HEIGHT CLEARANCE OF 2.5m (TO SERVICES AND STRUCTURE) SHOULD BE PROVIDED ABOVE ACCESSIBLE PARKING SPACES MINIMUM HEIGHT CLEARANCE OF 4.5m (TO SERVICES AND STRUCTURE) SHOULD BE PROVIDED ABOVE SERVICE VEHICLE ACCESS ROADWAYS AND LOADING DOCKS HEIGHT CLEARANCE ABOVE A SAG CHANGE IN GRADES SHOULD BE MEASURED IN ACCORDANCE WITH FIGURE 5.3 AS2890.1:2004 |



Genesis Traffic.

PROJECT

33-35 FAIRLIGHT STREET AND 10-12 CLIFFORD AVENUE, FAIRLIGHT

TITLE SWEPT PATH ASSESSMENT

TRUCKS APPROACH FROM WOODS PARADE TO FAIRLIGHT STREET

EARLY DEMOLITION



SCALE A3 1:200

DESIGNED BY A.XIA, L.MRKONJA


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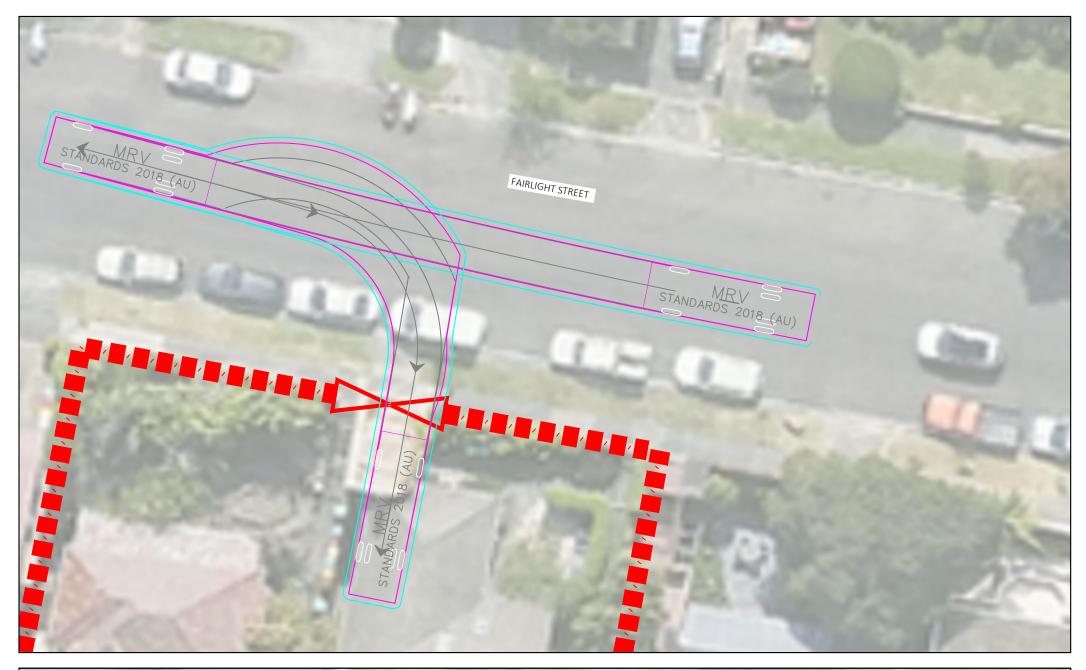
ISSUE DATE 9 December 2024 SHEET NO. DRAWING REF NO. 24070-V1.2-SP-CTMP


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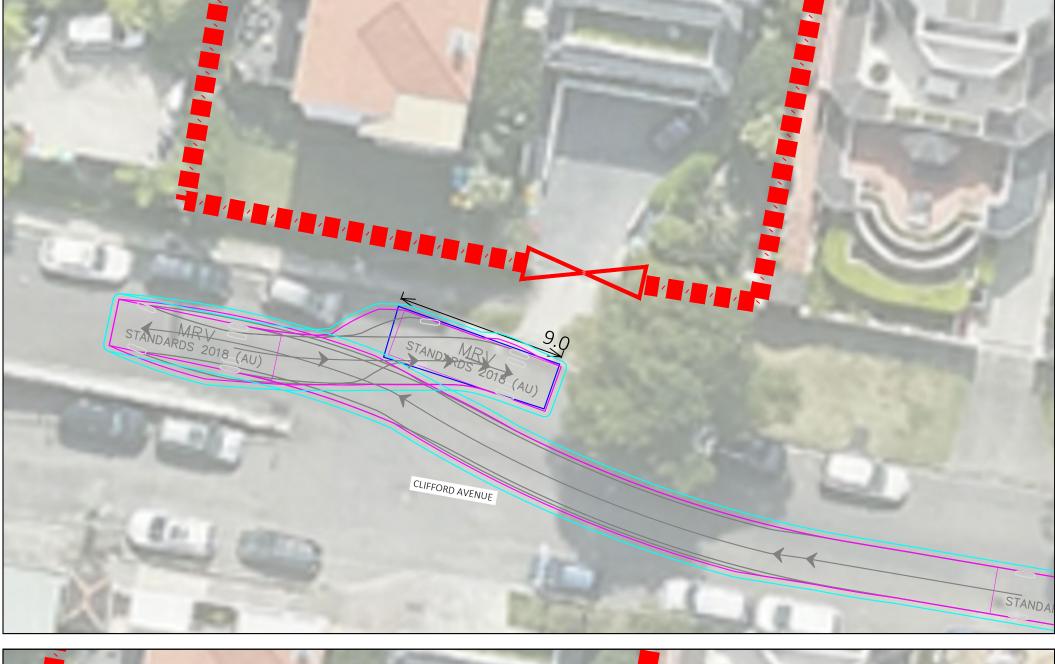
LEGENDS/NOTES





8.80 (\mathbf{O}) (ତ 1.50 5.00 MRV meters wiath : 2.50 Track : 2.50 Lock to Lock Time : 6.0 Steering Angle : 34.0




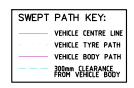


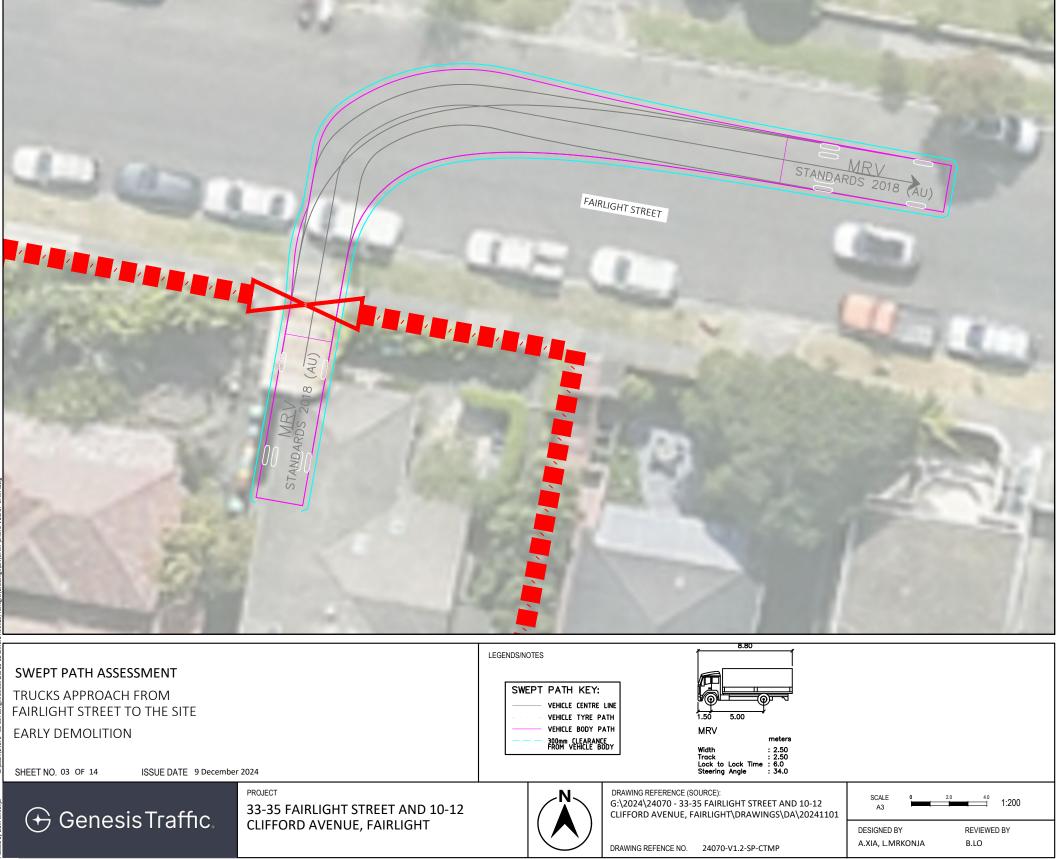

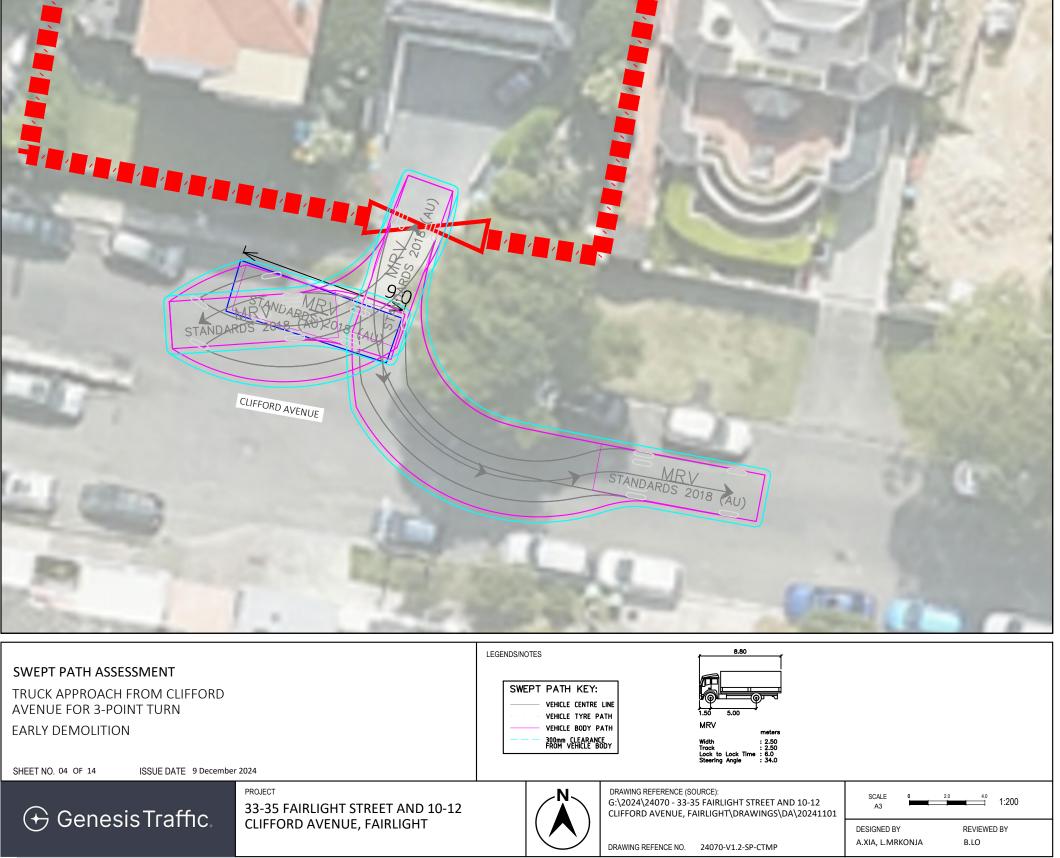

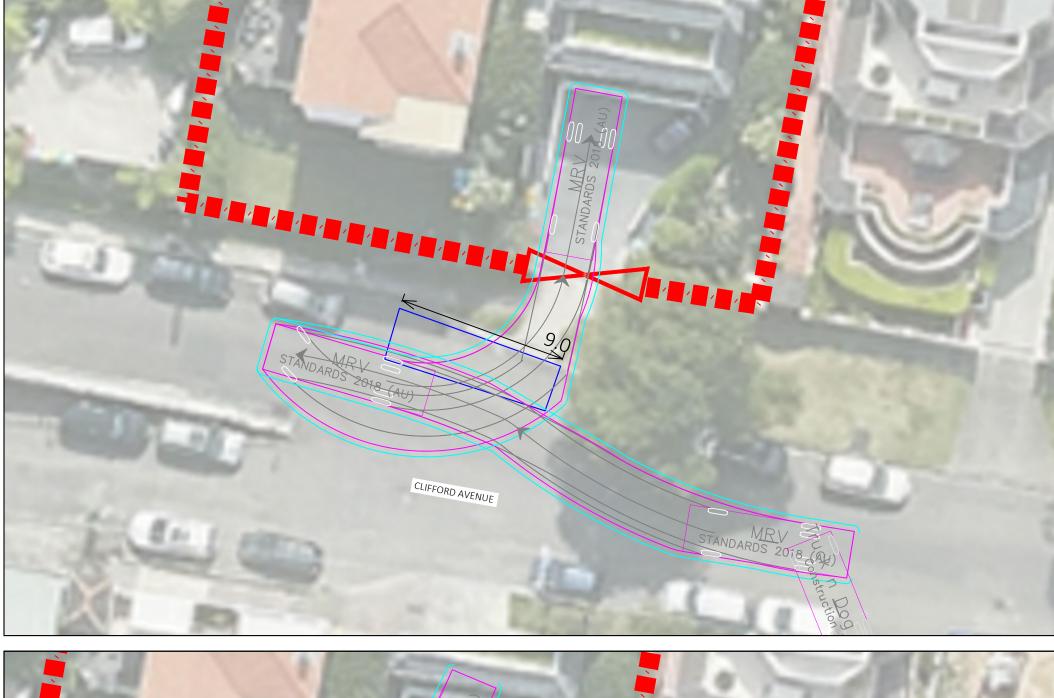

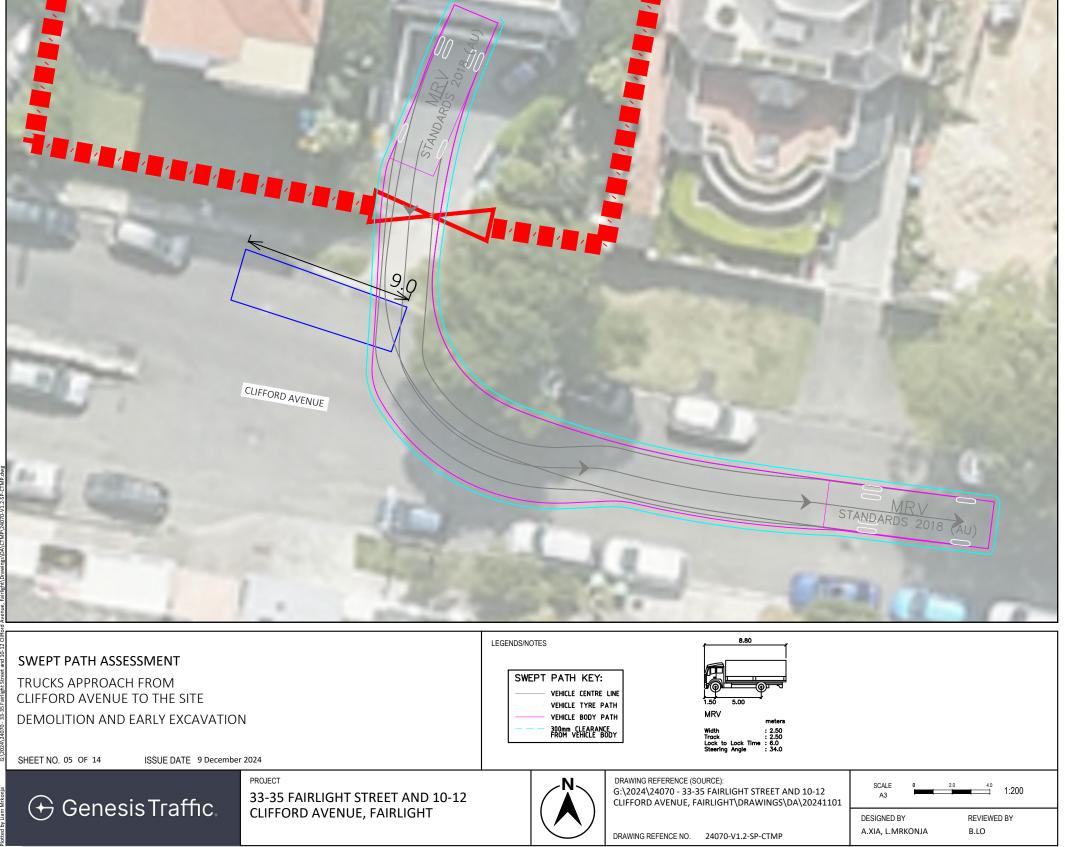

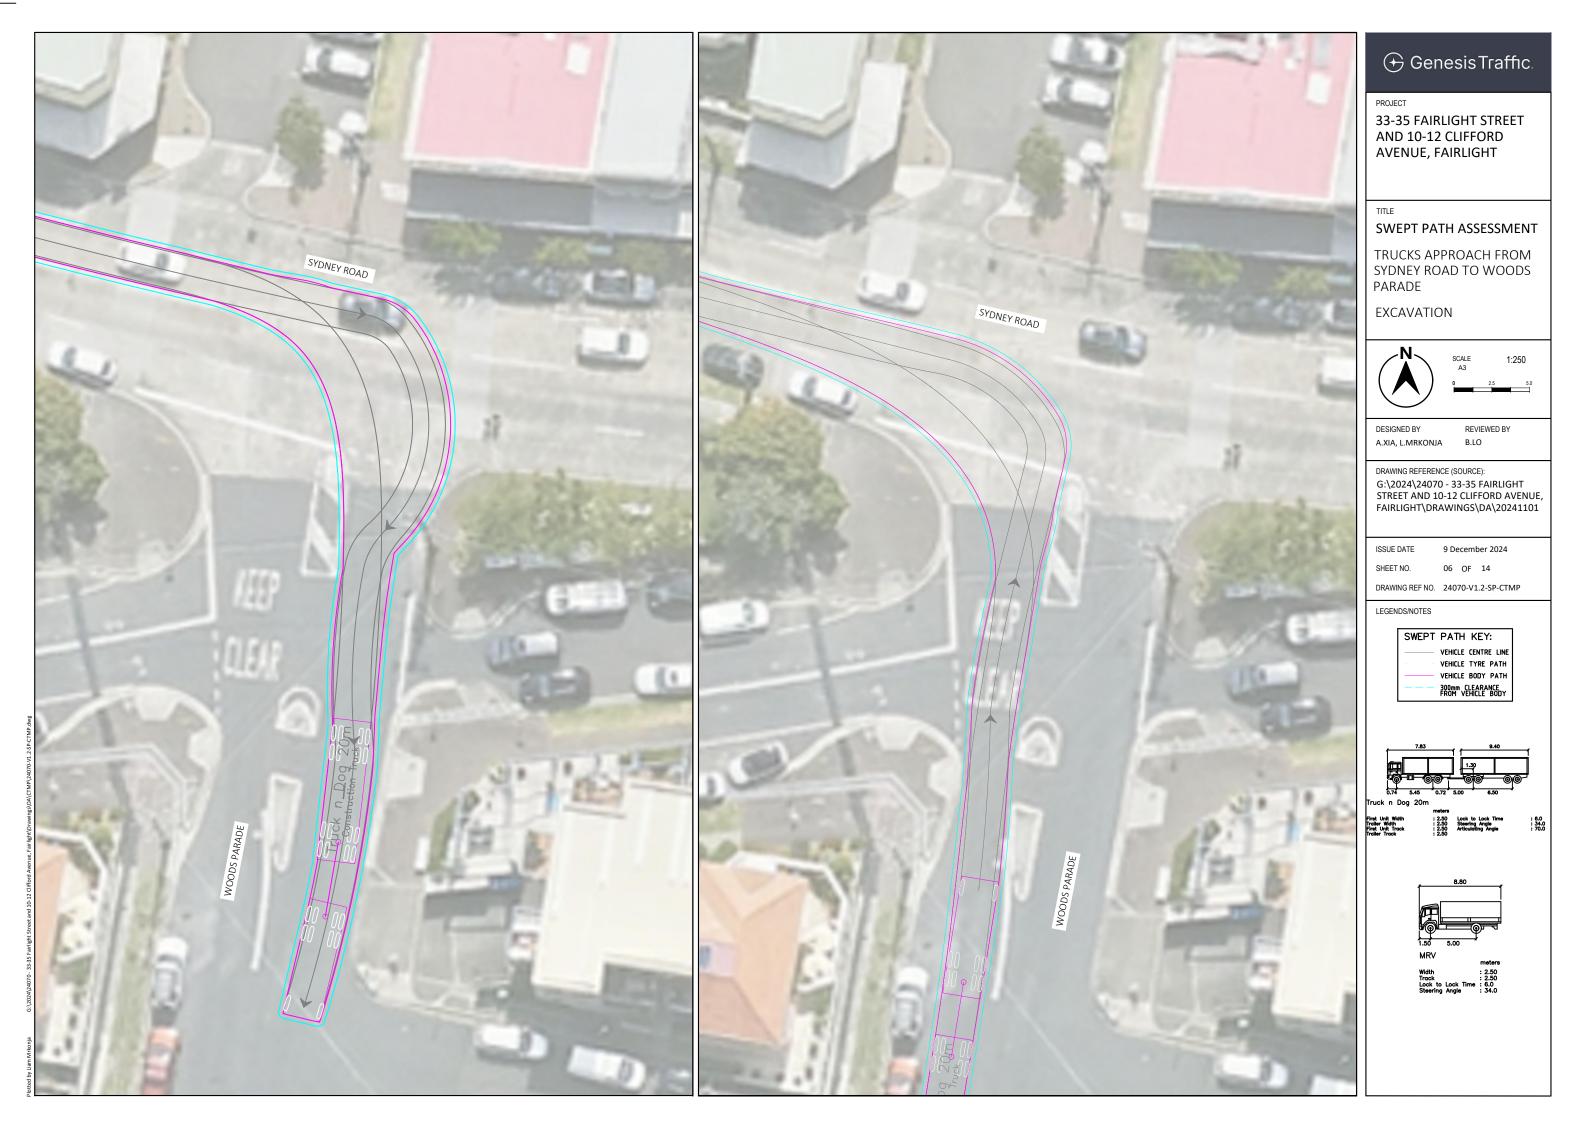














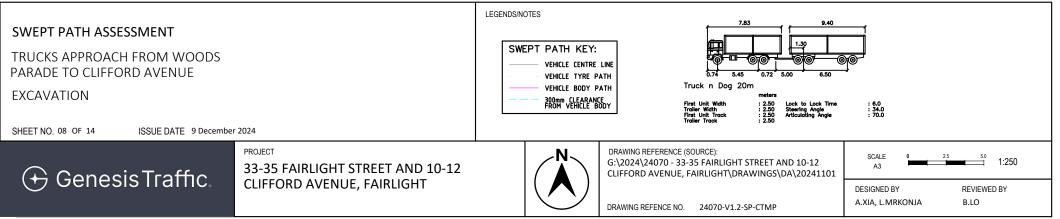






| | | LEGENDS/NOTES | | | |
|---|---|--|--|--|--|
| SWEPT PATH ASSESSMENT | | | | | |
| TRUCKS APPROACH FROM CLIFFORD AVENUE TO THE SITE EXCAVATION | | SWEPT PATH KEY: VEHICLE CENTRE LINE VEHICLE TYRE PATH VEHICLE BODY PATH 300mm CLEARANCE FROM VEHICLE BODY | | 5.74 5.45 ⁺ 0.72 5.00 ⁺ 6.50 ⁺ Truck n Dog 20m metera | |
| SHEET NO. 09 OF 14 ISSUE DATE 9 December 2024 | | | | | |
| 🕂 Genesis Traffic. | PROJECT 33-35 FAIRLIGHT STREET AND 10-12 CLIFFORD AVENUE, FAIRLIGHT | | | DRAWING REFERENCE (SOURCE): G:\2024\24070 - 33-35 FAIRLIGHT STREET AND 10-12 CLIFFORD AVENUE, FAIRLIGHT\DRAWINGS\DA\20241101 | SCALE 0 2.5 5.0 1:250 |
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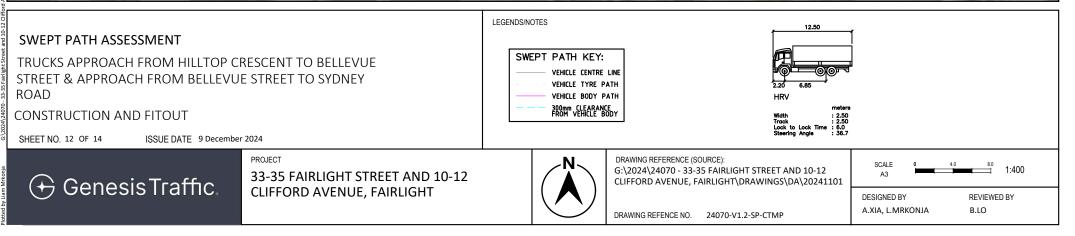











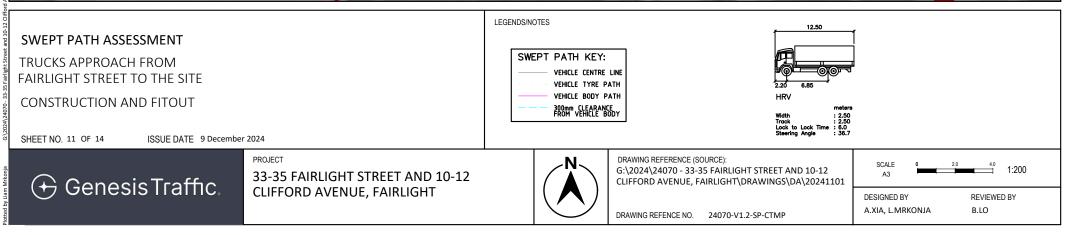




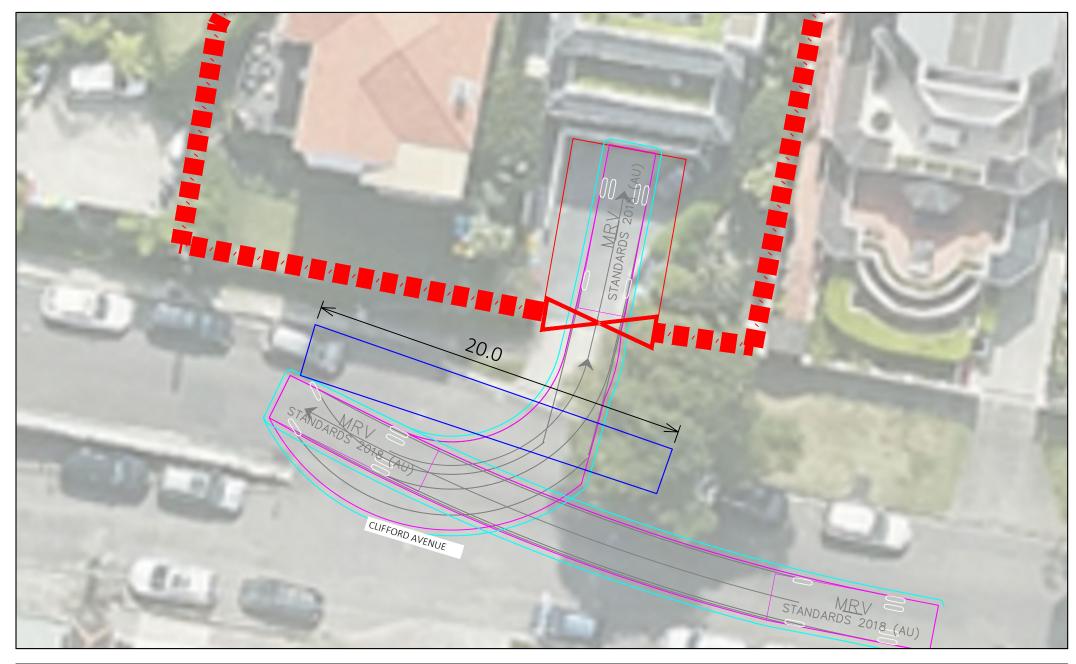

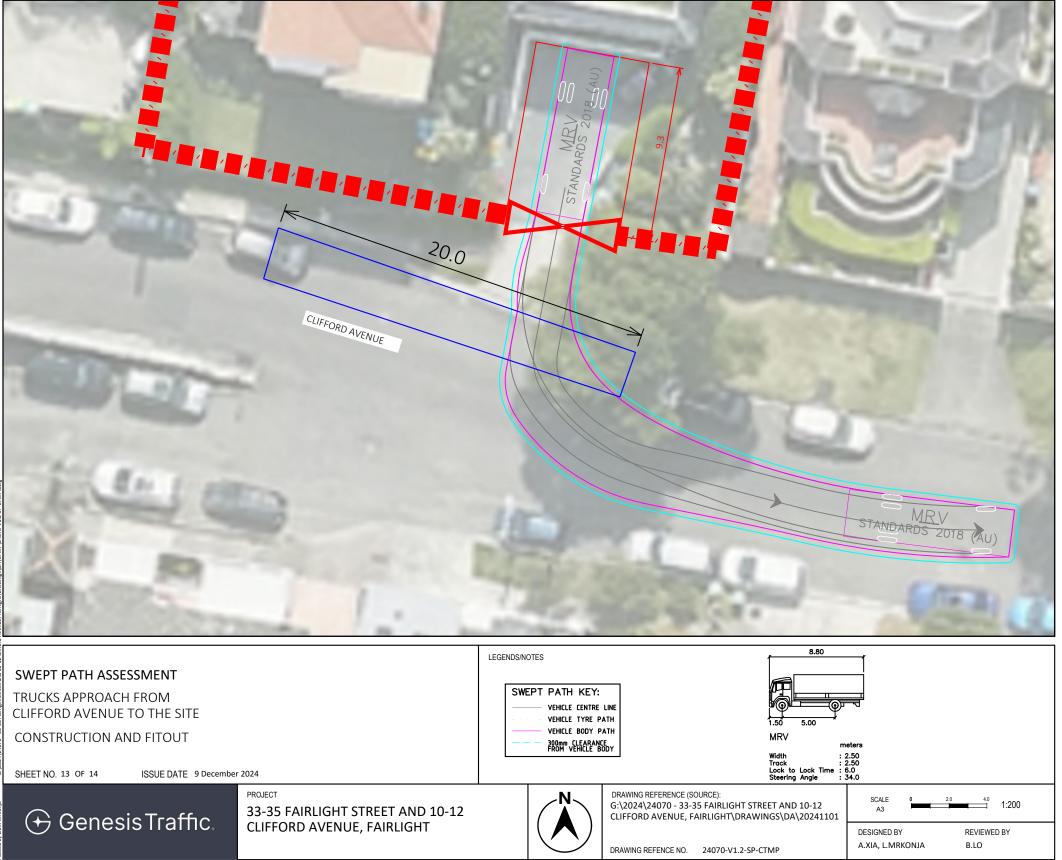

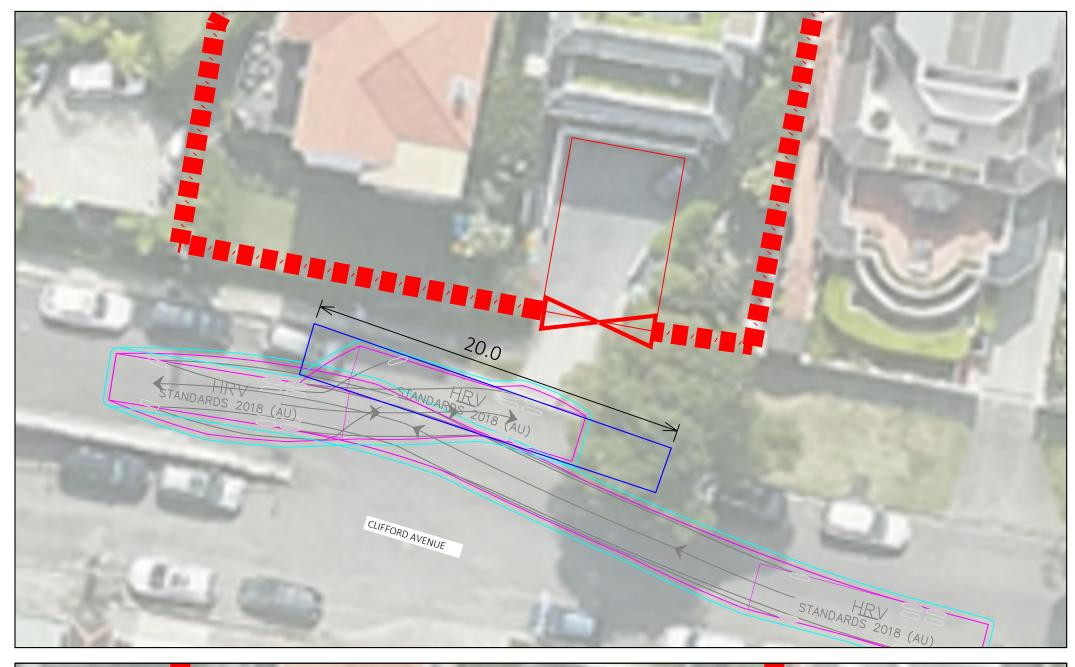

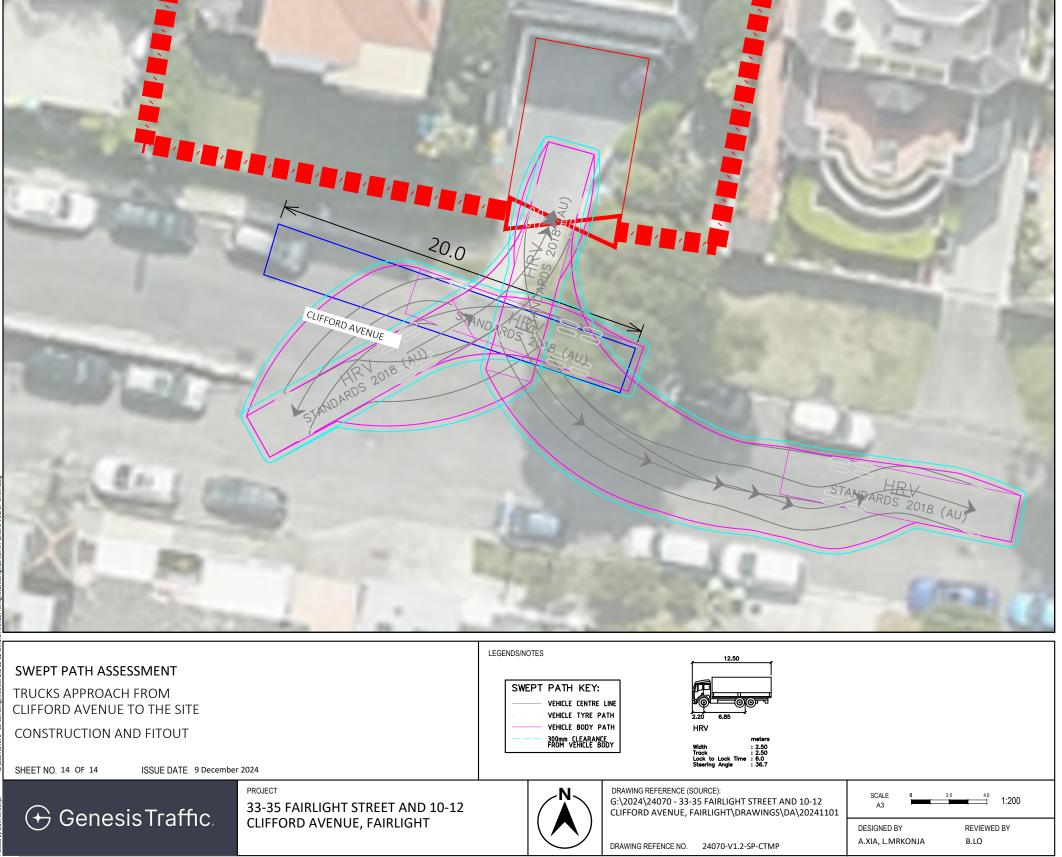





Better Developments with Genesis Traffic