

1323L

75m²

1 tap

Outdoors

Outdoors

4kL

Provide pool cover &

Solar (Gas boosted)

Provide spa cover & pump with timber

Solar (Gas boosted)

pump with timber

Landscape

Hardscape

Softscape

Total

Footprint Area

Dwelling

Existing

256.2m²

(35.8%)

307.4m²

(42.9%)

563.6m²

(78.7%)

Existing

156.5m²

Proposed

223.0m²

(31.1%)

330.9m²

(46.2%)

553.9m²

(77.3%)

Proposed

164.6m²

Permissable

43.0m²

386.1m²

429.9m²

(54%)

(60%)

(6%)

Hot water

Lighting

Fixtures

Construction

Insulation (minimum)

Floor over building

Walls: brick veneer

Walls: shared garage

Walls: Framed

Ceiling: flat roof

Roof:

Instantaneous gas

Min. 3 stars

Nil

R1 16

R1.30

R1.45

RFL blanket

Min. 40% LED or CF

Frame & glass type

Alum., Low-E glass

NW1

NW2

SW1

SW2

NE1

NE2

SF1

SE2

Shading device

Eave >900mm

Eave >600mm

Eave >450mm

Eave >600mm

Eave >450mm

Eave >900mm

None

None

Rainwater tank

Located

Capacity

Located

Capacity

Pool

Spa

Size (min.)

Collection area

Connected to

Requirements

Heating type

Requirements

Heating type

10.06.20 Amended DA issue 27.05.20 Council issue

DA ISSUE

PROJECT
Alterations & additions
48 The Serpentine, Bilgola

LEGEND

Items to be demolished


New dwelling extension (enclosed) New balcony / terrace / pool extension New facade extension / alterations New or adjusted glazed openings


Existing walls New roof extension


DRAWING SITE PLAN

Bawtree Design

SHEET SCALE DRAWING NO A3 1:200 С 1811/01

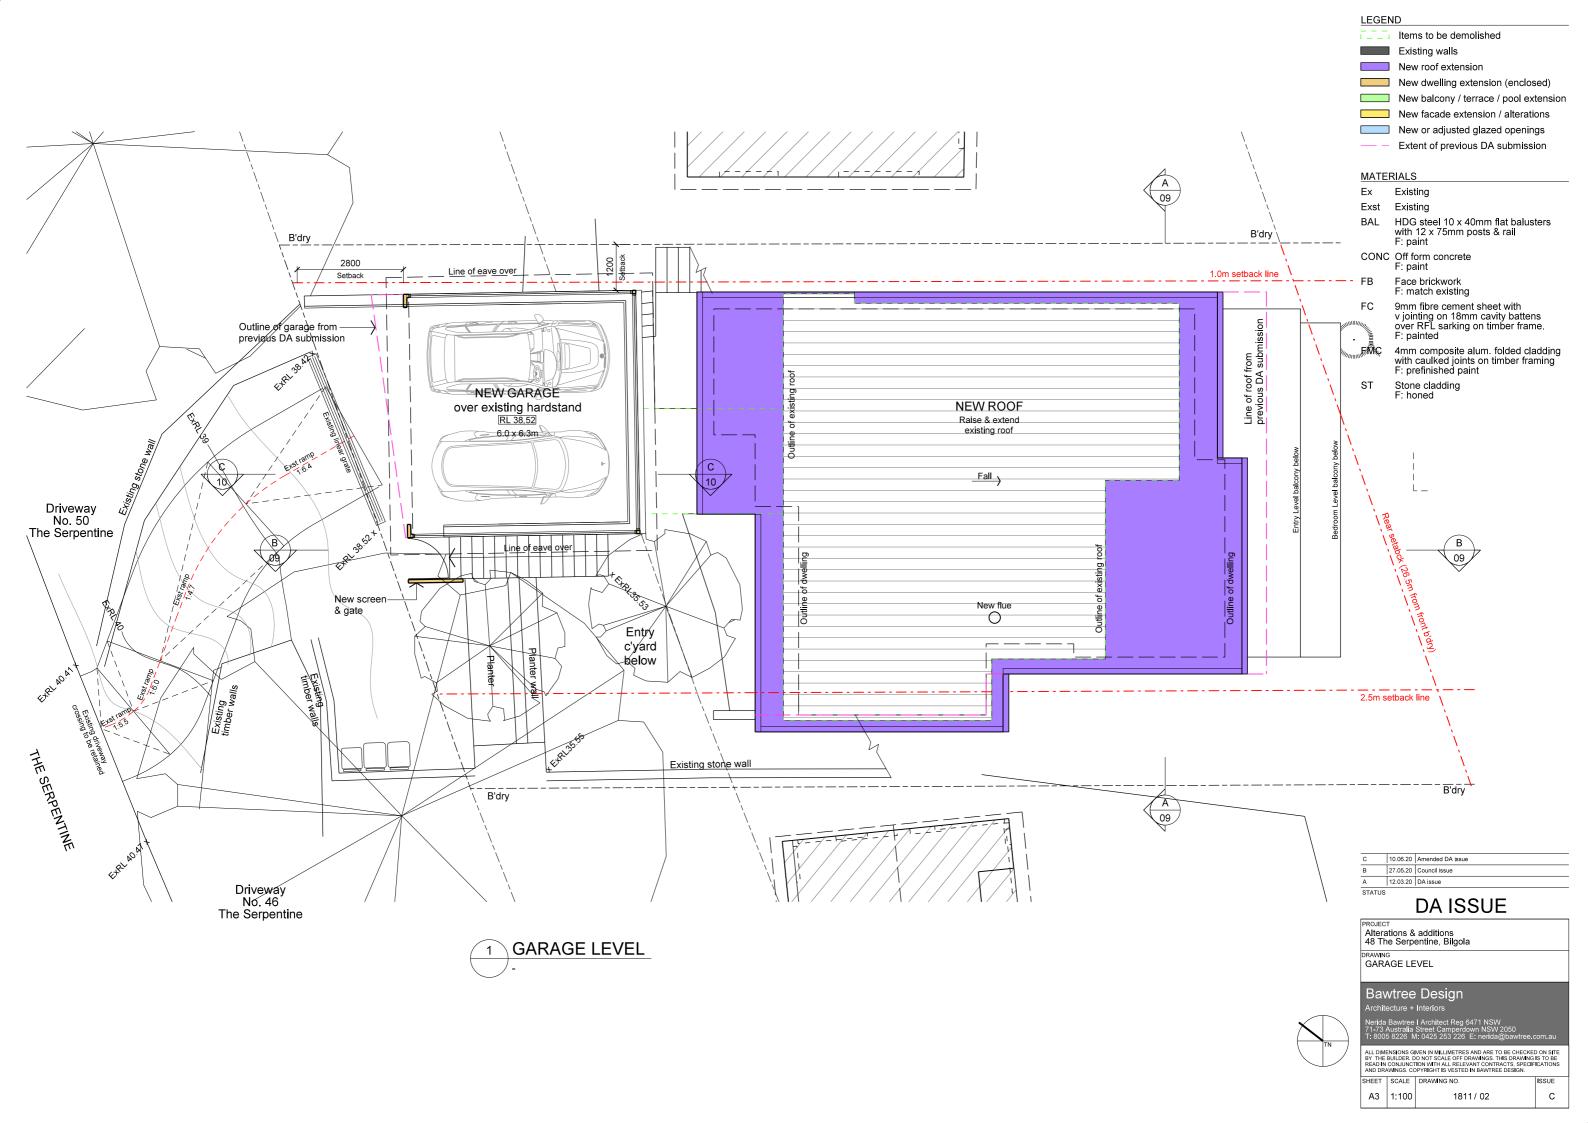

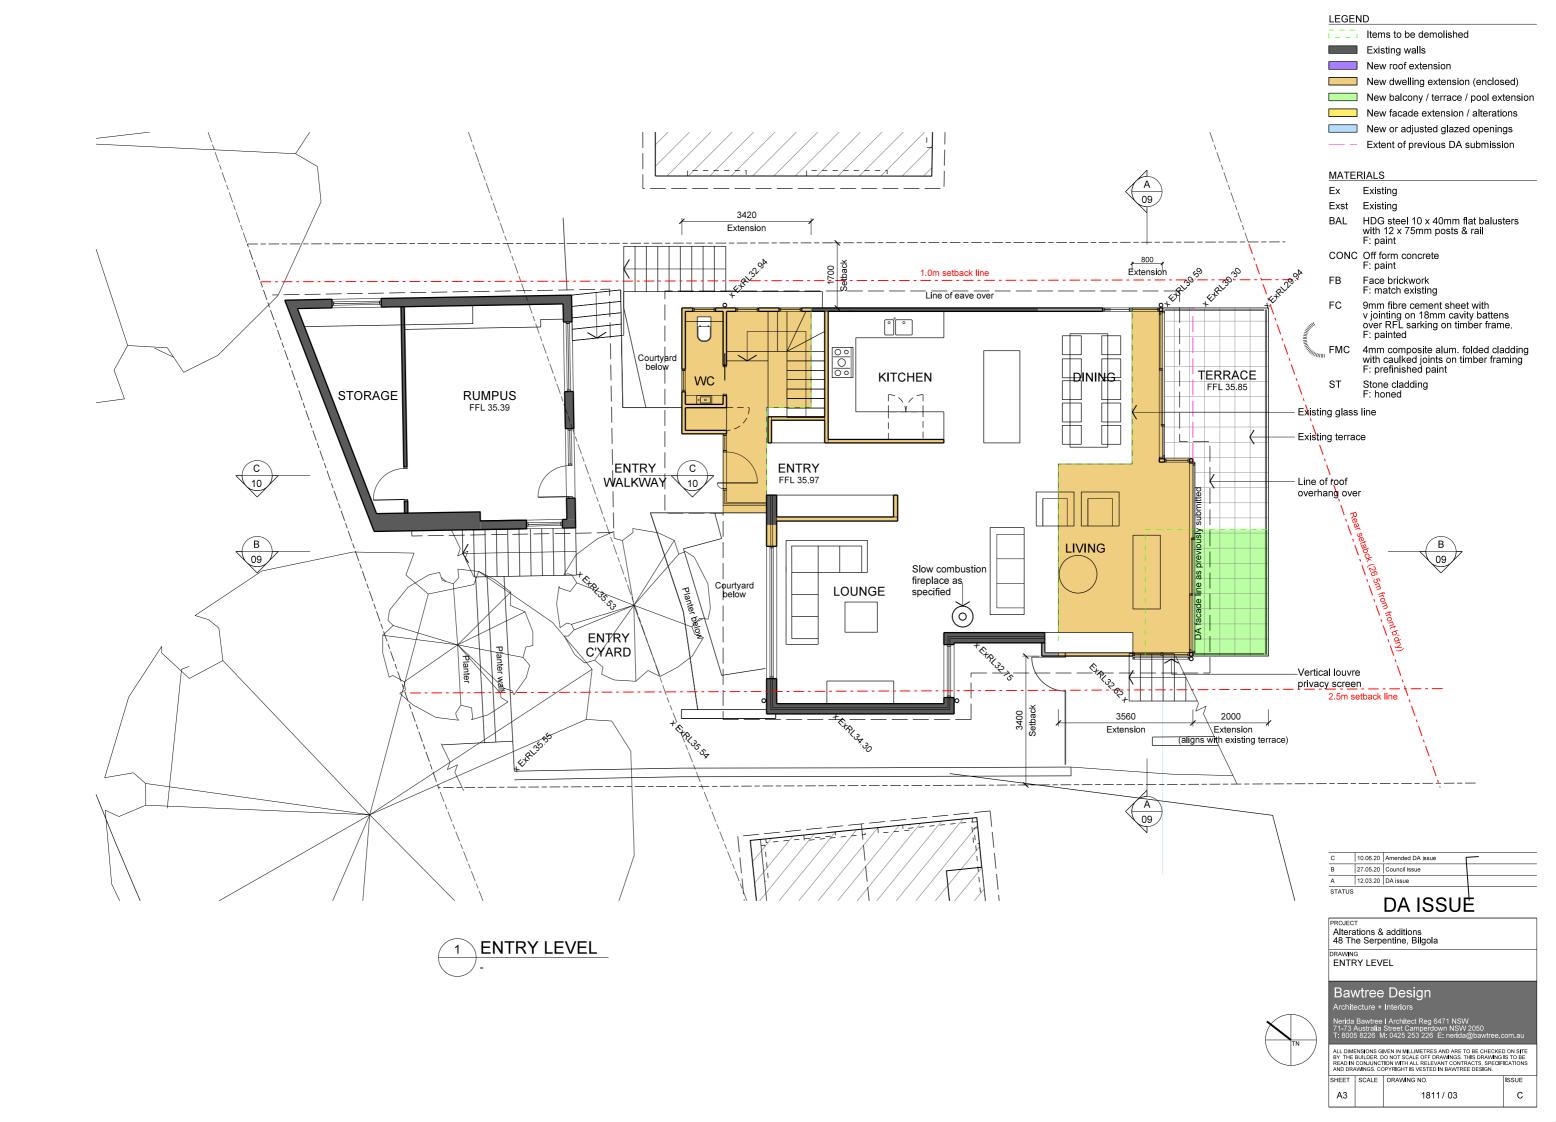

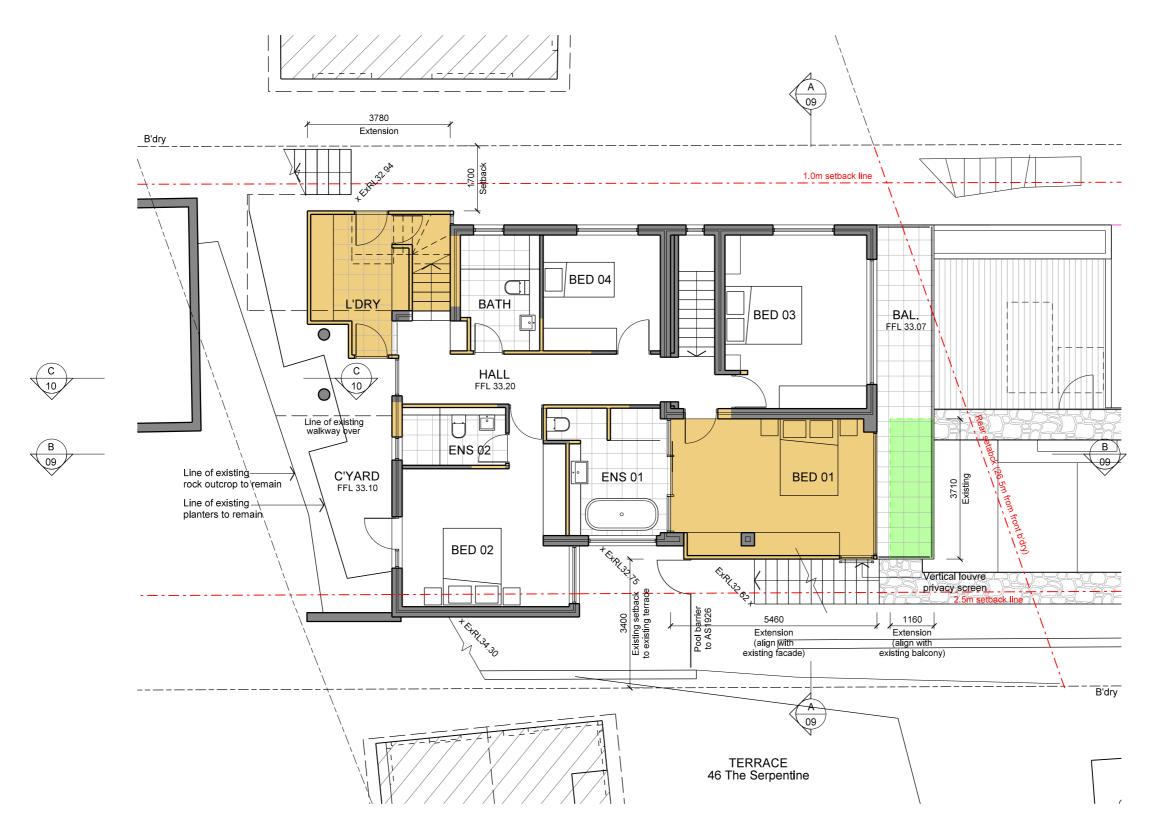

BEDROOM LEVEL

LEGEND

Items to be demolished Existing walls New roof extension New dwelling extension (enclosed) New balcony / terrace / pool extension New facade extension / alterations New or adjusted glazed openings Extent of previous DA submission

MATERIALS

Existing Ex

Exst Existing

HDG steel 10 x 40mm flat balusters with 12 x 75mm posts & rail F: paint

CONC Off form concrete
F: paint

Face brickwork F: match existing

9mm fibre cement sheet with v jointing on 18mm cavity battens over RFL sarking on timber frame. F: painted

FMC 4mm composite alum. folded cladding with caulked joints on timber framing F: prefinished paint

Stone cladding F: honed

С	10.06.20	Amended DA issue
В	27.05.20	Council issue
Α	12.03.20	DA issue

DA ISSUE


Alterations & additions
48 The Serpentine, Bilgola


DRAWING BEDROOM LEVEL

Bawtree Design


С

HEET	SCALE	DRAWING NO.
А3	1:100	1811 / 04

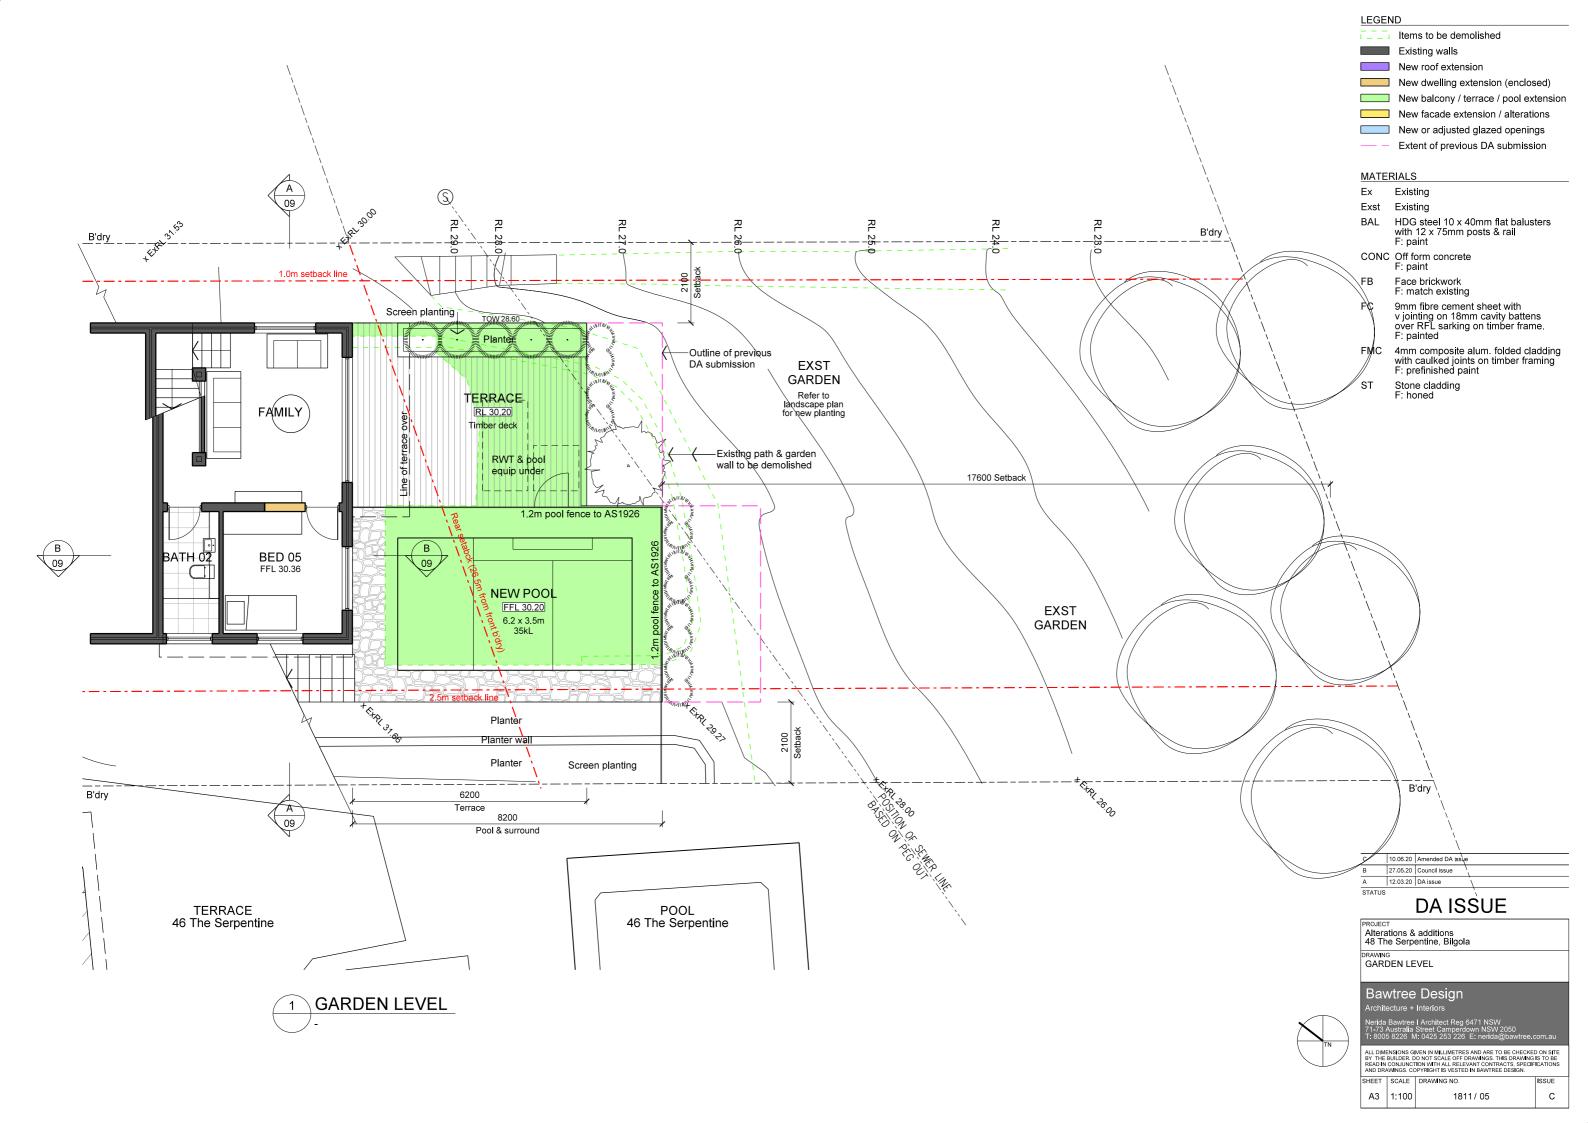

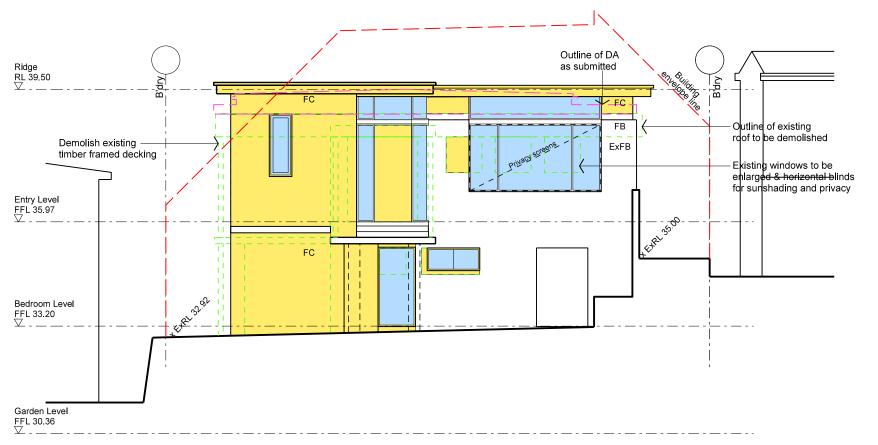

NORTH WEST ELEVATION STREET FACADE

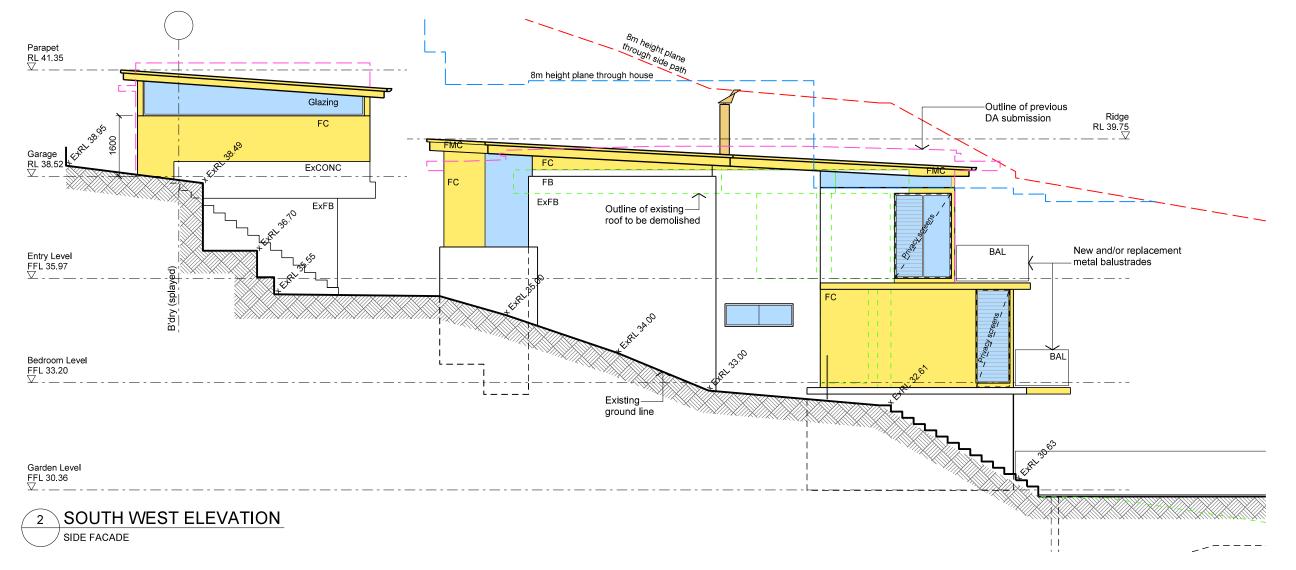

LEGEND

Existing walls New roof extension New dwelling extension (enclosed) New balcony / terrace / pool extension New facade extension / alterations

New or adjusted glazed openings Extent of previous DA submission

Items to be demolished

MATERIALS

Ex Existing Exst Existing

> HDG steel 10 x 40mm flat balusters with 12 x 75mm posts & rail F: paint

CONC Off form concrete F: paint

Face brickwork F: match existing

9mm fibre cement sheet with v jointing on 18mm cavity battens over RFL sarking on timber frame. F: painted

FMC 4mm composite alum. folded cladding with caulked joints on timber framing F: prefinished paint

Stone cladding F: honed ST

С	10.06.20	Amended DA issue
В	27.05.20	Council issue
Α	12.03.20	DA issue
STATUS		


DA ISSUE


PROJECT
Alterations & additions
48 The Serpentine, Bilgola DRAWING ELEVATIONS

Bawtree Design

SHEET | SCALE | DRAWING NO

A3 1:100 С 1811/07

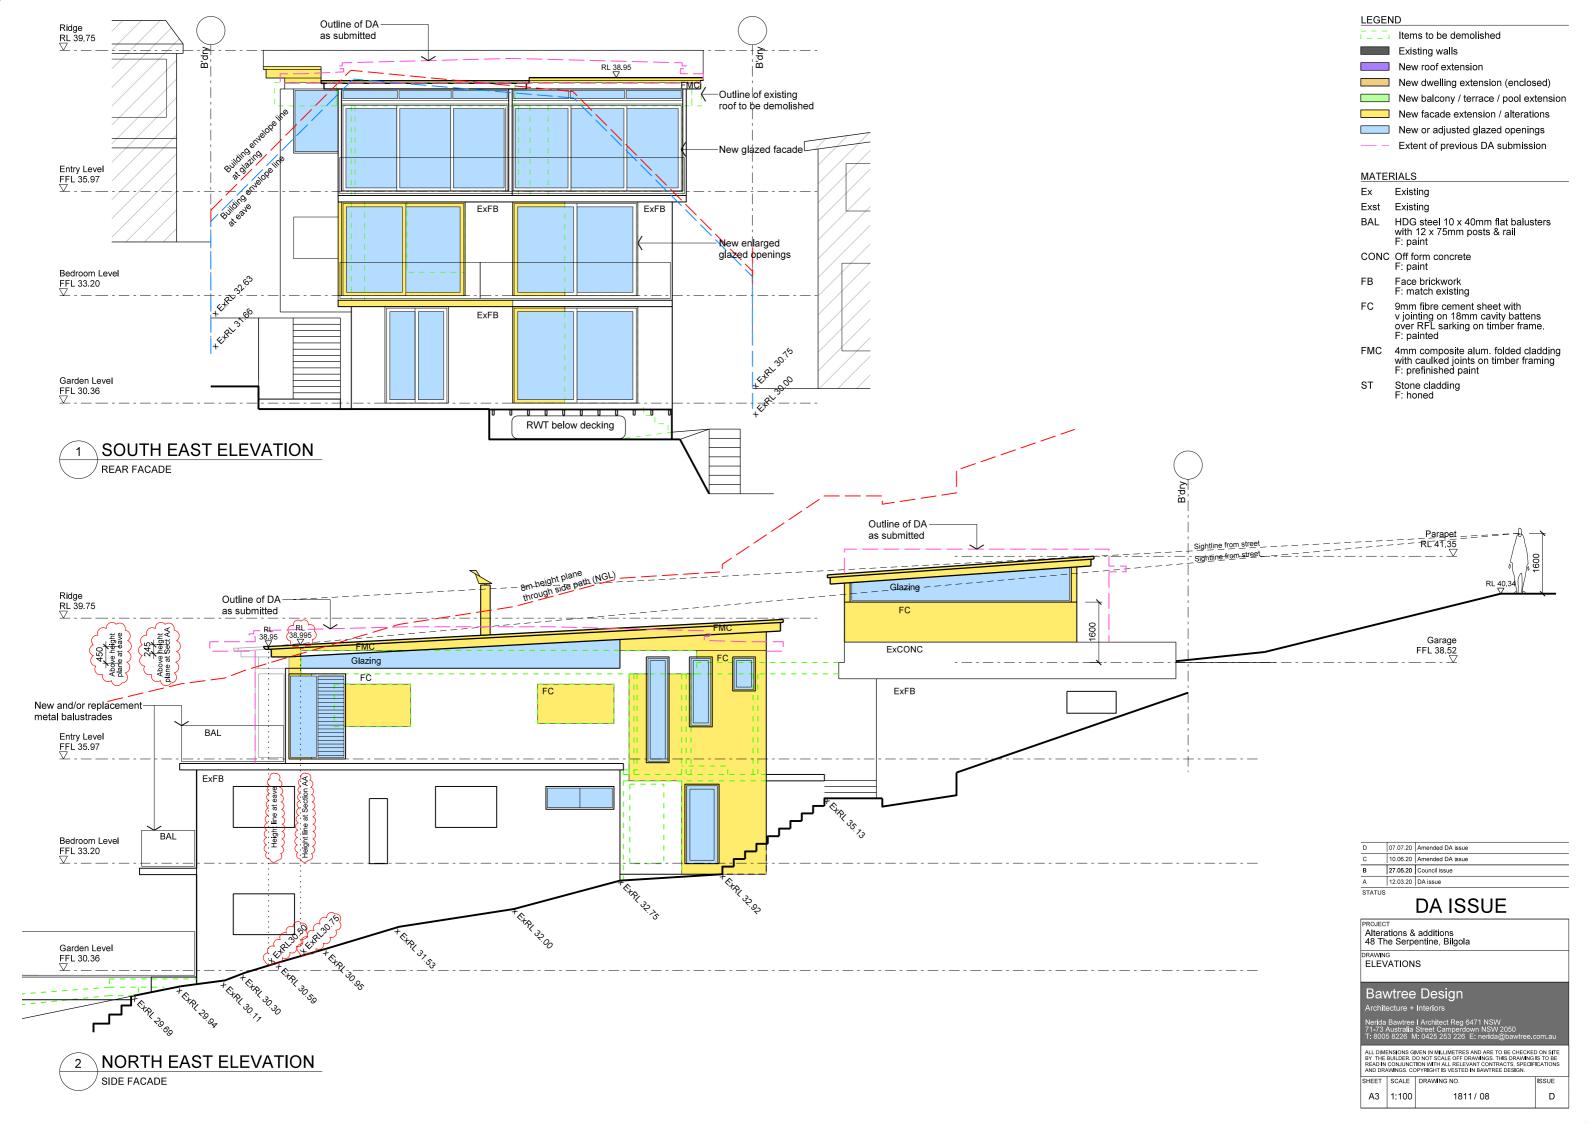

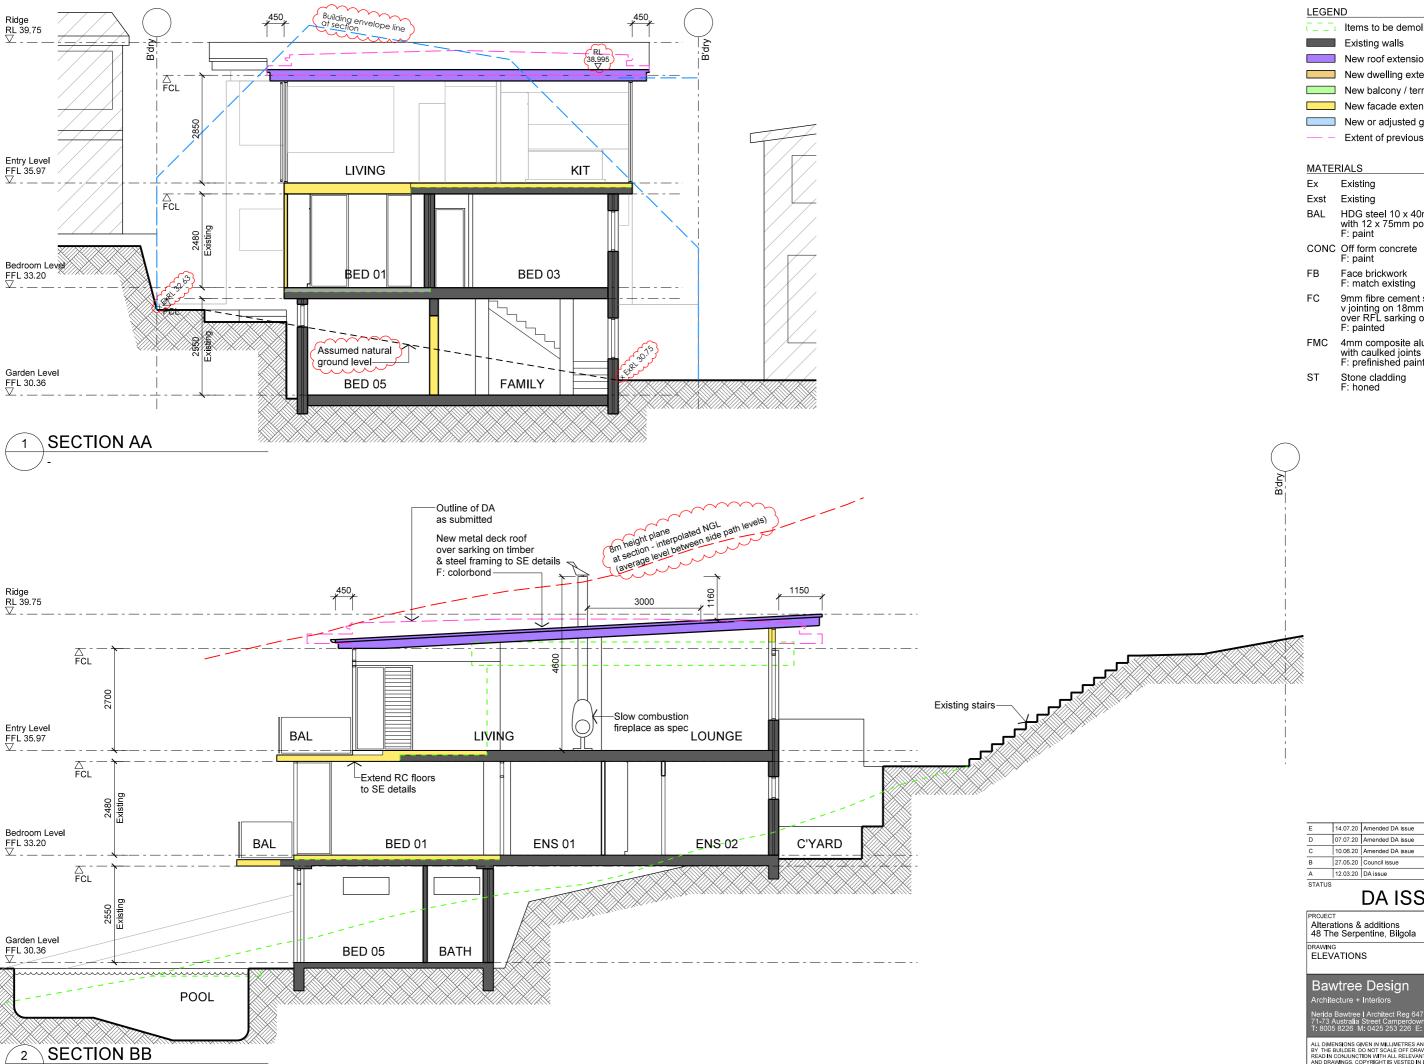

LEGEND

Items to be demolished Existing walls

New roof extension

New dwelling extension (enclosed)

New balcony / terrace / pool extension New facade extension / alterations

New or adjusted glazed openings Extent of previous DA submission

Existing

HDG steel 10 x 40mm flat balusters with 12 x 75mm posts & rail

F. paint

Face brickwork

F: match existing

9mm fibre cement sheet with v jointing on 18mm cavity battens over RFL sarking on timber frame.

FMC 4mm composite alum. folded cladding with caulked joints on timber framing F: prefinished paint


Stone cladding F: honed


14.07.20 Amended DA issue 07.07.20 Amended DA issue 10.06.20 Amended DA issue 27.05.20 Council issue 12.03.20 DA issue


DA ISSUE

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SHEET | SCALE | DRAWING NO A3 1:100 1811/09



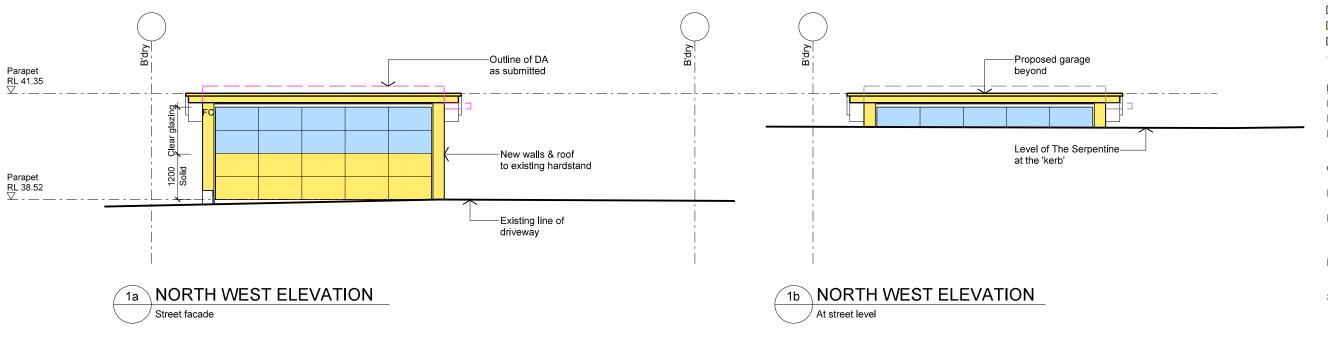

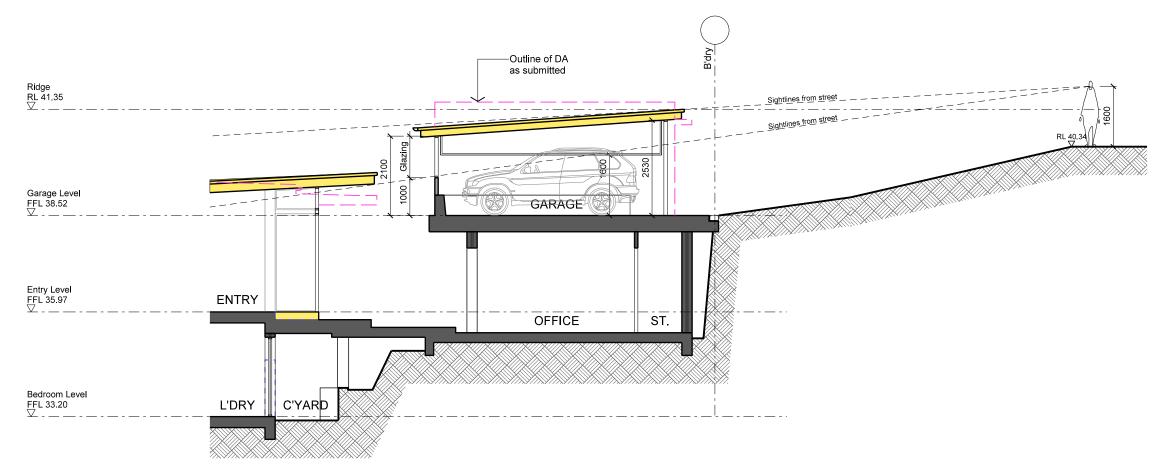

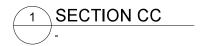	Existing walls
	New roof extension
	New dwelling extension (enclosed)
	New balcony / terrace / pool extension
	New facade extension / alterations
	New or adjusted glazed openings
— –	Extent of previous DA submission

MATERIALS

LEGEND

Ex Existing

Exst Existing

HDG steel 10 x 40mm flat balusters with 12 x 75mm posts & rail F: paint

CONC Off form concrete F: paint

[___] Items to be demolished

Face brickwork F: match existing

9mm fibre cement sheet with v jointing on 18mm cavity battens over RFL sarking on timber frame. F: painted

FMC 4mm composite alum. folded cladding with caulked joints on timber framing F: prefinished paint

Stone cladding F: honed

-	С	10.06.20	Amended DA issue
-	В	27.05.20	Council issue
	Α	12.03.20	DA issue

STATUS


DA ISSUE

PROJECT
Alterations & additions
48 The Serpentine, Bilgola

DRAWING GARAGE ELEVATION & SECTION


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1:100	1811 / 10	С




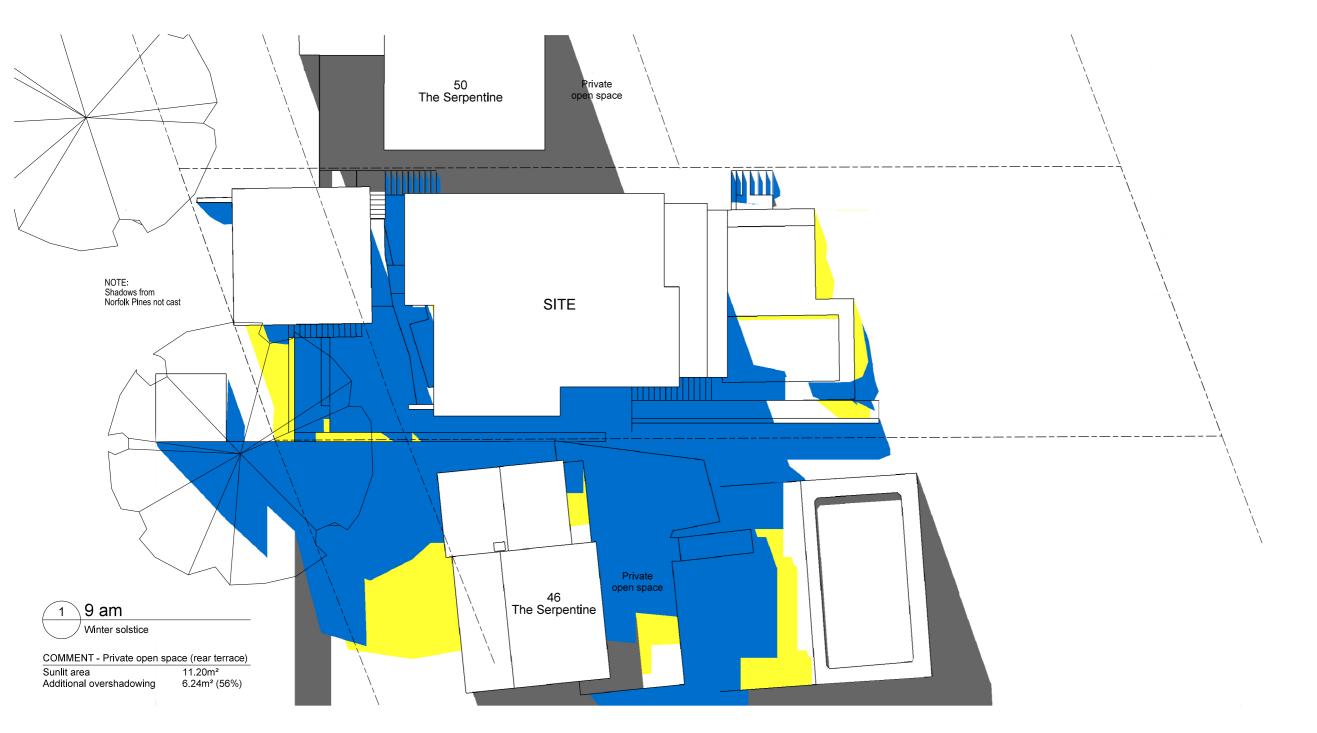

EXISTING SHADOWS (Subject site)

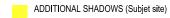

NOTE: No shadows have been cast for general landscape, mature trees or timber boundary fences

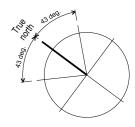

Time Altitude Azimuth

9.00am 18 deg. N43E 12 noon 32 deg. N 3.00pm 18 deg. N43W

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A	12.03.20	DA issue

STATUS

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Alterations & additions
48 The Serpentine, Bilgola

DRAWING SHADOW DIAGRAMS

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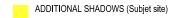
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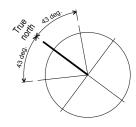




EXISTING SHADOWS (Subject site)



NOTE: No shadows have been cast for general landscape, mature trees or timber boundary fences



Time Altitude Azimuth

9.00am 18 deg. N43E 12 noon 32 deg. N 3.00pm 18 deg. N43W

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PROJECT
Alterations & additions
48 The Serpentine, Bilgola

DRAWING SHADOW DIAGRAMS


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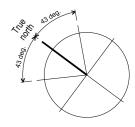




EXISTING SHADOWS (Subject site)



NOTE: No shadows have been cast for general landscape, mature trees or timber boundary fences

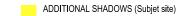

Time Altitude Azimuth

9.00am 18 deg. N43E 12 noon 32 deg. N 3.00pm 18 deg. N43W

С	10.06.20	Amended DA issue
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STATUS

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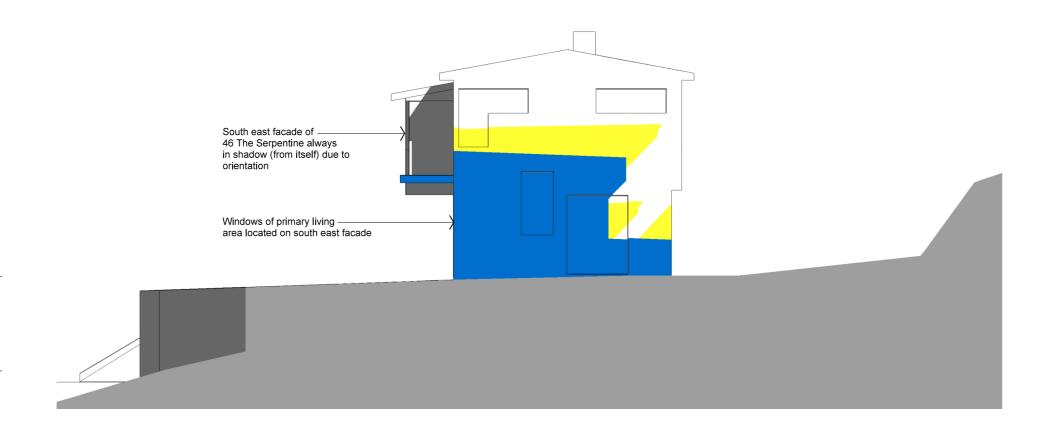
PROJECT
Alterations & additions
48 The Serpentine, Bilgola

DRAWING SHADOW DIAGRAMS

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9 am

Winter solstice 46 The Serpentine North east facade (side)


COMMENT

Glazed area 7.94m² 4.23m² Existing overshadowed Additional overshadowing

0.80m² (10%)


There is no more overshadowing of the north east facade (from 48 The Serpentine) after 12 noon



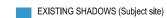



NOTE: No shadows have been cast for general landscape, mature trees or timber boundary fences

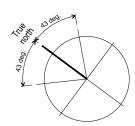

Altitude Azimuth

9.00am 18 deg. N43E 12 noon 32 deg. N 3.00pm 18 deg. N43W

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В	27.05.20	Council issue
A	12.03.20	DA issue

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Alterations & additions
48 The Serpentine, Bilgola

DRAWING SHADOW DIAGRAMS

Bawtree Design

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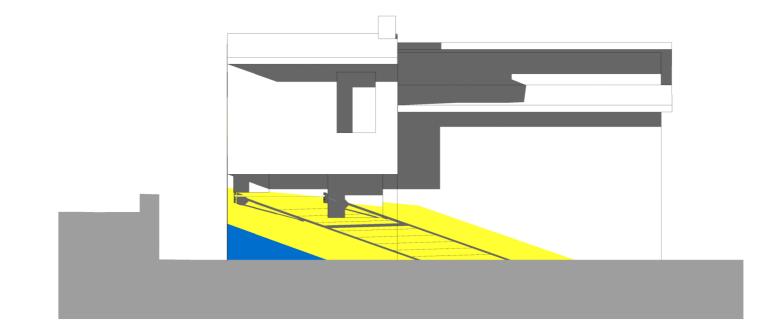
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12 noon

Winter solstice 46 The Serpentine North east facade (side)




9 am

Winter solstice 46 The Serpentine North west facade (street)

COMMENT

Clothes line shown & shadow cast

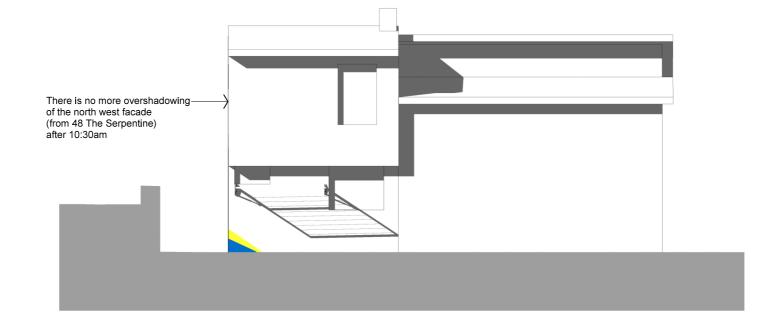


10:30 am


Winter solstice 46 The Serpentine North west facade (street)

COMMENT


No existing or additional shadows cast on wall after 10h30

EXISTING SHADOWS

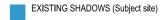

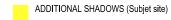

NOTE: No shadows have been cast for general landscape, mature trees or timber boundary fences

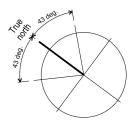

Time Altitude Azimuth

9.00am 18 deg. N43E 12 noon 32 deg. N 3.00pm 18 deg. N43W

С	10.06.20	Amended DA issue
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Α	12.03.20	DA issue

STATUS


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Alterations & additions
48 The Serpentine, Bilgola DRAWING SHADOW DIAGRAMS

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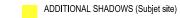


Winter solstice 50 The Serpentine South west facade (side)


COMMENT

Glazed area 7.61m² Existing overshadowed
Additional overshadowing 7.09m² 0.33m² (4%) EXISTING SHADOWS

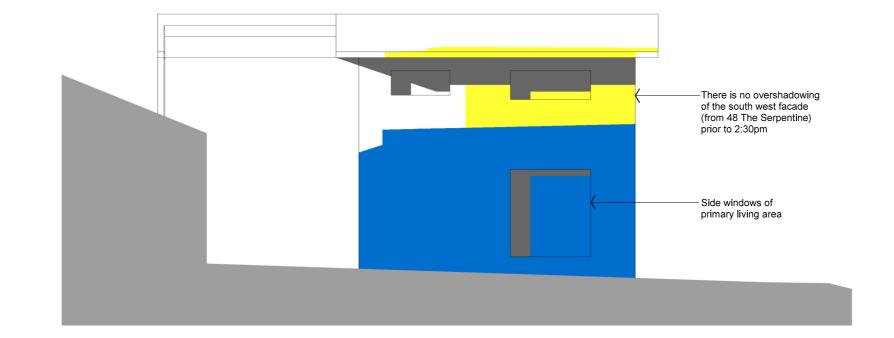EXISTING SHADOWS (Subject site)



NOTE: No shadows have been cast for general landscape, mature trees or timber boundary fences

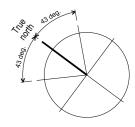

Time Altitude Azimuth

9.00am 18 deg. N43E 12 noon 32 deg. N 3.00pm 18 deg. N43W

С	10.06.20	Amended DA issue
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48 The Serpentine, Bilgola

DRAWING SHADOW DIAGRAMS

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SHEET | SCALE | DRAWING NO. A3 1:100





С



VIEW 1

Towards South Bilgola Headland

Proposed garage enclosure, shown ghosted to illustrate portion of view that is being affected.



2	VIEW 2
	Towards oce

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DA ISSUE

Alterations & additions 48 The Serpentine, Bilgola

DRAWING VIEW ANALYSIS


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С

A3 1:200 1811 / 18

Item	Material / Product	Finish / Colour
FB	Existing face brickwork	Blonde brick to match existing
BAL	Steel balustrade	Colourbond Monument
ST	Stone cladding	Quartzite natural stone
FC	Vertical grooved fibre cement sheet	Colourbond Monument
Soffits & Decking	Spotted Gum hardwood	Natural oil
Roof MR	Prefinished standing seam sheet metal roofing	'Colorbond' Basalt
Doors & window frames, trims	Aluminium & steel commercial framing	Dulux Powdercoat - Matt Monument





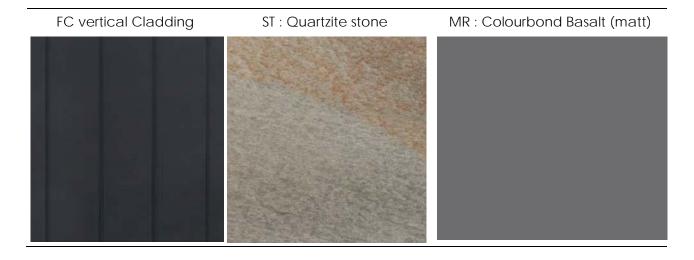

1 VIEW 1a



2 VIEW 1b



3 VIEW 2

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Alterations & additions
48 The Serpentine, Bilgola

DRAWING PERSPECTIVES

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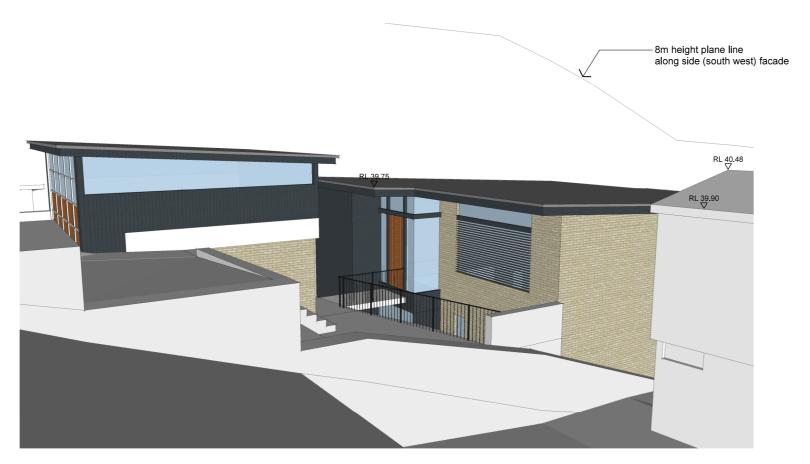
А3 С 1811/20





1 VIEW 3

2 VIEW 4



3 VIEW 5

С	10.06.20	Amended DA issue
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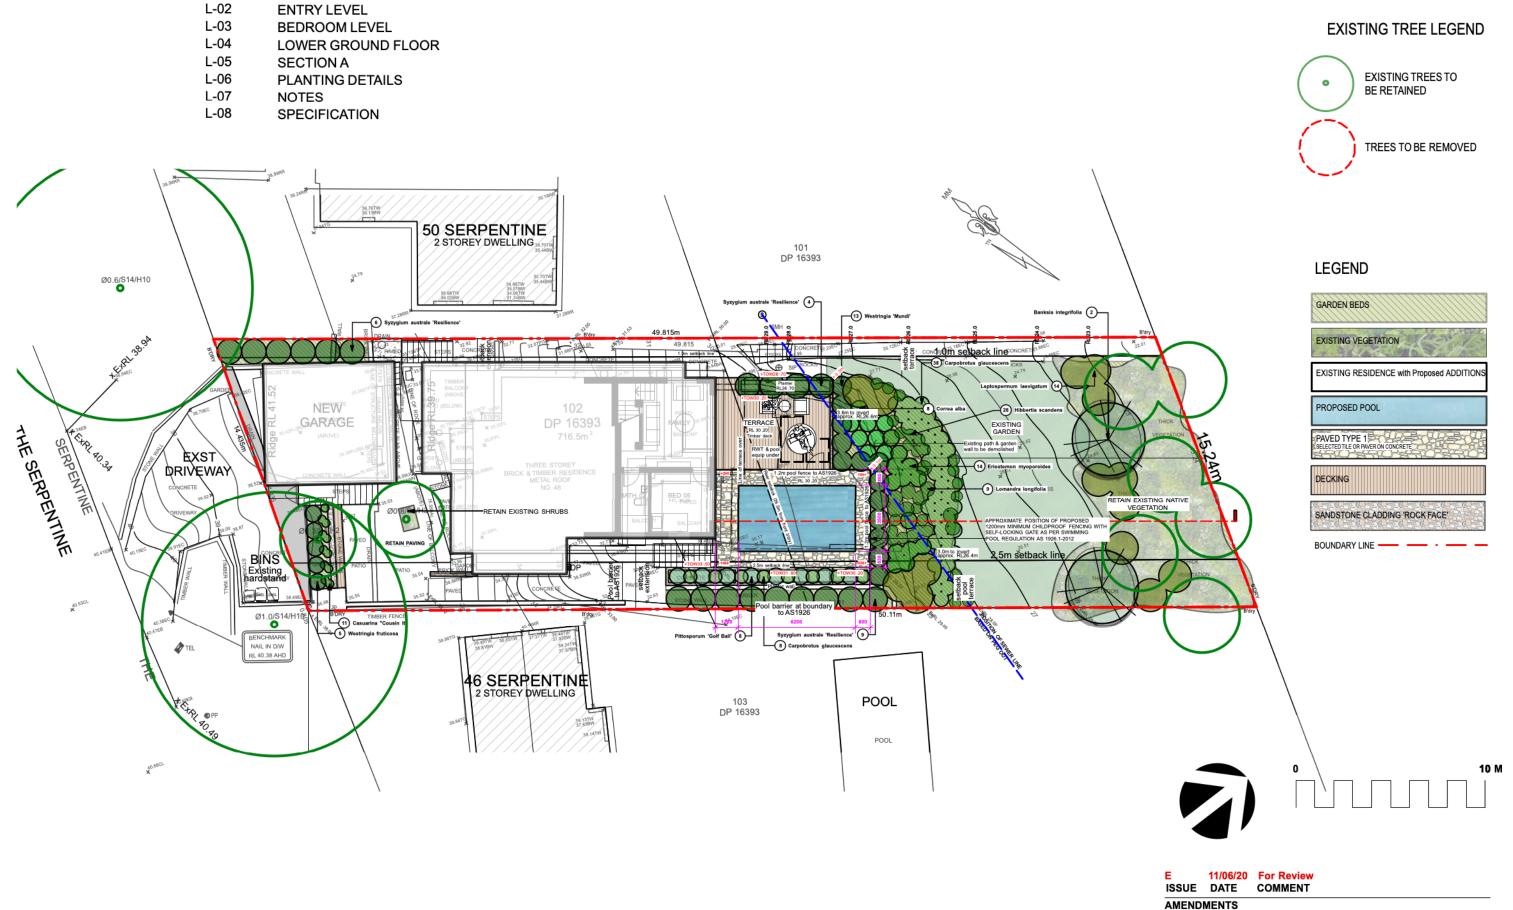
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Alterations & additions
48 The Serpentine, Bilgola DRAWING PERSPECTIVES

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С 1811/21



GENERAL NOTES
All work to be carried out in accordance with the Building Code of Australia, all Local and State Government Ordinances, relevant Australian Standards, Local
Authorities Regulations and all other relevant Authorities concerned.
All structural work and site drainage to be subject to Engineer's details or certification where required by Council. This shall include r.c. slabs and footings, r.c. and
steel beams & columns, wind bracing to AS 1170
and AS4058, nother trods or bolts, lie downs, fixings etc., driveway slabs and drainage to Council's setsfaction. All timbers to be in accordance with SAA Timber
Structure Code AS1720 and SAA Timber Framing Code AS 1684. All work to be carried out in a professional and workman- shiplike manner according to the plan

Sheet Number Sheet Title

SITE PLANS

L-01

NOTE

On not scale off the drawings unless otherwise stated and use figured dimensions in preference.
All dimensions are to be checked and verified on site before the commencement of any work, all dimensions and levels are subject to final survey and set-out
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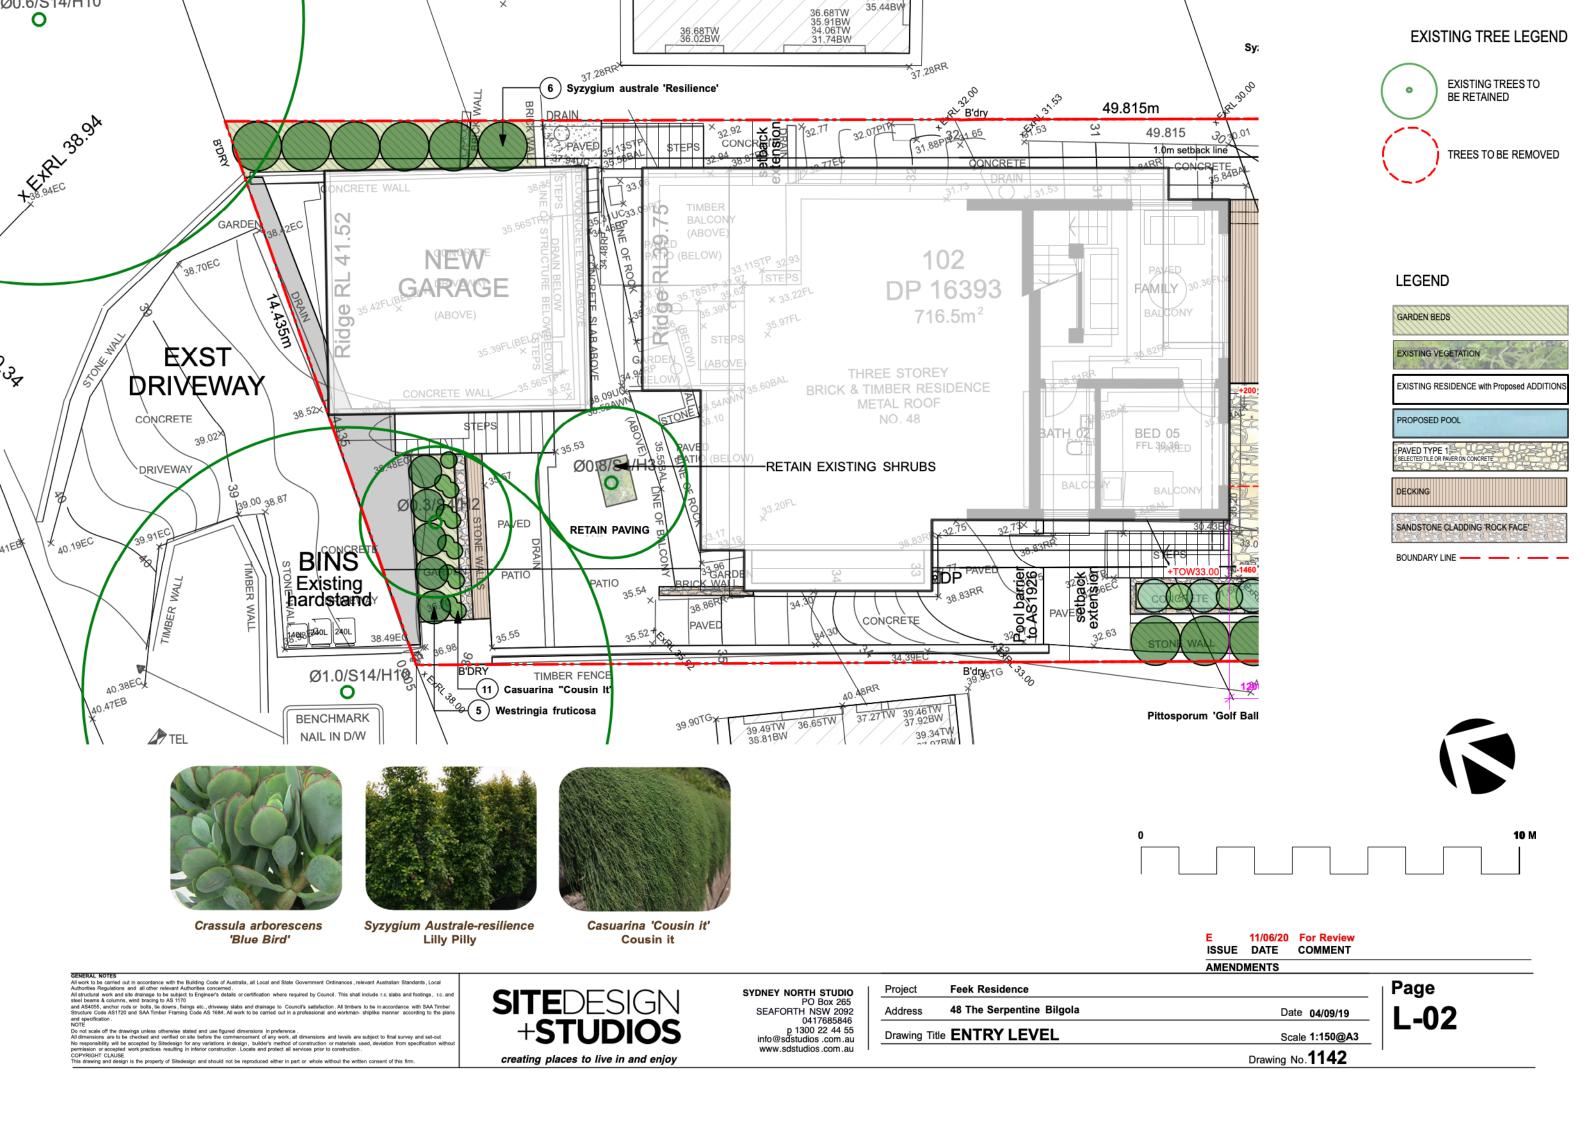
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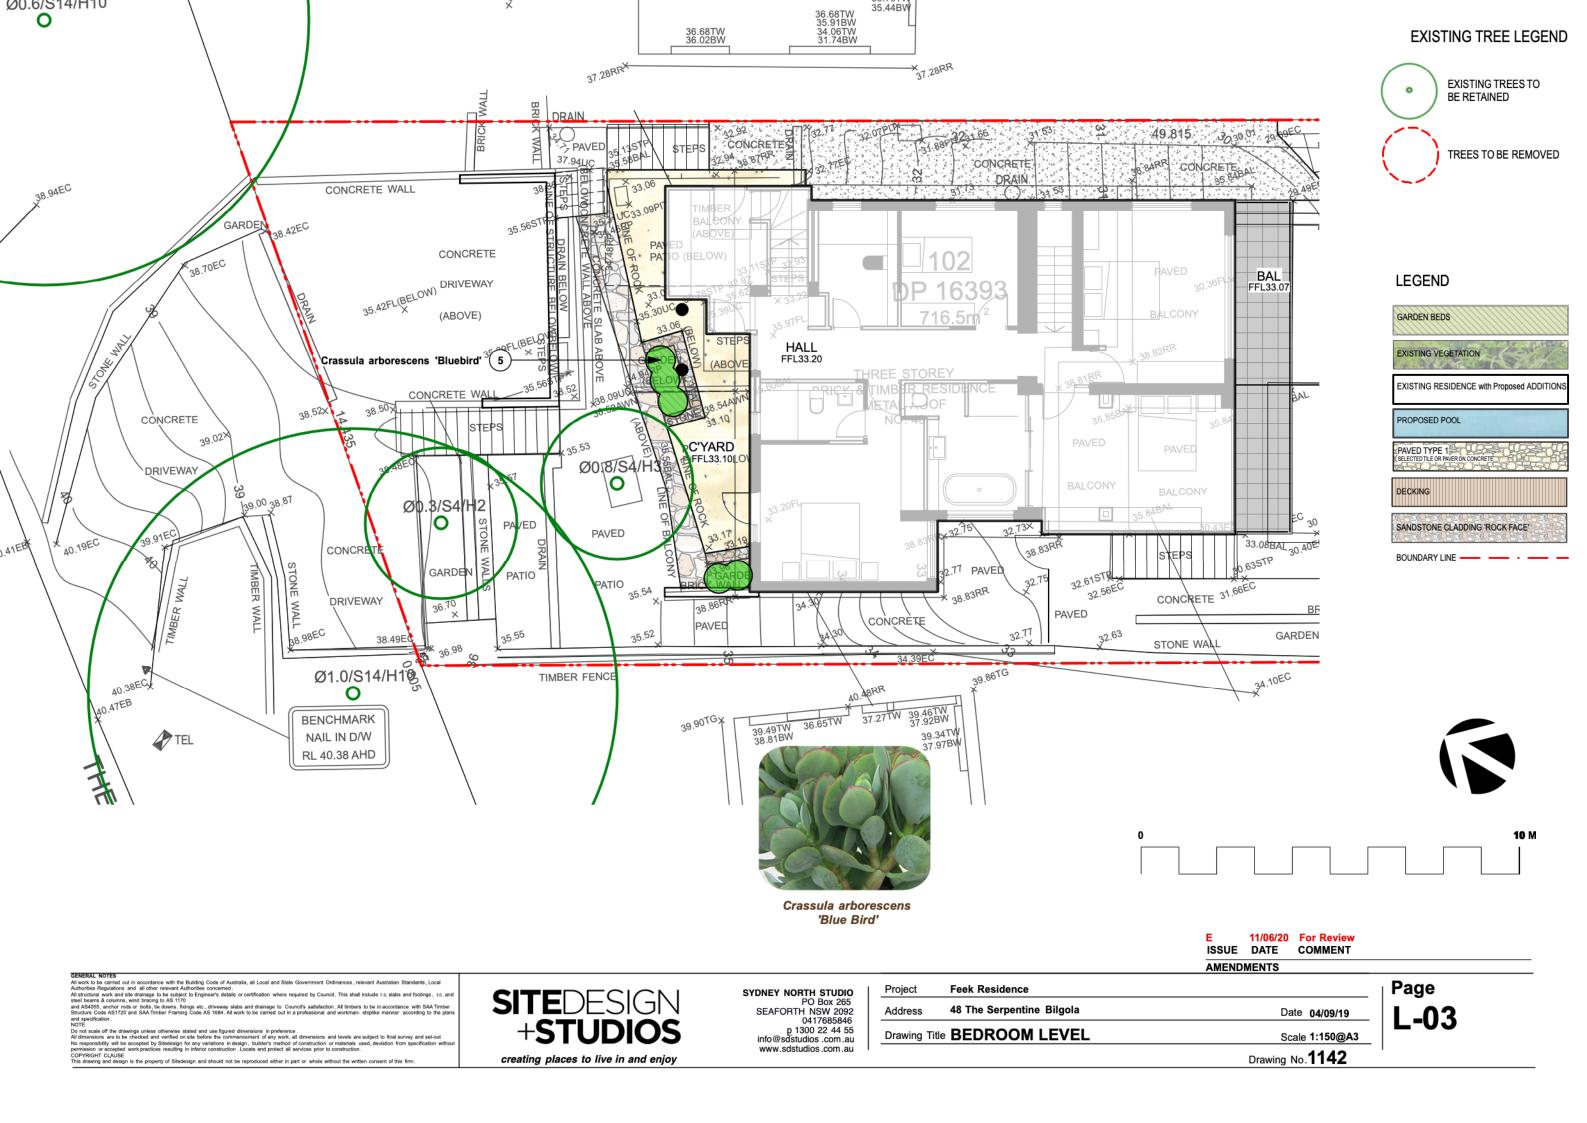
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PO Box 265
SEAFORTH NSW 2092
0417685846
p 1300 22 44 55
info@sdstudios.com.au
www.sdstudios.com.au


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	Address	48 The Serpentine Bilgola	Date 04/09/19
	Drawing Ti	tle SITE PLANS	Scale 1:200@A3
ı			44.40


Page L-01

Drawing No.**1142**





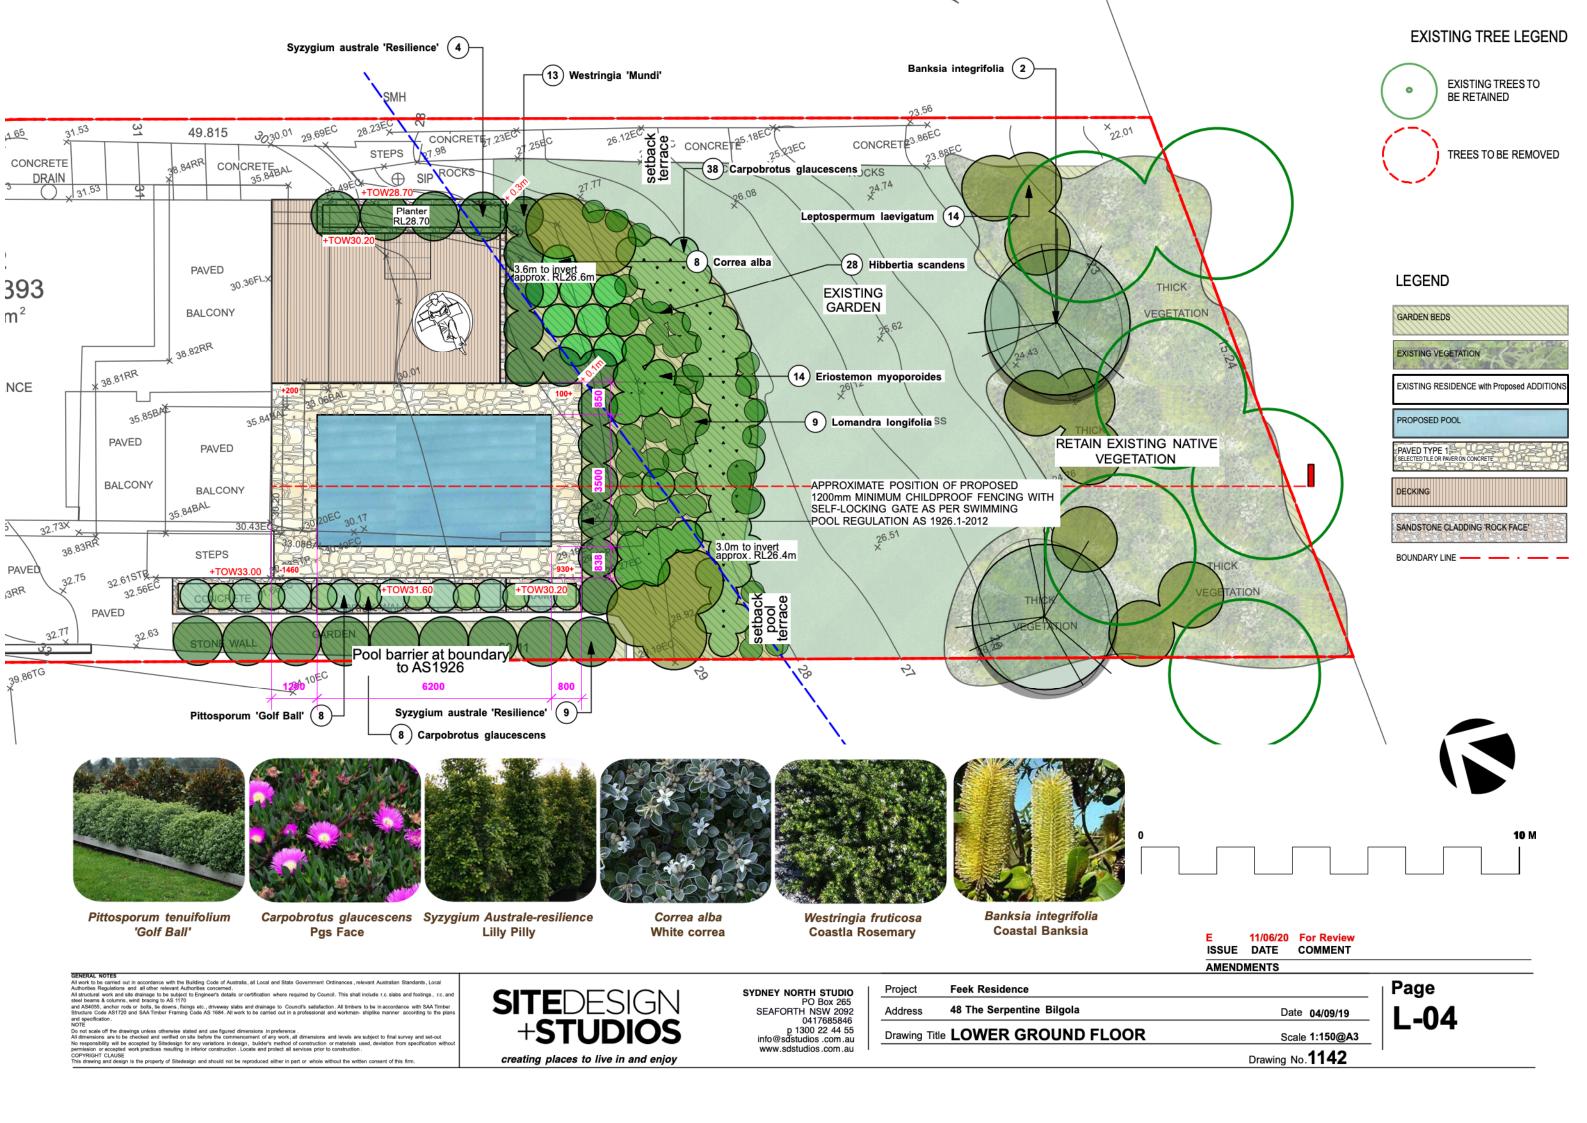

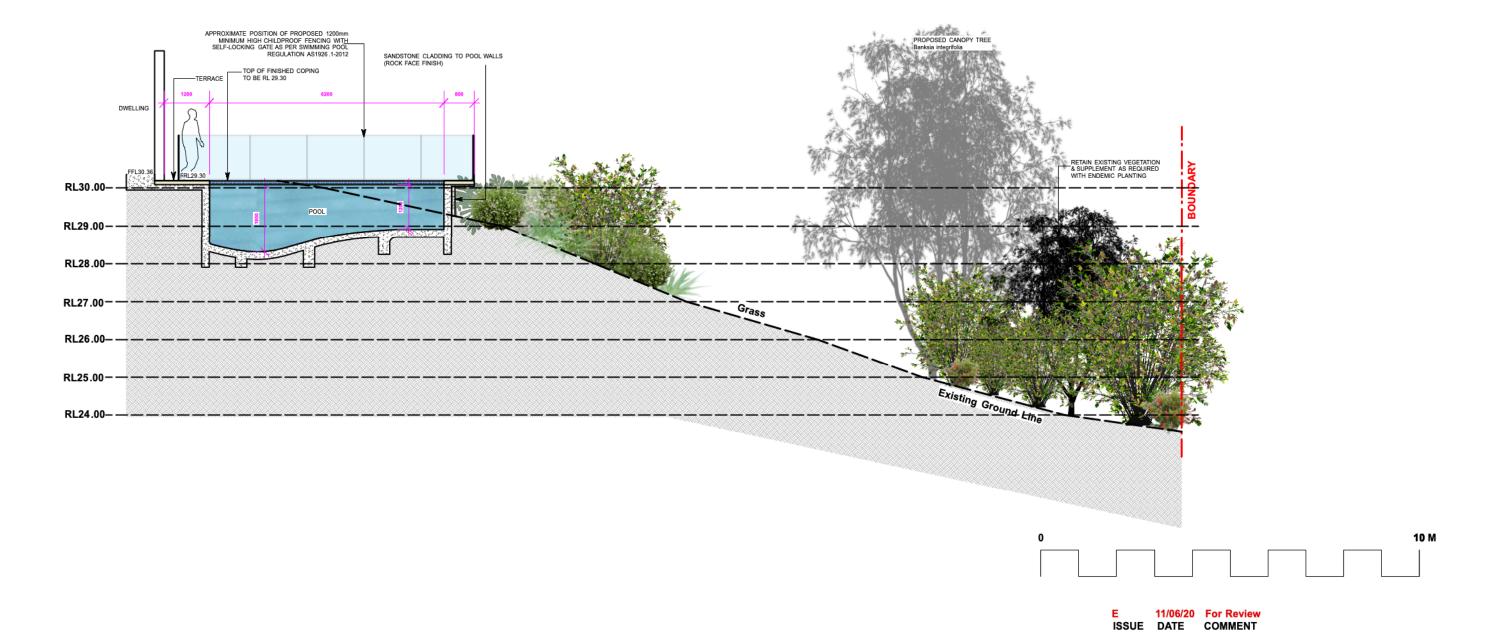

GENERAL NOTES

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All structural work and site drainage to be subject to Engineer's details or certification where required by Council. This shall include r.c. slabs and footings, r.c. a

steel beams & columns, wind bracing to AS 1170
and AS4655, another rods or bolts, lie downs fixings etc., driveway slabs and drainage to Council's satisfaction. All timbers to be in accordance with SAA Timber Structure Code AS1720 and SAA Timber Framing Code AS 1684, All work to be carried out in a professional and workman-shiplike manner according to the pix and specification.

on not scale off the drawings unless otherwise stated and use figured dimensions in preference

All dimensions are to be checked and verified on site before the commencement of any work, all dimensions and levels are subject to final survey and set-out. No responsibility will be accepted by Stedesign for any variations in design, builder's method of construction or materials used, deviation from specification without commencement or accepted work protections resulting in inferior construction. Locate and protect all services prior to construction.

Definition of the content of the con

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PO Box 265
SEAFORTH NSW 2092
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p 1300 22 44 55
info@sdstudios.com.au
www.sdstudios.com.au

Project Feek Residence

Address 48 The Serpentine Bilgola Date 04/09/19

Drawing Title SECTION A Scale 1:100@A3

Drawing No.1142

AMENDMENTS

Page L-05



Banksia integrifolia Coastal Banksia



Correa alba White correa



Pittosporum tenuifolium Syzygium Australe-resilience 'Golf Ball'





Westringia 'Mundi' **Dwarf coastal rosemary**



Carpobrotus glaucescens Pgs Face



Casuarina 'Cousin it' Cousin it



Crassula arborescens 'Blue Bird'



Westringia fruticosa Coastla Rosemary



Eriostemon myoporodies **Wax Flower**



Leptospermum laevigatum Coast tea tree




Lilly Pilly

Hibbertia scandens Golden guinea flower




Lomandra longifolia Mat Rush

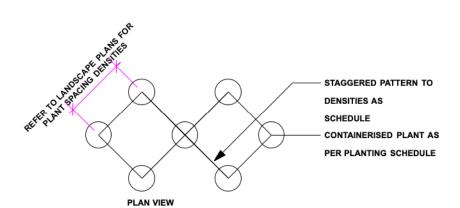

Plant List

ID	Botanical Name	Common Name	Scheduled Size	Mature Height	Mature Spread	Qty
Trees						
Ban-int	Banksia integrifolia	Coastal Banksia	45L	10m	3m	2
Shrubs						
Cor-alb	Correa alba	White Correa	200mm	0.9m	0.9 - 1.2m	8
eri-my	Eriostemon myoporoides	Wax Flower	200mm	0.6 - 1.2m	0.6m	14
LL	Leptospermum laevigatum	Coast Tea-Tree	300mm	1.5 - 4m	1.2 - 2.0m	14
pit 'gb'	Pittosporum 'Golf Ball'	Pittosporum	200mm	0.6m	0.9m	8
syz-au're'	Syzygium australe 'Resilience'	Lilly Pilly	200mm	1 - 2.5m	1.5m	19
Wes-mun	Westringia 'Mundi'	Dwarf Coastal Rosemary	200mm	0.8m	0.9m	13
Wes-fru	Westringia fruticosa	Coastal Rosemary	200mm	1m	0.9m	5
Ground Covers	-	•				
Car-gla	Carpobrotus glaucescens	Coastal Moonflower, Pigface, Iceplant	150mm	0.2m	1.2 - 2.0m	46
cas'ci'	Casuarina "Cousin It'	Casuarina "Cousin It'	150mm	0.3m	1.2 - 2.0m	11
Cra-arb	Crassula arborescens 'Bluebird'	'Blue Bird'	150mm	0.6m	0.3 - 0.6m	5
Hib-sca	Hibbertia scandens	Snake Vine	150mm	0.3m	1.2m	28
Grasses						
Lom-lon	Lomandra longifolia	Spiny-headed Mat-Rush	150mm	0.6m	0.8m	9

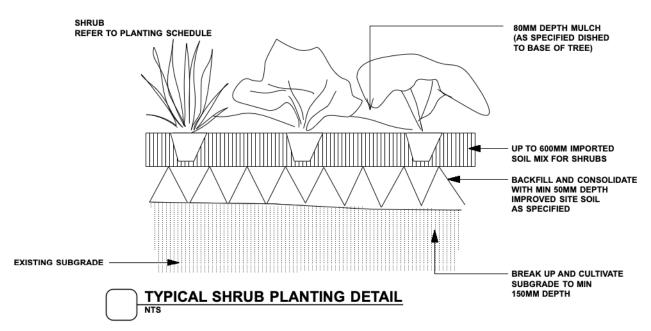

AMENDMENTS

InterNation Notes

(Invert to be carried out in accordance with the Building Code of Australia, all Local and State Government Ordinances, relevant Australian Standards, Local

(Inthorities Regulations and all other relevant Authorities concerned.)

Istructural work and site drainage to be subject to Engineer's details or certification where required by Council. This shall include r.c. slabs and footings, r.c. and

see beams & columns, wind bracing to AS 1170.

13 ASSASS, Applications and all timesers to be in accordance with SAA Timber.

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ı	Project Feek Residence					
	Address	48 The Serpentine Bilgola Date				
	Drawing Title	PLANTING DETAILS	Scale N.T.S@A3			

Drawing No.**1142**

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POOL COMPLIANCE NOTES

The design of the swimming pool and associated equipment must comply with the following requirements:

- i) The Swimming Pools Act & Regulations .
- ii) Australian Standard 1926 Swimming Pool Safety as prescribed under the
- Building Code of Australia.
- iii) The pump and associated equipment must be sound insulated and/or isolated so

that the noise emitted does not exceed an LAeq (15min) of not more than 5 dB(A) above the background level in any octave band from 31.5Hz to 8KHz centre frequencies inclusive at the boundary of the site

The swimming pool excavation and/or swimming pool must be provided with a suitable barrier to prevent a risk of falling into the excavation or pool at all times throughout the construction phase.

- -The measurement of sound must be carried out in accordance with Australian
- Standard 1055.1.
- -Additional information is available from Sutherland Shire Swimming Pool
- Environmental Specification
- -Landscaping and ancillary structures must not intrude into the child-resistant
- barrier Non-Climbable Zone.
- -Only structures associated with the pool may be located within the pool area.
- -Clothes lines, barbeque, sheds, entertainment structure, outside toilets or any other non pool-related structures are not permitted within the pool area.

Before the issue of any Occupation Certificate:

- i) The child resistant barrier must be installed in accordance with A above.
- ii) The swimming pool is to be registered in the NSW Swimming Pool Register.

The pump and associated equipment must be maintained and operated in accordance with the noise levels described above.

ii) The child resistant barrier must be maintained in accordance with the Australian Standard as described above.

LANDSCAPE MAINTENANCE NOTES

MONTH	MOWING EDGING BLOWING	FERTILISING (SEASOL)	CHECK IRRIGATION	HAND WEED REMOVAL	PRUNING	WEED SPARAYING	WATERING/ IRRIGATION	PLANT REPLACEMENT IF REQUIRED
DEC	W	M	М	W	F	М	D	W
JAN	W	М	М	W	F	М	D	W
FEB	W	М	М	W	F	М	D	W
MAR	F	М	М	F	М	М	D	W
APR	F	N/A	М	F	М	М	D	W
MAY	F	N/A	М	М	M	М	D	W
JUNE	М	N/A	М	М	N/A	N/A	2ND D	W
JULY	М	N/A	М	М	N/A	N/A	2ND D	W
AUG	M	N/A	М	M	N/A	N/A	2ND D	W
SEP	М	М	М	М	N/A	N/A	2ND D	W
ОСТ	F	F	М	F	М	М	D	W
NOV	F	F	М	F	М	М	D	W
PLANTING	SESTABLISHM	MENT PERIOD - 1	12 MONTHS					

LANDSCAPE MATERIAL ESTABLISHMENT - 12 MONTHS

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Drawing No.**1142**

MAINTENANCE GENERAL NOTES

SECTION C: LANDSCAPE MAINTENANCE SPECIFICATION 1.0 SCOPE

1.1 PERIOD

The 52 week Planting Establishment Period commences at the date of registration of the repective plan. The contractor is to also allow for maintenance from the date of Practical Completion to the start date of the 52 week Planting Establishment Period. The allowance shall be for a weekly rate which will then be implemented until the formal maintenance period commences.

1.2 PROGRAM

Furnish a proposed planting maintenance program with the tender.

1.3 MAINTENANCE LOGBOOK

Contractor to keep a maintenance record of works carried out on a monthly basis. Log should include but not limited to: - Activities carried out during each attendance:

- Irregularities encountered and actions taken:
- NB: Maintenance payments will be evaluated on submission of monthly logbooks.

1.4 RECURRENT WORKS

Throughout the Planting Establishment Period, continue to carry out recurrent works of a maintenance nature including, but not limited to, watering, mowing, weeding, rubbish removal, fertilising, pest and disease control, staking and tying, replanting, cultivating, pruning and keeping the site neat and tidy. All rubbish related to landscape works shall be removed by the landscape contractor before it is allowed to accumulate .

1.5 PLANTING

Commence recurrent planting maintenance works at the completion of planting. Ensure the stock arriving on site is protected and maintained for healthy growth.

1.6 REPLACEMENTS

Continue to replace failed, damaged or stolen plants for the extent of the Planting Establishment Period.

1.7 MULCHED SURFACES

Maintain the surface in a clean and tidy condition and reinstate the mulch as necessary

1.8 GRASSED AREAS

Commence grass maintenance works at the completion of turfing, and continue to carry out grass maintenance throughout the contract and Planting Establishment Period, maintaining healthy weed free growth. 1.9 STAKES AND TIES

Adjust or replace as required . Remove those not required at the end of the Planting Establishment Period . 1.10 WATERING/ IRRIGATION

An irrigation system is to be installed to all mass planted beds and new tree planting, connected to a pump and the rainwater tank /OSD tank. Install one tap near the front boundary (Wurrook Circuit) and one tap on the rear (eastern) boundary. This system shall be installed and maintained for the duration of the maintenance period (52 weeks) and in perpetuity of the development . All irrigation works shall be performed by a licensed irrigation contractor. Materials to be used are to be submitted to the site superintendent for approval. The contractor shall provide design drawings and material specifications/samples prior to commencing work. All works are to be conducted to all current and relevant Australian Standards.

The contractor is to be completely responsible for the coordination of the installation of the irrigation system with other services throughout the site. Recommended flow rates: The system shall be set up on a trial basis and them adjusted to suit the local requirements and conditions. Once the system is satisfactorily adjusted the contractor shall make fortnightly visits within the establishment period to ensure satisfactory performance of the system and to adjust the watering periods as required . A minimum even coverage of 25mm of water per week is

2.0 REPORTS

2.1 LANDSCAPE MAINTENANCE REPORT

'Landscape Maintenance Reports' shall be submitted to the Principle Certifying Authority by the contractor verifying that satisfactory maintenance of the landscape works has been undertaken and that any necessary rectification measures have been carried out to a high professional standard. This documentation is to be submitted through the plant establishment period.

EXTERNAL LIGHTING - (AMENITY)

To ensure that any lighting on the site does not cause a nuisance to neighbours or motorists on nearby roads:

All lighting must be designed in accordance with Australian Standard AS4282 -Control of the Obtrusive Effects of Outdoor Lighting.

Ongoing

All lighting must be operated and maintained in accordance with the Standard above.

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AMENDMENTS

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GENERAL NOTES
All work to be carried out in accordance with the Building Code of Australia, all Local and State Government Ordinances, relevant Australian Standards, Local
Authorities Regulations and all other relevant Authorities concerned.
All structural work and site drainage to be subject to Engineer's details or certification where required by Council. This shall include r.c. slabs and footings, r.c. and
steel beams & columns, wind bracing to AS 1170
and AS4055, anchor rods or bolts, tie downs, futings etc., driveways slabs and drainage to Council's satisfaction. All timbers to be in accordance with SAA Timber
Structure Code AS1720 and SAA Timber Framing Code AS 1684. All work to be carried out in a professional and workman- shiplike manner according to the plans

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LANDSCAPE WORK SPECIFICATION

PRELIMINARIES

1.01 GENERAL

The following general conditions should be considered prior to the commencement of landscape works

The landscape plans should be read in conjunction with the architectural plans, hydraulic plans, service plans and survey prepared for the proposed

All services including existing drainage should be accurately located prior to the commencement of landscape installation. Any proposed tree planting which falls close to services will be relocated on site under the instruction of the landscape architect

Installation of conduit for required irrigation, electrical and other services shall be completed prior to the commencement of hardscape works and

All outdoor lighting specified by architect or client to be installed by qualified electrician

Anomalies that occur in these plans should be brought to our immediate attention

Where an Australian Standard applies for any landscape material testing or installation technique, that

standard shall be followed

1.02 PROTECTION OF ADJACENT FINISHES

The Contractor shall take all precautions to prevent damage to all or any adjacent finishes by providing adequate protection to these areas / surfaces prior to the commencement of the Works

1.03 PROTECTION OF EXISTING TREES

Existing trees identified to be retained shall be done so in accordance with NATSPEC Guide 2 "A Guide to Assessing Tree Quality". Where general works are occurring around such trees, or pruning is required, a qualified Arborist shall be engaged to oversee such works and manage tree health

Existing trees designated on the drawing for retention shall be protected at all times during the construction period. Any soil within the drip-line of exi

trees shall be excavated and removed by hand only. No stockpiling shall occur within the root zone of existing trees to be retained Any roots larger in diameter than 50mm shall only be severed under instruction by a qualified arborist. Roots smaller than 50mm diameter shall be cut

cleanly with a saw

Temporary fencing shall be installed around the base of all trees to be retained prior to the commencement of landscape works. Where possible this fencing will be located around the drip line of these trees, or a minimum of 3m from the trunk. The fencing shall be maintained for the full construction period 1.04 EROSION & POLLUTION CONTROL

The Contractor shall take all proper precautions to prevent the erosion of soil from the subject site. The contractor shall install erosion & sediment control barriers and as required by council, and maintain these barriers throughout the construction period. Note that the sediment control measures adopted should reflect the soil type and erosion characteristics of the site.

Erosion & pollution control measures shall incorporate the following

- Construction of a sediment trap at the vehicle access point to the subject sit
- Sediment fencing using a geotextile filter fabric in the location indicated on the erosion control plan or as instructed on

- Earth banks to prevent scour of stockpiles
- Sandbag kerb sediment traps
- Straw hale & geotextile sediment filter
- Exposed banks shall be pegged with an approved Jute matting in preparation for mass planting

Refer to "Sitewise Reference Kit" as prepared by DLWC & WSROC (1997) for construction technique

2.01 MATERIALS

Specified Soil Conditioner (Generally to improve site soil)

The specified soil conditioner for site top-soil improvement shall be an organic mix, equal to "Botany Humus", as supplied by ANL. Note that for sites where soil testing indicates toxins or extremes in pH, or soils that are extremely poor, allow to excavate and supply 300mm of imported soil mix

New gardens & proposed Planting

New garden and planting areas shall consist of a 50/50 mix of clean site soil (refer d) below) and imported "Organic Garden Mix" as supplied by ANL or approved equal. All mixes are to comply with AS 4419 Soils for landscaping & garden use, &AS 4454 Composts, Soil conditioners & mu

Specified Soil Mix - Turf

The specified soil mix for all turf areas shall be a min 75mm layer of imported soil mix consisting of 80% washed river sand (reasonably coarse), and 20% composted organic matter equivalent to mushroom compost or soil conditioner, or other approved lawn top dress.

Site topsoil is to be clean and free of unwanted matter such as gravel, cXXIay lumps, grass, weeds, tree roots, sticks, rubbish and plastics, and any deleterious materials and materials toxic to plants. The topsoil must have a pH of between 5.5 and 7. Use 100% imported soil mix when site when site topsoil runs out.

a) Establishing Subgrade Levels

Subgrade levels are defined as the finished base levels prior to the placement of the specified material (i.e. soil conditioner). The following subgrade levels shall apply

Mass Planting Beds - 300mm below existing levels with specified imported soil mix.

Turf areas - 100mm below finished surface level

Note that all subgrades shall consist of a relatively free draining natural material, consisting of site topsoil placed previously by the Civil Contractor. No builders waste material shall be acceptable

b) Subgrade Cultivation

Cultivate all subgrades to a minimum depth of 100mm in all planting beds and all turf areas, ensuring a thorough breakup of the subgrade into a reasonably coarse tilth. Grade subgrades to provide falls to surface and subsurface drains, prior to the placement of the final specified soil mix

c) Drainage Works

Install surface and subsurface drainage where required and as detailed on the drawing. Drain subsurface drains to outlets provided, with a minimum fall of 1:100 to outlets and / or service pits.

d) Placement and Preparation of Specified Soil Conditioner & Mixes

Trees in turf & beds - Holes shall be twice as wide as root ball and minimum 100mm deeper - backfill hole with 50/50 mix of clean site soil and imported "Organic Garden Mix" as supplied by ANL or approved equal

Mass Planting Beds - Install specified soil conditioner to a compacted depth of 100mm

Place the specified soil conditioner to the required compacted depth and use a rotary hoe to thoroughly mix the conditioner into the top 300mm of garden bed soil. Ensure thorough mixing and the preparation of a reasonably fine tilth and good growing medium in preparation for planting. Turf Areas - Install specified soil mix to a minimum compacted depth of 75mm

Place the specified soil mix to the required compacted depth and grade to required finished soil levels, in preparation for planting and turfing

PLANTING

3.01 MATERIALS

a) Quality and Size of Plant Material

All trees supplied above a 25L container size must be grown and planted in accordance with Clarke, R 1996 Purchasing Landscape Trees: A guide to assessing tree quality. Natspec Guide No. 2. Certification that trees have been grown to Natspec guidelines is to be provided upon request of Council's Tree Management Officer

Above - Ground Assessment

The following plant quality assessment criteria should be followed:

Plant true to type, Good vigour and health, free from pest & disease, free from injury, self-supporting, good stem taper, has been pruned correctly, is apically dominant, has even crown symmetry, free from included bark & stem junctions, even trunk position in pot, good stem structure Below - Ground Assessment

Good root division & direction, rootball occupancy, rootball depth, height of crown, non-suckering For further explanation and description of the assessment criteria, refer to Ross Clark's book.

Landscape Architect. No plant shall be accepted which does not conform to the standards listed above

Provide min. 2 No. Stakes and ties to all plants identified as trees in the plant schedule. Stakes shall be sound, unpainted, straight hardwood, free of knots and pointed at one end. They shall be 2200mm x 50mm x 50mm Hardwood , or approved alternative . Ties shall be 50mm wide hessian webbing material.

c) Fertilisers

Fertilisers shall be approved slow release fertilisers suitable for the proposed planting types. Note that for native plants specifically Proteaceae family plants including Grevillea species, low phosphorus fertilizers shall be used

d) Mulch

Mulch shall be an approved equal to "Forest Blend" as supplied by ANL. Mulch shall be completely free from any soil, weeds, rubbish or other debris.

e) Turf

Turf shall be "Sir Walter" Buffalo or equivalent (unless stated otherwise), free from any weeds and other grasses, and be in a healthy growing condition

3.02 INSTALLATION

a) Setting Out

All planting set out shall be in strict accordance with the drawings, or as directed. Note that proposed tree planting located near services should be adjusted at this stage. Notify Landscape Architect for inspection for approval prior to planting.

b) Planting

All plant material shall be planted as soon after delivery as possible. Planting holes for trees shall be excavated as detailed and specified. Plant containers shall be removed and discarded, and the outer roots gently teased from the soil mass Immediately set plant in hole and backfill with specified soil mix, incorporating the approved quantity of fertiliser for each plant type. Ensure that plants are set plumb vertically and root balls set to the consolidated finished grades detailed on the drawings. Compact the backfilled soil and saturate by hand watering to expel any remaining air pockets immediately after planting.

c) Staking and Tying

Staking and tying shall be in strict accordance with the drawings and shall occur immediately following plant placement and soil backfilling. All plants identified as "Trees" on the planting schedule shall be staked with a min. 3 stakes

Mulch should be spread so that a compacted thickness of 75mm is achieved after settlement in all planting beds and around each individual plant. Apply immediately following planting and watering in, ensuring that a 50mm radius is maintained around the trunk of each plant . There shall be no mixing of soil and mulch material .

e) Turfing

Moisten soil prior to the turf being laid. Turf shall be neatly butt jointed and true to grade to finish flush with adjacent surfaces Incorporate a lawn fertilizer and thoroughly water in. Keep turf moist until roots have taken and sods/rolls cannot be lifted. Keep all traffic off turf until this has occurred. Allow for top dressing of all turf areas. All turf shall be rolled immediately following installation

f) Steel Garden Edging

The Contractor shall install stone edging as shown on the drawings, to all mass planting beds adjoining turf or gravel mulched areas, and where required. The resultant edge shall be true to line and flush with adjacent surfaces

HARDSCAPE WORKS

4.01 GENERAL

The Contractor shall undertake the installation of all hardscape works as detailed on the drawing , or where not detailed , by manufacturers specification

Paving - refer to typical details provided, and applicable Australian Standards . Permeable paving may be used as a suitable means of satisfying Council permeable surface requirements, while providing a useable, hardwearing, practical surface. In most instances, the client shall nominate the appropriate paving material to be

Australian Standards shall be adhered to in relation to all concrete, masonry & metal work, Some details are typical and may vary on site. All hardscape works shall be setout as per the drawings, and inspected and approved by the Landscape Architect prior to installation. All workmanship shall be of the highest standard. Any que or problems that arise from hardscape variations should be bought to the attention of the Landscape Architect

Your attention is directed to any obligations or responsibilities under the Dividing Fences Act, 1991 in respect of adjoining property owner/s which may arise from this application. Any enquiries in this regard may be made to the Crown Lands Division on (02) 8836-5332

IRRIGATION WORKS

5.01 GENERAL (PERFORMANCE SPECIFICATION)

An automated drip-irrigation system is to be installed to all gardens, planters and lawn areas in accordance with the approved Irrigation Design

This system shall be designed and installed by a qualified and licensed irrigation specialist, to the highest industry standards and to maximise the efficient usage of

The Installer is required to obtain all approvals necessary for the completion of works in accordance with the Laws of Australia, Laws of the State of NSW, Council By-Laws and Ordinances

Drawings:

-The Landscape Contractor nominated Licensed Irrigation Specialist shall provide irrigation drawings for approval upon engag

- The irrigation system shall be installed prior to all planting works. It shall incorporate a commercially available irrigation system, with sub-surface dripper lines to irrigate all gardens, planters and lawn areas.

-It shall incorporate a suitable back flow prevention device for the scale of works, an in-line filter, check valves, and suitable high and low density poly hose fittings and PVC piping to achieve flow rates suitable for specified planting

- The irrigation application rate shall not exceed the infiltration rate of the soil or creates run-off
- The landscape contractor shall check the existing pressure available from the ring mains and size irrigation piping to suit. Supply shall be from local hose cock where

-All piping and fittings shall be buried 50mm below the finished soil levels in garden and lawn areas, and secured in position at 500mm centres with galv wire pins

- Size of pipes shall be selected to ensure the working pressure at the end of the line does not decrease by more than 5%

Services Co-ordination

- Co-ordination required by Landscape Contractor or Project Manager to provide required conduit, pipe work and penetration through slabs and planter walls for water

- The Landscape Contractor shall be engaged with the Irrigation Specialist to co-ordinate with the Project Manager to identify the preferred service and conduit

- Project Manager and Landscape Contractor to establish area suitable for irrigation control system with required area, power provision and water supply.

Upon completion of installation, the system shall be tested, including

-Main Line Pressure Test: The main line is pressurised to test for leaks. All valves are shut and the pressure is taken over a determined length of time

- Dripper Pressure Test: Measurement at flushing valves are taken and the pressure gauged to make sure it conforms to the manufacturer recommendations . The inlet pressure is then tested under the same conditions to check it does not exceed 300Kpa

-All components are to be satisfactorily functional and operational prior to approval. Should any defect develop, or the capacity or efficiency of the system decline during the agreed maintenance system, then these faults shall be immediately rectified

-A full 12 month warranty shall be included to cover labour and all parts

- On request, a detailed irrigation performance specification report can be issued

12 MONTH MAINTENANCE

The consolidation and maintenance period shall be 12 months beginning from the approved completion of the specified construction work (Practical Completion). A qualified landscape maintenance contractor shall undertake the required landscape maintenance works. Consolidation and maintenance shall mean the care and naintenance of Contracted works by accepted landscaping or horticultural practices, ensuring that all plants are in optimum growing conditions and appearance at all times, as well as rectifying any defects that become apparent in the contracted works

This shall include, but not be limited to, the following items where and as required: Watering all planting and lawn areas / irrigation maintenance

Clearing litter and other debris from landscaped areas

Removing weeds, pruning and general plant maintenance

placement of damaged, stolen or unhealthy plants. Make good areas of soil subsidence or erc Topping up of mulched areas

Spray / treatment for Insect and disease control

Fertilizing with approved fertilizers at correct rates.

Mowing lawns & trimming edges each 14 days in summer or 18 days in winter Adjusting ties to Stake

Maintenance of all paying, retaining and hardscape elements

On the completion of the maintenance period, the landscape works shall be inspected and at the satisfaction of the superintendent or landscape architect, the responsibility will be signed over to the client.xx

> 11/06/20 For Review ISSUE DATE COMMENT

AMENDMENTS

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VENEZAL NOTES to carried out in accordance with the Building Code of Australia, all Local and State Government Ordinances, relevant Australian Standards, Local All work to be carried out in accordance and all other relevant Auditorities concerned.

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