

#### CONTENTS


PERSPECTIVES
SURVEY
SITE ANALYSIS & WASTE MANAGEMENT PLAN
GARAGE FLOOR PLAN
GROUND FLOOR PLAN
EIGHT FLOOR PLAN DA1 DA2 DA3 DA5 DA6 FIRST FLOOR PLAN DA7 DA8 THIRD FLOOR PLAN FOURTH FLOOR PLAN ROOF PLAN ELEVATIONS, N, S ELEVATIONS, E DA9 DA10 DA11 ELEVATIONS, W ELEVATIONS, W1 SECTIONS A-A, B-B DA12 DA13 DA14 DA15 SECTIONS B1-B1 SECTIONS C-C DA17 SECTIONS D-D, E-E DA18 SECTIONS F-F LANDSCAPING PLAN SOLAR JUNE 21-9AM DA19 DA20 SOLAR JUNE 21-12PM SOLAR JUNE 21-3PM


## private residence


## 67 marine parade, avalon


additions & alterations development application


architectural perspectives

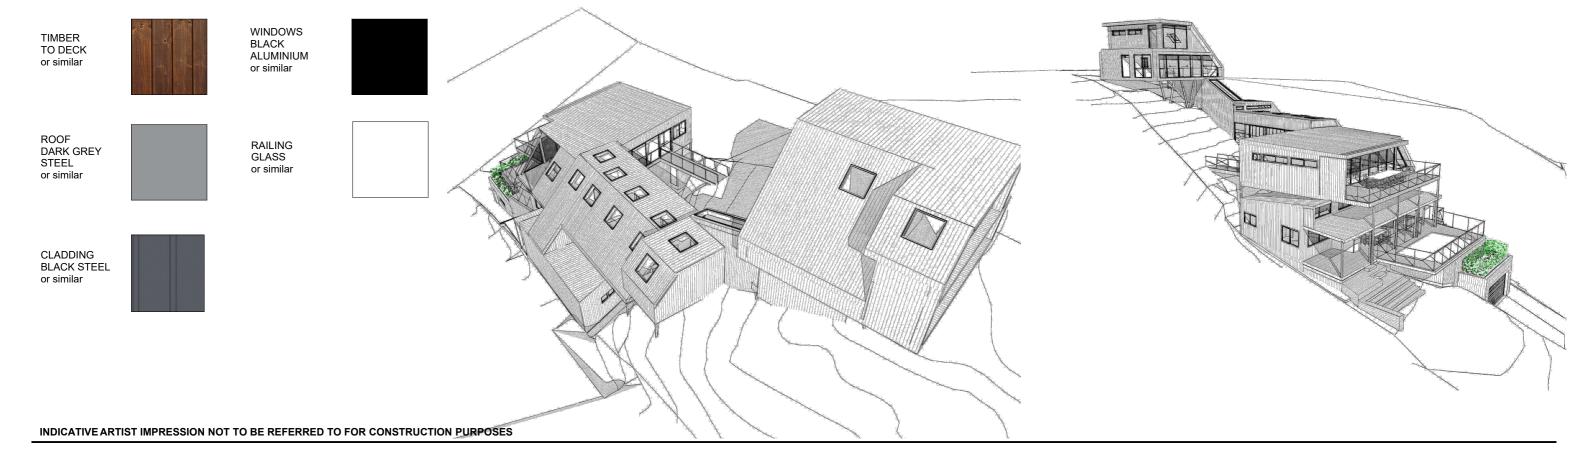


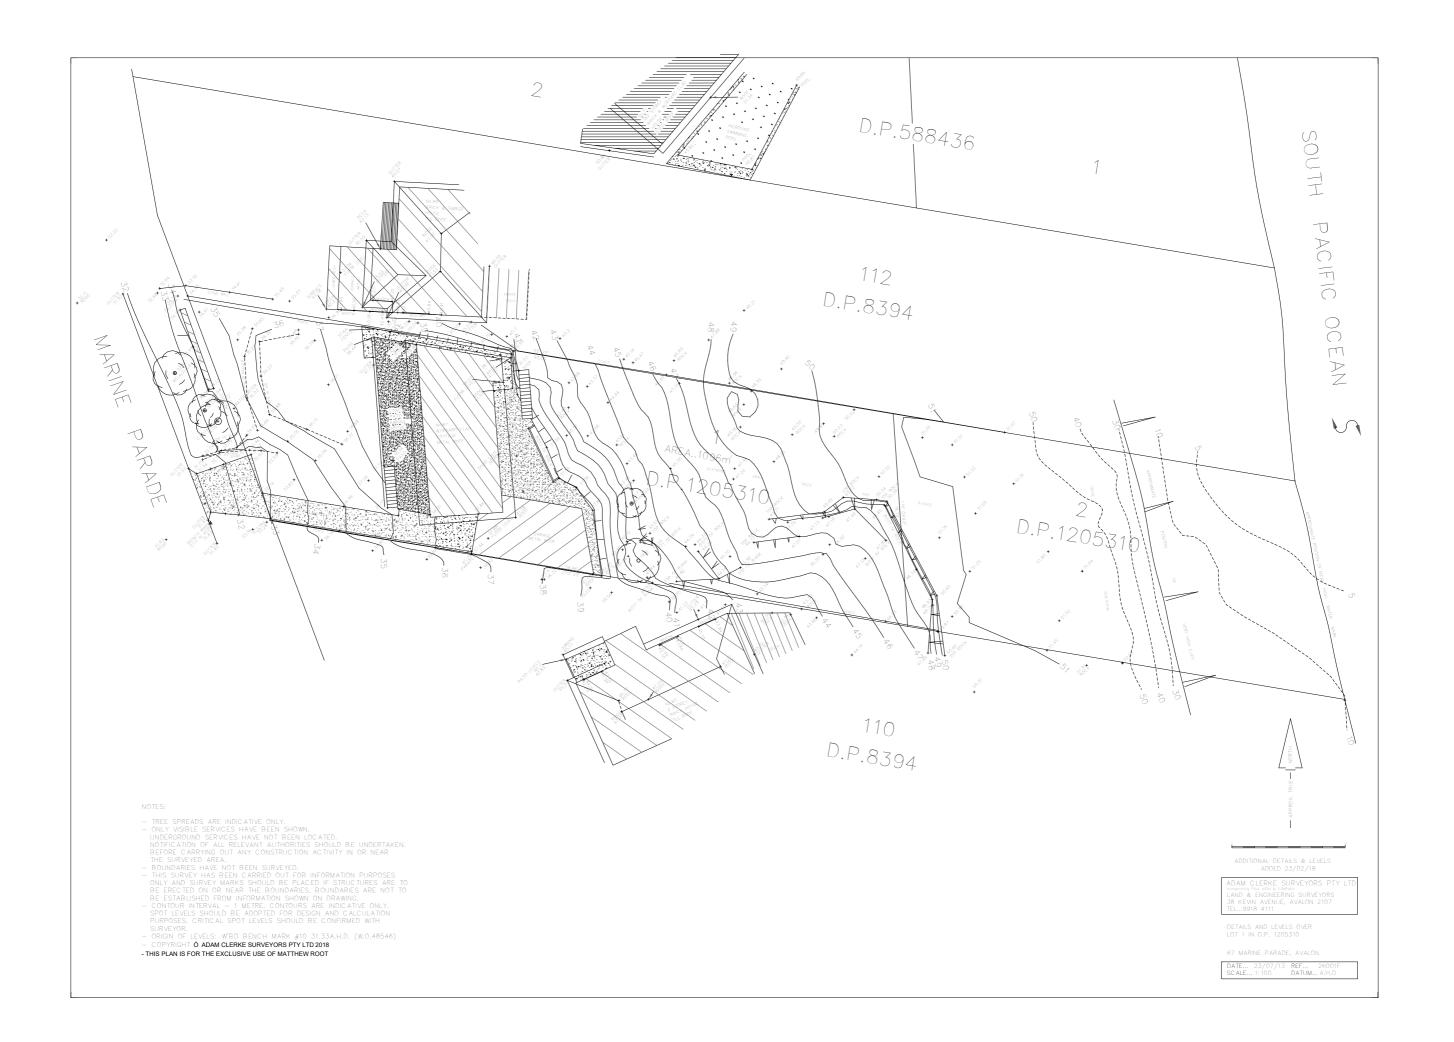


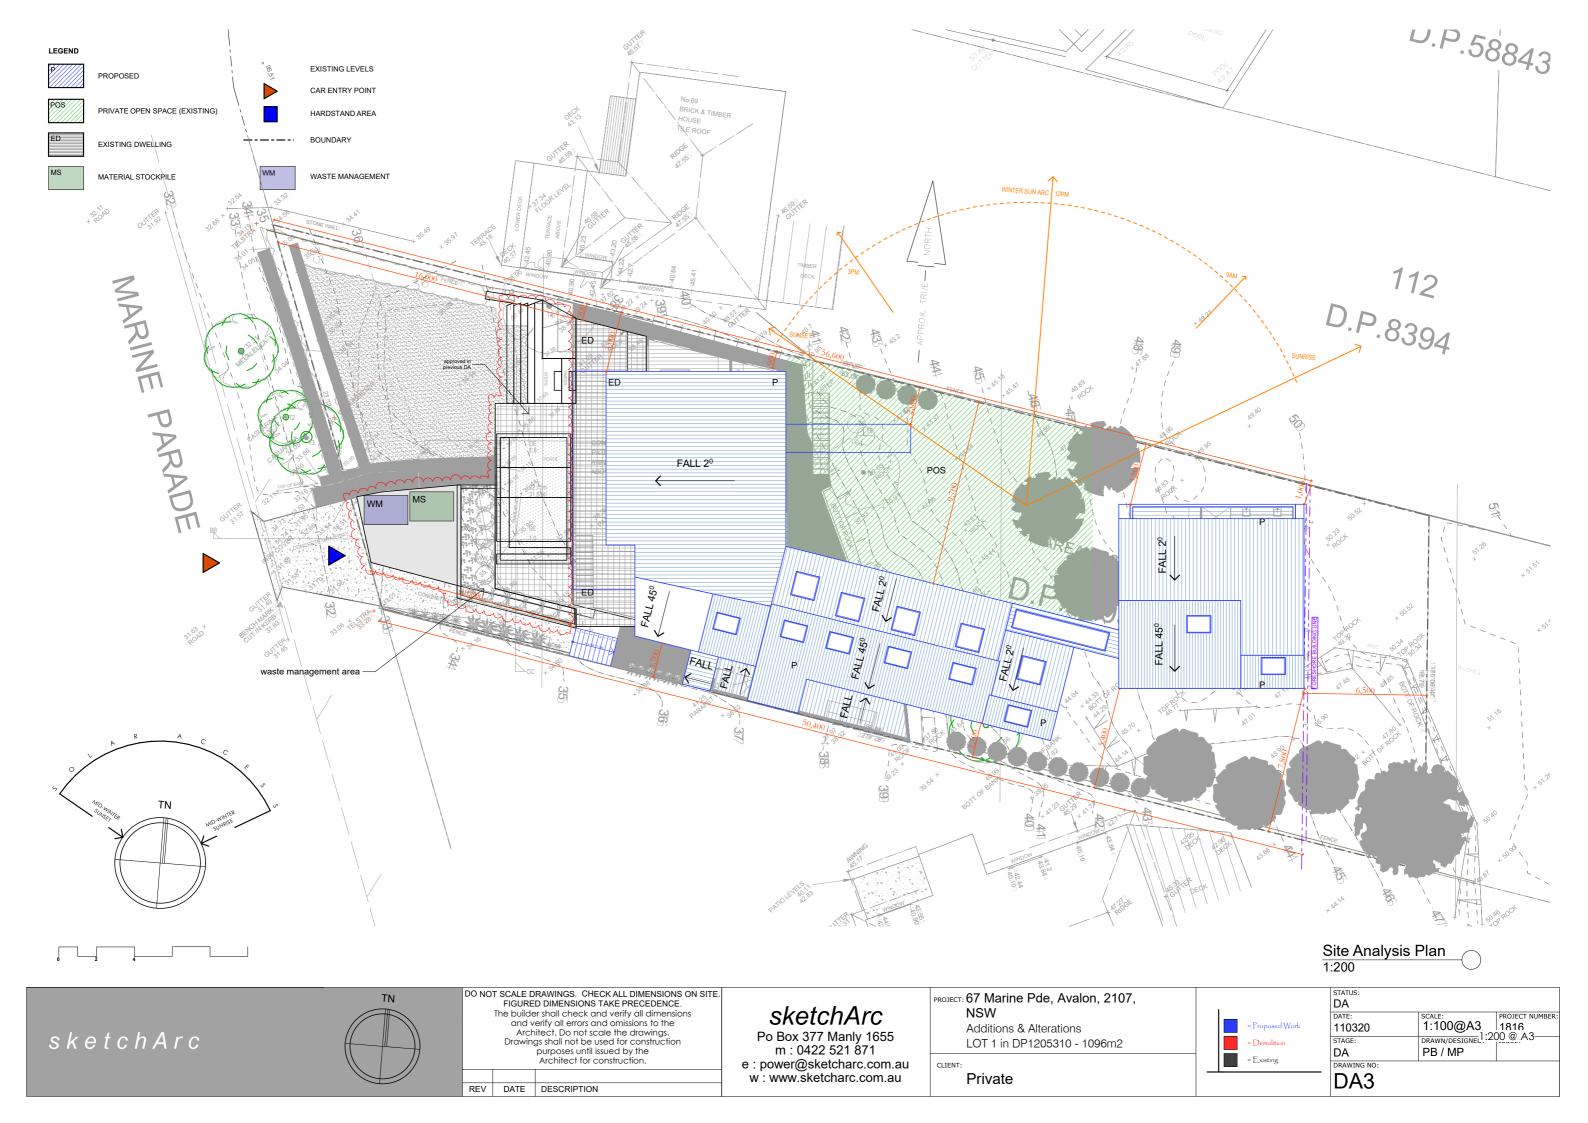


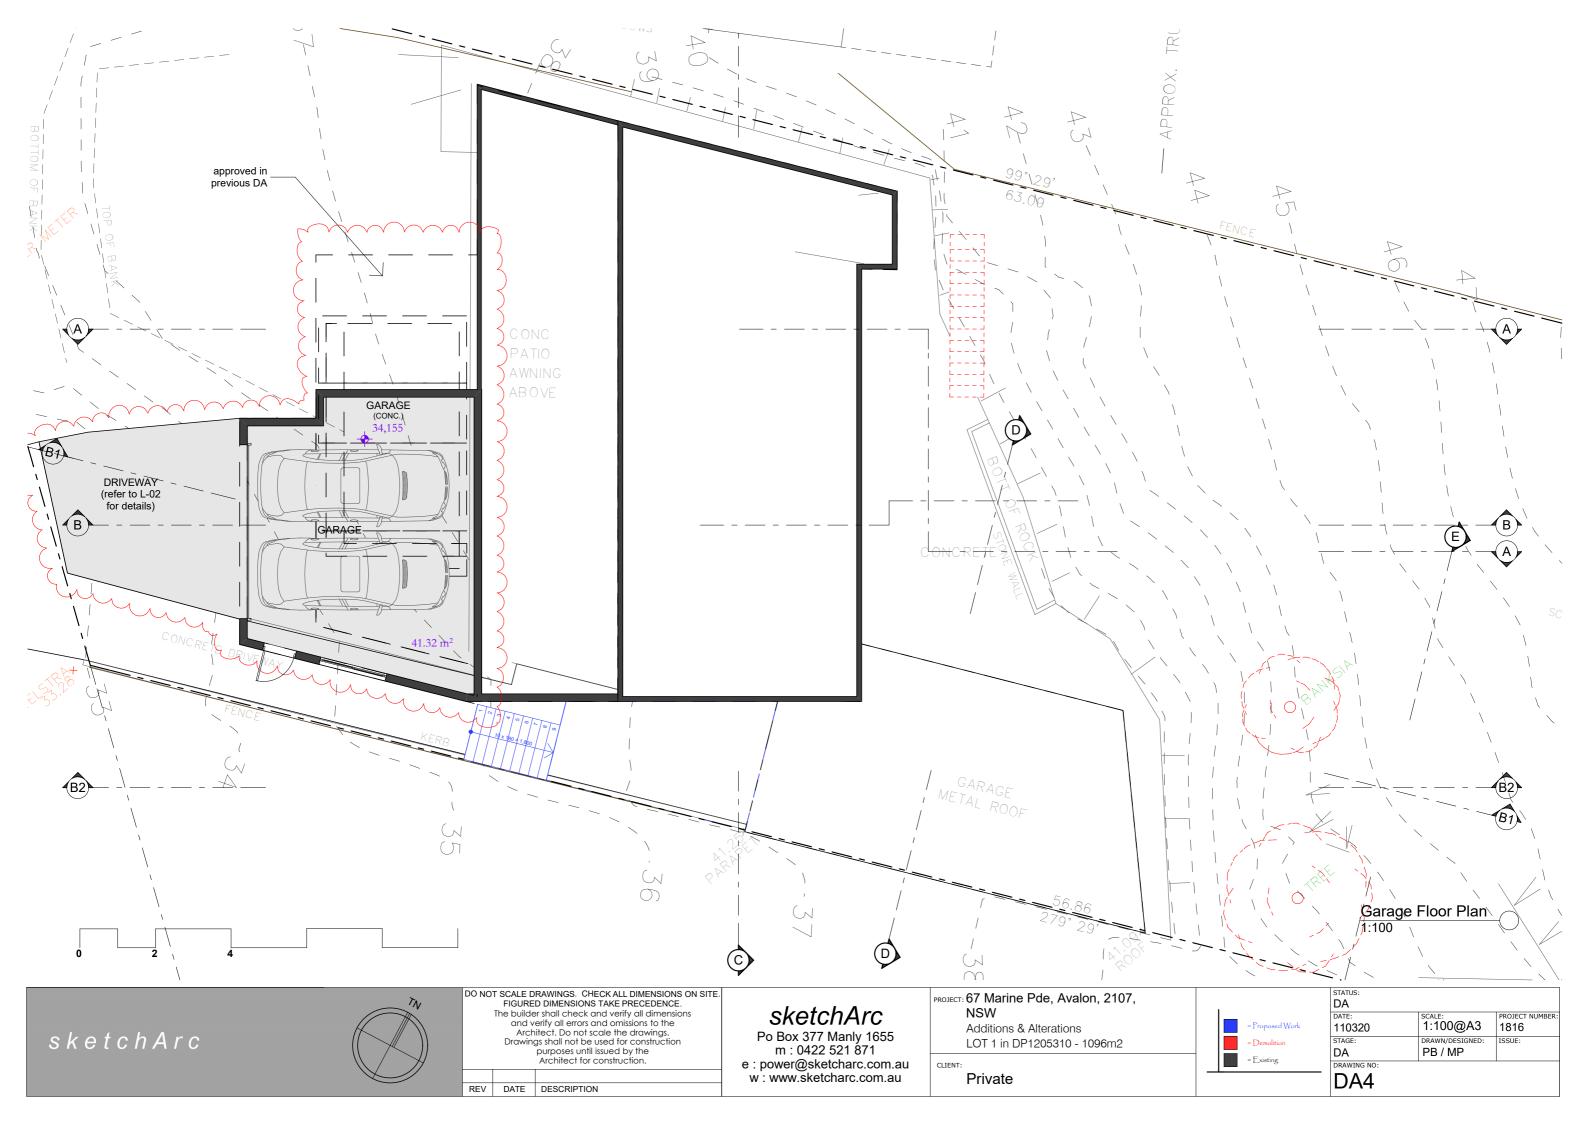


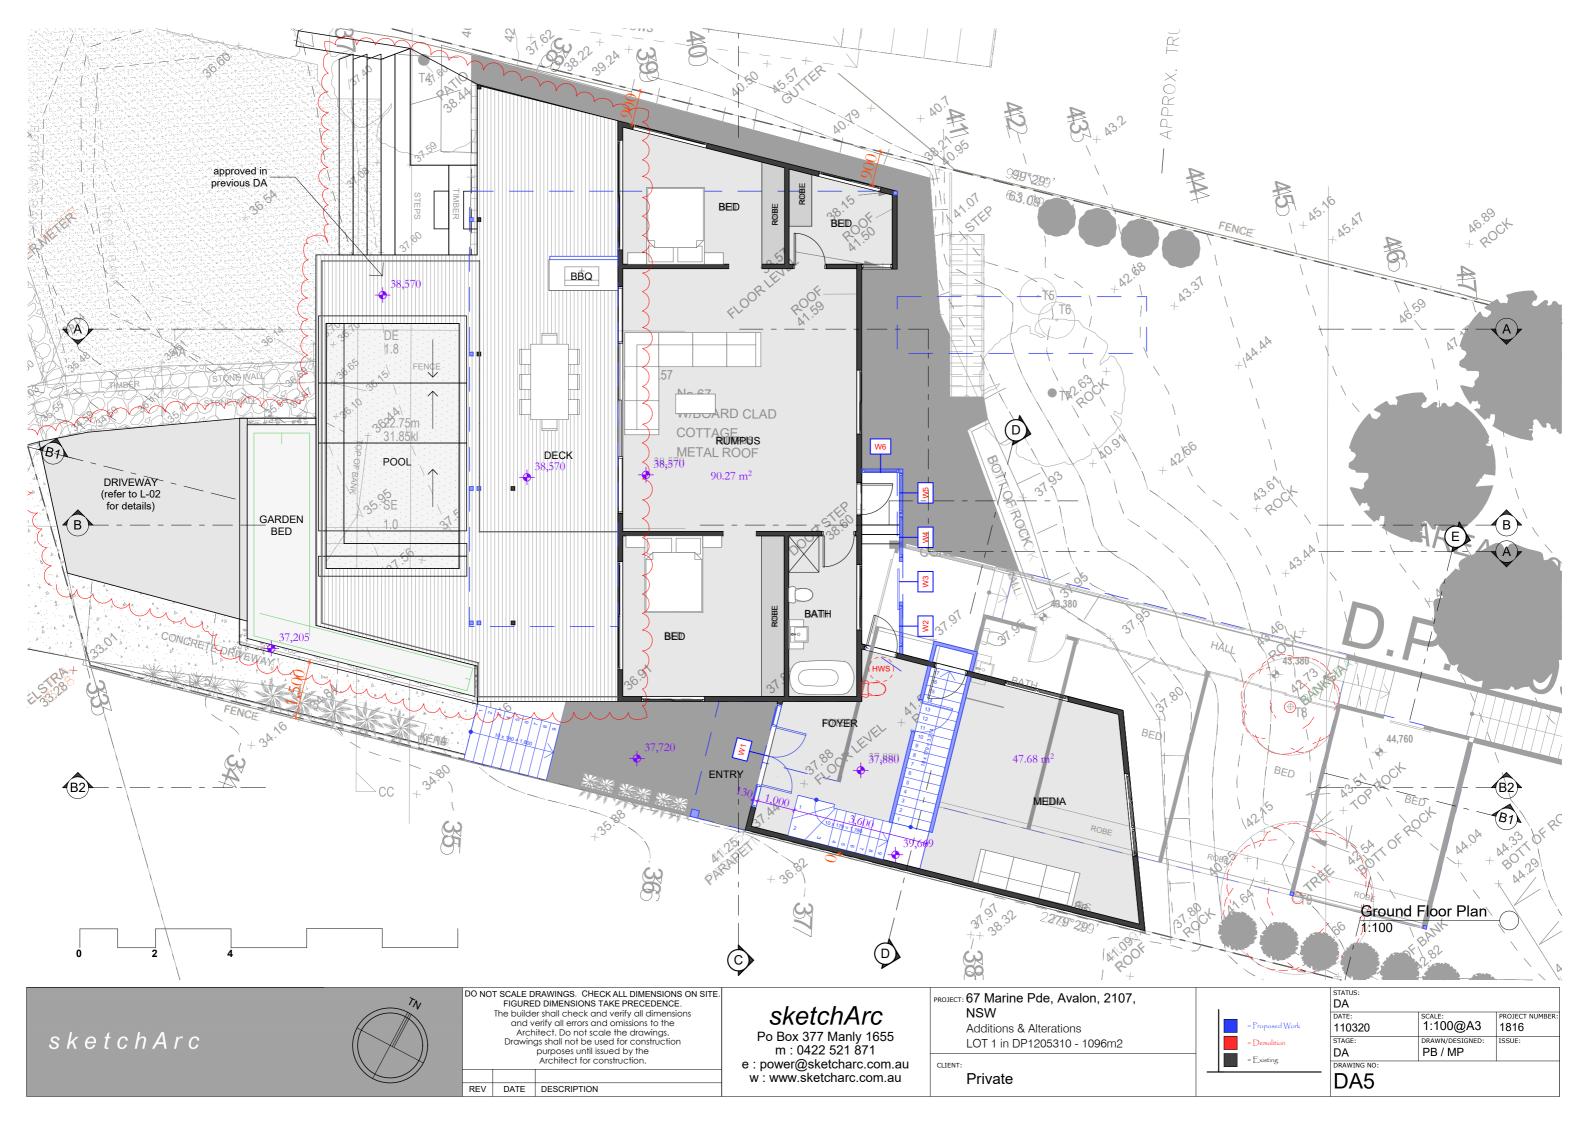


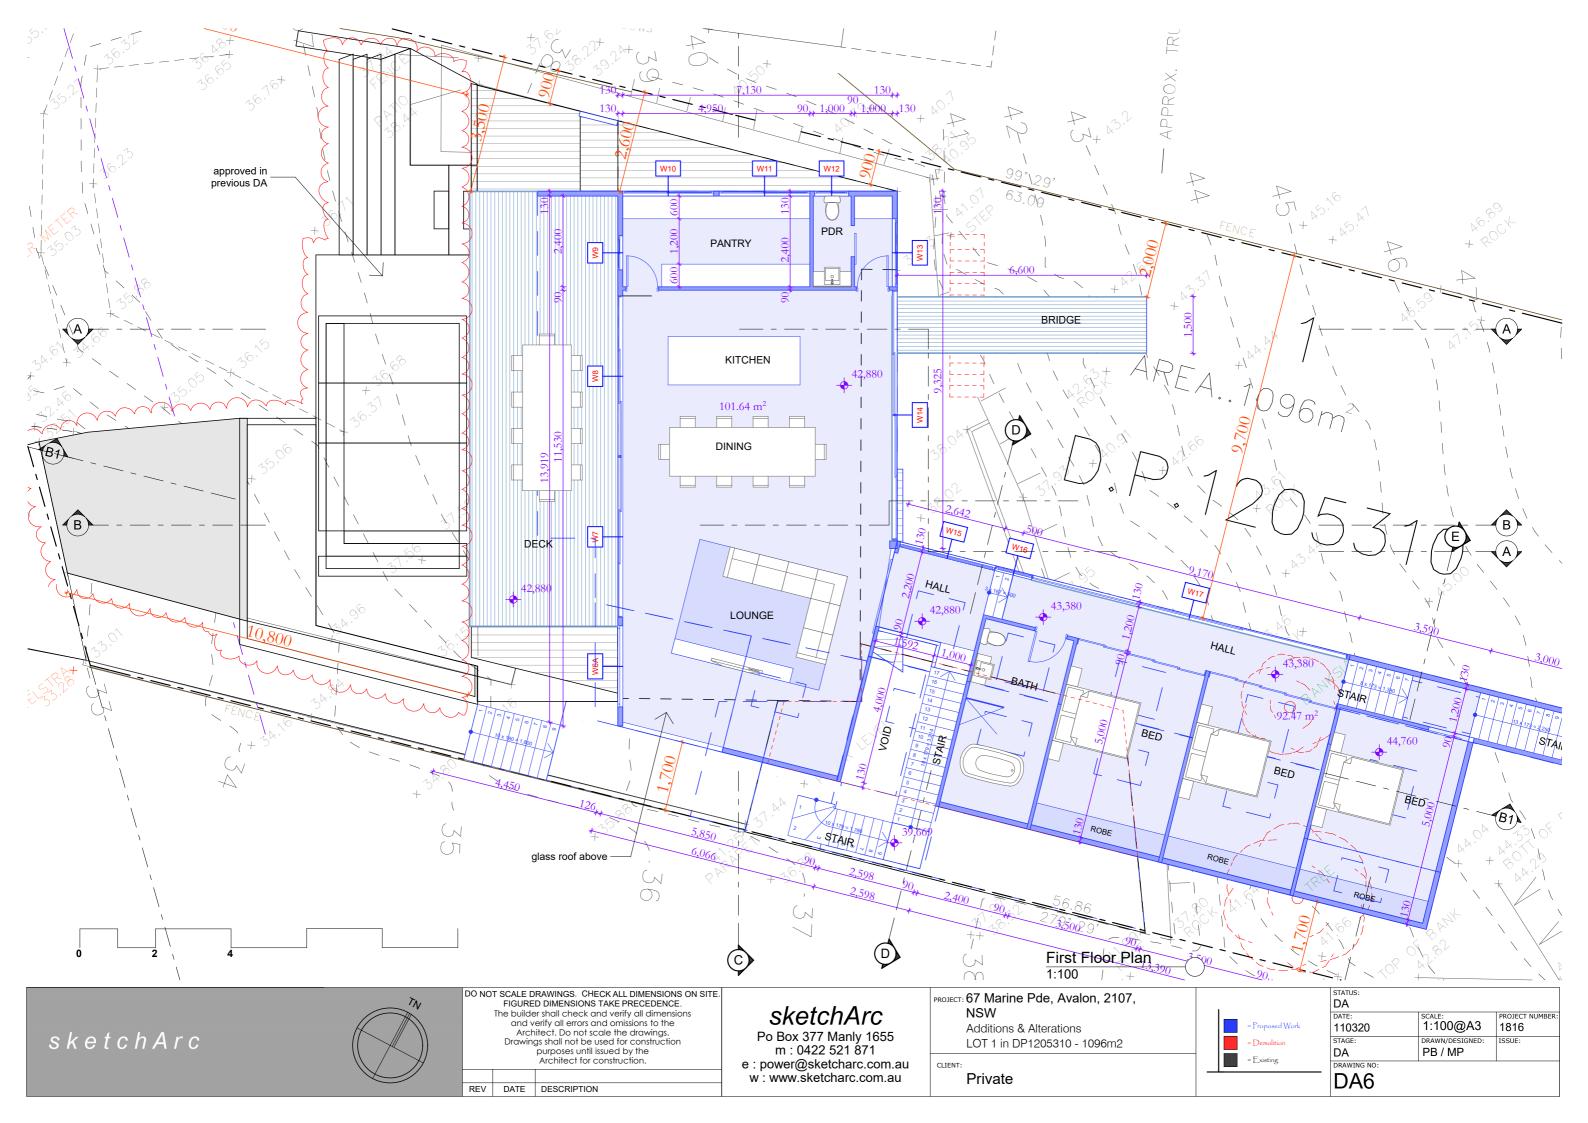


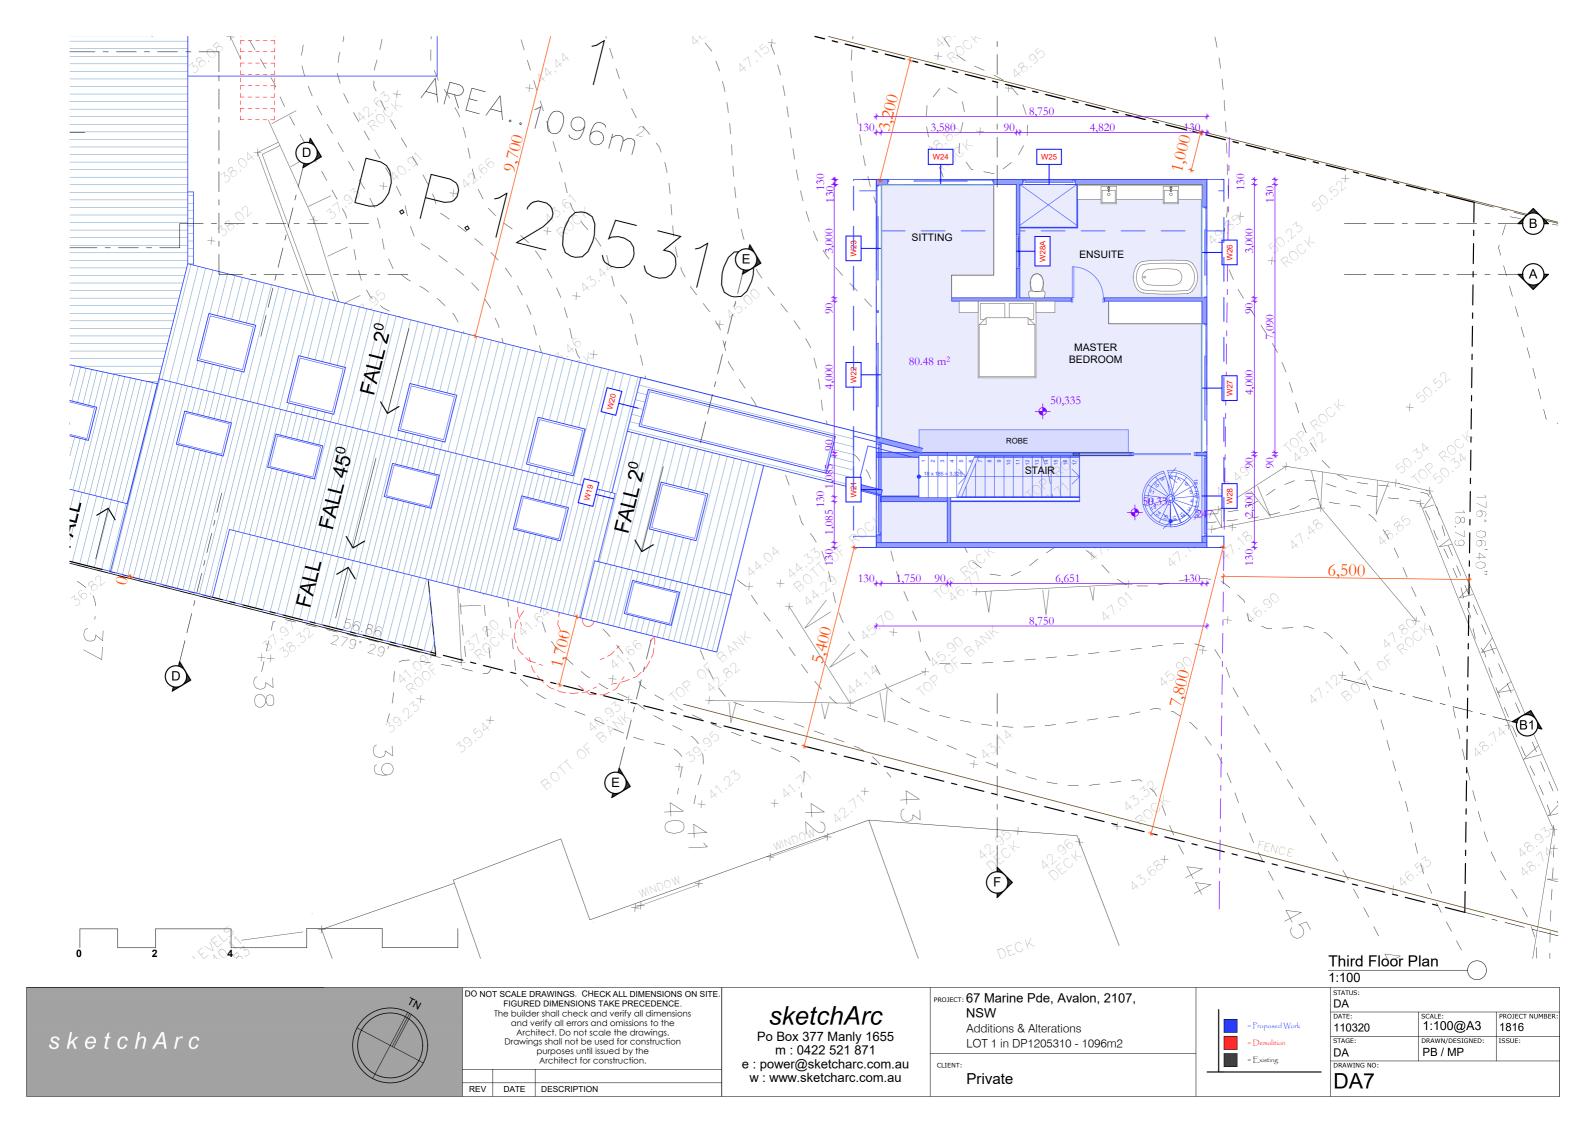


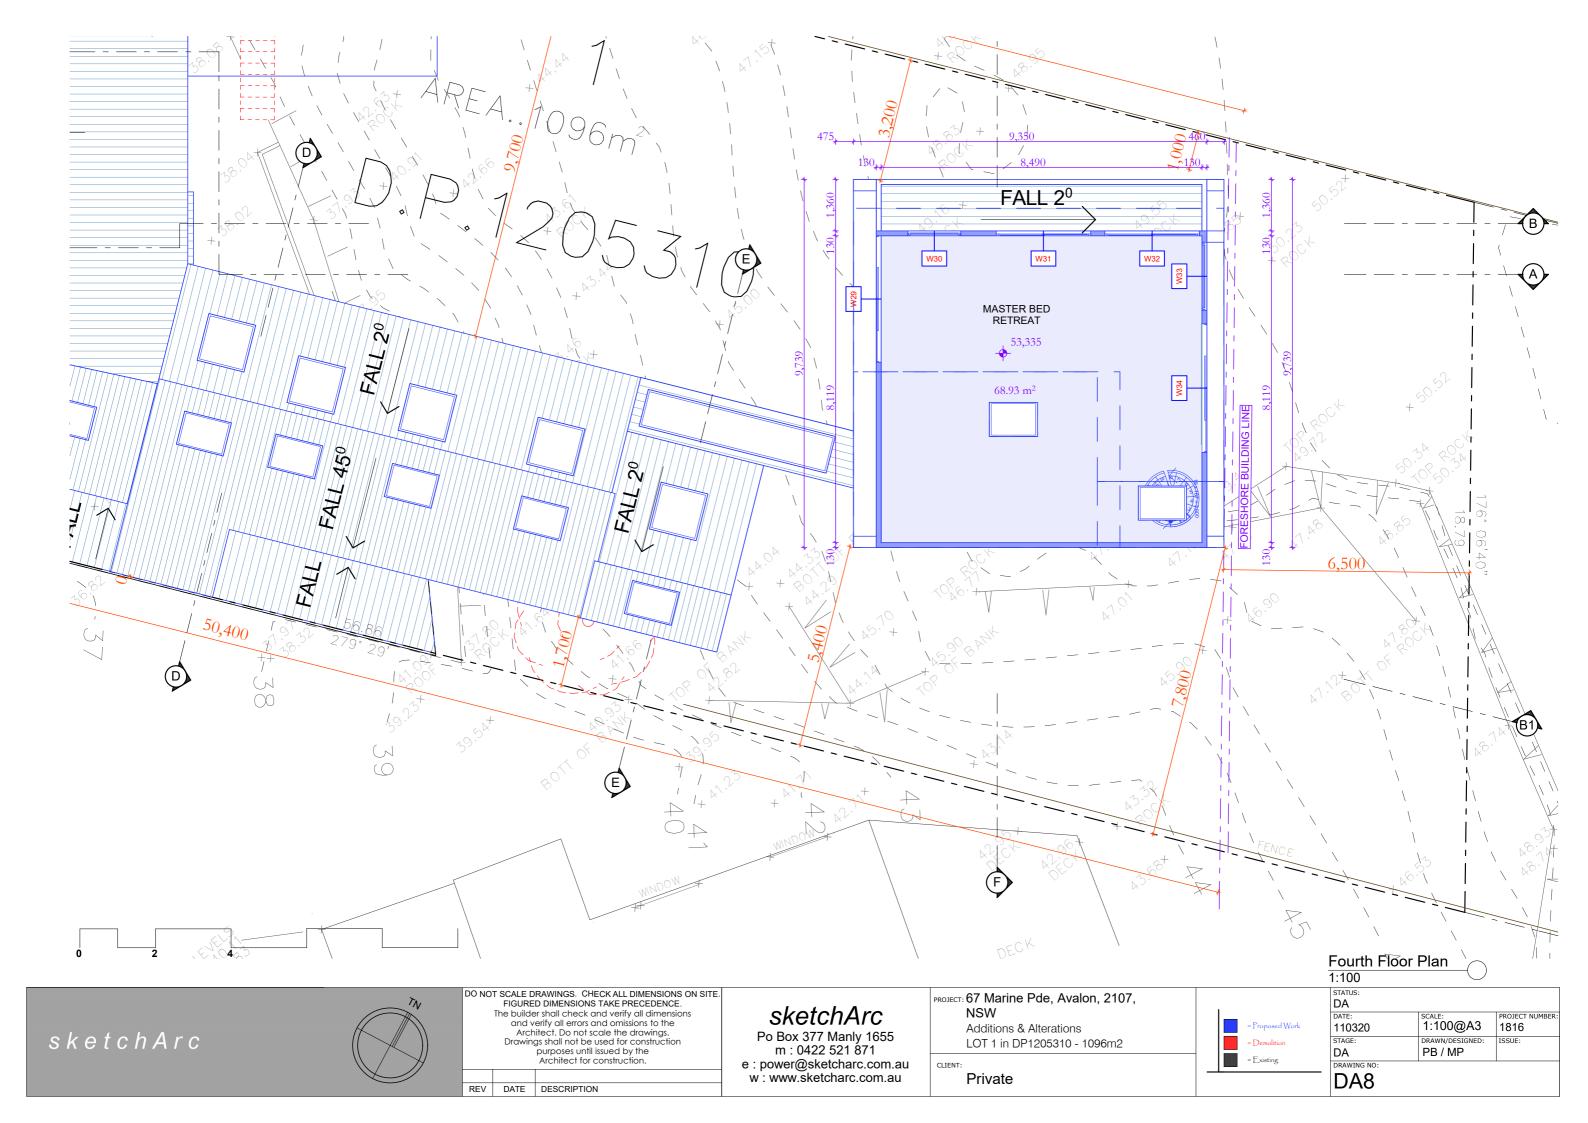

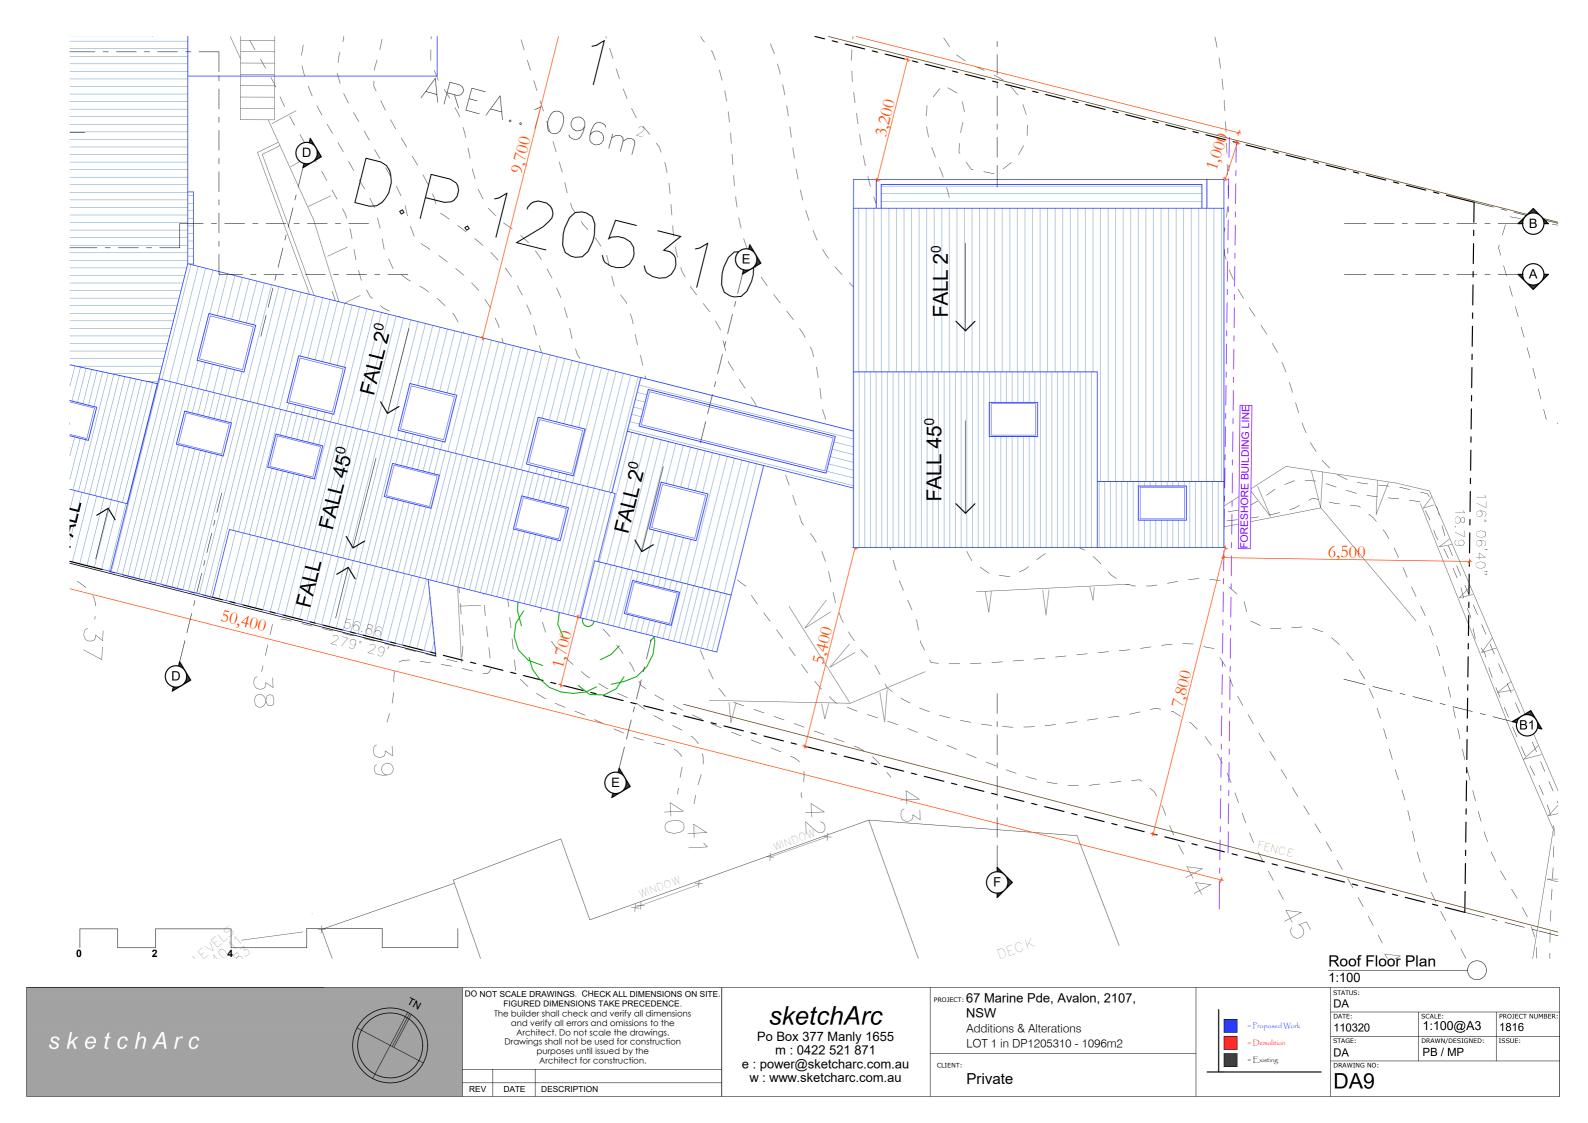

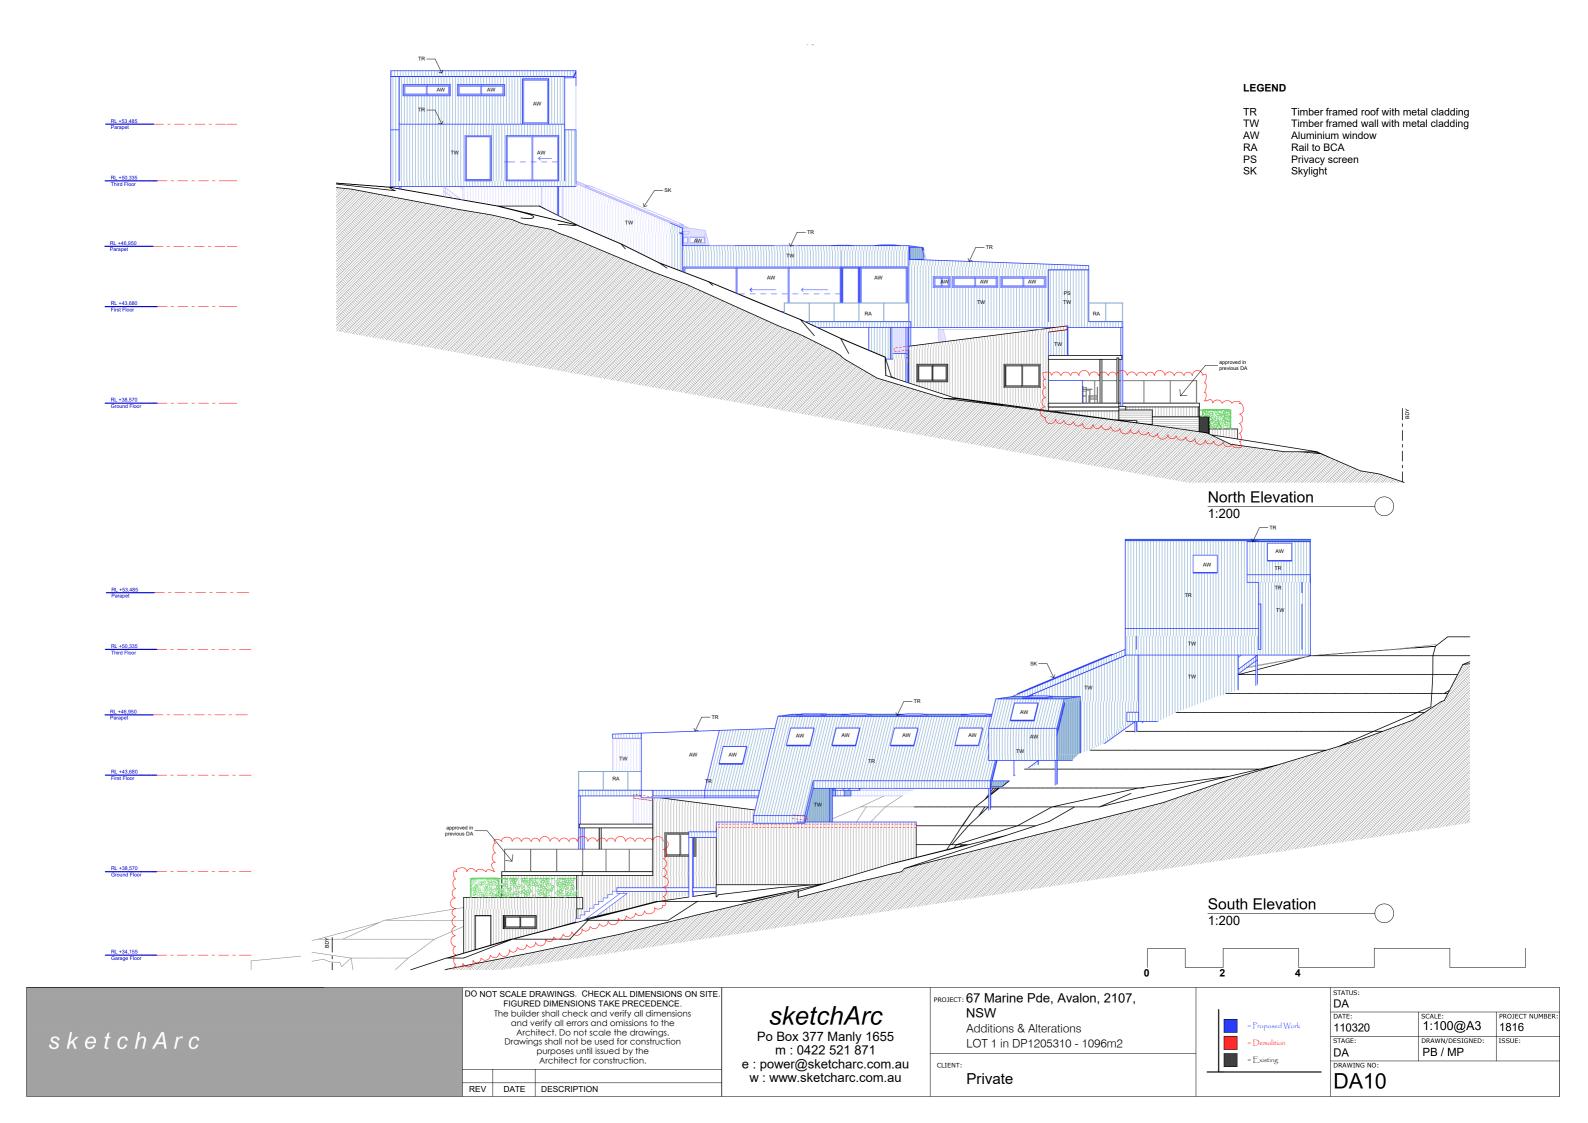

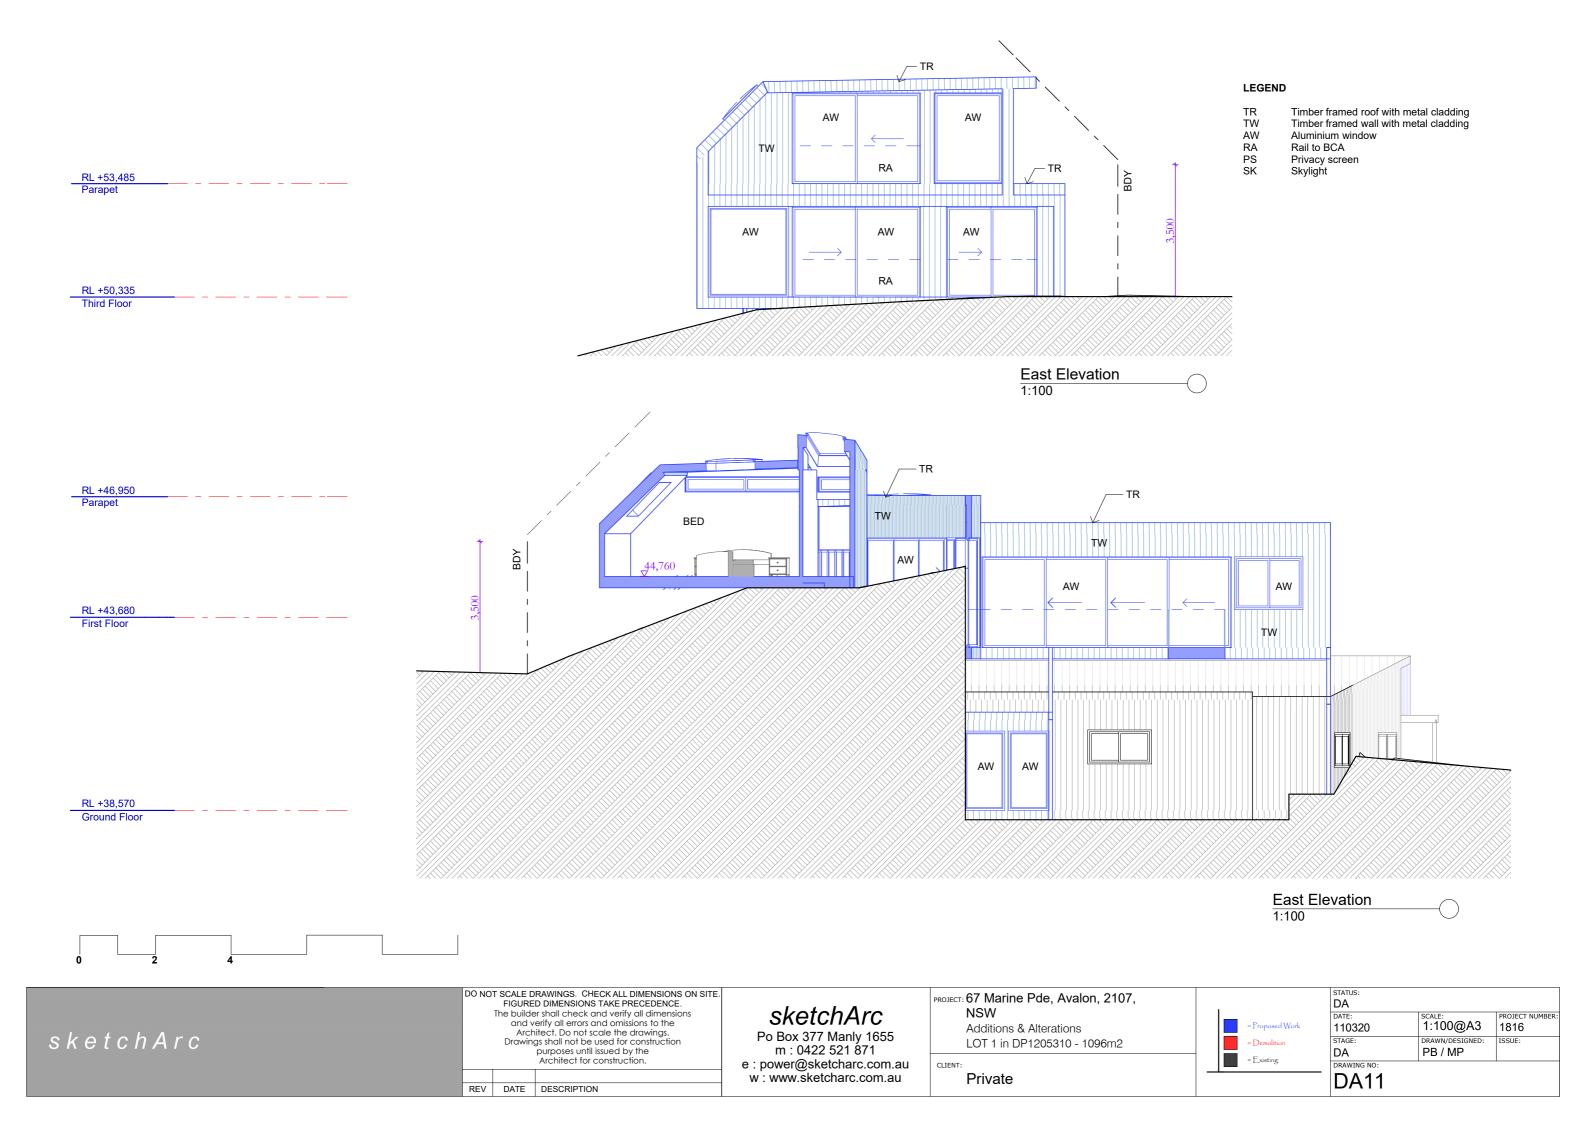

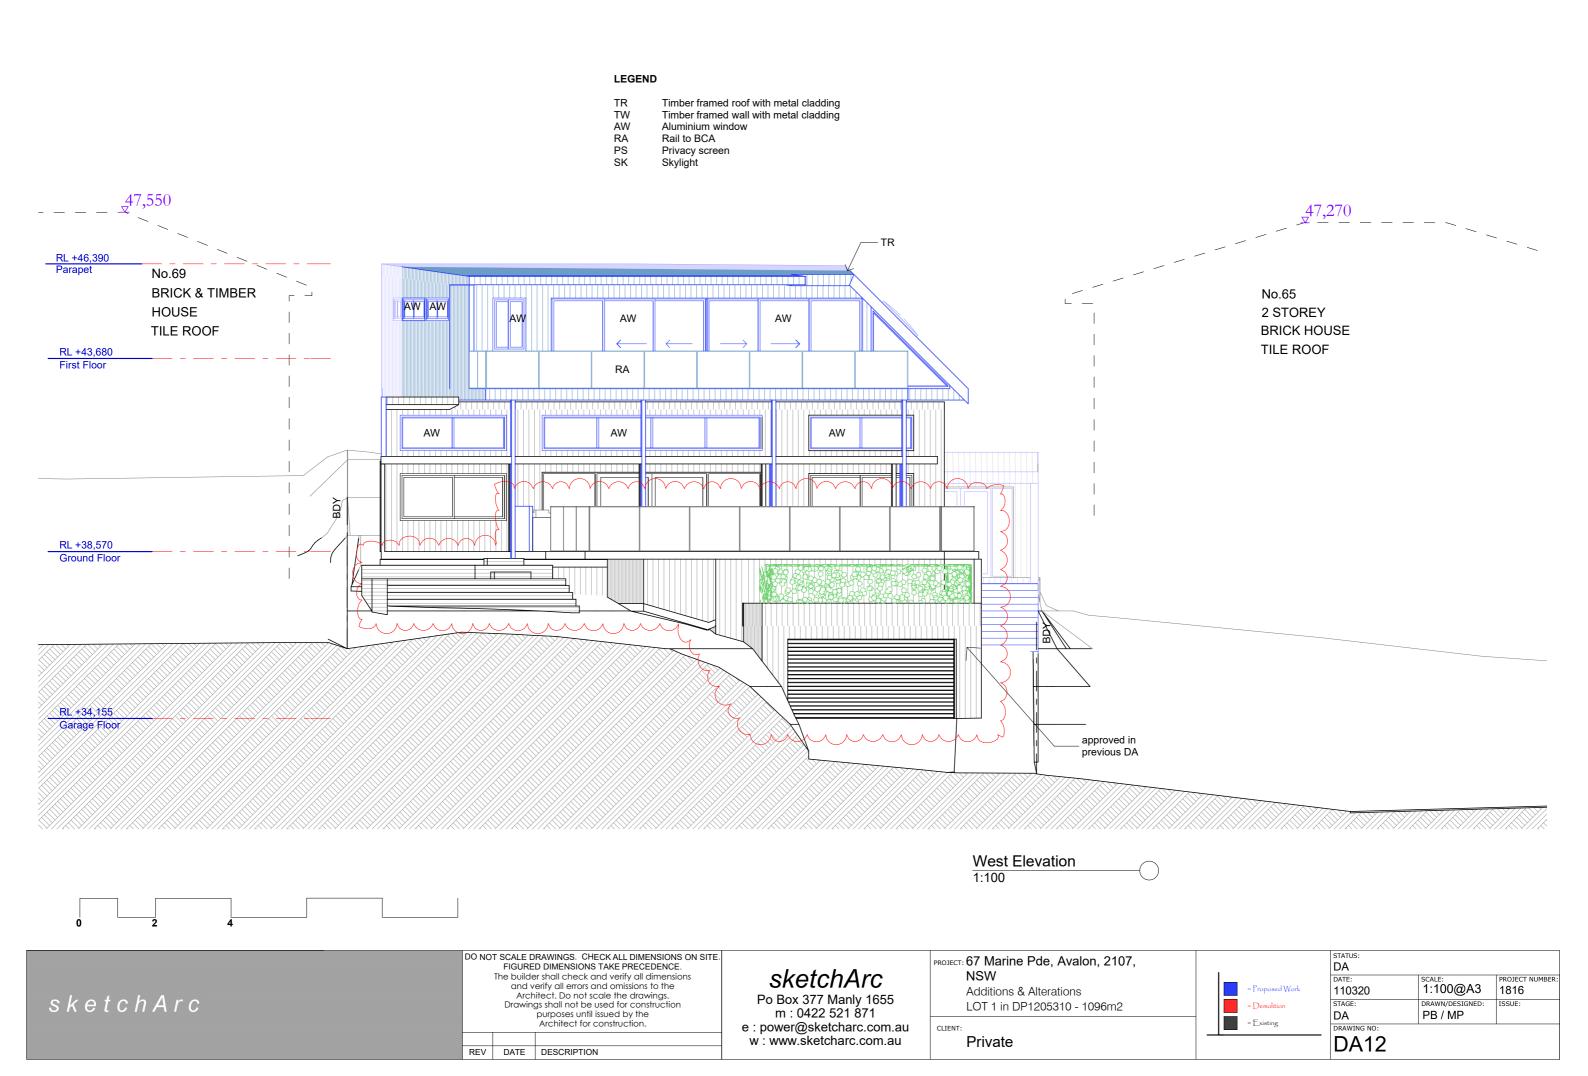

### LEGEND


TR TW AW RA PS SK Timber framed roof with metal cladding Timber framed wall with metal cladding Aluminium window Rail to BCA

Privacy screen Skylight



RL +53,485 Parapet

RL +50,335 Third Floor

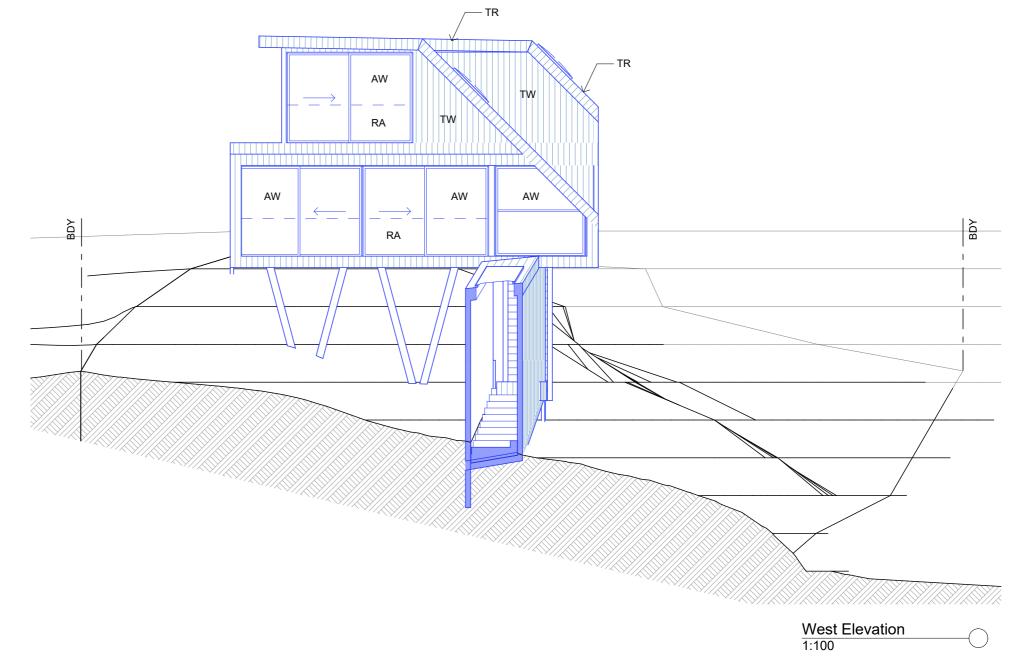




## DO NOT SCALE DRAWINGS. CHECK ALL DIMENSIONS ON SITE. FIGURED DIMENSIONS TAKE PRECEDENCE. The builder shall check and verify all dimensions and verify all errors and omissions to the Architect. Do not scale the drawings. Drawings shall not be used for construction purposes until issued by the Architect for construction. sketchArc REV DATE DESCRIPTION

# **SketchArc**Po Box 377 Manly 1655 m: 0422 521 871

e : power@sketcharc.com.au w : www.sketcharc.com.au


PROJECT: 67 Marine Pde, Avalon, 2107, NSW	
INOVV	
Additions & Alterations	
LOT 1 in DP1205310 - 1096m2	
CLIENT:	
Private	
Tivate	

	STATUS:		
	DA		
I	DATE:	SCALE:	PROJECT NUMBER
= Proposed Work	110320	1:100@A3	1816
- Demolition	STAGE:	DRAWN/DESIGNED:	ISSUE:
= Existing	DA	PB / MP	
Labeling	DRAWING NO:		
	DA13		

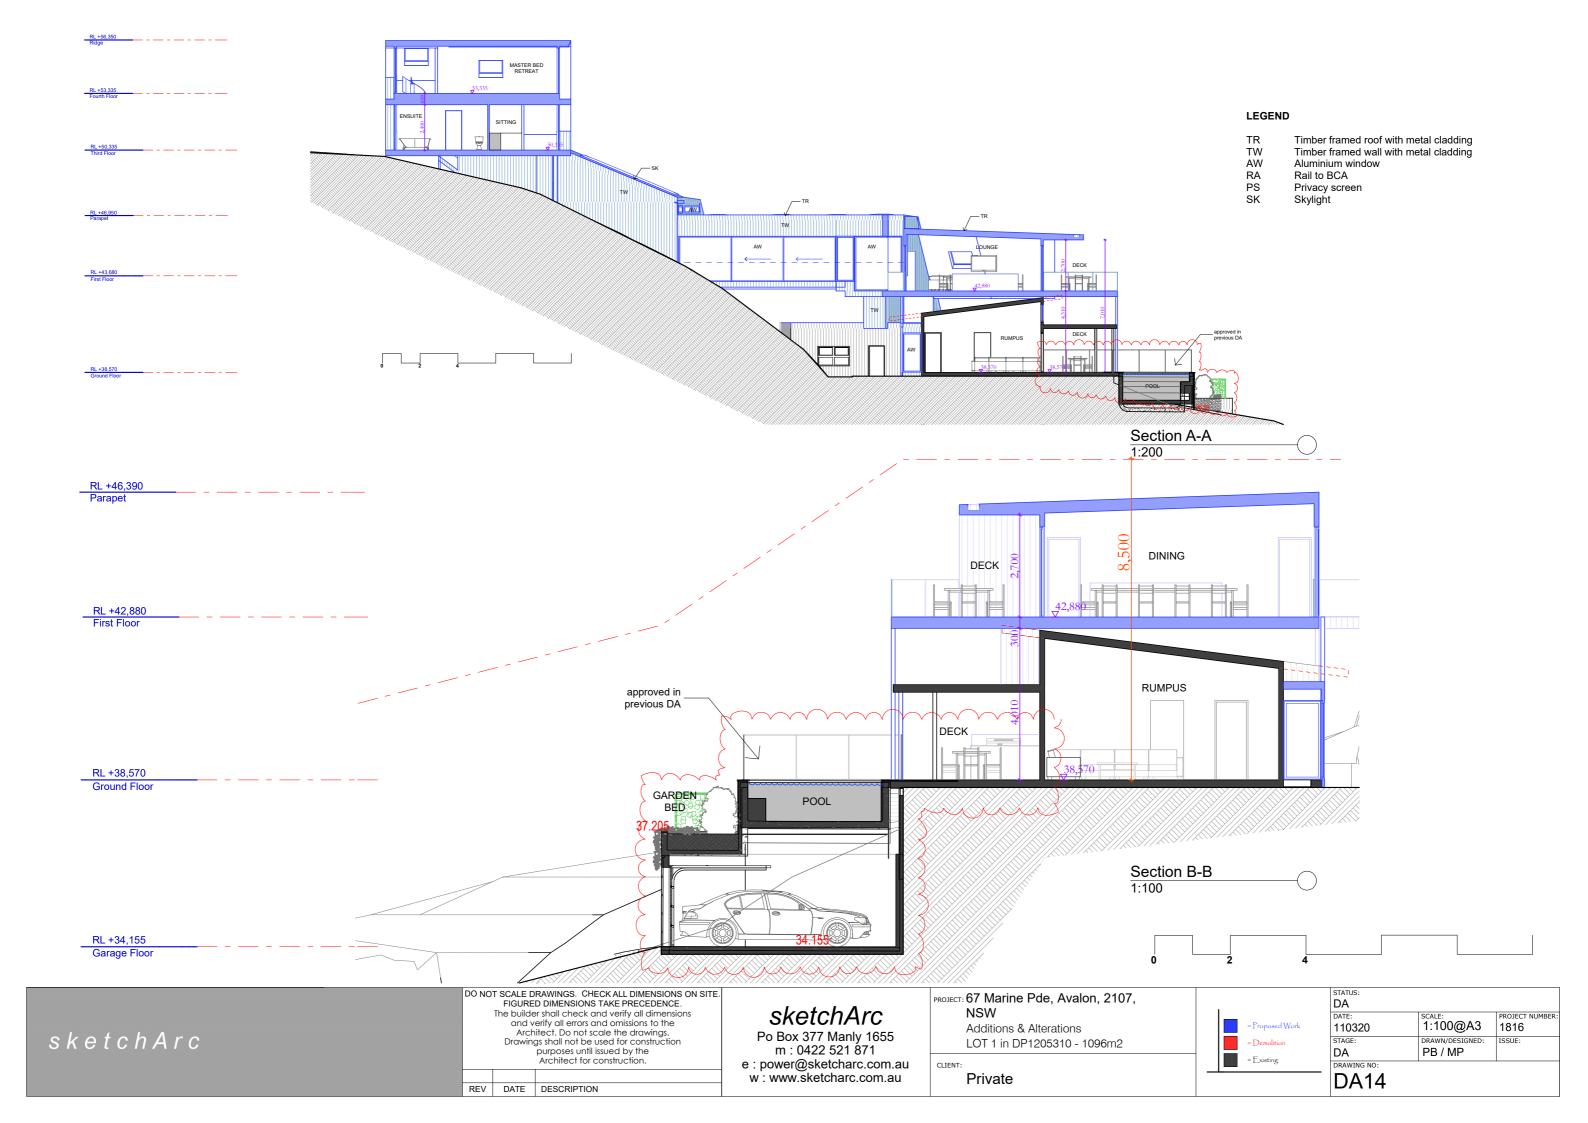








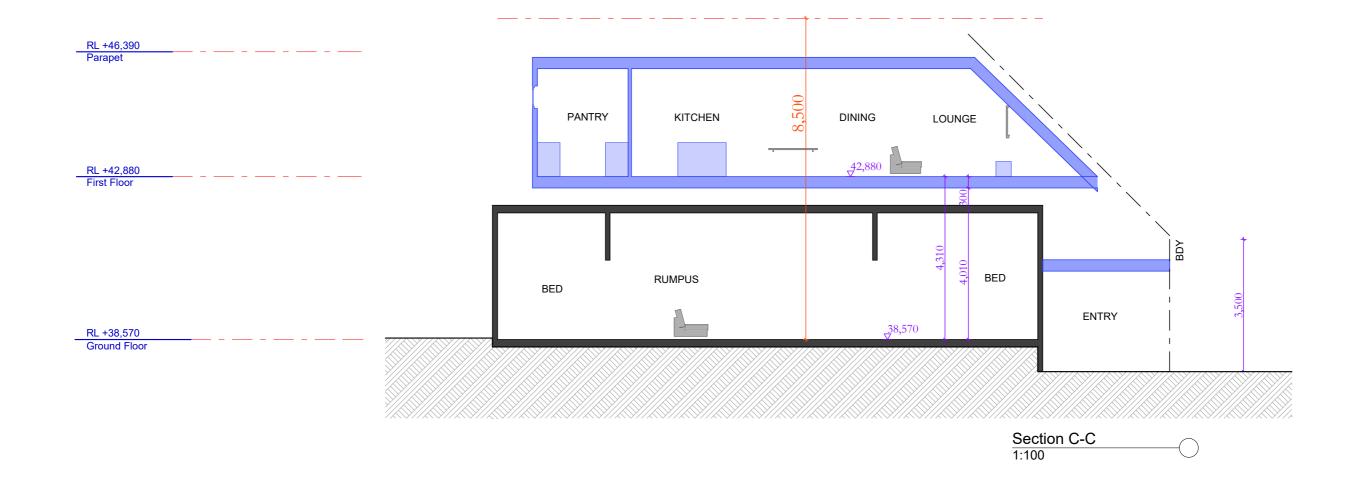



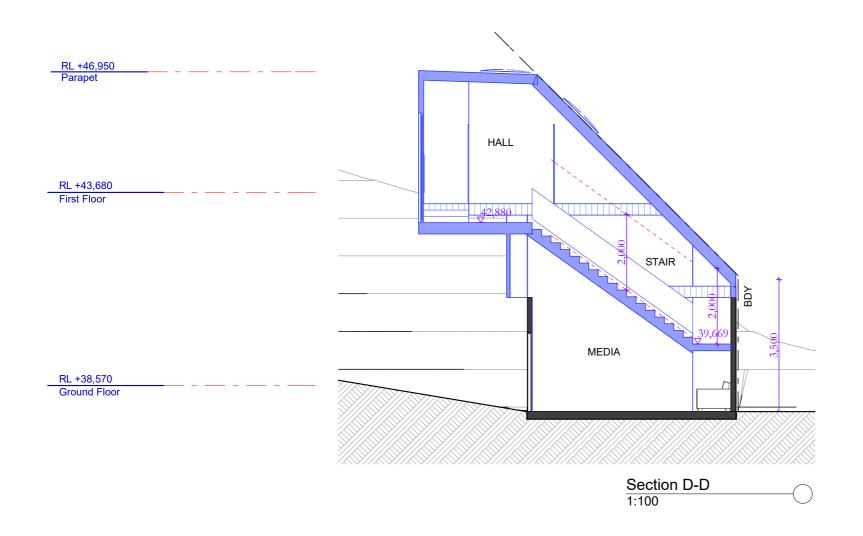

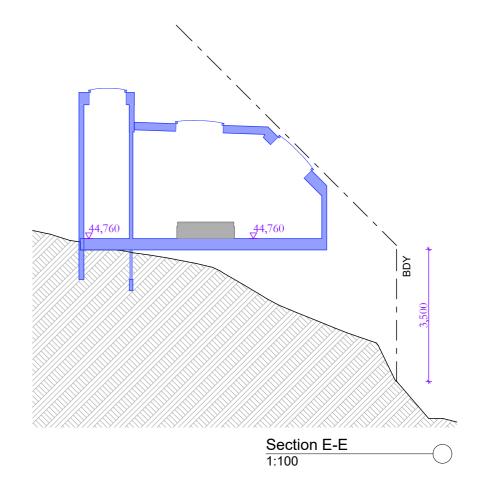

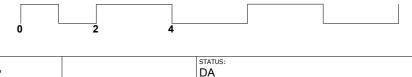


DO NOT SCALE DRAWINGS. CHECK ALL DIMENSIONS ON SITE.
FIGURED DIMENSIONS TAKE PRECEDENCE.
The builder shall check and verify all dimensions
and verify all errors and omissions to the
Architect. Do not scale the drawings.
Drawings shall not be used for construction
purposes until issued by the
Architect for construction. sketchArc REV DATE DESCRIPTION


sketchArc Po Box 377 Manly 1655 m: 0422 521 871

e : power@sketcharc.com.au w : www.sketcharc.com.au


PROJECT: 67 Marine Pde, Avalon, 2107, NSW Additions & Alterations LOT 1 in DP1205310 - 1096m2 Private



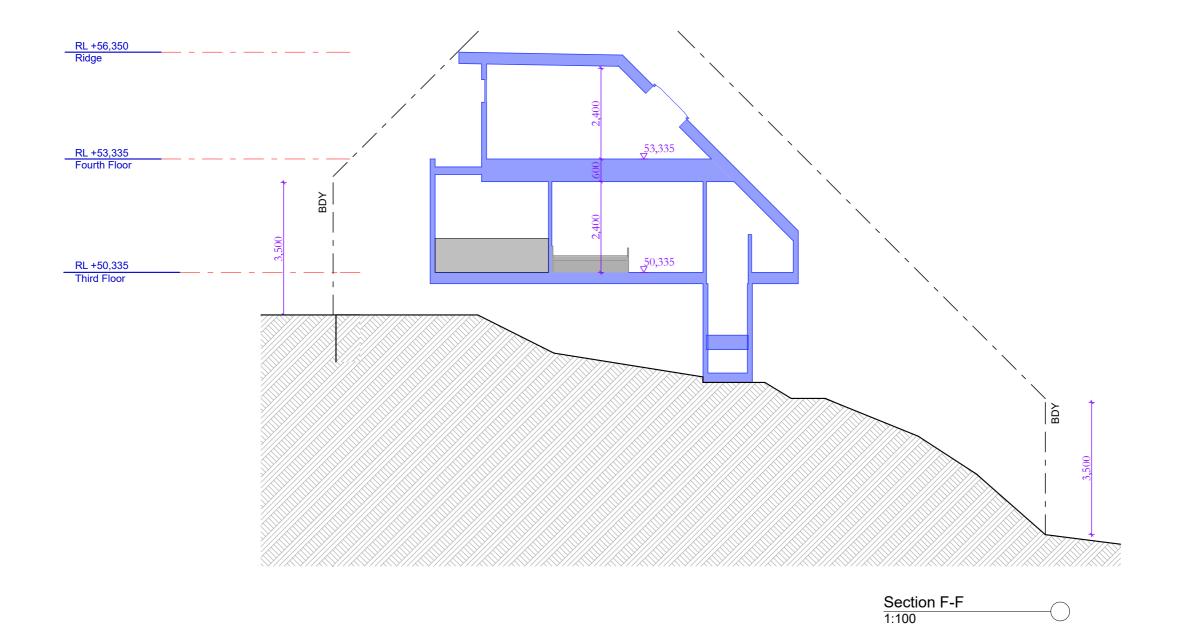


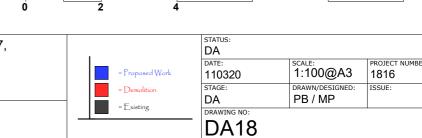


DO NOT SCALE DRAWINGS. CHECK ALL DIMENSIONS ON SITE.
FIGURED DIMENSIONS TAKE PRECEDENCE.
The builder shall check and verify all dimensions
and verify all errors and omissions to the
Architect. Do not scale the drawings.
Drawings shall not be used for construction
purposes until issued by the
Architect for construction. PROJECT: 67 Marine Pde, Avalon, 2107, SketchArc
Po Box 377 Manly 1655
m: 0422 521 871
e: power@sketcharc.com.au
w: www.sketcharc.com.au NSW SCALE: 1:100@A3 | PROJECT NUMBER: 1816 Additions & Alterations sketchArc STAGE:
DA
DRAWING NO:
DA18 LOT 1 in DP1205310 - 1096m2 Private REV DATE DESCRIPTION

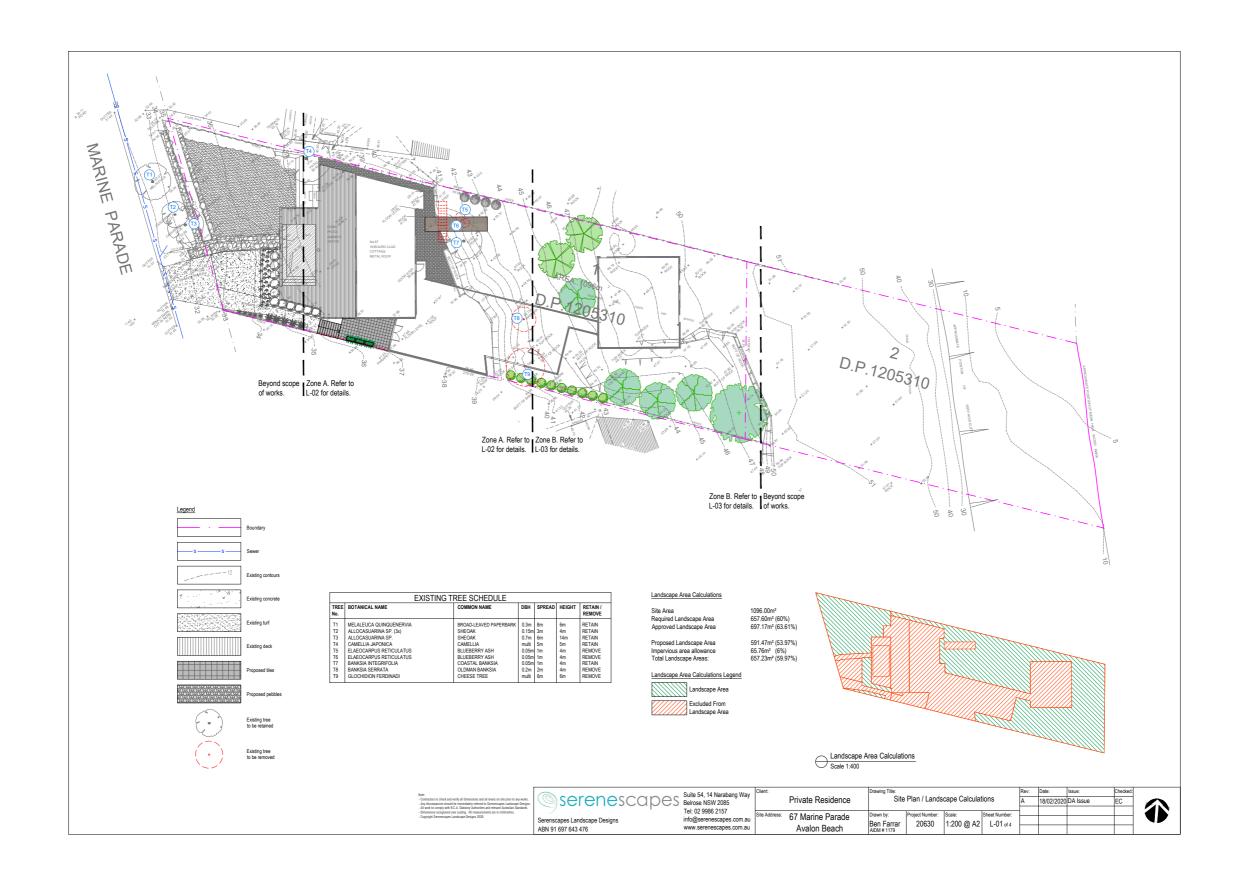




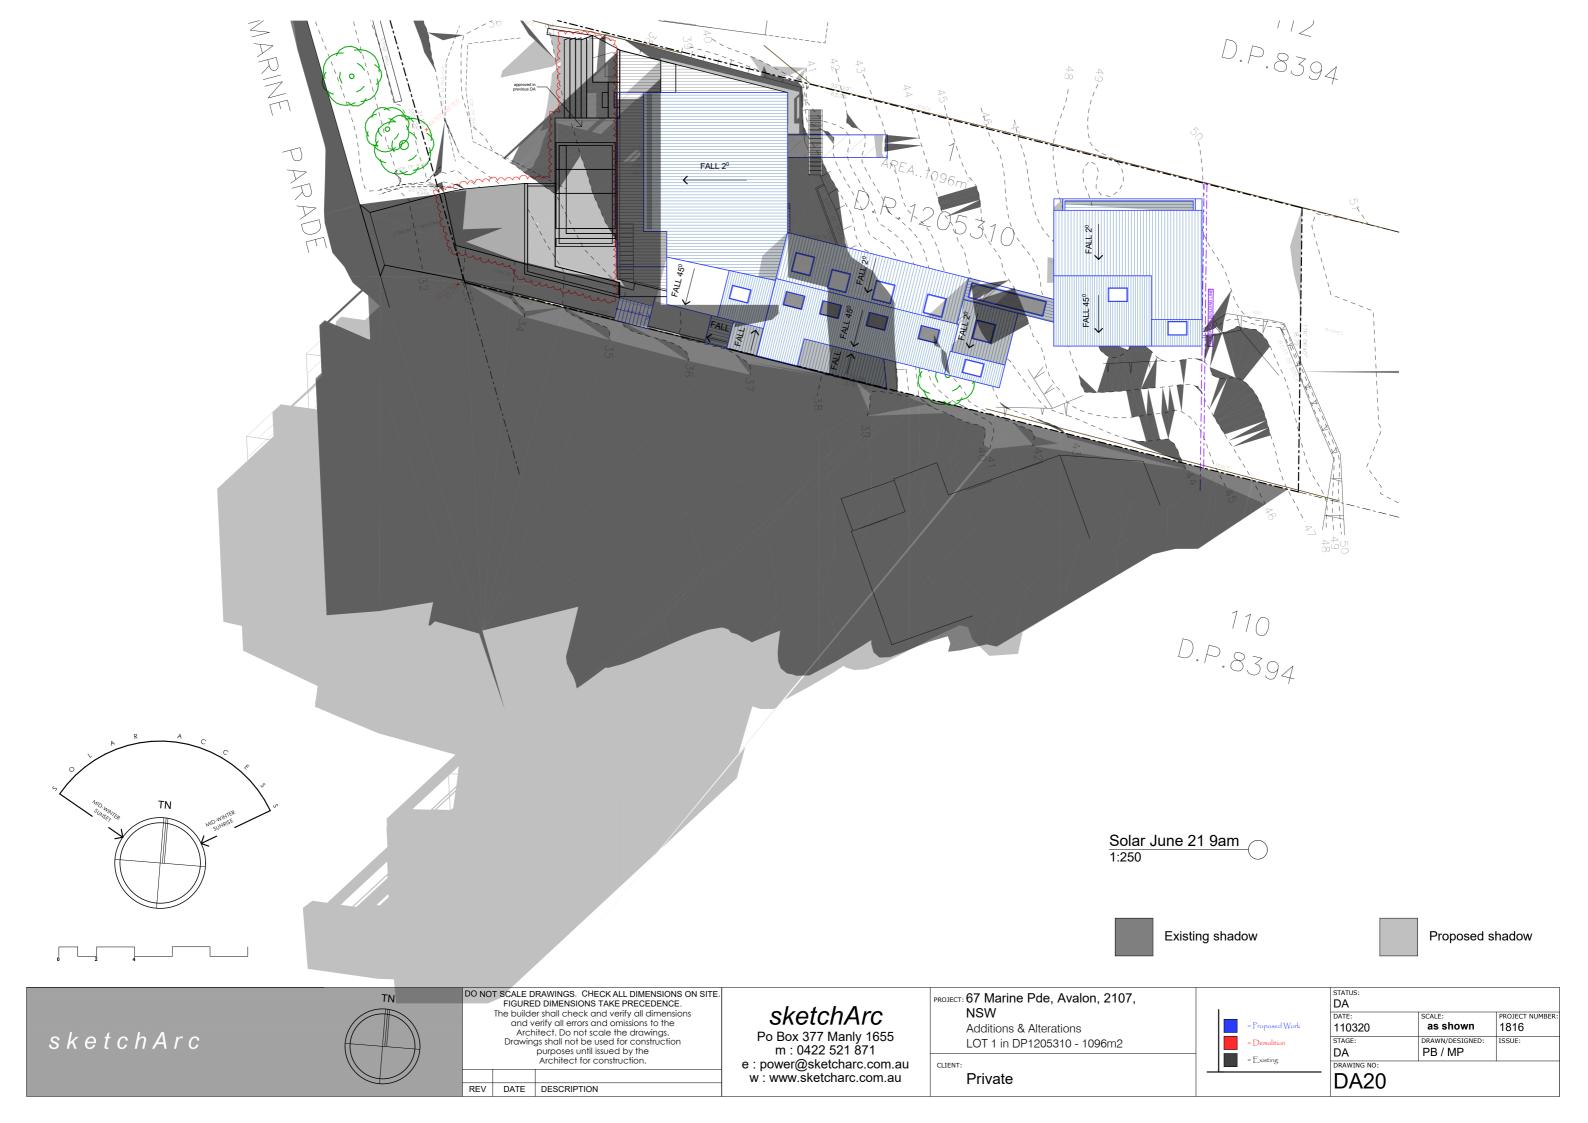

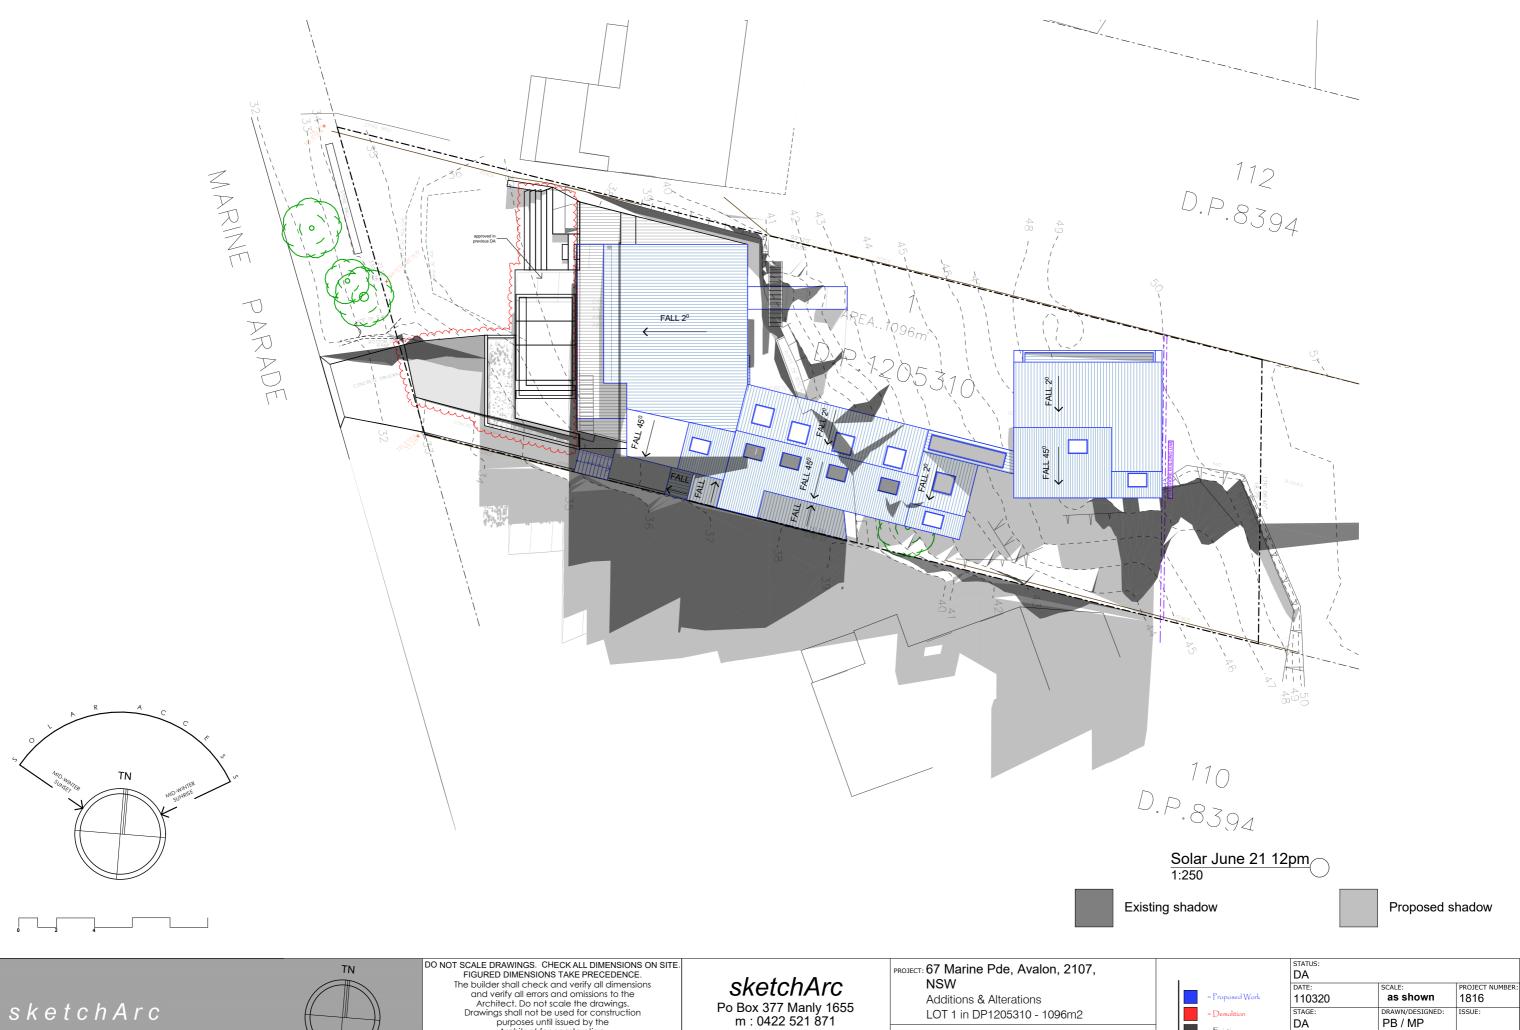

SketchArc
Po Box 377 Manly 1655
m: 0422 521 871
e: power@sketcharc.com.au
w: www.sketcharc.com.au The builder shall check and verify all dimensions and verify all errors and omissions to the Architect. Do not scale the drawings.

Drawings shall not be used for construction purposes until issued by the Architect for construction. STAGE:
DA
DRAWING NO:
DA21 Private REV DATE DESCRIPTION

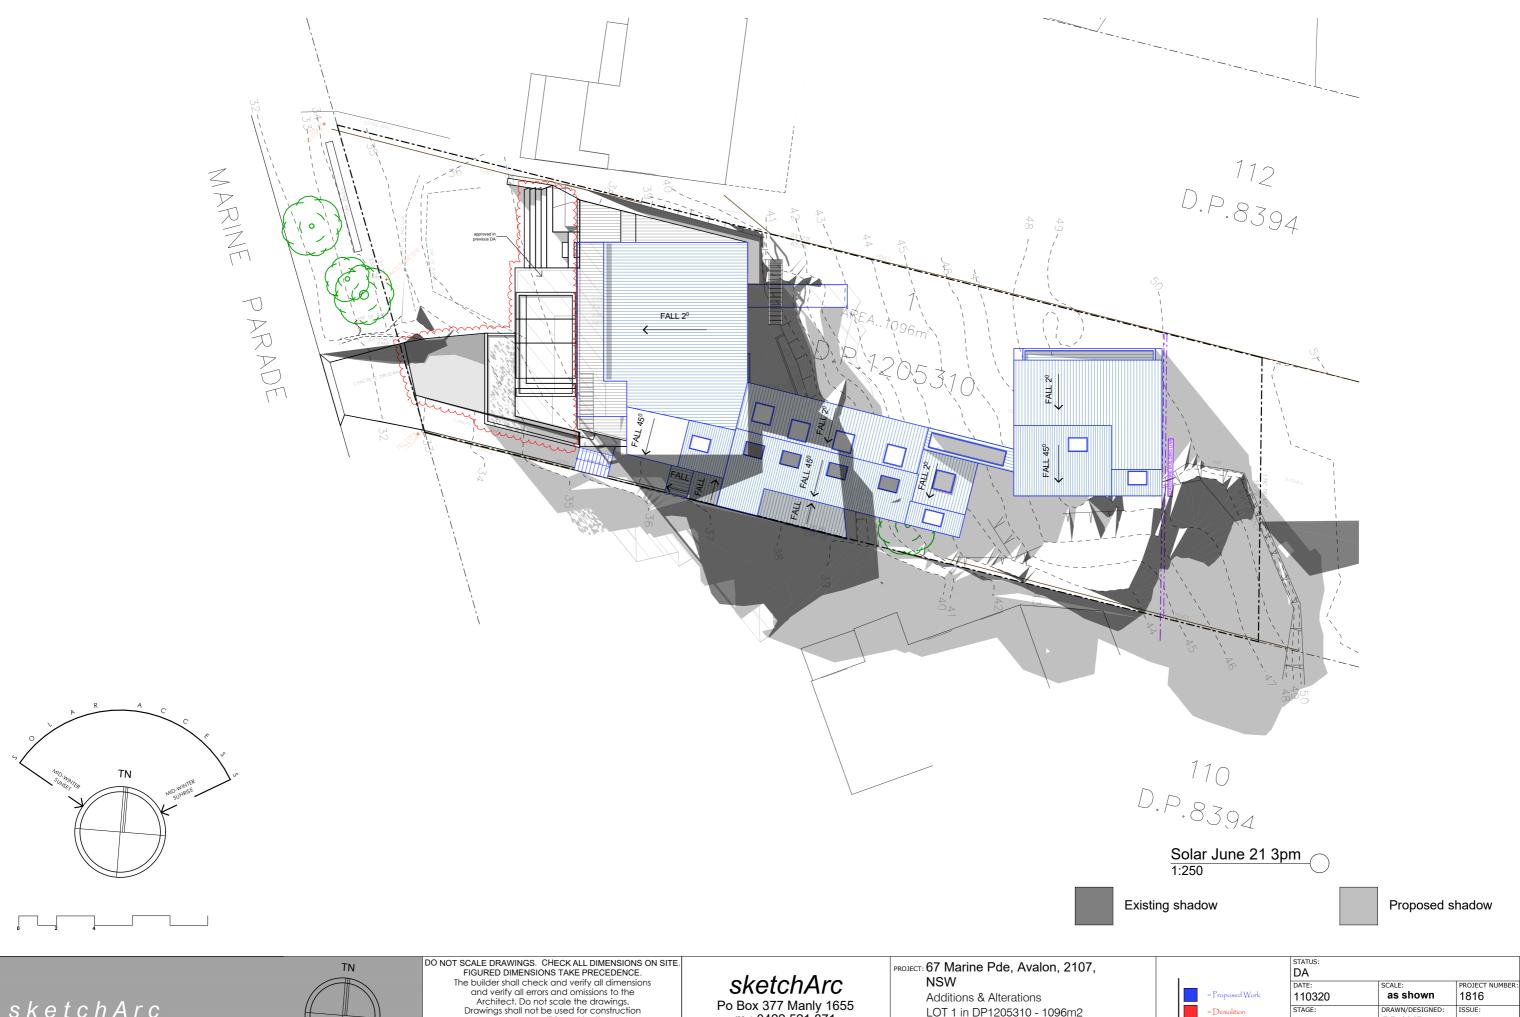

The builder shall check and verify all dimensions and verify all errors and omissions to the Architect. Do not scale the drawings.

Drawings shall not be used for construction purposes until issued by the Architect for construction. = Proposed V Po Box 377 Manly 1655 m: 0422 521 871 e: power@sketcharc.com.au w: www.sketcharc.com.au sketchArc STAGE:
DA
DRAWING NO:
DA22 PB / MP LOT 1 in DP1205310 - 1096m2 Private REV DATE DESCRIPTION



Building Sustainability Index www.basix.nsw.gov.au

#### Alterations and Additions

Certificate number: A357439\_02

sketchArc

This certificate confirms that the proposed development will meet the NSW government's requirements for sustainability, if it is built in accordance with the commitments set out below. Terms used in this certificate, or in the commitments, have the meaning given by the document entitled "BASIX Alterations and Additions Definitions" dated 06/10/2017 published by the Department. This document is available at www.basix.nsw.gov.au

Secretary
Date of issue: Saturday, 07, March 2020
To be valid, this certificate must be lodged within 3 months of the date of issue.

Project address	
Project name	67 Marine Pde - DA_02
Street address	67 Marine Parade Avalon 2107
Local Government Area	Northern Beaches Council
Plan type and number	Deposited Plan 1205310
Lot number	1
Section number	
Project type	
Dwelling type	Separate dwelling house
Type of alteration and addition	My renovation work is valued at \$50,000 or more and does not include a pool (and/or spa).

Planning, Industry & Environment					
Fixtures and systems			Show on DA Plans	Show on CC/CDC Plans & specs	Certifier Check
Hot water					
The applicant must install the following hot wat	er system in the development: gas instantaneou	us.	~	✓	V
Lighting					
The applicant must ensure a minimum of 40% light-emitting-diode (LED) lamps.	of new or altered light fixtures are fitted with fluc	prescent, compact fluorescent, or		<b>✓</b>	~
Fixtures					
The applicant must ensure new or altered show	werheads have a flow rate no greater than 9 litre	es per minute or a 3 star water rating.		~	~
The applicant must ensure new or altered toile	ts have a flow rate no greater than 4 litres per a	verage flush or a minimum 3 star water rating.		✓	✓
The applicant must ensure new or altered taps		✓			
Construction			Show on DA Plans	Show on CC/CDC Plans & specs	Certifier Check
Construction  Insulation requirements				CC/CDC Plans &	
	on is not required where the area of new constr			CC/CDC Plans &	
Insulation requirements  The applicant must construct the new or altered the table below, except that a) additional insulati	on is not required where the area of new constr		DA Plans	CC/CDC Plans &	
Insulation requirements  The applicant must construct the new or altered the table below, except that a) additional insulati is not required for parts of altered construction w	on is not required where the area of new construction of the construction already exists.	uction is less than 2m2, b) insulation specified	DA Plans	CC/CDC Plans &	
Insulation requirements The applicant must construct the new or altered the table below, except that a) additional insulati is not required for parts of altered construction w  Construction suspended floor with open subfloor: framed	on is not required where the area of new constr there insulation already exists.  Additional insulation required (R-value)	uction is less than 2m2, b) insulation specified	DA Plans	CC/CDC Plans &	

Legend
In these commitments, "applicant" means the person carrying out the development.
Commitments identified with a "<" in the "Show on DA plans" column must be shown on the plans accompanying the development application for the proposed development (if a development application is to be lodged for the proposed development).
Commitments identified with a "\square\squar
Commitments identified with a "\" in the "Certifier check" column must be certified by a certifying authority as having been fulfilled, before a final occupation certificate for the development may be issued.

DO NO	FIGURE The builde and v Arch	RAWINGS. CHECK ALL DIMENSIONS ON SIT D DIMENSIONS TAKE PRECEDENCE. or shall check and verify all dimensions erify all errors and omissions to the itect. Do not scale the drawings. 35 shall not be used for construction purposes until issued by the Architect for construction.
REV	DATE	DESCRIPTION

sketchArc Po Box 377 Manly 1655

m: 0422 521 871 e : power@sketcharc.com.au w : www.sketcharc.com.au

PROJECT: 67 Marine Pde, Avalon, 2107, NSW Additions & Alterations LOT 1 in DP1205310 - 1096m2

Private

Windows and glazed doors

The applicant must install the windows, glazed doors and shading devices, in accordance with the specifications listed in the table below Relevant overshadowing specifications must be satisfied for each window and glazed door.


The following requirements must also be satisfied in relation to each window and glazed door:

= Demolition = Existing

DA PROJECT NUMBER: 110320 1816 STAGE: DRAWN/DESIGNE PB / MP DA DRAWING NO: DA23

he following	g requirements	must also	be sausii	ed in relation	to each window and glazed door:			~	
nave a U-va nust be calc	lue and a Solar culated in accor	Heat Gair dance with	n Coefficie h National	ent (SHGC) r Fenestration	no greater than that listed in the tabl	ar glazing, or toned/air gap/clear glazing must e below. Total system U-values and SHGCs . The description is provided for information		<b>✓</b>	~
or projection	ns described in	millimetre	es, the lea	iding edge of	f each eave, pergola, verandah, balo	cony or awning must be no more than 500 mm	✓	<b>✓</b>	~
or projection	ns described a	s a ratio, t			than 2400 mm above the sill. on from the wall to the height above	the window or glazed door sill must be at	✓	✓	~
	own in the table		imilar tran	slucent mate	erial must have a shading coefficien	t of less than 0.35		.,	
_					_	ch they are situated, unless the pergola also		./	Ľ
					ens must not be more than 50 mm.	and the chalacter, amone the pergena alor		•	ľ
	and glazed								
Window / do no.	dow / door Orientation Area of Overshadowing Shading device Frame and glass type    Glass   Height   Distance   Distance								
		inc. frame (m2)	(m)	(m)					
W1	w	6.7	0	0	eave/verandah/pergola/balcony >=900 mm	improved aluminium, single clear, (U-value: 6.44, SHGC: 0.75)			
W2	E	2.2	0	0	projection/height above sill ratio >=0.23	improved aluminium, single pyrolytic low-e, (U-value: 4.48, SHGC: 0.46)			
W3	E	2.2	0	0	projection/height above sill ratio >=0.23	improved aluminium, single pyrolytic low-e, (U-value: 4.48, SHGC: 0.46)			
W4	E	2.2	0	0	projection/height above sill ratio	improved aluminium, single pyrolytic low-e,			
W5	E	2.2	0	0	>=0.23 projection/height above sill ratio	(U-value: 4.48, SHGC: 0.46) improved aluminium, single pyrolytic low-e,			
W6	N	2.1	0	0	>=0.23 eave/verandah/pergola/balcony	(U-value: 4.48, SHGC: 0.46) improved aluminium, single clear, (U-value:			
					>=900 mm	6.44, SHGC: 0.75)			
W7	W	10.2	0	0	eave/verandah/pergola/balcony >=900 mm	improved aluminium, single clear, (U-value: 6.44, SHGC: 0.75)			
W8	W	10.2	0	0	eave/verandah/pergola/balcony >=900 mm	improved aluminium, single clear, (U-value: 6.44, SHGC: 0.75)			
W9	W	1.2	0	0	eave/verandah/pergola/balcony >=900 mm	improved aluminium, single clear, (U-value: 6.44, SHGC: 0.75)			
W10	N	1.4	0	0	projection/height above sill ratio >=0.23	improved aluminium, single pyrolytic low-e, (U-value: 4.48, SHGC: 0.46)			
W11	N	1.4	0	0	projection/height above sill ratio >=0.23	improved aluminium, single pyrolytic low-e, (U-value: 4.48, SHGC: 0.46)			ĺ
W12	N	0.5	0	0	projection/height above sill ratio >=0.23	improved aluminium, single pyrolytic low-e, (U-value: 4.48, SHGC: 0.46)			
W13	E	2.5	0	0	projection/height above sill ratio >=0.23	improved aluminium, single pyrolytic low-e, (U-value: 4.48, SHGC: 0.46)			
W14	E	16.8	0	0	projection/height above sill ratio >=0.23	improved aluminium, single pyrolytic low-e, (U-value: 4.48, SHGC: 0.46)			ĺ
W15	N	7.5	0	0	projection/height above sill ratio >=0.23	improved aluminium, single pyrolytic low-e, (U-value: 4.48, SHGC: 0.46)			ĺ
W16	N	2.3	0	0	projection/height above sill ratio >=0.23	improved aluminium, single pyrolytic low-e, (U-value: 4.48, SHGC: 0.46)			
W17	N	20.6	0	0	projection/height above sill ratio >=0.23	improved aluminium, single pyrolytic low-e, (U-value: 4.48, SHGC: 0.46)			ĺ
W18	S DE	LETE	D)	0	none DE	LETED (luminium, single clear, (U-value:			
W19	W	1.3	0	0	projection/height above sill ratio >=0.29	improved aluminium, single pyrolytic low-e, (U-value: 4.48, SHGC: 0.46)			ĺ
W20	W	0.4	0	0	projection/height above sill ratio >=0.23	improved aluminium, single clear, (U-value: 6.44, SHGC: 0.75)			ĺ
W21	W	4.8	0	0	eave/verandah/pergola/balcony >=600 mm	improved aluminium, single pyrolytic low-e, (U-value: 4.48, SHGC: 0.46)			ĺ
W22	w	8	0	0	eave/verandah/pergola/balcony >=600 mm	improved aluminium, single pyrolytic low-e, (U-value: 4.48, SHGC: 0.46)			
W23	w	8	0	0	eave/verandah/pergola/balcony >=600 mm	improved aluminium, single pyrolytic low-e, (U-value: 4.48, SHGC: 0.46)			
W24	N	6.7	0	0	projection/height above sill ratio	improved aluminium, single pyrolytic low-e,			
W25	N	3.3	0	0	projection/height above sill ratio >=0.23	improved aluminium, single pyrolytic low-e, (U-value: 4.48, SHGC: 0.46)			
W26	E	5.7	0	0	eave/verandah/pergola/balcony	improved aluminium, single pyrolytic low-e, (U-value: 4.48, SHGC: 0.46)			
W27	E	8.1	0	0	>=600 mm eave/verandah/pergola/balcony	improved aluminium, single pyrolytic low-e,			
W28	E	5.1	0	0	>=600 mm eave/verandah/pergola/balcony	(U-value: 4.48, SHGC: 0.46) improved aluminium, single pyrolytic low-e,			
W29	w	8	0	0	>=600 mm eave/verandah/pergola/balcony >=600 mm	(U-value: 4.48, SHGC: 0.46) improved aluminium, single pyrolytic low-e,			
W30	N	3.3	0	0	projection/height above sill ratio	(U-value: 4.48, SHGC: 0.46) improved aluminium, single pyrolytic low-e,			
					>=0.23	(U-value: 4.48, SHGC: 0.46)			
W31	N	1.5	0	0	eave/verandah/pergola/balcony >=600 mm	improved aluminium, single pyrolytic low-e, (U-value: 4.48, SHGC: 0.46)			
W32	N	1.5	0	0	eave/verandah/pergola/balcony >=600 mm	improved aluminium, single pyrolytic low-e, (U-value: 4.48, SHGC: 0.46)			
W33	E	4.3	0	0	eave/verandah/pergola/balcony >=600 mm	improved aluminium, single pyrolytic low-e, (U-value: 4.48, SHGC: 0.46)			
W34	E	8.1	0	0	eave/verandah/pergola/balcony >=600 mm	improved aluminium, single pyrolytic low-e, (U-value: 4.48, SHGC: 0.46)			
W6A	w	2.3	0	0	eave/verandah/pergola/balcony	improved aluminium, single pyrolytic low-e,	1		1



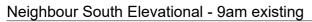



Neighbour South Elevational - 12pm existing



Neighbour South Elevational - 3pm existing



Neighbour South Elevational - 9am proposed



Neighbour South Elevational - 12pm proposed



Neighbour South Elevational - 3pm proposed

DO NOT SCALE DRAWINGS. CHECK ALL DIMENSIONS ON SITE. FIGURED DIMENSIONS TAKE PRECEDENCE.

The builder shall check and verify all dimensions and verify all errors and omissions to the Architect. Do not scale the drawings.

Drawings shall not be used for construction purposes until issued by the Architect for construction.

REV DATE DESCRIPTION

sketchArc


Po Box 377 Manly 1655 m: 0422 521 871 e: power@sketcharc.com.au w: www.sketcharc.com.au

PROJECT: 67 Marine Pde, Avalon, 2107, NSW

Additions & Alterations LOT 1 in DP1205310 - 1096m2

Private


	STATUS:		
	DA		
	DATE:	SCALE:	PROJECT NUMBER:
	110320	no scale	1816
	STAGE:	DRAWN/DESIGNED:	ISSUE:
	DA	PB / MP	
	DRAWING NO:		
•	DA24		

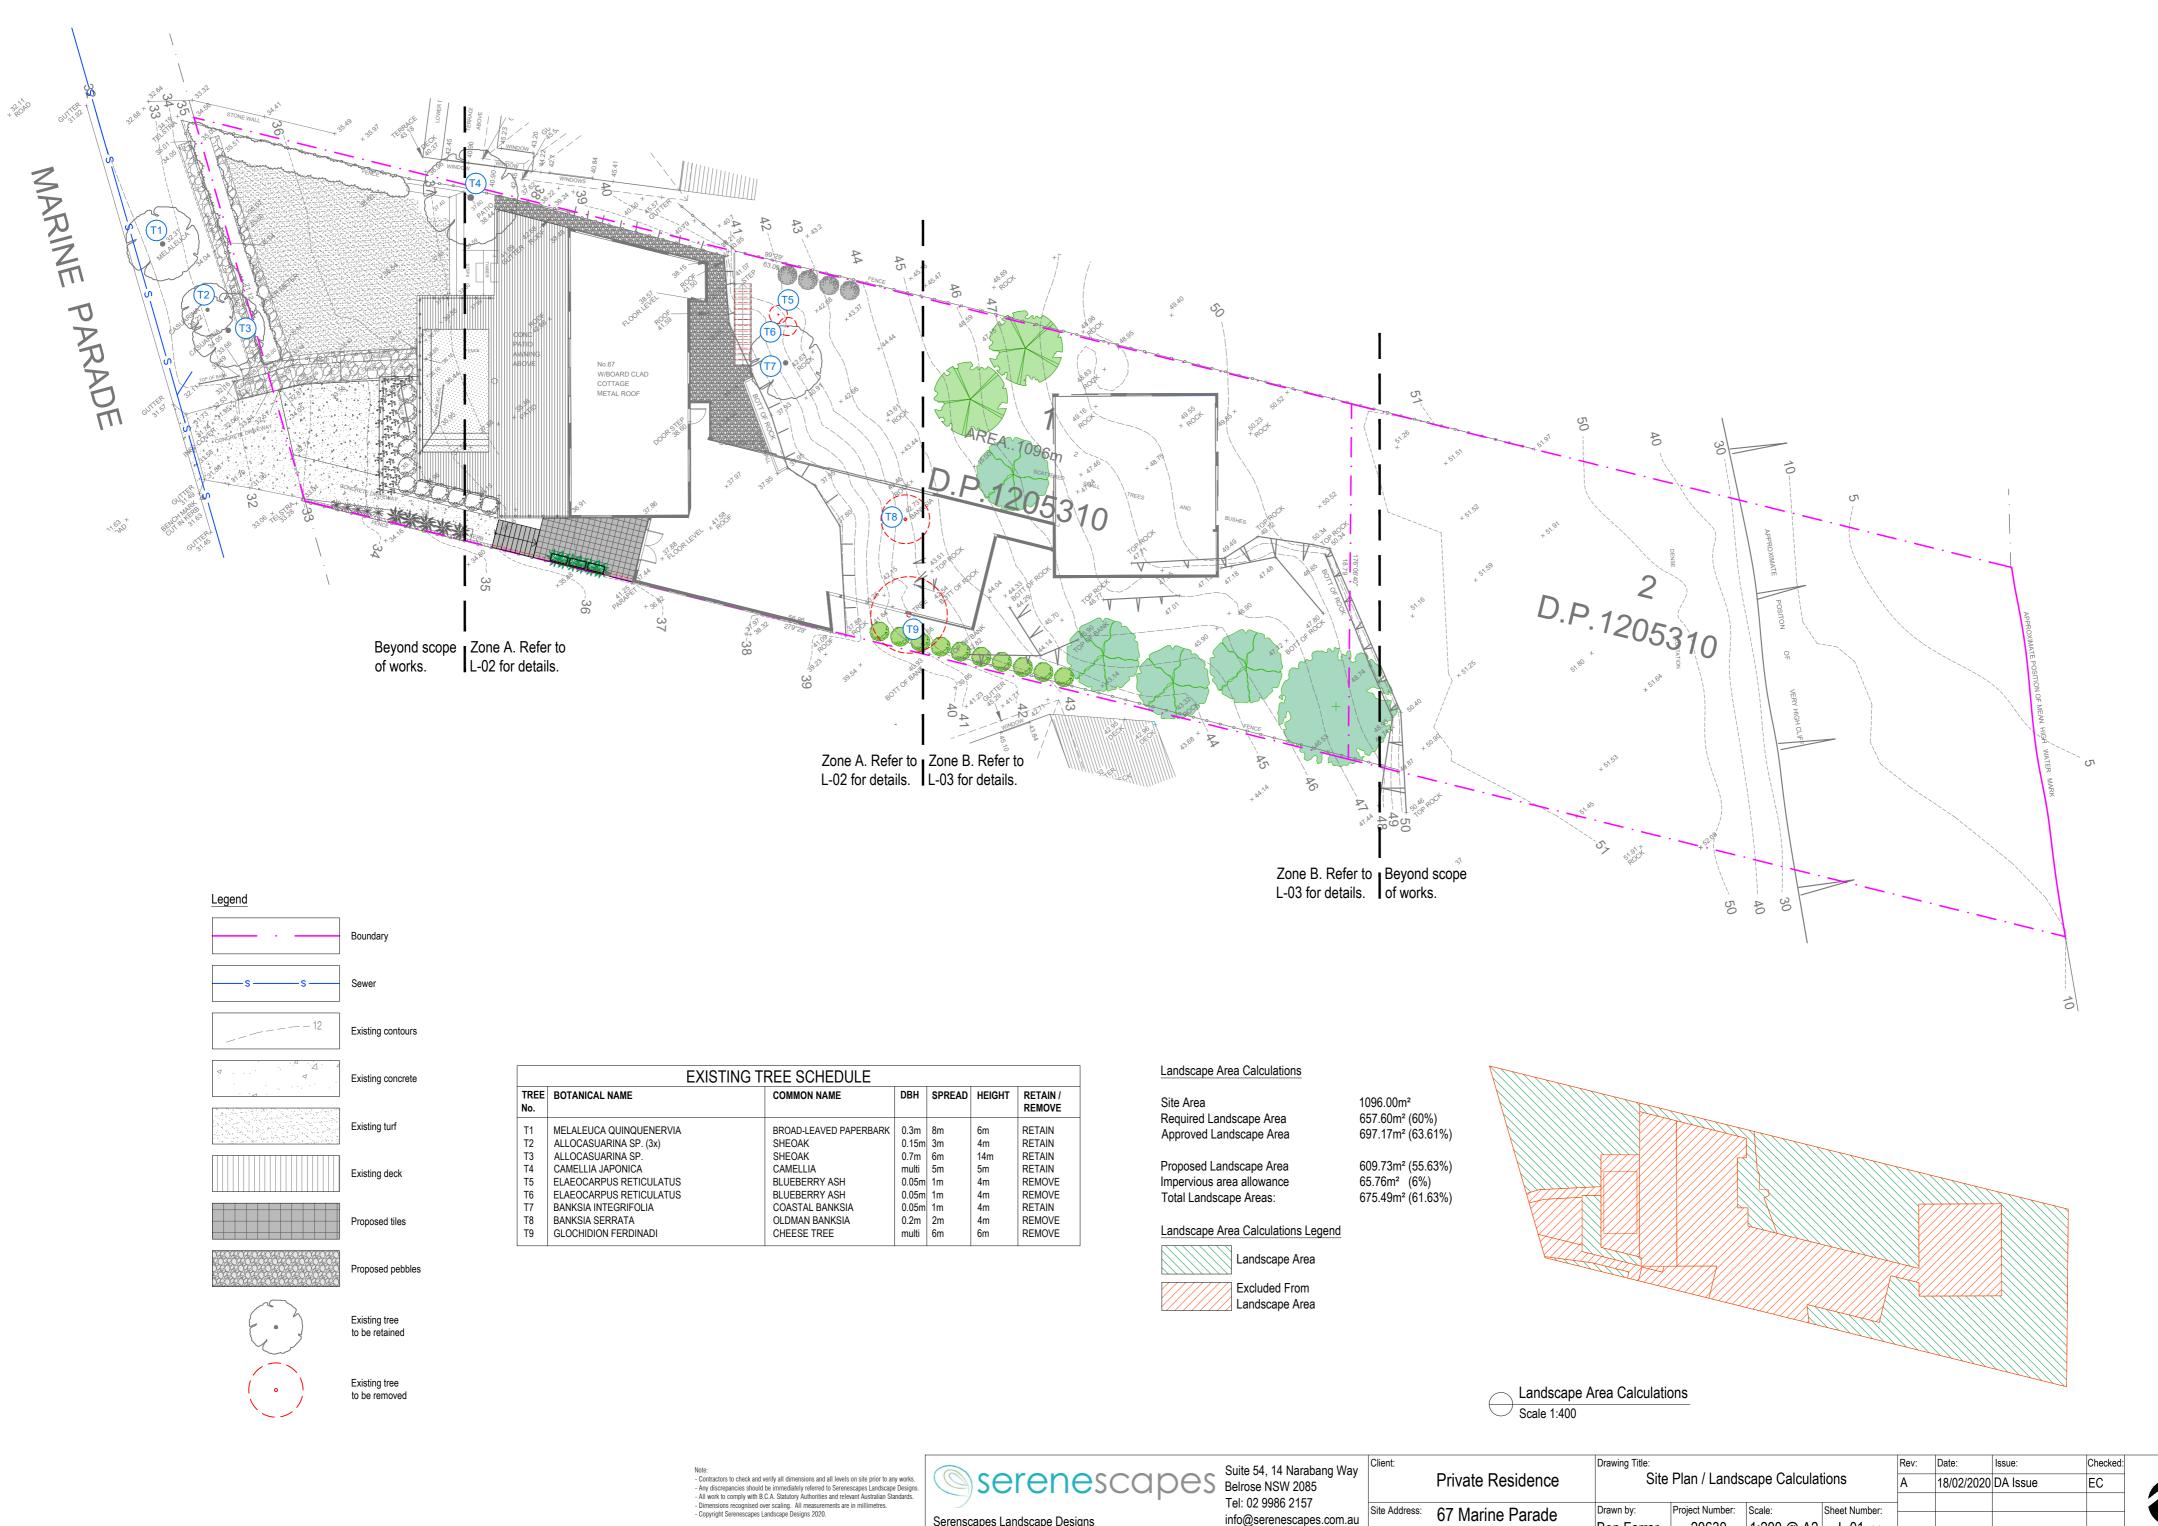

Project Number: Scale: Sheet Number: Drawn by: 20630 1:200 @ A2 L-01 of 4 Ben Farrar AIDM # 1179

ABN 91 697 643 476

Avalon Beach

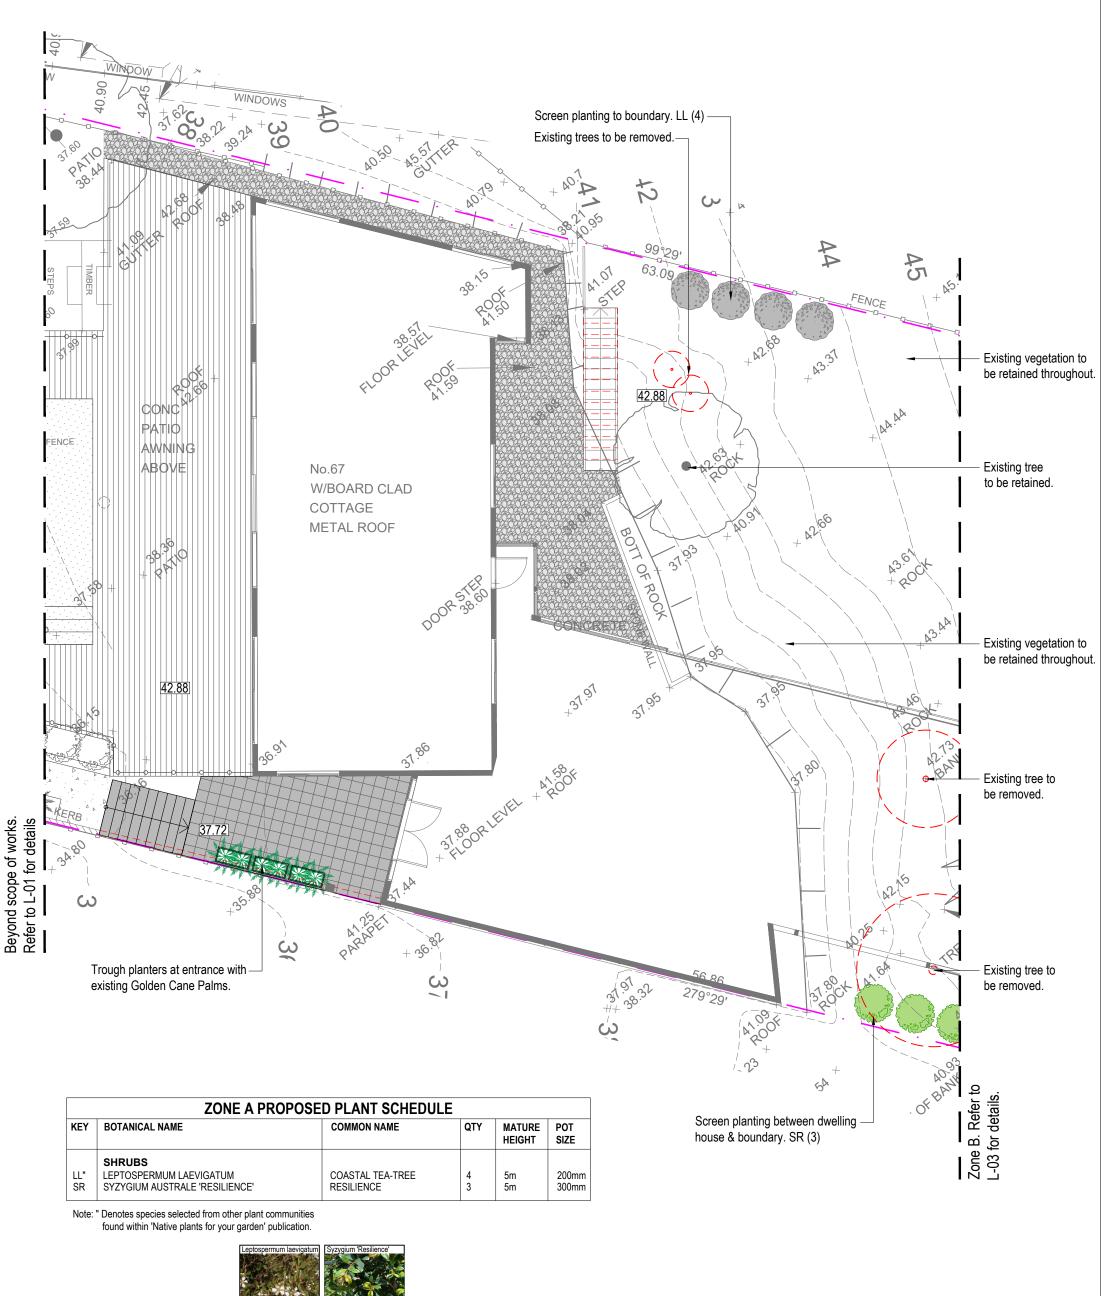



Note:
- Contractors to check and verify all dimensions and all levels on site prior to any works.

Checked:

EC

Any discrepancies should be immediately referred to Serenescapes Landscape Designs.
 All work to comply with B.C.A. Statutory Authorities and relevant Australian Standards.
 Dimensions recognised over scaling. All measurements are in millimetres.
 Copyright Serenescapes Landscape Designs 2020.

Issue:

18/02/2020 DA Issue

Rev: Date:




Suite 54, 14 Narabang Way Tel: 02 9986 2157 info@serenescapes.com.au www.serenescapes.com.au

Private Residence	Drawing Title:	Zone A	N Detail Pla	n
UI WAIIIE FAIAUE		Project Number:		Sheet Number:
Auglan Dagah	Ben Farrar AILDM # 1179	20630	1:100 @ A3	L-02 of 4

Drawing Title:



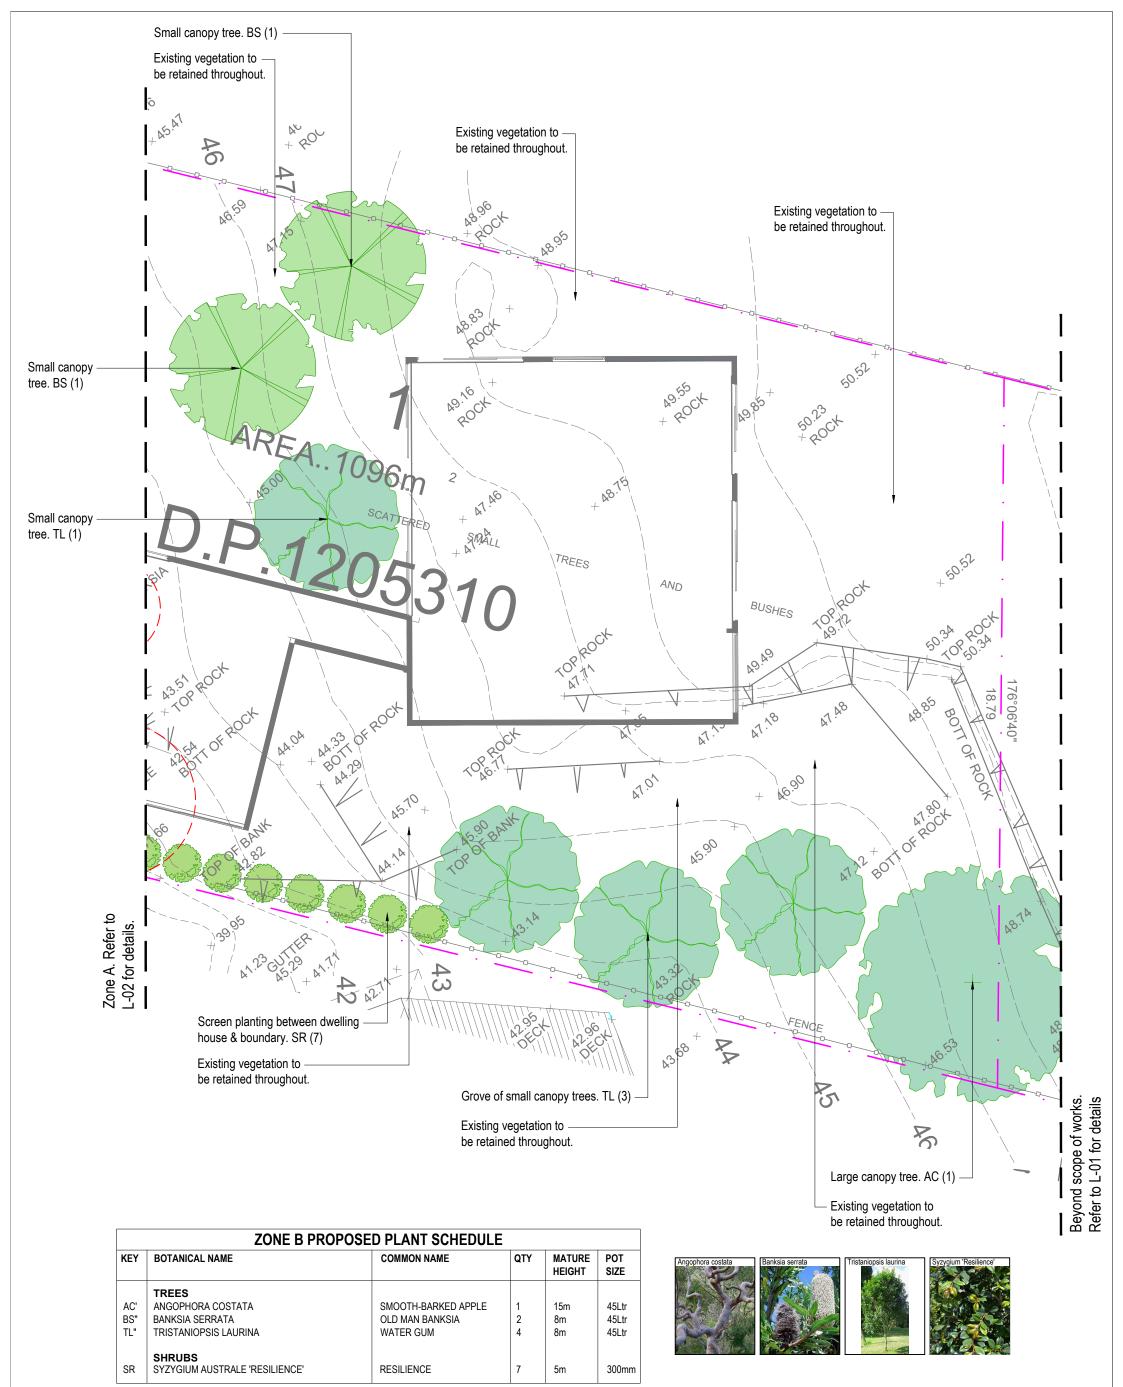

Note: 'Denotes species selected from Rolling Hills and Lower Shale Slopes

plant community as found within 'Native plants for your garden' publication.

" Denotes species selected from other plant communities

found within 'Native plants for your garden' publication.

Rev: Date:


Note:
- Contractors to check and verify all dimensions and all levels on site prior to any works.


Checked:

Any discrepancies should be immediately referred to Serenescapes Landscape Designs.
 All work to comply with B.C.A. Statutory Authorities and relevant Australian Standards.
 Dimensions recognised over scaling. All measurements are in millimetres.
 Copyright Serenescapes Landscape Designs 2020.

Issue:



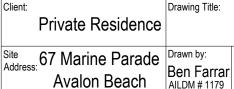

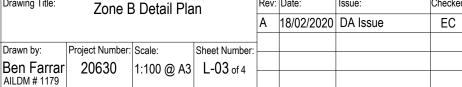



#### LANDSCAPE SPECIFICATION NOTES

#### SITE PREPARATION

Locate any underground and overground services & ensure no damage occurs. Levels on plan are nominal only & all dimensions to be checked on site prior to commencement. Final structural integrity of all items shall be the sole responsibility of landscape contractor.

#### PROTECTION OF EXISTING TREES:

Prior to construction, the builder shall erect tree protection fencing to the drip line of existing trees to be retained.

The fence shall be constructed of star pickets at 2.4m spacings and connected by three strands of 2mm wire at 300mm spacings to a minimum height of 1500mm.

Protect all trees affected by demolition & construction. Take necessary precautions to protect the Critical Root Zone(CRZ) which is the area normally within 3m radius from each tree trunk.

Tree protection measures shall remain intact until the completion of all construction works.

#### Prohibited Works within the CRZ:

- entry of machinery or storage of building materials
- parking of any kind of vehicle
- erection or placement of site facilities
- removal or stockpiling of soil or site debris
- disposal of liquid waste including paint & concrete wash
- excavation or trenching of any kind (including irrigation or electrical connections).
- attaching any signs or any other objects to the tree
- placement of waste disposal or skip bins
- pruning and removal of branches, other than those by a qualified Arborist

Compacted Ground/Coring: Avoid compaction of the ground under trees. If compaction nevertheless occurs loosen the soil by Coring. Coring to be carried out by a qualified Arborist.

#### REMOVAL OF EXISTING TREES

All trees to be removed shall be carried out by a qualified arborist and work shall conform to the provisions of AS4373-2007 Australian Standards for The Pruning of Amenity Trees.

#### **ELIMINATE WEEDS**

Remove all existing weeds by hand, wiping or spraying with a glyphosate based herbicide. Weed control shall never be performed by mechanical cultivation or by scraping. <u>Herbicide spraying is to be used to eliminate all existing weeds 30 days prior to planting.</u>

#### **EXCAVATION & SUB SOIL PREPARATION**

Excavate garden beds to the depth required and rip or scarify base & sides of pit to a minimum depth of 150mm

#### SUB SOIL DRAINAGE

Install drainage layer where there is surface water runoff draining into garden bed areas & where the existing sub-soil has more than 50% clay composition & there is a risk of subsurface water ponding. Install perforated corrugated ag. line 75-100mm Dia. with geotextile filter sock & backfill to a minimum 200mm using free draining material, reclaimed/recycled where available. Direct flows at a minimum 0.5% fall to sw system. In areas isolated from stormwater system excavate & backfill an appropriate water dispersion pit.

#### **REUSE EXISTING TOPSOIL**

Existing site topsoil should be salvaged & appropriately stockpiled where possible.

#### IMPORTED TOPSOIL

Quality System: AS 4419 or as specified below.

Turf Areas: 'Turf Underlay' as supplied by, ANL p: 02 9450 1444 or approved alternative.

Tree Pit and Shrub Planting: 'Premium Garden Mix' as supplied by, ANL p: 02 9450 1444 or approved alternative.

Planting in Planter Boxes: Soil mix A - 'Planter Box Mix', Soil mix B - Washed River Sand as supplied by, ANL p: 02 9450 1444 or approved alternative.

#### PLANTING

Health & Vigour: Supply plants with foliage size, texture & colour consistent with that shown in healthy specimens of the species.

Balance of Crown: Supply plants with max. variation in crown bulk on opposite sides of stem axis, +/- 20%. Stock selection should be based on NATSPEC Guide Specifying Trees: a Guide to Assessment of Tree Quality.

#### STAKING

Install 2 x 1800mm 40x40 hardwood timber stakes with hessian ties to all trees. Provide appropriate support considering exposure to prevailing winds. Stakes and hessian ties to be removed as soon as the tree is self supporting.

#### IRRIGATION SYSTEM

New dripline irrigation system to be installed with backflow preventer and with timers. Irrigation system to be designed and installed to local codes.

The entire irrigation system shall be fully automated and provide drip irrigation to all tree, shrub and ground cover zones. It is the Contractor's responsibility to verify water pressure available and determine all design-built parameters prior to any installation and sizing of irrigation components. Irrigation system to be connected to water tank to supplement water from mains.

#### TIMBER DECK, STAIRS & BENCH SEATS

Supply and install timber deck, stairs and bench seats to BCA requirements and to Australian Standards. All framing timber posts to be treated pine. All decking, steps and bench seats to be hardwood. Decking to be fixed using stainless steel countersink nails or screws. Decking boards up to 86mm space with 3mm gaps, boards over 86mm space with 5mm gaps. Stagger joints and ensure all joins in decking boards sit over a joist. Pre drill nail holes into decking boards to avoid splitting. Nail to be 12mm from edges and ends of boards. Nails driven flush with surface (not punched). Each decking board should be nailed to each joist with two nails as per AS1684 or in accordance with manufacturers instructions.

Supply and install 2 coats of oil. Ensure minimum 300mm clearance between bearer & ground level to provide adequate airflow around structure.

#### MULCHING

Quality system: AS 4454

All planting area impacted by building works to receive 50-75mm of garden Mulch, Hort-Bark, ANL p: 02 9450 1444 or approved alternative. Keep mulch 100mm away from plant stem & form a well to stop excessive water runoff. Finish flush with adjacent surfaces.

#### TURFING

New turf- Sir Walter Soft Leafed Buffalo.


Excavate / grade all areas to be turfed to 120mm below finished levels. Ensure that all surface runoff is directed away from buildings. Ensure that no pooling or ponding will occur. Further rip the sub-grade to 150mm. Install 100mm of imported turf underlay. Rolls to be closely butted and laid in a brickwork pattern. Fill any small gaps with topsoil and water thoroughly.


#### WATERING

Water in immediately after plant installation & allow for soil settlement. For the first 2 to 4 weeks after planting, the root zone & immediate surrounds must be kept moist. Continue watering until plants have established.

#### RETAINING WALLS & PLANTER BOXES

All retaining walls & planter boxes to be constructed to Engineer's details. Ensure all internal surfaces are

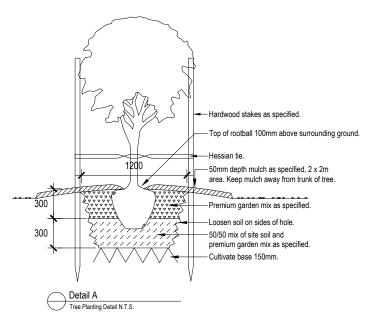

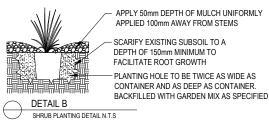

Note:

Contractors to check and verify all dimensions and all levels on site prior to any works.

Any disconnection of bould be immediately referred to Connection and Applications and Application

Any discrepancies should be immediately referred to Serenescapes Landscape Designs. All work to comply with B.C.A. Statutory Authorities and relevant Australian Standards.

Dimensions recognised over scaling. All measurements are in millimetres
 Copyright Serenescapes Landscape Designs 2020.



Serenscapes Landscape Designs info@
ABN 91 697 643 476 www.

Suite 54, 14 Narabang Way Belrose NSW 2085 Tel: 02 9986 2157 info@serenescapes.com.au www.serenescapes.com.au

Client:		Drawing Title:  Landscape Specification & Details				Rev:	Date:	Issue:	Checked:	
	Private Residence					Α	18/02/2020	DA Issue	EC	
Site Address: 67 Marine Parade	'   '	· 1		Sheet Number:						
		20630		L-04 of 4						
	Avalon Beach		1179							