PROPOSED NEW DOUBLE STOREY ATTACHED DUAL OCCUPANCY AT

1 NERIDAH AVENUE, BELROSE NSW 2085 LOT 1 DP 237377

SHEET LIST		
SHEET	DESCRIPTION	
0.00	COVER SHEET	
0.01	DEMOLITION PLAN	
1.00	SUBDIVISION PLAN	
1.01	SITE AND SITE ANALYSIS PLAN	
1.02	AREA PLAN	
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5.01	ROOF PLAN	
6.01	SHADOW DIAGRAMS	
7.01	LANDSCAPE PLAN	
8.01	NOTIFICATION PLANS	



ARTIST IMPRESSION ONLY





CLIENT NAME:	
MR JAGDISH CHAUDHARI	
PROJECT ADDRESS	LOT DETAILS
1 NERIDAH AVENUE, BELROSE NSW 2085	LOT 1 DP 237377
SHEET TITLE:	PROJECT NUMBER:
COVER SHEET	1504

DESIGNED BY: DD	DRAWN BY: DD
DATE: 03-12-2025	CHECKED BY: DD
SCALE:	REVISION: B
DWG NUMBER: 0.00	LGA: NORTHERN BEACHES

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- ROCEEDING.
- . ALL EXISTING GROUND LINES AND TREE LOCATIONS ARE APPROXIMATE.
- . ALL EAST MOS GROUND LINES AND TREE LOCATIONS ARE APPROXIMATE, HEREFORE TO BE VERIFIED ON-SITE BY THE BUILDER
 . ALL WORKMANSHIP AND MATERIALS SHALL COMPLY WITH ALL THE RELEVANT CODES AND AUSTRALIAN STANDARDS.



LEGEND




DEMOLISH EXISTING RESIDENCE, SHED, STAIRS, & AWNING



DEMOLISH EXISTING **CONCRETE DRIVEWAY**



PROPOSED REMOVAL OF EXISTING TREES

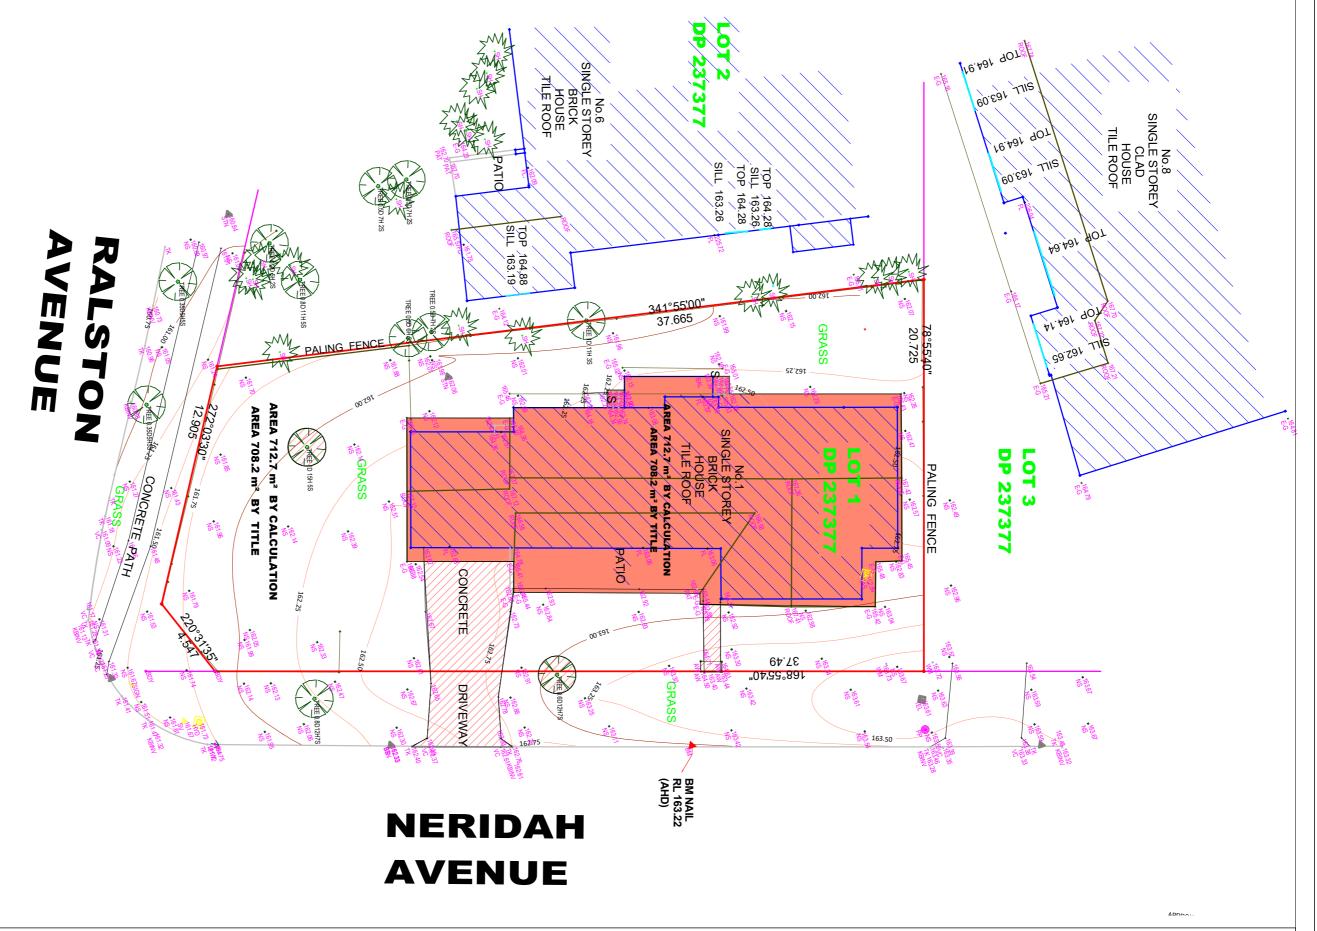



DEMOLITION PLAN

SCALE 1:200



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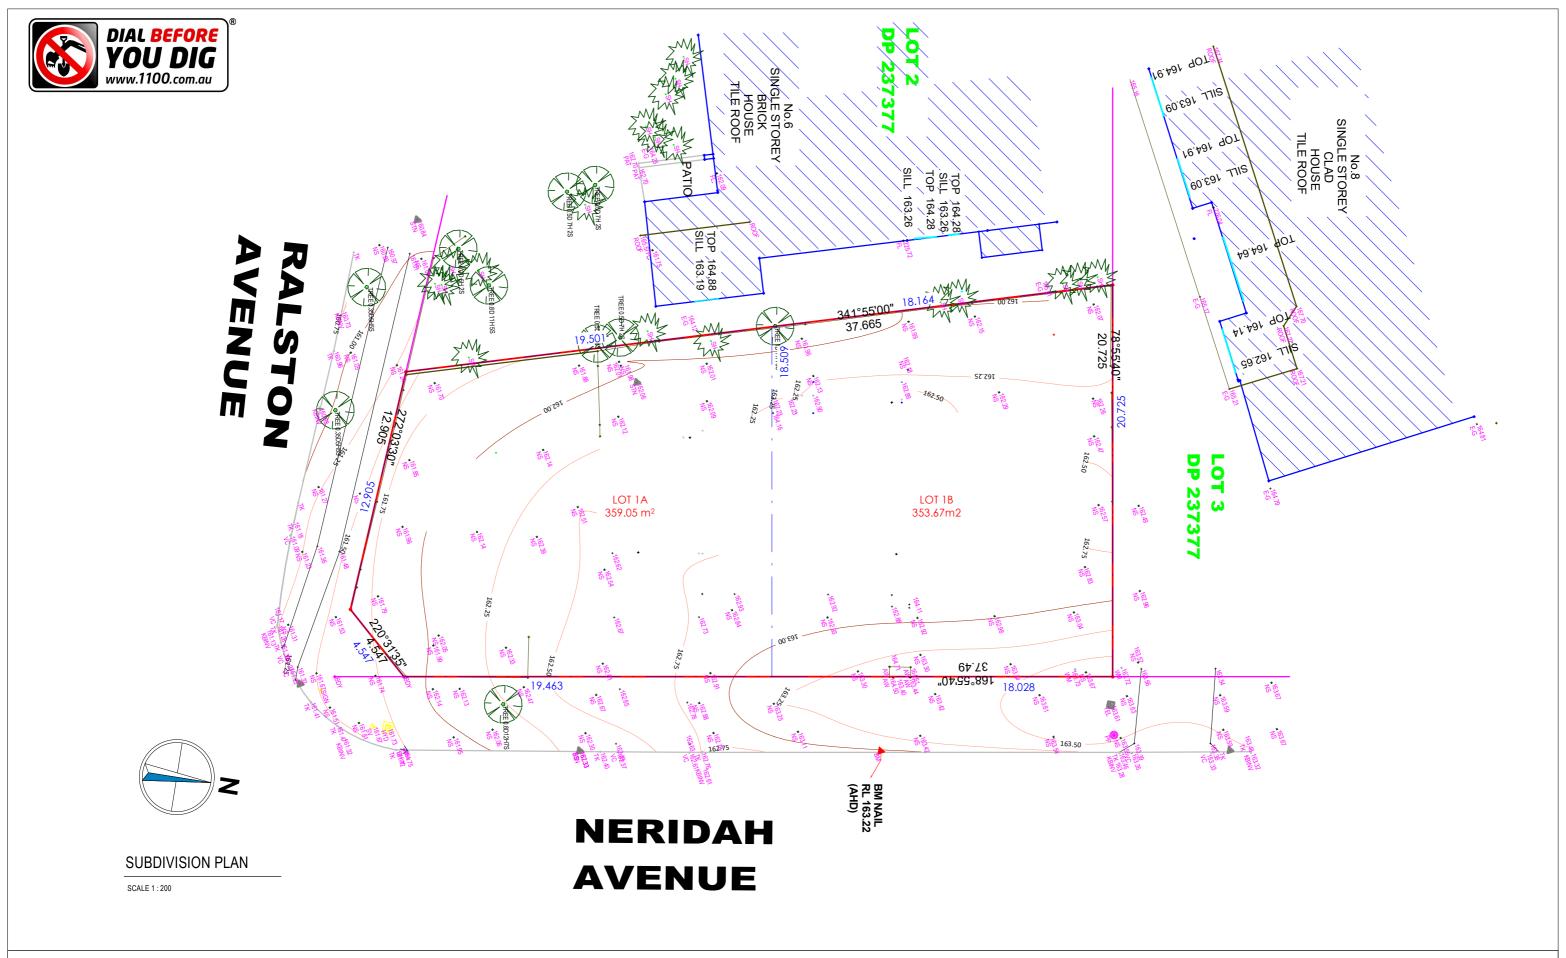
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DEMOLITION PLAN	1504

DESIGNED BY: DD	DRAWN BY: DD
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SHEET TITLE:	PROJECT NUMBER:
SUBDIVISION PLAN	1504

DESIGNED BY: DD	DRAWN BY: DD
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SCALE: 1:200	REVISION:
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GENERAL NOTES:

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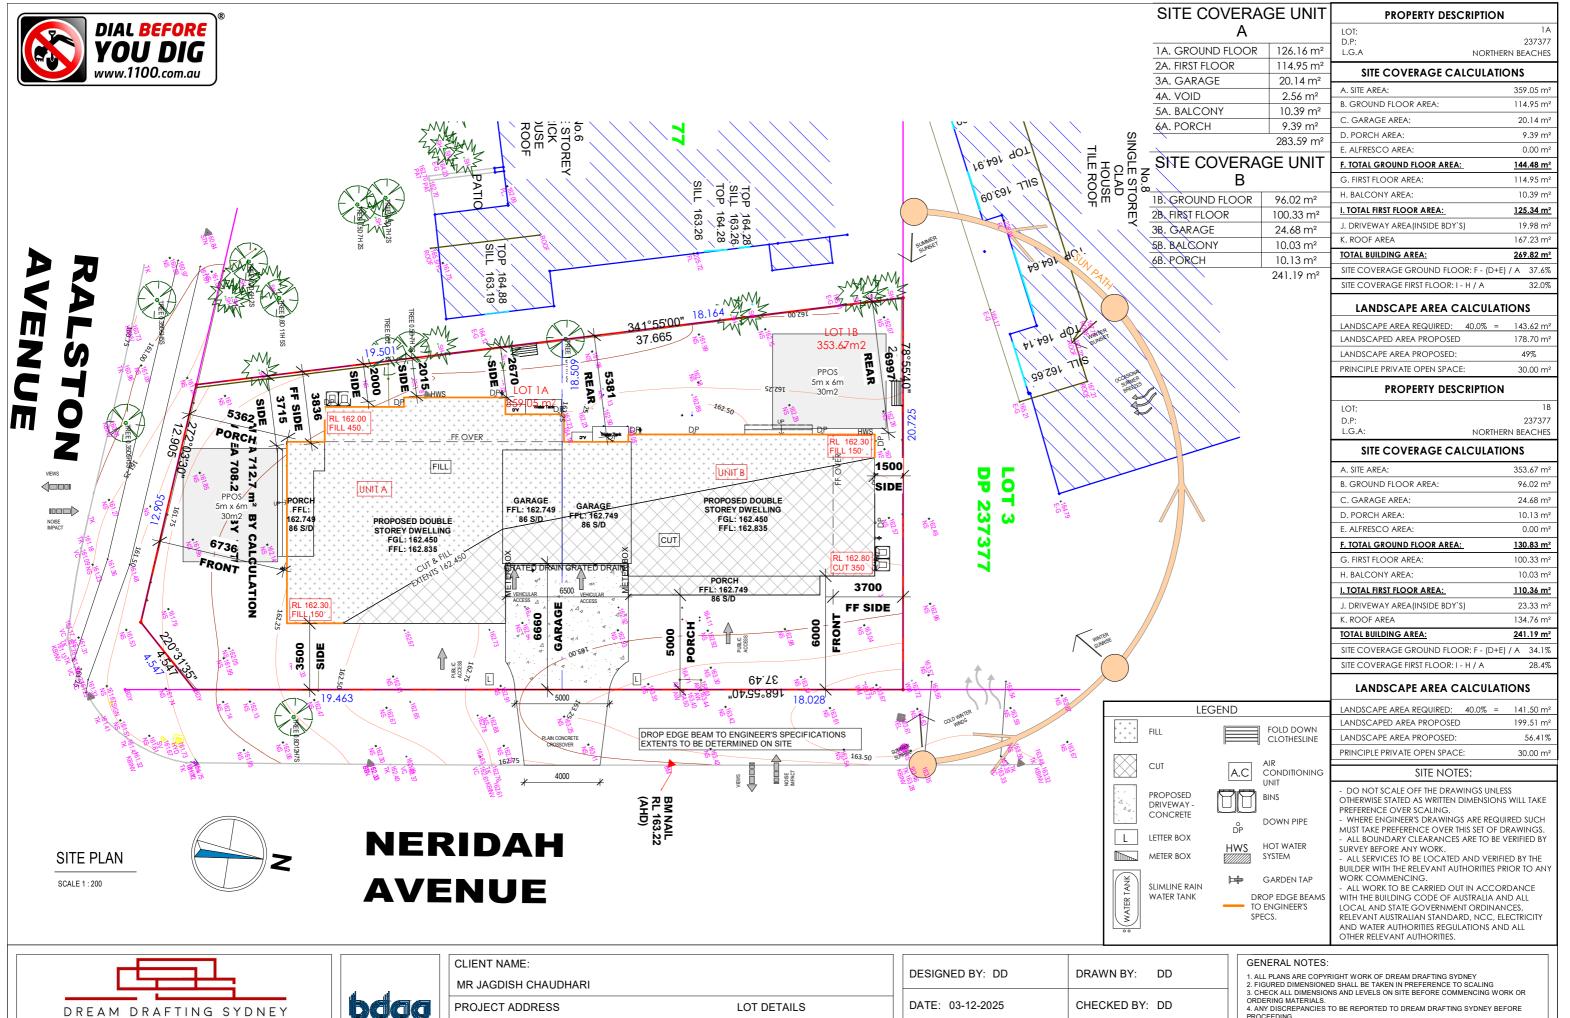
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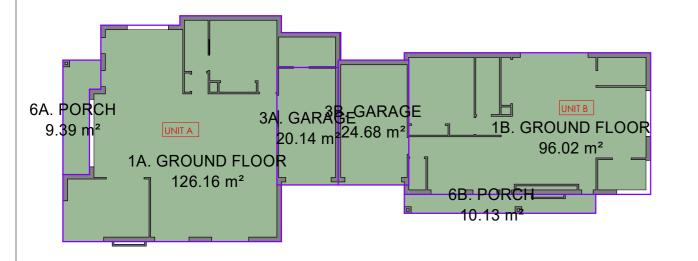


	SITE AND SITE ANALYSIS PLAN	1504
	SHEET TITLE:	PROJECT NUMBER:
	1 NERIDAH AVENUE, BELROSE NSW 2085	LOT 1 DP 237377
	PROJECT ADDRESS	LOT DETAILS
	MR JAGDISH CHAUDHARI	
l	CLIENT NAME:	

DESIGNED BY: DD	DRAWN BY: DD
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1- GROUND FLOOR SITE COVERAGE


SCALE 1:200

SITE COVERAGE UNIT Α

1A. GROUND FLOOR	126.16 m ²
2A. FIRST FLOOR	114.95 m ²
3A. GARAGE	20.14 m ²
4A. VOID	2.56 m ²
5A. BALCONY	10.39 m ²
6A. PORCH	9.39 m²
	283.59 m ²

SITE COVERAGE UNIT

1B. GROUND FLOOR	96.02 m²
2B. FIRST FLOOR	100.33 m²
3B. GARAGE	24.68 m²
5B. BALCONY	10.03 m ²
6B. PORCH	10.13 m ²
	241.19 m ²

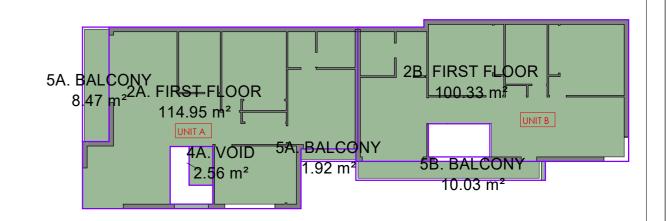

2- FIRST FLOOR SITE COVERAGE

SCALE 1:200



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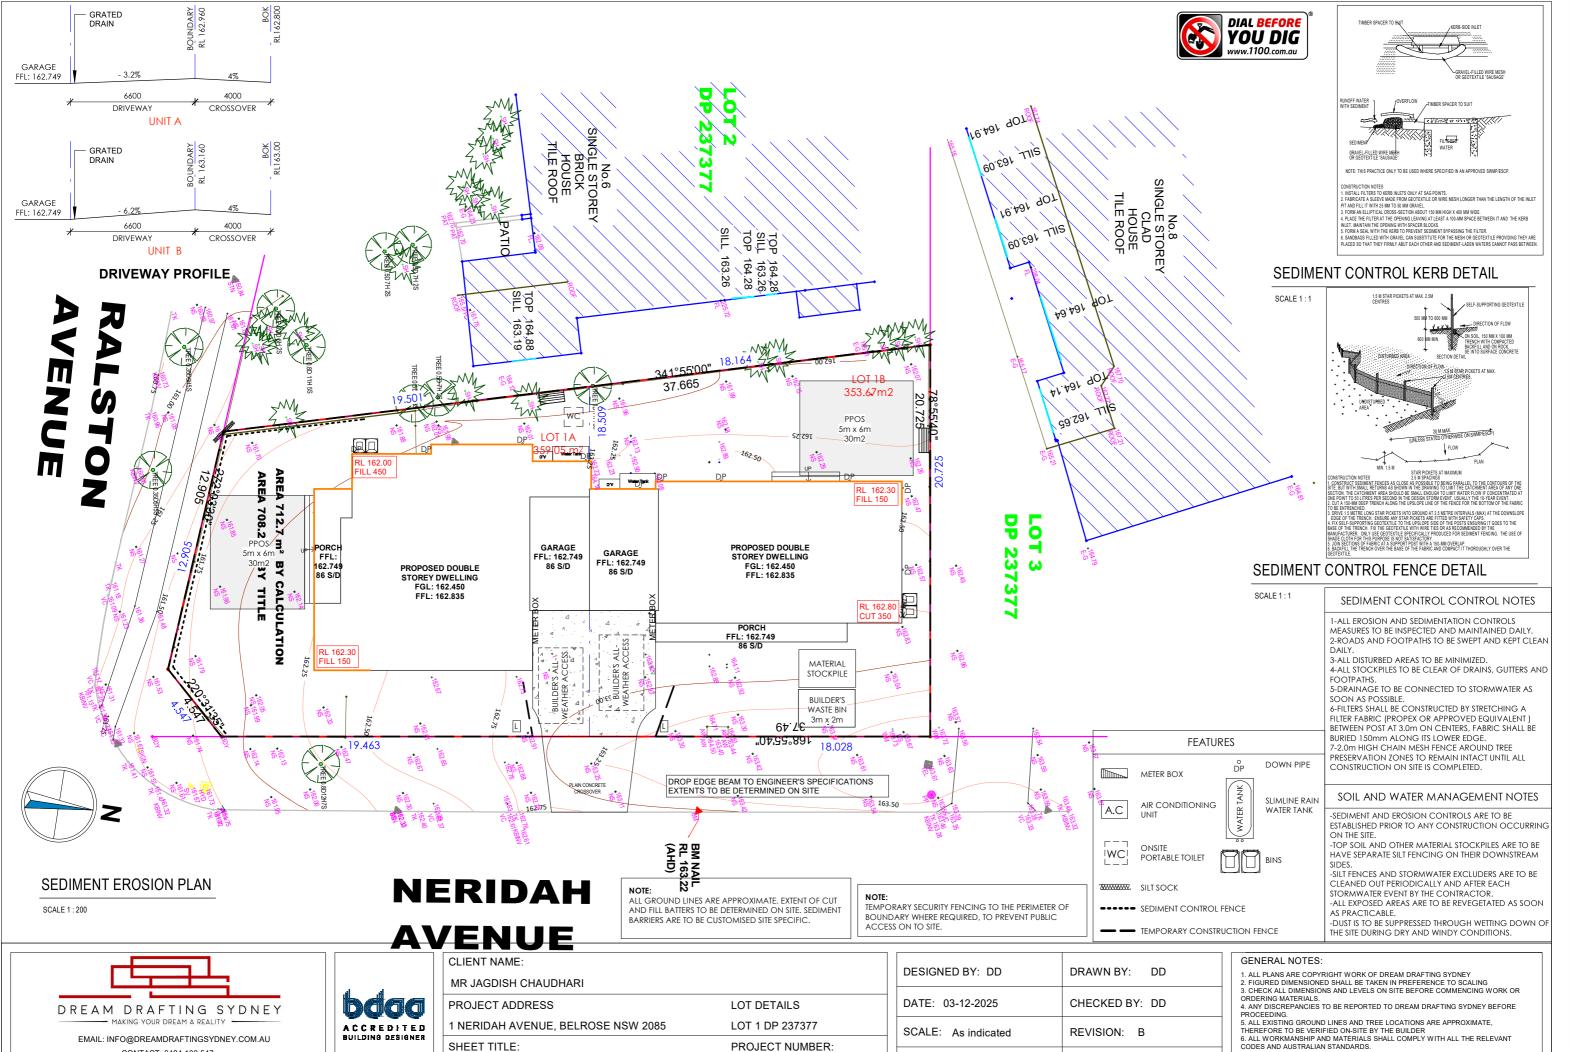


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SHEET TITLE:	PROJECT NUMBER:
AREA PLAN	1504

DESIGNED BY: DD	DRAWN BY: DD	
DATE: 03-12-2025	CHECKED BY: DD	
SCALE: 1:200	REVISION: B	
DWG NUMBER: 1.02	LGA: NORTHERN BEACHES	

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PROJECT NUMBER: SEDIMENT CONTROL AND WASTE MANAGEMENT PLANSO4

DESIGNED BY: DD	DRAWN BY: DD	1. 2.
DATE: 03-12-2025	CHECKED BY: DD	3. 0 4.
SCALE: As indicated	REVISION: B	5. Ti 6.
DWG NUMBER: 1.04	LGA: NORTHERN BEACHES	

BE ADVISED: SOME CLAUSES IN THIS SPECIFICATION MAY NOT BE RELEVANT TO THIS PROJECT

1.0 GENERAL

- ALL DIMENSIONS SHALL BE CHECKED ON SITE PRIOR TO COMMENCEMENT ANY WORK
- 1.2 ALL MATERIALS SHALL COMPLY WITH RELEVENT CURRENT AUSTRLIAN STANDARDS AND SHALL BE NEW AND THE BEST OF THEIR RESPECTIVE KINDS AND SUITABLE FOR THEIR INTENDED PURPOSES.
- ALL WORKMANSHIP SHALL COMPLY WITH RELEVENT CURRENT AUSTRALIAN STANDARDS AND TO GOOD TRADE PRACTICES.
- ALL WORK SHALL BE IN ACCORDANCE WITH REQUIREMENTS OF THE RESPECTIVE AUTHORITY HAVING JURISDICTION OVER THE WORKS.
- THE ARCHITECTURAL DRAWINGS SHOULD BE READ IN CONJUNCTION WITH THE SPECIFICATION, SCHEDULES AND CONSULTANTS DRAWINGS THAT FORMS PART OF THE CONSTRUCTION DOCUMENTS REFERRED TO IN THE "BUILDING CONTRACT'
- DO NOT SCALE FROM DRAWINGS. NOTIFY OF ANY ERRORS OR OMISSIONS BEFORE PROCEEDING WITH ANY WORKS
- ENSURE THAT BACKGROUNDS ARE SUITABLE FOR THE INTENDED SUBSEQUENT FINISHES. COMMENCEMENT OF WORK ON THE BACKGROUNDS IMPLIES ACCEPTANCE BY THE SUBCONTRACTOR OF THE BACKGROUNDS ON WHICH FINISHES ARE APPLIED
- SUPPLY ALL EQUIPMENT NECESSARY FOR THE COMPLETION OF RESPECTIVE
- PROGRESSIVELY CLEAN UP AFTER THE COMPLETION OF RESPECTIVE WORKS

- 2.1 UNLESS OTHERWISE STATED, REMOVE TOPSOIL TO A MINIMUM DEPTH OF 200mm INCLUDING ALL ROOTS, AND OTHER MATTER, AND REQUIRED BY THE SOIL CONDITION AND/OR THE BUILDER. PROVIDE SUITABLE CLEAN FILLING SAND AND COMPACT IN LAYERS NOT GREATER THAN 300mm TO REDUCE LEVELS AS SHOWN
- COMPACT SAND FILLING AND SANDY SUB GRADES UNDER FOOTINGS AND SLAB TO OBTAIN MIN. SEVEN (7) BLOWS PER 300mm ON A STANDARDS PERTH SAND PENEFROMETER TEST (AS PER AS 1289 F3.3)
- DO NOT EXCAVATE SERVICES TRENCHES WITHIN AN ANGEL OF 45 DEGREES DOWN FROM BOTTOM EDGE OF FOOTING.
- ALL RETAINING WALLS TO BE TREATED WITH "BITKOTE" WATERPROOFING AGENT

3.0 CONCRETE

- CONCRETE REINFORCEMENT AND FORMWORK SHALL BE TO A STRUTURAL ENGINEERS DETAILS, RELEVANT BUILDING CODES AND STANDARDS
- ALL CONCRETE TO CONFORM TO THE REQUIREMENTS OF AS 3600 CONCRETE STRENGTH GRADE: N20, AGGREGATE 20mm, SLUMP 80mm.
- 3.3 SLAB IS TO BE CURED FOR 7 DAYS MIN. & SLAB REINFORCEMENT PLACED ON APPROVED CHAIRS TO IMPROVE CRACK CONTROL
- THE FOOTING AND SLAB CONSTRUCTION IS TO COMPLY WITH AS 2870.
- PROVIDE A PROPRIETARY VAPOR BARRIER WHICH CONSISTS OF HIGH IMPACT RESISTANT POLYTHENE FILM MIN. 0.2mm THICK WHICH HAS BEEN PIGMENTED AND BRANDED BY THE MANUFACTURER.

3.6 TERMITE PROTECTION:

PROVIDE ANTI-TERMITE TREATMENT UNDER THE BUILDING AREAS IN ACCORDANCE WITH AS 2057, AS 3660.1 AND APPENDIX D, FOR RETICULATED

BUILDER SHALL PROVIDE "DURSBAN" (HAND SPRAYED ORGANO-PHOSPHATE) OR SIMILAR APPROVED ANTI-TERMITE TREATMENT IN ACCORDANCE WITH RELEVANT AUSTRALIAN STANDARD CODES

4.0 BRICKWORK

- BRICK WORK SHALL COMPLY WITH:
 - AS 3700 MASONRY CODE AS A123 MASONRY CODE
- MORTAR FOR MASONRY CONSRUCTION BRICK GAUGE 7 STANDARD COURSES = 600mm
- ALL BRICKS SHOULD HAVE MIN. COMPRESSIVE STRENGTH OF 20MPa AND AS FOLLOWS

EXTERNAL FACE WORK: 230x110x76mn

EXTERNAL RENDER: WINDOW SILLS: WINDOW HEADS:

305x162x90mm MAXIBRICK OR VERTICORE 2c FACE BRICK SPLAYED SILLS SOLID FACEBRICK COURSE

INTERNAL WALLS: 305x162x90mm MAXIBRICK OR VERTICORE WITH BED JOINT AND PERPENDS FILLED 305x76x90mm LONGREACH OR JUMBO FOR

COURSE ADJUSTMENT

MORTAR: 1:1:6 CEMENT:LIME:SAND MORTAR (FACE BRICK) COLOR TO MATCH EXISTING AS SELECTED

- TIES SHALL BE 3.5mm DIAMETER GALVANIZED WIRE KINKED FOR AND BUILT IN EVERY 5TH COURSE AT APPROXIMATELY 900mm CENTRES, WITH ADDITIONAL TIES AT THE RATE OF 1 TIE/300mm HEIGHT OF OPENINGS AND VERTICAL CONTROL JOINTS AND WITHIN 150mm OF THE OPENINGS. BUILD TIES INTO EACH LEAF AT LEAST 50mm. VERTICAL CONTROL JOINTS SHALL BE 12mm WIDE FILLED AT COMPLETION WITH 'COMPRIBAND' CONTINUOUS FILLER STRIP.
- KEEP CAVITIES CLEAR OF MORTAR, PROVIDE CAVITY BOARDS, TEMPORARILY OMIT BRICKS TO PERMIT RAKING OUT OF CAVITY BOTTOMS.
- FORM WEEP HOLES EVERY FOURTH PERPEND ABOVE FLASHINGS AND CAVITY FILL. KEEP CLEAR OF MORTAR. DO NOT LOCATE WEEPHOLES CLOSER THAN 500mm TO JOINTS IN DAMP PROOF COURSES OR FLASHINGS
- PROVIDE DAMP PROOF COURSES (DPC) IN THE BOTTOM 3 COURSES OF BRICK WORK AND SLAB AND/OR FOOTINGS. DPC ADDITIVE SHALL BE CLEAR IN ALL FACEWORK
- SETOUT BRICKWORK ACCURATELY, PLUMB, LEVEL AND PROPERLY BONDED. RISING WORK TO BE RAKED BACK, JAMBS, REVEALS, CORNERS, PERPENDS ETC. TO BE TRUE, PLUMB, AND IN LINE WITH PERPENDS TRUE TO LINE. SETOUT DOOR FRAMES NEAR PERPANDICULAR WALL WITH A MARGIN OF 12mm OR GREATER THAN 50mm
- MOISTEN ALL EXTRUDED BRICKS BEFORE LAYING.
- PROVIDED 12mm PLASTERING MARGIN BETWEEN WINDOW FRAME AND INTERNAL BRICKWORK TO BE PLASTERED.
- WHERE NECESSARY REINFORCE BELOW AND OVER OPENINGS WITH GALVANISED WOVEN WIRE FABRIC 75mm WIDE IN CENTRE OF EACH LEAF LOCATED IN 2 COUSES BELOW SILL AND IN THE 2 COURSES ABOVE AN OPENING EXTENDING A MINIMUM OF 600mm BEYOND THE OPENING.
- 4.13 BUILD IN ALCOR/PGI FLASHINGS AS FOLLOWS: -WHEREVER SHOWN ON DRAWINGS

-CAVITY WALLS BUILT OF SLAB ON GROUND (WHERE NOT PARGED.) -OVER LINTELS TO EXPOSED OPENINGS:

> FULL WIDTH OF OUTER LEAF CONTINUOUS ACROSS CAVITY 50mm INTO INNER LEAF 2c ABOVE

-OVER ROOF:

FULL WIDTH OF EXTERAL LEAF, STEPPED TO ROOF SLOPE TURNED DOWN MIN 50mm OVER BASE FLASHING. TURN UP IN CAVITY SLOPING INWARDS AND BUILT

-DOOR / WINDOW STILES:

FULL HIGHT 150mm WIDE FIXED TO FRAMES INTERLEAVED WITH SILL AND HEAD FLASHING AT EACH END

-STRUCTURE OR SERVICES WITHIN 30mm OF OUTER BRICK LEAF IN CAVITY VERTICAL FLASHINGS CONTINUOUS 1¢ BELOW FL TO ABOVE STRUCTURE OR FRAME. NOMINAL 300mm WIDE. FOR HORIZONTAL STRUCTURES / SERVICES: CONTINUOUS FLASHING BUILT IN AS FOR OVER LINTELS.

-AT CAVITY WALLS WITH GLASS BLOCK 300mm WIDE FIXED TO GLASS BLOCK FRAME AND TURNED AWAY IN CAVITY FROM INNER LEAVE.

4.14 LINTELS

MAX SPAN	LINTELS SIZE	BEARING	
(mm)	(VERT x HORIZ x THICK)	EACH END (mm)	
900	75x10	150	
1200	75x75x8	150	
1500	90x90x8	150	
1800	100x75x8	230	
2100	125x75x8	230	
2400	125x75x10	230	
2500	100x100x8	230	
3000	150x90x10	230	

5.0 CARPENTRY WORK

- ROOF AND CEILING FRAMING SHOULD COMPLY WITH AS 1684 LIGHT TIMBER FRAMING CODE. DRAW STRAP FIRMLY OVER WALL PLATES AND SECURELY FIX TO TOP OF PLATE BY 2x30mm GALV CLOUTS/STRAP
- REFER TO AS 1684 FOR ROOF FRAMING SIZES UNLESS SPECIFIED ON DRAWINGS
- SUPPLY AND FIX ALL BULKHEADS & FALSE CEILINGS AS SHOWN ON THE DRAWINGS.

6.0 METALWORK

- ELECTRIC AND GAS METER BOXES AS SHOWN IN DRAWINGS
- WINDOW FRAMES SHALL BE RESIDENTIAL OR COMMERCIAL SECTION WITH POWDERCOAT FINISH AS SELECTED BY OWNER. ALLOW FOR FLYSCREENS TO ALL WINDOWS. REFER TO ADDENDUM. ANGLED WINDOW UNITS SHALL BE FACTORY MADE AND FIXED AND DELIVERED ON SITE AS COMPLETE UNIT.
- CLOTHES HOIST: REFER TO ADDENDUM.

7.0 ROOFING

- 7.1 SELECTED ROOFING MATERIAL SHALL BE INSTALLED AND FIXED IN ACCORDANCE WITH MANUFACTURERS SPECIFICATION AND RELEVANT BUILDING CODES
- GUTTER, FASCIA, DOWN PIPES, FLASHINGS SHALL BE IN LONGEST POSSIBLE LENGTHS AND SHALL MATCH EXISTING.
- 7.3 DOWN PIPES SHALL MATCH EXISTING.
- ALLOW FOR ALL JOINTS AND JOINING MATERIALS, COLLARS, STRAPS & FASTENINGS NECESSARY TO COMPLETE WORK
- 7.5 ALLOW FOR ALL ROOF PENETRATIONS, ROOF COWLS, FLASHINGS, FLUMES THROUGH ROOF
- 7.6 FIX GUTTERS & FLASHINGS TO PERMIT THERMAL MOVEMENT IN THEIR FULL LENGTH
- SEAL BETWEEN OVERLAPPING FLASHINGS; FLASHINGS TURNED DOWN OVER BASE OR APRON FLASHINGS: FLASHINGS OVER METAL ROOF: FLASHINGS OVER SECRET GUTTERS: AROUND ROOF PENETRATIONS ETC.

8.0 JOINERY

- 8.1 ALL JOINERY SHALL BE OF HIGHEST QUALITY MATERIALS TO BEST TRADE PRACTICES AND HIGH QUALITY FINISH.
- EXTERNAL DOOR FRAMES SHALL BE: 110x40 DOUBLE REBATED FRAME WITH 130x40 WEATHERED THRESHOLD U.N.O.
- SUPPLY AND BUILD IN TIMBER DOOR FRAMES TO EXTERNAL LOCATIONS AS SHOWN ON ARCHITECTURAL DRAWINGS.

- 9.1 CEILINGS SHALL BE RECESSED EDGE, MINIMUM 8.0mm PLASTERGLASS OR GYPROCK.
- 9.2 FLUSH JOINTS SCREW HEADS AND OTHER BLEMISHES IN THE SHEETS USING APPROVED SYSTEMS TO PROVIDE FLUSH SMOOTH CONTINUOUS SURFACE
- 9.3 PROVIDE AND FIX ALL FLUSH STOP BEADS & CASING BEADS TO ALL CORNERS & EDGES.
- PROVIDE ALL SELECTED MOLDINGS AND CORNICES TO ALL CEILINGS AS STATED IN ARCHITECTURAL DOCUMENTS.

10.0 PLASTERING

- INTERNAL WALL FINISHES INCLUDING CUPBOARD, BIN, & FRIDGE RECESSES, ETC. SHALL BE (OTHER THAN FACE FINISHES OR WHERE COVERED BY FEATURE MATERIALS) FLOAT AND SET IN HARDWALL PLASTER U.N.O.
- PLASTERED WALLS SHALL BE NOMINAL 12mm THICK CONSISTING OF 1:1:9, CEMENT: LIME: SAND RENDER, AND FINISHED WITH NOMINALLY 3mm HARDWALL PLASTER
- SUPPLY AND FIX EXTERNAL CORNER BEADS TO ALL EXTERNAL CORNERS.
- PROVIDE STOP BEADS WHERE PLASTER WORK ABUTS TIMBER FRAMES, OR FACEWORK EXTERNAL RENDER WHEN APPLICABLE SHALL BE 2 COAT SAND FINISH. (FOR PAINTING)
- NIBS IN INTERNAL CORNERS ADJACENT TO DOOR FRAMES GREATER THAN 40mm SHALL NOT BE FLUSHED UP WITH FRAMES.
- PROVIDE V-JOINTS IN RENDER & FINISHING PLASTER WHERE BRICK WORK ABUTS OR JOINS ONTO CONCRETE WORK

11.0 GLAZING

- CLEAR GLASS GENERALLY: OBSCURE GLASS TO BATHROOMS, REFER TO DRAWINGS. ALL TO THE RELEVANT AUSTRALIAN STANDARDS.
- WHERE GLASS BLOCKS HAVE BEEN NOMINATED, THEY SHALL BE IN FRAMES AND INSTALLED TO MANUFACTURES SPECIFICATIONS.

12.0 FLOORING FINISHES

- 12.1 CARPET FLOOR COVERINGS TO NOMINATED AREAS COMPLETE WITH SELECTED UNDERLAY SMOOTH EDGE, DIMINISHING STRIPS ETC, TO COMPLETE THE WORKS: REFER TO DRAWINGS & FINISHES SCHEDULE.
- PROVIDE TILED FLOOR FINISHES TO NOMINATED AREAS COMPLETE WITH ALL MATERIALS ANGLE TRIMS, ETC.TO COMPLETE THE WORKS: REFER TO DRAWINGS & FINISHES SCHEDULE.
- PROVIDE TIMBER FLOOR FINISHES TO NOMINATED AREAS COMPLETE WITH ALL MATERIALS, DIMINISHING BOARDS ETC. TO COMPLETE THE WORKS: FLOOR BOARDS TO BE SANDED & POLISHED TO HIGH STANDARD WITH PREMIUM QUALITY SEALER (2 COATS). REFER TO DRAWINGS & FINISHERS SCHEDULE.

13.0 SIGNAGE

- WHERE NECESSARY SUPPLY & FIX SELECTED UNIT AND HOUSE NUMBERS TO EACH UNIT AND TO LETTERBOXES AS SCHEDULED
- 13.2 DREAM DRAFTING SYDNEY RESERVES THE RIGHT TO ERECT A BUILDERS SIGN ON THE PROPERTY FACING THE STREET FRONTAGE IN COMPLIANCE WITH AUTHORITY REQUIREMENTS.

14.0 PAVING

- GENERALLY: WHEN PAVING IS INCLUDED IN THE BUILDING CONTRACT, THE FOLLOWING SHALL APPLY AS A MINIMUM STANDARD
- SUPPLY AND LAY ALL PAVING TO EXTERNAL AREAS AS SHOWN ON WORKING DRAWINGS
- CUT, FILL AND COMPACT SAND TO REQUIRED LEVELS. SCREED TO UNIFORM THINNESS
- PROVIDE BRICK EDGE-RETRAINING FOOTING EMBEDDED IN MORTAR BENEATH THE PAVING BRICK, GENERALLY, TO DRIVEWAY AREAS, PROVIDE NOMINAL 300x150mm CONCRETE FOOTING ALONG PERIMETER OF DRIVEWAY AND BED EDGE BRICK IN MORTAR.
- PROVIDE 100mm COMPACTED LIMESTONE BASE TO DRIVEWAY TOPPED WITH 50mm CLEAN SAND AND GRADE TO FALLS.
- PAVING PATTERN: REFER TO ADDENDUM.
- BRICK PAVERS SHALL BE

TRAFFICABLE AREAS: MIN. 65mm SOLID CLAY OR CONCRETE PEDESTRIAN AREAS: MIN. 43mm SOLID CLAY OR CONCRETE





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1 NERIDAH AVENUE, BELROSE NSW 2085	LOT 1 DP 237377
SHEET TITLE:	PROJECT NUMBER:
STANDARD SPECIFICATIONS	1504

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NCC 2022 & AUSTRALIAN STANDARDS COMPLIANCE

H1 STRUCTURE

STRUCTURE PROVISIONS

(DEEMED-TO SATISEY PROVISION H1D2 TO H1D11)

- STRUCTURE PROVISIONS FOR CLASS 1 OR CLASS 10 BUILDINGS MUST BE IN ACCORDANCE WITH SECTION 2 OF THE ABCB HOUSING PROVISIONS OR THE RELEVANT PROVISIONS OF H1D3 TO H1D12 OR ANY COMBINATION THEREOF

O-SATISFY PROVISION H1D3)

- SITE PREPARATION TO BE IN ACCORDANCE WITH THE FOLLOWING

PART 3.2 OF THE ABCB HOUSING PROVISIONS PROVIDED SITE CLASSED AS A, S, M, H OR E IN ACCORDANCE WITH PART 4.2.2 OF THE ARCR HOUSING PROVISIONS AND THE WORK IS UNDERTAKEN IN NORMAL SITE CONDITIONS.

AS4678 FOR FARTH RETAINING

PART 3.4 OF ABCB HOUSING PROVISIONS FOR TERMITE RISK

FOOTINGS & SLABS

(DEEMED-TO-SATISFY PROVISION H1D4)

FOOTINGS & SLABS TO BE CONSTRUCTED IN ACCORDANCE WITH EITHER AS 2870 OR AS3600

WHERE IT FALLS WITHIN THE REQUIREMENTS OF H1D4 SECTION 2 OF THE NCC THEN CAN COMPLY WITH SECTION 4 OF THE ABCB HOUSING PROVISIONS

MASONARY

(DEEMED-TO-SATISEY PROVISION H1D5)

- MASONARY VENEER TO BE CONSTRUCTED IN ACCORDANCE WITH: AS3700 OR AS4773.1 & AS4773.2 OR PART 5 OF THE ABCB HOUSING

WIND CLASS N3 & LESS

COMPLY WITH HID4 & PART 5.6 USING COMPONENTS OF PART 5.7 OF THE HOUSING PROVISIONS

SOIL CLASS A. S. M IN ACCORDANCE TO AS2870

TED MASONARY AS PER H1D6 NOT LOCATED WITHIN ALPINE AREAS

NO EARTHQUAKE AFFECTED DESIGN REQUIREMENTS

- CAVITY BRICK UNREINFORCED TO BE CONSTRUCTED IN ACCORDANCE

AS3700 OR AS4773.1 & AS4773.2 OR PART 5.3 OF THE ABCB HOUSING

PROVISIONS PROVIDED WIND SPEED OF NOT MORE THAN N3

COMPLY WITH H1D4 & PART 5.6 USING COMPONENTS OF PART 5.7 OF THE ABCB HOUSING PROVISIONS

SOIL CLASS A. S. M IN ACCORDANCE WITH AS2870 NOT LOCATED WITHIN ALPINE AREAS

NO EARTHQUAKE AFFECTED DESIGN REQUIREMENTS

SINGLE LEAF UNREINFORCED MASONARY TO BE CONSTRUCTED IN

ACCORDANCE WITH: AS3700 OR AS4773.1 & AS4773.2 OR PART 5.4 OF THE ABCB HOUSING

PROVISIONS PROVIDED: WIND SPEED NOT MORE THAN N3

COMPLY WITH H1D4 & PART 5.6 USING COMPONENTS OF PART

5.7 OF THE ABCB HOUSING PROVISIONS

SOIL CLASS A, S, M IN ACCORDANCE WITH AS2870 NOT LOCATED WITHIN ALPINE AREAS

NO EARTHQUAKE AFFECTED DESIGN REQUIREMENTS

- REINFORCED MASONARY TO BE CONSTRUCTED IN ACCORDANCE WITH:

 AS3700 EXCEPT '(FOR PIERS—ISOLATED OR ENGAGED)' IS
REMOVED FROM CLAUSE 8.5.1 (D); AND WHERE CLAUSE 8.5.1 REQUIRES DESIGN AS FOR UNREINFORCED MASONRY IN ACCORDANCE WITH SECTION 7, THE MEMBER MUST ALSO BE DESIGNED AS UNREINFORCED MASONRY IN ACCORDANCE WITH TABLE 10.3 AND 4.1(A)(I)(C) OF AS 3700; OR AS4773.1 & AS4773.2

- ISOLATED MASONARY PIERS TO BE CONSTRUCTED IN ACCORDANCE WITH ONE OF THE FOLLOWING, AS APPROPRIATE:

AS3700 EXCEPT '(FOR PIERS—ISOLATED OR ENGAGED)' IS REMOVED FROM CLAUSE 8.5.1 (D); AND WHERE CLAUSE 8.5.1 REQUIRES DESIGN AS FOR UNREINFORCED MASONRY IN ACCORDANCE WITH SECTION 7, THE MEMBER MUST ALSO BE DESIGNED AS UNREINFORCED MASONRY IN ACCORDANCE WITH TABLE 10.3 AND 4.1(A)(I)(C) OF AS 3700; OR

AS4773.1 & AS4773.2
PART 5.5 OF THE ABCB HOUSING PROVISIONS PROVIDED

- WIND CLASS NO MORE THAN N3 - COMPLY WITH H1D4

COMPLY WITH PART 5.6.2(4) OF THE HOUSING PROVISIONS OF THE NCC AND HAVE 6.2MPa FOR SOLID & CORE UNITS AND 15MPa FOR HOLLOW UNITS.

- THE ROOF STRUCTURE & WALLS IN ACCORDANCE WITH AS3700 EXCEPT

'(FOR PIERS—ISOLATED OR ENGAGED)' IS REMOVED FROM CLAUSE 8.5.1(D); AND WHERE CLAUSE 8.5.1 REQUIRES DESIGN AS FOR UNRFINEORCED MASONRY IN ACCORDANCE WITH SECTION 7, THE MEMBER MUST ALSO BE DESIGNED AS UNREINFORCED MASONRY IN ACCORDANCE WITH TABLE 10.3

AND 4.1(A)(I)(C) OF AS 3700: AND SOIL CLASS A, S, M IN ACCORDANCE WITH AS2870

NOT LOCATED WITHIN ALPINE AREAS

NO EARTHQUAKE AFFECTED DESIGN REQUIREMENTS

MASONARY ACCESSORIES TO BE CONSTRUCTED IN ACCORDANCE WITH:

AS3700 OR AS4773.1 & AS4773.2

PART 5.6 OF HOUSING PROVISIONS OF THE NCC PROVIDED - WIND CLASS N3 OR LESS

- NOT LOCATED WITHIN ALPINE AREAS - NO EARTHQUAKE AFFECTED DESIGN REQUIREMENTS

(DEEMED-TO-SATISFY PROVISION H1D6)

- STEEL FRAMING TO BE CONSTRUCTED IN ACCORDANCE WITH NASH STANDARD RESIDENTIAL AND LOW-RISE STEEL FRAMING PART 1 & 2, STEEL STRUCTURES AS4100 AND/OR COLD-FORMED STEEL STRUCTURES AS/N7S4600 TIMBER FRAMING TO BE CONSTRUCTED IN ACCORDANCE WITH AS1720.1, AS1720.5, AS1684.2 OR AS1684.4, AS1684.3 & AS1860.2

IF WITHIN A CYCLONE AREA A\$1684.3 - STRUCTURAL STEEL SECTIONS TO BE CONSTRUCTED IN ACCORDANCE WITH A\$4100, A\$/NZ\$4600 & PART 6.3 TO 6.3.9 OF ABCB HOUSING PROVISIONS - SOFTWARE IN ACCORDANCE WITH ABCB PROTOCOL FOR STRUCTURAL

SOFTWARE & GEOMETRIC LIMITS, PROGRAMS THAT CONTAIN SIMILAR TABLES TO AS1684 OR NASH STANDARD RESIDENTIAL & LOW-RISE STEEL FRAMING

ROOF AND WALL CLADDING

EEMED-TO SATISFY PROVISION H1D7)

- TERRACOTTA, FIBRE-CEMENT AND TIMBER SLATES AND SHINGLES IN

ACCORDANCE WITH AS4597 - ROOF TILES AS SELECTED TO BE IN ACCORDANCE WITH AS2050 OR PART 7.3 OF THE ABCB HOUSING PROVISIONS, PROVIDED

(A) WIND CLASS NOT MORE THAN N3

(B) COMPLY WWITH AS204; AND (C) ROOF PITCH OF NO LESS THAN 15 DEGREES AND NO MORE THAN 35 DEGREES

- TIMBER AND COMPOSITE WALL CLADDING TO BE IN ACCORDANCE WITH A\$5146.1 FOR AUTOCLAVED AERATED WALL CLADDING OR PART 7.5 OF THE ABCB HOUSING PROVISIONS FOR WALL CLADDING.

METAL WALL CLADDING TO BE IN ACCORDANCE WITH A\$1562.1

EARTHQUAKE AREAS
(DEEMED-TO-SATISFY PROVISION H1D9)
- CLASS 1 & 10 BUILDING TO BE IN ACCORDANCE WITH SECTION 2 OF THE ABCB HOUSING PROVISIONS SUBJECT TO SEISMIC ACTIVITY

FLOOD HAZARD AREAS
(DEEMED-TO-SATISFY PROVISION H1D10)
- CLASS 1 TO BE IN ACCORDANCE WITH ABCB STANDARD FOR CONSTRUCTION OF BUILDINGS IN FLOOD HAZARD AREAS

ATTACHMENT OF FRAMED DECKS AND BALCONIES TO EXTERNAL WALLS OF

BUILDINGS USING THE WALING PLATE (DEEMED-TO-SATISFY PROVISION H1D11)

- ATTACHMENT OF FRAMED DECKS AND BALCONIES TO EXTERNAL WALLS OF BUILDINGS USING A WALING PLATE TO BE IN ACCORDANCE WITH PART 12.3 OF THE ABCB HOUSING PROVISIONS (SUBJECT TO CONDITIONS)

PILED FOOTINGS

(DEEMED-TO-SATISFY PROVISION H1D12)
- PILED FOOTINGS TO BE IN ACCORDANCE WITH AS2159

H2 DAMP & WEATHER PROOFING

(DEEMED-TO-SATISFY H2D2)

- DRAINAGE TO BE IN ACCORDANCE WITHAS/NZS3500.3; OR - PART 3.3 OF THE ABCB HOUSING PROVISIONS FOR ROOFS IN AREAS SUBJECT TO 5 MINUTE DURATION RAINFALL INTENSIFIES OF NOT MORE THAN 255 MM. PER HOUR OVER AN ANNUAL EXCEEDANCE PROBABILITY OF 5% (AS PER TABLE 7.4.3D OF THE ABCB HOUSING PROVISIONS) WHERE A DRAINAGE SYSTEM IS REQUIRED; AND SUB-SOIL AREAS WHERE EXCESSIVE SOIL MOISTURE PROBLEMS MAY OCCUR; AND LAND ADJOINING AND UNDER BUILDINGS.

(DEEMED-TO-SATISFY PROVISION H2D3)

- FOOTINGS & SLABS TO BE PROVIDED IN ACCORDANCE WITH H1D4 (1)(A) OR

MASONARY (DEEMED-TO-SATISFY PROVISION H2D4)

- MASONARY WALLS TO BE PROVIDED IN ACCORDANCE WITH EITHER AS3700, A\$4773.1 & A\$4773.2 OR PART 5.7 OF THE ABCB HOUSING PROVISIONS PROVIDING CONSTRUCTED IN ACCORDANCE WITH H1D5 AND REQUIREMENTS OF PART 5.7

(DEEMED-TO-SATISFY PROVISION H2D5)

- FOUNDATIONS AREAS TO BE PROVIDED WITH ACCESS & SUBFLOOR VENTILATION TO BE IN ACCORDANCE WITH PART 6.2 OF THE ABCB HOUSING

ROOF AND WALL CLADDING

(DEEMED-TO-SATISEY PROVISION H2D6)

GUTTERS & DOWNPIPES TO BE IN ACCORDANCE WITH AS/NZS 3500.3 OR PART 7.4 OF THE ABCB HOUSING PROVISIONS

(DEEMED-TO-SATISEY PROVISION H2D7)

GLAZING TO BE IN ACCORDANCE WITH H1D8(1) OF THE NCC

EXTERNAL WATERPROOFING (DEEMED-TO-SATISFY PROVISION H2D8)

EXTERNAL WATERPROOFING TO BE IN ACCORDANCE WITH A\$4654.1 & A\$4654.2 ALSO APPLICABLE TO ROOFING \$Y\$TEMS WITH H1D7(2) & (3)M TERRACES, RAI CONIES SUSPENDED CONCRETE SLARS & SPACED DECKING IN

FIRE HAZARD PROPERTIES AND NON-COMBUSTIBLE BUILDING ELEMENTS
- HAZARD PROPERTIES AND NON-COMBUSTIBLE BUILDING ELEMENTS TO BE

PROVIDED IN ACCORDANCE WITH H3D2

- FLEXIBLE DUCTWORK USED FOR THE TRANSFER OF PRODUCTS INITIATING FROM A HEAT SOURCE THAT CONTAINS A FLAME MUST COMPLY WITH THE FIRE HAZARD PROPERTIES SET OUT IN AS4254 1

FIRE SEPARATION FROM EXTERNAL WALLS

(DEEMED-TO-SATISFY PROVISION H3D3) - COMPLIANCE WITH PART 9.2 OF THE ABCB HOUSING PROVISIONS

FIRE PROTECTION OF SEPARATION WALLS AND FLOORS

COMPLIANCE WITH PART 9.3 OF THE ABCB HOUSING PROVISIONS

FIRE SEPARATION OF GARAGE-TOP-DWELLINGS

COMPLIANCE WITH PART 9.4 OF THE ABCB HOUSING PROVISIONS

SMOKE ALARMS AND EVACUATION LIGHTING

- COMPLIANCE WITH PART 9.5 OF THE ABCB HOUSING PROVISIONS

H4 HEALTH & AMENITY

WET AREAS WATERPROOFING

(DEEMED-TO-SATISFY PROVISION H4D2)

WET AREAS TO BE PROVIDED IN COMPLIANCE WITH AS3740 OR PART 10.2 OF

MATERIALS AND INSTALLATION OF WET AREA COMPONENTS AND SYSTEMS

(DEEMED-TO-SATISFY PROVISION H4D3)

- MATERIALS AND INSTALLATION OF WET AREA COMPONENTS AND SYSTEMS TO COMPLY WITH EITHER AS3740 AND CLAUSE 10.2.12 OOF THE ABCB HOUSING PROVISIONS OR 10.2.7 TO 10.2.32 OF THE ABCB HOUSING PROVISIONS

ROOM HEIGHTS (DEEMED-TO-SATISEY PROVISION H4D4) ROOM HEIGHTS TO COMPLY WITH PART 10.3 OF THE ABCB HOUSING

(DEEMED-TO-SATISFY PROVISION H4D5)
- FACILITIES TO BE PROVIDED IN ACCORDANCE WITH PART 10.4 OF THE ABCB

HOUSING PROVISIONS

HOUSING PROVISIONS

(DEEMED-TO-SATISFY PROVISION H4D6)
- LIGHT TO BE PROVIDED IN ACCORDANCE WITH PART 10.5 OF THE ABCB

(DEEMED-TO-SATISEY PROVISION H4D7)

MECHANICAL VENTILATION TO COMPLY WITH AS 1668.2 EXCEPT FOR AN EXHAUST FAN FROM A SANITARY COMPARTMENT, LAUNDRY, KITCHEN, OR

- COMPLY WITH PART 10.6 OFF THE ABCB HOUSING PROVISIONS

(DEEMED-TO-SATISEY PROVISION H4D8)

SOUND INSULATION TO BE PROVIDED IN ACCORDANCE WITH PART 10.7 OF THE ABCB HOUSING PROVISIONS

CONDENSATION MANAGEMENT

(DEEMED-TO-SATISEY PROVISION H4D9) SOUND INSULATION TO BE PROVIDED IN ACCORDANCE WITH PART 10.8 OF THE ABCB HOUSING PROVISIONS

H5 SAFE MOVEMENT & ACCESS

STAIRWAY & RAMP CONSTRUCTION

(DEEMED-TO-SATISFY PROVISION H5D2)

STAIRS AND RAMPS TO COMPLY WITRH PART 11.2 OF THE ABCB HOUSING

(DEEMED-TO-SATISEY PROVISION H5D3) BARRIERS AND HANDRAILS TO COMPLY WITH PART 11.3 OF THE ABCB HOUSING



ADDITONAL COMPLIANCE

ALL ASPECTS OF CONSTRUCTION TO BE COMPLIANT WITH RELEVANT PERFORMANCE REQUIREMENTS OF THE NATIONAL CONSTRUCTION CODE AND AUSTRALIAN STANDARDS INCLUDING, BUT NOT LIMITED TO, THE FOLLOWING

GARAGE AND DRIVEWAY PROFILES/GRADES TO COMPLY IN ACCORDANCE WITH AS2890

TERMITE CONTROL MEASURES REDSTOP PIPE PENETRATIONS

VERTICAL ARTICULATION JOINTS

GRANITE GUARD APPLICATION TO PERIMETER WALLS IN ACCORDANCE WITH AS3660.1 CLAUSE 6.59 & 6.60

VERTICAL ARTICULATION JOIUNTS TO COMPLY WITH PART 5.6.8 OF THE ABCB HOUSING PROVISIONS

STAIRS, RAMPS AND BAILISTRADES NOTE:

- STAIRS TO BE CONSTRUCTED IN ACCORDANCE WITH THE REQUIREMENTS OF CLAUSE 11.2.2 OF VOLUME 2 OF THE NCC - FINISHES OF ALL STAIRS TO MEET THE REQUIREMENTS OF CLAUSE 11.2.4 OF VOLUME 2 OF THE NCC - ANY LANDINGS TO MEET THE REQUIREMENTS OF CLAUSE 11.2.5 OF VOLUME 2 OF THE NCC

ANY RAMPS TO BE CONSTRUCTED IN ACCORDANCE WITH CLAUSE 11.2.6 OF VOLUME 2 OF THE NCC THRESHOLDS WILL BE CONSTRUTED IN ACCORDANCE WITH CLAUSE 11.2.6 OF VOLUME 2 OF THE NCC

- STAIRS TO BE SERVICED BY A HANDRAIL IN ACCORDANCE WITH THE REQUIREMENTS OF CLAUSE 11.3.1 TO 11.3.6 OF VOLUME 2 OF THE NCC - THE BALUSTRADES SERVICING THE DWELLING (INTERNAL AND EXTERNAL) TO MEET THE REQUIREMENTS OF CLAUSE 1 VOLUME 2 OF THE NCC

WET AREA FLASHING

TO BE IN ACCORDANCE WITH AS3740 OR PART 10 OF THE ABCB HOUSING PROVISION



CONTACT: 0424 133 547

WEBSITE: WWW.DREAMDRAFTINGSYDNEY.COM.AU



CLIENT NAME:	
MR JAGDISH CHAUDHARI	
PROJECT ADDRESS	LOT DETAILS
1 NERIDAH AVENUE, BELROSE NSW 2085	LOT 1 DP 237377
SHEET TITLE:	PROJECT NUMBER:
NCC 2022 AND AUSTRALIAN STANDARDS COMPLI	IANCE504


DESIGNED BY: DD	DRAWN BY: SS	1
DATE: 03-12-2025	CHECKED BY: DD	
SCALE: 1:100	REVISION: B	
DWG NUMBER: 1.06	LGA: NORTHERN BEACHES	


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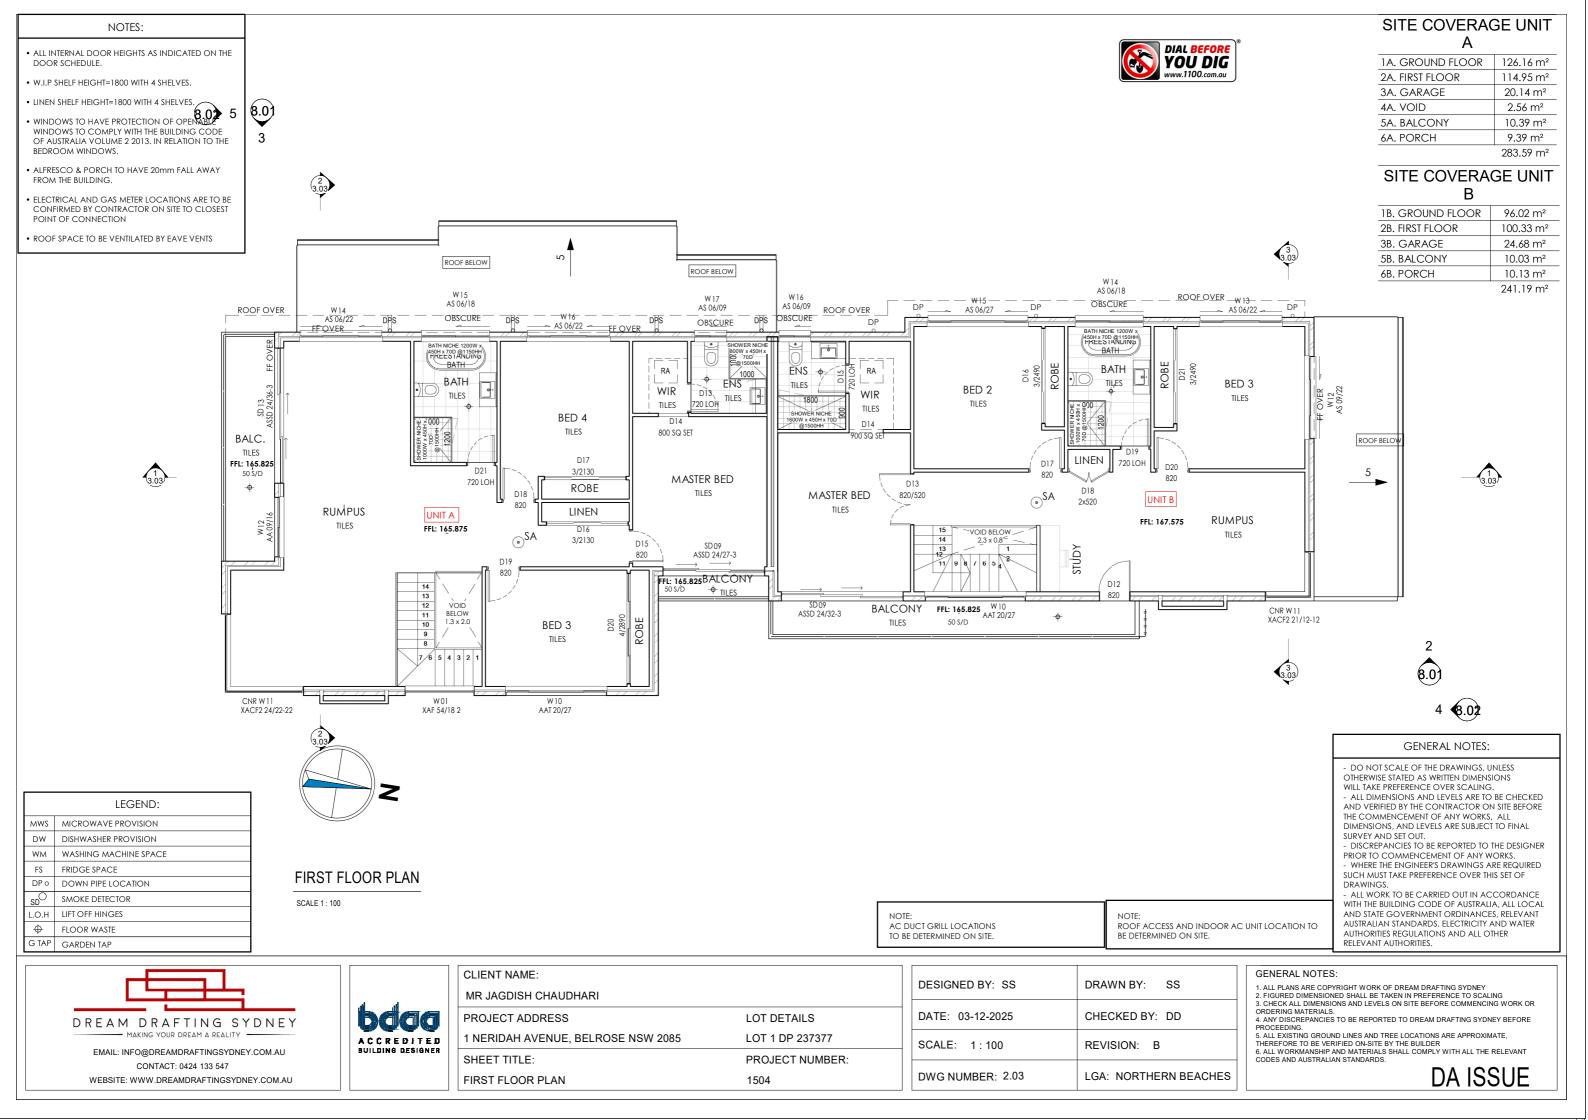
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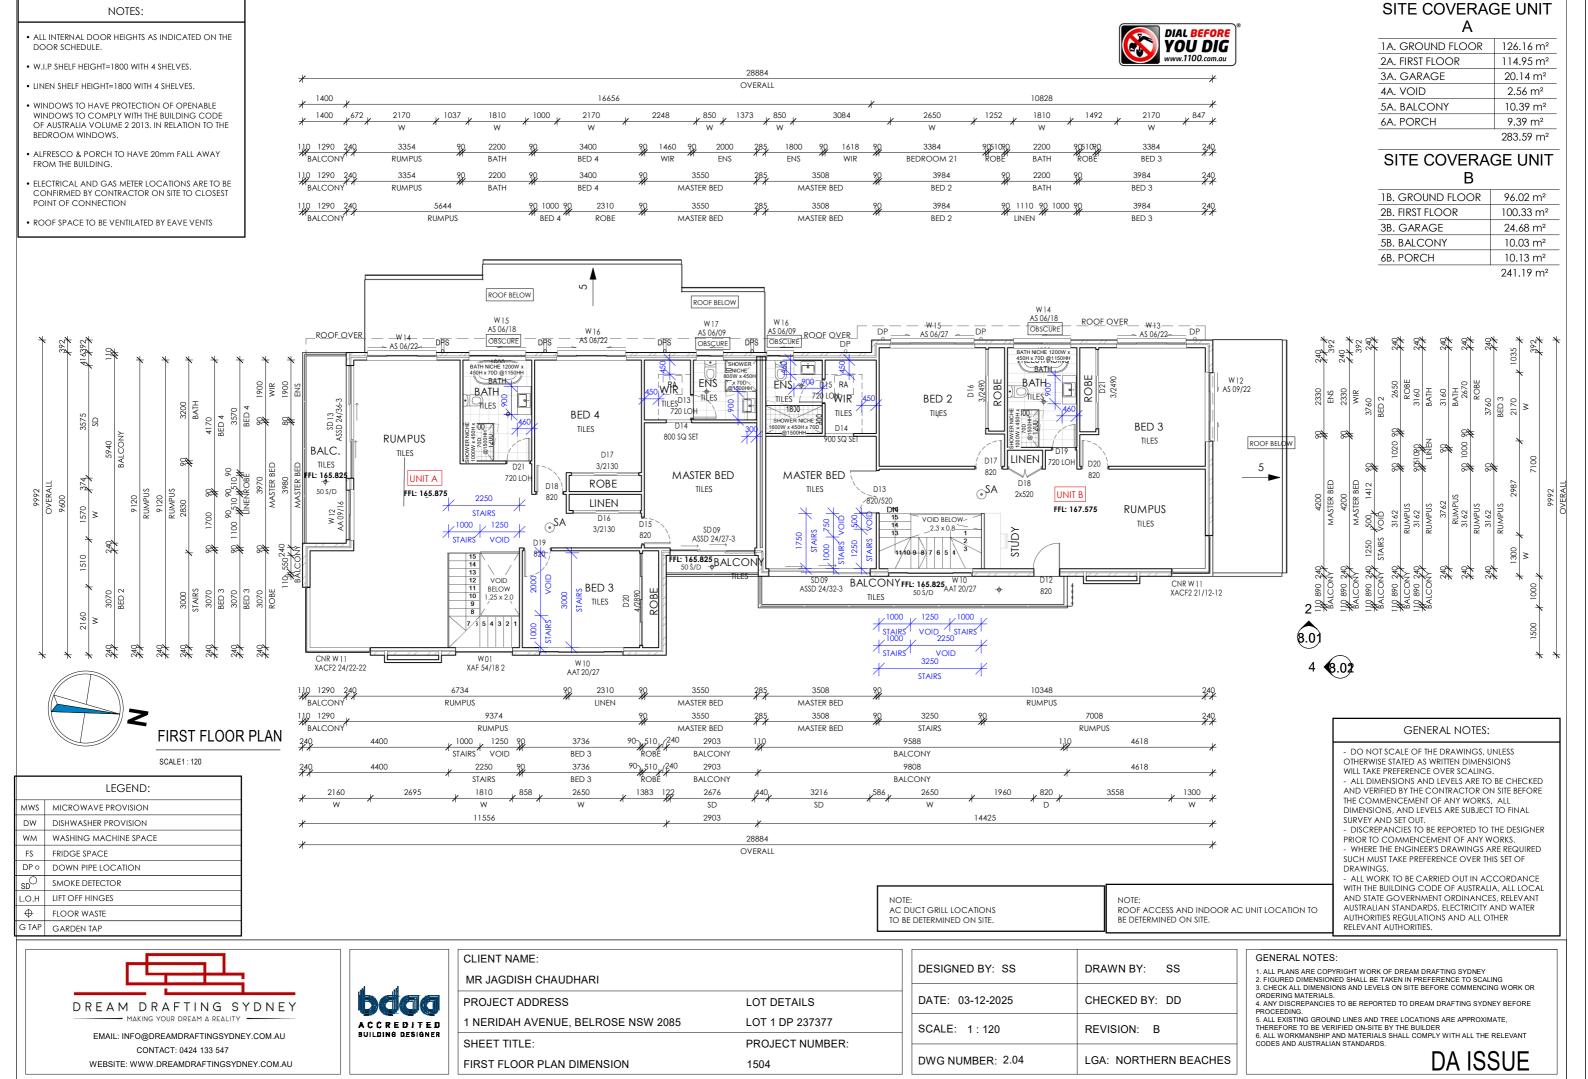
ORDERING MATERIALS. 4. ANY DISCREPANCIES TO BE REPORTED TO DREAM DRAFTING SYDNEY BEFORE ROCEEDING. 5 ALL EXISTING GROUND LINES AND TREE LOCATIONS ARE APPROXIMATE


6. ALL EADSTING GROUND LINES AND TREE LOCATIONS ARE APPROXIMATE, THEREFORE TO BE VERIFIED ON-SITE BY THE BUILDER 6. ALL WORKMANSHIP AND MATERIALS SHALL COMPLY WITH ALL THE RELEVANT CODES AND AUSTRALIAN STANDARDS. **DA ISSUE**






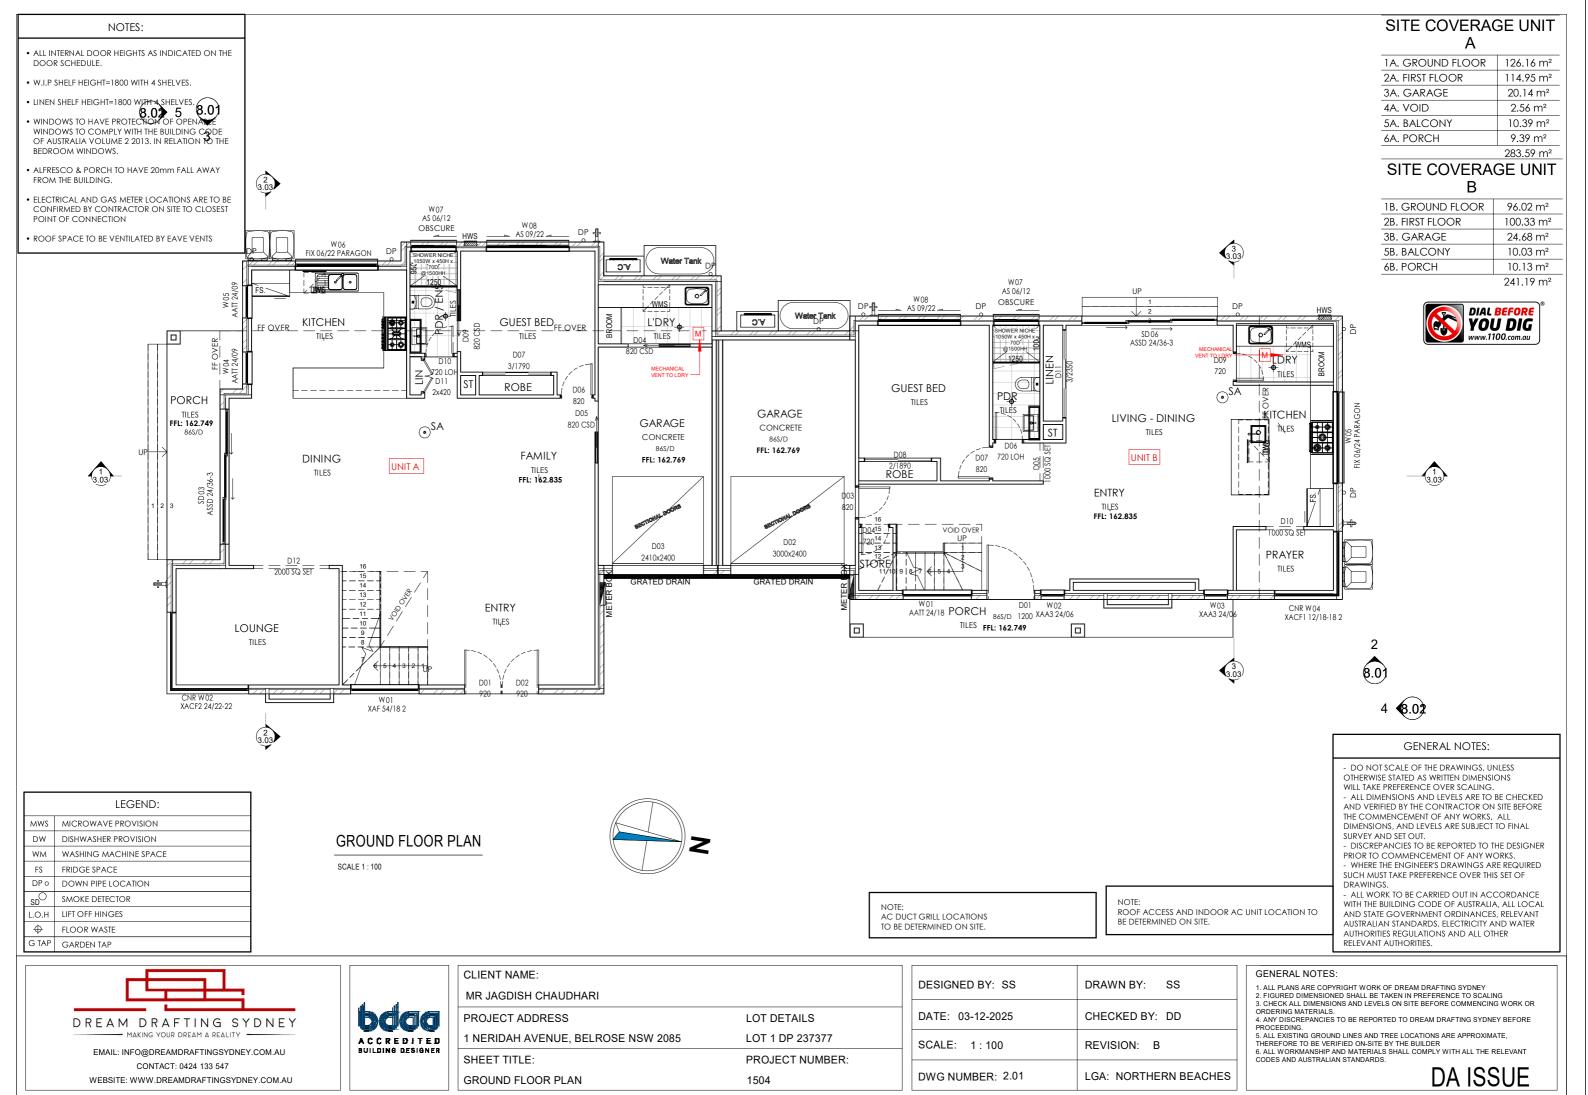

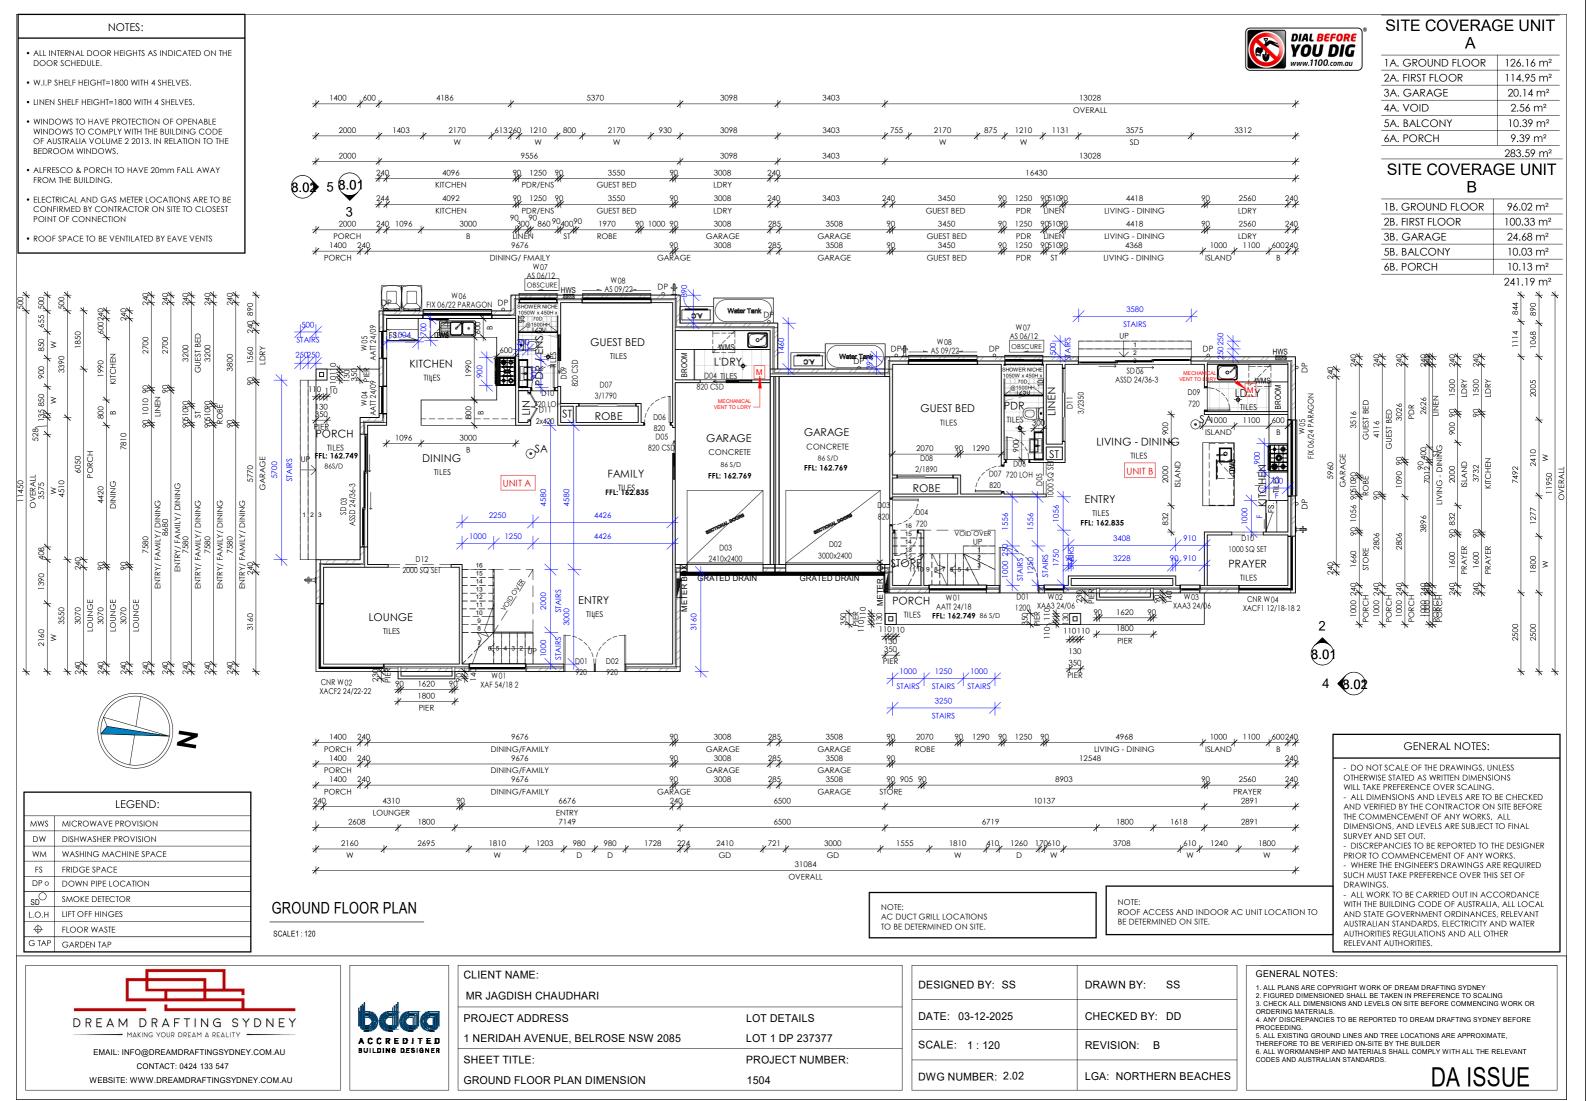

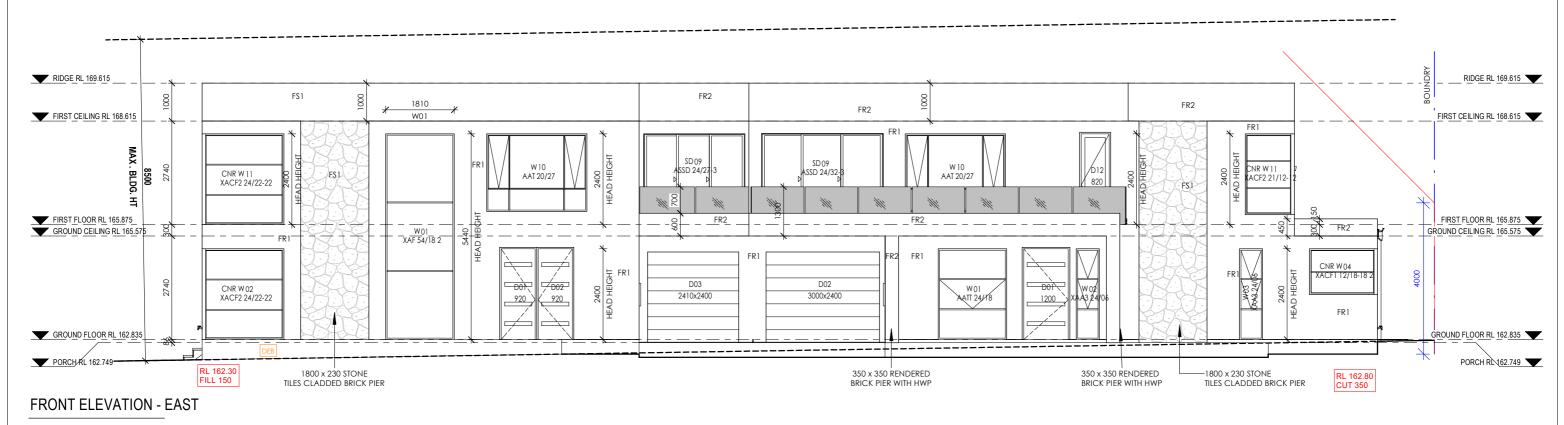

SCALE 1:100

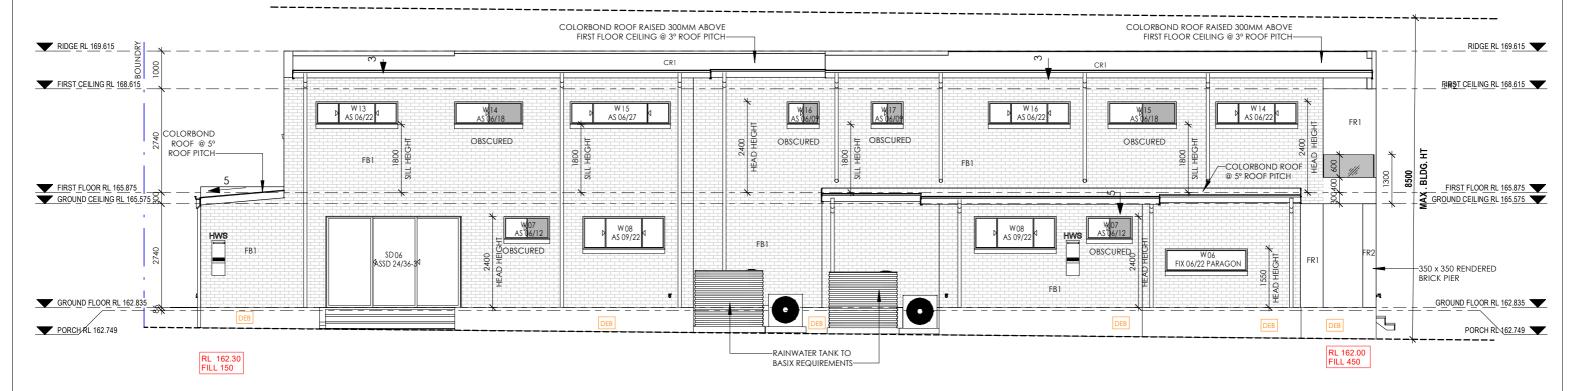

REAR ELEVATION - WEST

SCALE 1:100






CLIENT NAME:	
MR JAGDISH CHAUDHARI	
PROJECT ADDRESS	LOT DETAILS
1 NERIDAH AVENUE, BELROSE NSW 2085	LOT 1 DP 237377
SHEET TITLE:	PROJECT NUMBER:
ELEVATIONS & MATERIALS/FINISHES	1504

DESIGNED BY: DD	DRAWN BY: DD
DATE: 03-12-2025	CHECKED BY: DD
SCALE: 1:100	REVISION: B
DWG NUMBER: 3.01	LGA: NORTHERN BEACHES

- 1. ALL PLANS ARE COPYRIGHT WORK OF DREAM DRAFTING SYDNEY
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 3. CHECK ALL DIMENSIONS AND LEVELS ON SITE BEFORE COMMENCING WORK OR ORDERING MATERIALS.
 4. ANY DISCREPANCIES TO BE REPORTED TO DREAM DRAFTING SYDNEY BEFORE PROCEEDING.

- 5. ALL EXISTING GROUND LINES AND TREE LOCATIONS ARE APPROXIMATE, HEREFORE TO BE VERIFIED ON-SITE BY THE BUILDER 6. ALL WORKMANSHIP AND MATERIALS SHALL COMPLY WITH ALL THE RELEVANT CODES AND AUSTRALIAN STANDARDS.

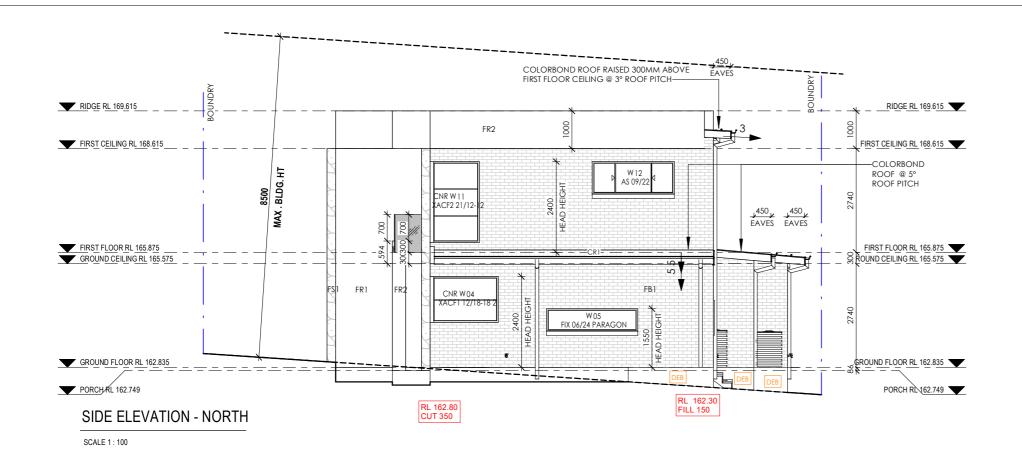

COLORBOND ROOF RAISED 300MM ABOVE FIRST FLOOR CEILING @ 3° ROOF PITCH——— RIDGE RL 169.615 RIDGE RL 169.615 FR2 FIRST CEILING RL 168.615 FIRST CEILING RL 168.615 COLORBOND ROOF @ 5° ROOF PITCH-CNR W 1 1 XACF2 24/22-22 SD 13 8500 . BLDG. FIRST FLOOR RL 165.875
GROUND CEILING RL 165.575 FR1_ FIRST FLOOR RL 165.875 GROUND CEILING RL 165.575 FR1 SD 03 W 04/ CNR W02 XACF2 24/22-22 GROUND FLOOR RL 162.835 GROUND FLOOR RL 162.835 PORCH RL 162.749 PORCH RL 162.749 RL 162.30 FILL 150 RL 162.00 FILL 450

SIDE ELEVATION - SOUTH

SCALE 1:100

DREAM DRAFTING SYDNEY MAKING YOUR DREAM A REALITY
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CONTACT: 0424 133 547
WEBSITE: WWW.DREAMDRAFTINGSYDNEY.COM.AU



CLIENT NAME:	
MR JAGDISH CHAUDHARI	
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SHEET TITLE:	PROJECT NUMBER:
ELEVATIONS & MATERIALS/FINISHES	1504

DESIGNED BY: DD	DRAWN BY: SS
DATE: 03-12-2025	CHECKED BY: DD
SCALE: 1:100	REVISION: B
DWG NUMBER: 3.02	LGA: NORTHERN BEACHES

FBI AUSTRAL BRICKS MORTAR: DARK JOINT - COVE	warmed stone Or Similar	
FEATURE RENDER: FRI	LEXICON HALF OR SIMILAR	
FEATURE RENDER: FR2	MONUMENT OR SIMILAR	
FEATURE STONE: FS1	STONE TILES OR SIMILAR	員
ROOF COVERING: CR1 COLORBOND	WINDSPRAY OR SIMILAR	
GARAGE DOOR: B & D SIMILAR SECTIONAL PROFILE	MONUMENT OR SIMILAR	
GUTTER, FASCIA & DOWNPIPES: COLORBOND	WINDSPRAY OR SIMILAR	
WINDOW & SLIDING DOORS: ALUMINIUM POWDERCOATED	BLACK OR SIMILAR	
FRONT DOOR: PMAD104 1200W	monument or Similar	
FRONT DOOR: PMAD104 2 X 920W	MONUMENT OR SIMILAR	
DRIVEWAY: COLOURED CONCRETE DRIVEWAY BROOM FINISH	GREY	
FENCE: 1.8m COLORBOND FENCE	WINDSPRAY OR SIMILAR	

SCHEDULE OF EXTERNAL FINISHES

DESCRIPTION

IMAGE REFERENCE


ITEM

EXTERNAL BRICK WALLS:

GENERAL NOTES:

- GENERAL NOTES.

 1. ALL PLANS ARE COPYRIGHT WORK OF DREAM DRAFTING SYDNEY
 2. FIGURED DIMENSIONED SHALL BE TAKEN IN PREFERENCE TO SCALING
 3. CHECK ALL DIMENSIONS AND LEVELS ON SITE BEFORE COMMENCING WORK OR ORDERING MATERIALS.
 4. ANY DISCREPANCIES TO BE REPORTED TO DREAM DRAFTING SYDNEY BEFORE PROCEEDING.
 5. ALL EXISTING GROUND LINES AND TREE LOCATIONS ARE APPROXIMATE, THEREFORE TO BE VERIFIED ON-SITE BY THE BUILDER
 6. ALL WORKMANSHIP AND MATERIALS SHALL COMPLY WITH ALL THE RELEVANT CODES AND AUSTRALIAN STANDARDS.

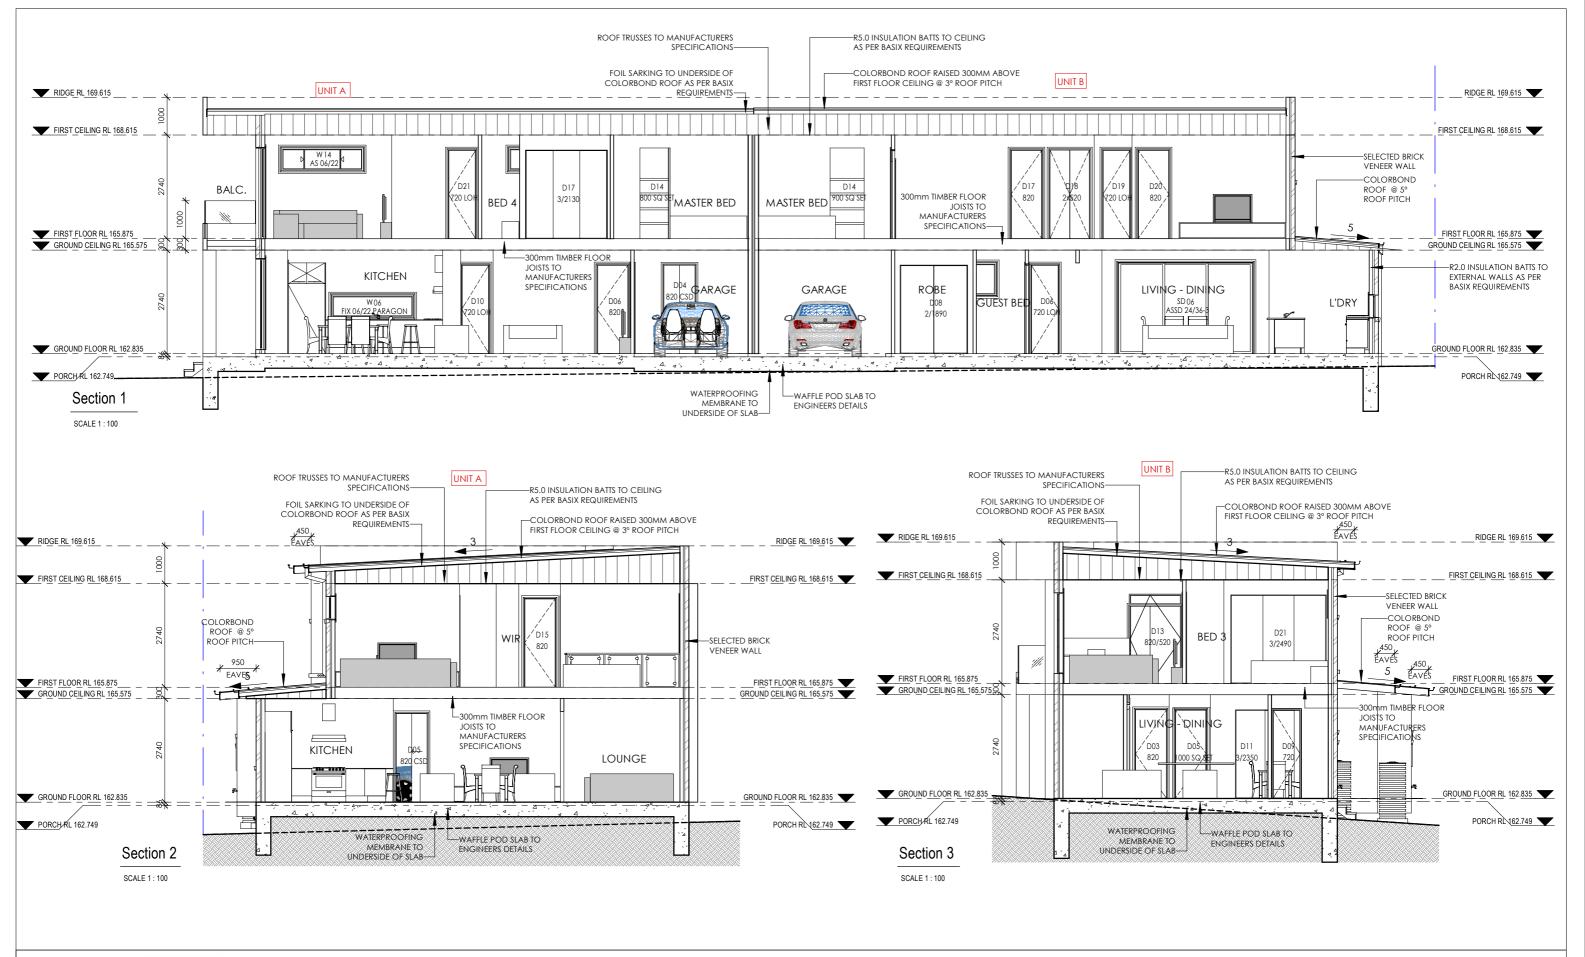





CLIENT NAME:	
MR JAGDISH CHAUDHARI	
PROJECT ADDRESS	LOT DETAILS
1 NERIDAH AVENUE, BELROSE NSW 2085	LOT 1 DP 237377
SHEET TITLE:	PROJECT NUMBER:
SECTIONS	1504

DESIGNED BY: DD	DRAWN BY: SS
DATE: 03-12-2025	CHECKED BY: DD
SCALE: 1:100	REVISION: B
DWG NUMBER: 3.03	LGA: NORTHERN BEACHES

SENERAL NOTES:

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 3. CHECK ALL DIMENSIONS AND LEVELS ON SITE BEFORE COMMENCING WORK OR
 ROBERING MATERIALS.
 4. ANY DISCREPANCIES TO BE REPORTED TO DREAM DRAFTING SYDNEY BEFORE
- ROCEEDING.
- ROCEEUINS.
 ALL EXISTING GROUND LINES AND TREE LOCATIONS ARE APPROXIMATE,
 HEREFORE TO BE VERIFIED ON-SITE BY THE BUILDER
 ALL WORKMANSHIP AND MATERIALS SHALL COMPLY WITH ALL THE RELEVANT
 ODES AND AUSTRALIAN STANDARDS.
 - **DA ISSUE**

DOOR SCHEDULE UNIT A					
MARK	HEIGHT	WIDTH	DESCRIPTION		
01	2400	920	PMAD104 ENTRY DOOR		
02	2400	920	PMAD104 ENTRY DOOR		
03	2400	2410	PANELIFT GARAGE DOOR		
04	2340	820	CAVITY SLIDING DOOR		
05	2340	820	CAVITY SLIDING DOOR		
06	2340	820	FLUSH PANEL		
07	2340	1790	SLIDING ROBE DOOR		
09	2340	820	CAVITY SLIDING DOOR		
10	2340	720	FLUSH PANEL LOH		
11	2340	420	FLUSH PANEL		
12	2400	2000	SQUARE SET OPENING		
13	2340	720	FLUSH PANEL LOH		
14	2400	800	SQUARE SET OPENING		
15	2340	820	FLUSH PANEL		
16	2340	2130	SLIDING ROBE DOOR		
17	2340	2130	SLIDING ROBE DOOR		
18	2340	820	FLUSH PANEL		
19	2340	820	FLUSH PANEL		
20	2340	2890	SLIDING ROBE DOOR		
21	2340	720	FLUSH PANEL LOH		

DOOR SCHEDULE UNIT B					
MARK	HEIGHT	WIDTH	DESCRIPTION		
01	2400	1200	PANELIFT GARAGE DOOR		
02	2400	3000	PANELIFT GARAGE DOOR		
03	2340	820	FLUSH PANEL		
04	2340	720	FLUSH PANEL		
05	2400	1000	SQUARE SET OPENING		
06	2340	720	FLUSH PANEL LOH		
07	2340	820	FLUSH PANEL LOH		
08	2340	1750	SLIDING ROBE DOOR		
09	2340	720	FLUSH PANEL		
10	2400	1000	SQUARE SET OPENING		
11	2340	2300	SLIDING ROBE DOOR		
12	2400	820	EXTERNAL FLUSH PANEL		
13	2340	1350	FLUSH PANEL		
14	2400	900	SQUARE SET OPENING		
15	2340	720	FLUSH PANEL LOH		
16	2340	2490	SLIDING ROBE DOOR		
17	2340	820	FLUSH PANEL		
18	2340	520	DOUBLE FLUSH PANEL		
19	2340	720	FLUSH PANEL LOH		
20	2340	820	FLUSH PANEL		
21	2340	2490	FLUSH PANEL		

WINDOW & SLIDING DOOR SCHEDULE UNIT A						
MARK	CODE	STYLE	HEIGHT	WIDTH	FRAME TYPE	GLAZING
01	XAF 54/18 2	DESIGNER FIXED	5440	1810	POWDER COATED ALUMINIUM	SINGLE CLEAR
02	XACF2 24/22-22	DESIGN FIXED CORNER	2400	2160	POWDER COATED ALUMINIUM	SINGLE CLEAR
03	ASSD 24/36-3	STACKING	2410	3575	POWDER COATED ALUMINIUM	SINGLE CLEAR
04	AATT 24/09	AWNING WINDOW	2400	850	POWDER COATED ALUMINIUM	SINGLE CLEAR
05	AATT 24/09	AWNING WINDOW	2400	850	POWDER COATED ALUMINIUM	SINGLE CLEAR
06	FIX 06/22 PARAGON	PARAGON	600	2170	POWDER COATED ALUMINIUM	SINGLE CLEAR
07	AS 06/12	SLIDING	600	1210	POWDER COATED ALUMINIUM	OBSCURE
08	AS 09/22	SLIDING	860	2170	POWDER COATED ALUMINIUM	SINGLE CLEAR
09	ASSD 24/27-3	STACKING	2410	2676	POWDER COATED ALUMINIUM	SINGLE CLEAR
10	AAT 20/27	AWNING	2050	2650	POWDER COATED ALUMINIUM	SINGLE CLEAR
11	XACF2 24/22-22	DESIGN FIXED CORNER	2400	2160	POWDER COATED ALUMINIUM	SINGLE CLEAR
12	AA 09/16	AWNING	860	1570	POWDER COATED ALUMINIUM	SINGLE CLEAR
13	ASSD 24/36-3	STACKING	2410	3575	POWDER COATED ALUMINIUM	SINGLE CLEAR
14	AS 06/22	SLIDING	600	2170	POWDER COATED ALUMINIUM	SINGLE CLEAR
15	AS 06/18	SLIDING	600	1810	POWDER COATED ALUMINIUM	OBSCURE
16	AS 06/22	SLIDING	600	2170	POWDER COATED ALUMINIUM	SINGLE CLEAR
17	AS 06/09	SLIDING	600	850	POWDER COATED ALUMINIUM	OBSCURE

WINDOW & SLIDING DOOR SCHEDULE UNIT B						
MARK	CODE	STYLE	HEIGHT	WIDTH	FRAME TYPE	GLAZING
01	AATT 24/18	AWNING WINDOW	2400	1810	POWDER COATED ALUMINIUM	SINGLE CLEAR
02	XAA3 24/06	DESIGNER AWNING	2400	610	POWDER COATED ALUMINIUM	SINGLE CLEAR
03	XAA3 24/06	DESIGNER AWNING	2400	610	POWDER COATED ALUMINIUM	SINGLE CLEAR
04	XACF1 12/18-18 2	DESIGN FIXED CORNER	1210	1800	POWDER COATED ALUMINIUM	SINGLE CLEAR
05	FIX 06/24 PARAGON	PARAGON	600	2410	POWDER COATED ALUMINIUM	SINGLE CLEAR
06	ASSD 24/36-3	STACKING	2410	3575	POWDER COATED ALUMINIUM	SINGLE CLEAR
07	AS 06/12	SLIDING	600	1210	POWDER COATED ALUMINIUM	OBSCURE
08	AS 09/22	SLIDING	860	2170	POWDER COATED ALUMINIUM	SINGLE CLEAR
09	ASSD 24/32-3	STACKING	2410	3216	POWDER COATED ALUMINIUM	SINGLE CLEAR
10	AAT 20/27	AWNING	2050	2650	POWDER COATED ALUMINIUM	SINGLE CLEAR
11	XACF2 21/12-12	DESIGN FIXED CORNER	2140	1300	POWDER COATED ALUMINIUM	SINGLE CLEAR
12	AS 09/22	SLIDING	860	2170	POWDER COATED ALUMINIUM	SINGLE CLEAR
13	AS 06/22	SLIDING	600	2170	POWDER COATED ALUMINIUM	SINGLE CLEAR
14	AS 06/18	SLIDING	600	1810	POWDER COATED ALUMINIUM	OBSCURE
15	AS 06/27	SLIDING	600	2650	POWDER COATED ALUMINIUM	SINGLE CLEAR
16	AS 06/09	SLIDING	600	850	POWDER COATED ALUMINIUM	OBSCURE



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CLIENT NAME:	
MR JAGDISH CHAUDHARI	
PROJECT ADDRESS	LOT DETAILS
1 NERIDAH AVENUE, BELROSE NSW 2085	LOT 1 DP 237377
SHEET TITLE:	PROJECT NUMBER:
DOOR WINDOW SCHEDULE & BASIX COMMITMENTS	1504

DESIGNED BY: DD	DRAWN BY: DD	1.
DATE: 03-12-2025	CHECKED BY: DD	3. O 4.
SCALE:	REVISION: B	5. TI 6.
DWG NUMBER: 4.01	LGA: NORTHERN BEACHES	


- GENERAL NOTES.


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UNIT A ROOF SCHEDULE				
MARK	AREA	ROOF TYPE		
ROOF A	31.35 m²	SELECTED COLORBOND ROOF		
ROOF B	135.87 m²	SELECTED COLORBOND ROOF		
TOTAL	167.23 m²			

	UNIT B ROC	OF SCHEDULE
MARK	AREA	ROOF TYPE
ROOF A	16.30 m²	SELECTED COLORBOND ROOF
ROOF B	118.46 m²	SELECTED COLORBOND ROOF
TOTAL	134.76 m ²	





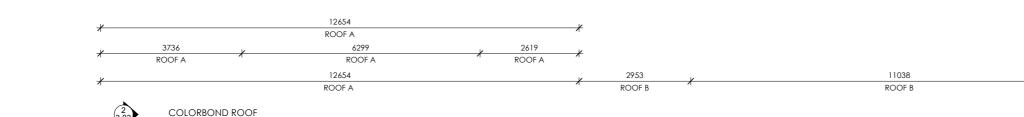
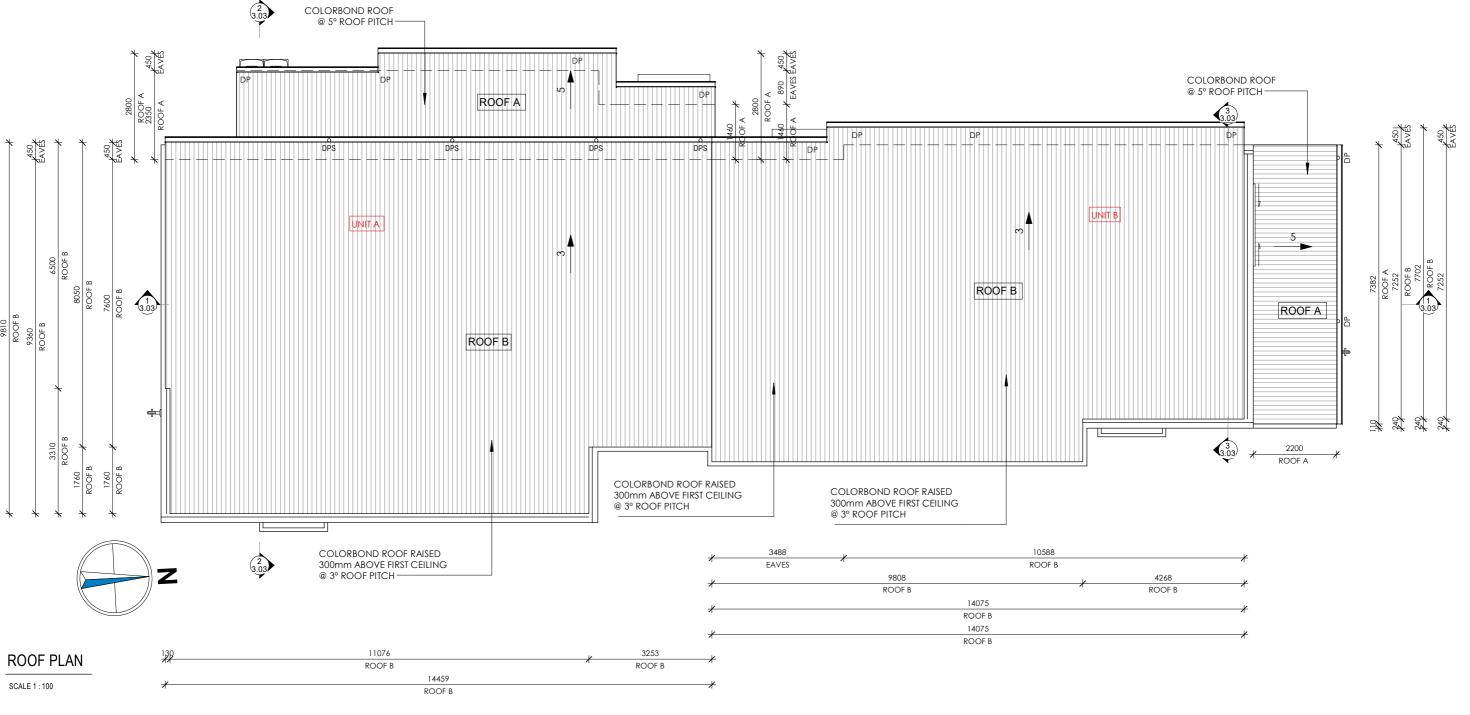
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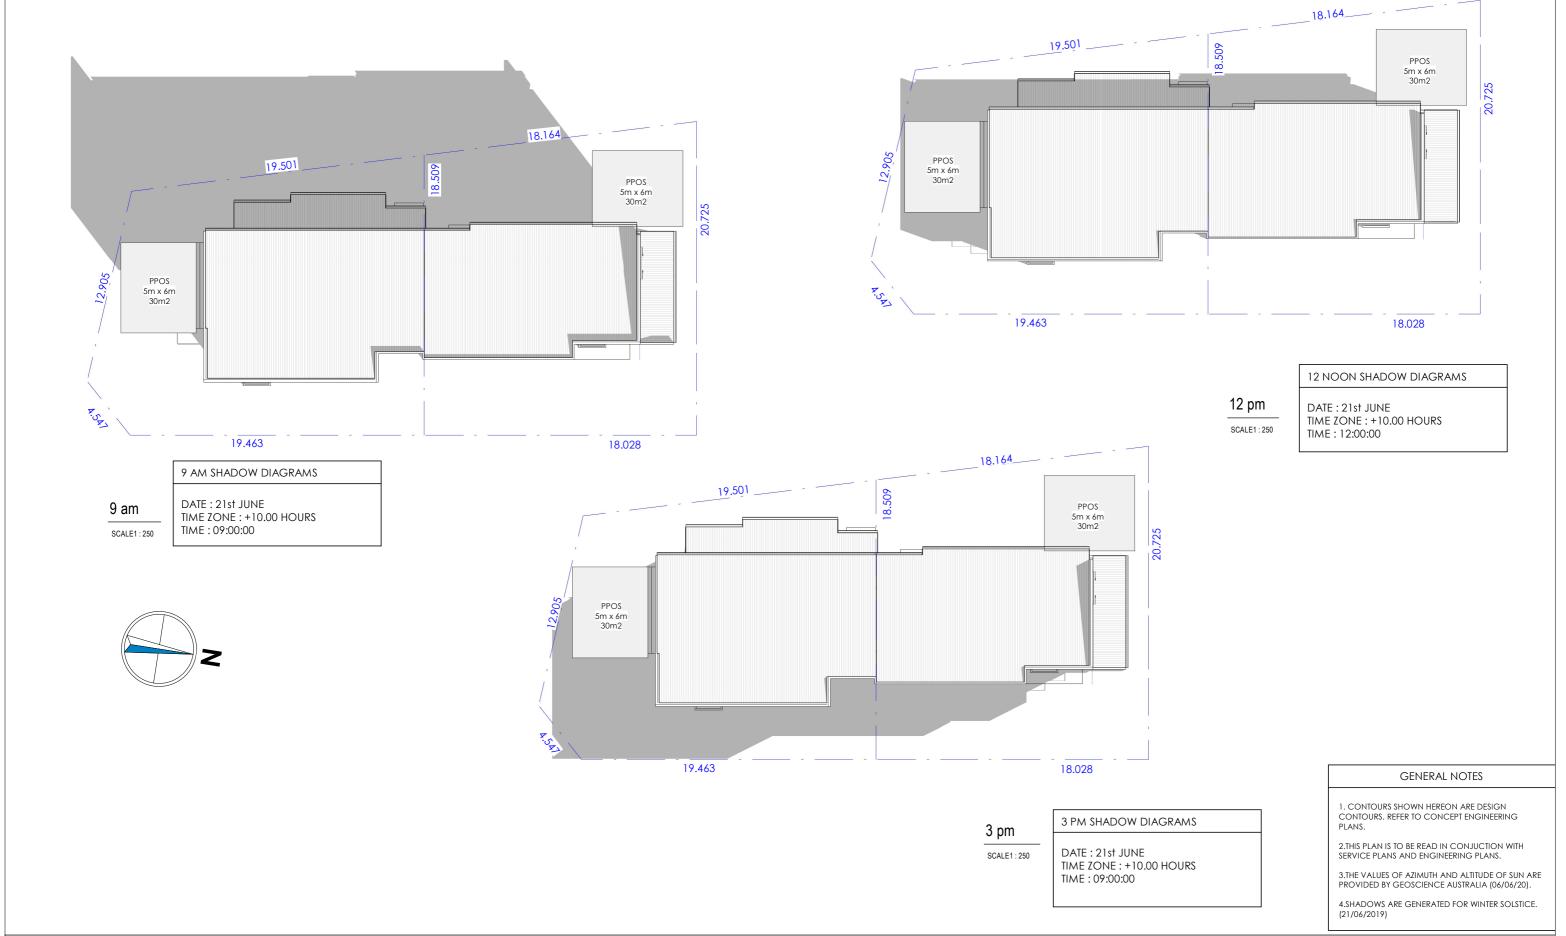
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PROJECT ADDRESS	LOT DETAILS
1 NERIDAH AVENUE, BELROSE NSW 2085	LOT 1 DP 237377
SHEET TITLE:	PROJECT NUMBER:
ROOF PLAN	1504

DESIGNED BY: DD	DRAWN BY: DD
DATE: 03-12-2025	CHECKED BY: DD
SCALE: 1:100	REVISION: B
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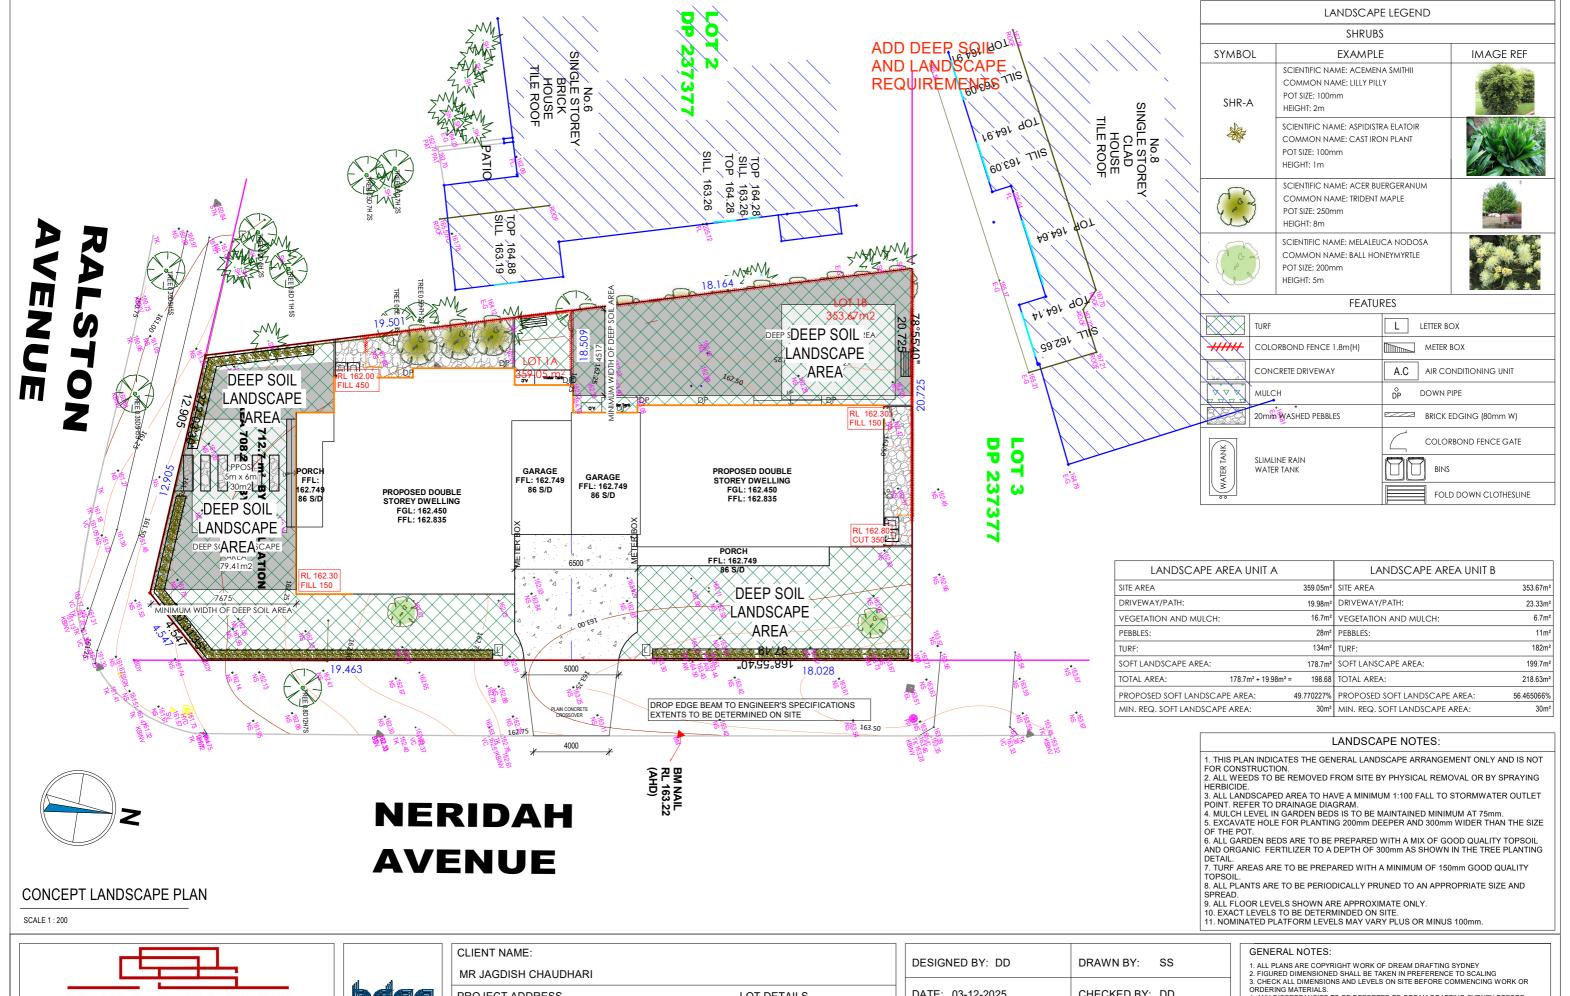
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MR JAGDISH CHAUDHARI	
PROJECT ADDRESS	LOT DETAILS
1 NERIDAH AVENUE, BELROSE NSW 2085	LOT 1 DP 237377
SHEET TITLE:	PROJECT NUMBER:
SHADOW DIAGRAMS	1504

DESIGNED BY: DD	DRAWN BY: SS	1
DATE: 03-12-2025	CHECKED BY: DD	(4
SCALE: 1:250	REVISION: B	1
DWG NUMBER: 6.01	LGA: NORTHERN BEACHES	,

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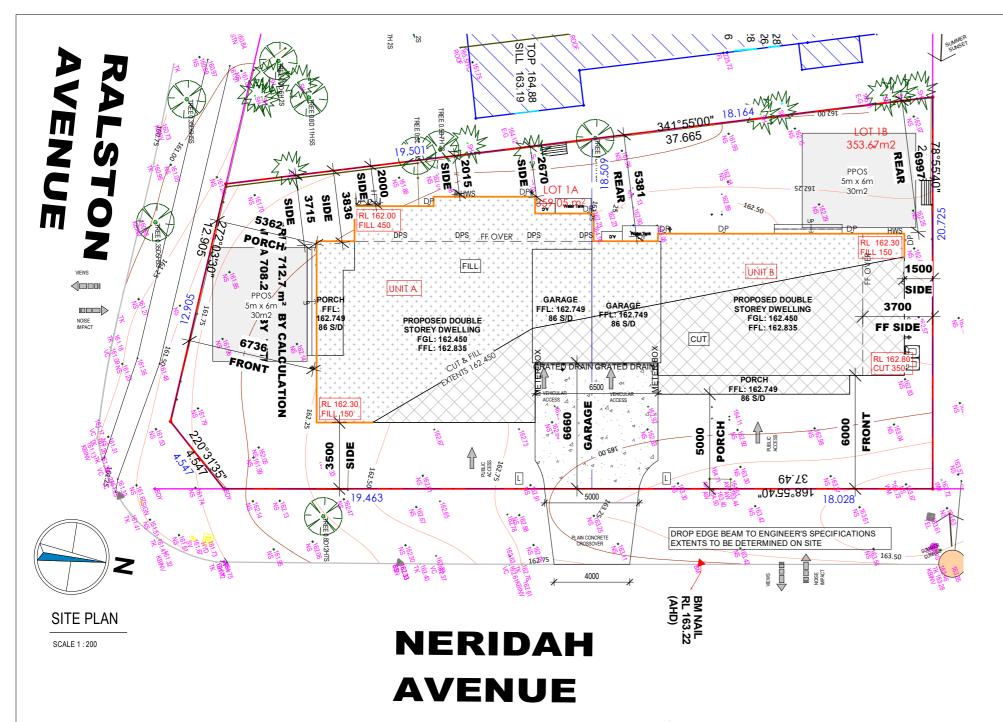



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PROJECT ADDRESS	LOT DETAILS
1 NERIDAH AVENUE, BELROSE NSW 2085	LOT 1 DP 237377
SHEET TITLE:	PROJECT NUMBER:
LANDSCAPE PLAN	1504

DESIGNED BY: DD	DRAWN BY: SS	
DATE: 03-12-2025	CHECKED BY: DD	
SCALE: 1:200	REVISION: B	
DWG NUMBER: 7.01	LGA: NORTHERN BEACHES	

- 4. ANY DISCREPANCIES TO BE REPORTED TO DREAM DRAFTING SYDNEY BEFORE
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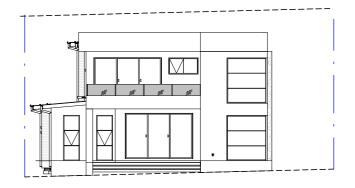
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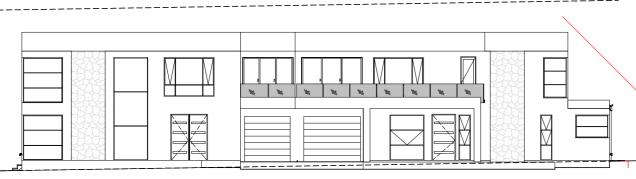


N SIDE ELEVATION - NORTH

SCALE 1:200

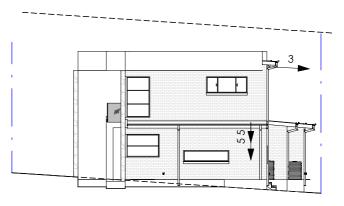

N SIDE ELEVATION - SOUTH



N FRONT ELEVATION - EAST

SCALE 1:200



N REAR ELEVATION - WEST

SCALE 1:200



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(CLIENT NAME:	
	MR JAGDISH CHAUDHARI	
F	PROJECT ADDRESS	LOT DETAILS
Ĺ	1 NERIDAH AVENUE, BELROSE NSW 2085	LOT 1 DP 237377
5	SHEET TITLE:	PROJECT NUMBER:
1	NOTIFICATION PLANS	1504

DESIGNED BY: DD	DRAWN BY: SS
DATE: 03-12-2025	CHECKED BY: DD
SCALE: 1:200	REVISION: B
DWG NUMBER: 8.01	LGA: NORTHERN BEACHES

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