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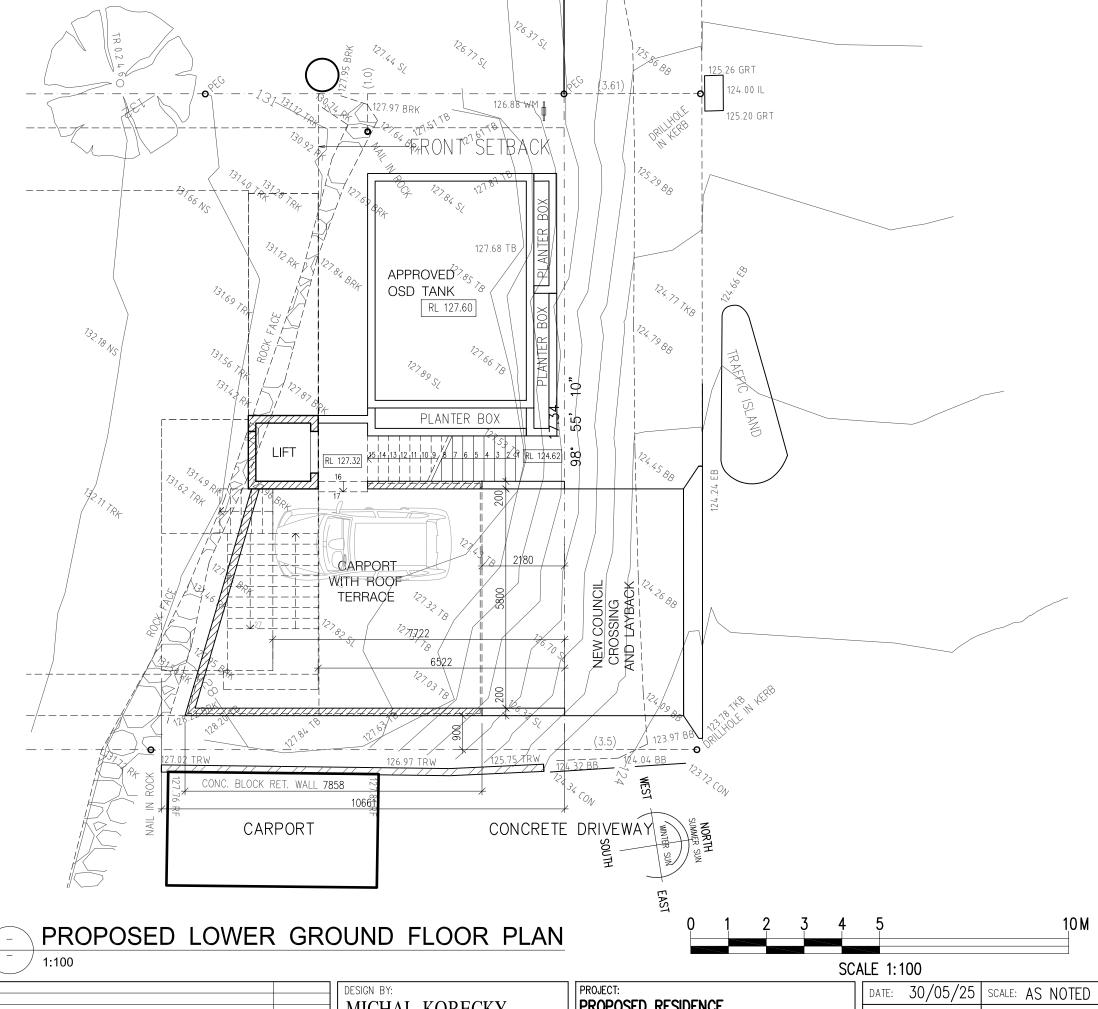
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21 NALYA ROAD, NARRAWEENA NSW 2099 ABN: 79 393 130 294 Email: koreckym@gmail.com Mob: 0438 148 944

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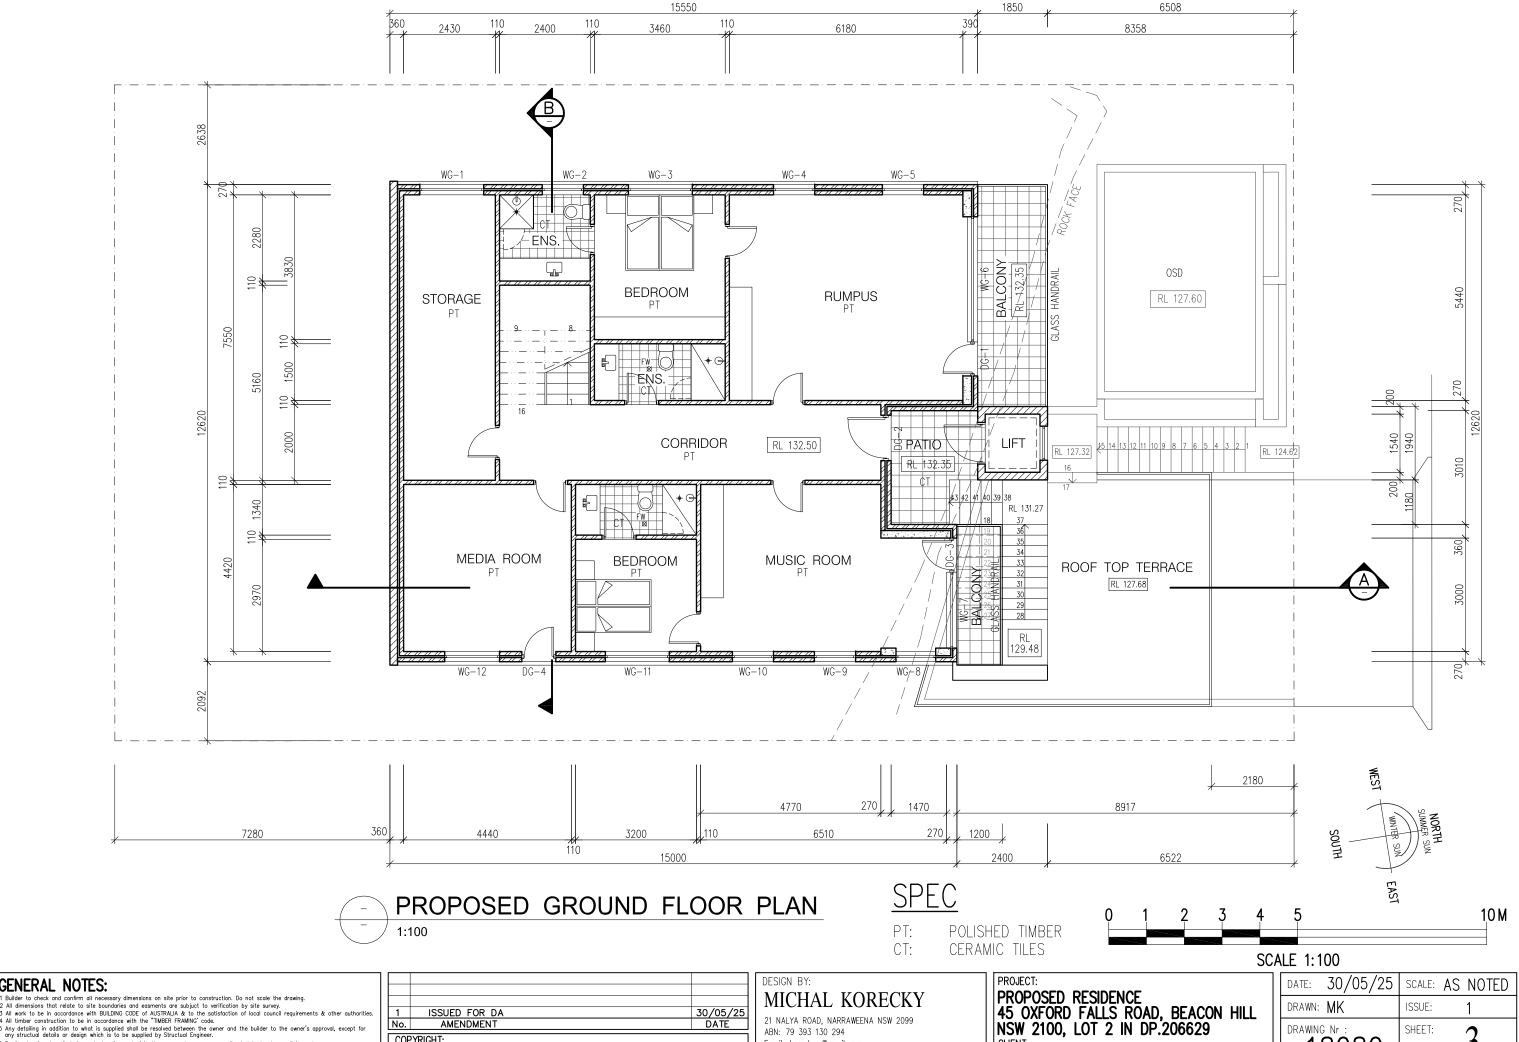
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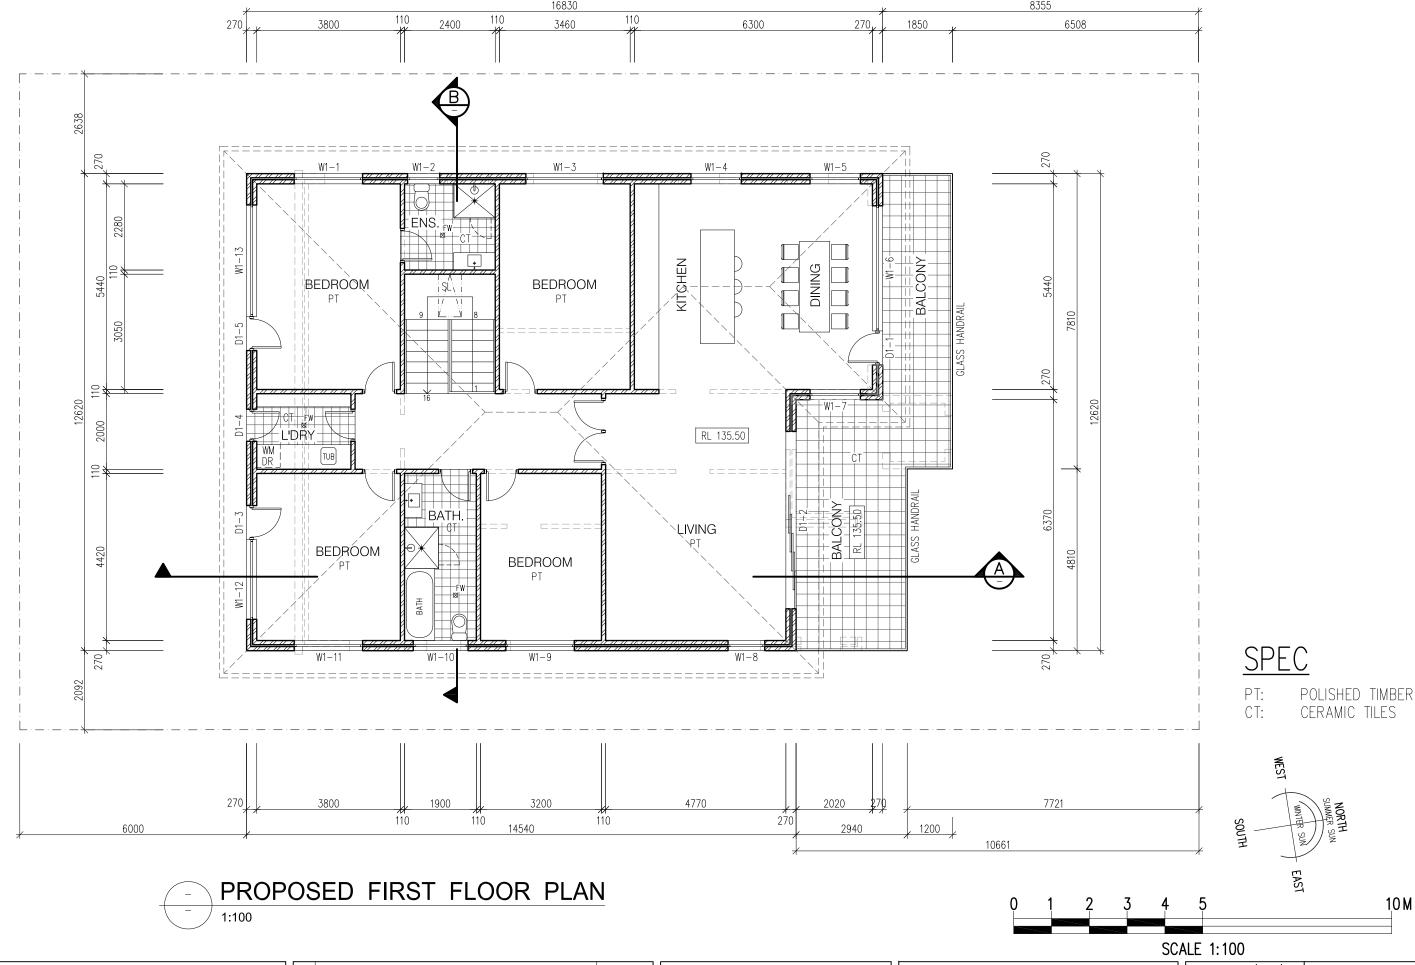
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PROPOSED RESIDENCE 45 OXFORD FALLS ROAD, BEACON HILL NSW 2100, LOT 2 IN DP.206629 JIRI AND MARCELA ALBRECHT

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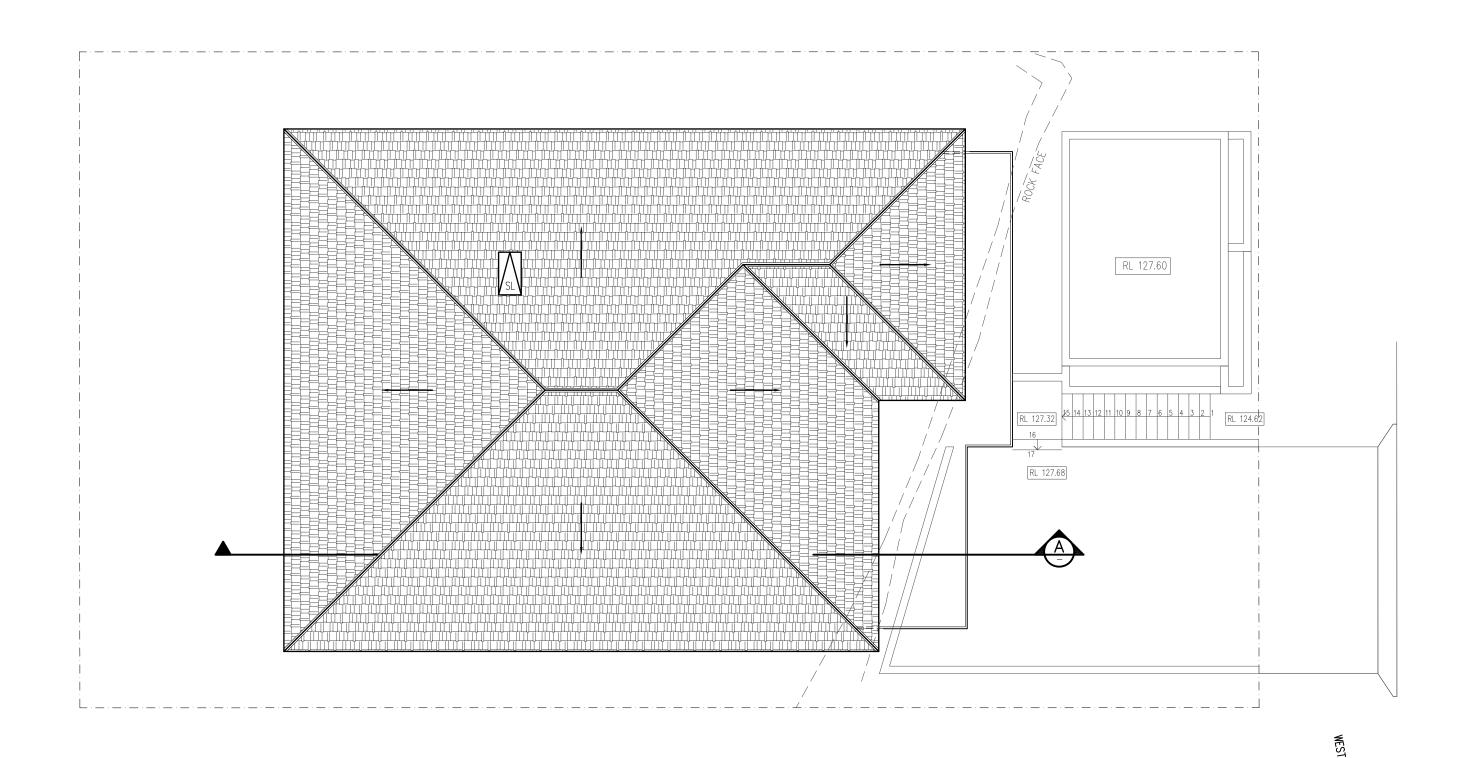
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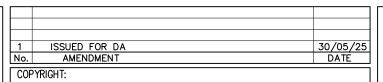
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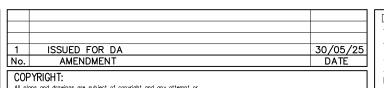


PROPOSED NORTH ELEVATION

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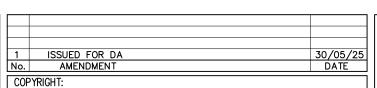
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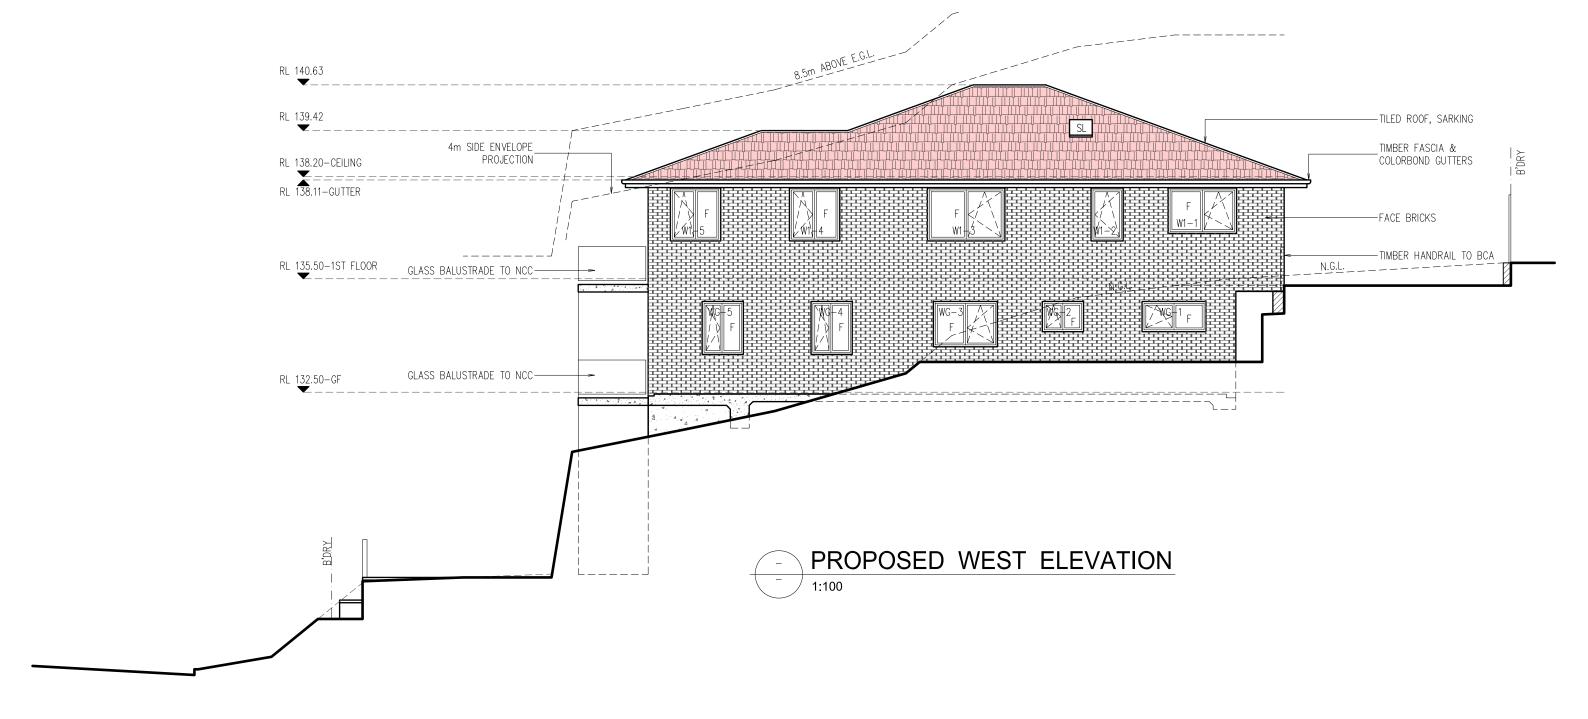
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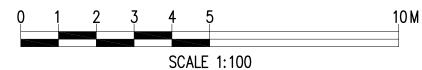
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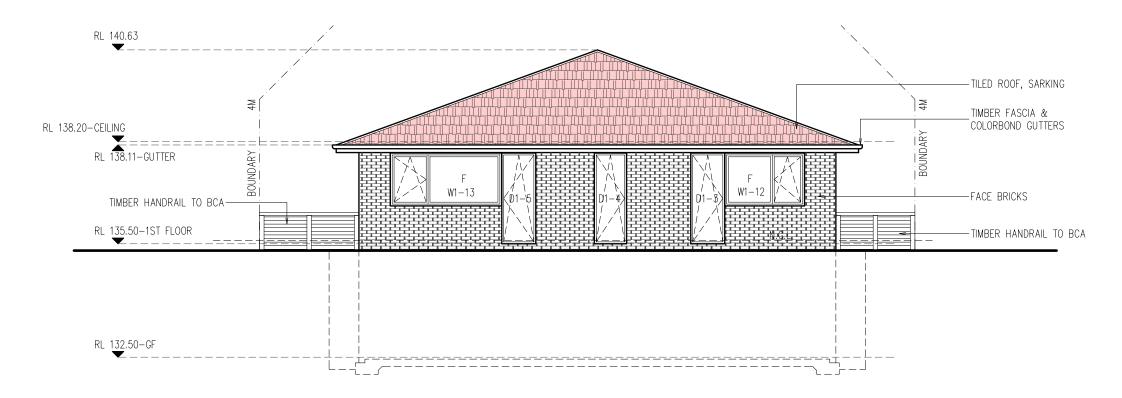


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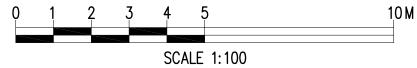
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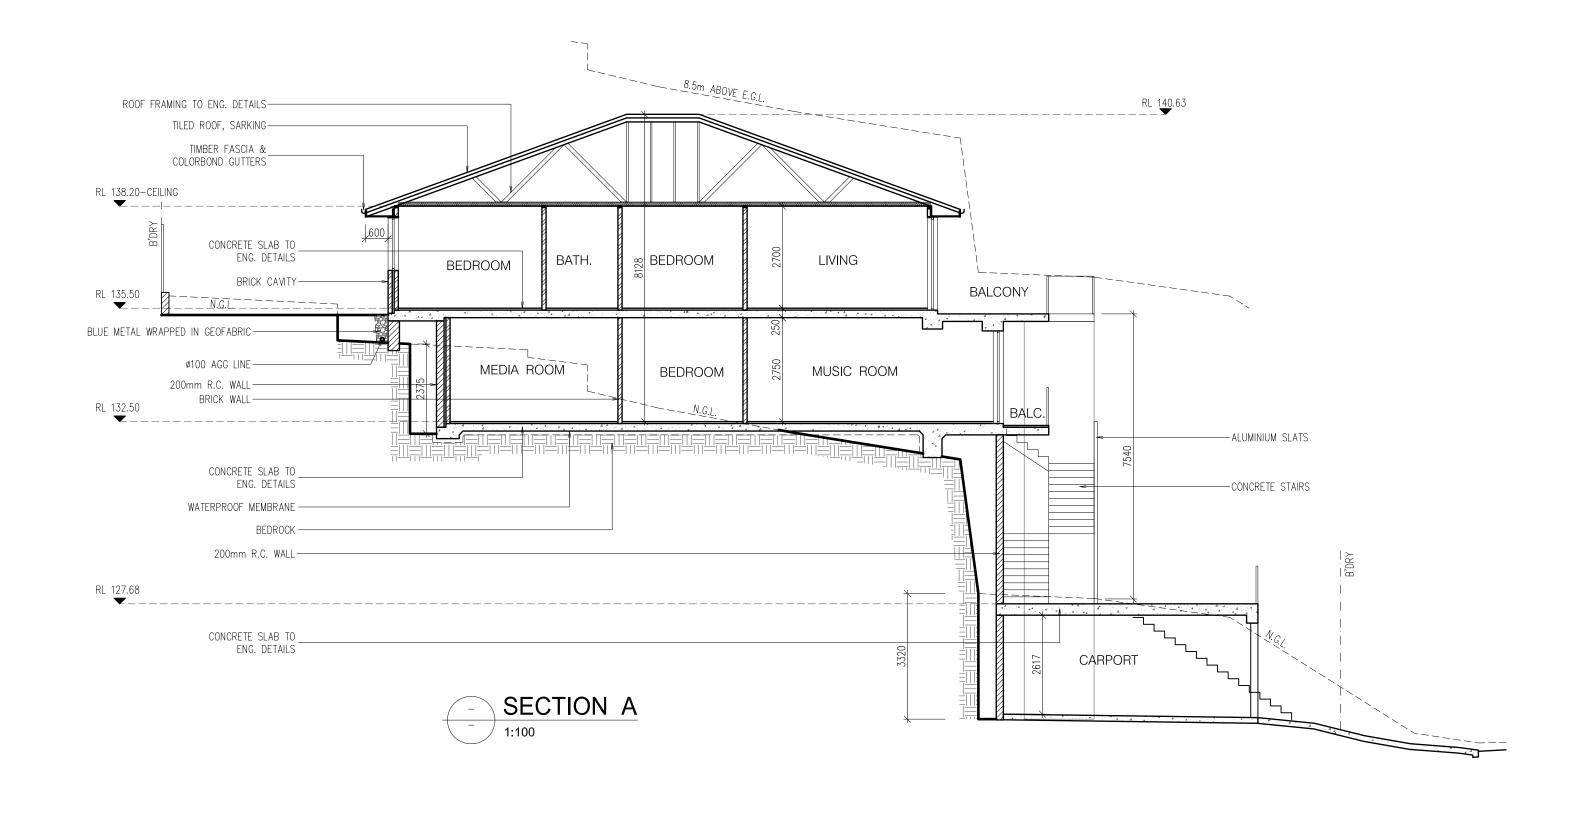
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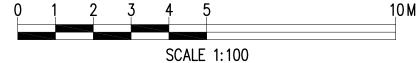
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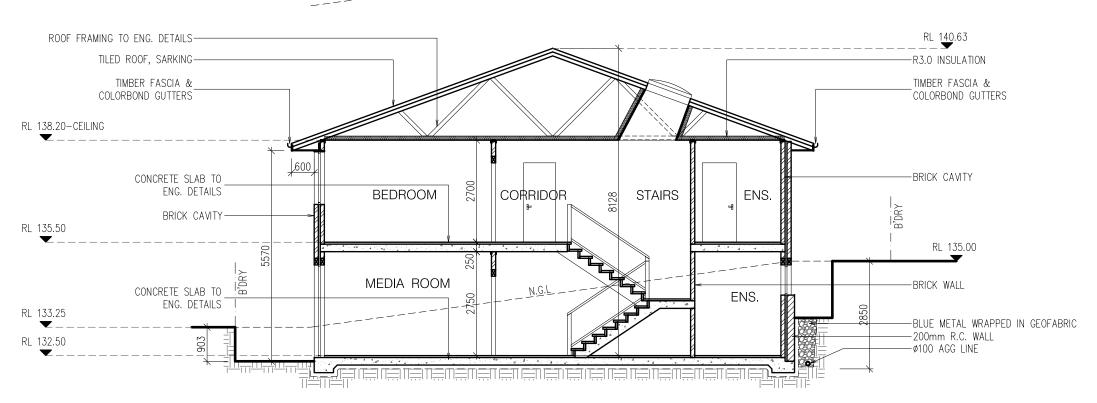
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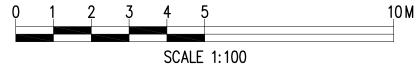
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WINDOWS AND DOOR SCHEDULE				
	ODIENT	SI	ZE	AREA (m2)
	ORIENT.	W	Н	ANLA (IIIZ)
WG-1	WEST	1690	800	1.35
WG-2	WEST	1090	800	0.87
WG-3	WEST	1690	1200	2.03
WG-4	WEST	1090	1400	1.53
WG-5	WEST	1090	1400	1.53
WG-6	NORTH	3310	1400	4.63
WG-7	NORTH	2010	1400	2.81
WG-8	EAST	1050	1400	1.47
WG-9	EAST	1090	1400	1.53
WG-10	EAST	1090	1400	1.53
WG-11	EAST	1690	1400	2.37
WG-12	EAST	1450	1400	2.03
DG-1	NORTH	900	2400	2.16
DG-2	NORTH	1200	2400	2.88
DG-3	NORTH	900	2400	2.16
DG-4	EAST	900	2400	2.16
W1-1	WEST	1810	1200	2.17
W1-2	WEST	850	1400	1.19
W1-3	WEST	2050	1400	2.87
W1-4	WEST	1330	1400	1.86
W1-5	WEST	1330	1400	1.86
W1-6	NORTH	3310	1400	4.63
W1-7	EAST	1330	1400	1.86
W1-8	EAST	970	1400	1.36
W1-9	EAST	1810	1400	2.53
W1-10	EAST	1450	1400	2.03
W1-11	EAST	1810	1400	2.53
W1-12	SOUTH	2110	1400	2.95
W1-13	SOUTH	2950	1400	4.13
D1-1	NORTH	900	2400	2.16
D1-2	NORTH	4690	2400	11.26
D1-3	SOUTH	900	2400	2.16
D1-4	SOUTH	900	2400	2.16
D1-5	SOUTH	900	2400	2.16

NATHERS INCLUSIONS SUMMARY

atHERS Thermal Comfort Inclusions - 45 Oxford Falls Rad, Beacon Hill External

Walls

Face brick cavity wall, rendered inside for a total R value 1.59

External Colour

Dark (SA > 0.7)

Internal walls

Single-skin brick rendered

Plasterboard walls to Skylight cavity, R2.0 insulation

External Floor

Concrete slab on ground

Suspended concrete floor

Internal Floor

Suspended concrete floor between levels, no insulation required

Floor coverings

Tiles to wet areas, timber elsewhere

Roof and Ceilings

Tile roof with sarking

Plasterboard ceiling with R3.0 insulation (insulation only value)

Plasterboard ceiling with R3.0 insulation (insulation only value), where balcony above

External Colour

Dark (SA > 0.7)

Ceiling Penetrations

Sealed IC rated LED downlights, one every 5.0m²

Glazing Doors and Windows

Tilt & turn + hinged

U-value: 3.0 (equal to or lower than) SHGC: 0.48 (±5%)

Sliding + fixed

U-value: 3.0 (equal to or lower than) SHGC: 0.56 (±5%)

Given values are AFRC total window system values (glass and frame)

Frame colour: Dark (SA > 0.7)

Skylights

30/05/25 DATE

Operable, U-value: 2.61 (equal to or lower than) SHGC: 0.21 (±5%)

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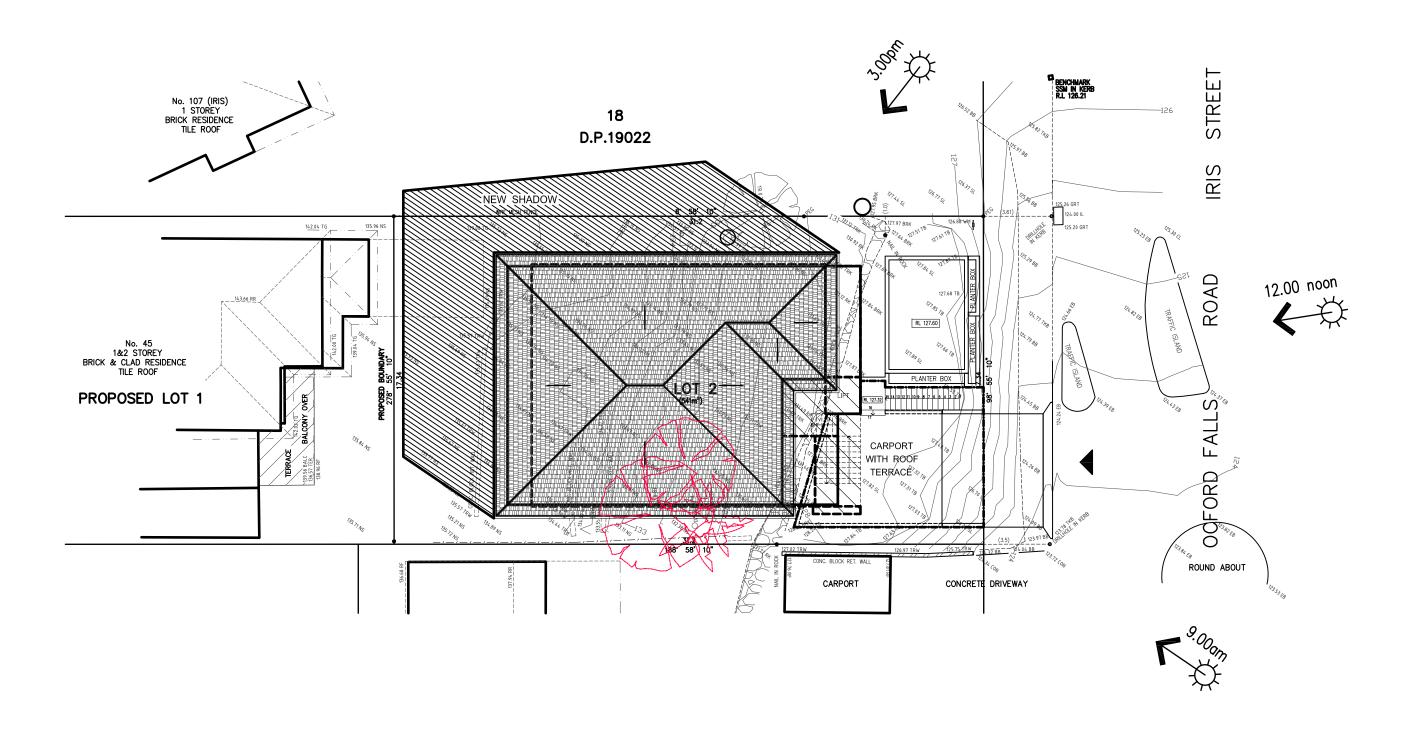
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SHADOW DIAGRAM AZIMUTH 43° ALTITUDE 20° 21/6 - 9:00

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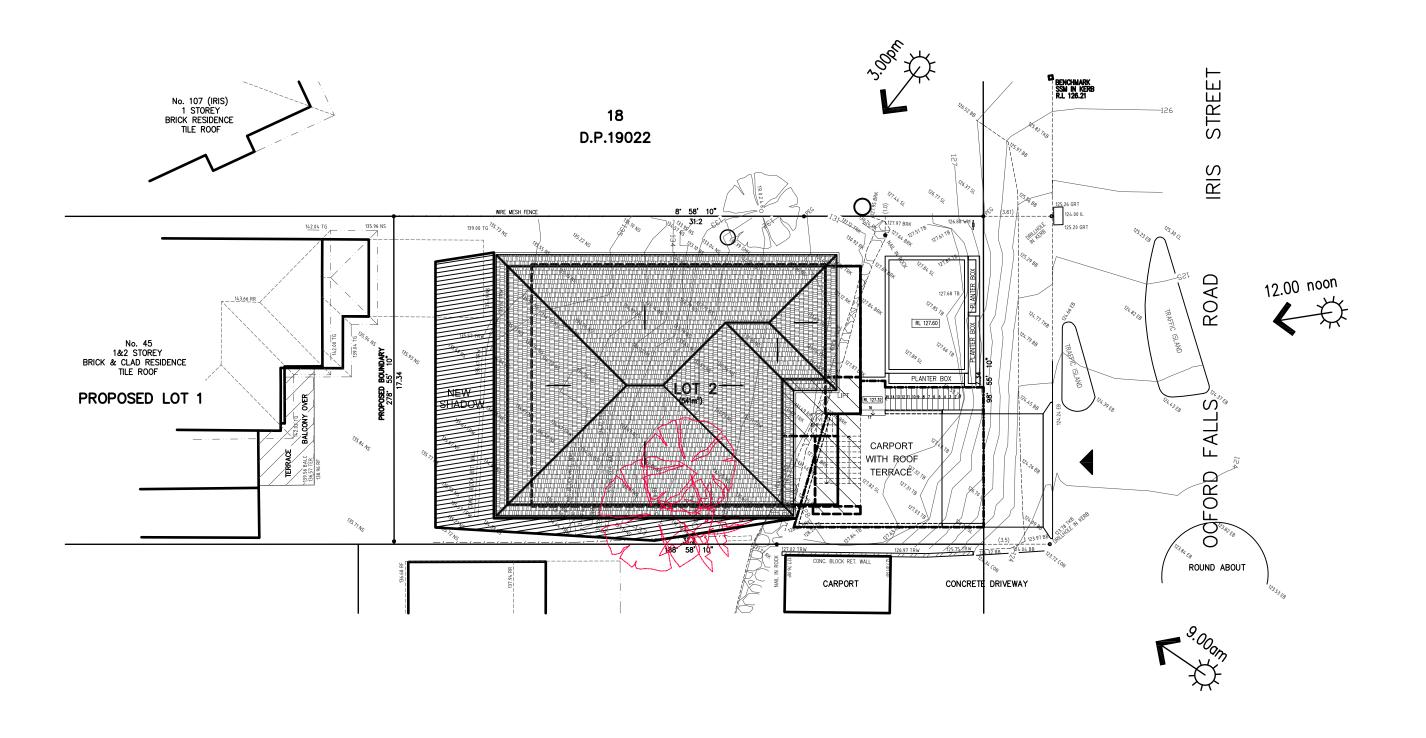
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SHADOW DIAGRAM AZIMUTH 0° ALTITUDE 34° 21/6 - 12:00 1:200

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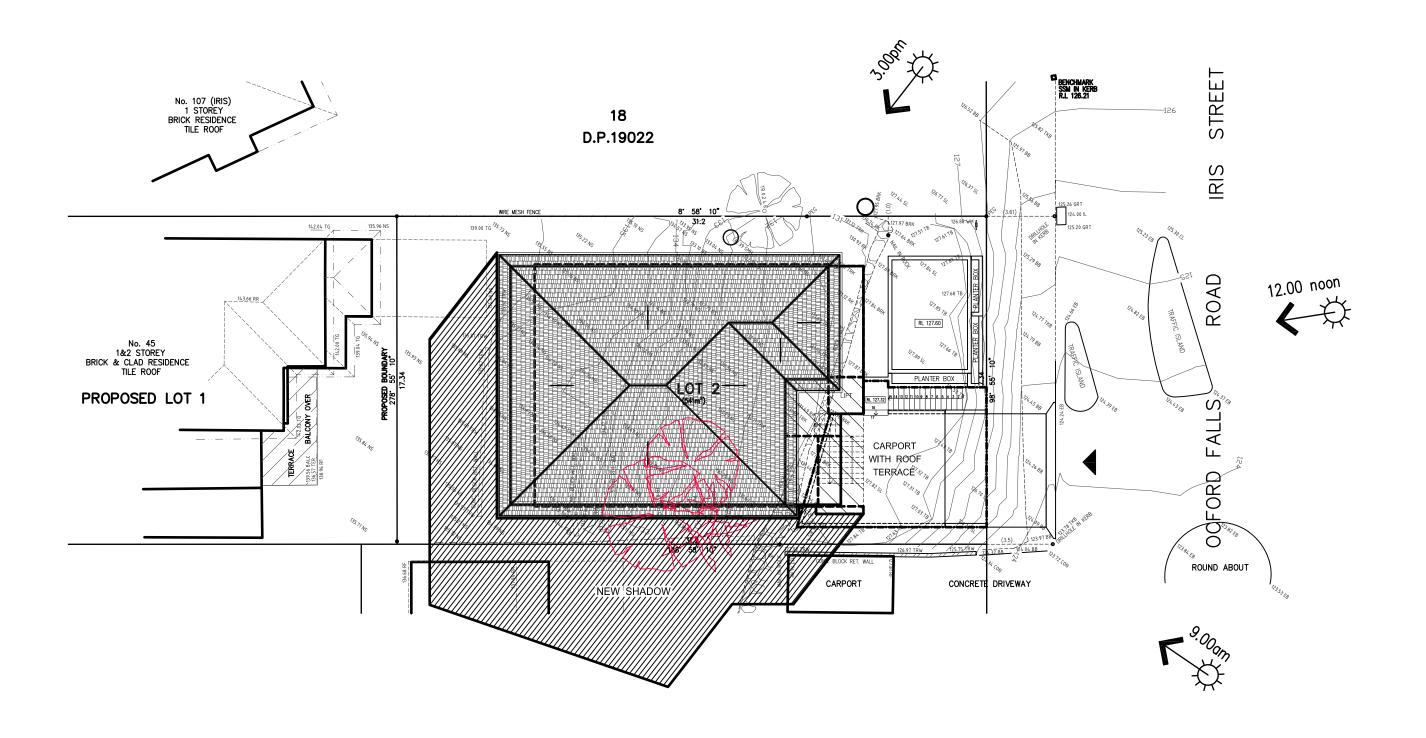
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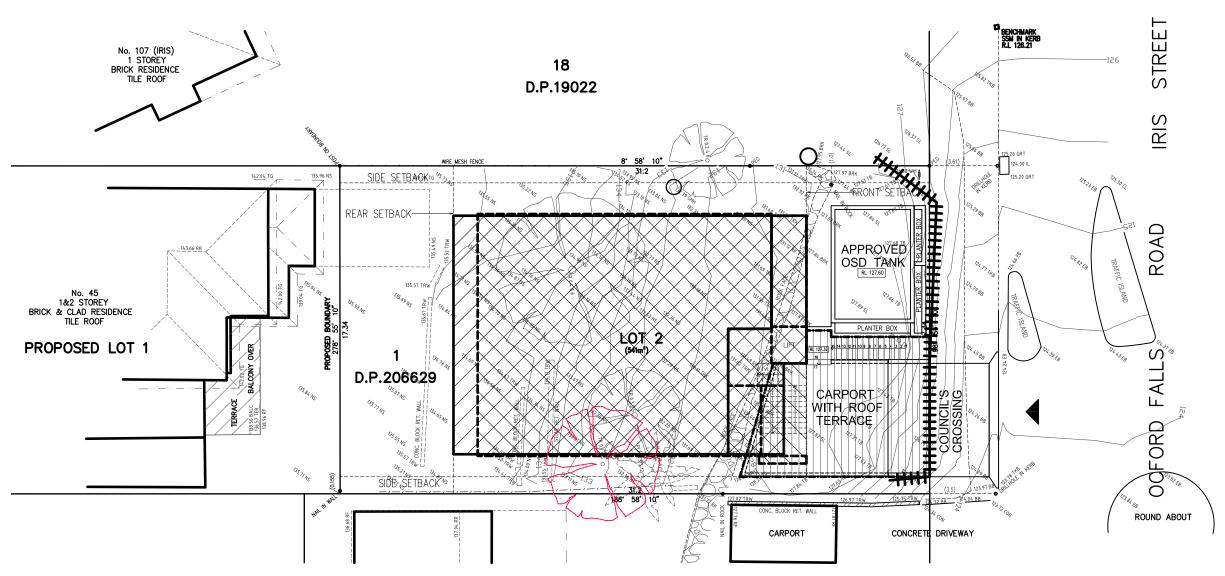
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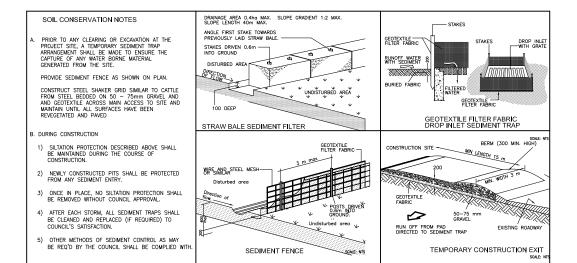
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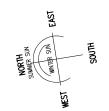


EROSION AND SEDIMENT MANAGEMENT PLAN

1:200



SEDIMENT CONTROL FENCE



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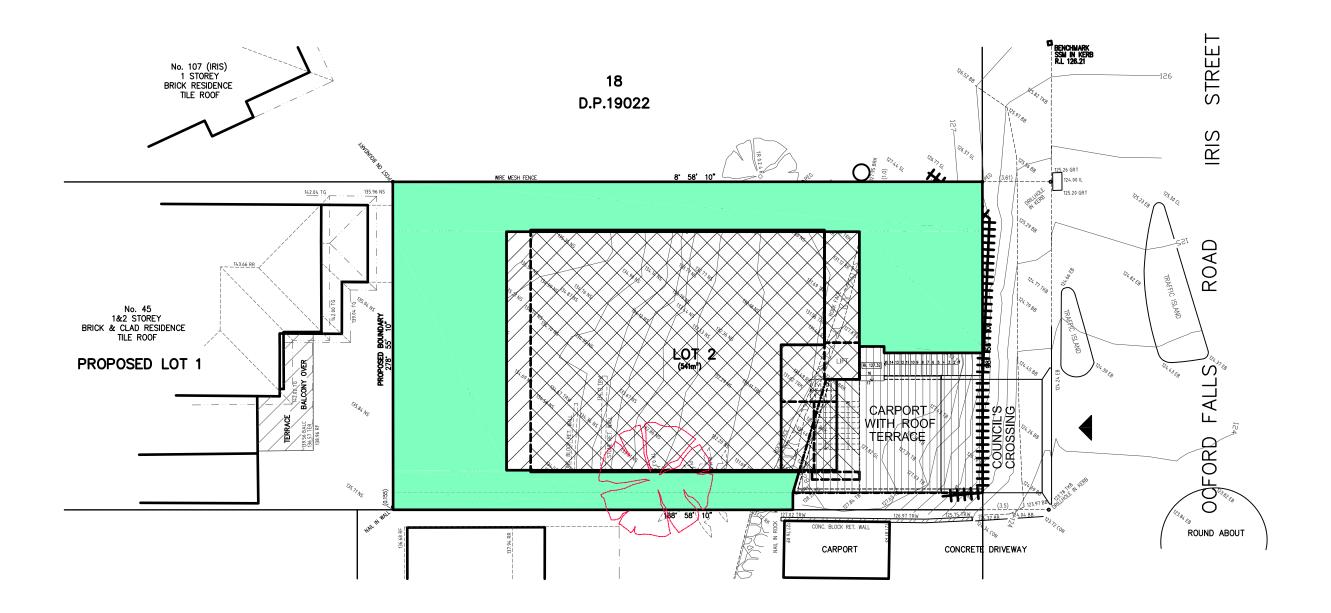
 3. All work to be in accordance with BUILDING CODE of AUSTRALIA & to the satisfaction of local council requirements & other authorities.

 3. All timber construction to be in accordance with the "TIMBER FRAMING" code.
- 6 Roof water & sub-soil drainage to be disposed of in the approved manner or as directed by local council inspectors. 7 All electrical power & light outlets to be determined by owner. 8 Make good and repair all existing finishes damaged by new work. Reuse existing material where possible.
- ISSUED FOR DA AMENDMENT 30/05/25 DATE No.

DESIGN BY: MICHAL KORECKY

21 NALYA ROAD, NARRAWEENA NSW 2099 ABN: 79 393 130 294 Email: koreckym@gmail.com Mob: 0438 148 944

SCALE 1: 200				
DATE: 30/05/25	SCALE: AS NOTED			
DRAWN: MK	ISSUE: 1			
DRAWING Nr : 18080	SHEET: 16			



LANDSCAPE OPEN SPACE CALCULATION SHEET

L.O.S. CALCULATION	(m2)
SITE AREA	541.0
L.O.S. 1	241.1
TOTAL L.O.S.	222.9 (44.5%) > 40%



10 M

0 1 2 3 4 5

SCALE 1: 200

GENERAL NOTES:

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1	ISSUED FOR DA	30/05/25	
No.	AMENDMENT	DATE	
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COMEL 1:200				
SCALE:	AS NOTED			
ISSUE:	1			
SHEET:	17			
	SCALE:			

BASIX™Certificate

www.planningportal.nsw.gov.au/development-and-assessment/basix

Single Dwelling

This certificate confirms that the proposed development will meet the NSW government's requirements for sustainability, if a is built in accordance with the commitments set out below. Terms used in this certificate, or in the commitment have the meaning given by the document entitled "BASIX Definitions" dated 10.09/20/20 published by the Department. This document is available at www.planningportal.nsw.gov.au/definitions



Project summary			
Project name	45 Oxford Falls Road - New		
Street address	45 0XF ORD FALLS Road BEACON HILL 2100		
Local Government Area	Northern Beaches Council		
Plan type and plan number	Deposted Plan DP206629		
Lot no.	1		
Section no.			
Project type	dwelling house (detached)		
No. of bedrooms	6		
Project score	2011		
Water	✓ 41	Target 40	
Thermal Performance	✓ Pass	Target Pas	
Energy	✓ 76	Target 72	
Materials	✓ -82	Target n/a	

Certificate Prepared by	
Name / Company Name: MICHAL KORECKY	
ABN (f applicable):	

BASIX Department of Planning, Housing and www.basix.now.gov.au Version: 4.03/EUCAL/PTUS_03_01_0 Certificate No: 10036965 Thursday, 03 Abr 2025 Inhardscuture

Project address		Assessor details and then	mal loads	
Project name	45 Oxford Falls Road - New	NatHERS assessor number	10035	
Street address	45 OXFORD FALLS Road BEACON HILL 2100	NatHERS certificate number	#HR-UHXD8y-01	
Local Government Area	Northern Beaches Council	Climate zone	56	
Plan type and plan number	Deposited Plan DP206629	Area adjusted cooling load (MJ/ m².vear)		
Lot no.	1	Area adjusted heating load (MJ/		
Section no.		m².year)	1"	
Project type		Project score		San San Carlo
Project type	dwelling house (detached)	Water	√ 41	Target 40
No. of bedrooms	6		V 41	Target 40
Site details		Thermal Performance	✓ Pass	Target Pa
Site area (m²)	541	Energy		
Roof area (m²)	242	chergy	√ 76	Target 72
Conditioned floor area (m²)	335.6	Materials	√ -82	Target n/a
Unconditioned floor area (m²)	13.4			
Total area of garden and lawn (m²)	241			
Roof area of the existing dwelling (m²)	0			


ssor details and therm	ial loads	No. of Concession, Name of Street, or other Designation, Name of Street, or other Designation, Name of Street,	Water Commitments	DA plans
RS assessor number	10035			
RS certificate number	#HR-UHXD8y-01		Fixtures	
zone	56		The applicant must install showerheads with a minimum rating of 4 star (> 4.5 but <= 6 L/min plus spray force and/or coverage tests) in all showers in the development.	
djusted cooling load (MJ/ r)	9		The applicant must install a toilet flushing system with a minimum rating of 4 star in each toilet in the development.	
djusted heating load (MJ/ r)	11		The applicant must install taps with a minimum rating of 5 star in the kitchen in the development.	
ct score		150.475.65	The applicant must install basin taps with a minimum rating of 5 star in each bathroom in the development.	
	√ 41	Target 40	Alternative water	
al Performance	✓ Pass	Target Pass	Rainwater tank	
	√ 76	Target 72	The applicant must install a rainwater tank of at least 5000 litres on the site. This rainwater tank must meet, and be installed in accordance with, the requirements of all applicable regulatory authorities.	~
als	√ -82	Target n/a	The applicant must configure the rainwater tank to collect rain runoff from at least 241 square metres of the roof area of the development (excluding the area of the roof which drains to any stormwater tank or private dam).	
	•		The applicant must connect the rainwater tank to:	
			 at least one outdoor tap in the development (Note: NSW Health does not recommend that rainwalter be used for human consumption in areas with potable water supply.) 	

Schedule of BASIX commitments

The commitments set out below regulate how the proposed development is to be carried out. It is a condition of any development consent granted, or complying development certificate issued, for the proposed development, that BASIX commitments be complied with.


rmal Performance and Materials commitments	Show on DA plans	Show on CC/CDC plans & specs	Certifier
ulation Method			
essor details and thermal loads			
applicant must attach the certificate referred to under "Assessor Details" on the front page of this BASIX certificate (the "Assessor Interfact") to the development application and construction certificate agolication for the proposed development, of the applicant is lying for a complying development certificate for the proposed development, to that application.) The applicant must also attach the sesor Certificate for the application for an occupation certificate for the proposed development.			
Assessor Certificate must have been issued by an Accredited Assessor in accordance with the Thermal Comfort Protocol.			
details of the proposed development on the Assessor Certificate must be consistent with the details shown in this BASIX ficate, including the Cooling and Heating loads shown on the front page of this certificate and the "Construction" and "Glazing" es below.			
applicant must show on the plans accompanying the development application for the proposed development, all matters which Assessor Certificate requires to be shown on those plans. Those plans must bear a stamp of endorsement from the Accredited sessor to certify that this sit he case. The applicant must able on on the plans accompanying the application for a construction fictate (or complying development certificate, if applicable), all thermial performance specifications set out in the Assessor fictate (or complying development certificate, if applicable), all thermial performance specifications set out in the Assessor fictate (or complying development certificate, if applicable), all thermial performance specifications set out in the Assessor fictate (or complying development very complete that the property of	~	~	~
applicant must construct the development in accordance with all thermal performance specifications set out in the Assessor illicate, and in accordance with those aspects of the development application or application for a complying development certificate here used to acculate those specifications.		~	~
applicant must show on the plans accompanying the development application for the proposed development, the locations of ng fans set out in the Assessor Certificate. The applicant must show on the plans accompanying the application for a construction ficate for complying development certificate it applicable), the locations of ceiling fains set out in the Assessor Certificate.	~	~	~

BASIX Department of Planning, Housing and www.basic.now.gov.au Version: 4.03 / EUCALYPTUS_03_01_0 Certificate No.: 18028885 Thursday, 03 July 2025 Infrastructure

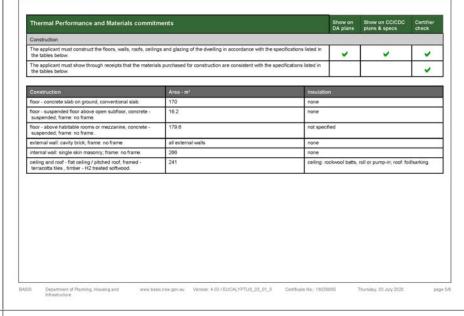

Thermal Performance and Materials commitments			Show on DA plans	Show on CC/CDC plans & specs	Certifie
Glazing					
The applicant must install windows, glazed doors and s listed in the table.	kylights as described in the table b	elow, in accordance with the specifications	~	~	~
Frames		Maximum area - m2			
aluminium		0			
timber		0			
uPVC		85.91			
steel		0			
composite		0			
		635			
Glazing		Maximum area - m2			
single		0			
double		85.91			
triple		0			

Energy Commitments	Show on DA plans	Show on CC/CDC plans & specs	Certifier check
Hot water			
The applicant must install the following hot water system in the development, or a system with a higher energy rating: electric heat pump with a performance of 31 to 35 STCs or better.	~	~	~
Cooling system			
The applicant must install the following cooling system, or a system with a higher energy rating, in at least 1 living area: 3-phase airconditioning; Energy rating: EER < 2.5		~	~
The applicant must install the following cooling system, or a system with a higher energy rating, in at least 1 bedroom: 3-phase airconditioning; Energy rating: EER < 2.5		~	~
Heating system			
The applicant must install the following heating system, or a system with a higher energy rating, in at least 1 living area: 3-phase airconditioning; Energy rating: EER < 2.5		~	~
The applicant must install the following heating system, or a system with a higher energy rating, in at least 1 bedroom: 3-phase airconditioning; Energy rating: EER < 2.5		~	~
Ventilation			
The applicant must install the following exhaust systems in the development:			
At least 1 Bathroom: individual fan, open to façade; Operation control: please select		~	~
Kitchen: individual fan, ducted to façade or roof, Operation control: manual switch on/off		~	~
Laundry: individual fan, ducted to façade or roof; Operation control: manual switch on/off		~	~
Artificial lighting			
The applicant must ensure that a minimum of 80% of light fixtures are fitted with fluorescent, compact fluorescent, or light-emitting- diode (LED) lamps.		~	~
Natural lighting			
The applicant must install a window and/or skylight in the kitchen of the dwelling for natural lighting.	5240		2.4

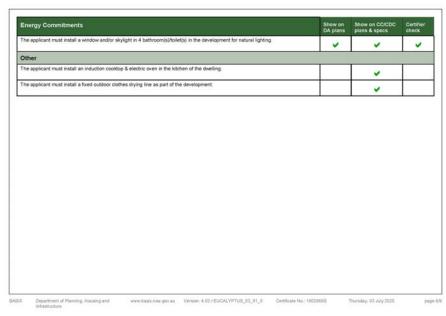



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- 30/05/25 DATE 1 ISSUED FOR DA No. AMENDMENT

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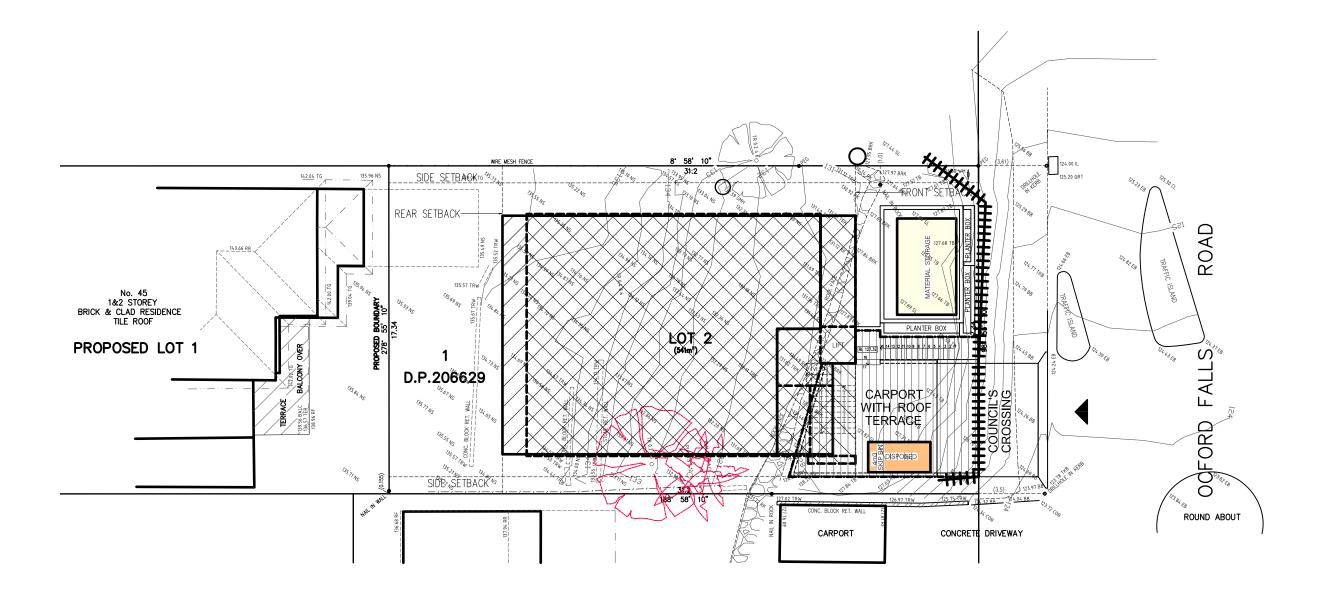
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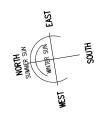
PROPOSED RESIDENCE 45 OXFORD FALLS ROAD, BEACON HILL NSW 2100, LOT 2 IN DP.206629 JIRI AND MARCELA ALBRECHT

PROJECT:

DATE: 30/05/25	SCALE: /	AS NOTED
DRAWN: MK	ISSUE:	1
18080	SHEET:	18







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0 1 2 3 4 5

SCALE 1:200

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30ALL 1.200					
DATE: 30/05/25	SCALE:	AS NOTED			
DRAWN: MK	ISSUE:	1			
18080	SHEET:	19			