# 12B JOHN STREET AVALON, NSW, 2107

### **SHEET LIST:**

00 - COVER PAGE

01 - SITE PLAN

02 - GROUND FLOOR PLAN

03 - FIRST FLOOR PLAN

10 - ELEVATIONS

11 - ELEVATIONS

12 - ELEVATIONS

13 - ELEVATIONS

14 - ELEVATIONS

20 - SECTIONS

21 - SECTIONS

100 - SITE ANALYSIS

101 - ANALYSIS SECTIONS

102 - SHADOW PLANS


103 - SHADOW 3D'S

104 - COLOUR & FINISHES

105 - 3D'S

106 - BASIX & NATHERS

Building Component	Construction Material	s	Insulation	Colour - Solar Absorpt.	Other Detail/Requirements
External Walls	Weatherboard	Plasterboard lined	R4.1	Medium (0.475 to 0.70)	Walls as marked
	Fibre Cement	Plasterboard lined	R1.8	Medium (0.475 to 0.70)	Main Dwelling: 12A (Cavity slider wall dining room)
A LIMB CONTRACTOR OF THE PARTY	Fibre Cement	Plasterboard lined	R4.1	Medium (0.475 to 0.70)	Walls as marked
Internal walls (within)	Plasterboard on studs		R3.6		Granny Flats: All internal walls
	Plasterboard on studs		R2.7		Main Dwellings 128 wet areas
	Plasterboard on studs		R2.5		Main Dwelling 12A: All wet areas
	Plasterboard on studs		None		Main Dwellings 12A and 12B: All other areas
	Alum SG Clear: U = 6.70: SF	IGC = 0.57	All too		Granny flat A and B: All garage windows
Windows/Glazing*	Alum DG Argon Fill High Sol	ar Gain low-E -Clear: U = 4.1: SHGC = 0.52			Granny flat A and B: Sliding window
	Aluminium Louvre Seconda	ry Glaze SG 6mmLE: U = 3.71: SHGC = 0.54			Louvre windows in all dwellings (except garages). WA16
	Al Thermally Broken DG Air	Fill High Solar Gain low-E -Clear: U = 3.1: SHGC = 0.49			All other windows
Roof	Metal Deck		R9.2	Medium (0.475 to 0.70)	
Ceiling	Timber				As above
Floor Structure	Concrete		None		Granny flats ground floor
	Timber		R4.1		Main dwelling floors. Granny flats first floors
Floor Covering	Timber	All other rooms			As drawn
	Ceramic Tiles Wet areas				
Ceiling/Wall Penetrations	Must be sealed				
External Shading Devices	As drawn				
Roof Windows	None				
Skylights	None				

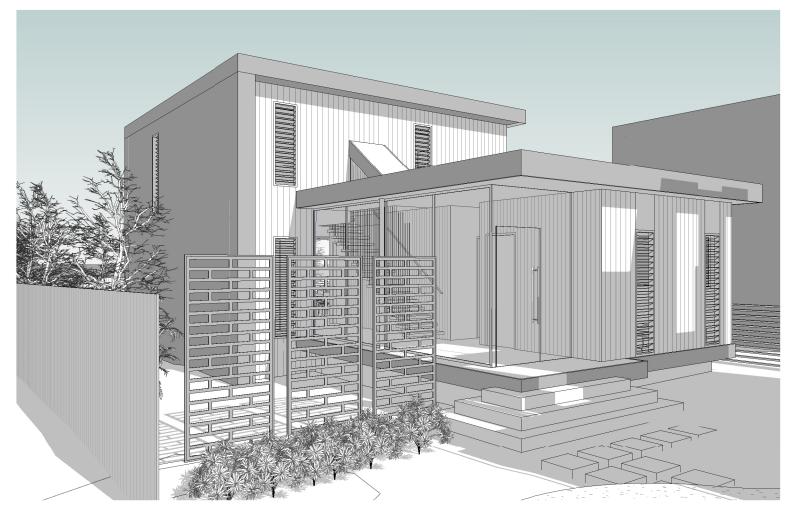

NUM #	SILL	HEIGHT	WIDTH
WB01	0	1200	2400
WB02	0	1200	1800
WB03	0	1200	2400
WB04	0	2400	600
WB05	0	2800	8300
WB06	0	2400	600
WB07	0	3100	6400
WB08	0	3100	2050
WB09	0	2400	600
WB10	0	2400	600
WB11	0	2400	600
WB12	0	2800	5200
WB13	0	2800	3000
WB14	0	2400	600
WB15	400	2000	600
WB16	400	2000	600
WB17	1300	800	1800
WB18	300	2100	900
WB19	1300	800	1800
WB20	0	2600	900
WB21	0	2600	6000
WB22	900	700	2550
WB23	0	2600	900



RCHITECT'S WORK IS COPYRIGHT AND COVERED BY COPYRIGHT ACT 1968

RAWINGS NOT TO BE SCALED. USE FIGURED DIMENSIONS ONLY, CHECK ALL DIMENSIONS ON SITE . ELECTRONIC COPIES OF DRAWINGS SHOULD BE VERIFIED AGAINST PRINTED COPIES TO ENSURE NO LOSS OF INFORMATION, IF IN DOUBT ASK



reg# NSW 7417 - TIM WEST ph. 02 9918 5085 e. tim@thw.net.au

m. Suite 101 - Level 1, 60 Old Barrenjoey rd, Avalon NSW, 2107

SURVEY BEE & LETHBRIDGE PTY LTD SUITE 2, 14 STARKEY ST, FORESTVILLE, NSW, 2087 P. 9975 3535 E. SURVEY@BEELETH.COM.AU

STORMWATER / FLOOD

LUCASBCE@BIGPOND.COM 0418 620 330

BARRENJOEY CONSULTING ENGINEERS

34 GEORGE ST, AVALON, NSW, 2107

VAUGHAN MILLIGAN DEVELOPMENT CONSULTING VAUGHAN MILLIGAN 8/1 KALINYA ST, NEWPORT, NSW, 2106 W. BEELETH.COM.AU

**PLANNER** 

BASIX / NATHERS

SUSTAINABLE THERMAL SOLUTIONS

138 COWLES RD, MOSMAN, NSW, 2088

ENQUIRIES@SUSTAINABLETHERMALSOLUTIONS.COM.AU 0420 312 721

LANDSCAPE A TOTAL CONCEPT 65 WEST ST, NORTH SYDNEY, NSW, 2060 DESIGN@ATOTALCONCEPT.COM.AU

BIODIVERSITY / COASTAL

ECOLOGICALCA@OUTLOOK.COM

9918 4486

ECOLOGICAL CONSULTANTS AUSTRALIA

**PROJECT** PROPOSED DWELLING 12B JOHN ST, AVALON, NSW, 2107

CLIENT TIM DONOVAN TDONOVAN@CITYFREEHOLDS.

A 01/12/2023 DA


DATE


142B


COMMENTS


PAGE SIZE JOB NUM# DRAWN BY CHK. BY **A**3 MVTW PROJECT NAME SCALE 12B JOHN ST 1:100 DRAWING NAME DRAWING NUMBER A 00 -A

**COVER PAGE** 

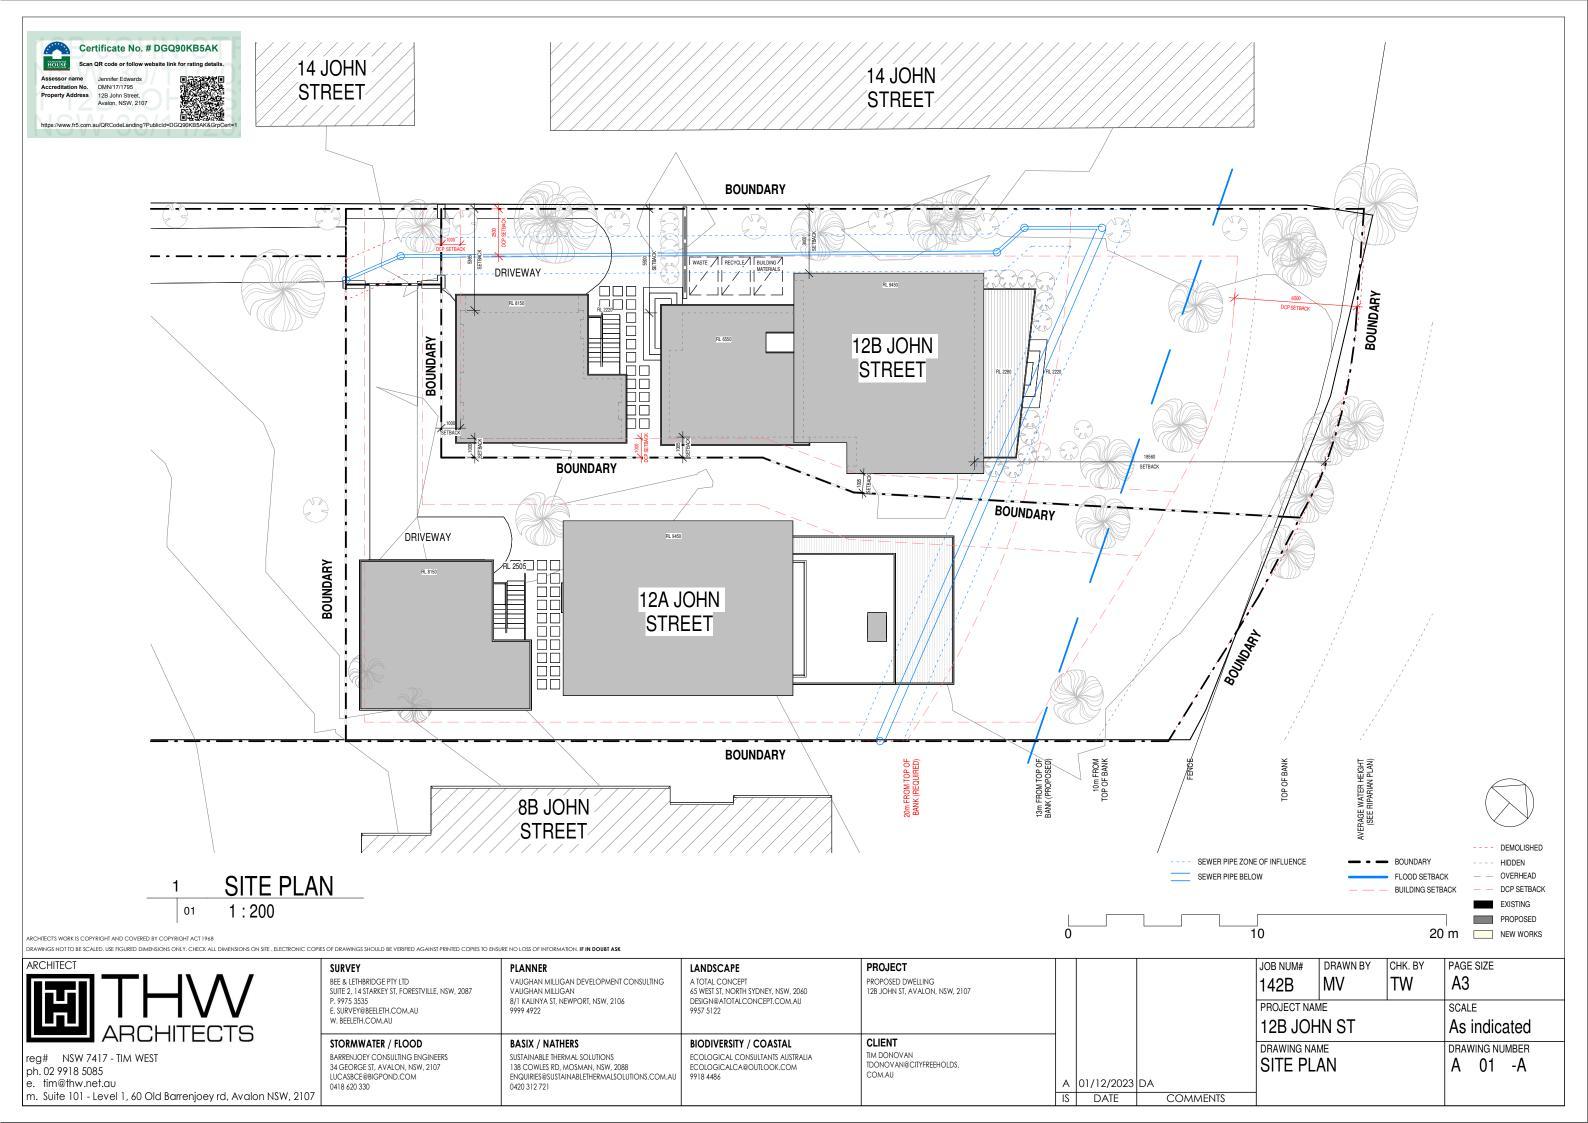

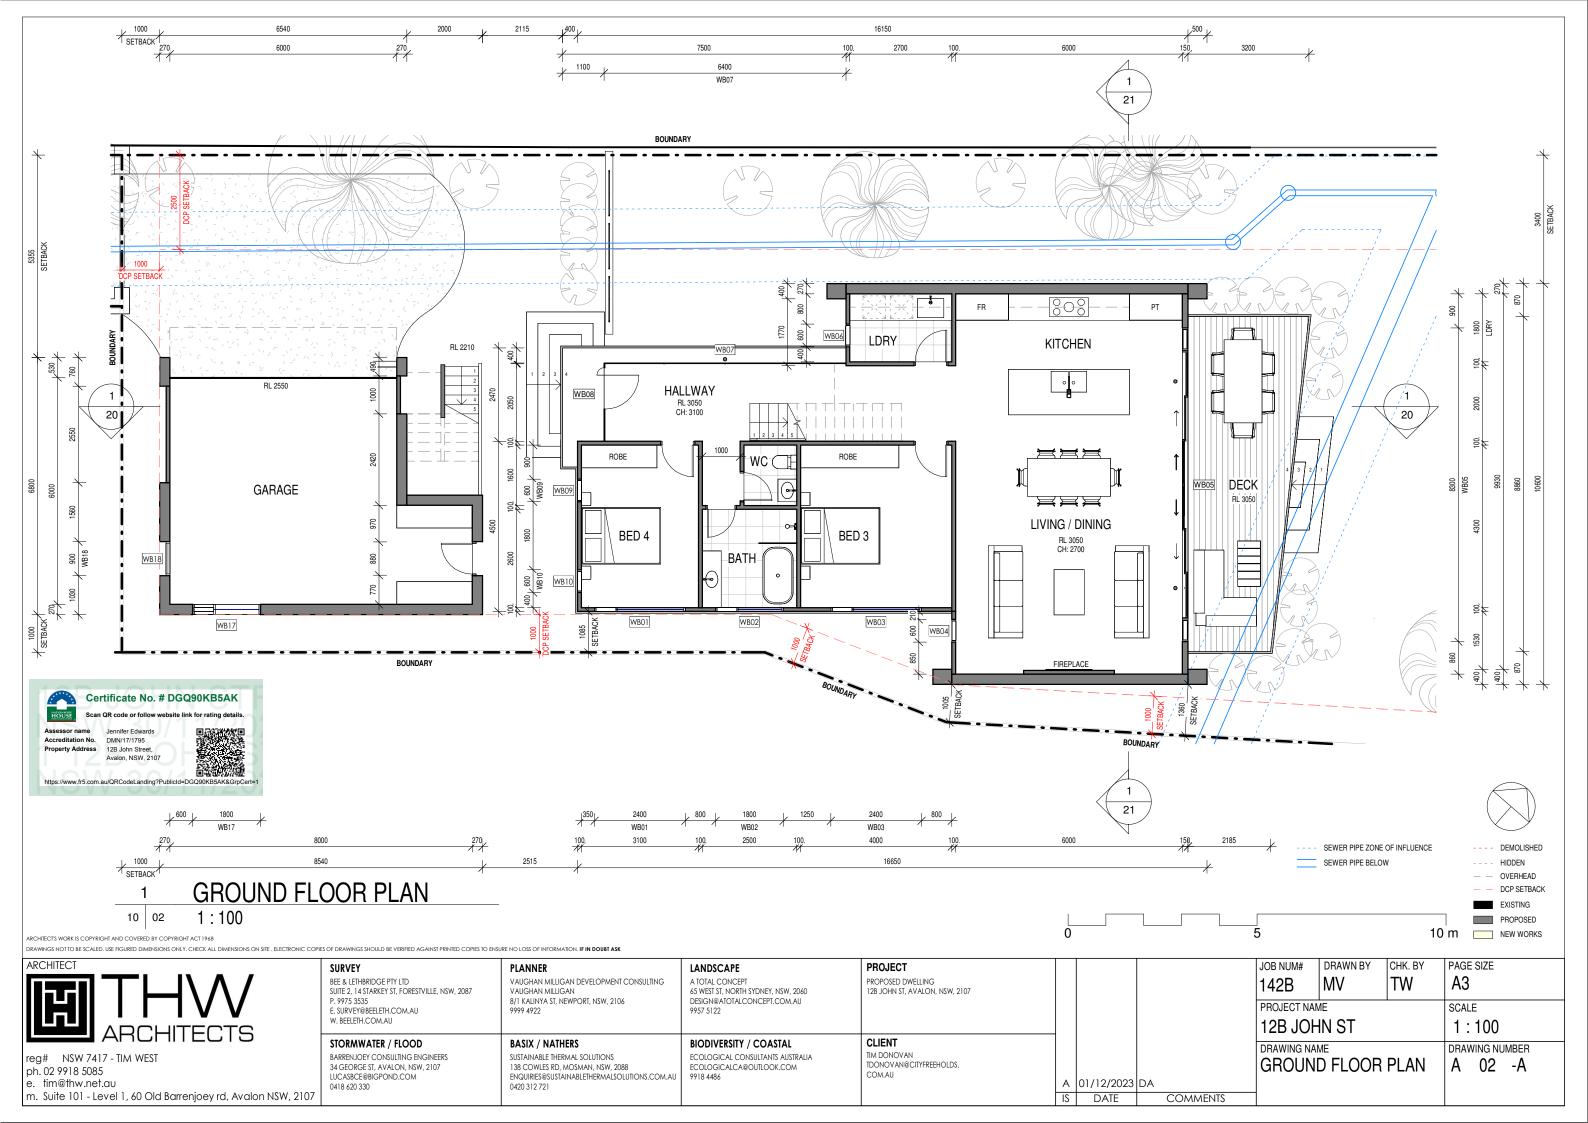

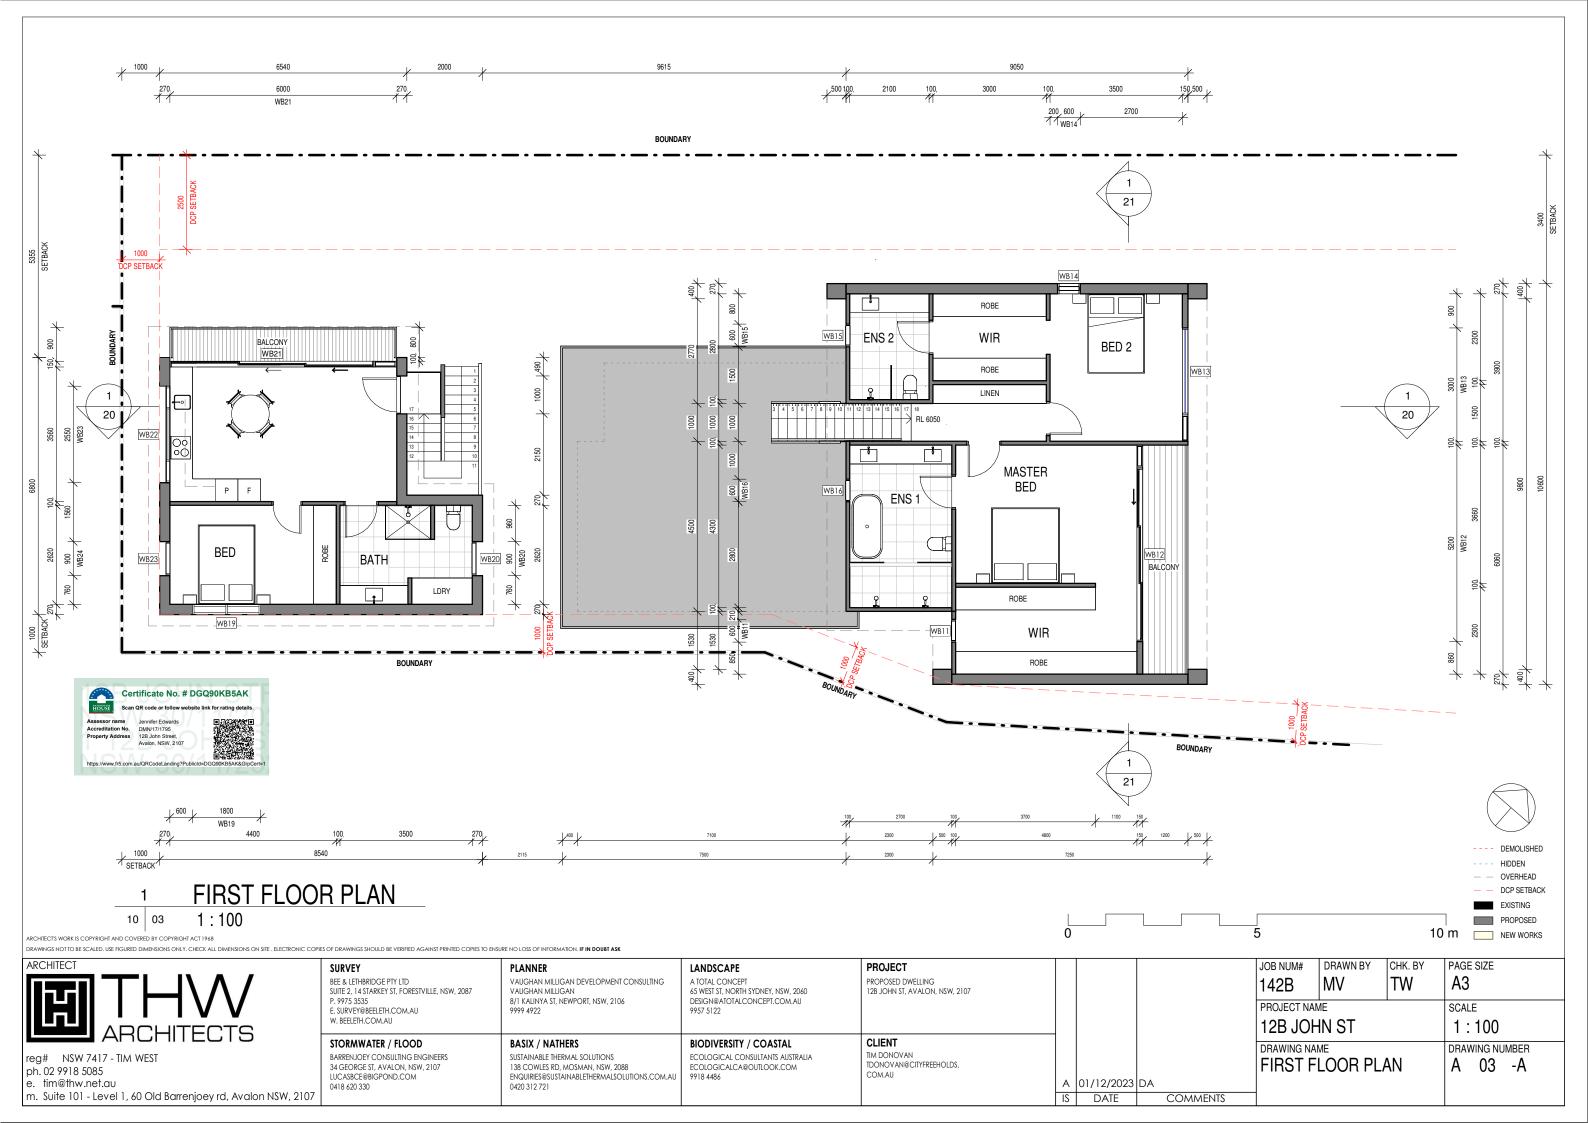

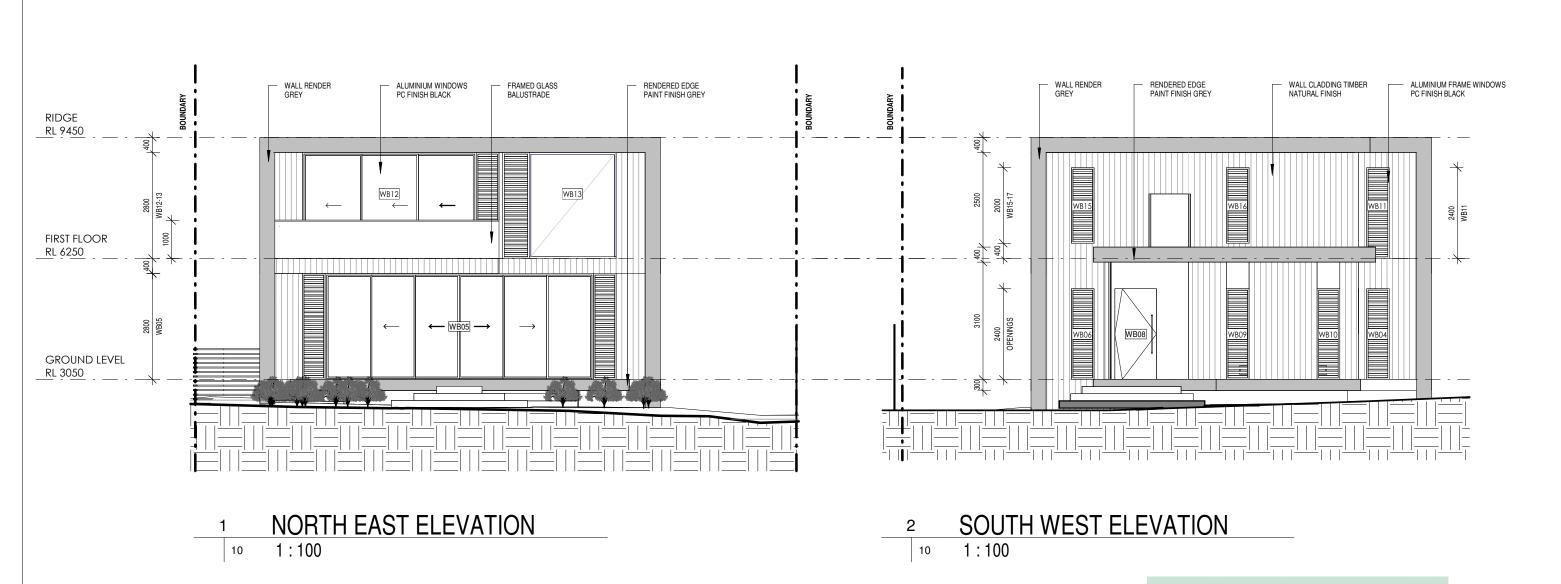

Certificate No. # DGQ90KB5AK Accreditation No. DMN/17/1795 Property Address 12B John Street, Avalon, NSW, 2107 https://www.fr5.com.au/QRCodeLanding?PublicId=DGQ90KB5AK&GrpCert 10 m NEW WORKS

RCHITECT'S WORK IS COPYRIGHT AND COVERED BY COPYRIGHT ACT 1968

DRAWINGS NOT TO BE SCALED, USE FIGURED DIMENSIONS ONLY, CHECK ALL DIMENSIONS ON SITE, ELECTRONIC COPIES OF DRAWINGS SHOULD BE VERIFIED AGAINST PRINTED COPIES TO ENSURE NO LOSS OF INFORMATION, IF IN DOUBT ASK



reg# NSW 7417 - TIM WEST ph. 02 9918 5085

e. tim@thw.net.au m. Suite 101 - Level 1, 60 Old Barrenjoey rd, Avalon NSW, 2107

BEE & LETHBRIDGE PTY LTD SUITE 2, 14 STARKEY ST, FORESTVILLE, NSW, 2087 P. 9975 3535 E. SURVEY@BEELETH.COM.AU

W. BEELETH.COM.AU

STORMWATER / FLOOD

LUCASBCE@BIGPOND.COM 0418 620 330

BARRENJOEY CONSULTING ENGINEERS 34 GEORGE ST, AVALON, NSW, 2107

PLANNER VAUGHAN MILLIGAN DEVELOPMENT CONSULTING VAUGHAN MILLIGAN 8/1 KALINYA ST, NEWPORT, NSW, 2106 9999 4922

BASIX / NATHERS

SUSTAINABLE THERMAL SOLUTIONS

138 COWLES RD, MOSMAN, NSW, 2088

ENQUIRIES@SUSTAINABLETHERMALSOLUTIONS.COM.AU 0420 312 721

LANDSCAPE 65 WEST ST, NORTH SYDNEY, NSW, 2060 DESIGN@ATOTALCONCEPT.COM.AU 9957 5122

BIODIVERSITY / COASTAL

ECOLOGICALCA@OUTLOOK.COM

9918 4486

ECOLOGICAL CONSULTANTS AUSTRALIA

**PROJECT** PROPOSED DWELLING 12B JOHN ST, AVALON, NSW, 2107

CLIENT TIM DONOVAN TDONOVAN@CITYFREEHOLDS. A 01/12/2023 DA

DATE

COMMENTS

JOB NUM# DRAWN BY MV142B PROJECT NAME 12B JOHN ST DRAWING NAME **NE/SW ELEVATIONS** 


А3 SCALE 1:100 DRAWING NUMBER A 10 -A

PAGE SIZE

CHK. BY

--- DEMOLISHED ---- HIDDEN

OVERHEAD EXISTING PROPOSED

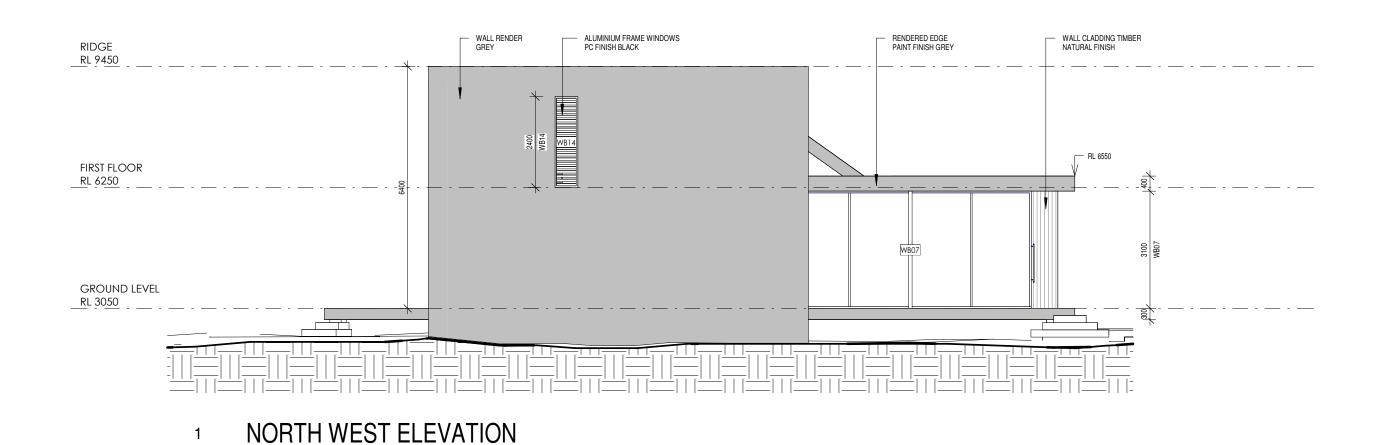



---- DEMOLISHED

---- HIDDEN — — OVERHEAD EXISTING PROPOSED 10 m NEW WORKS

RCHITECT'S WORK IS COPYRIGHT AND COVERED BY COPYRIGHT ACT 1968

DRAWINGS NOT TO BE SCALED, USE FIGURED DIMENSIONS ONLY, CHECK ALL DIMENSIONS ON SITE: ELECTRONIC COPIES OF DRAWINGS SHOULD BE VERIFIED AGAINST PRINTED COPIES TO ENSURE NO LOSS OF INFORMATION, IF IN DOUBT ASK

ARCHITECT

reg# NSW 7417 - TIM WEST ph. 02 9918 5085 e. tim@thw.net.au m. Suite 101 - Level 1, 60 Old Barrenjoey rd, Avalon NSW, 2107

20KAE1
BEE & LETHBRIDGE PTY LTD SUITE 2, 14 STARKEY ST, FORESTVILLE, NSW, 2087
P. 9975 3535 E. SURVEY@BEELETH.COM.AU W. BEELETH.COM.AU

STORMWATER / FLOOD BARRENJOEY CONSULTING ENGINEERS 34 GEORGE ST, AVALON, NSW, 2107 LUCASBCE@BIGPOND.COM 0418 620 330

**PLANNER** VAUGHAN MILLIGAN DEVELOPMENT CONSULTING VAUGHAN MILLIGAN 8/1 KALINYA ST, NEWPORT, NSW, 2106 9999 4922

138 COWLES RD, MOSMAN, NSW, 2088 ENQUIRIES@SUSTAINABLETHERMALSOLUTIONS.COM.AU 0420 312 721

BASIX / NATHERS

SUSTAINABLE THERMAL SOLUTIONS

LANDSCAPE A TOTAL CONCEPT 65 WEST ST, NORTH SYDNEY, NSW, 2060 DESIGN@ATOTALCONCEPT.COM.AU 9957 5122

BIODIVERSITY / COASTAL

ECOLOGICALCA@OUTLOOK.COM 9918 4486

ECOLOGICAL CONSULTANTS AUSTRALIA

**PROJECT** PROPOSED DWELLING 12B JOHN ST, AVALON, NSW, 2107


CLIENT TIM DONOVAN TDONOVAN@CITYFREEHOLDS. A 01/12/2023 DA

DATE

COMMENTS

JOB NUM#	DRAWN BY	CHK. BY	
142B	MV	TW	
PROJECT NAM	ИE		
12B JOH	IN ST		
DRAWING NAME NOT			
			ı

PAGE SIZE А3 SCALE 1:100 DRAWING NUMBER A 11 -A

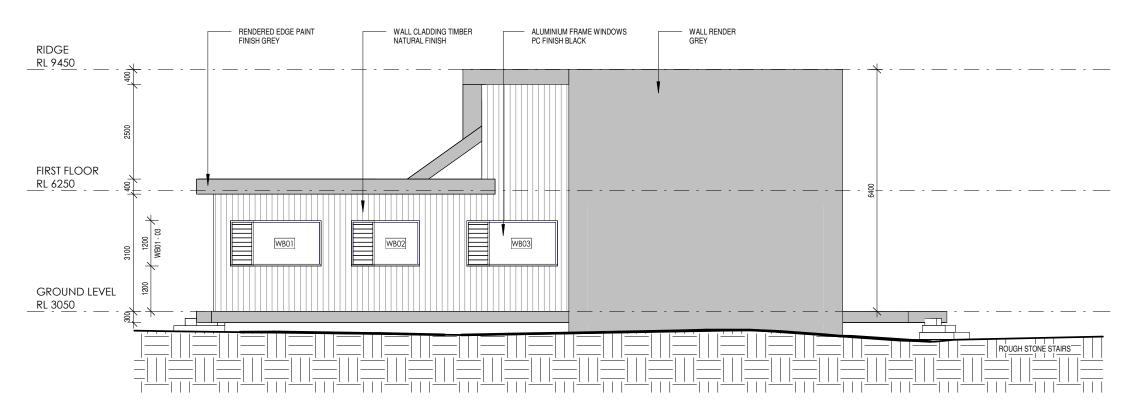

### SOUTH EAST ELEVATION



--- DEMOLISHED

---- HIDDEN — — OVERHEAD EXISTING PROPOSED 10 m NEW WORKS

RCHITECT'S WORK IS COPYRIGHT AND COVERED BY COPYRIGHT ACT 1968

DRAWINGS NOT TO BE SCALED, USE FIGURED DIMENSIONS ONLY, CHECK ALL DIMENSIONS ON SITE, ELECTRONIC COPIES OF DRAWINGS SHOULD BE VERIFIED AGAINST PRINTED COPIES TO ENSURE NO LOSS OF INFORMATION, IF IN DOUBT ASK

ARCHITECT	T	Н	V	/
	ARC	CHIT	ECT	S

reg# NSW 7417 - TIM WEST ph. 02 9918 5085

e. tim@thw.net.au m. Suite 101 - Level 1, 60 Old Barrenjoey rd, Avalon NSW, 2107 BEE & LETHBRIDGE PTY LTD SUITE 2, 14 STARKEY ST, FORESTVILLE, NSW, 2087 P. 9975 3535 E. SURVEY@BEELETH.COM.AU W. BEELETH.COM.AU

STORMWATER / FLOOD

LUCASBCE@BIGPOND.COM 0418 620 330

BARRENJOEY CONSULTING ENGINEERS 34 GEORGE ST, AVALON, NSW, 2107

VAUGHAN MILLIGAN DEVELOPMENT CONSULTING VAUGHAN MILLIGAN 8/1 KALINYA ST, NEWPORT, NSW, 2106 9999 4922

BASIX / NATHERS

SUSTAINABLE THERMAL SOLUTIONS

138 COWLES RD, MOSMAN, NSW, 2088

ENQUIRIES@SUSTAINABLETHERMALSOLUTIONS.COM.AU 0420 312 721

PLANNER

LANDSCAPE A TOTAL CONCEPT 65 WEST ST, NORTH SYDNEY, NSW, 2060 DESIGN@ATOTALCONCEPT.COM.AU 9957 5122

BIODIVERSITY / COASTAL

ECOLOGICALCA@OUTLOOK.COM

9918 4486

ECOLOGICAL CONSULTANTS AUSTRALIA

**PROJECT** PROPOSED DWELLING 12B JOHN ST, AVALON, NSW, 2107

CLIENT TIM DONOVAN TDONOVAN@CITYFREEHOLDS.

JOB NUM# 142B PROJECT NAME


COMMENTS

A 01/12/2023 DA


DATE

PAGE SIZE DRAWN BY CHK. BY MV А3 SCALE

12B JOHN ST 1:100 DRAWING NAME DRAWING NUMBER SE ELEVATION A 12 -A

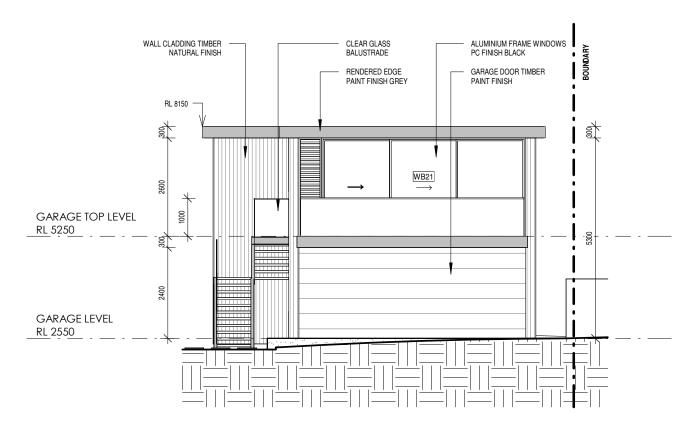

**GARAGE NW ELEVATION** 

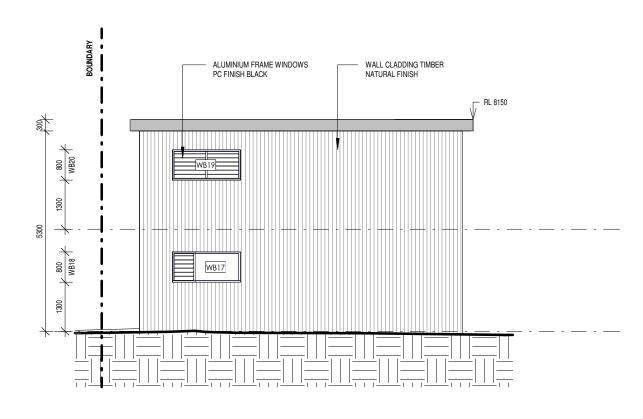

### **GARAGE SE ELEVATION**

A 01/12/2023 DA

DATE

1:100



RCHITECT'S WORK IS COPYRIGHT AND COVERED BY COPYRIGHT ACT 1968 DRAWINGS NOT TO BE SCALED, USE FIGURED DIMENSIONS ONLY, CHECK ALL DIMENSIONS ON SITE, ELECTRONIC COPIES OF DRAWINGS SHOULD BE VERIFIED AGAINST PRINTED COPIES TO ENSURE NO LOSS OF INFORMATION, IF IN DOUBT ASK

**ARCHITECT** 

reg# NSW 7417 - TIM WEST ph. 02 9918 5085

e. tim@thw.net.au m. Suite 101 - Level 1, 60 Old Barrenjoey rd, Avalon NSW, 2107 BEE & LETHBRIDGE PTY LTD SUITE 2, 14 STARKEY ST, FORESTVILLE, NSW, 2087 P. 9975 3535

VAUGHAN MILLIGAN DEVELOPMENT CONSULTING VAUGHAN MILLIGAN 8/1 KALINYA ST, NEWPORT, NSW, 2106 E. SURVEY@BEELETH.COM.AU 9999 4922 W. BEELETH.COM.AU

PLANNER

BASIX / NATHERS

LANDSCAPE 65 WEST ST, NORTH SYDNEY, NSW, 2060 DESIGN@ATOTALCONCEPT.COM.AU 9957 5122

**PROJECT** PROPOSED DWELLING

12B JOHN ST, AVALON, NSW, 2107 CLIENT TIM DONOVAN TDONOVAN@CITYFREEHOLDS.

JOB NUM# 142B PROJECT NAME

COMMENTS

PAGE SIZE DRAWN BY CHK. BY MV**A**3 SCALE

HIDDEN

OVERHEAD


12B JOHN ST 1:100 DRAWING NAME DRAWING NUMBER **GARAGE ELEVATIONS** A 13 -A

BARRENJOEY CONSULTING ENGINEERS 34 GEORGE ST, AVALON, NSW, 2107 LUCASBCE@BIGPOND.COM 0418 620 330


STORMWATER / FLOOD

SUSTAINABLE THERMAL SOLUTIONS 138 COWLES RD, MOSMAN, NSW, 2088 ENQUIRIES@SUSTAINABLETHERMALSOLUTIONS.COM.AU 0420 312 721


BIODIVERSITY / COASTAL ECOLOGICAL CONSULTANTS AUSTRALIA ECOLOGICALCA@OUTLOOK.COM 9918 4486

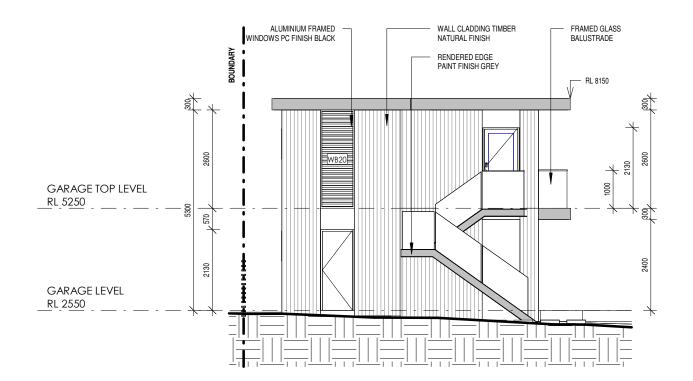

**GARAGE NE ELEVATION** 

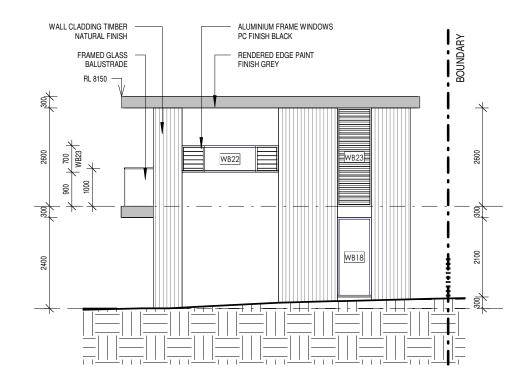

## **GARAGE SW ELEVATION**

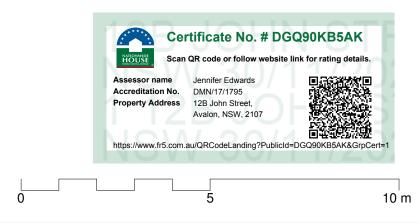

RCHITECT'S WORK IS COPYRIGHT AND COVERED BY COPYRIGHT ACT 1968

DRAWINGS NOT TO BE SCALED, USE FIGURED DIMENSIONS ONLY, CHECK ALL DIMENSIONS ON SITE, ELECTRONIC COPIES OF DRAWINGS SHOULD BE VERIFIED AGAINST PRINTED COPIES TO ENSURE NO LOSS OF INFORMATION, IF IN DOUBT ASK

**ARCHITECT** 

reg# NSW 7417 - TIM WEST ph. 02 9918 5085

e. tim@thw.net.au m. Suite 101 - Level 1, 60 Old Barrenjoey rd, Avalon NSW, 2107 BEE & LETHBRIDGE PTY LTD SUITE 2, 14 STARKEY ST, FORESTVILLE, NSW, 2087 P. 9975 3535 E. SURVEY@BEELETH.COM.AU

W. BEELETH.COM.AU

STORMWATER / FLOOD

LUCASBCE@BIGPOND.COM 0418 620 330

BARRENJOEY CONSULTING ENGINEERS

34 GEORGE ST, AVALON, NSW, 2107

PLANNER VAUGHAN MILLIGAN DEVELOPMENT CONSULTING VAUGHAN MILLIGAN 8/1 KALINYA ST, NEWPORT, NSW, 2106 9999 4922

BASIX / NATHERS

SUSTAINABLE THERMAL SOLUTIONS

138 COWLES RD, MOSMAN, NSW, 2088

ENQUIRIES@SUSTAINABLETHERMALSOLUTIONS.COM.AU 0420 312 721

LANDSCAPE 65 WEST ST, NORTH SYDNEY, NSW, 2060 DESIGN@ATOTALCONCEPT.COM.AU

BIODIVERSITY / COASTAL

ECOLOGICALCA@OUTLOOK.COM

9918 4486

ECOLOGICAL CONSULTANTS AUSTRALIA

**PROJECT** PROPOSED DWELLING 12B JOHN ST, AVALON, NSW, 2107

CLIENT TIM DONOVAN TDONOVAN@CITYFREEHOLDS. A 01/12/2023 DA

COMMENTS


DATE


PAGE SIZE JOB NUM# DRAWN BY CHK. BY MV**A**3 142B PROJECT NAME SCALE 12B JOHN ST 1:100 DRAWING NAME DRAWING NUMBER GARAGE ELEVATIONS A 14 -A

--- DEMOLISHED --- HIDDEN

— — OVERHEAD EXISTING PROPOSED

NEW WORKS

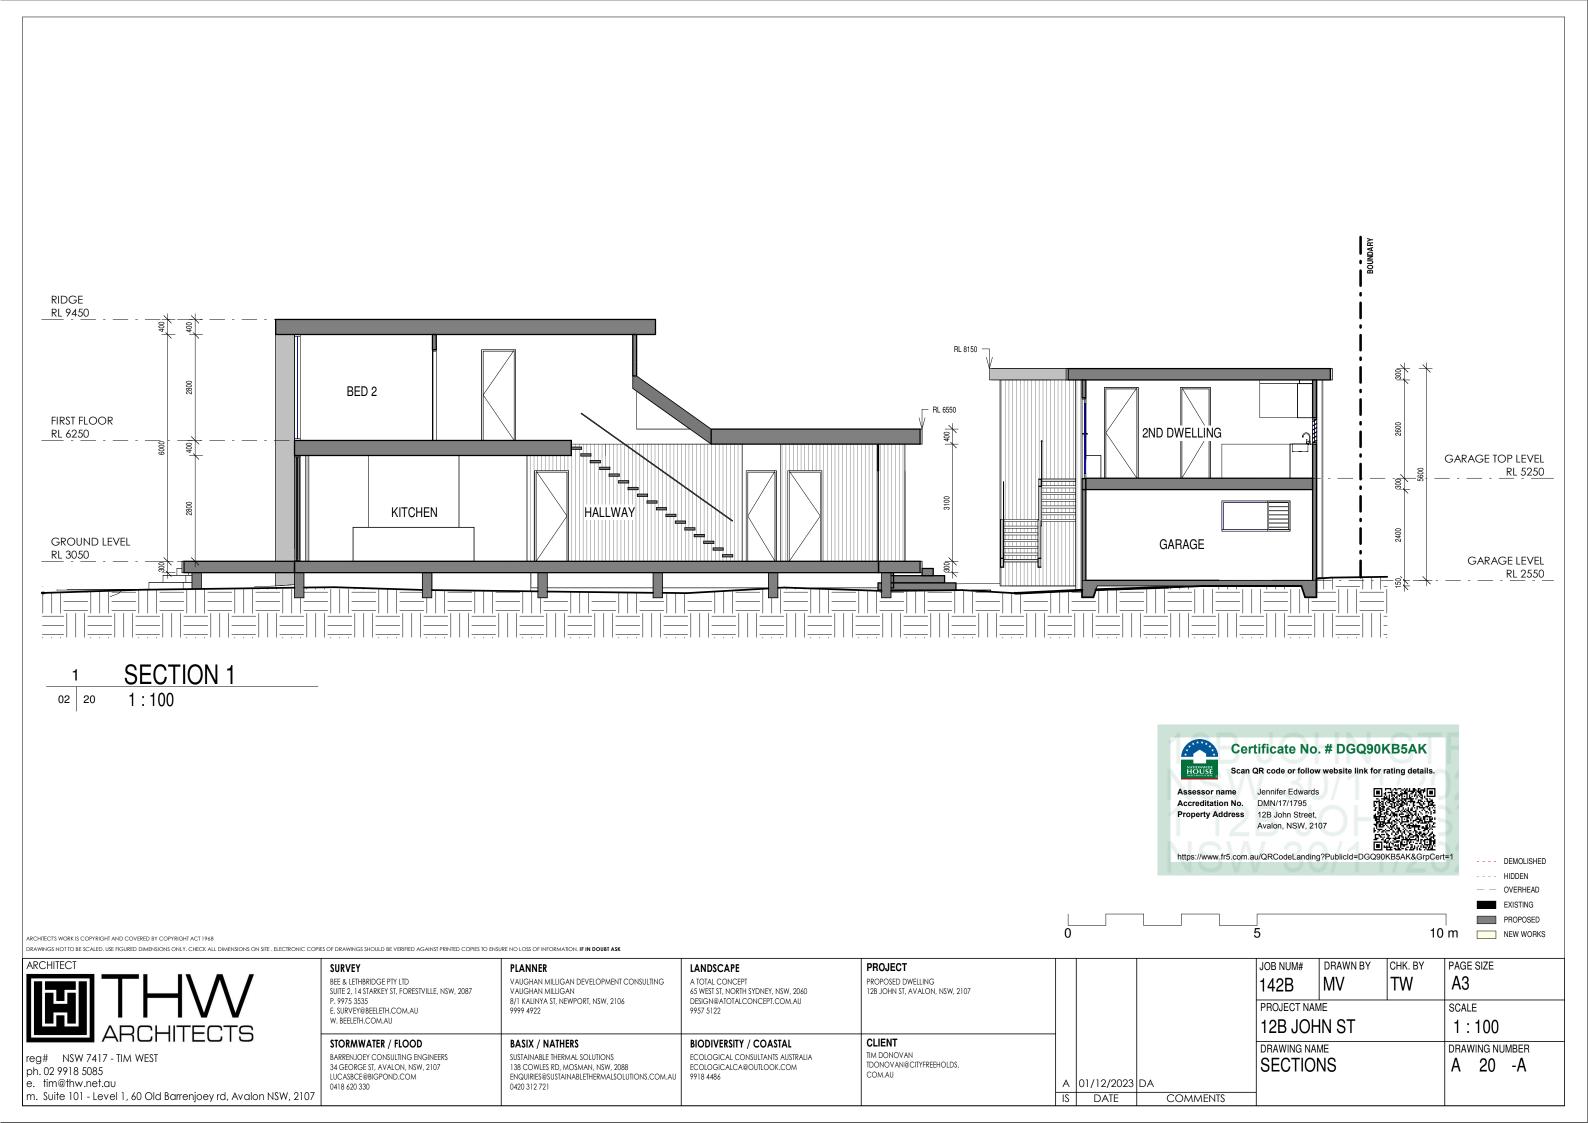

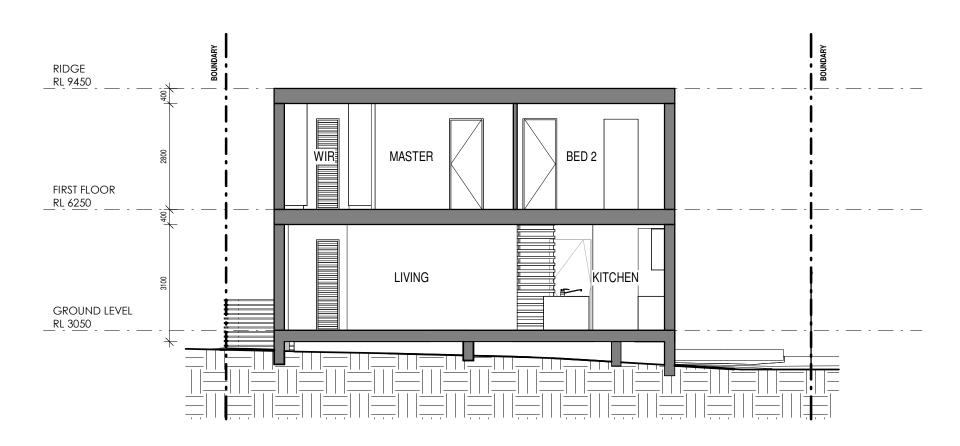

SECTION 2 1:100 02 21



ARCHITECT'S WORK IS COPYRIGHT AND COVERED BY COPYRIGHT ACT 1968

DRAWINGS NOTTO BE SCALED, USE FIGURED DIMENSIONS ONLY, CHECK ALL DIMENSIONS ON SITE. ELECTRONIC COPIES OF DRAWINGS SHOULD BE VERIFIED AGAINST PRINTED COPIES TO ENSURE NO LOSS OF INFORMATION, IF IN DOUBT ASK

ARCHITECT

reg# NSW 7417 - TIM WEST ph. 02 9918 5085

e. tim@thw.net.au m. Suite 101 - Level 1, 60 Old Barrenjoey rd, Avalon NSW, 2107

SURVEY BEE & LETHBRIDGE PTY LTD SUITE 2, 14 STARKEY ST, FORESTVILLE, NSW, 2087 P. 9975 3535 E. SURVEY@BEELETH.COM.AU

W. BEELETH.COM.AU

STORMWATER / FLOOD BARRENJOEY CONSULTING ENGINEERS

LUCASBCE@BIGPOND.COM 0418 620 330

34 GEORGE ST, AVALON, NSW, 2107

VAUGHAN MILLIGAN DEVELOPMENT CONSULTING VAUGHAN MILLIGAN 8/1 KALINYA ST, NEWPORT, NSW, 2106 9999 4922

**PLANNER** 

BASIX / NATHERS

SUSTAINABLE THERMAL SOLUTIONS

138 COWLES RD, MOSMAN, NSW, 2088 ENQUIRIES@SUSTAINABLETHERMALSOLUTIONS.COM.AU 0420 312 721

LANDSCAPE A TOTAL CONCEPT 65 WEST ST, NORTH SYDNEY, NSW, 2060 DESIGN@ATOTALCONCEPT.COM.AU 9957 5122

BIODIVERSITY / COASTAL

ECOLOGICALCA@OUTLOOK.COM 9918 4486

ECOLOGICAL CONSULTANTS AUSTRALIA

**PROJECT** PROPOSED DWELLING 12B JOHN ST, AVALON, NSW, 2107

CLIENT

TIM DONOVAN TDONOVAN@CITYFREEHOLDS. A 01/12/2023 DA

DATE


COMMENTS

į	5		10	O'm NEW V	VORKS
	JOB NUM#	DRAWN BY	CHK. BY	PAGE SIZE	
	142B	MV	TW	A3	
	PROJECT NAM	ΛE		SCALE	
	12B JOH	IN ST	1:100		
	DRAWING NAM			DRAWING NUMBE	
	SECTION	VS		A 21 -A	١

---- DEMOLISHED ---- HIDDEN - - OVERHEAD EXISTING PROPOSED



JOHN

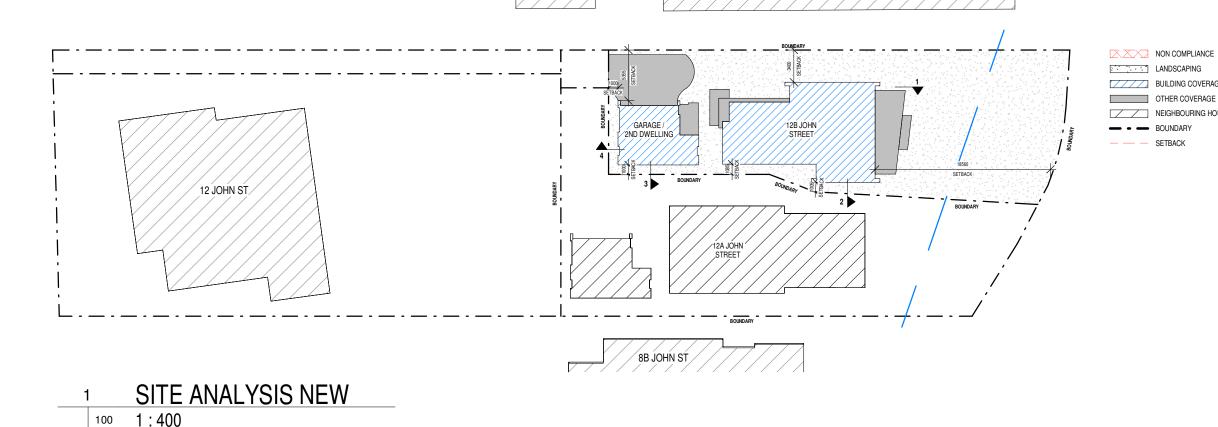

#### SITE ANALYSIS

SITE AREA 700m<sup>2</sup> ZONE E4

MAX COVERAGE 40% = 280m<sup>2</sup> BUILDING FOOTPRINT 183.2m<sup>2</sup> HARD PAVING / DECK / STAIRS 87.9m<sup>2</sup> PRO COVERAGE 271.1m<sup>2</sup> = 38.7%

REQ LANDSCAPE 60% = 420m<sup>2</sup> PRO LANDSCAPE 428.9m<sup>2</sup> = 61.3%

MAX HEIGHT PRO HEIGHT 8.5m 7.34m


REQ FRONT SETBACK 6.50m PRO FRONT SETBACK HOUSE PRO FRONT SETBACK GARAGE 12.1m 1.00m

REQ REAR SETBACK 6.50m PRO REAR SETBACK HOUSE 18.56m PRO REAR SETBACK GARAGE 37.71m

REQ SIDE SETBACK 1.00m / 2.50m PRO SIDE SETBACK HOUSE 1.08m / 3.40m PRO SIDE SETBACK GARAGE 1.00m / 5.36m

PLANNER

BASIX / NATHERS

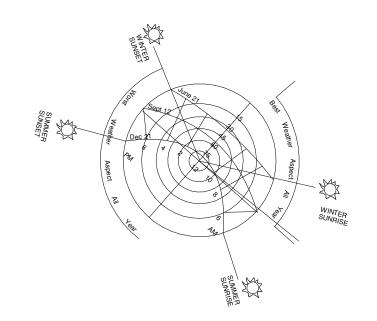

Certificate No. # DGQ90KB5AK

Accreditation No.

DMN/17/1795 12B John Street Avalon, NSW, 2107

BUILDING COVERAGE OTHER COVERAGE NEIGHBOURING HOUSE

BOUNDARY SETBACK

https://www.fr5.com.au/QRCodeLanding?PublicId=DGQ90KB5AK&GrpCert=

RCHITECT'S WORK IS COPYRIGHT AND COVERED BY COPYRIGHT ACT 1968

DRAWINGS NOT TO BE SCALED, USE FIGURED DIMENSIONS ONLY, CHECK ALL DIMENSIONS ON SITE: ELECTRONIC COPIES OF DRAWINGS SHOULD BE VERIFIED AGAINST PRINTED COPIES TO ENSURE NO LOSS OF INFORMATION, IF IN DOUBT ASK



reg# NSW 7417 - TIM WEST ph. 02 9918 5085 e. tim@thw.net.au

m. Suite 101 - Level 1, 60 Old Barrenjoey rd, Avalon NSW, 2107

SURVEY

BEE & LETHBRIDGE PTY LTD SUITE 2, 14 STARKEY ST, FORESTVILLE, NSW, 2087 P. 9975 3535 E. SURVEY@BEELETH.COM.AU

VAUGHAN MILLIGAN DEVELOPMENT CONSULTING VAUGHAN MILLIGAN 8/1 KALINYA ST, NEWPORT, NSW, 2106 9999 4922

SUSTAINABLE THERMAL SOLUTIONS

138 COWLES RD, MOSMAN, NSW, 2088

ENQUIRIES@SUSTAINABLETHERMALSOLUTIONS.COM.AU 0420 312 721

LANDSCAPE A TOTAL CONCEPT 65 WEST ST, NORTH SYDNEY, NSW, 2060 DESIGN@ATOTALCONCEPT.COM.AU 9957 5122

BIODIVERSITY / COASTAL

ECOLOGICALCA@OUTLOOK.COM

9918 4486

ECOLOGICAL CONSULTANTS AUSTRALIA

**PROJECT** PROPOSED DWELLING 12B JOHN ST, AVALON, NSW, 2107

TIM DONOVAN TDONOVAN@CITYFREEHOLDS.

CLIENT

A 01/12/2023 DA DATE COMMENTS


JOB NUM#	DRAWN BY	CHK. BY	PAGE SIZE
142B	MV	TW	A3
PROJECT NAM	ИE		SCALE
12B JOH	IN ST		As indicated
DRAWING NAM			DRAWING NUMBER
SITE AN	ALYSIS		A 100 -A


#### STORMWATER / FLOOD BARRENJOEY CONSULTING ENGINEERS

LUCASBCE@BIGPOND.COM 0418 620 330


34 GEORGE ST, AVALON, NSW, 2107

W. BEELETH.COM.AU

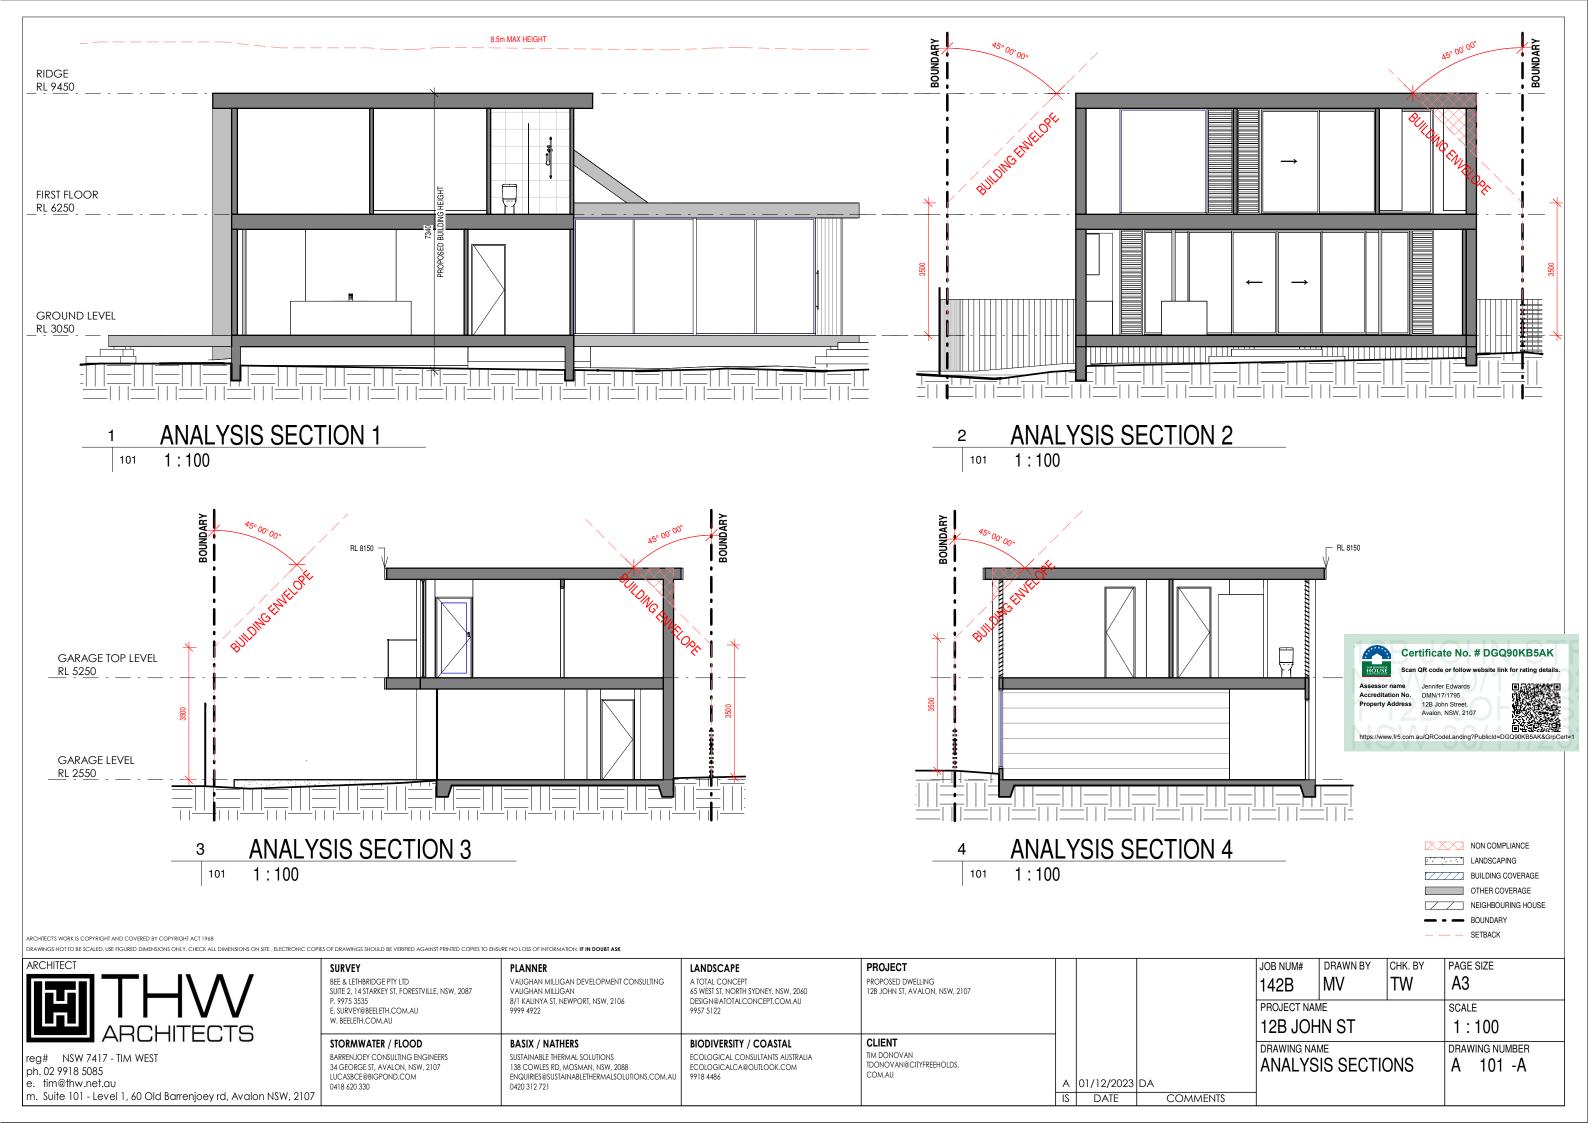

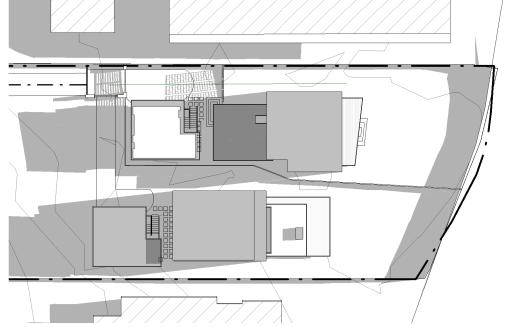

**SHADOWS 9AM JUNE 21ST** 

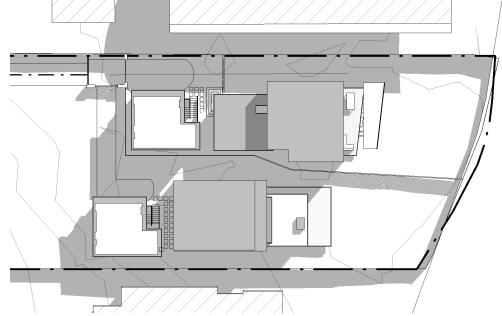

SHADOWS 12PM JUNE 21ST

102



SHADOWS 3PM JUNE 21ST

102





PAGE SIZE

А3

RCHITECT'S WORK IS COPYRIGHT AND COVERED BY COPYRIGHT ACT 1968

DRAWINGS NOT TO BE SCALED, USE FIGURED DIMENSIONS ONLY, CHECK ALL DIMENSIONS ON SITE, ELECTRONIC COPIES OF DRAWINGS SHOULD BE VERIFIED AGAINST PRINTED COPIES TO ENSURE NO LOSS OF INFORMATION, IF IN DOUBT ASK



reg# NSW 7417 - TIM WEST ph. 02 9918 5085 e. tim@thw.net.au

m. Suite 101 - Level 1, 60 Old Barrenjoey rd, Avalon NSW, 2107

W. BEELETH.COM.AU

STORMWATER / FLOOD

34 GEORGE ST, AVALON, NSW, 2107

BEE & LETHBRIDGE PTY LTD SUITE 2, 14 STARKEY ST, FORESTVILLE, NSW, 2087 P. 9975 3535 E. SURVEY@BEELETH.COM.AU

PLANNER VAUGHAN MILLIGAN DEVELOPMENT CONSULTING VAUGHAN MILLIGAN 8/1 KALINYA ST, NEWPORT, NSW, 2106 9999 4922

LANDSCAPE A TOTAL CONCEPT 65 WEST ST, NORTH SYDNEY, NSW, 2060 DESIGN@ATOTALCONCEPT.COM.AU 9957 5122

BIODIVERSITY / COASTAL

**PROJECT** PROPOSED DWELLING 12B JOHN ST, AVALON, NSW, 2107

> CLIENT TIM DONOVAN TDONOVAN@CITYFREEHOLDS.

JOB NUM# 142B PROJECT NAME

DRAWN BY CHK. BY MV

SCALE 12B JOHN ST 1:500

DRAWING NAME DRAWING NUMBER SHADOW PLANS A 102 -A

BARRENJOEY CONSULTING ENGINEERS SUSTAINABLE THERMAL SOLUTIONS 138 COWLES RD, MOSMAN, NSW, 2088 ENQUIRIES@SUSTAINABLETHERMALSOLUTIONS.COM.AU 0420 312 721

BASIX / NATHERS

ECOLOGICAL CONSULTANTS AUSTRALIA ECOLOGICALCA@OUTLOOK.COM 9918 4486

A 01/12/2023 DA DATE COMMENTS

LUCASBCE@BIGPOND.COM 0418 620 330



3D SHADOWS JUNE 21ST 9AM

103



3D SHADOWS JUNE 21ST 12AM

103



3D SHADOWS JUNE 21ST 3PM

103



DRAWN BY

JOB NUM#

RCHITECT'S WORK IS COPYRIGHT AND COVERED BY COPYRIGHT ACT 1968

DRAWINGS NOT TO BE SCALED. USE FIGURED DIMENSIONS ONLY, CHECK ALL DIMENSIONS ON SITE. ELECTRONIC COPIES OF DRAWINGS SHOULD BE VERIFIED AGAINST PRINTED COPIES TO ENSURE NO LOSS OF INFORMATION, IF IN DOUBT ASK



reg# NSW 7417 - TIM WEST ph. 02 9918 5085 e. tim@thw.net.au

m. Suite 101 - Level 1, 60 Old Barrenjoey rd, Avalon NSW, 2107

SURVEY

W. BEELETH.COM.AU

BEE & LETHBRIDGE PTY LTD SUITE 2, 14 STARKEY ST, FORESTVILLE, NSW, 2087 P. 9975 3535 E. SURVEY@BEELETH.COM.AU

VAUGHAN MILLIGAN 8/1 KALINYA ST, NEWPORT, NSW, 2106 9999 4922

BASIX / NATHERS

**PLANNER** 

VAUGHAN MILLIGAN DEVELOPMENT CONSULTING

LANDSCAPE A TOTAL CONCEPT 65 WEST ST, NORTH SYDNEY, NSW, 2060 DESIGN@ATOTALCONCEPT.COM.AU

BIODIVERSITY / COASTAL

**PROJECT** 

CLIENT

PROPOSED DWELLING 12B JOHN ST, AVALON, NSW, 2107

TIM DONOVAN TDONOVAN@CITYFREEHOLDS.

MV TW 142B **A**3 PROJECT NAME SCALE 12B JOHN ST DRAWING NAME DRAWING NUMBER SHADOW 3D'S A 103 -A

CHK. BY

PAGE SIZE

A 01/12/2023 DA DATE COMMENTS

34 GEORGE ST, AVALON, NSW, 2107 LUCASBCE@BIGPOND.COM 0418 620 330

STORMWATER / FLOOD

BARRENJOEY CONSULTING ENGINEERS


SUSTAINABLE THERMAL SOLUTIONS 138 COWLES RD, MOSMAN, NSW, 2088 ENQUIRIES@SUSTAINABLETHERMALSOLUTIONS.COM.AU 0420 312 721

ECOLOGICAL CONSULTANTS AUSTRALIA ECOLOGICALCA@OUTLOOK.COM 9918 4486





WALL CALDDING: TIMBER NATURAL FINISH

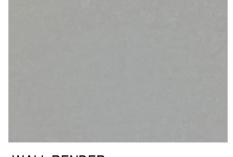

WALL RENDER: GREY



WINDOW FRAMES: PC FINISH **BLACK** 

RCHITECT'S WORK IS COPYRIGHT AND COVERED BY COPYRIGHT ACT 1968

DRAWINGS NOT TO BE SCALED. USE FIGURED DIMENSIONS ONLY, CHECK ALL DIMENSIONS ON SITE , ELECTRONIC COPIES OF DRAWINGS SHOULD BE VERIFIED AGAINST PRINTED COPIES TO ENSURE NO LOSS OF INFORMATION, IF IN DOUBT ASK

reg# NSW 7417 - TIM WEST ph. 02 9918 5085 e. tim@thw.net.au

m. Suite 101 - Level 1, 60 Old Barrenjoey rd, Avalon NSW, 2107

SURVEY

BEE & LETHBRIDGE PTY LTD SUITE 2, 14 STARKEY ST, FORESTVILLE, NSW, 2087 P. 9975 3535

E. SURVEY@BEELETH.COM.AU W. BEELETH.COM.AU

**PLANNER** VAUGHAN MILLIGAN DEVELOPMENT CONSULTING VAUGHAN MILLIGAN 8/1 KALINYA ST, NEWPORT, NSW, 2106 9999 4922

LANDSCAPE

A TOTAL CONCEPT

65 WEST ST., NORTH SYDNEY, NSW, 2060
DESIGN@ATOTALCONCEPT.COM.AU
9957 5122

**PROJECT** PROPOSED DWELLING 12B JOHN ST, AVALON, NSW, 2107

CLIENT

A 01/12/2023 DA

COMMENTS

DRAWN BY CHK. BY JOB NUM# MV 142B PROJECT NAME 12B JOHN ST

А3 SCALE

PAGE SIZE

DRAWING NAME

DRAWING NUMBER **EXTERNAL FINISHES** A 104 -A

MANAMANANA MANAMANANANA

STORMWATER / FLOOD BASIX / NATHERS

mmmmmmm

BARRENJOEY CONSULTING ENGINEERS 34 GEORGE ST, AVALON, NSW, 2107 LUCASBCE@BIGPOND.COM 0418 620 330

ECOLOGICAL CONSULTANTS AUSTRALIA ECOLOGICALCA@OUTLOOK.COM 9918 4486

DATE

BIODIVERSITY / COASTAL SUSTAINABLE THERMAL SOLUTIONS
138 COWIES RD, MOSMAN, NSW, 2088
ENQUIRIES@SUSTAINABLETHERMALSOLUTIONS.COM.AU
0420 312 721

TIM DONOVAN TDONOVAN@CITYFREEHOLDS.



3D VIEW 1



3D VIEW 3

105

RCHITECT'S WORK IS COPYRIGHT AND COVERED BY COPYRIGHT ACT 1968 DRAWINGS NOT TO BE SCALED, USE FIGURED DIMENSIONS ONLY, CHECK ALL DIMENSIONS ON SITE. ELECTRONIC COPIES OF DRAWINGS SHOULD BE VERIFIED AGAINST PRINTED COPIES TO ENSURE NO LOSS OF INFORMATION, IF IN DOUBT ASK

reg# NSW 7417 - TIM WEST ph. 02 9918 5085

e. tim@thw.net.au

m. Suite 101 - Level 1, 60 Old Barrenjoey rd, Avalon NSW, 2107

SURVEY

BEE & LETHBRIDGE PTY LTD SUITE 2, 14 STARKEY ST, FORESTVILLE, NSW, 2087 P. 9975 3535

E. SURVEY@BEELETH.COM.AU W. BEELETH.COM.AU

STORMWATER / FLOOD

BARRENJOEY CONSULTING ENGINEERS 34 GEORGE ST. AVALON, NSW, 2107 LUCASBCE@BIGPOND.COM 0418 620 330

**PLANNER** 

BASIX / NATHERS

VAUGHAN MILLIGAN DEVELOPMENT CONSULTING VAUGHAN MILLIGAN 8/1 KALINYA ST, NEWPORT, NSW, 2106 9999 4922

SUSTAINABLE THERMAL SOLUTIONS
138 COWIES RD, MOSMAN, NSW, 2088
ENQUIRIES@SUSTAINABLETHERMALSOLUTIONS.COM.AU
0420 312 721

A TOTAL CONCEPT 65 WEST ST, NORTH SYDNEY, NSW, 2060 DESIGN@ATOTALCONCEPT.COM.AU 9957 5122

BIODIVERSITY / COASTAL

ECOLOGICALCA@OUTLOOK.COM 9918 4486

ECOLOGICAL CONSULTANTS AUSTRALIA

LANDSCAPE

CLIENT TIM DONOVAN TDONOVAN@CITYFREEHOLDS. COM.AU

**PROJECT** PROPOSED DWELLING 12B JOHN ST, AVALON, NSW, 2107

A 01/12/2023 DA

COMMENTS

DATE

JOB NUM# DRAWN BY CHK. BY PAGE SIZE MV TW 142B А3 PROJECT NAME SCALE 12B JOHN ST DRAWING NAME DRAWING NUMBER 3D VIEWS A 105 -A

3D VIEW 2

105



(i) Water	Show on DA plans	Show on CC/CDC plans & specs	Certifier check
(a) The applicant must comply with the commitments listed below in carrying out the development of a dwelling listed in a table below.			
(b) The applicant must plant indigenous or low water use species of vegetation throughout the area of land specified for the dwelling in the "Indigenous species" column of the table below, as private landscaping for that dwelling. (This area of indigenous vegetation is to be contained within the "Area of garden and lawn" for the dwelling specified in the "Description of Project" table).	~	~	
(c) If a rating is specified in the table below for a fixture or appliance to be installed in the dwelling, the applicant must ensure that each such fixture and appliance meets the rating specified for it.		~	V
(d) The applicant must install an on demand hot water recirculation system which regulates all hot water use throughout the dwelling, where indicated for a dwelling in the "HW recirculation or diversion" column of the table below.		~	V
(e) The applicant must install:			
(aa) a hot water diversion system to all showers, kitchen sinks and all basins in the dwelling, where indicated for a dwelling in the "HW recirculation or diversion" column of the table below; and		~	V
(bb) a separate diversion tank (or tanks) connected to the hot water diversion systems of at least 100 litres. The applicant must connect the hot water diversion tank to all toilets in the dwelling.		~	-
(e) The applicant must not install a private swimming pool or spa for the dwelling, with a volume exceeding that specified for it in the table below.	V	~	
(f) If specified in the table, that pool or spa (or both) must have a pool cover or shading (or both).		~	
(g) The pool or spa must be located as specified in the table.	V	~	
(h) The applicant must install, for the dwelling, each alternative water supply system, with the specified size, listed for that dwelling in the table below. Each system must be configured to collect run-off from the areas specified (excluding any area which supplies any other alternative water supply system) and to divert overflow as specified. Each system must be connected as pecified.	~	~	~

Fixtures				Appliances			Individual pool			Individual spa				
Dwelling no.	All shower- heads	All toilet flushing systems	taps	All bathroom taps	HW recirculation or diversion	All clothes washers	All dish- washers	Volume (max volume)		Pool location	Pool shaded	Volume (max volume)	Spa cover	Spa shaded
	4 star (> 4.5 but <=	5 star	5 star	5 star	-	-	-	-	-	-	-	-	-	-

	Alternative water source									
Dwelling no.	Alternative water supply systems	Size	Configuration	Landscape connection	Toilet connection (s)	Laundry connection	Pool top- up	Spa top-up		
Main	Central water tank (No. 1)	See central systems	See central systems	yes	yes	no	no	no		
Main	No alternative water supply	-	-	-	-		-	-		
All other dwellings	Central water tank (No. 1)	See central systems	See central systems	yes	no	no	no	no		
All other dwellings	No alternative water supply	-	2	-	-	51	5	5		

(ii) Energy	Show on DA plans	Show on CC/CDC plans & specs	Certifier check
(a) The applicant must comply with the commitments listed below in carrying out the development of a dwelling listed in a table below.			
(b) The applicant must install each hot water system specified for the dwelling in the table below, so that the dwelling's hot water is supplied by that system. If the table specifies a central hot water system for the dwelling, then the applicant must connect that central system to the dwelling, so that the dwelling's hot water is supplied by that central system.	*	~	~
(c) The applicant must install, in each bathroom, kitchen and laundry of the dwelling, the ventilation system specified for that room in the table below. Each such ventilation system must have the operation control specified for it in the table.		~	~
(d) The applicant must install the cooling and heating system's specified for the dwelling under the "Living areas" and "Bedroom areas" headings of the "Cooling" and "Heating" columns in the table below, in/for at least 1 invigibedroom area of the dwelling. If no cooling or heating system is specified in the table for "Living areas" or "Bedroom areas"; then no systems may be installed in any such areas. If the term "zoned" is specified beside an air conditioning system, then the system must provide for day/night zoning between living areas and bedrooms.		•	~

ii) Energy	Show on DA plans	Show on CC/CDC plans & specs	Certifier check
(e) This commitment applies to each room or area of the dwelling which is referred to in a heading to the "Artificial lighting" column of the table below (but only to the extent specified for that torom or area). The applicant must ensure that the "primary type of artificial lighting" for each such room in the dwelling is fluorescent lighting or light entitling diode (LED) lighting. If the term "dedicated" is specified for a particular room or area, then the light fittings in that room or area must only be capable of being used for fluorescent lighting or light emitting diode (LED) lighting.		~	~
(f) This commitment applies to each room or area of the dwelling which is referred to in a heading to the "Natural lighting" column of the table below (but only to the extent specified for that room or area). The applicant must ensure that each such room or area is fitted with a window and/or skylight.	~	~	~
(g) This commitment applies if the applicant installs a water heating system for the dwelling's pool or spa. The applicant must:			
(aa) install the system specified for the pool in the "Individual Pool" column of the table below (or alternatively must not install any system for the pool). If specified, the applicant must install a timer, to control the pool's pump; and		~	
(bb) install the system specified for the spa in the "individual Spa" column of the table below (or alternatively must not install any system for the spa). If specified, the applicant must install a timer to control the spa's pump.		<b>✓</b>	
h) The applicant must install in the dwelling:			
<ul><li>(aa) the kitchen cook-top and oven specified for that dwelling in the "Appliances &amp; other efficiency measures" column of the table below;</li></ul>		~	
(bb) each appliance for which a rating is specified for that dwelling in the "Appliances & other efficiency measures" column of the table, and ensure that the appliance has that minimum rating; and		<b>~</b>	~
(cc) any clothes drying line specified for the dwelling in the "Appliances & other efficiency measures" column of the table.		~	
) If specified in the table, the applicant must carry out the development so that each refrigerator space in the dwelling is "well ventilated"			

	Hot water	Bathroom ven	tilation system	Kitchen venti	lation system	Laundry ventilation system		
Dwelling no.	Hot water system	Each bathroom	Operation control	Each kitchen	Operation control	Each laundry	Operation control	
All dwellings	gas instantaneous - 6 star	individual fan, ducted to façade or roof		individual fan, ducted to façade or roof	manual switch on/off	individual fan, ducted to façade or roof	manual switch on/off	

		Coc	oling	Hea	ting	Natural lighting		
	Dwelling no.	living areas	bedroom areas	living areas	bedroom areas	No. of bathrooms or toilets	Main kitchen	
	Main	-	-	-	-	3	yes	
l	All other dwellings	-	2	-	-	1	yes	

		dividual pool		Individual s	pa	Appliances other efficiency measures				
Dwelling no.	Pool heating system	Pool Pump	Timer	Spa heating system	Timer	Kitchen cooktop/oven	Dishwasher	Clothes dryer	Indoor or sheltered clothes drying line	Private outdoor or unsheltered clothes drying line
All dwellings	-	-	-	-	-	gas cooktop & electric oven	-	-	yes	yes

	Alternative energy	
Photovoltaic system (min rated electrical output in peak kW)	Photovoltaic collector installation	Orientation inputs
-	-	=
		Photovoltaic system (min rated electrical Photovoltaic collector installation

(iii) Thermal Performance	Show on DA plans	Show on CC/CDC plans & specs	Certifier check
(a) The applicant must attach the certificate referred to under "Assessor details" on the front page of this BASIX certificate (the "Assessor Certificate") to the development application and construction certificate application for the proposed development (or, if the applicant is applying for a complying development certificate for the proposed development, to that application). The applicant must also attach the Assessor Certificate to the application for a final occupation certificate for the proposed development.			
(b) The Assessor Certificate must have been issued by an Accredited Assessor in accordance with the Thermal Comfort Protocol.			
(c) The details of the proposed development on the Assessor Certificate must be consistent with the details shown in this BASIX Certificate, including the details shown in the "Thermal Loads" table below.			
(d) The applicant must show on the plans accompanying the development application for the proposed development, all matters which the Thermal Comfort Protocol requires to be shown on those plans. Those plans must bear a stamp of endorsement from the Accredited Assessor, to certify that this is the case.	~		

(iii) Thermal Performance	Show on DA plans	Show on CC/CDC plans & specs	Certifier check
(e) The applicant must show on the plans accompanying the application for a construction certificate (or complying development certificate, if applicable), all thermal performance specifications set out in the Assessor Certificate, and all aspects of the proposed development which were used to calculate those specifications.		~	
(f) The applicant must construct the development in accordance with all thermal performance specifications set out in the Assessor Certificate, and in accordance with those aspects of the development application or application for a complying development certificate which were used to calculate those specifications.		~	~
(g) Where there is an in-slab heating or cooling system, the applicant must:	V	~	~
(aa) Install insulation with an R-value of not less than 1.0 around the vertical edges of the perimeter of the slab; or			
(bb) On a suspended floor, install insulation with an R-value of not less than 1.0 underneath the slab and around the vertical edges of the perimeter of the slab.			
(h) The applicant must construct the floors and walls of the development in accordance with the specifications listed in the table below.	~	~	~
(i) The applicant must show on The plans accompanying The development application for The proposed development, The locations of ceiling fans set out in The Assessor Certificate.	V		
(j) The applicant must show on the plans accompanying the application for a construction certificate (or complying development certificate, if applicable), the locations of ceiling fans set out in the Assessor Certificate.		~	

	Thermal loads							
Dwelling no.	Area adjusted heating load (in MJ/m²/yr)	Area adjusted cooling load (in MJ/m²/yr)	Area adjusted total load (in MJ/m²/yr)					
Main	16.1	13.6	29.700					
All other dwellings	18.3	11.1	29.400					

		Construction of floors and walls										
Dwelling no.	Concrete slab on ground (m²)	Suspended floor with open subfloor (m²)	Suspended floor with enclosed subfloor (m²)	Suspended floor above garage (m²)	Primarily rammed earth or mudbrick walls							
Main	-1	-	127	-	no							
All other dwellings	54	=	-	43	no							

	Floor types											
		Concrete	slab on ground	1	Suspended flo	or above encl	osed subfloor	Suspended	ded floor above open subfloor			
Dwelling no.	Area (m²)	Insulation	Low emissions option	Dematerialisation	Construction type	Area (m²)	Insulation	Construction type	Area (m²)	Insulation		
Main	-	-	-	-	-	127	(-)	-	-	-		
All other dwellings	-	-	-	conventional slab	-	-	-		-	-		

	Floor types												
Dwelling no.		oor above ha		Suspend	ed floor abov	e garage			Garage flo	oor	Dematerialisation		
	Construction type	Area (m²)	Insulation	Construction type	Area (m²)	Insulation	Construction type	Area (m²)	Insulation	Low emissions option	Dematerialisation		
Main	-	-	-	-	-	-	-	-	-	-	-		
All other dwellings	-	-	ē	particle board, frame: timber - H2 treated softwood	43	fibreglass batts or roll	concrete slab on ground	43	-	none	conventional slab		

	External walls										
		Exter	nal wall type 1		External wall type 2						
Dwelling no.	Wall type	Area (m²)	Insulation	Low emissions option	Wall type	Area (m²)	Insulation	Low emissions option			
Main	framed (fibre cement sheet or boards), frame : timber - H2 treated softwood	262	fibreglass batts or roll	-	-	-	-	71			
All other dwellings	framed (fibre cement sheet or boards), frame : timber - H2 treated softwood	89	fibreglass batts or roll	-	-		-	n.			

	Internal walls	nternal walls											
	Interna	l walls shared wit	h garage		Internal wall typ	e 1		Internal wall type	2				
Dwelling no.	Wall type	Area (m²)	Insulation	Wall type	Area (m²)	Insulation	Wall type	Area (m²)	Insulation				
Main	-	-	-	plasterboard, frame: timber - H2 treated softwood	181	fibreglass batts or roll	-	-	-				
All other dwellings	-		-	plasterboard, frame: timber - H2 treated softwood	22	fibreglass batts or roll	-	-	= 1				

	Ceiling and roo	of							
Dwelling no.	Flat ceiling / pitched roof			Raked ceiling / pitched or skillion roof			Flat ceiling / flat roof		
	Construction type	Area (m²)	Insulation	Construction type	Area (m²)	Insulation	Construction type	Area (m²)	Insulation
Main	=	-	-	-	-	-	framed - metal roof, frame: timber - H2 treated softwood	151	-
All other dwellings	7	-	-	-	E)	-	framed - metal roof, frame: timber - H2 treated softwood	64	-
(i) Materials					1000		Show on	Show on CC/0	CDC Certifie

(i) Materials	Show on DA plans	Show on CC/CDC plans & specs	Certifie
(a) The details of the proposed development on the Assessor Certificate must be consistent with the details shown in this BASIX Certificate, including the details shown in the "Floor types", "External wall types", "Internal wall types", "Ceiling and roof types", "Frames" and "Glazing" tables below.			~
(b) The applicant must show on the plans accompanying the application for a construction certificate (or complying development certificate, if applicable), all specifications included in the tables below.		~	
(c) The applicant must construct the floors, walls, roof, ceiling and roof, windows, glazed doors and skylights of the development in accordance with the specifications isted in the tables below. In the case of glazing, a 5% variance from the area values listed in the 'Frames' and 'Glazing' tables is permitted.	~	~	~
(d) The applicant must show through receipts that the materials purchased for construction are consistent with the specifications listed in the below tables.			V
(i) Water	Show on DA plans	Show on CC/CDC plans & specs	Certifier check
(a) If, in carrying out the development, the applicant installs a showerhead, toilet, tap or clothes washer into a common area, then that item must meet the specifications listed for it in the table.		~	~
(b) The applicant must install (or ensure that the development is serviced by) the alternative water supply system(s) specified in the "Central systems" column of the table below. In each case, the system must be sized, be configured, and be connected, as specified in the table.	~	~	~
(c) A swimming pool or spa listed in the table must not have a volume (in kLs) greater than that specified for the pool or spa in the table.	V	V	
(d) A pool or spa listed in the table must have a cover or shading if specified for the pool or spa in the table.		~	
(e) The applicant must install each fire sprinkler system listed in the table so that the system is configured as specified in the table.		~	~
(f) The applicant must ensure that the central cooling system for a cooling tower is configured as specified in the table.		~	~
(ii) Energy	Show on DA plans	Show on CC/CDC plans & specs	Certifier
(b) In carrying out the development, the applicant must install, as the "primary type of artificial lighting" for each common area specified in the table below, the lighting specified for that common area. This lighting must meet the efficiency measure specified. The applicant must also install a centralised lighting control system or Building Management System (BMS) for the common area, where specified.		~	~
(c) The applicant must install the systems and fixtures specified in the "Central energy systems" column of the table below. In each case, the system or fixture must be of the type, and meet the specifications, listed for it in the table.			_



Certificate No. # DGQ90KB5AK

Accreditation No.

DMN/17/1795 12B John Street, Avalon, NSW, 2107

https://www.fr5.com.au/QRCodeLanding?PublicId=DGQ90KB5AK&GrpCert=1

CHK. BY

ARCHITECT'S WORK IS COPYRIGHT AND COVERED BY COPYRIGHT ACT 1968

DRAWINGS NOTTO BE SCALED, USE FIGURED DIMENSIONS ONLY, CHECK ALL DIMENSIONS ON SITE. ELECTRONIC COPIES OF DRAWINGS SHOULD BE VERIFIED AGAINST PRINTED COPIES TO ENSURE NO LOSS OF INFORMATION, IF IN DOUBT ASK



reg# NSW 7417 - TIM WEST ph. 02 9918 5085

e. tim@thw.net.au

m. Suite 101 - Level 1, 60 Old Barrenjoey rd, Avalon NSW, 2107

SURVEY BEE & LETHBRIDGE PTY LTD SUITE 2, 14 STARKEY ST, FORESTVILLE, NSW, 2087 P. 9975 3535 E. SURVEY@BEELETH.COM.AU W. BEELETH.COM.AU

**PLANNER** VAUGHAN MILLIGAN DEVELOPMENT CONSULTING VAUGHAN MILLIGAN 8/1 KALINYA ST, NEWPORT, NSW, 2106 9999 4922

BASIX / NATHERS

LANDSCAPE A TOTAL CONCEPT 65 WEST ST, NORTH SYDNEY, NSW, 2060 DESIGN@ATOTALCONCEPT.COM.AU 9957 5122 **PROJECT** PROPOSED DWELLING 12B JOHN ST, AVALON, NSW, 2107

A 01/12/2023 DA

COMMENTS

DATE

MV 142B PROJECT NAME 12B JOHN ST

JOB NUM#

А3 SCALE DRAWING NUMBER

PAGE SIZE

DRAWING NAME BASIX & NATHERS

DRAWN BY

A 106 -A

LUCASBCE@BIGPOND.COM 0418 620 330

STORMWATER / FLOOD

BARRENJOEY CONSULTING ENGINEERS

34 GEORGE ST, AVALON, NSW, 2107

SUSTAINABLE THERMAL SOLUTIONS 138 COWLES RD, MOSMAN, NSW, 2088 ENQUIRIES@SUSTAINABLETHERMALSOLUTIONS.COM.AU 0420 312 721

BIODIVERSITY / COASTAL ECOLOGICAL CONSULTANTS AUSTRALIA ECOLOGICALCA@OUTLOOK.COM 9918 4486

CLIENT TIM DONOVAN TDONOVAN@CITYFREEHOLDS.