12A JOHN STREET AVALON, NSW, 2107

SHEET LIST:

00 - COVER PAGE 01 - SITE PLAN

02 - GROUND FLOOR PLAN

03 - FIRST FLOOR PLAN

10 - ELEVATIONS

11 - ELEVATIONS

12 - ELEVATIONS

13 - ELEVATIONS

14 - ELEVATIONS

20 - SECTIONS

21 - SECTIONS

100 - SITE ANALYSIS

101 - ANALYSIS SECTIONS

102 - SHADOW PLANS

103 - SHADOW 3D'S

104 - COLOUR & FINISHES

105 - 3D'S

106 - BASIX & NATHERS

Construction Material	s s	Insulation	Colour - Solar Absorpt.	Other Detail/Requirements
Weatherboard	Plasterboard lined	R4.1	Medium (0.475 to 0.70)	Walls as marked
Fibre Cement	Plasterboard lined	R1.8	Medium (0.475 to 0.70)	Main Dwelling: 12A (Cavity slider wall dining room)
Fibre Cement	Plasterboard lined	R4.1	Medium (0.475 to 0.70)	Walls as marked
Plasterboard on studs		R3.6		Granny Flats: All internal walls
Plasterboard on studs		R2.7	-3	Main Dwellings 128 wet areas
Plasterboard on studs		R2.5		Main Dwelling 12A: All wet areas
Plasterboard on studs		None		Main Dwellings 12A and 12B: All other areas
Alum SG Clear: U = 6.70: SF	IGC = 0.57			Granny flat A and B: All garage windows
Alum DG Argon Fill High Sol	ar Gain low-E -Clear: U = 4.1: SHGC = 0.52			Granny flat A and B: Sliding window
Aluminium Louvre Secondary Glaze SG 6mmLE: U = 3.71: SHGC = 0.54		17		Louvre windows in all dwellings (except garages). WA16
Al Thermally Broken DG Air Fill High Solar Gain low-E -Clear: U = 3.1: SHGC = 0.49				All other windows
Metal Deck		R9.2	Medium (0.475 to 0.70)	
Timber				As above
Concrete		None		Granny flats ground floor
Timber		R4.1		Main dwelling floors. Granny flats first floors
Timber	All other rooms			As drawn
Ceramic Tiles	Wetareas			
Must be sealed	100			
As drawn				
None				
None				
	Weatherboard Fibre Cement Fibre Cement Plasterboard on studs Alum SG Clear: U = 6.70: SH Alum DG Argon Fill High Sol Aluminium Louvre Seconda Al Thermally Broken DG Air Metal Deck Timber Concrete Timber Timber Ceramic Tiles Must be sealed As drawn None	Fibre Cement Fibre Cement Plasterboard lined Plasterboard on studs Alum SG Clear: U = 6.70: SHGC = 0.57 Alum DG Argon Fill High Solar Gain low-E-Clear: U = 4.1: SHGC = 0.52 Aluminium Louvre Secondary Glaze SG 6mmLE: U = 3.71: SHGC = 0.54 Al Thermally Broken DG Air Fill High Solar Gain low-E-Clear: U = 3.1: SHGC = 0.49 Metal Deck Timber Concrete Timber All other rooms Ceramic Tiles Wet areas Must be sealed As drawn None	Weatherboard Plasterboard lined R4.1 Fibre Cement Plasterboard lined R1.8 Fibre Cement Plasterboard lined R4.1 Plasterboard on studs R3.6 Plasterboard on studs R2.7 Plasterboard on studs R2.7 Plasterboard on studs R2.5 Plasterboard on studs R2.5 Plasterboard on studs None Alum SG Clear: U = 6.70: SHGC = 0.57 Alum DG Argon Fill High Solar Gain low-E-Clear: U = 4.1: SHGC = 0.52 Aluminium Louvre Secondary Glaze SG 6mmLE: U = 3.71: SHGC = 0.54 Al Thermally Broken DG Air Fill High Solar Gain low-E-Clear: U = 3.1: SHGC = 0.49 Metal Deck R9.2 Timber None Timber All other rooms Ceramic Tiles Wet areas Must be sealed As drawn None	Construction Materials Insulation Absorpt. Weatherboard Plasterboard lined R4.1 Medium (0.475 to 0.70) Fibre Cement Plasterboard lined R1.8 Medium (0.475 to 0.70) Fibre Cement Plasterboard lined R4.1 Medium (0.475 to 0.70) Plasterboard on studs R3.6 R3.6 Plasterboard on studs R2.7 R2.5 Plasterboard on studs None R2.5 Alum SG Clear: U = 6.70: SHGC = 0.57 None Alum DG Argon Fill High Solar Gain low-E-Clear: U = 4.1: SHGC = 0.52 Aluminium Louvre Secondary Glaze SG 6mmLE: U = 3.71: SHGC = 0.49 Metal Deck R9.2 Medium (0.475 to 0.70) Timber None Concrete None Timber All other rooms Ceramic Tiles Wet areas Must be sealed Medium (0.475 to 0.70)



NUM#	SILL	HEIGHT	WIDT
WA01	1200	1200	2100
WA02	900	700	3000
WA03	900	700	4200
WA04	0	2800	1600
WA05	0	2800	1845
WA06	0	2800	1845
WA07	0	2800	4960
WA08	0	2800	1300
WA09	0	2800	2200
WA10 WA11	1800	1000	1400
WATI WA12	1200	1200	2000
WA12 WA13	1200	1200	2100
WAI3 WAI4	1200 1400	1200 1000	2100 2000
WA14 WA15	0	2800	2000
WA16	0	2800	3900
WA17	0	2800	2200
WA17 WA18	1800	1000	1400
WA19	0	2800	1400
WA20	1200	1200	2000
WA21	1300	800	1800
WA22	0	2400	900
WA23	1300	800	1800
WA24	0	2400	900
WA25	0	2600	6000
WA26	900	700	2550
WA27	0	2600	900



RCHITECT'S WORK IS COPYRIGHT AND COVERED BY COPYRIGHT ACT 1968

RAWINGS NOTTO BE SCALED, USE FIGURED DIMENSIONS ONLY, CHECK ALL DIMENSIONS ON SITE . ELECTRONIC COPIES OF DRAWINGS SHOULD BE VERIFIED AGAINST PRINTED COPIES TO ENSURE NO LOSS OF INFORMATION, IF IN DOUBT ASK

SURVEY

ARCHITECT	
	THVV
шш	ARCHITECTS

reg# NSW 7417 - TIM WEST ph. 02 9918 5085

e. tim@thw.net.au

m. Suite 101 - Level 1, 60 Old Barrenjoey rd, Avalon NSW, 2107

BEE & LETHBRIDGE PTY LTD SUITE 2, 14 STARKEY ST, FORESTVILLE, NSW, 2087 P. 9975 3535

E. SURVEY@BEELETH.COM.AU W. BEELETH.COM.AU

STORMWATER / FLOOD

LUCASBCF@BIGPOND.COM

BARRENJOEY CONSULTING ENGINEERS

34 GEORGE ST, AVALON, NSW, 2107

PLANNER

BASIX / NATHERS

SUSTAINABLE THERMAL SOLUTIONS

138 COWLES RD, MOSMAN, NSW, 2088

ENQUIRIES@SUSTAINABLETHERMALSOLUTIONS.COM.AU

VAUGHAN MILLIGAN DEVELOPMENT CONSULTING VAUGHAN MILLIGAN 8/1 KALINYA ST, NEWPORT, NSW, 2106

LANDSCAPE A TOTAL CONCEPT 65 WEST ST, NORTH SYDNEY, NSW, 2060 DESIGN@ATOTALCONCEPT.COM.AU

PROJECT PROPOSED DWELLING 12A JOHN ST, AVALON, NSW, 2107

CLIENT


BIODIVERSITY / COASTAL TIM DONOVAN TDONOVAN@CITYFREEHOLDS. ECOLOGICAL CONSULTANTS AUSTRALIA ECOLOGICALCA@OUTLOOK.COM


COMMENTS


A 01/12/2023 DA


DATE

DRAWN BY PAGE SIZE JOB NUM# CHK. BY **A3** MV 142A PROJECT NAME SCALE 12A JOHN ST 1:100 DRAWING NAME DRAWING NUMBER **COVER PAGE** A 00 -A

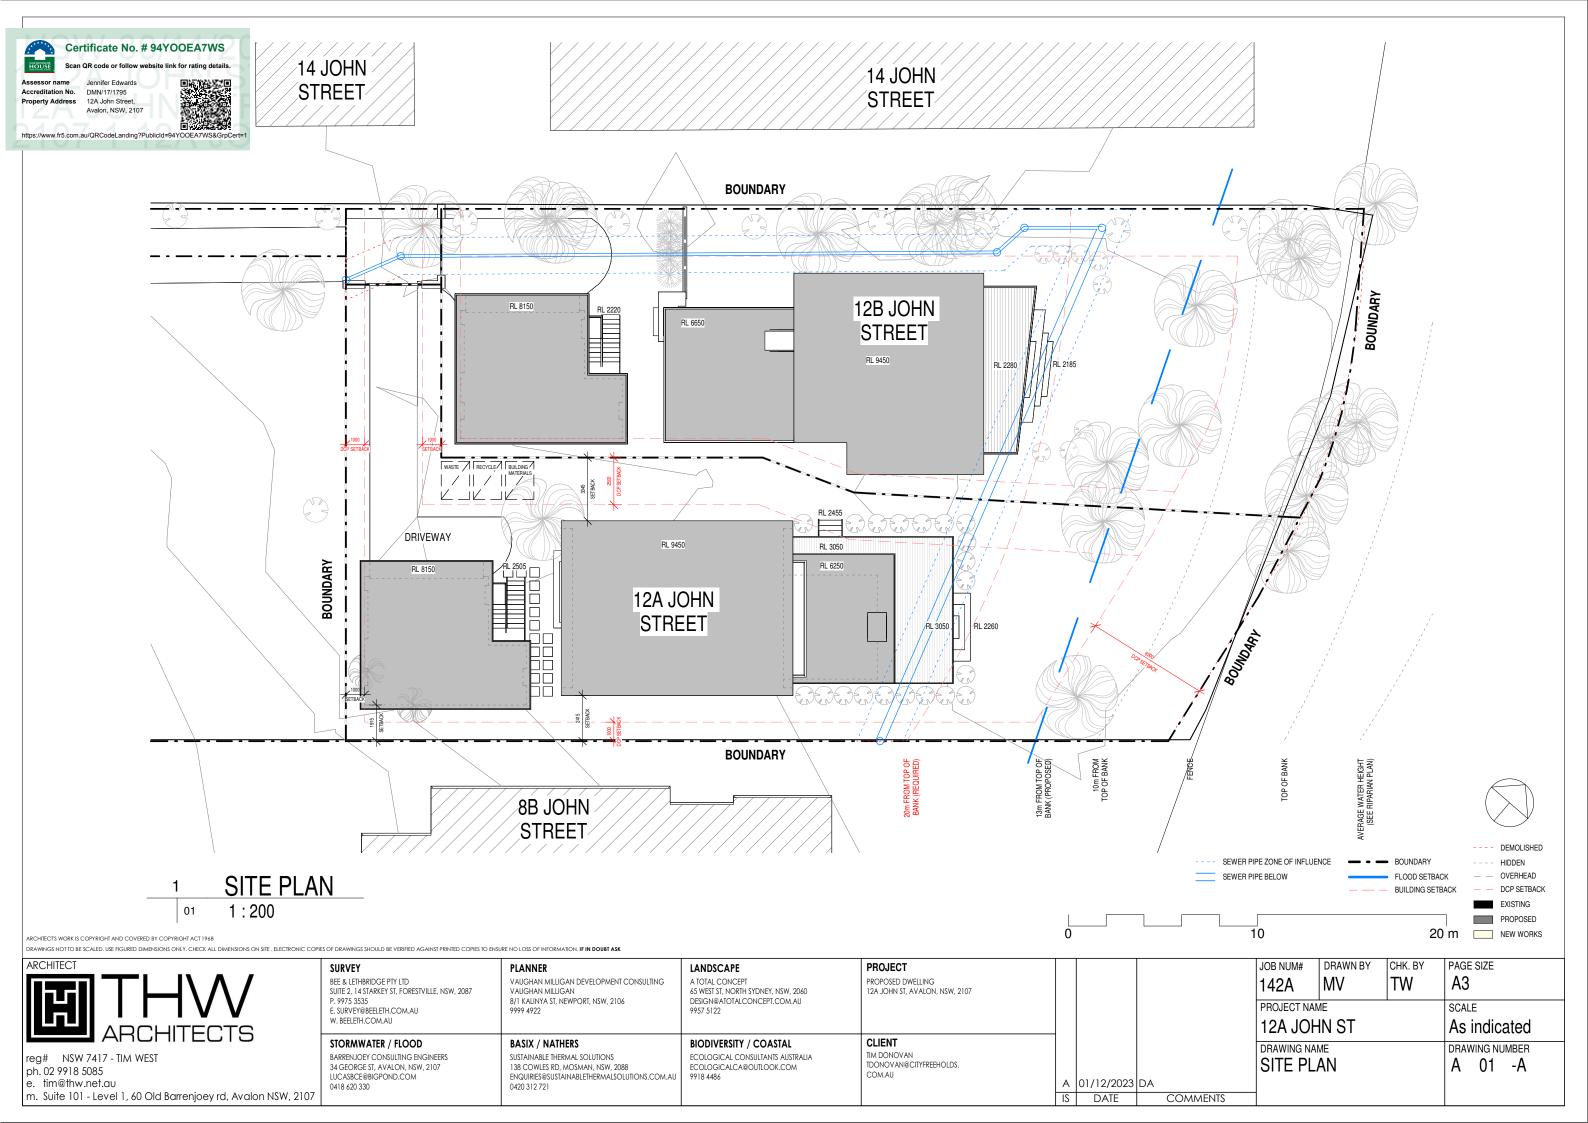

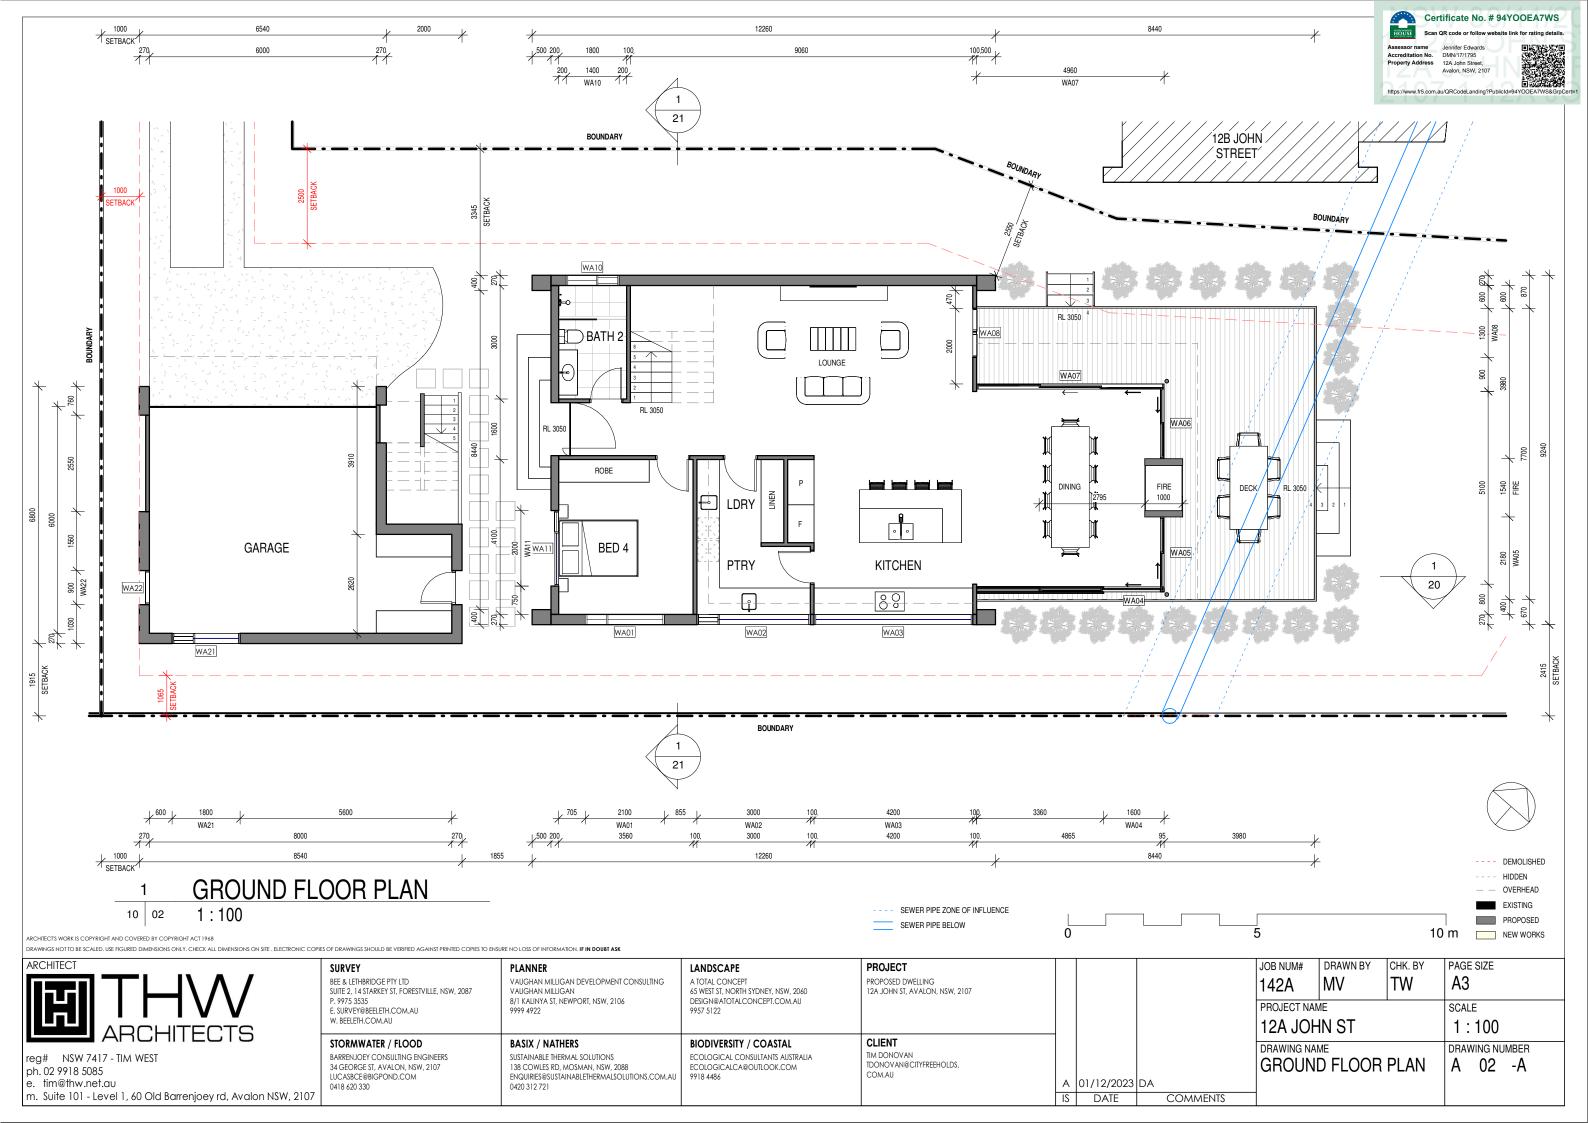

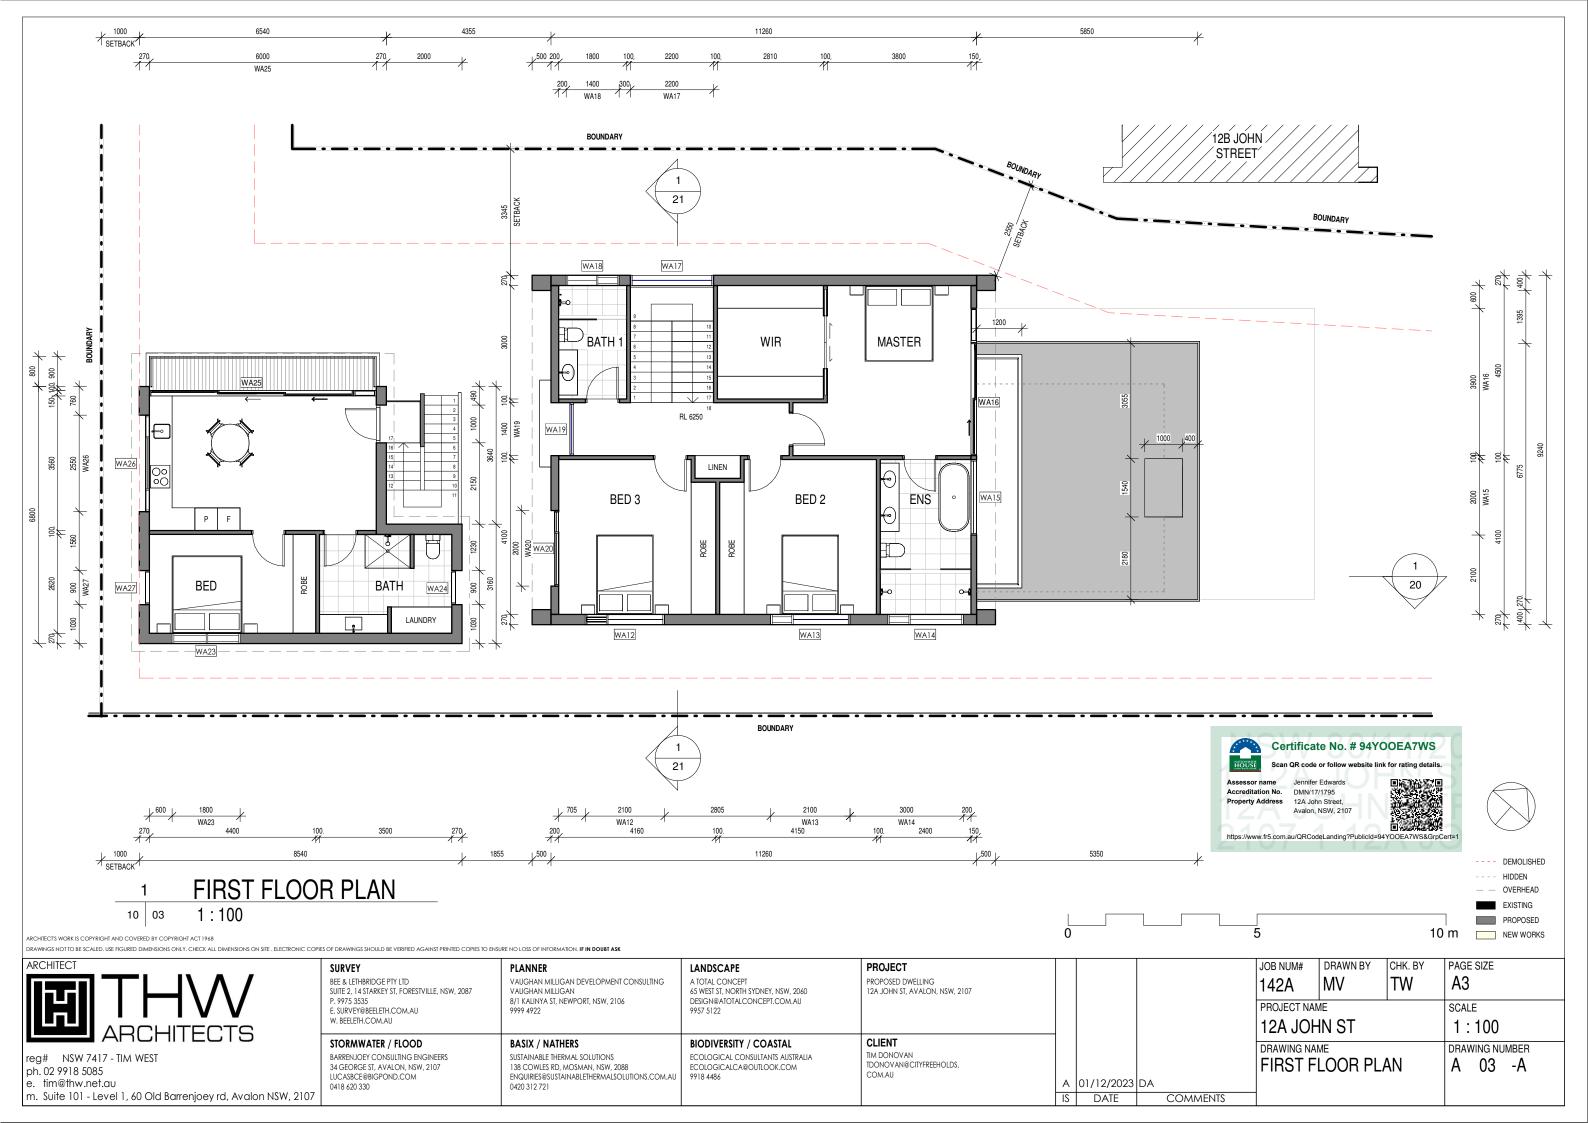

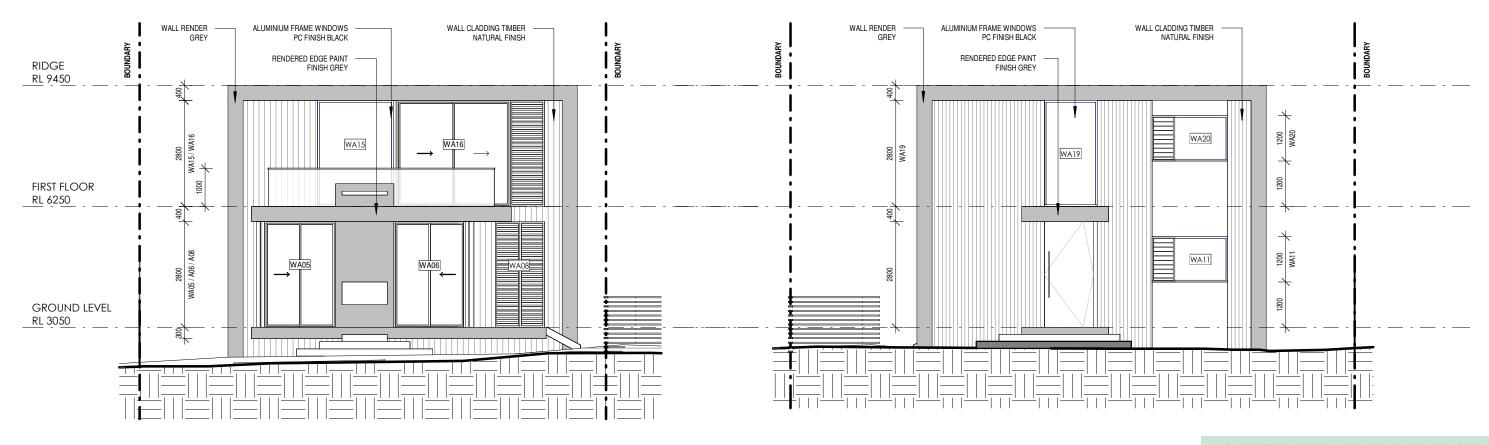

NORTH EAST ELEVATION

SOUTH WEST ELEVATION 10



RCHITECT'S WORK IS COPYRIGHT AND COVERED BY COPYRIGHT ACT 1968

DRAWINGS NOT TO BE SCALED, USE FIGURED DIMENSIONS ONLY, CHECK ALL DIMENSIONS ON SITE, ELECTRONIC COPIES OF DRAWINGS SHOULD BE VERIFIED AGAINST PRINTED COPIES TO ENSURE NO LOSS OF INFORMATION, IF IN DOUBT ASK

ARCHITECT

reg# NSW 7417 - TIM WEST ph. 02 9918 5085

e. tim@thw.net.au m. Suite 101 - Level 1, 60 Old Barrenjoey rd, Avalon NSW, 2107

10

BEE & LETHBRIDGE PTY LTD SUITE 2, 14 STARKEY ST, FORESTVILLE, NSW, 2087 P. 9975 3535

STORMWATER / FLOOD

LUCASBCE@BIGPOND.COM 0418 620 330

BARRENJOEY CONSULTING ENGINEERS 34 GEORGE ST, AVALON, NSW, 2107

E. SURVEY@BEELETH.COM.AU W. BEELETH.COM.AU

PLANNER VAUGHAN MILLIGAN DEVELOPMENT CONSULTING VAUGHAN MILLIGAN 8/1 KALINYA ST, NEWPORT, NSW, 2106 9999 4922

BASIX / NATHERS

SUSTAINABLE THERMAL SOLUTIONS

138 COWLES RD, MOSMAN, NSW, 2088

ENQUIRIES@SUSTAINABLETHERMALSOLUTIONS.COM.AU 0420 312 721

LANDSCAPE A TOTAL CONCEPT 65 WEST ST, NORTH SYDNEY, NSW, 2060 DESIGN@ATOTALCONCEPT.COM.AU 9957 5122

BIODIVERSITY / COASTAL

ECOLOGICALCA@OUTLOOK.COM

9918 4486

ECOLOGICAL CONSULTANTS AUSTRALIA

PROJECT

PROPOSED DWELLING 12A JOHN ST, AVALON, NSW, 2107 CLIENT TIM DONOVAN TDONOVAN@CITYFREEHOLDS.

A 01/12/2023 DA

DATE


COMMENTS

JOB NUM# DRAWN BY CHK. BY MV142A PROJECT NAME 12A JOHN ST DRAWING NAME **NE/SW ELEVATIONS**

A3 SCALE 1:100 DRAWING NUMBER A 10 -A

--- DEMOLISHED ---- HIDDEN — OVERHEAD EXISTING PROPOSED 10 m NEW WORKS

PAGE SIZE

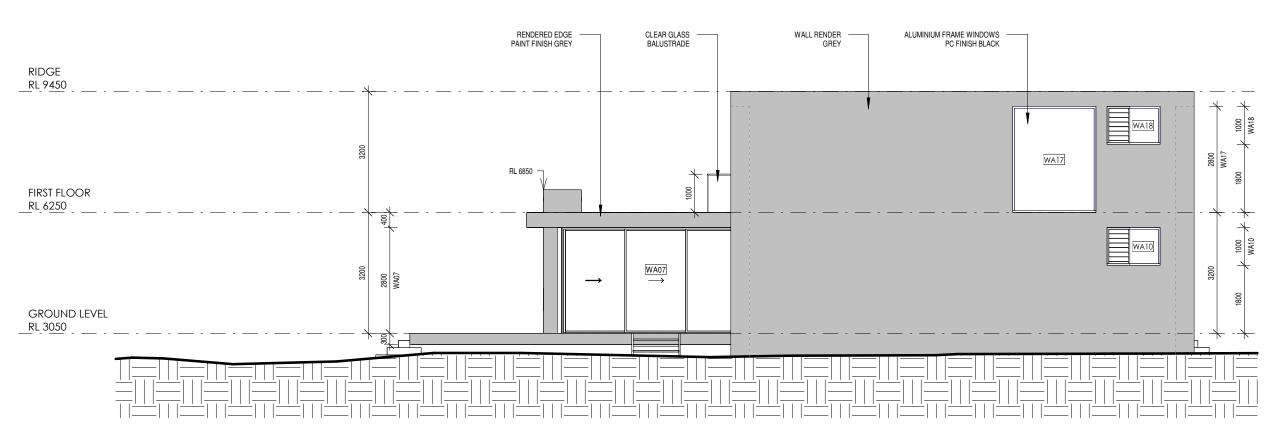

NORTH WEST ELEVATION

1:100



RCHITECT'S WORK IS COPYRIGHT AND COVERED BY COPYRIGHT ACT 1968

DRAWINGS NOT TO BE SCALED, USE FIGURED DIMENSIONS ONLY, CHECK ALL DIMENSIONS ON SITE. ELECTRONIC COPIES OF DRAWINGS SHOULD BE VERIFIED AGAINST PRINTED COPIES TO ENSURE NO LOSS OF INFORMATION, IF IN DOUBT ASK

ARCHITECT

reg# NSW 7417 - TIM WEST ph. 02 9918 5085 e. tim@thw.net.au m. Suite 101 - Level 1, 60 Old Barrenjoey rd, Avalon NSW, 2107

JUNALI
BEE & LETHBRIDGE PTY LTD
SUITE 2, 14 STARKEY ST, FORESTVILLE, NSW, 2083
P. 9975 3535
E. SURVEY@BEELETH.COM.AU
W REFLETH COM ALL

STORMWATER / FLOOD

LUCASBCE@BIGPOND.COM 0418 620 330

BARRENJOEY CONSULTING ENGINEERS 34 GEORGE ST, AVALON, NSW, 2107

PLANNER VAUGHAN MILLIGAN DEVELOPMENT CONSULTING VAUGHAN MILLIGAN 8/1 KALINYA ST, NEWPORT, NSW, 2106 9999 4922

BASIX / NATHERS

SUSTAINABLE THERMAL SOLUTIONS

138 COWLES RD, MOSMAN, NSW, 2088

ENQUIRIES@SUSTAINABLETHERMALSOLUTIONS.COM.AU 0420 312 721

LANDSCAPE A TOTAL CONCEPT 65 WEST ST, NORTH SYDNEY, NSW, 2060 DESIGN@ATOTALCONCEPT.COM.AU 9957 5122

BIODIVERSITY / COASTAL

ECOLOGICALCA@OUTLOOK.COM

9918 4486

ECOLOGICAL CONSULTANTS AUSTRALIA

PROJECT PROPOSED DWELLING 12A JOHN ST, AVALON, NSW, 2107 CLIENT


TIM DONOVAN TDONOVAN@CITYFREEHOLDS. A 01/12/2023 DA

DATE

COMMENTS

10 m NEW WORKS DRAWN BY PAGE SIZE JOB NUM# CHK. BY MV **A**3 142A PROJECT NAME SCALE 12A JOHN ST 1:100 DRAWING NAME DRAWING NUMBER NW ELEVATION A 11 -A

---- DEMOLISHED ---- HIDDEN — — OVERHEAD EXISTING PROPOSED

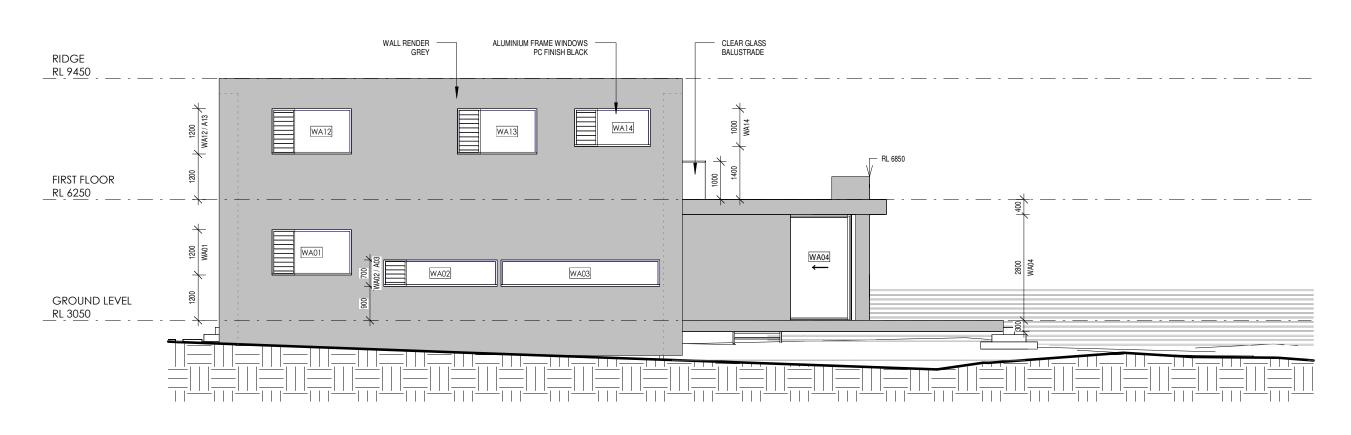

SOUTH EAST ELEVATION

12



RCHITECT'S WORK IS COPYRIGHT AND COVERED BY COPYRIGHT ACT 1968

DRAWINGS NOT TO BE SCALED, USE FIGURED DIMENSIONS ONLY, CHECK ALL DIMENSIONS ON SITE, ELECTRONIC COPIES OF DRAWINGS SHOULD BE VERIFIED AGAINST PRINTED COPIES TO ENSURE NO LOSS OF INFORMATION, IF IN DOUBT ASK

ARCHITECT

reg# NSW 7417 - TIM WEST ph. 02 9918 5085 e. tim@thw.net.au m. Suite 101 - Level 1, 60 Old Barrenjoey rd, Avalon NSW, 2107

E. SURVEY@BEELETH.COM.AU W. BEELETH.COM.AU

STORMWATER / FLOOD

LUCASBCE@BIGPOND.COM 0418 620 330

BARRENJOEY CONSULTING ENGINEERS 34 GEORGE ST, AVALON, NSW, 2107

BEE & LETHBRIDGE PTY LTD SUITE 2, 14 STARKEY ST, FORESTVILLE, NSW, 2087 P. 9975 3535

VAUGHAN MILLIGAN DEVELOPMENT CONSULTING VAUGHAN MILLIGAN 8/1 KALINYA ST, NEWPORT, NSW, 2106 9999 4922

PLANNER

BASIX / NATHERS

SUSTAINABLE THERMAL SOLUTIONS

138 COWLES RD, MOSMAN, NSW, 2088

ENQUIRIES@SUSTAINABLETHERMALSOLUTIONS.COM.AU 0420 312 721

LANDSCAPE A TOTAL CONCEPT 65 WEST ST, NORTH SYDNEY, NSW, 2060 DESIGN@ATOTALCONCEPT.COM.AU 9957 5122

BIODIVERSITY / COASTAL

ECOLOGICALCA@OUTLOOK.COM

9918 4486

ECOLOGICAL CONSULTANTS AUSTRALIA

PROJECT PROPOSED DWELLING 12A JOHN ST, AVALON, NSW, 2107


CLIENT TIM DONOVAN TDONOVAN@CITYFREEHOLDS. A 01/12/2023 DA

COMMENTS

DATE

DRAWN BY PAGE SIZE JOB NUM# CHK. BY MVА3 142A PROJECT NAME SCALE 12A JOHN ST 1:100 DRAWING NAME DRAWING NUMBER SE ELEVATION A 12 -A

---- DEMOLISHED ---- HIDDEN — — OVERHEAD EXISTING PROPOSED 10 m NEW WORKS

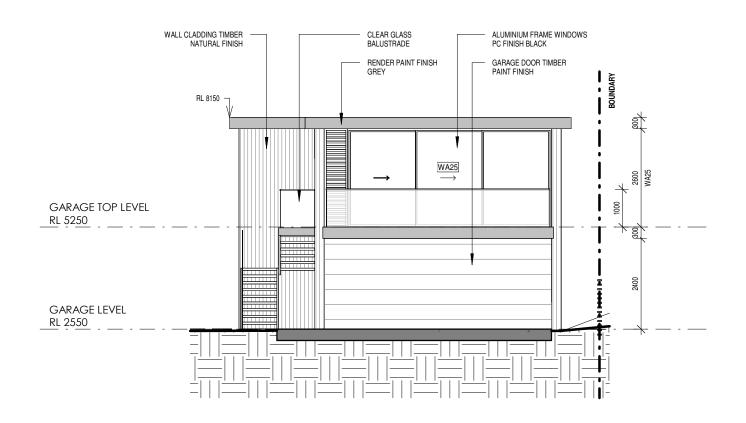

RENDER PAINT FINISH GREY RL 8150 WA21


ALUMINIUM FRAME WINDOWS PC FINISH BLACK

GARAGE NW ELEVATION

GARAGE SE ELEVATION

DATE

WALL CLADDING TIMBER NATURAL FINISH

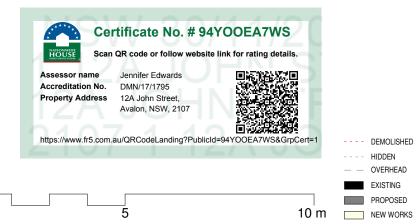

RCHITECT'S WORK IS COPYRIGHT AND COVERED BY COPYRIGHT ACT 1968

DRAWINGS NOT TO BE SCALED, USE FIGURED DIMENSIONS ONLY, CHECK ALL DIMENSIONS ON SITE, ELECTRONIC COPIES OF DRAWINGS SHOULD BE VERIFIED AGAINST PRINTED COPIES TO ENSURE NO LOSS OF INFORMATION, IF IN DOUBT ASK

ARCHITECT

reg# NSW 7417 - TIM WEST ph. 02 9918 5085

e. tim@thw.net.au m. Suite 101 - Level 1, 60 Old Barrenjoey rd, Avalon NSW, 2107

BEE & LETHBRIDGE PTY LTD SUITE 2, 14 STARKEY ST, FORESTVILLE, NSW, 2087 P. 9975 3535 E. SURVEY@BEELETH.COM.AU

W. BEELETH.COM.AU

STORMWATER / FLOOD

LUCASBCE@BIGPOND.COM 0418 620 330

BARRENJOEY CONSULTING ENGINEERS 34 GEORGE ST, AVALON, NSW, 2107

PLANNER VAUGHAN MILLIGAN DEVELOPMENT CONSULTING VAUGHAN MILLIGAN 8/1 KALINYA ST, NEWPORT, NSW, 2106 9999 4922

BASIX / NATHERS

SUSTAINABLE THERMAL SOLUTIONS

138 COWLES RD, MOSMAN, NSW, 2088

ENQUIRIES@SUSTAINABLETHERMALSOLUTIONS.COM.AU 0420 312 721

LANDSCAPE A TOTAL CONCEPT 65 WEST ST, NORTH SYDNEY, NSW, 2060 DESIGN@ATOTALCONCEPT.COM.AU 9957 5122

BIODIVERSITY / COASTAL

ECOLOGICALCA@OUTLOOK.COM

9918 4486

ECOLOGICAL CONSULTANTS AUSTRALIA


PROJECT PROPOSED DWELLING 12A JOHN ST, AVALON, NSW, 2107

CLIENT TIM DONOVAN TDONOVAN@CITYFREEHOLDS.

JOB NUM# 142A A 01/12/2023 DA

COMMENTS

PAGE SIZE DRAWN BY CHK. BY MVА3 PROJECT NAME SCALE 12A JOHN ST 1:100 DRAWING NAME DRAWING NUMBER **GARAGE ELEVATIONS** A 13 -A

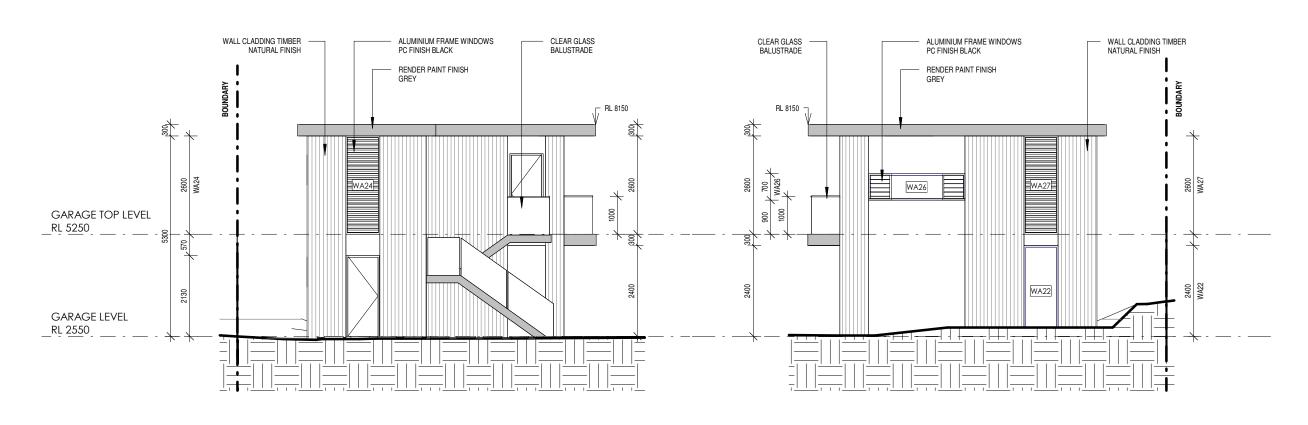

GARAGE NE ELEVATION

GARAGE SW ELEVATION

1:100



RCHITECT'S WORK IS COPYRIGHT AND COVERED BY COPYRIGHT ACT 1968

DRAWINGS NOT TO BE SCALED. USE FIGURED DIMENSIONS ONLY, CHECK ALL DIMENSIONS ON SITE. ELECTRONIC COPIES OF DRAWINGS SHOULD BE VERIFIED AGAINST PRINTED COPIES TO ENSURE NO LOSS OF INFORMATION. IF IN DOUBT ASK

reg# NSW 7417 - TIM WEST ph. 02 9918 5085

e. tim@thw.net.au m. Suite 101 - Level 1, 60 Old Barrenjoey rd, Avalon NSW, 2107

STORMWATER / FLOOD

LUCASBCE@BIGPOND.COM 0418 620 330

BARRENJOEY CONSULTING ENGINEERS 34 GEORGE ST, AVALON, NSW, 2107

BEE & LETHBRIDGE PTY LTD SUITE 2, 14 STARKEY ST, FORESTVILLE, NSW, 2087 P. 9975 3535 VAUGHAN MILLIGAN DEVELOPMENT CONSULTING E. SURVEY@BEELETH.COM.AU W. BEELETH.COM.AU

VAUGHAN MILLIGAN 8/1 KALINYA ST, NEWPORT, NSW, 2106 9999 4922

SUSTAINABLE THERMAL SOLUTIONS

138 COWLES RD, MOSMAN, NSW, 2088

ENQUIRIES@SUSTAINABLETHERMALSOLUTIONS.COM.AU 0420 312 721

BASIX / NATHERS

PLANNER

LANDSCAPE 65 WEST ST, NORTH SYDNEY, NSW, 2060 DESIGN@ATOTALCONCEPT.COM.AU 9957 5122

BIODIVERSITY / COASTAL

ECOLOGICALCA@OUTLOOK.COM

9918 4486

ECOLOGICAL CONSULTANTS AUSTRALIA

PROJECT PROPOSED DWELLING 12A JOHN ST, AVALON, NSW, 2107

CLIENT TIM DONOVAN TDONOVAN@CITYFREEHOLDS. A 01/12/2023 DA

DATE

COMMENTS

PAGE SIZE JOB NUM# DRAWN BY CHK. BY MV142A PROJECT NAME 12A JOHN ST DRAWING NAME **GARAGE ELEVATIONS**


SCALE 1:100 DRAWING NUMBER A 14 -A


DEMOLISHED

HIDDEN OVERHEAD

10 m NEW WORKS

А3

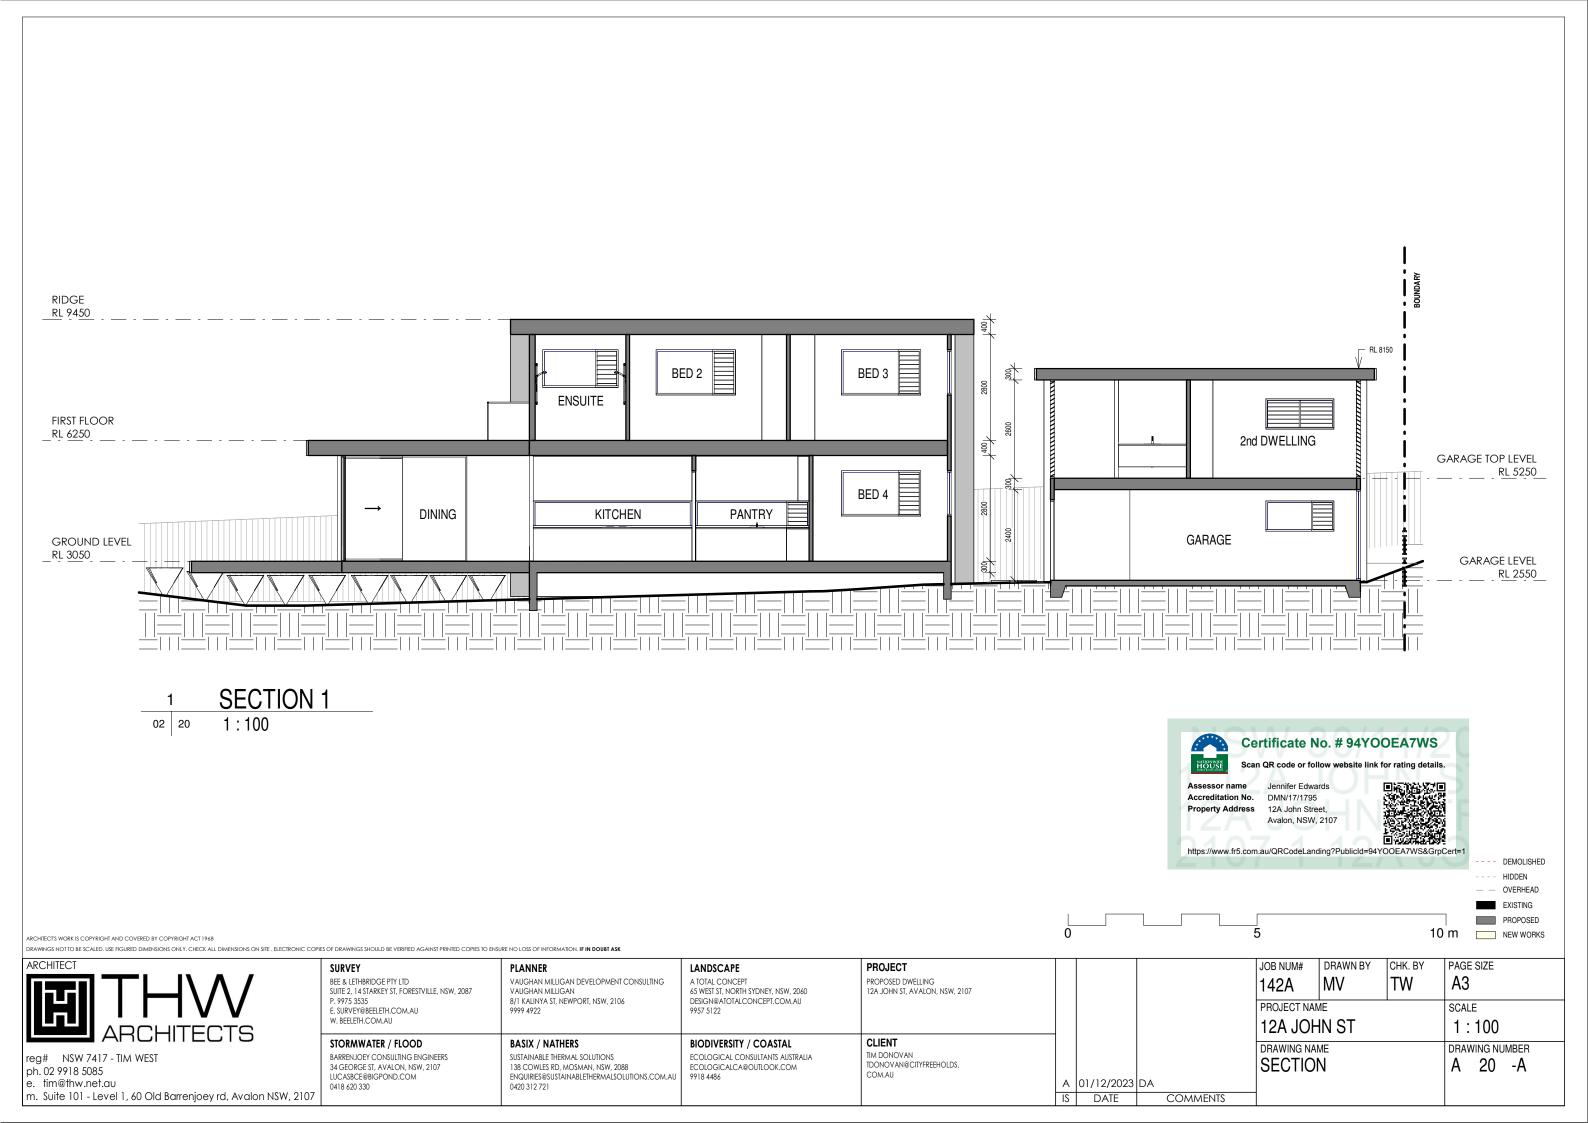

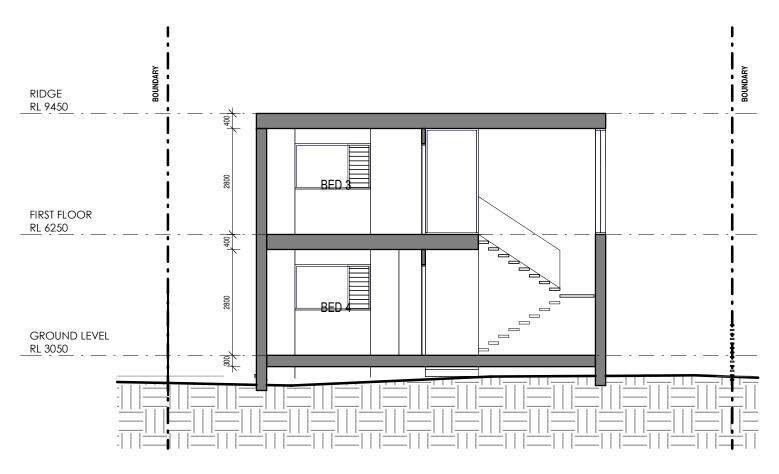

SECTION 2 02 21



RCHITECT'S WORK IS COPYRIGHT AND COVERED BY COPYRIGHT ACT 1968

DRAWINGS NOT TO BE SCALED, USE FIGURED DIMENSIONS ONLY, CHECK ALL DIMENSIONS ON SITE: ELECTRONIC COPIES OF DRAWINGS SHOULD BE VERIFIED AGAINST PRINTED COPIES TO ENSURE NO LOSS OF INFORMATION, IF IN DOUBT ASK

ARCHITECT

reg# NSW 7417 - TIM WEST ph. 02 9918 5085 e. tim@thw.net.au

m. Suite 101 - Level 1, 60 Old Barrenjoey rd, Avalon NSW, 2107

SURVEY BEE & LETHBRIDGE PTY LTD SUITE 2, 14 STARKEY ST, FORESTVILLE, NSW, 2087 P. 9975 3535

STORMWATER / FLOOD

LUCASBCE@BIGPOND.COM 0418 620 330

BARRENJOEY CONSULTING ENGINEERS

34 GEORGE ST, AVALON, NSW, 2107

VAUGHAN MILLIGAN DEVELOPMENT CONSULTING VAUGHAN MILLIGAN 8/1 KALINYA ST, NEWPORT, NSW, 2106 E. SURVEY@BEELETH.COM.AU 9999 4922 W. BEELETH.COM.AU

PLANNER

BASIX / NATHERS

SUSTAINABLE THERMAL SOLUTIONS

138 COWLES RD, MOSMAN, NSW, 2088

ENQUIRIES@SUSTAINABLETHERMALSOLUTIONS.COM.AU 0420 312 721

LANDSCAPE A TOTAL CONCEPT 65 WEST ST, NORTH SYDNEY, NSW, 2060 DESIGN@ATOTALCONCEPT.COM.AU 9957 5122

BIODIVERSITY / COASTAL

ECOLOGICALCA@OUTLOOK.COM 9918 4486

ECOLOGICAL CONSULTANTS AUSTRALIA

PROJECT PROPOSED DWELLING 12A JOHN ST, AVALON, NSW, 2107

CLIENT TIM DONOVAN TDONOVAN@CITYFREEHOLDS.

A 01/12/2023 DA

DATE

COMMENTS


DRAWN BY JOB NUM# MV 142A PROJECT NAME 12A JOHN ST DRAWING NAME SECTION

PAGE SIZE CHK. BY А3 SCALE 1:100 DRAWING NUMBER A 21 -A

---- HIDDEN - - OVERHEAD EXISTING PROPOSED 10 m ____ NEW WORKS





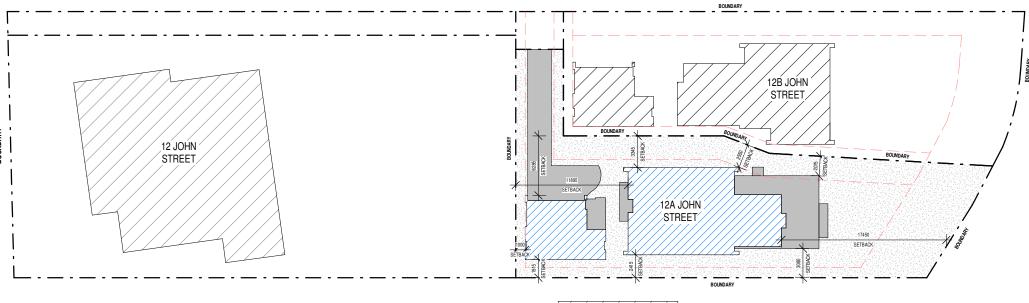

8B JOHN STREET

ANALYSIS PLAN 12A

1:400 10 100

SITE ANALYSIS

SITE AREA 700m² ZONE E4

MAX COVERAGE 40% = 280m² BUILDING FOOTPRINT 178.9m² HARD PAVING / DECK / STAIRS 113.8m² PRO COVERAGE 292.7m² = 41.8%


REQ LANDSCAPE $60\% = 420m^2$ PRO LANDSCAPE 407.3m² = 58.2%

MAX HEIGHT 8.50m PRO HEIGHT 7.39m

REQ FRONT SETBACK PRO FRONT SETBACK HOUSE 6.50m 11.9m PRO FRONT SETBACK GARAGE 1.00m

REQ REAR SETBACK 6.50m PRO REAR SETBACK HOUSE 17.5m PRO REAR SETBACK GARAGE 35.2m

REQ SIDE SETBACK 1.00m / 2.50m PRO SIDE SETBACK HOUSE 2.42m / 2.55m PRO SIDE SETBACK GARAGE 1.00m / 6.28m

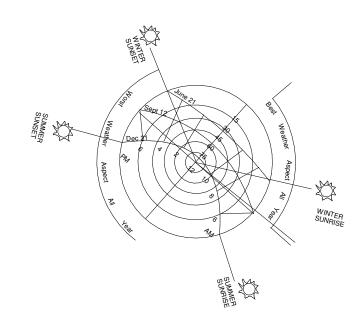



NON COMPLIANCE LANDSCAPING BUILDING COVERAGE OTHER COVERAGE NEIGHBOURING HOUSE

- BOUNDARY

SETBACK

Accreditation No.

DMN/17/1795 12A John Street, Avalon, NSW, 2107



https://www.fr5.com.au/QRCodeLanding?PublicId=94YOOEA7WS&GrpCert=

RCHITECT'S WORK IS COPYRIGHT AND COVERED BY COPYRIGHT ACT 1968

DRAWINGS NOT TO BE SCALED, USE FIGURED DIMENSIONS ONLY, CHECK ALL DIMENSIONS ON SITE , ELECTRONIC COPIES OF DRAWINGS SHOULD BE VERIFIED AGAINST PRINTED COPIES TO ENSURE NO LOSS OF INFORMATION, IF IN DOUBT ASK



reg# NSW 7417 - TIM WEST ph. 02 9918 5085

e. tim@thw.net.au m. Suite 101 - Level 1, 60 Old Barrenjoey rd, Avalon NSW, 2107 SURVEY

W. BEELETH.COM.AU

STORMWATER / FLOOD

LUCASBCE@BIGPOND.COM 0418 620 330

BARRENJOEY CONSULTING ENGINEERS

34 GEORGE ST, AVALON, NSW, 2107

BEE & LETHBRIDGE PTY LTD SUITE 2, 14 STARKEY ST, FORESTVILLE, NSW, 2087 P. 9975 3535 E. SURVEY@BEELETH.COM.AU

VAUGHAN MILLIGAN DEVELOPMENT CONSULTING VAUGHAN MILLIGAN 8/1 KALINYA ST, NEWPORT, NSW, 2106 9999 4922

BASIX / NATHERS

SUSTAINABLE THERMAL SOLUTIONS

138 COWLES RD, MOSMAN, NSW, 2088

ENQUIRIES@SUSTAINABLETHERMALSOLUTIONS.COM.AU 0420 312 721

PLANNER

LANDSCAPE A TOTAL CONCEPT 65 WEST ST, NORTH SYDNEY, NSW, 2060 DESIGN@ATOTALCONCEPT.COM.AU 9957 5122

BIODIVERSITY / COASTAL

ECOLOGICALCA@OUTLOOK.COM

9918 4486

ECOLOGICAL CONSULTANTS AUSTRALIA

PROJECT PROPOSED DWELLING 12A JOHN ST, AVALON, NSW, 2107

TIM DONOVAN TDONOVAN@CITYFREEHOLDS.

CLIENT


DATE


JOB NUM#	DRAWN BY	CHK. BY	PAGE SIZE
142A	MV	TW	A3
PROJECT NAM	ИE		SCALE
12A JOH	IN ST		As indicated
DRAWING NAM	ME		DRAWING NUMBER

SITE ANALYSIS A 01/12/2023 DA

COMMENTS


A 100 -A

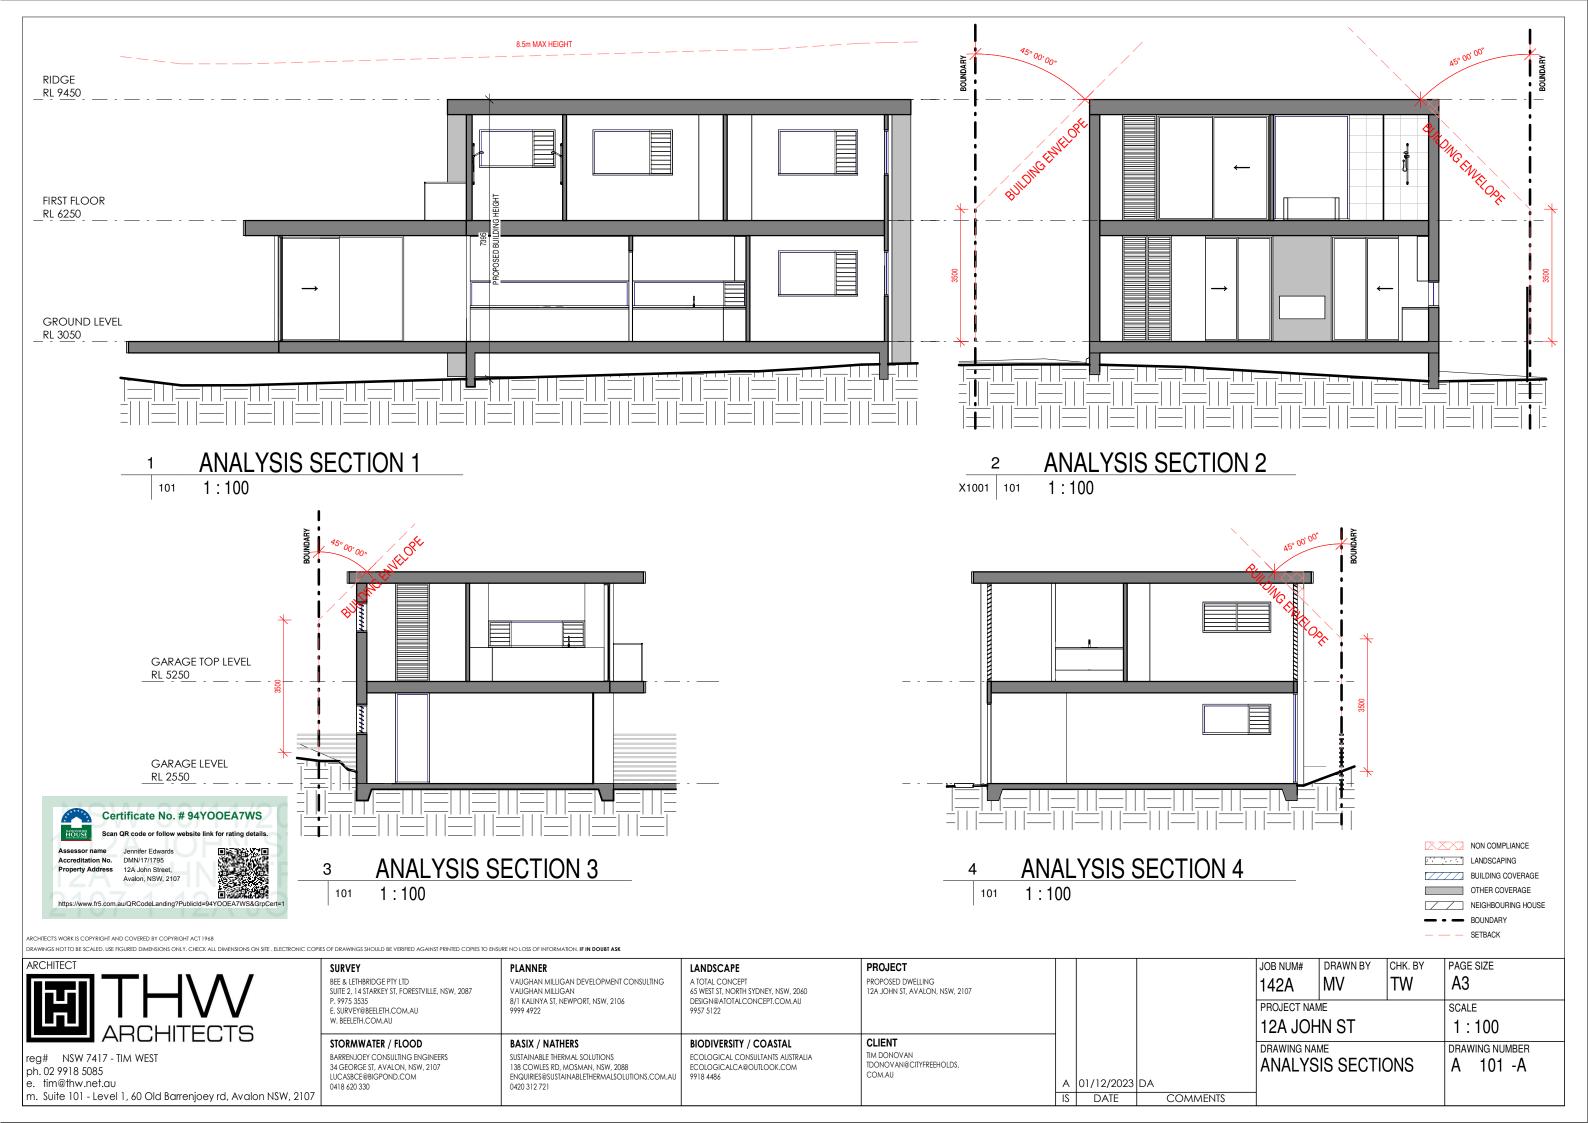

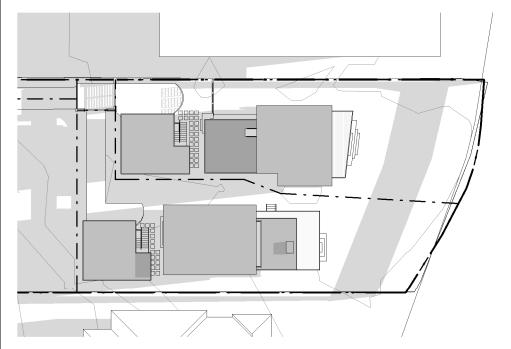

SHADOWS PLAN JUNE 21ST 9AM

SHADOWS PLAN JUNE 21ST 12AM 102

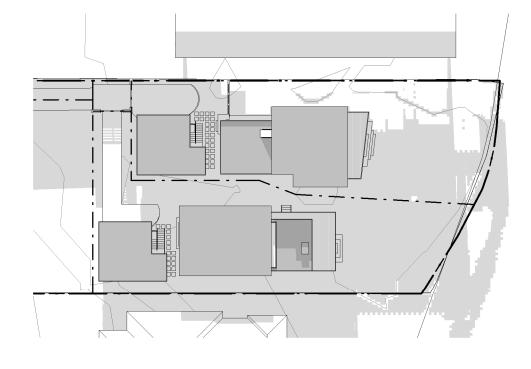

SHADOWS PLAN JUNE 21ST 3PM

102



RCHITECT'S WORK IS COPYRIGHT AND COVERED BY COPYRIGHT ACT 1968

102

DRAWINGS NOT TO BE SCALED, USE FIGURED DIMENSIONS ONLY, CHECK ALL DIMENSIONS ON SITE, ELECTRONIC COPIES OF DRAWINGS SHOULD BE VERIFIED AGAINST PRINTED COPIES TO ENSURE NO LOSS OF INFORMATION, IF IN DOUBT ASK



reg# NSW 7417 - TIM WEST ph. 02 9918 5085 e. tim@thw.net.au

m. Suite 101 - Level 1, 60 Old Barrenjoey rd, Avalon NSW, 2107

SURVEY

W. BEELETH.COM.AU

STORMWATER / FLOOD

LUCASBCE@BIGPOND.COM 0418 620 330

BARRENJOEY CONSULTING ENGINEERS

34 GEORGE ST, AVALON, NSW, 2107

BEE & LETHBRIDGE PTY LTD SUITE 2, 14 STARKEY ST, FORESTVILLE, NSW, 2087 P. 9975 3535 E. SURVEY@BEELETH.COM.AU

PLANNER

BASIX / NATHERS

SUSTAINABLE THERMAL SOLUTIONS

138 COWLES RD, MOSMAN, NSW, 2088

VAUGHAN MILLIGAN DEVELOPMENT CONSULTING VAUGHAN MILLIGAN 8/1 KALINYA ST, NEWPORT, NSW, 2106 9999 4922

ENQUIRIES@SUSTAINABLETHERMALSOLUTIONS.COM.AU 0420 312 721

LANDSCAPE A TOTAL CONCEPT 65 WEST ST, NORTH SYDNEY, NSW, 2060 DESIGN@ATOTALCONCEPT.COM.AU 9957 5122

BIODIVERSITY / COASTAL

ECOLOGICALCA@OUTLOOK.COM

9918 4486

ECOLOGICAL CONSULTANTS AUSTRALIA

PROJECT PROPOSED DWELLING 12A JOHN ST, AVALON, NSW, 2107


> CLIENT TIM DONOVAN TDONOVAN@CITYFREEHOLDS.

DRAWN BY PAGE SIZE JOB NUM# CHK. BY MV TW А3 142A PROJECT NAME SCALE 12A JOHN ST 1:500 DRAWING NAME DRAWING NUMBER SHADOWS A 102 -A


A 01/12/2023 DA DATE COMMENTS





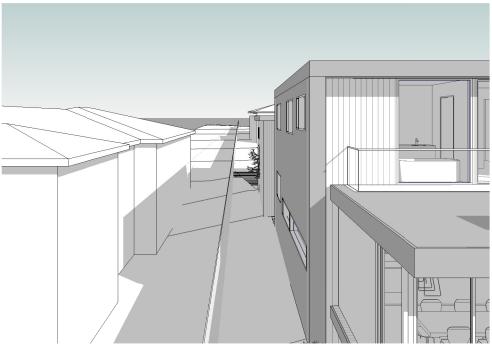

SHADOWS 3D JUNE 21ST 12AM

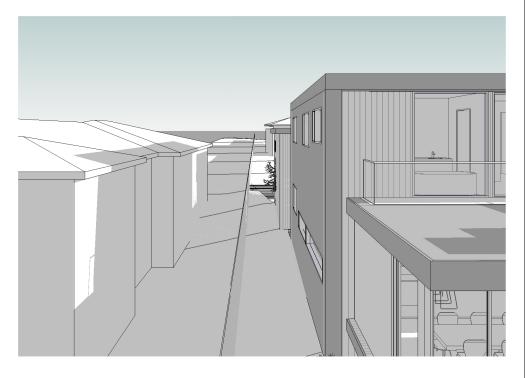

3 SHADOWS 3D JUNE 21ST 3PM

103



ARCHITECT'S WORK IS COPYRIGHT AND COVERED BY COPYRIGHT ACT 1968

103

drawings not to be scaled, use figured dimensions only, check all dimensions on site, electronic copies of drawings should be verified against printed copies to ensure no loss of information, if in doubt ask

THV ARCHITECTS

reg# NSW 7417 - TIM WEST ph. 02 9918 5085 e. tim@thw.net.au m. Suite 101 - Level 1, 60 Old Barrenjoey rd, Avalon NSW, 2107

STORMWATER / FLOOD

BARRENJOEY CONSULTING ENGINEERS
34 GEORGE ST, AVALON, NSW, 2107
LUCASBCE@BIGPOND.COM
0418 620 330

E. SURVEY@BEELETH.COM.AU

W. BEELETH.COM.AU

SURVEY

BEE & LETHBRIDGE PTY LTD

SUITE 2, 14 STARKEY ST, FORESTVILLE, NSW, 2087
P. 9975 3535

N, 2087 VAUGHAN MILIGAN 8/1 KALINYA ST, NEWPORT, NSW, 2106 9999 4922

BASIX / NATHERS

SUSTAINABLE THERMAL SOLUTIONS

138 COWLES RD, MOSMAN, NSW, 2088

ENQUIRIES@SUSTAINABLETHERMALSOLUTIONS.COM.AU 0420 312 721

VAUGHAN MILLIGAN DEVELOPMENT CONSULTING

PLANNER

LANDSCAPE
A TOTAL CONCEPT
65 WEST ST, NORTH SYDNEY, NSW, 2060
DESIGN@ATOTAL CONCEPT. COM. AU
9957 5 132

BIODIVERSITY / COASTAL

ECOLOGICALCA@OUTLOOK.COM

9918 4486

ECOLOGICAL CONSULTANTS AUSTRALIA

PROJECT
PROPOSED DWELLING
12A JOHN ST, AVALON, NSW, 2107

12A JOHN ST, AVALON, NSW, 2107

CLIENT
TIM DONOVAN
TDONOVAN@CITYFREEHOLDS.

A 01/12/2023 DA

IS DATE COMMENTS

JOB NUM# DRAWN BY CHK. BY A3

PROJECT NAME SCALE

12A JOHN ST

DRAWING NAME DRAWING NUMBER A 103 -A





Property Address

12A John Street, Avalon, NSW, 2107



https://www.fr5.com.au/QRCodeLanding?PublicId=94YOOEA7WS&GrpCert=1




-WALL RENDER: **GREY**



-WALL CALDDING: TIMBER NATURAL FINISH



-STEEL EDGES & WINDOW FRAMES: **BLACK PC FINISH**

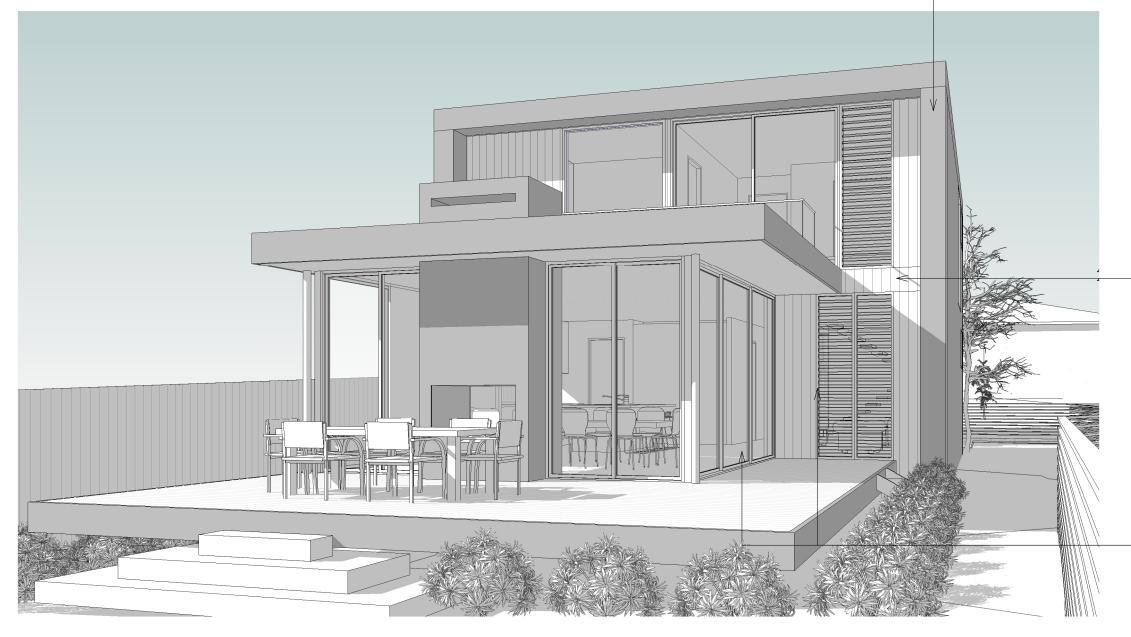

RCHITECT'S WORK IS COPYRIGHT AND COVERED BY COPYRIGHT ACT 1968

DRAWINGS NOT TO BE SCALED, USE FIGURED DIMENSIONS ONLY, CHECK ALL DIMENSIONS ON SITE. ELECTRONIC COPIES OF DRAWINGS SHOULD BE VERIFIED AGAINST PRINTED COPIES TO ENSURE NO LOSS OF INFORMATION, IF IN DOUBT ASK

reg# NSW 7417 - TIM WEST ph. 02 9918 5085

e. tim@thw.net.au m. Suite 101 - Level 1, 60 Old Barrenjoey rd, Avalon NSW, 2107 SURVEY

BEE & LETHBRIDGE PTY LTD SUITE 2, 14 STARKEY ST, FORESTVILLE, NSW, 2087 P. 9975 3535

E. SURVEY@BEELETH.COM.AU W. BEELETH.COM.AU

STORMWATER / FLOOD BASIX / NATHERS

BARRENJOEY CONSULTING ENGINEERS 34 GEORGE ST, AVALON, NSW, 2107 LUCASBCE@BIGPOND.COM 0418 620 330

PLANNER

VAUGHAN MILLIGAN DEVELOPMENT CONSULTING

138 COWLES RD, MOSMAN, NSW, 2088 ENQUIRIES@SUSTAINABLETHERMALSOLUTIONS.COM.AU 0420 312 721

VAUGHAN MILLIGAN 8/1 KALINYA ST, NEWPORT, NSW, 2106 9999 4922

SUSTAINABLE THERMAL SOLUTIONS

LANDSCAPE

A TOTAL CONCEPT 65 WEST ST, NORTH SYDNEY, NSW, 2060 DESIGN@ATOTALCONCEPT.COM.AU 9957 5122

BIODIVERSITY / COASTAL

ECOLOGICALCA@OUTLOOK.COM 9918 4486

ECOLOGICAL CONSULTANTS AUSTRALIA

PROJECT

PROPOSED DWELLING 12A JOHN ST, AVALON, NSW, 2107

CLIENT

TIM DONOVAN TDONOVAN@CITYFREEHOLDS.

MV TW А3 142A PROJECT NAME SCALE 12A JOHN ST DRAWING NAME DRAWING NUMBER **EXTERNAL FINISHES** A 104 -A

CHK. BY

PAGE SIZE

DRAWN BY

JOB NUM#

A 01/12/2023 DA DATE COMMENTS



3D VIEW 1 105



3D VIEW 4

105

ARCHITECT'S WORK IS COPYRIGHT AND COVERED BY COPYRIGHT ACT 1968

DRAWINGS NOT TO BE SCALED, USE FIGURED DIMENSIONS ONLY, CHECK ALL DIMENSIONS ON SITE: ELECTRONIC COPIES OF DRAWINGS SHOULD BE VERIFIED AGAINST PRINTED COPIES TO ENSURE NO LOSS OF INFORMATION, IF IN DOUBT ASK



reg# NSW 7417 - TIM WEST ph. 02 9918 5085 e. tim@thw.net.au

m. Suite 101 - Level 1, 60 Old Barrenjoey rd, Avalon NSW, 2107

SURVEY

BEE & LETHBRIDGE PTY LTD SUITE 2, 14 STARKEY ST, FORESTVILLE, NSW, 2087 P. 9975 3535

E. SURVEY@BEELETH.COM.AU W. BEELETH.COM.AU

STORMWATER / FLOOD

BARRENJOEY CONSULTING ENGINEERS 34 GEORGE ST. AVALON, NSW, 2107 LUCASBCE@BIGPOND.COM 0418 620 330

PLANNER

VAUGHAN MILLIGAN DEVELOPMENT CONSULTING VAUGHAN MILLIGAN 8/1 KALINYA ST, NEWPORT, NSW, 2106 9999 4922

SUSTAINABLE THERMAL SOLUTIONS
138 COWLES RD, MOSMAN, NSW, 2088
ENQUIRIES@SUSTAINABLETHERMALSOLUTIONS.COM.AU
0420 312 721

BASIX / NATHERS

LANDSCAPE

A TOTAL CONCEPT 65 WEST ST, NORTH SYDNEY, NSW, 2060 DESIGN@ATOTALCONCEPT.COM.AU 9957 5122

BIODIVERSITY / COASTAL

ECOLOGICALCA@OUTLOOK.COM 9918 4486

ECOLOGICAL CONSULTANTS AUSTRALIA

TIM DONOVAN TDONOVAN@CITYFREEHOLDS. COM.AU

PROJECT

PROPOSED DWELLING 12A JOHN ST, AVALON, NSW, 2107

3D VIEW 2

3D VIEW 3

105

DRAWN BY CHK. BY JOB NUM# MV TW 142A

А3 PROJECT NAME SCALE 12A JOHN ST

PAGE SIZE

A 01/12/2023 DA DATE COMMENTS

3

105

CLIENT

DRAWING NAME DRAWING NUMBER 3D VIEWS A 105 -A



i) Water	Show on DA plans	Show on CC/CDC plans & specs	Certifier check
(a) The applicant must comply with the commitments listed below in carrying out the development of a dwelling listed in a table below.			
(b) The applicant must plant indigenous or low water use species of vegetation throughout the area of land specified for the dwelling in the "Indigenous species" column of the table below, as private landscaping for that dwelling. (This area of indigenous vegetation is to be contained within the "Area of garden and lawn" for the dwelling specified in the "Description of Project" table).	~	~	
(c) If a rating is specified in the table below for a fixture or appliance to be installed in the dwelling, the applicant must ensure that each such fixture and appliance meets the rating specified for it.		~	~
(d) The applicant must install an on demand hot water recirculation system which regulates all hot water use throughout the dwelling, where indicated for a dwelling in the "HW recirculation or diversion" column of the table below.		~	~
(e) The applicant must install:			
(aa) a hot water diversion system to all showers, kitchen sinks and all basins in the dwelling, where indicated for a dwelling in the "HW recirculation or diversion" column of the table below; and		~	~
(bb) a separate diversion tank (or tanks) connected to the hot water diversion systems of at least 100 litres. The applicant must connect the hot water diversion tank to all toilets in the dwelling.		~	~
(e) The applicant must not install a private swimming pool or spa for the dwelling, with a volume exceeding that specified for it in the table below.	~	~	
(f) If specified in the table, that pool or spa (or both) must have a pool cover or shading (or both).		~	
(g) The pool or spa must be located as specified in the table.	V	~	
(h) The applicant must install, for the dwelling, each alternative water supply system, with the specified size, listed for that dwelling in the table below. Each system must be configured to collect run-off from the areas specified (excluding any area which supplies any other alternative water supply system), and to divert overflow as specified. Each system must be connected as specified.	~	~	~

	Fixtures				Fixtures Appliances Individual pool					Individual spa				
Dwelling no.	All shower- heads	All toilet flushing systems	taps	bathroom	HW recirculation or diversion	All clothes washers	All dish- washers	Volume (max volume)		Pool location	Pool shaded	Volume (max volume)	Spa cover	Spa shaded
dwellings	4 star (> 4.5 but <= 6 L/min)	5 star	5 star	5 star		-	-	-	-	-	*		-	-

		Alternative water source								
Dwelling no.	Alternative water supply systems	Size	Configuration	Landscape connection	Toilet connection (s)	Laundry connection	Pool top- up	Spa top-up		
Main	Central water tank (No. 1)	See central systems	See central systems	yes	yes	no	no	no		
Main	No alternative water supply	-	51		=	=	-	1-		
All other dwellings	Central water tank (No. 1)	See central systems	See central systems	yes	no	no	no	no		
All other dwellings	No alternative water supply		-	-	9	8	-	-		

(ii) Energy	Show on DA plans	Show on CC/CDC plans & specs	Certifier
(a) The applicant must comply with the commitments listed below in carrying out the development of a dwelling listed in a table below.			
(b) The applicant must install each hot water system specified for the dwelling in the table below, so that the dwelling's hot water is supplied by that system. If the table specifies a central hot water system for the dwelling, then the applicant must connect that central system to the dwelling, so that the dwelling's hot water is supplied by that central system.	~	~	>
(c) The applicant must install, in each bathroom, kitchen and laundry of the dwelling, the ventilation system specified for that room in the table below. Each such ventilation system must have the operation control specified for it in the table.		V	V
(d) The applicant must install the cooling and heating system/s specified for the dwelling under the "Living areas" and "Bedroom areas" headings of the "Cooling" and "Heating" columns in the table below, [infor at least 1 living/bedroom area of the dwelling. If no cooling or heating system is specified in the table for "Living areas" or "Bedroom areas", then no systems may be installed in any such areas. If the term "zoned" is specified beside an air conditioning system, then the system must provide for day/night zoning between living areas and bedrooms.		~	~

ii) Energy	Show on DA plans	Show on CC/CDC plans & specs	Certifier check
(e) This commitment applies to each room or area of the dwelling which is referred to in a heading to the "Artificial lighting" column of the table below (but only to the extent specified for that room or area). The applicant must ensure that the "primary type of artificial lighting" for each such room in the dwelling is fluorescent lighting or light entiting diode (LED) lighting. If the term "dedicated" is specified for a particular room or area, then the light fittings in that room or area must only be capable of being used for fluorescent lighting or light emitting diode (LED) lighting.		~	~
(f) This commitment applies to each room or area of the dwelling which is referred to in a heading to the "Natural lighting" column of the table below (but only to the extent specified for that room or area). The applicant must ensure that each such room or area is fitted with a window and/or skylight.	~	~	~
(g) This commitment applies if the applicant installs a water heating system for the dwelling's pool or spa. The applicant must:			
(aa) install the system specified for the pool in the "Individual Pool" column of the table below (or alternatively must not install any system for the pool). If specified, the applicant must install a timer, to control the pool's pump; and		~	
(bb) install the system specified for the spa in the "Individual Spa" column of the table below (or alternatively must not install any system for the spa). If specified, the applicant must install a timer to control the spa's pump.		~	
(h) The applicant must install in the dwelling:			
(aa) the kilchen cook-top and oven specified for that dwelling in the "Appliances & other efficiency measures" column of the table below;		~	
(bb) each appliance for which a rating is specified for that dwelling in the "Appliances & other efficiency measures" column of the table, and ensure that the appliance has that minimum rating; and		~	-
(cc) any clothes drying line specified for the dwelling in the "Appliances & other efficiency measures" column of the table.		~	
(i) If specified in the table, the applicant must carry out the development so that each refrigerator space in the dwelling is "well ventilated".		~	
(j) The applicant must install the photovoltaic system specified for the dwelling under the "Photovoltaic system" heading of the "Alternative energy" column of the table below, and connect the system to that dwelling's electrical system.	~	_	-

		Hot water	Bathroom ventilation system		Kitchen venti	lation system	Laundry ventilation system		
	Dwelling no.	Hot water system	Each bathroom	Operation control	Each kitchen	Operation control	Each laundry	Operation control	
	All dwellings	gas instantaneous - 6 star	individual fan, ducted to façade or roof		individual fan, ducted to façade or roof		individual fan, ducted to façade or roof	manual switch on/off	
ľ					•				

	Cod	ling	Hea	ting	Natural lighting		
Dwelling no.	living areas	bedroom areas	living areas		No. of bathrooms or toilets	Main kitchen	
Main	-		-	-	3	yes	
All other dwellings		-	-		1	yes	

	In		Individual s	Individual spa Appliances other efficier					cy measures	
Dwelling no.	Pool heating system	Pool Pump	Timer	Spa heating system	Timer	Kitchen cooktop/oven	Dishwasher	Clothes dryer	Indoor or sheltered clothes drying line	Private outdoor or unsheltered clothes drying line
All dwellings	-	-	-	-	-	gas cooktop & electric oven	-	2	yes	yes

		Alternative energy	
Dwelling no.	Photovoltaic system (min rated electrical output in peak kW)	Photovoltaic collector installation	Orientation inputs
All dwellings	=	€	E0
		Wage	,

(iii) Thermal Performance	Show on DA plans	Show on CC/CDC plans & specs	Certifier check
(a) The applicant must attach the certificate referred to under "Assessor details" on the front page of this BASIX certificate (the "Assessor Certificate") to the development application and construction certificate application for the proposed development (or, if the applicant is applying for a complying development certificate for the proposed development, to that application). The applicant must also attach the Assessor Certificate to the application for a final occupation certificate for the proposed development.			
(b) The Assessor Certificate must have been issued by an Accredited Assessor in accordance with the Thermal Comfort Protocol.			
(c) The details of the proposed development on the Assessor Certificate must be consistent with the details shown in this BASIX Certificate, including the details shown in the "Thermal Loads" table below.			
(d) The applicant must show on the plans accompanying the development application for the proposed development, all matters which the Thermal Comfort Protocol requires to be shown on those plans. Those plans must bear a stamp of endorsement from the Accredited Assessor, to certify that this is the case.	~		

							Dwelling no.
	Cod	oling	Hea	ating	Natural li	ghting	
Dwelling no.	living areas	bedroom areas	living areas	bedroom areas	No. of bathrooms	Main kitchen	Main
Dwelling no.	nving areas	bediooiii areas	nving areas	bedroom areas	or toilets	Maiii Ritorieii	All other dwelling
Main		-	-	-1	3	yes	
All other dwellings	-)		-	-	1	yes	(i) Materials
		V				Water 1	

	In	dividual pool		Individual sp	a	Appliances other efficiency measures				
Dwelling no.	Pool heating system	Pool Pump	Timer	Spa heating system	Timer	Kitchen cooktop/oven	Dishwasher	Clothes dryer	Indoor or sheltered clothes drying line	Private outdoor or unsheltered clothes drying line
All dwellings	-	-	-	2	2	gas cooktop & electric oven	19	-	yes	yes

Dwelling no.	Photovoltaic system (min rated electrical output in peak kW)	Photovoltaic collector installation	t		
All dwellings	-	-	-9	how on Show on CC/CDC	
(iii) Thermal Performance					Certifier check
"Assessor Certificate") to the applicant is applying for	he certificate referred to under "Assessor details" on the development application and construction certificate a complying development certificate for the proposed sor Certificate to the application for a final occupation or	application for the proposed development (or, if development, to that application). The applicant			
(b) The Assessor Certificate m	ust have been issued by an Accredited Assessor in acc	cordance with the Thermal Comfort Protocol.			
	development on the Assessor Certificate must be constails shown in the "Thermal Loads" table below.	sistent with the details shown in this BASIX			
	n the plans accompanying the development application col requires to be shown on those plans. Those plans in tify that this is the case.		~		

Main -		Concrete	slab on groun	d	Suspended flo	oor above end	losed subfloor	Suspended floor above open subfloor		
Dwelling no.	Area (m²)	Insulation	Low emissions option	Dematerialisation	Construction type	Area (m²)	Insulation	Construction type	Area (m²)	Insulation
Main	-	1-	-	-	-	120	1-	9	-	-
All other dwellings	-	-	-	conventional slab	-	-	-	-	-	-
	Floor types									
	First f	loor above habit	able	Suspended floor a	above garage			Garage floor		

	Floor types										
		oor above ha		Suspend	ed floor abov	re garage			Garage flo	ог	
Dwelling no.	Construction type	Area (m²)	Insulation	Construction type	Area (m²)	Insulation	Construction type	Area (m²)	Insulation	Low emissions option	Dematerialisation
Main	-	-	-	-1	-	-	-	-	-	=	-
All other dwellings		-	-	particle board, frame: timber - H2 treated softwood	43	fibreglass batts or roll	concrete slab on ground	43	-	none	conventional slab

	External walls									
		Exten	nal wall type 1		External wall type 2					
Dwelling no.	Wall type	Area (m²)	Insulation	Low emissions option	Wall type	Area (m²)	Insulation	Low emissions option		
Main	framed (fibre cement sheet or boards), frame : timber - H2 treated softwood	249	fibreglass batts or roll	-	-	-	-			
All other dwellings	framed (fibre cement sheet or boards), frame : timber - H2 treated softwood	89	fibreglass batts or roll	-	-	-	-	-		

	External walls							
		External v	vall type 3	. 78		External v	vall type 4	
lling no.	Wall type	Area (m²)	Insulation	Low emissions option	Wall type	Area (m²)	Insulation	Low emissions option
vellings	-	-	-	-		=	=1	-

	Internal walls	internal walls											
	Internal walls shared with garage				Internal wall type 1			Internal wall type	2				
Dwelling no.	Wall type	Area (m²)	Insulation	Wall type	Area (m²)	Insulation	Wall type	Area (m²)	Insulation				
Main	-	-	-	plasterboard, frame: timber - H2 treated softwood	159	fibreglass batts or roll	-	-	-				
All other dwellings	-	-	-	plasterboard, frame: timber - H2 treated softwood	22	fibreglass batts or roll	-	-					

	Ceiling and roof											
	Flat ceiling / pitched roof			Raked ceiling / pitched or skillion roof				Flat ceiling / flat	roof			
Dwelling no.	Construction type	Area (m²)	Insulation	Construction type	Area (m²)	Insulation	Construction type	Area (m²)	Insulation			
Main	-	-	-	-	-	-	framed - metal roof, frame: timber - H2 treated softwood	151	-			
All other dwellings	-	,=		-	e e	-	framed - metal roof, frame: timber - H2 treated softwood	61	-1			

		Glazing type		Frame types				
Dwelling no.	Single glazing (m²)	Double glazing (m²)	Triple glazing (m²)	Aluminium frames (m²)	Timber frames (m²)	uPVC frames (m²)	Steel frames (m²)	Composite frames (m²)
Main	-	81	-	81	-	-	-	-
All other dwellings	-	27	5	27	-	-	-	a .

(i) Materials	Show on DA plans	Show on CC/CDC plans & specs	Certifier check
(a) The details of the proposed development on the Assessor Certificate must be consistent with the details shown in this BASIX Certificate, including the details shown in the 'Floor types', 'External wall types', 'Internal wall types', 'Ceiling and roof types', 'Frames' and 'Giazing' fables below.			~
(b) The applicant must show on the plans accompanying the application for a construction certificate (or complying development certificate, if applicable), all specifications included in the tables below.		~	
(c) The applicant must construct the floors, walls, roof, ceiling and roof, windows, glazed doors and skylights of the development in accordance with he specifications listed in the tables below. In the case of glazing, a 5% variance from the area values listed in the "Frames" and "Glazing" table is permitted.	~	~	~
(d) The applicant must show through receipts that the materials purchased for construction are consistent with the specifications listed in the below tables.			V
(i) Water	Show on	Show on CC/CDC	Certifier

(i) Water	Show on DA plans	Show on CC/CDC plans & specs	Certifier check
(a) If, in carrying out the development, the applicant installs a showerhead, toilet, tap or clothes washer into a common area, then that item must meet the specifications listed for it in the table.		~	~
(b) The applicant must install (or ensure that the development is serviced by) the alternative water supply system(s) specified in the "Central systems" column of the table below. In each case, the system must be sized, be configured, and be connected, as specified in the table.	~	~	~
(c) A swimming pool or spa listed in the table must not have a volume (in kLs) greater than that specified for the pool or spa in the table.	~	V	
(d) A pool or spa listed in the table must have a cover or shading if specified for the pool or spa in the table.		~	
(e) The applicant must install each fire sprinkler system listed in the table so that the system is configured as specified in the table.		~	~
(f) The applicant must ensure that the central cooling system for a cooling tower is configured as specified in the table.		_	~

All common no common facility no common facility no common facility no common facility	
areas	

Central systems	Size	Configuration	Connection (to allow for)
Central water tank - rainwater or stommwater (No. 1)	5000	To collect run-off from at least: - 150 square metres of roof area of buildings in the development - 0 square metres of impervious area in the development - 0 square metres of garden/lawn area in the development - 0 square metres of plantier box area in the development (excluding, in each case, any area which drains to, or supplies, any other alternative water supply system).	- irrigation of 0 square metres of common landscaped area on the site - car washing in 0 car washing bays on the site

(ii) Energy	Show on DA plans	Show on CC/CDC plans & specs	Certifier
(a) If, in carrying out the development, the applicant installs a ventilation system to service a common area specified in the table below, then that ventilation system must be of the type specified for that common area, and must meet the efficiency measure specified.		~	~
(ii) Energy	Show on DA plans	Show on CC/CDC plans & specs	Certifier check
(b) In carrying out the development, the applicant must install, as the "primary type of artificial lighting" for each common area specified in the table below, the lighting specified for that common area. This lighting must meet the efficiency measure specified. The			

					-
in the table below, the lighting specified	or that common area. Th	"primary type of artificial lighting" for each common area specified is lighting must meet the efficiency measure specified. The Building Management System (BMS) for the common area,		~	~
(c) The applicant must install the systems are case, the system or fixture must be of the		e "Central energy systems" column of the table below. In each cifications, listed for it in the table.	~	V	

ARCHITECT'S WORK IS COPYRIGHT AND COVERED BY COPYRIGHT ACT 1968

DRAWINGS NOTTO BE SCALED, USE FIGURED DIMENSIONS ONLY; CHECK ALL DIMENSIONS ON SITE . ELECTRONIC COPIES OF DRAWINGS SHOULD BE VERIFIED AGAINST PRINTED COPIES TO ENSURE NO LOSS O



reg# NSW 7417 - TIM WEST ph. 02 9918 5085

e. tim@thw.net.au

m. Suite 101 - Level 1, 60 Old Barrenjoey rd, Avalon NSW, 2107

BEE & LETHBRIDGE PTY LTD SUITE 2, 14 STARKEY ST, FORESTVILLE, NSW, 2087 P. 9975 3535 E. SURVEY@BEELETH.COM.AU W. BEELETH.COM.AU

STORMWATER / FLOOD

BARRENJOEY CONSULTING ENGINEERS 34 GEORGE ST. AVALON, NSW, 2107 LUCASBCE@BIGPOND.COM 0418 620 330

VAUGHAN MILLIGAN DEVELOPMENT CONSULTING VAUGHAN MILLIGAN 8/1 KALINYA ST, NEWPORT, NSW, 2106 9999 4922

PLANNER

BASIX / NATHERS

SUSTAINABLE THERMAL SOLUTIONS
138 COWLES RD, MOSMAN, NSW, 2088
ENQUIRIES@SUSTAINABLETHERMALSOLUTIONS.COM.AU
0420 312 721

LANDSCAPE A TOTAL CONCEPT 65 WEST ST, NORTH SYDNEY, NSW, 2060 DESIGN@ATOTALCONCEPT.COM.AU 9957 5122

BIODIVERSITY / COASTAL

ECOLOGICALCA@OUTLOOK.COM 9918 4486

ECOLOGICAL CONSULTANTS AUSTRALIA

PROJECT PROPOSED DWELLING 12A JOHN ST, AVALON, NSW, 2107

Certificate No. # 94YOOEA7WS
Scan QR code or follow washells a final fin CLIENT TIM DONOVAN TDONOVAN@CITYFREEHOLDS.

A 01/12/2023 DA

DATE

COMMENTS

CHK. BY PAGE SIZE JOB NUM# DRAWN BY MV А3 142A PROJECT NAME SCALE 12A JOHN ST DRAWING NAME DRAWING NUMBER BASIX & NATHERS A 106 -A