DEVELOPMENT APPLICATION

57 PARNI PLACE, FRENCHS FOREST 2086




SUBJECT SITE

CONTENTS PAGE **DRAWING TITLE** COVER PAGE DA.00 SITE ANALYSIS PLAN EXISTING GROUND FLOOR PLAN EXISTING FIRST FLOOR PLAN EXISTING ROOF PLAN DA.01 DA.02 DA.03 DA.04 DEMOLITION GROUND FLOOR PLAN DEMOLITION FIRST FLOOR PLAN DEMOLITION ROOF PLAN EXISTING ELEVATIONS SHEET 1 EXISTING ELEVATIONS SHEET 2 EXISTING ELEVATIONS SHEET 3 EXISTING ELEVATIONS SHEET 4 DA.05 DA.06 DA.07 DA.08 DA.09 DA.10 DA.11 PROPOSED GROUND FLOOR PLAN PROPOSED FIRST FLOOR PLAN DA.12 DA.13 PROPOSED ROOF PLAN PROPOSED ELEVATIONS SHEET 1 PROPOSED ELEVATIONS SHEET 2 DA.14 DA.15 DA.16 PROPOSED ELEVATIONS SHEET 3 PROPOSED ELEVATIONS SHEET 4 SECTION / SPECIFICATION DA.17 DA.18 DA.19 DA.20 LANDSCAPED AREA CALCULATION PLAN ROOF & STORMWATER CONCEPT PLAN EROSION & SEDIMENT CONTROL / WASTE MANAGEMENT PLAN SHADOW DIAGRAM JUNE 21 9AM SHADOW DIAGRAM JUNE 21 12PM SHADOW DIAGRAM JUNE 21 3PM OPENINGS SCHEDULE DA.21 DA.22 DA.23 DA.24 DA.25 DA.26





JJ DRAFTING AUSTRALIA PTY LTD 1300 977 804 www.jjdrafting.com.au

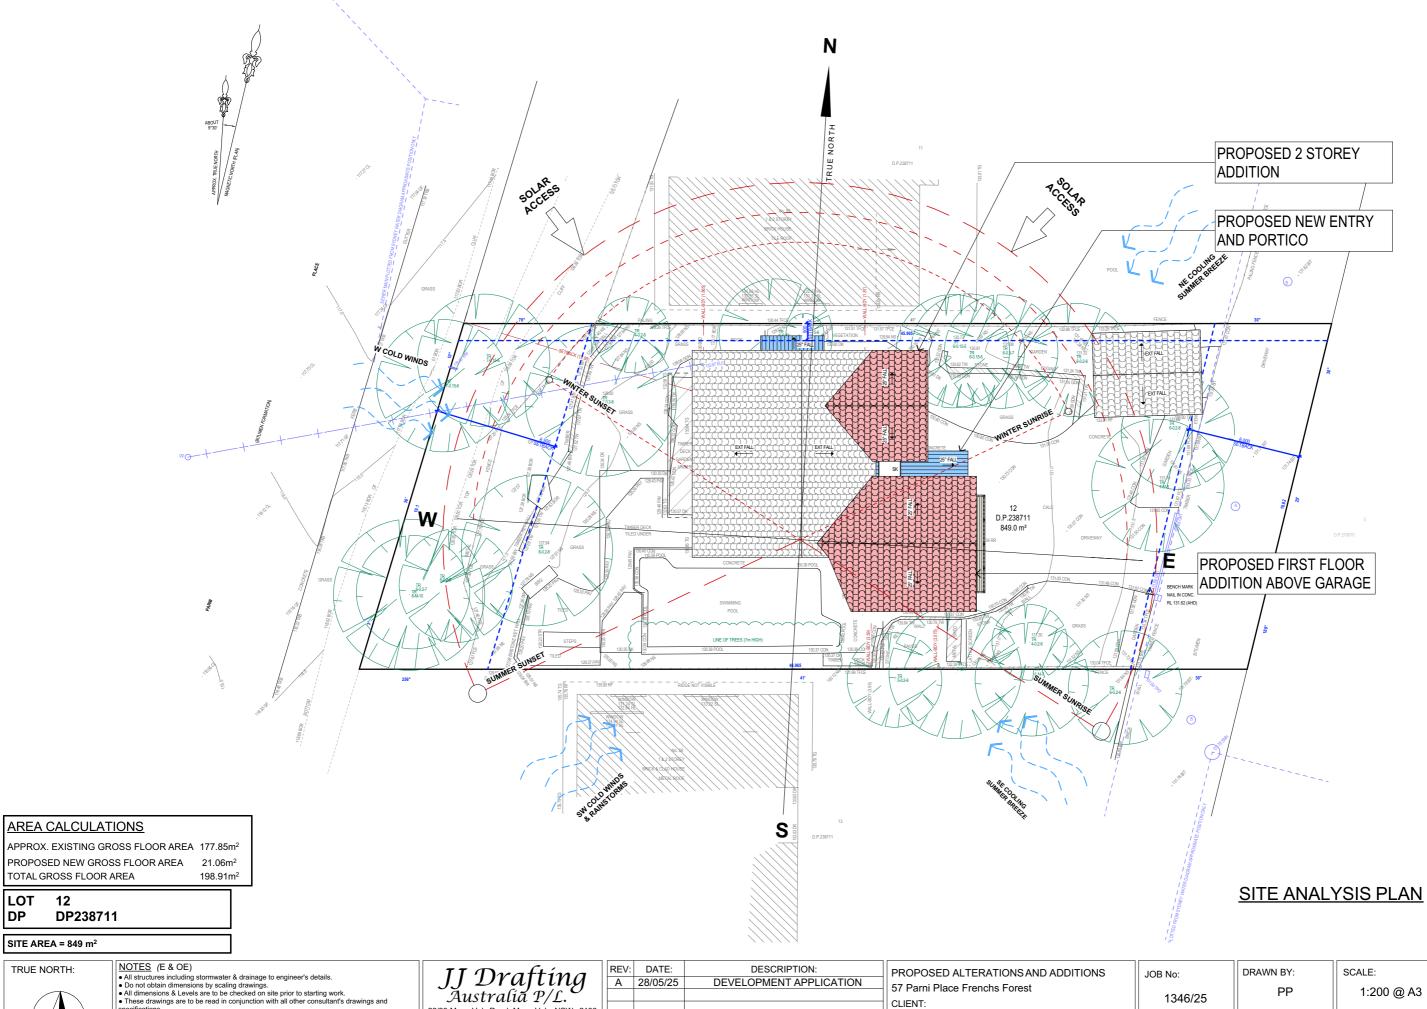

 All workmariship a finaterials sital use in accordance with the requirements of cultural construction. Today, represent the standards & loca council requirements.
 New materials are to be used throughout unless otherwise noted.
 Concrete footings, slab, structural beams or any other structural members are to be designed. by a practicing engineer.

26/90 Mona Vale Road, Mona Vale, NSW, 2103 PO Box 687, Dee Why, NSW, 2099 Mob. 0414 717 541 | ACN 651 693 346 Email. enquiries@jjdrafting.com.au www.jjdrafting.com.au


- 1	· \L v .	D/(IL.	DECORA TION.	I PROPOSED ALTERATION
	Α	28/05/25	DEVELOPMENT APPLICATION	57 Parni Place Frenchs For
				37 Famili Flace Flench's For
				CLIENT:
				Sophia Dafaur
-				
-				DRAWING TITLE:
				SITE ANALYSIS PLAN


PROPOSED ALTERATIONS AND ADDITIONS 57 Parni Place Frenchs Forest
CLIENT: Sophia Dafaur
DRAWING TITLE:


DATE:


APR/25


1:200 @ A3 BUILDING DESIGNER DRAWING No: CHECKED BY: **DA.01** JJ

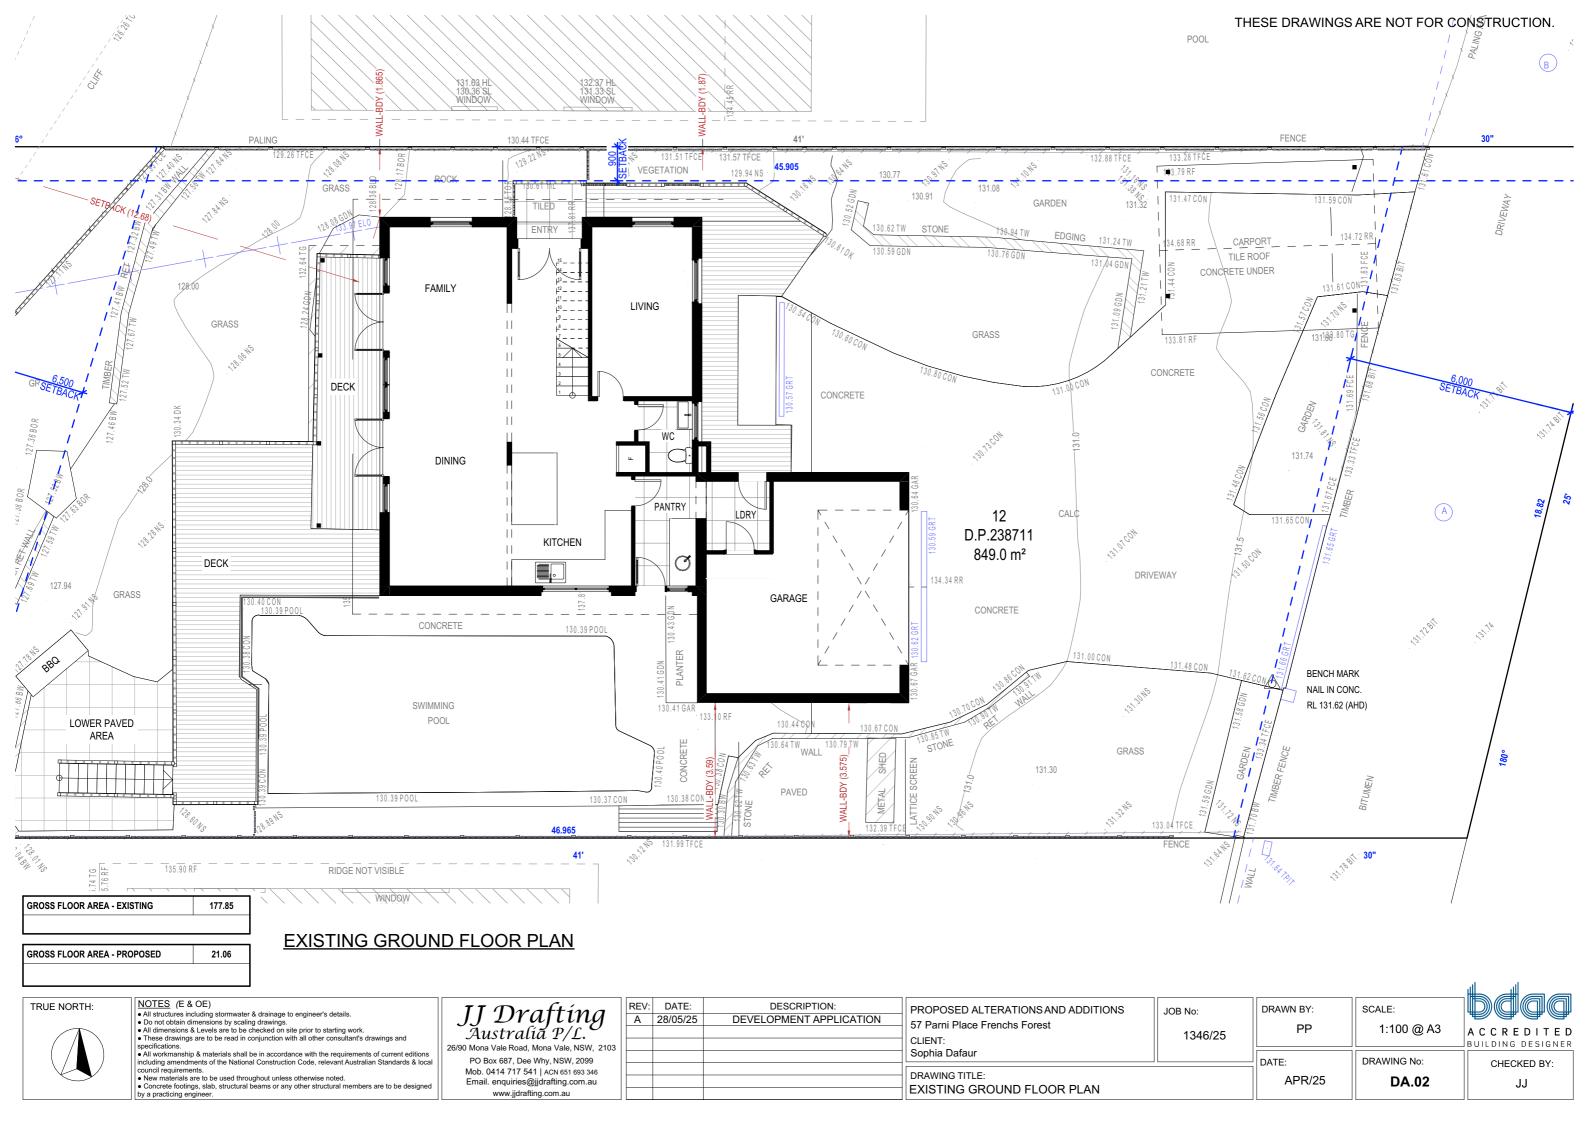


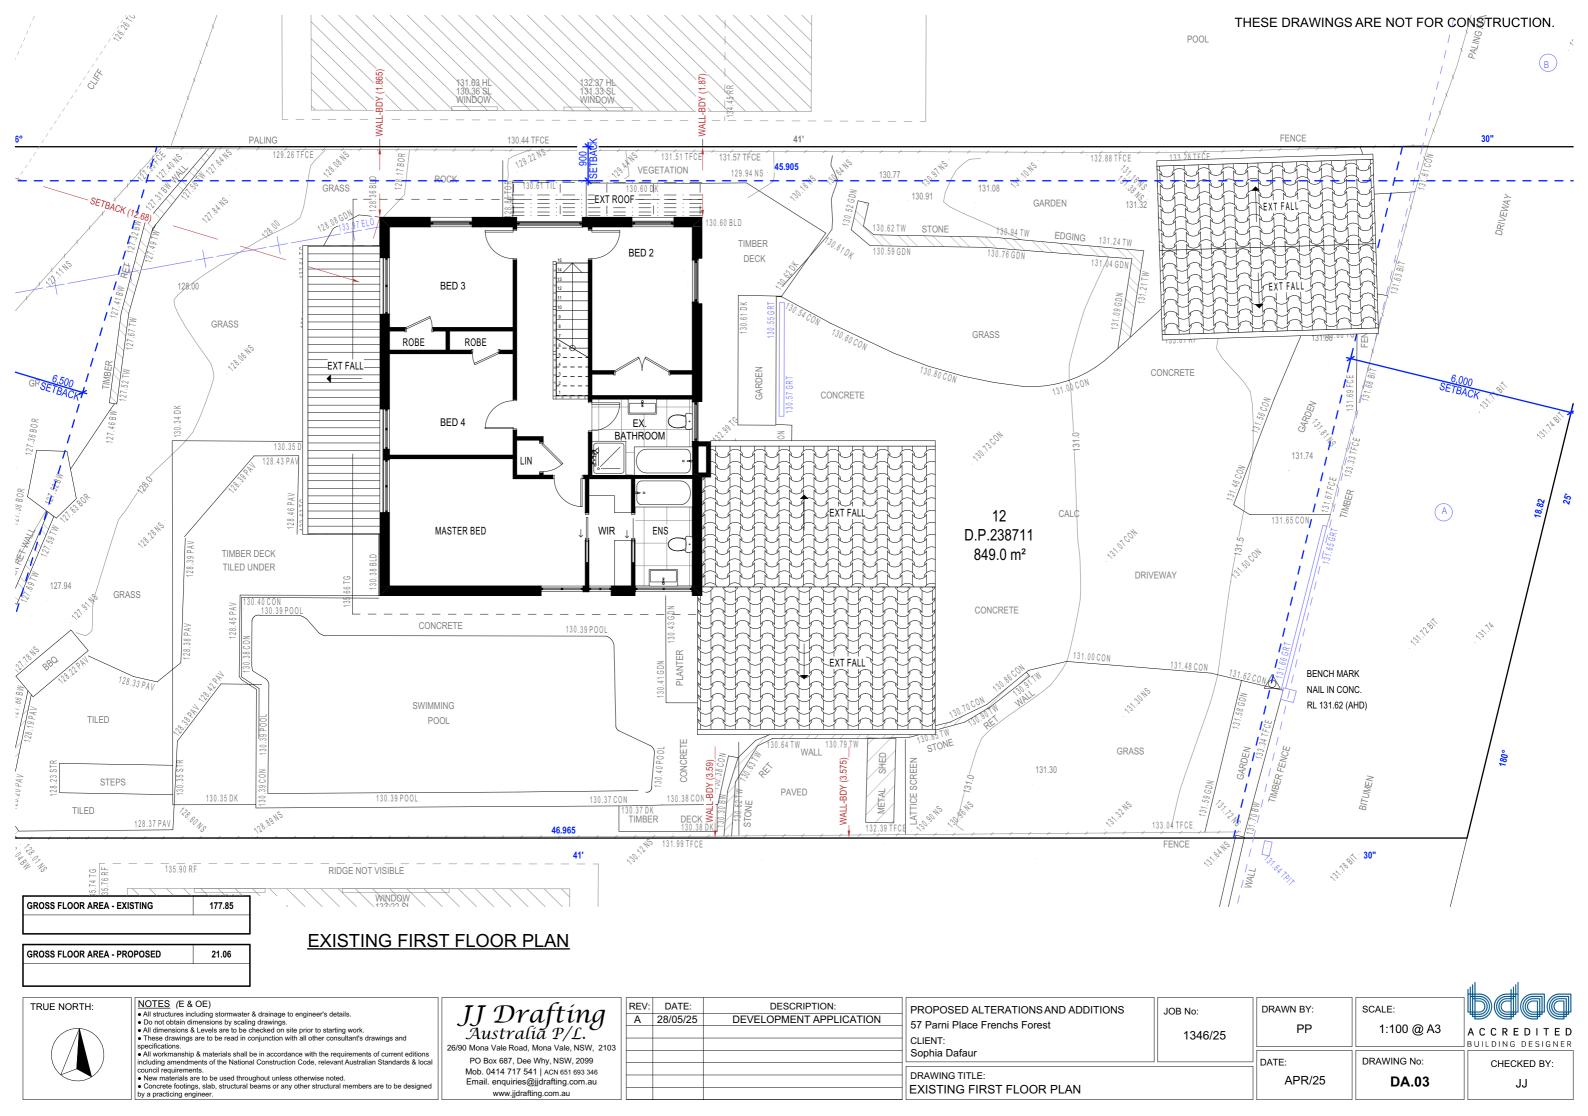


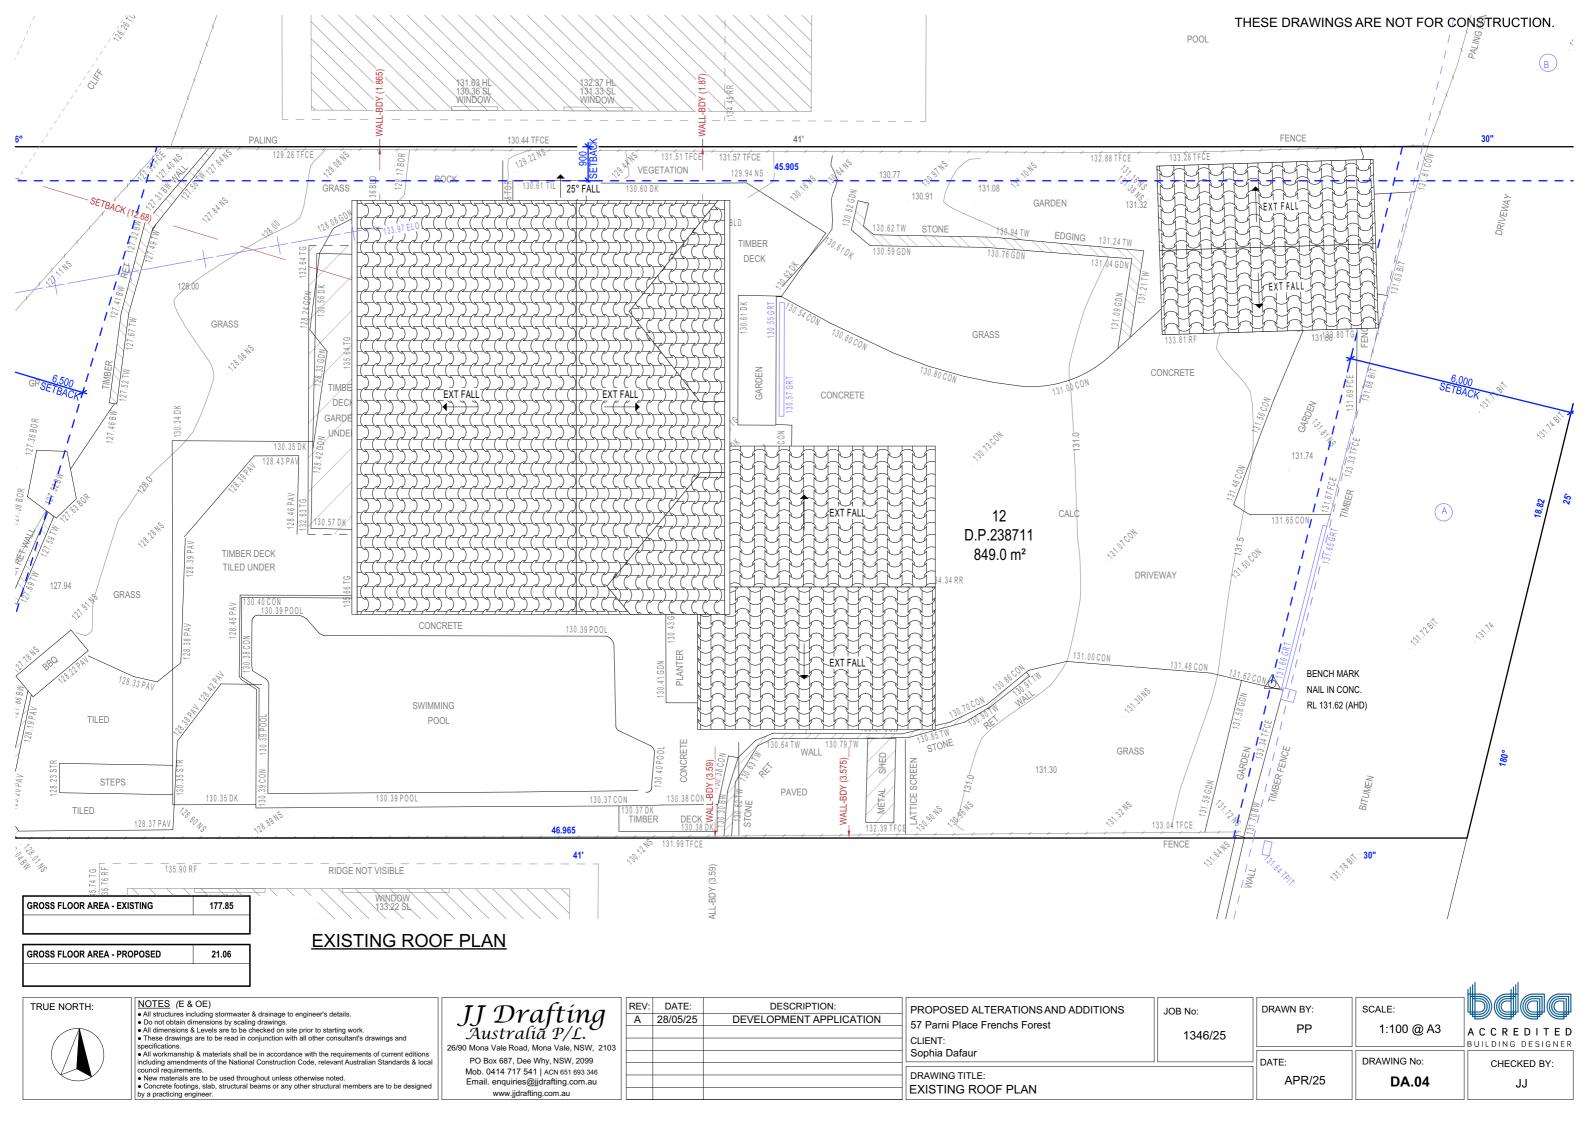

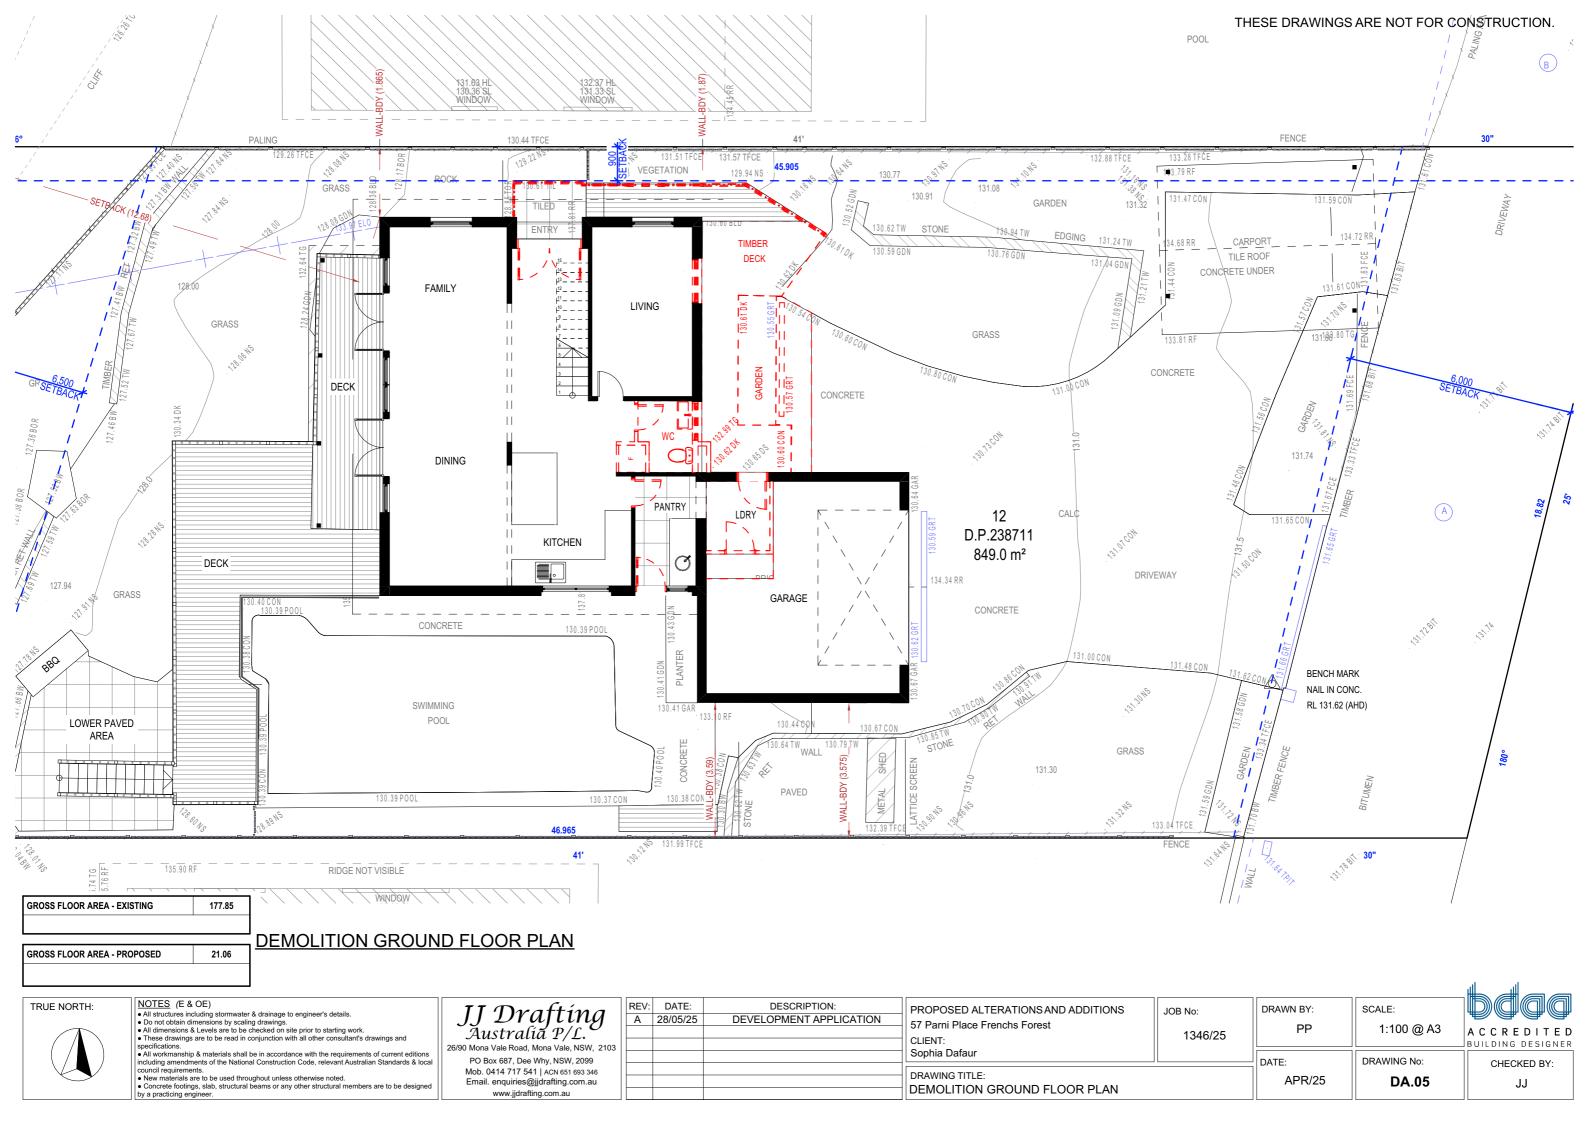

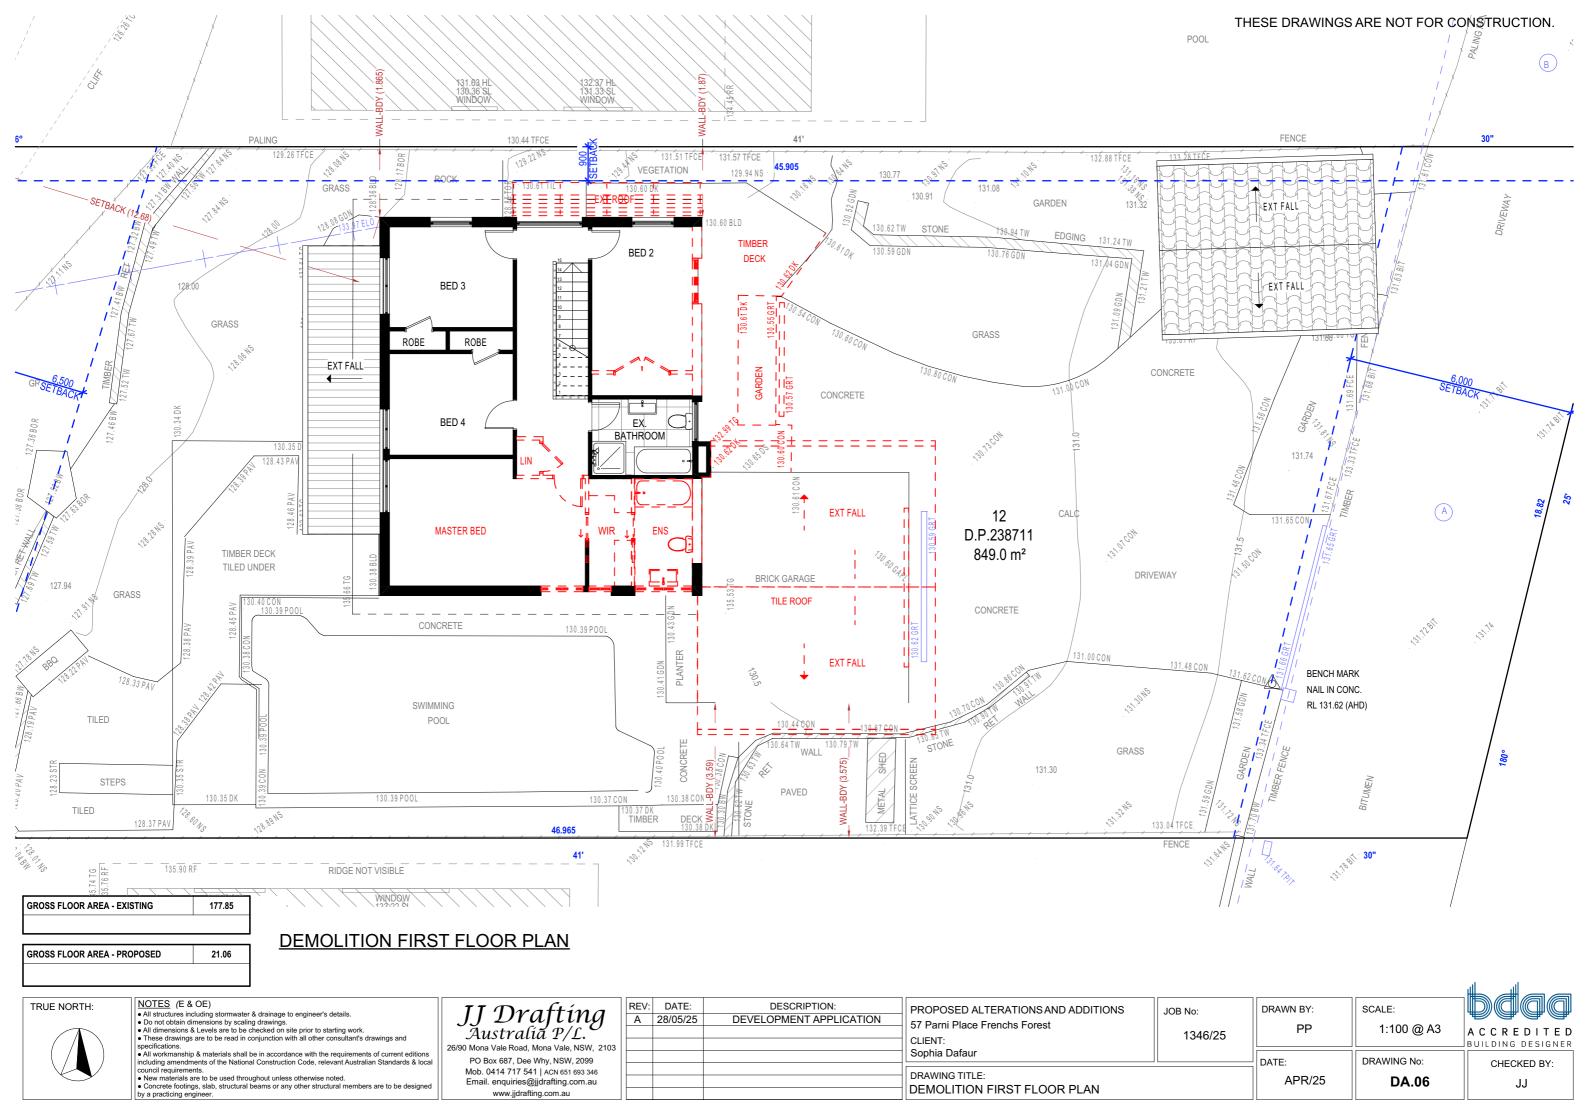

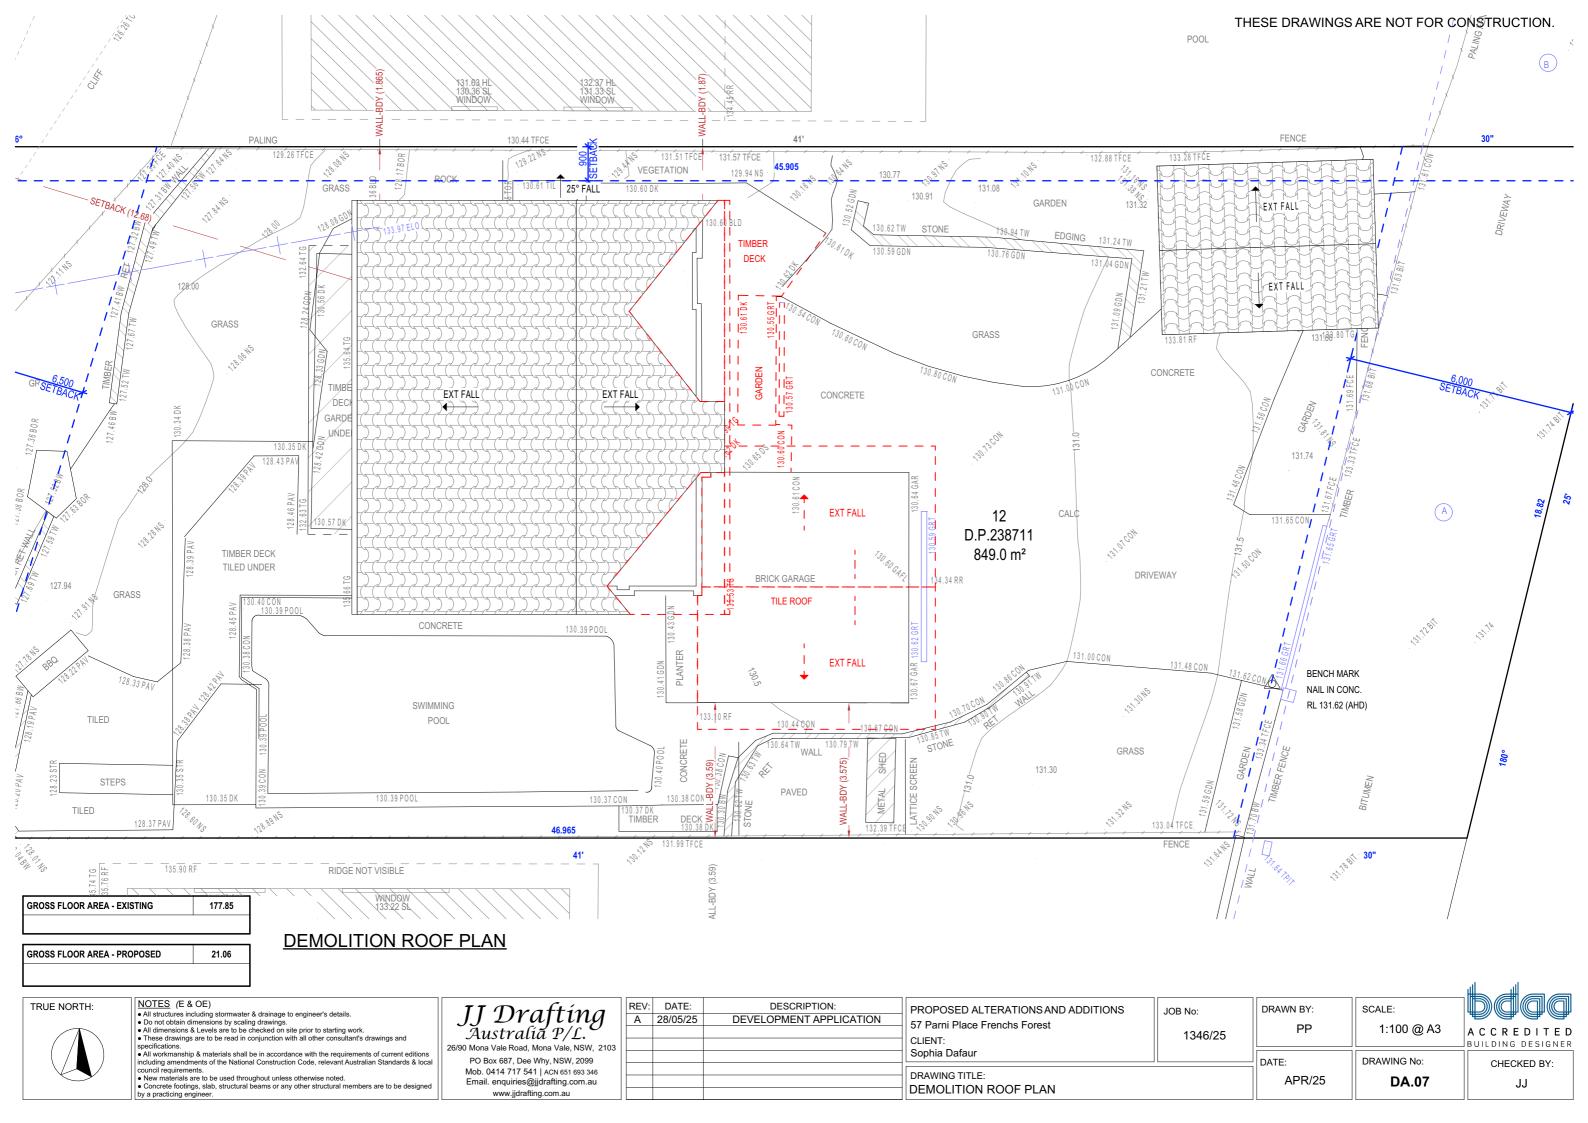

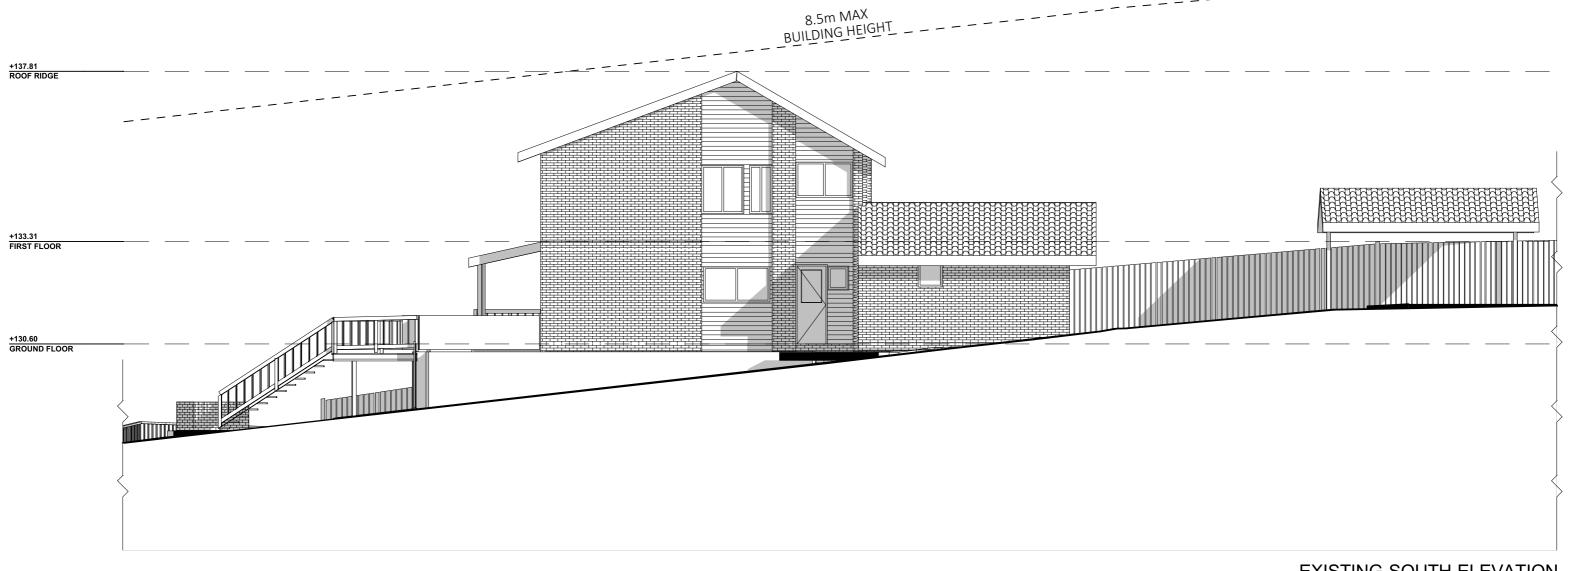

EXISTING SOUTH ELEVATION

- NOTES (E & OE)

 All structures including stormwater & drainage to engineer's details.

 Do not obtain dimensions by scaling drawings.

 All dimensions & Levels are to be checked on site prior to starting work.

 These drawings are to be read in conjunction with all other consultant's drawings and specifications.

 All workmanship & materials shall be in accordance with the requirements of current editic including amendments of the National Construction Code, relevant Australian Standards & I
- All workmanship & materials shall be in accordance with the requirements of current editions including amendments of the National Construction Code, relevant Australian Standards & loca council requirements.

 New materials are to be used throughout unless otherwise noted.
 Concrete footings, slab, structural beams or any other structural members are to be designed by a practicing engineer.

JJ Drafting ^{Australia} P/L.

26/90 Mona Vale Road, Mona Vale, NSW, 2103 PO Box 687, Dee Why, NSW, 2099 Mob. 0414 717 541 | ACN 651 693 346 Email. enquiries@jjdrafting.com.au www.jjdrafting.com.au

	REV:	DATE:	DESCRIPTION:	
	Α	28/05/25	DEVELOPMENT APPLICATION] 5
				\parallel_{c}
3				∃s
				╁
				IJE

PROPOSED ALTERATIONS AND ADDITIONS 57 Parni Place Frenchs Forest
CLIENT: Sophia Dafaur
DRAWING TITLE: EXISTING ELEVATIONS SHEET 1

JOB No:	DRAWN BY:
1346/25	PP
	DATE.

DRAWN BY:	SCALE:	P
PP		A C C R E
DATE:	DRAWING No:	CHEC
4 DD /0E	D 4 00	

		BUILDING DESIGN
i:	DRAWING No:	CHECKED BY:
APR/25	DA.08	JJ

+137.81 ROOF RIDGE +133.31 FIRST FLOOR +130.60 GROUND FLOOR

8.5m MAX BUILDING HEIGHT

EXISTING EAST ELEVATION

- NOTES (E & OE)

 All structures including stormwater & drainage to engineer's details.

 Do not obtain dimensions by scaling drawings.

 All dimensions & Levels are to be checked on site prior to starting work.

 These drawings are to be read in conjunction with all other consultant's drawings and specifications.
- PAI WORNIAISHIP & ITRAETICAL STRIAI DE III ACCORDANCE WILL UIE FEQUIPMENTS OF CONTROLLED STRIAIN STR
- by a practicing engineer.

JJ Drafting ^{Australia} P/L.

26/90 Mona Vale Road, Mona Vale, NSW, 2103 PO Box 687, Dee Why, NSW, 2099 Mob. 0414 717 541 | ACN 651 693 346 Email. enquiries@jjdrafting.com.au www.jjdrafting.com.au

	REV:	DATE:	DESCRIPTION:
	Α	28/05/25	DEVELOPMENT APPLICATION
03			

PROPOSED ALTERATIONS AND ADDITIONS 57 Parni Place Frenchs Forest CLIENT: Sophia Dafaur

EXISTING ELEVATIONS SHEET 2

DRAWING TITLE:

JOB No: 1346/25 DRAWN BY: SCALE: 1:100 @ A3 ACCREDITED BUILDING DESIGNER CHECKED BY:

JJ

DATE: APR/25 DRAWING No: DA.09

+137.81 EXISTING ROOF RIDGE 8.5m MAX BUILDING HEIGHT +133.31 EXISTING FIRST FLOOR +130.60 EXISTING GROUND FLOOR

EXISTING NORTH ELEVATION

- NOTES (E & OE)

 All structures including stormwater & drainage to engineer's details.

 Do not obtain dimensions by scaling drawings.

 All dimensions & Levels are to be checked on site prior to starting work.

 These drawings are to be read in conjunction with all other consultant's drawings and specifications.

 All workmanship & materials shall be in accordance with the requirements of current edition including amendments of the National Construction Code relevant Australian Standards & Io
- All workmanship & materials shall be in accordance with the requirements of current editions including amendments of the National Construction Code, relevant Australian Standards & local council requirements.

 New materials are to be used throughout unless otherwise noted.

 Concrete footings, slab, structural beams or any other structural members are to be designed by a practicing engineer.

JJ Drafting ^{Australia} P/L.

26/90 Mona Vale Road, Mona Vale, NSW, 2103 PO Box 687, Dee Why, NSW, 2099 Mob. 0414 717 541 | ACN 651 693 346 Email. enquiries@jjdrafting.com.au www.jjdrafting.com.au


03	REV:	DATE: 28/05/25	DESCRIPTION: DEVELOPMENT APPLICATION	PROPOSED ALTERATIONS AND ADDITI 57 Parni Place Frenchs Forest CLIENT: Sophia Dafaur
				DRAWING TITLE: EXISTING ELEVATIONS SHEET 3

PROPOSED ALTERATIONS AND ADDITIONS 57 Parni Place Frenchs Forest	
CLIENT: Sophia Dafaur	
DRAWING TITLE:	

No:	DRAWN BY:	SCALE:
1346/25	PP	1:1
	DATE.	DDAM

APR/25

100 @ A3 BUILDING DESIGNER VING No: CHECKED BY: **DA.10**

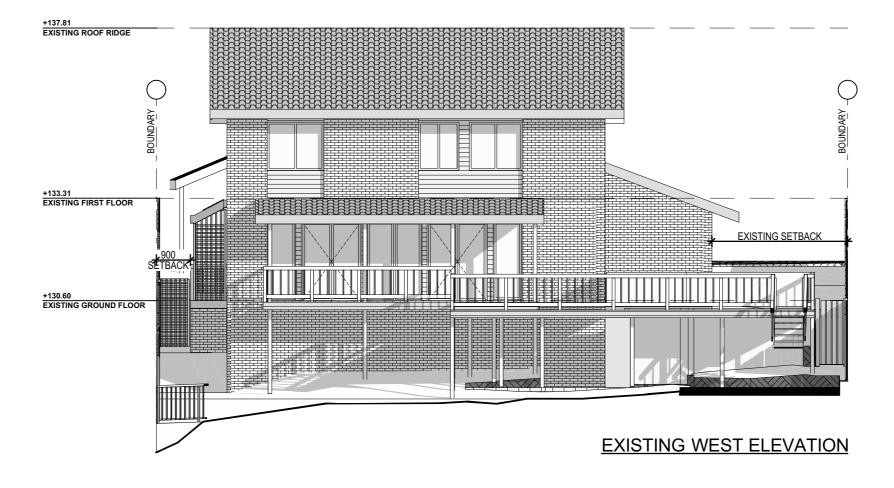

NOTES (E & OE)

• All structures including stormwater & drainage to engineer's details.

• Do not obtain dimensions by scaling drawings.

• All dimensions & Levels are to be checked on site prior to starting work.

• These drawings are to be read in conjunction with all other consultant's drawings and specifications.

• All workmanship & materials shall be in accordance with the requirements of current editions including amendments of the National Construction Code relevant Australian Standards & local

All workmanship & materials shall be in accordance with the requirements of current editions including amendments of the National Construction Code, relevant Australian Standards & local council requirements.

New materials are to be used throughout unless otherwise noted.

Concrete footings, slab, structural beams or any other structural members are to be designed by a practicing engineer.

JJ Drafting Australia P/L.
6/90 Mona Vale Road, Mona Vale, NSW, 2103

PO Box 687, Dee Why, NSW, 2099 Mob. 0414 717 541 | ACN 651 693 346 Email. enquiries@jjdrafting.com.au www.jjdrafting.com.au

	REV:	DATE:	DESCRIPTION:	PROPOSED ALTERATIONS AND ADDITI
	Α	28/05/25	DEVELOPMENT APPLICATION	57 Parni Place Frenchs Forest
03				CLIENT: Sophia Dafaur
				DRAWING TITLE: EXISTING ELEVATIONS SHEET 4

PROPOSED ALTERATIONS AND ADDITIONS
57 Parni Place Frenchs Forest
CLIENT:
Sophia Dafaur

JOB No: 1346/25


DRAWN BY: SCALE: PP 1:100 @ A3


DRAWING No:


DA.11


ACCREDITED BUILDING DESIGNER CHECKED BY:

DATE: APR/25 JJ

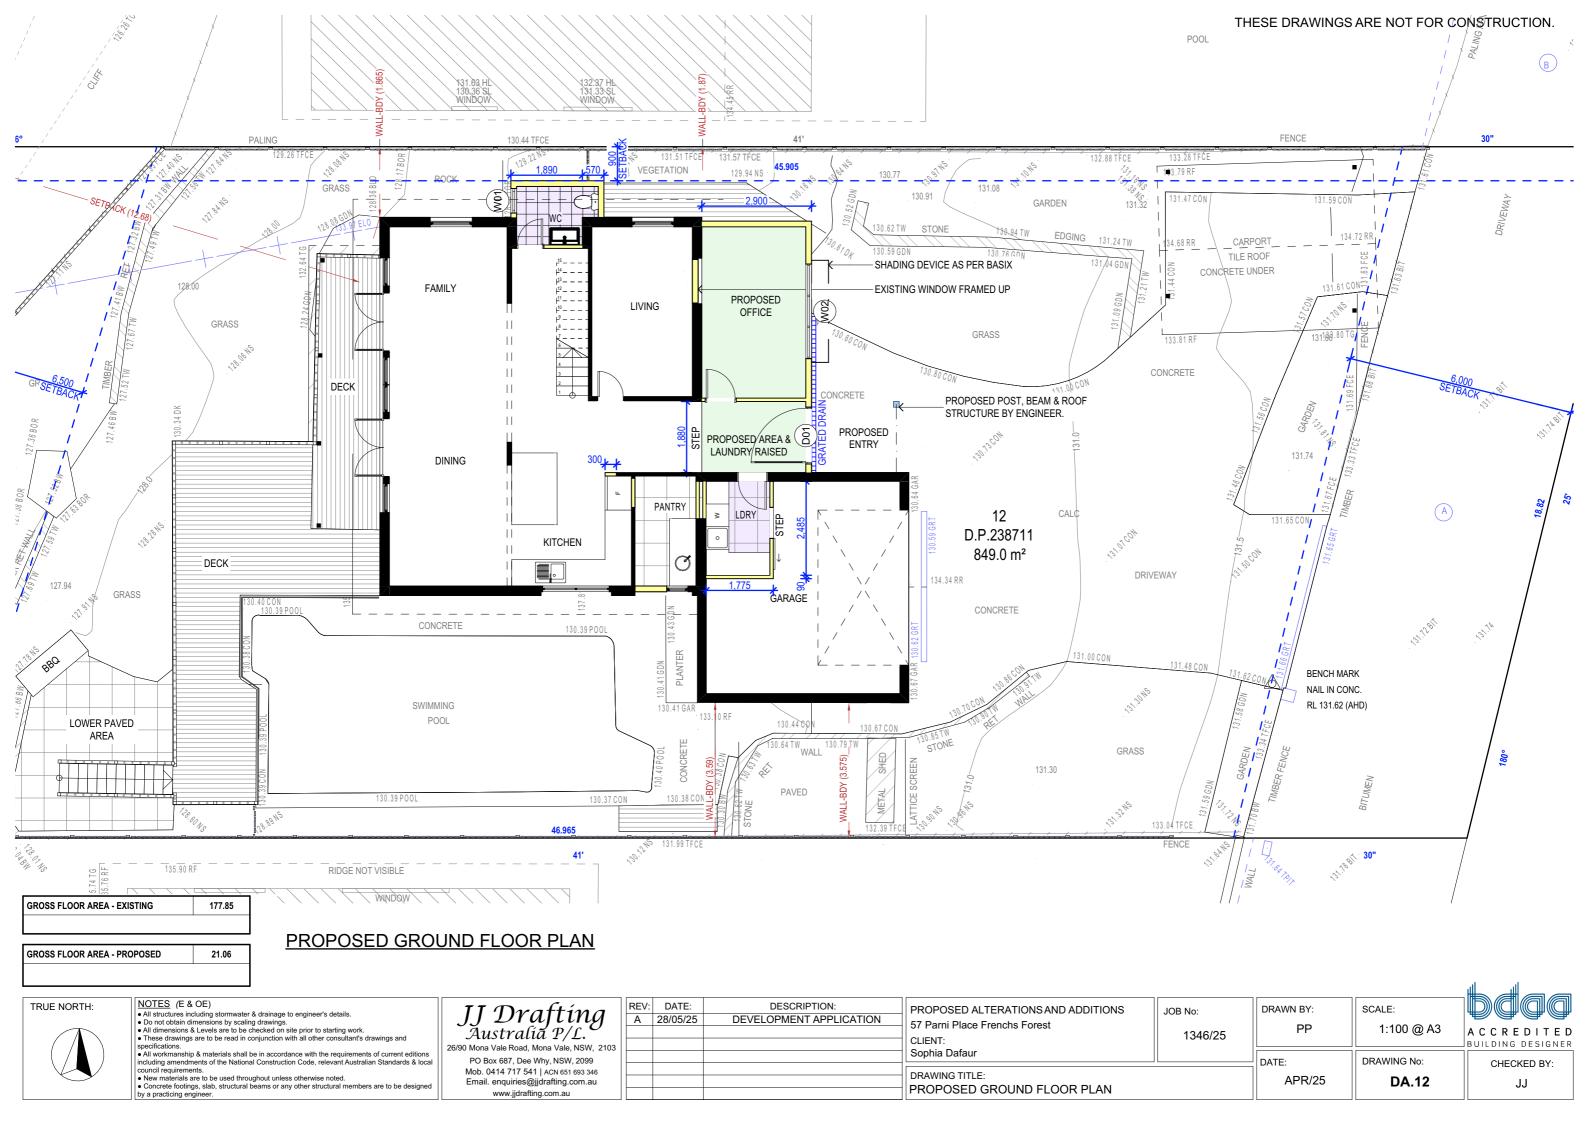

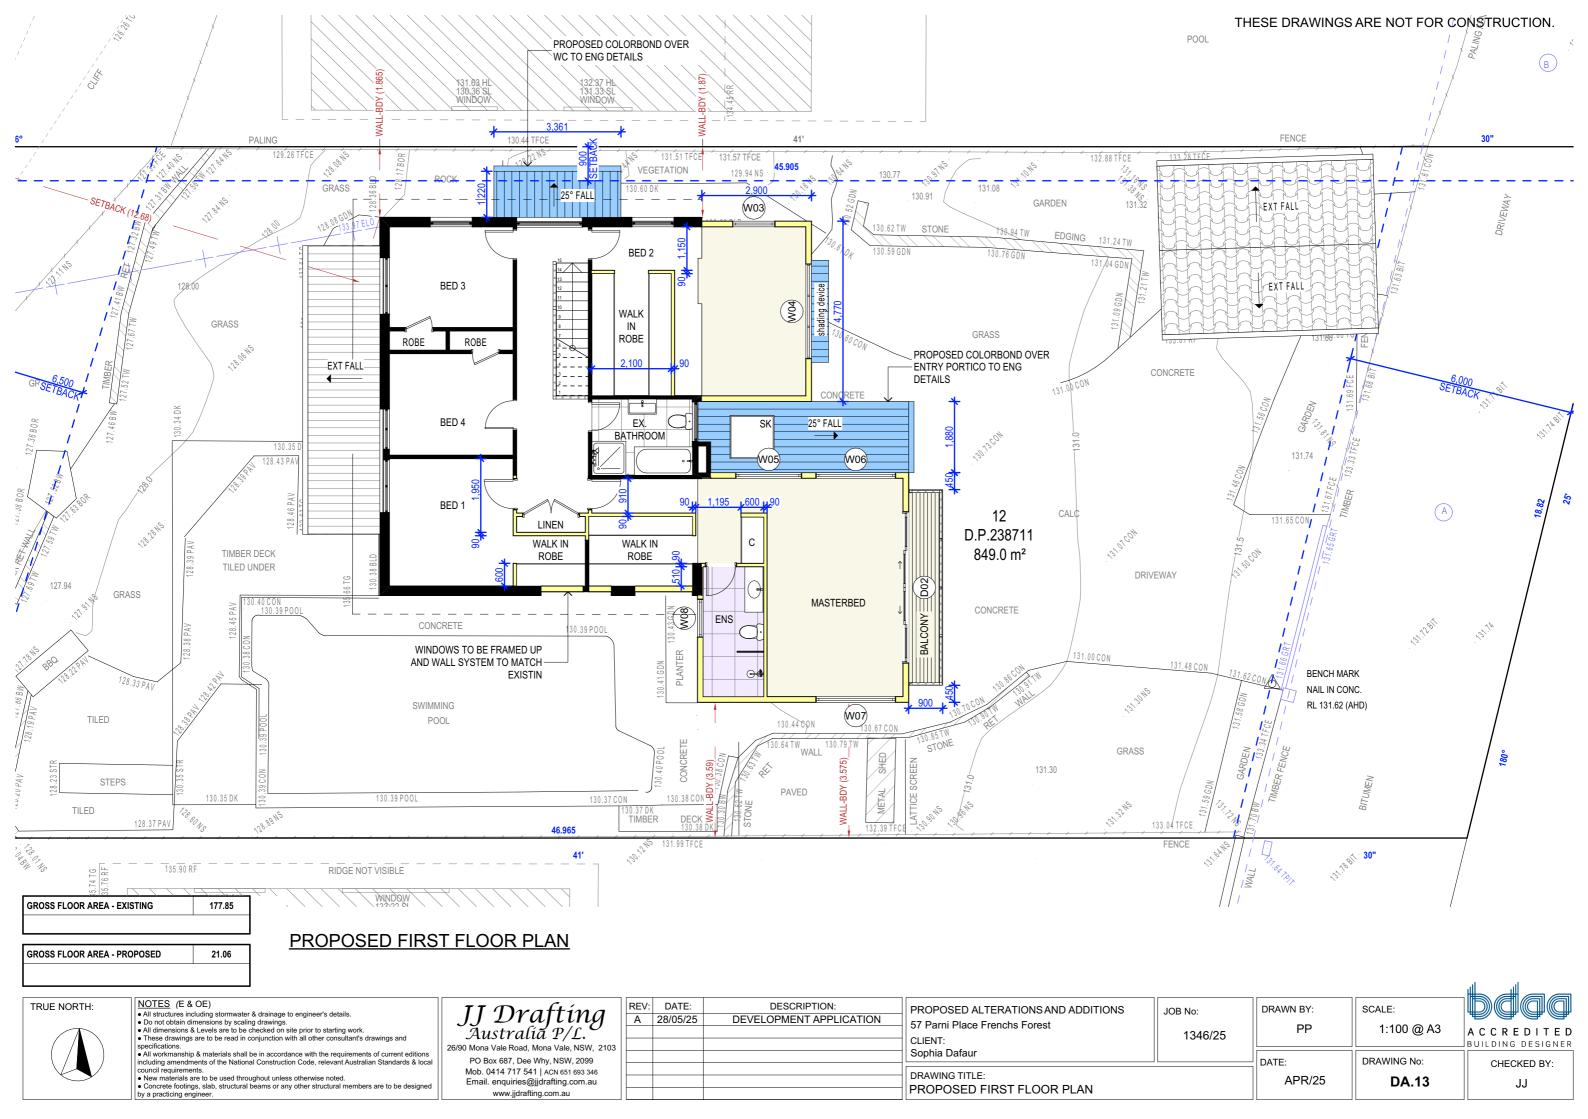

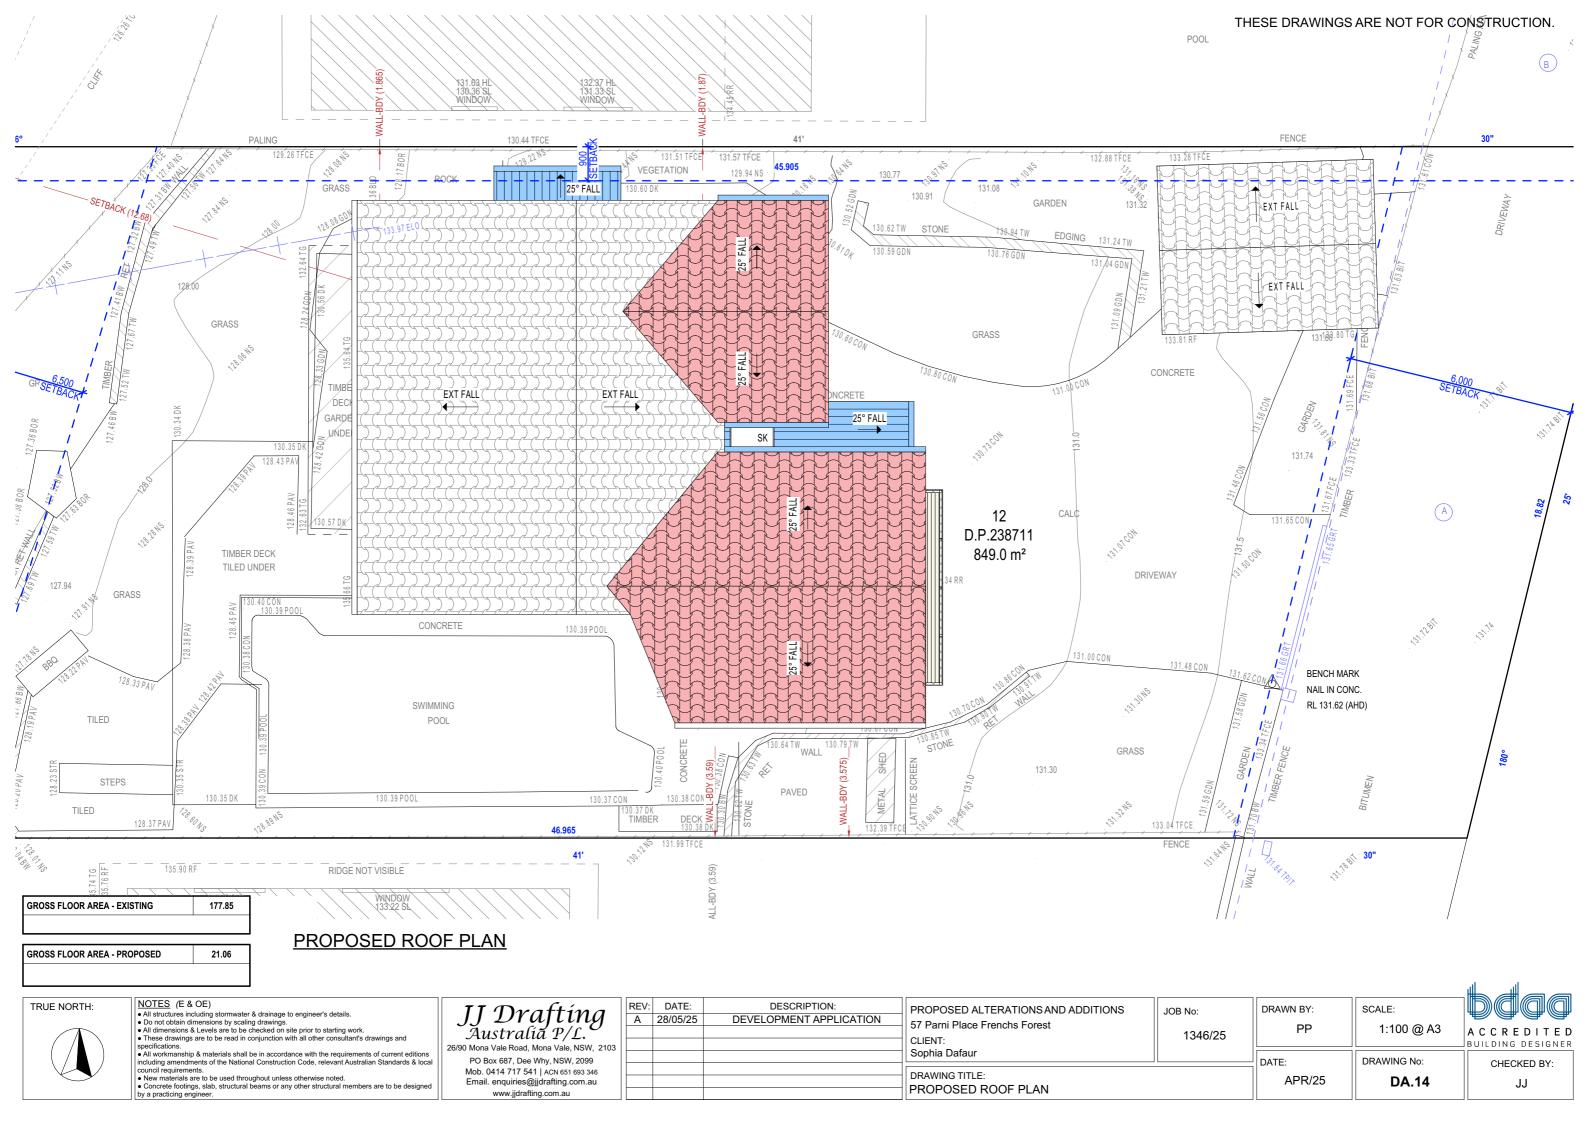

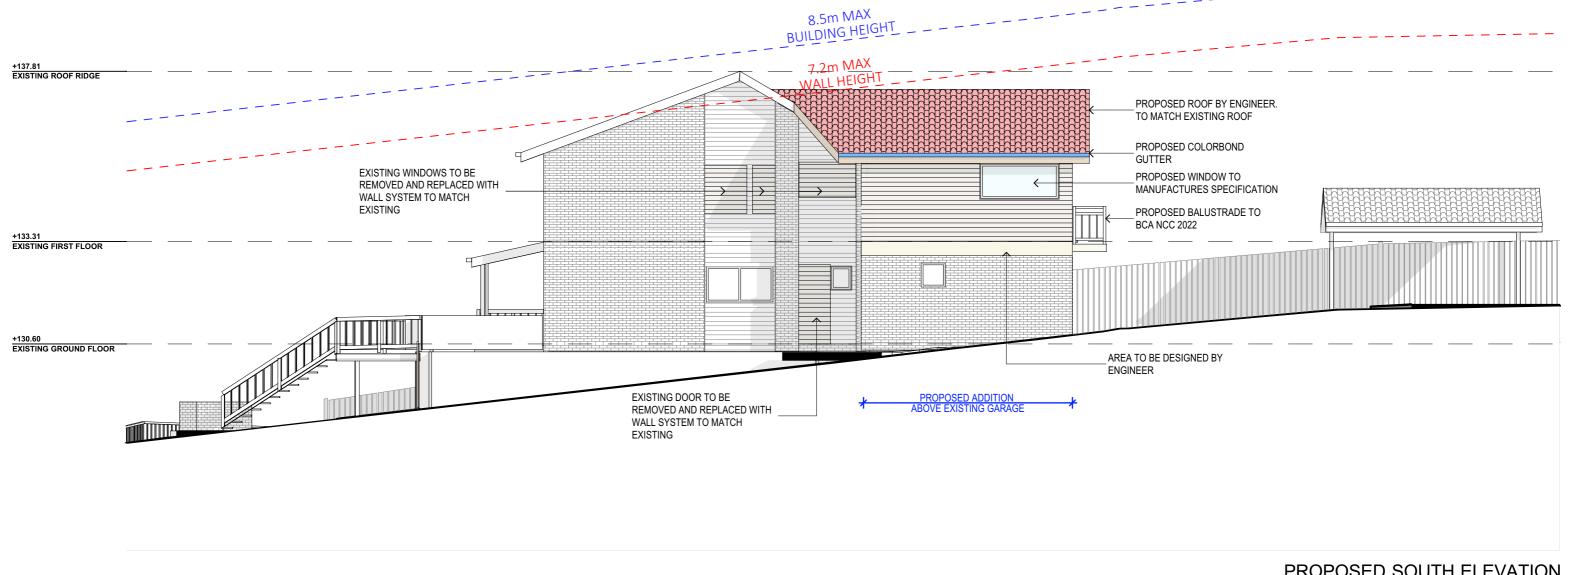

PROPOSED SOUTH ELEVATION

- NOTES (E & OE)

 All structures including stormwater & drainage to engineer's details.

 Do not obtain dimensions by scaling drawings.
 All dimensions & Levels are to be checked on site prior to starting work.
 These drawings are to be read in conjunction with all other consultant's drawings and specifications
- All working amendments of the National Construction Code, relevant Australian Standards & loca council requirements.
 New materials are to be used throughout unless otherwise noted.
 Concrete footings, slab, structural beams or any other structural members are to be designed by a prefixing continuous.

JJ Drafting Australia P/L. 26/90 Mona Vale Road, Mona Vale, NSW, 2103

PO Box 687, Dee Why, NSW, 2099 Mob. 0414 717 541 | ACN 651 693 346 Email. enquiries@jjdrafting.com.au www.jjdrafting.com.au


03	REV:	DATE: 28/05/25	DESCRIPTION: DEVELOPMENT APPLICATION	PROPOSED ALTERATIONS AND ADDITION 57 Parni Place Frenchs Forest CLIENT:
				Sophia Dafaur
				DRAWING TITLE: PROPOSED ELEVATIONS SHEET 1

PROPOSED ALTERATIONS AND ADDITIONS
7 Parni Place Frenchs Forest
CLIENT:
Sophia Dafaur

JOB No:	DRA
1346/25	
	11

	DDAMING No.
PP	1:100 @
DRAWN BY:	SCALE:

ATE:	DRAWING No:	CHECKED
APR/25	DA.15	JJ

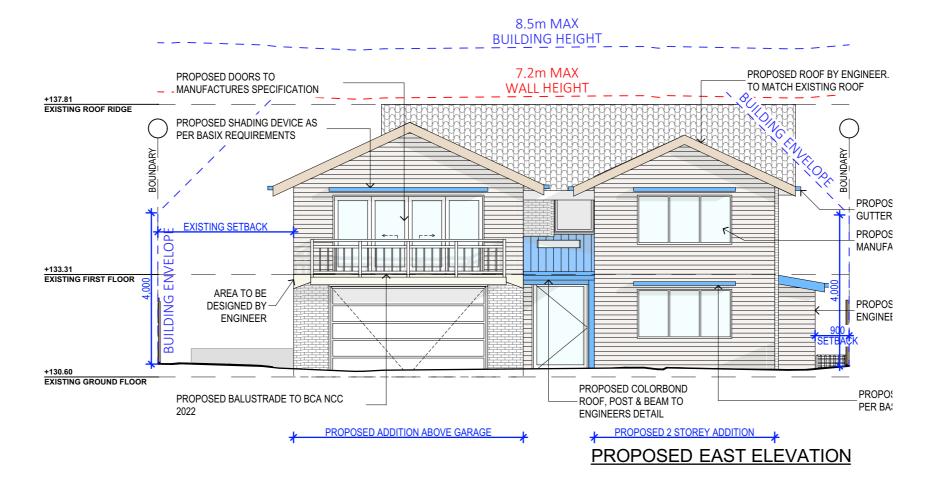

- NOTES (E & OE)

 All structures including stormwater & drainage to engineer's details.

 Do not obtain dimensions by scaling drawings.

 All dimensions & Levels are to be checked on site prior to starting work.

 These drawings are to be read in conjunction with all other consultant's drawings and apported to the starting work.
- PAI WORNIAISHIP & ITRAETICAL STRIAI DE III ACCORDANCE WILL UIE FEQUIPMENTS OF CONTROLLED STRIAIN STR
- by a practicing engineer.

JJ Drafting ^{Australia} P/L.

26/90 Mona Vale Road, Mona Vale, NSW, 2103 PO Box 687, Dee Why, NSW, 2099 Mob. 0414 717 541 | ACN 651 693 346 Email. enquiries@jjdrafting.com.au www.jjdrafting.com.au


	REV:	DATE:	DESCRIPTION:	PROPOSED ALTERATIONS AND ADDITION
	Α	28/05/25	DEVELOPMENT APPLICATION	57 Parni Place Frenchs Forest
03				CLIENT:
				Sophia Dafaur
				DRAWING TITLE:
				PROPOSED ELEVATIONS SHEET 2

PROPOSED ALTERATIONS AND ADDITIONS
57 Parni Place Frenchs Forest
CLIENT:
Sophia Dafaur

DRAWN BY: SCALE: JOB No: PΡ 1346/25

1:100 @ A3 ACCREDITED BUILDING DESIGNER DRAWING No:

DATE: APR/25 **DA.16** CHECKED BY: JJ

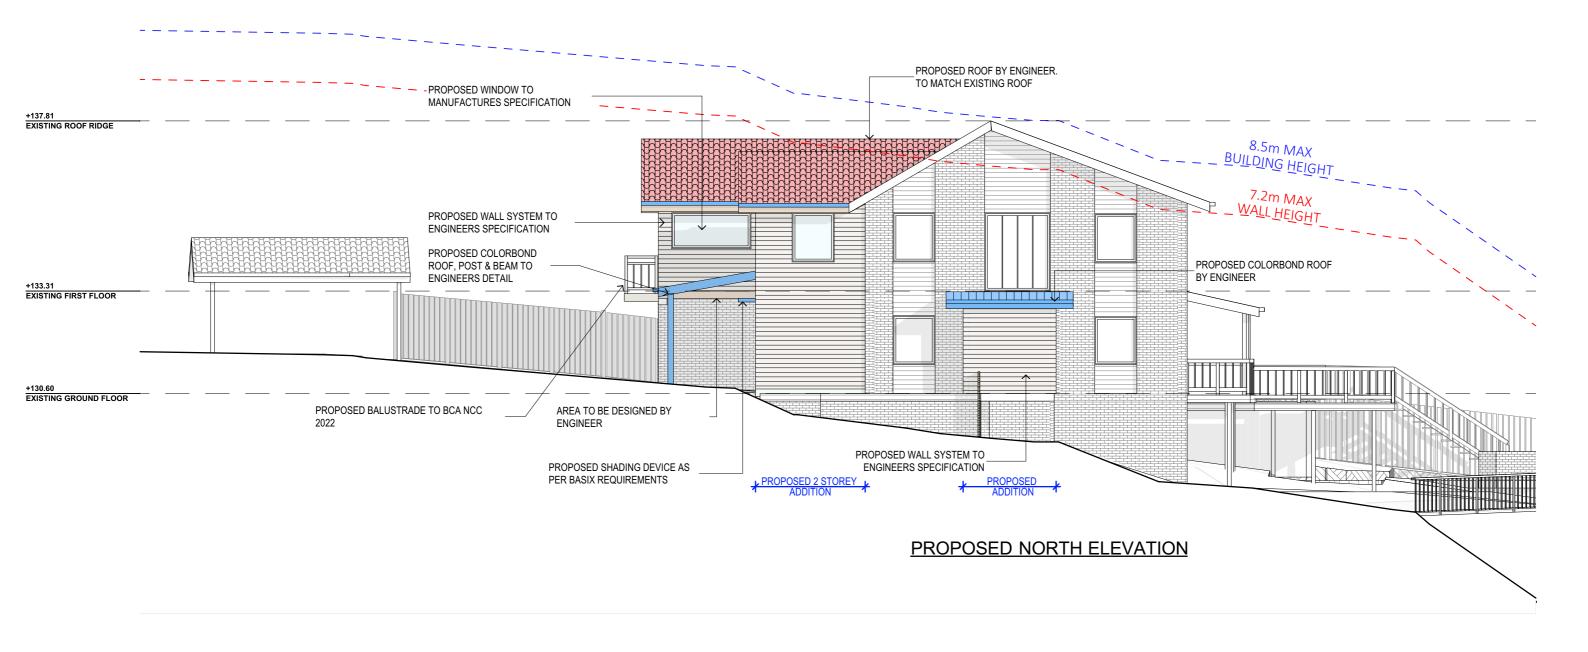

- NOTES (E & OE)

 All structures including stormwater & drainage to engineer's details.

 Do not obtain dimensions by scaling drawings.
 All dimensions & Levels are to be checked on site prior to starting work.
 These drawings are to be read in conjunction with all other consultant's drawings and specifications

- ▼All working its plant as state of the National Construction Code, relevant Australian Standards & loca council requirements.
 New materials are to be used throughout unless otherwise noted.
 Concrete footings, slab, structural beams or any other structural members are to be designed by a constriction anging or. by a practicing engineer.

JJ Drafting ^{Australia} P/L.

26/90 Mona Vale Road, Mona Vale, NSW, 2103 PO Box 687, Dee Why, NSW, 2099 Mob. 0414 717 541 | ACN 651 693 346 Email. enquiries@jjdrafting.com.au www.jjdrafting.com.au

	П	KEV:	DATE:	DESCRIPTION:	
	A 28/0		28/05/25	DEVELOPMENT APPLICATION	
03	Ц				
	Ц				
	Ц				

PROPOSED ALTERATIONS AND ADDITIONS 57 Parni Place Frenchs Forest CLIENT: Sophia Dafaur	
DRAWING TITLE:	

PROPOSED ELEVATIONS SHEET 3

OB No:	DRAWN BY:	SCALE:
1346/25	PP	1:100 @ A
	DATE:	DRAWING No:

APR/25

DA.17

BUILDING DESIGNER CHECKED BY: JJ



NOTES (E & OE)

• All structures including stormwater & drainage to engineer's details.

• Do not obtain dimensions by scaling drawings.

• All dimensions & Levels are to be checked on site prior to starting work.

• These drawings are to be read in conjunction with all other consultant's drawings and specifications.

specifications.

• All workmanship & materials shall be in accordance with the requirements of current editions.

• All working amendments of the National Construction Code, relevant Australian Standards & local council requirements.

• New materials are to be used throughout unless otherwise noted.

• Concrete footings, slab, structural beams or any other structural members are to be designed by a precision control. by a practicing engineer.

JJ Drafting Australia P/L.

26/90 Mona Vale Road, Mona Vale, NSW, 2103 PO Box 687, Dee Why, NSW, 2099 Mob. 0414 717 541 | ACN 651 693 346 Email. enquiries@jjdrafting.com.au www.jjdrafting.com.au


REV:	DATE: 28/05/25	DESCRIPTION: DEVELOPMENT APPLICATION	PROPOSED ALTERATIONS 57 Parni Place Frenchs Fore CLIENT: Sophia Dafaur
			DRAWING TITLE: PROPOSED ELEVATION

POSED ALTERATIONS AND ADDITIONS	JOB No:	DRAWN BY:
rni Place Frenchs Forest	1040/05	PP
Т:	1346/25	
a Dafaur		DATE:
		DAIL.
ING TITLE:		APR/25
POSED ELEVATIONS SHEET 4		

SCALE: 1:100 @ A3 ACCREDITED BUILDING DESIGNER DRAWING No: CHECKED BY:

JJ

DA.18

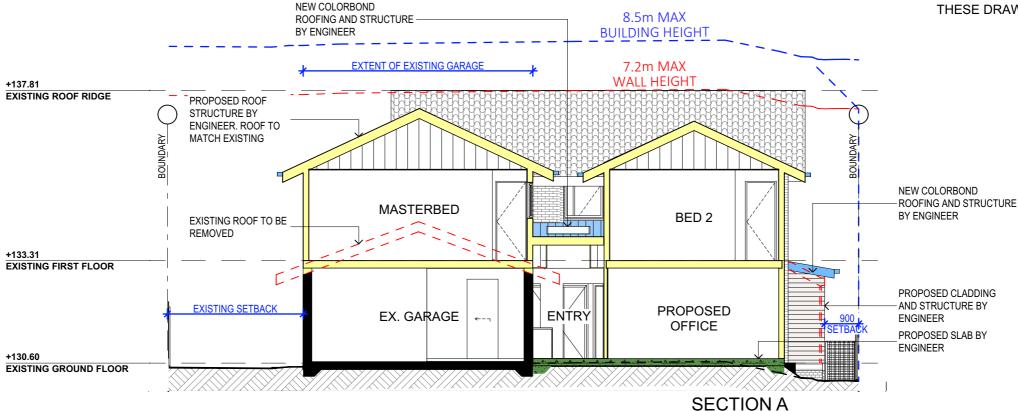

SPECIFICATION NOTES

PROVIDE PLASTERBOARD LINING.

- INSTALL TO MANUFACTURERS SPECIFICATIONS & AS 2589

EXTERNAL WALLS:

- BRICK VENEER WALLS WITH SELECTED BRICKS TO DWELLING.
- ALL EXTERNAL WALL CLADDINGS MUST BE COMPLIANT WITH THE REQUIREMENTS OF NCC 2022 - ABCB HOUSING PROVISIONS PART 7, AS1684 AND ALL RELEVANT CODEMARK CERTIFICATES.

- ROOF AND WALL CLADDING INSTALLATION TO NCC 2022 H1D7 & AS 1562 DESIGN AND INSTALLATION OF SHEET ROOF AND WALL CLADDING.

CONDENSATION MANAGEMENT:
- CONDENSATION MANAGEMENT MUST BE ADHERED TO IN ACCORDANCE WITH NCC 2022 - HOUSING

FLOOR:
- GROUND FLOOR TO BE REINFORCED CONCRETE SLAB IN ACCORDANCE WITH AS2870. - FIRST FLOOR TO BE TIMBER FRAMED FINISHED WITH T&G HARDWOOD FLOORING.

ALL WATERPROOFING TO NCC 2022 - ABCB HOUSING PROVISIONS PART 10, AS3740 AND PROVIDE A GUARANTEED FLEXIBLE WATERPROOF MEMBRANE TO ALL WET AREA FLOORS & SHOWER WALLS TO MANUFACTURED SPECIFICATIONS AND INSTALLATION INSTRUCTIONS

WATERPROOF INSTALLATION NCC (2022): HOUSING PROVISIONS PART 10, AS 3740 WATERPROOFING OF DOMESTIC WET AREAS (INTERNAL) & AS 4654 WATERPROOF MEMBRANES FOR EXTERNAL USE.

BEARERS AND JOISTS:

- SHALL BE INSTALLED TO COMPLY WITH AS1684 AS AMENDED FOR TIMBER COMPONENTS OR AS3620 FOR LIGHTWEIGHT STEEL FRAMING SECTIONS OR AS PER THE NASH ALTERNATIVES TO AS 3623.

SHALL BE INSTALLED IN ACCORDANCE WITH AS3660

PROFILED STEEL ROOF:

- METAL ROOF DESIGN AND INSTALLATION SHALL BE IN ACCORDANCE WITH NCC 2022 - ABCB HOUSING PROVISIONS PART 7, AS 1562.

ROOF TILES OR SHINGLES:
- NCC 2022 - ABCB HOUSING PROVISIONS PART 7.3.

- SHALL BE IN ACCORDANCE WITH NCC 2022 - ABCB HOUSING PROVISIONS PART 4.2.10. ALL WORKMANSHIP AND MATERIALS SHALL BE IN ACCORDANCE WITH CURRENT EDITIONS OF THE

BRICK AND BLOCKWORK:

- MASONRY STRUCTURES TO NCC 2022 - ABCB HOUSING PROVISIONS PART 5 & AS 3700 MASONRY STRUCTURES.

- FOOTINGS TO BE IN ACCORDANCE WITH AS1480.
- FOOTINGS TO BE IN ACCORDANCE WITH NCC VOL.2 PARTS H1D4
- ALL REINFORCEMENTS SHALL CONFORM TO AS1302, AS1303 AND AS1304
- RESIDENTIAL SLABS, FOOTINGS AND CONCRETE STRUCTURES TO NCC 2022 ABCB HOUSING PROVISIONS PART 3 & 4, AS 2870 RESIDENTIAL SLABS AND FOOTING & AS 3600 CONCRETE STRUCTURES.

CARPENTRY:
- TIMBER TO COMPLY WITH AS1170.2 OR AS4055.

- ALL WORKMANSHIP AND MATERIALS SHALL BE IN ACCORDANCE WITH AS1684 AND 1720 AS APPLICABLE. -TERMITE MANAGEMENT INSTALLATION OF PERIMETER & COLLARS TO NCC 2022 - ABCB HOUSING PROVISIONS PART 3.4 & AS 3660.1 TERMITE MANAGEMENT - NEW BUILDING WORK

TIMBER FRAMING:
-ALL EXTERNAL TIMBER FRAMED WALLS TO BE WRAPPED IN A BREATHABLE VAPOUR PERMEABLE MEMBRANE IN ACCORDANCE WITH NCC VOL.2 PART H1D6 , INSTALLED WITH AS/NZS 4200.1 & AS/NZS 4200.2

-TIMBER FRAMING INSTALLATION TO NCC 2022 - VOL.2 PART HAD6(4), AS 1684.4 RESIDENTIAL TIMBER FRAMED CONSTRUCTION & AS/NZS 1170 STRUCTURAL DESIGN ACTIONS.

 GROUND FLOOR TIMBERS SHALL BE ONLY OF HARDWOOD, CYPRESS PINE OR PRESSURE TREATED. RADIATA OR CANADA PINE BELOW A HEIGHT OF 300mm ABOVE FINISHED GROUND LEVEL AND MUST NOT

- SUBFLOOR VENTILATION SHALL CONFORM TO NCC 2022 ABCB HOUSING PRIVIONS PART 6.2
- IN BUSHFIRE PRONE AREAS SPECIAL CONDITIONS APPLY.
- WHERE TERMITE BARRIERS NEED TO BE INSPECTED, 400mm CLEARANCE IS REQUIRED BETWEEN THE UNDERSIDE OF BEARER AND GROUND SURFACE.
- USE TREATED TIMBER WHERE REQUIRED FOR DURABILITY
- DO NOT USE TIMBER UNSUITABLE FOR EXPOSURE TO MOISTURE IN EXPOSED LOCATION.
- PROVIDE STRUCTURE BRACING IN ACCORDANCE WITH AS1684 PROVIDE STRUCTURE TIEDOWN IN ACCORDANCE WITH AS1684
- USE GALVANISED FIXINGS WHERE EXPOSED TO WEATHER.

ALL STEEL FRAMING TO NCC 2022 - VOL.2 PARTH1D6(3), AS 4100 STEEL STRUCTURES, AS/NZS 4600 COLD-FORMED STEEL STRUCTURES & NASH STANDARD.

TO BE IN ACCORDANCE WITH TO AS3660.1

- SHALL BE IN ACCORDANCE WITH NCC 2022 - ABCB HOUSING PROVISION PART 3.4

FLASHING AND CAPPINGS

- SELECTION AND INSTALLATION OF METAL RAINWATER GOODS REFER TO AS2180 FLASH PROJECTIONS ABOVE THE ROOF WITH TWO PART FLASHINGS CONSISTING OF AN APRON
- FLASHING AND OVER FLASHING, WITH AT LEAST 100mm OVERLAP.
- PROVIDE FOR INDEPENDENT MOVEMENT BETWEEN ROOF AND PROJECTION.
- DAMP PROOF COURSE AND FLASHINGS TO NCC 2022 VOL.2 PART H2 & AS/NZS 2904 DAMP-PROOF COURSES AND FLASHINGS

CONCRETE BLOCKS OR BRICKS:
- TO COMPLY WITH TO AS4455 MASONRY BUILDING BLOCKS/PAVER.

 $\,$ - 40% OF NEW OR ALTERED LIGHT FIXTURES TO BE FITTED WITH FLUORESCENT, COMPACT FLUORESCENT, OR LIGHT-EMITTING-DIODE (LED) LAMPS

DOORS & WINDOWS:

- ALL FRAMED WINDOWS SHALL BE INSTALLED IN ACCORDANCE WITH AS2047-48 FOR ALUMINIUM WINDOWS AND AS2047 FOR TIMBER WINDOWS
- ALLIMINIUM FRAMED WINDOWS AND DOORS
- WEATHER STRIPPING IS TO BE PROVIDED TO ALL EXTERNAL WINDOWS AND DOORS
- ALL WINDOWS ARE TO BE RESTRICTED IN ACCORDANCE WITH NCC 2022 ABCB HOUSING PROVISIONS PART 11.3.7 & PART 11.3.8 PROTECTION OF OPENABLE WINDOWS WHERE SURFACE BELOW IS MORE THAN 2M.
- PROVIDE LIFT-OFF HINGES WHERE THE TOILET PAN IS WITHIN 1.2 METRES OF THE HINGED SIDE OF THE DOOR IN ACCORDANCE WITH NCC 2022 - ABCB HOUSING PROVISIONS PART 10.4.

STAIRS, HANDRAILS AND BALUSTRADES:

- RELATIONSHIP OF RISER TO GOING SHALL BE BETWEEN 1:2 AND 1:1.35 UNLESS OTHERWISE DIRECTED TO GOING SHALL BE BETWEEN 1:2 AND 1:1.35 UNLESS OTHERWISE DIRECTED OR AS PERMITTED IN
- BALUSTRADES SHALL BE PROVIDED TO ALL LANDINGS, RAMPS, DECKS, ROOFS AND OTHER ELEVATED PLATFORMS WHERE THE VERTICAL DISTANCE FROM THAT LEVEL IS MORE THAN 1m ABOVE THE ADJOINING FLOOR OR FINISHED GROUND LEVEL.
- THE HEIGHT OF BALUSTRADE MUST BE A MINIMUM OF 1m HIGH ABOVE LANDING AND NOT LESS THAN 365mm ABOVE THE NOSINGS OF ANY STAIR TREADS OR FLOOR RAMP AND HAVE NO OPENING GREATER THAN 125mm
- THE HEIGHT OF BALUSTRADE TO THE NEW STAIRCASES IS TO BE MEASURED A MINIMUM 865mm ABOVE THE NOSING LINE AND HAVE NO OPENING GREATER NO OPENING GREATER THAN 125mm
- ALL BALUSTRADES & PRIVACY SCREENS TO COMPLY WITH NCC 2022 ABCB HOUSING PROVISIONS PART 11, AS 1684, AS 1170, AS 1288 & AS/NZS 2208

SLIP RESISTANCE:

- MATERIALS TO BE USED FOR SURFACES OF FLOORS, STAIR LANDING, STEPS AND NOSINGS SHALL BE IN ACCORDANCE WITH THE CLASSIFICATIONS FOR SLIP RESISTANCE AS APPLY IN AS4586 AND HB198 - ALL STAIRS PROVIDING ACCESS TO COMPLY WITH NCC 2022 - ABCB HOUSING PROVISIONS PART 11, AS 4586 INCLUDING SLIP RESISTANCE P3 / R10 FOR DRY OR P4 / R11 FOR WET.

EAVES GUTTERS, VALLEY GUTTERS AND DOWPIPES

- TO COMPLY WITH AS/NZS 2179 FOR METAL AND AS1273 FOR UPVC COMPONENTS.
- IN ACCORDANCE WITH NCC VOL 2 PART 3.5.3
- NEW DOWNPIPES TO BE CONNECTED INTO EXISTING STORMWATER LINE - COLORBOND GUTTERS AND DOWNPIPES
- MINIMUM SLOPE OF FAVES AND GUTTERS 1:200

NCC VOL2 PART H1D8, ABCB HOUSING PROVISIONS PART 8.3

- -ALL WINDOW GLAZING AND DOOR GLAZING TO BE INSTALLED IN ACCORDANCE TO NCC 2022 ABCB HOUSING PROVISIONS PART 8, AS 1288 GLASS IN BUILDINGS, AS/NZS 2208 SAFETY GLAZING MATERIALS IN BUILDINGS & AS 2047 WINDOWS AND EXTERNAL DOORS IN BUILDINGS.
- SHOWER SCREEN/MIRRORS / WARDROBE GLASS INSTALLATION TO NCC 2022 HOUSING PROVISIONS PART 8, AS 1288 & AS/NZS 2208.
- GLASS BALUSTRADE INSTALLATION TO NCC 2022 HOUSING PROVISIONS PART 11, AS 1288 GLASS IN BUILDINGS, AS/NZS 2208 SAFETY GLAZING MATERIALS IN BUILDINGS & AS 1170 STRUCTURAL DESIGN

WATERPROOFING FOR EXTERNAL TILED BALCONIES:

- WATERPROOFING TO COMPLY WITH AS4654
- ALL WATERPROOFING TO NCC 2022 ABCB HOUSING PROVISIONS PART 10, AS3740 AND PROVIDE A GUARANTEED FLEXIBLE WATERPROOF MEMBRANE TO ALL WET AREA FLOORS & SHOWER WALLS TO MANUFACTURED SPECIFICATIONS AND INSTALLATION INSTRUCTIONS

- FIRE SAFETY, SMOKE DETECTORS/ALARMS:
 PROVIDE HARDWIRED & INTERCONNECTED SMOKE ALARM DEVICES COMPLYING WITH THE REQUIREMENTS OF THE LOCAL GOVERNMENT ACT AND/OR STATE OR TERRITORY REGULATIONS MUST BE FITTED IN THE LOCATIONS REQUIRED AND APPROVED BY THE AUTHORITY. SMOKE ALARMS TO BE INSTALLED TO NCC 2022 - ABCB HOUSING PROVISIONS PART 9.5, NSW 9.5.1 & AS 3786
- INSTALLATIONS IN BUILDINGS OTHER THAN CLASS 1 AND 10 MUST BE INSTALLED AND MANAGED TO COMPLY WITH NCC SPEC, E2.2a.
- FIRE SEPARATING WALL, A WALL WITHIN 900MM OF BOUNDARY INSTALLATION CERTIFICATE (FRL60/60/60) INCL ACOUSTIC SOUND (RW) + CTR50 TO NCC 2022 - ABCB HOUSING PROVISIONS PART 9 & PART 10.7, AS 1530 ALL PARTS.
- BUSHFIRE-PRONE AREAS CERTIFICATE FOR BUILDING NCC 2022 VOL. 2 PART NSW H7D4 CONSTRUCTION IN BUSHFIRE PRONE AREAS - AS 3959 CONSTRUCTION OF BUILDING IN BUSHFIRE-PRONE AREAS & PLANNING FOR BUSHFIRE PROTECTION 2019.

WASTE MANAGEMENT:

- ALL WASTE SHALL BE TAKEN AWAY BY TRUCKS TO A SUITABLE LANDFILL OR RECYCLE DEPOT.
- ALL WASTE SHALL BE COVERED DURING TRANSPORTATION.
- WASTE GENERATED DURING CONSTRUCTION SHALL BE PLACED IN STEEL BINS AND TAKEN AWAY BY AN APPROVED CONTRACTOR TO A APPROVED LANDFILL SITE.

SEDIMENT CONTROL:

- A FILTER CLOTH SYSTEM SHALL BE INSTALLED TO STOP ANY SEDIMENT ENTERING COUNCILS STORMWATER SYSTEM..

SWIMMING POOLS & SAFETY

-POOL PLUMBING/CIRCULATION TO COMPLY WITH NCC 2022 PART NSW H7D2, AS 1926.3 SWIMMING POOL SAFETY - WATER RECIRCULATION SYSTEMS

- ALL POOL FENCING TO BE INSTALLED TO: NCC 2022 NSW H7D2, AS 1926.1 - 2012 - SAFETY BARRIERS FOR SWIMMING POOLS, AS 1926.2 - 20007 - LOCATION OF SAFETY BARRIERS FOR SWIMMING POOLS, AS 1170 STRUCTURAL DESIGN ACTIONS AND IF GLASS POOL FENCING TO ADDITIONALLY COMPLY WITH AS 1288 - 2021 GLASS IN BUILDINGS, AS/NZS 2208 - SAFETY GLASS,

- AS 2783 USE OF REINFORCED CONCRETE FOR SMALL SWIMMING POOLS

MISCELLANEOUS ITEMS:

- ALLOW FOR SEPARATE TAPS FOR THE WASHING MACHINE AND KEEP THEM SEPARATE FROM THOSE OF THE LAUNDRY TUB. A DEDICATED LAUNDRY SPACE COMPRISING OF ONE WASHTUB AND A SPACE FOR A WASHING MACHINE MUST BE PROVIDED IN ACCORDANCE WITH NCC 2022 - ABCB HOUSING PROVISIONS

- GAS FIRE SUPPLY AND INSTALLATION TO COMPLY WITH NCC 2022 - ABCB HOUSING PROVISIONS PART 12.4, AS/NZS 5601 GAS INSTALLATIONS.

ALL PLANS ARE TO BE READ IN CONJUNCTION AND COMPLY WITH THE BASIX CERTIFICATE, BUSHFIRE AND GEOTECH REPORTS.

DA.19

NOTES (E & OE)

All structures including stormwater & drainage to engineer's details.
Do not obtain dimensions by scaling drawings.
All dimensions & Levels are to be checked on site prior to starting work.

- These drawings are to be read in conjunction with all other consultant's drawings and
- All workmanship & materials shall be in accordance with the requirements of current edition uding amendments of the National Construction Code, relevant Australian Sta
- ouncil requirements.


 New materials are to be used throughout unless otherwise noted.

 Concrete footings, slab, structural beams or any other structural members are to be designed. by a practicing engineer.
- 26/90 Mona Vale Road, Mona Vale, NSW, 2103 PO Box 687, Dee Why, NSW, 2099 Mob. 0414 717 541 | ACN 651 693 346

Email. enquiries@jjdrafting.com.au

www.jjdrafting.com.au

JJ Drafting

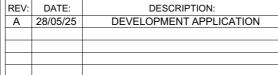

PROPOSED ALTERATIONS AND ADDITIONS JOB No: 57 Parni Place Frenchs Forest 1346/25 Sophia Dafaur DRAWING TITLE: SECTION / SPECIFICATION

DRAWN BY: SCALE: 1:100 @ A3 DATE: DRAWING No:

APR/25



BASIX™Certificate

Building Sustainability Index www.planningportal.nsw.gov.au/development-and-assessment/basix

Alterations and Additions

Certificate number: A1797653

This certificate confirms that the proposed development will meet the NSW government's requirements for sustainability, if it is built in accordance with the commitments set out below. Terms used in this certificate, or in the commitments, have the meaning given by the document entitled "BASIX Definitions" dated 1009/2020 published by the Department. This document is available at www.planningportal.nsw.gov.au/definitions

Secretary
Date of issue: Thursday, 29 May 2025
To be valid, this certificate must be lodged within 3 months of the date of issue.



Project address					
Project name	57 PARNI PLACE FRENCHS FOREST				
Street address	57 PARNI Place FRENCHS FOREST 2086				
Local Government Area	Northern Beaches Council				
Plan type and number	Deposited Plan DP238711				
Lot number	12				
Section number	-				
Project type					
Dwelling type	Dwelling house (attached)				
Type of alteration and addition	The estimated development cost for my renovation work is \$50,000 or more, and does not include a pool (and/or spa).				
N/A	N/A				
Certificate Prepared by (please complete before submitting to Council or PCA)					
Name / Company Name: JJ DRAFTING AUSTRALIA PTY LTD					
ABN (if applicable): 75651693346					

Fixtures and systems	Show on DA Plans	Show on CC/CDC Plans & specs	Certifier Check
Lighting			
The applicant must ensure a minimum of 40% of new or altered light fixtures are fitted with fluorescent, compact fluorescent, or light- emitting-diode (LED) lamps.		~	~
Fixtures			
The applicant must ensure new or altered showerheads have a flow rate no greater than 9 litres per minute or a 3 star water rating.		~	~
The applicant must ensure new or altered toilets have a flow rate no greater than 4 litres per average flush or a minimum 3 star water rating.		~	~
The applicant must ensure new or altered taps have a flow rate no greater than 9 litres per minute or minimum 3 star water rating.		~	

construction			Show on DA Plans	Show on CC/CDC Plans & specs	Certifie Check
nsulation requirements					
sted in the table below, except that a) addi	ered construction (floor(s), walls, and ceilings/ tional insulation is not required where the are of altered construction where insulation alrea	a of new construction is less than 2m2, b)	•	~	•
Construction	Additional insulation required (R-value)	Other specifications			
concrete slab on ground floor.	nil	N/A			
suspended floor above garage: framed (R0.7).	nil	N/A			
floor above existing dwelling or building.	nil	N/A			
external wall: framed (weatherboard, fibro, metal clad)	R1.30 (or R1.70 including construction)				
internal wall shared with garage: plasterboard (R0.36)	nil				
flat ceiling, pitched roof	ceiling: R1.45 (up), roof: foil backed blanket (55 mm)	medium (solar absorptance 0.475 - 0.70)			

Glazing requirements	Show on DA Plans	Show on CC/CDC Plans & specs	Certifier Check
Windows and glazed doors			
The applicant must install the windows, glazed doors and shading devices, in accordance with the specifications listed in the table below. Relevant overshadowing specifications must be satisfied for each window and glazed door.	~	~	~
The following requirements must also be satisfied in relation to each window and glazed door:		~	-
Each window or glazed door with improved frames, or pyritylic low-e glass, or cleariair gap/class glazing, or tonediair gap/class glazing must have a U-value and a Solar Heat Gain Coefficients (SHCC) no greater than that listed in the table below. Total system U-values and SHCCs must be calculated in accordance with National Fenestration Rating Council (NFRC) conditions. The description is provided for information only. Alternative systems with complying U-value and SHCC may be substituted.		~	~
For projections described in millimetres, the leading edge of each eave, pergola, verandah, balcony or awning must be no more than 500 mm above the head of the window or glazed door and no more than 2400 mm above the sill.	~	~	~
Pergolas with polycarbonate roof or similar translucent material must have a shading coefficient of less than 0.35.		~	~
Pergolas with fixed battens must have battens parallel to the window or glazed door above which they are situated, unless the pergola also shades a perpendicular window. The spacing between battens must not be more than 50 mm.			-

lazing requir			·				Show on DA Plans	Show on CC/CDC Plans & specs	Certifie Check
/indows and gla	zed doors glazing	requirements							
Window/door number	Orientation	Area of glass including frame (m2)	Overshadowing height (m)	Overshadowing distance (m)	Shading device	Frame and glass type			
W06	N	2	0	0	eave/ verandah/ pergola/balcony >=600 mm	standard aluminium, single pyrolytic low-e, (U- value: 5.7, SHGC: 0.47)			
W05	N	1.65	0	0	eave/ verandah/ pergola/balcony >=600 mm	standard aluminium, single pyrolytic low-e, (U- value: 5.7, SHGC: 0.47)			
D01	E	3.6	0	0	eave/ verandah/ pergola/balcony >=900 mm	standard aluminium, single pyrolytic low-e, (U- value: 5.7, SHGC: 0.47)			
D02	E	8.4	0	0	eave/ verandah/ pergola/balcony >=450 mm	standard aluminium, single pyrolytic low-e, (U- value: 5.7, SHGC: 0.47)			
W04	E	3.25	0	0	eave/ verandah/ pergola/balcony >=450 mm	standard aluminium, single pyrolytic low-e, (U- value: 5.7, SHGC: 0.47)			

Glazing requirements				Show on DA Plans	Show on CC/CDC Plans & specs	Certifier Check
Skylights						
The applicant must install the	skylights in accordance with the spec	cifications listed in the table b	elow.	~	~	~
The following requirements must also be satisfied in relation to each skylight:					~	~
Each skylight may either match the description, or, have a U-value and a Solar Heat Gain Coefficient (SHGC) no greater than that listed in the table below.					~	-
Skylights glazing requirem	ents					
Skylight number	Area of glazing inc. frame (m2)	Shading device	Frame and glass type			
S1	1.34	no shading	timber, low-E internal/argon fill/clear external, (or U-value: 2.9, SHGC: 0.456)			

Commitments identified with a 😾 in the "Show on DA plans" column must be shown on the plans accompanying the development application for the proposed development (if a development application is to be lodged for the proposed development). Commitments identified with a 💆 in the "Show on CCICDC plans & specs" column must be shown in the plans and specifications accompanying the application for a construction certificate / complying development certificate for the proposed development. Commitments identified with a V in the 'Certifier check' column must be certified by a certifying authority as having been fulfilled, before a final occupation certificate for the developed by the issued.

NOTES (E & OE)

- All structures including stormwater & drainage to engineer's details.
 Do not obtain dimensions by scaling drawings.
 All dimensions & Levels are to be checked on site prior to starting work.
 These drawings are to be read in conjunction with all other consultant's drawings and
- specifications.

 All workmanship & materials shall be in accordance with the requirements of current editions. • An working amendments of the National Construction Wood amendments of the National Construction Code, relevant Australian Standards & local council requirements.

 • New materials are to be used throughout unless otherwise noted.

 • Concrete footings, slab, structural beams or any other structural members are to be designed by a prediction continue.
- by a practicing engineer.

JJ Drafting Australia P/L.

26/90 Mona Vale Road, Mona Vale, NSW, 2103 PO Box 687, Dee Why, NSW, 2099 Mob. 0414 717 541 | ACN 651 693 346 Email. enquiries@jjdrafting.com.au www.jjdrafting.com.au

03	REV:	DATE: 28/05/25	DESCRIPTION: DEVELOPMENT APPLICATION	PROPOSED ALT 57 Parni Place Fr CLIENT: Sophia Dafaur
				DRAWING TITLE: BASIX


PROPOSED ALTERATIONS AND ADDITIONS 57 Parni Place Frenchs Forest CLIENT: Sophia Dafaur

DRAWN BY: JOB No: 1346/25


DATE:

SCALE: 1:2.42 @ A3 ACCREDITED

BUILDING DESIGNER DRAWING No: CHECKED BY: APR/25 **DA.20** JJ

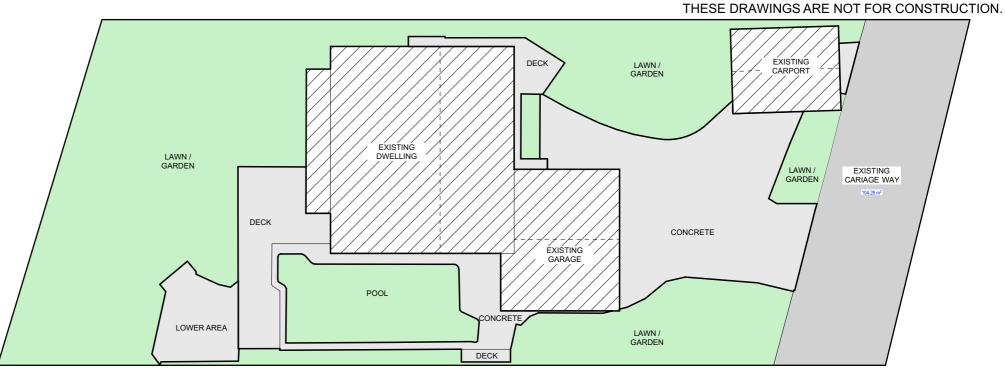

EXISTING LANDSCAPE PLAN

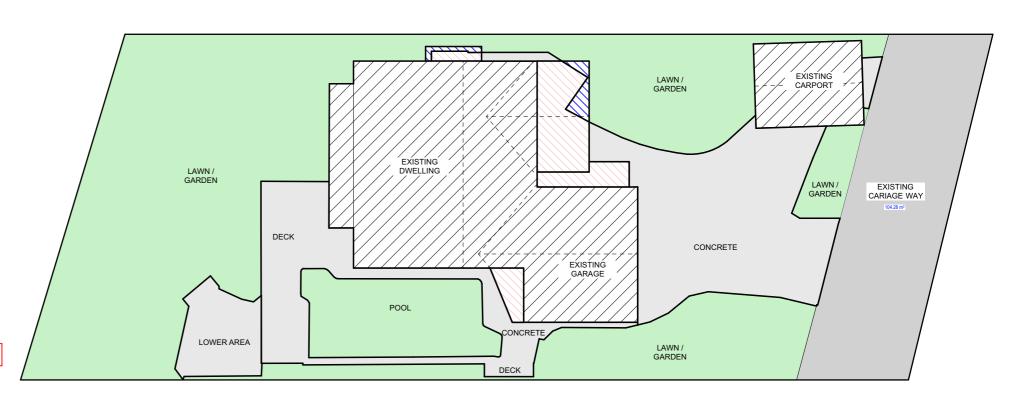

CALCULATIONS SITE AREA 849m² CARRIAGE WAYAREA 104.28m² LANDSCAPE CONTROL 297.8m² 40% EXISTING LANDSCAPED AREA 51.39% 382.72m² TOTAL LANDSCAPED AREA 50.09% 373.05m² EXISTING HARD SURFACE AREA 360.21m² (NOT INCLUDING CARRIAGE WAY) PROPOSED NEW AREAS OVER EXISTING HARDSURFACE NEW HARD SURFACE AREA 3.12m² 363.33m² TOTAL HARD SURFACE AREA

744.72m² AVAILABLE AREA

COMPLIES

PROPOSED LANDSCAPE PLAN

TRUE NORTH:



NOTES (E & OE)

- All structures including stormwater & drainage to engineer's details.
 Do not obtain dimensions by scaling drawings.
 All dimensions & Levels are to be checked on site prior to starting work.
 These drawings are to be read in conjunction with all other consultant's drawings and
- specifications.

 All workmanship & materials shall be in accordance with the requirements of current editions.
- New materials are to be used throughout unless otherwise noted.
 Concrete footings, slab, structural beams or any other structural members are to be designed. by a practicing engineer.

JJ Drafting Australia P/L.

26/90 Mona Vale Road, Mona Vale, NSW, 21 PO Box 687, Dee Why, NSW, 2099 Mob. 0414 717 541 | ACN 651 693 346 Email. enquiries@jjdrafting.com.au www.jjdrafting.com.au

103	A A	DATE: 28/05/25	DESCRIPTION: DEVELOPMENT APPLICATION	PROPOSED ALTERATION 57 Parni Place Frenchs Fo CLIENT: Sophia Dafaur
				DRAWING TITLE: LANDSCAPED AREA C


PROPOSED ALTERATIONS AND ADDITIONS 57 Parni Place Frenchs Forest CLIENT:	JOB No: 1346/25
Sophia Dafaur DRAWING TITLE: LANDSCAPED AREA CALCULATION PLAN	

DRAWN BY:	SCALE:	
PP		ACCR
DATE:	DRAWING No:	CHE
DATE:		BUIL

DA.21

APR/25

NG DESIGNER HECKED BY: JJ

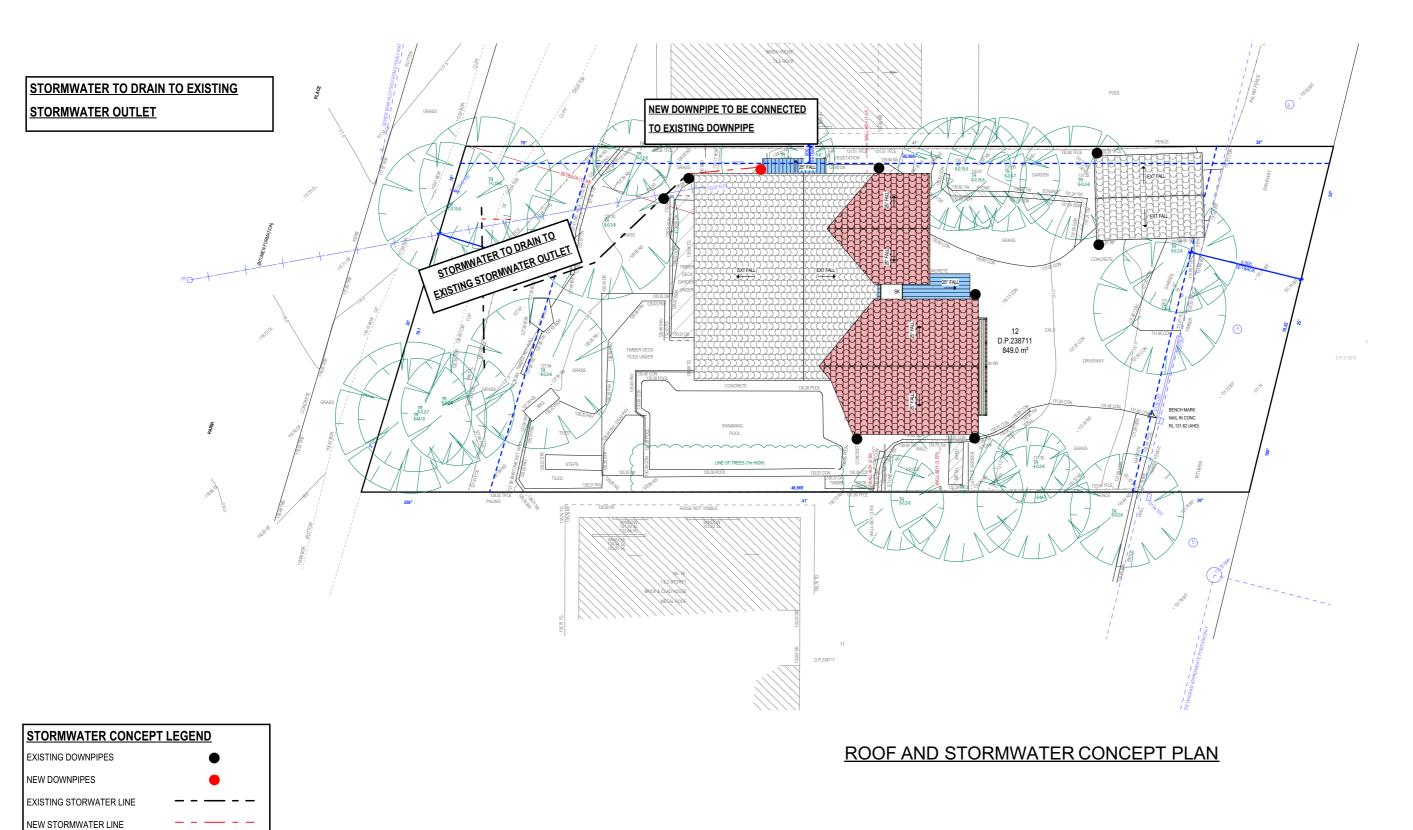

TRUE NORTH:

- NOTES (E & OE)

 All structures including stormwater & drainage to engineer's details.

 Do not obtain dimensions by scaling drawings.

 All dimensions & Levels are to be checked on site prior to starting work.

 These drawings are to be read in conjunction with all other consultant's draw
- All workmariship a friedrials strain or in accordance with the requirements of content construction foods, relevant Australian Standards & local council requirements.
 New materials are to be used throughout unless otherwise noted.
 Concrete footings, slab, structural beams or any other structural members are to be designed the content of by a practicing engineer.

JJ Drafting ^{Australia} P/L.

26/90 Mona Vale Road, Mona Vale, NSW, 2103 PO Box 687, Dee Why, NSW, 2099 Mob. 0414 717 541 | ACN 651 693 346 Email. enquiries@jjdrafting.com.au www.jjdrafting.com.au

	REV:	DATE:	DESCRIPTION:
	Α	28/05/25	DEVELOPMENT APPLICATION
3			

PROPOSED ALTERATIONS AND ADDITIONS 57 Parni Place Frenchs Forest	JOB No: 1346/25
CLIENT: Sophia Dafaur	10.10.20
DRAWING TITLE: ROOF & STORMWATER CONCEPT PLAN	

DRAWN BY:	SCALE:	
PP	1	A C C R E D I T E
		DOTEDING DESTON
DATE:	DRAWING No:	CHECKED BY:
APR/25	DA.22	JJ

JJ

NOTES

DESIGNATED SITE MANAGER/BUILDER

PRIOR TO COMMENCEMENT OF WORK A SITE MANAGER OR BUILDER MUST BE NOMINATED. THE SITE MANAGER OR BUILDER WILL BE RESPONSIBLE AND LIABLE FOR ALL WORKS CARRIED OUT ON THE SITE. THIS ASSUMES THE RESPONSIBILITY FOR THE ACTIONS OF ALL SUBCONTRACTED PARTIES AS WELL AS ADVISING THEM OF COUNCIL'S REQUIREMENTS WHEN CARRYING OUT WORKS.

TOPSOIL MANAGEMENT

PRIOR TO THE STRIPPING OF TOPSOIL, THE VEGETATIVE COVER MUST BE REDUCED BY EITHER SLASHING OR MOWING. ALL TOPSOIL IS TO BE RETAINED AND PROTECTED FOR REUSE ON SITE. SOIL STOCKPILES MUST NOT BE LOCATED ON NATURE STRIPS, FOOTPATHS, ROADWAYS, KERBS, ACCESSWAYS, WITHIN DRAINAGE LINES/FLOWS/PATHS OR AROUND OR AGAINST TREE SHRUBS. SEDIMENT CONTROL MEASURES MUST BE INCORPORATED WITH ANY RESULTING STOCKPILE. THE STOCKPILE CAN BE PROTECTED FROM EROSION BY COVERING IT WITH AN MPERVIOUS MATERIAL, IN CONJUNCTION WITH THE INSTALLATION OF A SEDIMENT FENCE AROUND IT. IF STOCKPILES ARE TO REMAIN FOR MORE THAN ONE MONTH THEY ARE TO BE GRASSED IMMEDIATELY AND STABILISED WITHIN FOURTEEN DAYS. SURPLUS TOPSOIL MUST BE REASONABLY REMOVED FROM SITE.

BUILDING MATERIAL STOCKPILING

SUFFICIENT AREA MUST BE ALLOCATED WITHIN THE SITE FOR SUCH STORAGE OF BUILDING MATERIALS, DEMOLITION WASTE, WASTE CONTAINERS, ETC. AS WILL BE REQUIRED.

A SEDIMENT FENCE SHOULD BE LOCATED ALONG THE DOWNSLOPE BOUNDARY(S) OF THE SITE. ON THE CONSTRUCTION SIDE OF THE TURF FILTER STRIP OR NATIVE VEGETATION, AND AROUND ALL STOCKPILES OF MATERIAL ON THE SITE.

DUST CONTROL

ALL TRUCKS/UTES MUST COVER THEIR LOADS AT ALL TIMES. APPROPRIATE METHODS ARE TO BE EMPLOYED TO PREVENT BLOWING DUST CREATING AN UNACCEPTABLE HAZARD OR NUISANCE ON THE SITE OR DOWN WIND. PRODUCTION OF DUST CAN BE MINIMISED BY LIMITING AREA OF EARTHWORKS, WATERING AND PROGRESSIVE VEGETATION. WHERE DUST IS CREATED AS A RESULT WORKS AND/OR SOIL EXPOSURE, THE BARE SOIL AREAS MUST BE WATERED, DURING AND/OR AT THE END OF EACH DAY TO LAY THE DUST. EARTH MOVING ACTIVITIES SHOULD BE AVOIDED WHERE WINDS ARE SUFFICIENTLY STRONG ENOUGH TO RAISE VISIBLE

EROSION & SEDIMENT CONTROLS

APPROPRIATE EROSION AND SEDIMENT CONTROLS MUST BE IMPLEMENTED ON ALL SITES THAT INVOLVE SOIL DISTURBANCE. THE MEASURES MUST BE IN PLACE PRIOR TO THE COMMENCEMENT OF WORK. THOSE CONTROLS ARE TO BE MONITORED AND MAINTAINED IN ORDER TO SERVE THEIR INTENDED FUNCTION FOR THE DURATION OF THE WORKS OR UNTIL SUCH TIME AS THE SITE IS FULLY STABILISED. IF ANY CONTROLS ARE DAMAGED OR BECOME INEFFECTIVE DURING THE COURSE OF THE WORKS THEY ARE TO BE REINSTATED OR REPLACED IMMEDIATELY. SUFFICIENT ACCESS TO THESE CONTROLS MUST BE PROVIDED IN CASE OF THE

SEDIMENT TRAPS


WHERE A SEDIMENT FENCE IS NOT USED APPROPRIATE SEDIMENT TRAPS SHOULD BE LOCATED AT ALL POINTS WHERE STORMWATER LEAVES THE CONSTRUCTION SITE OR LEAVES THE GUTTER AND ENTERS THE DRAINAGE SYSTEM. A COMMON TECHNIQUE IS THE GRAVEL SAUSAGE.


DIVERSION CHANNELS

A DIVERSION CHANNEL IS AN EXCAVATED EARTH DITCH OR PATH. THESE STRUCTURES ARE USED TO INTERCEPT AND DIRECT RUN-OFF TO A DESIRED LOCATION WHERE POSSIBLE. ALL STORMWATER RUN-OFF FLOWING ONTO DISTURBED AREAS, INCLUDING STOCKPILES, MUST BE INTERCEPTED, DIVERTED AND/OR SAFELY DISPOSED OF. THIS CAN BE ACHIEVED BY CONSTRUCTING A TEMPORARY EARTH BANK AROUND THE UPSLOPE EXTENT OF THE CONSTRUCTION SITE WHERE THE DIVERSION DOES NOT AFFECT THE NEIGHBOURING

VEHICLE MOVEMENTS


TO LIMIT DISTURBANCE TO THE SITE AND TRACKING OF MATERIAL ONTO THE STREET ALL VEHICLES AND PLANT EQUIPMENT ARE TO USE A SINGLE ENTRY/EXIT POINT UNLESS COUNCIL HAS APPROVED ALTERNATIVE ARRANGEMENTS. ACCESS POINTS AND PARKING AREAS ARE TO BE STABILISED WITH COMPACTED SUB-GRADE ASAP AFTER THEIR FORMATION. IF SPILLAGE DOES OCCUR IT IS TO BE CONTAINED IMMEDIATELY AND CAREFULLY REMOVED. THE AREA AFFECTED IS TO BE RESTORED TO A STANDARD EQUAL TO OR BETTER THAN ITS PREVIOUS CONDITION. ALL VEHICLES ARE TO BE WASHED PRIOR TO EXISTING THE SITE. THIS SERVES THE PURPOSE OF REMOVING SITE MATERIAL ON THE VEHICLE AND PREVENTS IT FROM BEING DEPOSITED ON THE ROAD NETWORK ADJACENT TO THE SITE AND THUS, THE STORMWATER SYSTEM. NO VEHICLE ASSOCIATED WITH THE WORK IS TO BE PARKED ON A FOOTPATH OR PUBLIC RESERVE. ALL VEHICLES VISITING THE SITE DURING DEMOLITION, EXCAVATION AND/OR CONSTRUCTION WORKS, ARE TO COMPLY WITH THE PARKING REQUIREMENTS IN THAT AREA.

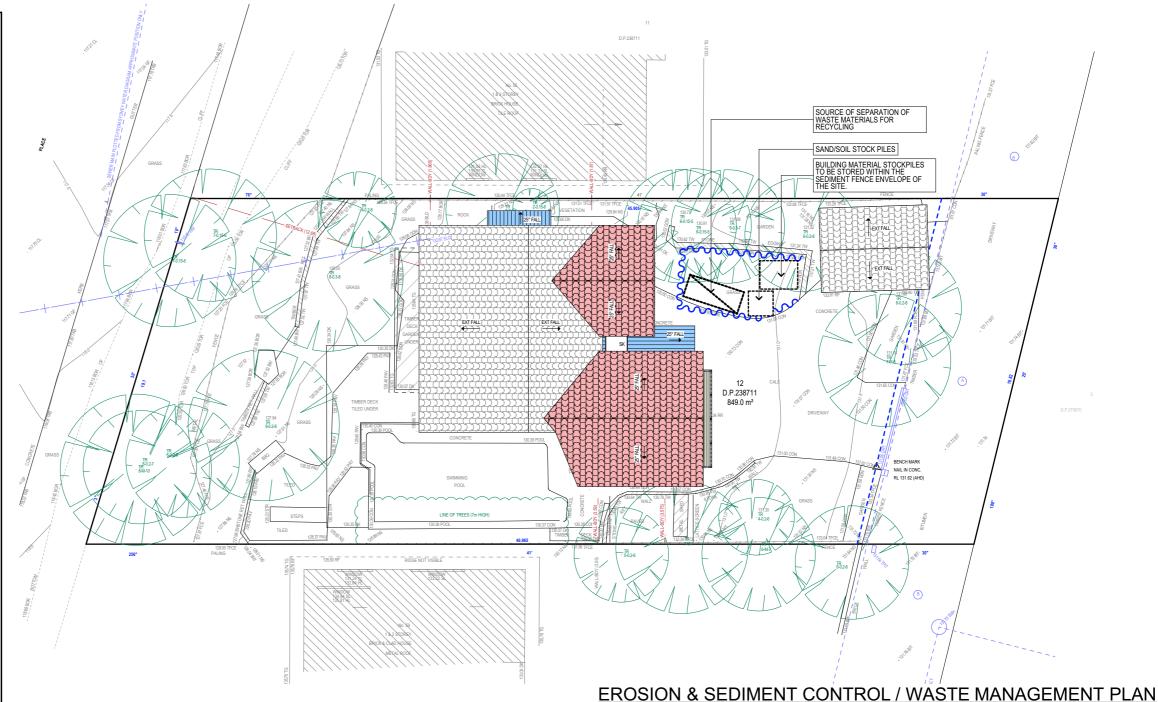

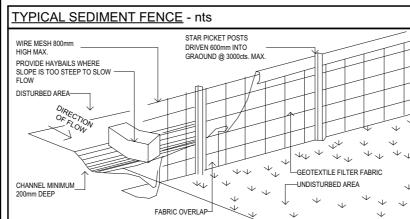

DESCRIPTION:

DEVELOPMENT APPLICATION

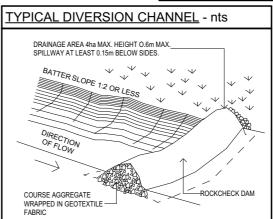

TRUE NORTH:



NOTES (E & OE)

All structures including stormwater & drainage to engineer's details.
Do not obtain dimensions by scaling drawings.
All dimensions & Levels are to be checked on site prior to starting work.

These drawings are to be read in conjunction with all other consultant's drawings and

All workmanship & materials shall be in accordance with the requirements of current editions

ouncil requirements New materials are to be used throughout unless otherwise noted. Concrete footings, slab, structural beams or any other structural members are to be designed by a practicing engineer.

JJ Drafting REV: DATE:
A 28/05/25

Australia P/L.			
0 Mona Vale Road, Mona Vale, NSW, 2103	П		
PO Box 687, Dee Why, NSW, 2099	П		
Mob. 0414 717 541 ACN 651 693 346	П		
Email. enquiries@jjdrafting.com.au	П		
www.jjdrafting.com.au	l		
www.jjuraitiiig.com.au	П		


PROPOSED ALTERATIONS AND ADDITIONS 57 Parni Place Frenchs Forest CLIENT: Sophia Dafaur	JOB No: 1346/25	
DRAWING TITLE: EROSION & SEDIMENT CONTROL / WASTE	MANAGEMENT	


DRAWN BY: SCALE: 1:200 @ A3 BUILDING DESIGNER DRAWING No: DATE: CHECKED BY:

DA.23

APR/25

JJ

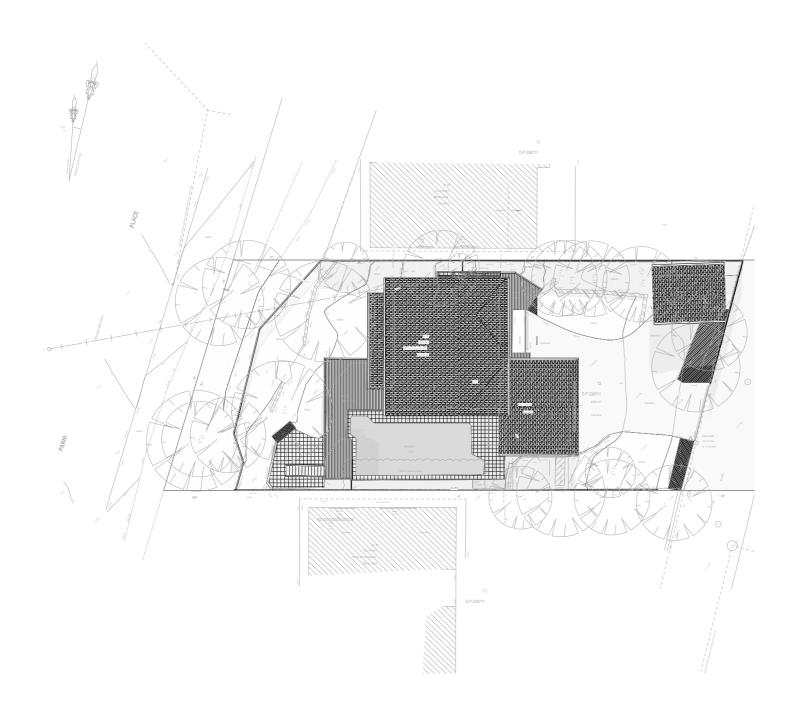

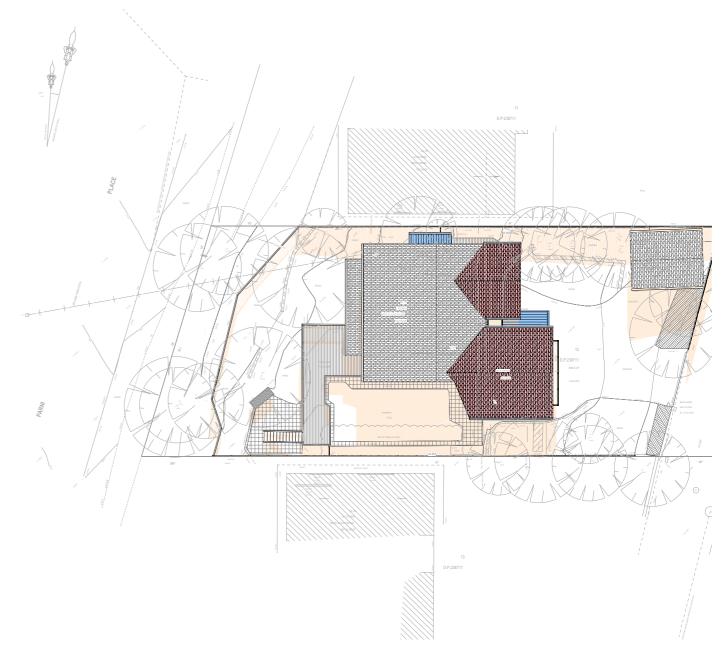

SHADOW DIAGRAM 9AM EXISTING

SHADOW DIAGRAM 9AM PROPOSED

TRUE NORTH:



NOTES (E & OE)

• All structures including stormwater & drainage to engineer's details.

• Do not obtain dimensions by scaling drawings.

• All dimensions & Levels are to be checked on site prior to starting work.

• These drawings are to be read in conjunction with all other consultant's drawings and specifications.

• All workmanship & materials shall be in accordance with the requirements of current editic All working amendments of the National Construction Code, relevant Australian Standards & local council requirements.
 New materials are to be used throughout unless otherwise noted.
 Concrete footings, slab, structural beams or any other structural members are to be designed by a precision construction construction.

by a practicing engineer.

JJ Drafting Australia P/L.
Australiã P/L.
26/90 Mona Vale Road, Mona Vale, NSW, 2103

PO Box 687, Dee Why, NSW, 2099 Mob. 0414 717 541 | ACN 651 693 346 Email. enquiries@jjdrafting.com.au www.jjdrafting.com.au

	REV:	DATE:	DESCRIPTION:	PROPOSED ALTERATIONS AND ADDITION
	Α	28/05/25	DEVELOPMENT APPLICATION	57 Parni Place Frenchs Forest
03				CLIENT: Sophia Dafaur
				DRAWING TITLE: SHADOW DIAGRAM JUNE 21 9AM

PROPOSED ALTERATIONS AND ADDITIONS	
57 Parni Place Frenchs Forest	
CLIENT: Sophia Dafaur	


JOB No: 1346/25

DRAWN BY: SCALE:

1:300 @ A3 ACCREDITED BUILDING DESIGNER DRAWING No:

DATE: APR/25 **DA.24** CHECKED BY:



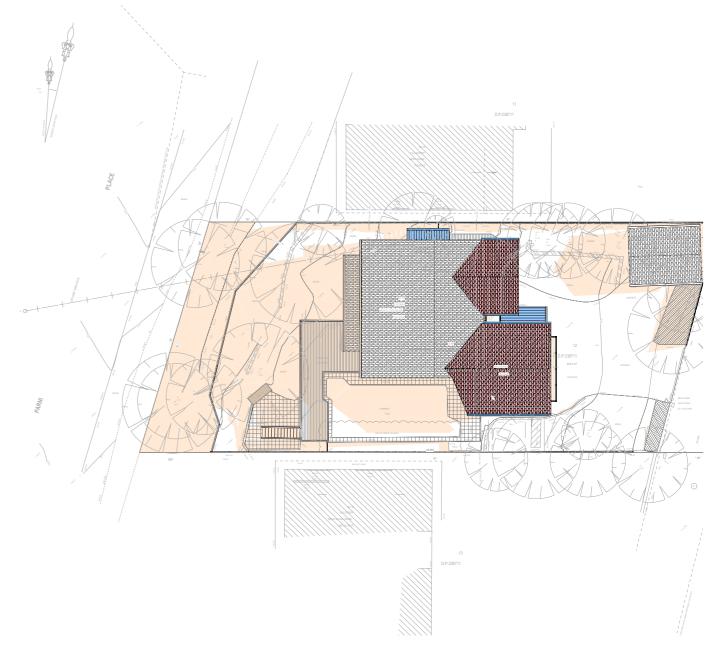

SHADOW DIAGRAM 12PM EXISTING

SHADOW DIAGRAM 12PM PROPOSED

TRUE NORTH:



NOTES (E & OE)

• All structures including stormwater & drainage to engineer's details.

• Do not obtain dimensions by scaling drawings.

• All dimensions & Levels are to be checked on site prior to starting work.

• These drawings are to be read in conjunction with all other consultant's drawings and specifications.

• All workmanship & materials shall be in accordance with the requirements of current editions including amendments of the National Construction Code relevant Australian Standards & local construction Code relevant Australian Standards & local code relevant Austra

 All working amendments of the National Construction Code, relevant Australian Standards & local council requirements.
 New materials are to be used throughout unless otherwise noted.
 Concrete footings, slab, structural beams or any other structural members are to be designed by a precision construction construction. by a practicing engineer.

JJ Drafting Australia P/L.
6/90 Mona Vale Road, Mona Vale, NSW, 2103

PO Box 687, Dee Why, NSW, 2099 Mob. 0414 717 541 | ACN 651 693 346 Email. enquiries@jjdrafting.com.au www.jjdrafting.com.au

	REV:	DATE:	DESCRIPTION:	PROPOSED ALTERATIONS AND ADDITION
	Α	28/05/25	DEVELOPMENT APPLICATION	57 Parni Place Frenchs Forest
03				CLIENT:
ا در				Sophia Dafaur
				DRAWING TITLE:
				SHADOW DIAGRAM JUNE 21 12PM


	PROPOSED ALTERATIONS AND ADDITIONS 57 Parni Place Frenchs Forest
	CLIENT: Sophia Dafaur
1	DRAWING TITLE:


DRAWN BY: SCALE: JOB No: 1346/25

APR/25

1:300 @ A3 ACCREDITED BUILDING DESIGNER DRAWING No: DATE:

CHECKED BY: DA.25

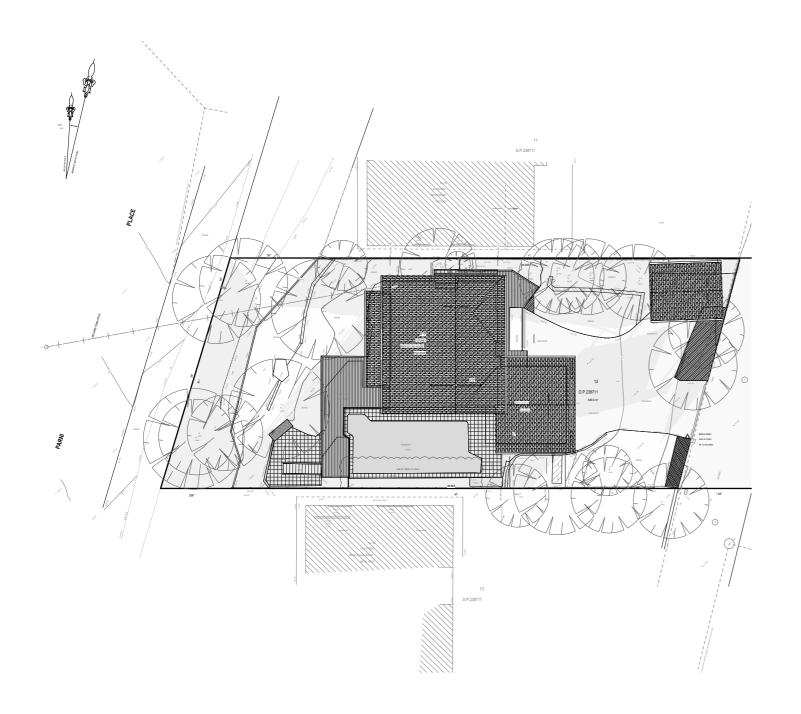

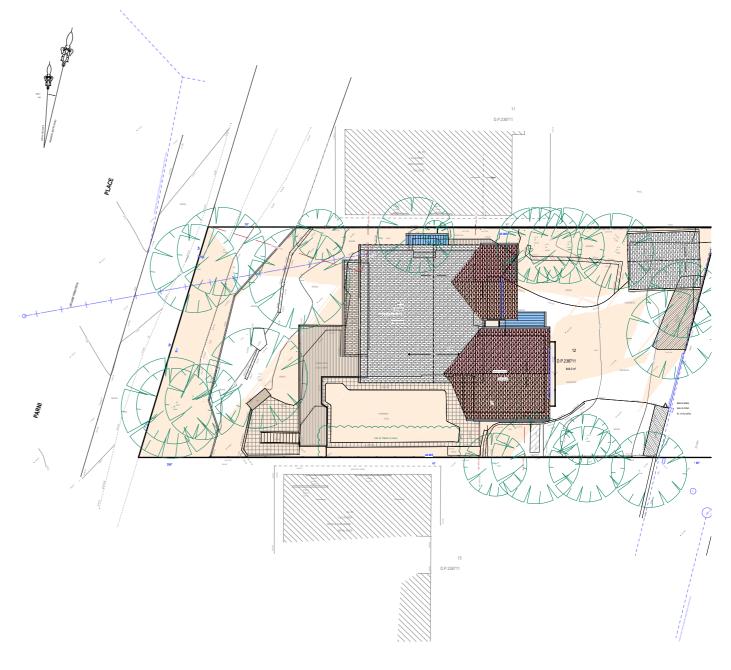

1346/25

SHADOW DIAGRAM 3PM EXISTING

SHADOW DIAGRAM 3PM PROPOSED

TRUE NORTH:

- NOTES (E & OE)

 All structures including stormwater & drainage to engineer's details.

 Do not obtain dimensions by scaling drawings.

 All dimensions & Levels are to be checked on site prior to starting work.

 These drawings are to be read in conjunction with all other consultant's draw

 - All Workmanship a materials are not to a more control of the National Construction Code, relevant Australian Standards & local council requirements.
 New materials are to be used throughout unless otherwise noted.
 Concrete footings, slab, structural beams or any other structural members are to be designed.

JJ Drafting Australia P/L.
26/90 Mona Vale Road, Mona Vale, NSW, 2103
PO Box 687, Dee Why, NSW, 2099
Mob. 0414 717 541 ACN 651 693 346

2 1003 0. 000 000 2 / 20	
90 Mona Vale Road, Mona Vale, NSW, 2103	
PO Box 687, Dee Why, NSW, 2099	
Mob. 0414 717 541 ACN 651 693 346	
Email. enquiries@jjdrafting.com.au	
www.iidrafting.com.au	

	REV:	DATE:	DESCRIPTION:	PROPOSED ALTERATIONS AND ADDITION
	Α	28/05/25	DEVELOPMENT APPLICATION	57 Parni Place Frenchs Forest
,				CLIENT:
٥				Sophia Dafaur
	\vdash			
	$\overline{}$			DRAWING TITLE:
				SHADOW DIAGRAM JUNE 21 3PM
				STIADOW DIAGNAM JUNE 21 SPM

PROPOSED ALTERATIONS AND ADDITIONS 57 Parni Place Frenchs Forest	JOB No:
CLIENT: Sophia Dafaur	1340
DRAWING TITLE:	

DRAWN BY: SCALE: DATE:

APR/25

1:300 @ A3

A C C R E D I T E D BUILDING DESIGNER CHECKED BY:

DRAWING No: **DA.26**

LABEL ID	D D01 D02			
ORIENTATION	EAST	EAST		
ELEVATION	7,500	4,000		
TYPE	SWING DOOR	SLIDING		
AREA FOR BASIX	3.60	8.40		
QUANTITY	1	1		
LOCATION	ENTRY	MASTER BED		

DOOR SCHEDULE

LABEL ID	W01	W02	W03	W04	W05	W06	W07	W08
ORIENTATION	WEST	EAST	NORTH	EAST	NORTH	NORTH	SOUTH	WEST
ELEVATION	**************************************	2,500	* 1,115 *	2,500	1,735	2,100	2,100 x	* 1,000 *
AREA FOR BASIX	0.59	3.25	1.45	3.25	1.65	2.00	2.00	0.90
QUANTITY	1	1	1	1	1	1	1	1
LOCATION	WC	OFFICE	BED 2	BED 2	MASTER BED	MASTER BED	MASTER BED	MASTER BED ENSUITE

WINDOW SCHEDULE

<u>NOTES</u>

FRAME OPENING DIMENSIONS FOR WINDOWS & DOORS TO BE CONFIRMED ON SITE PRIOR TO ORDERING.

	<u>NOTES</u>	(E & OE)	
--	--------------	----------	--

- NOTES (E & OE)

 All structures including stormwater & drainage to engineer's details.

 Do not obtain dimensions by scaling drawings.

 All dimensions & Levels are to be checked on site prior to starting work.

 These drawings are to be read in conjunction with all other consultant's drawings and specifications.

 All workmanship & materials shall be in accordance with the requirements of current editions including amendments of the National Construction Code, relevant Australian Standards & local council requirements.

 New materials are to be used throughout unless otherwise noted.

 Concrete footings, slab, structural beams or any other structural members are to be designed by a practicing engineer.

JJ Drafting Australia P/L.
26/90 Mona Vale Road, Mona Vale, NSW, 2103
PO Box 687, Dee Why, NSW, 2099
Mob. 0414 717 541 ACN 651 693 346 Email. enquiries@jjdrafting.com.au

www.jjdrafting.com.au

	REV:	DATE:	DESCRIPTION:	
	Α	28/05/25	DEVELOPMENT APPLICATION	
3				
				ſ
- 1	1			П

PROPOSED ALTERATIONS AND ADDITIONS 57 Parni Place Frenchs Forest CLIENT: Sophia Dafaur	JOB No: 1346/25
DRAWING TITLE: OPENINGS SCHEDULE	

DRAWN BY: SCALE: 1:1 @ A3 DATE:

APR/25

ACCREDITED BUILDING DESIGNER DRAWING No: CHECKED BY: **DA.27** JJ