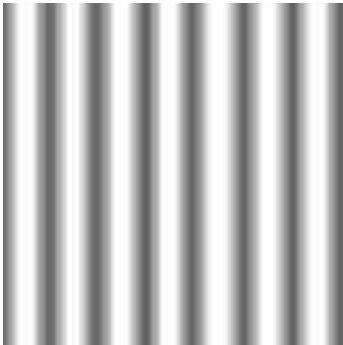


SPECIFICATION

- "Approval" - obtained by either an 'Accredited Certifying Authority' or 'Local Council'.
 - The Owner will directly pay all fees associated with the following:-
Building approval from council or accredited certifier, any footpath and kerb deposits with the local council, insurance fees to Building Services Corporation, Long Service Leave levy fees and approval fees by water and sewerage authority. All other fees are to be paid by the builder. The amount of any local authority deposits which are forfeited due to damage or other causes, will be deducted from payments due to the builder.
 - The Builder is to provide at his/her own expense adequate Public Risk Insurance and arrange indemnification under the Workers Compensation Act. Works insurance to be as stated in the contract conditions.
 - All tenderers are to visit the site to satisfy themselves as to the nature and extent of the Works, facilities available and difficulties entailed in the works as Variations will not be allowed due to work arising owing to neglect of this clause.
 - These drawings shall be read in conjunction with all structural and other consultant's drawings and specifications and with any such written instructions as may be issued during the course of the contract.
 - Set out dimensions shown on this drawing shall be verified by the builder on site before commencement of any work. Dimensions shall not be obtained by scaling the drawings. Use only figured dimensions. All dimensions are in millimetres.
 - The Builder is to ensure all construction, levels and other items comply with the conditions of the Building Approval.
 - Any detailing in addition to what is supplied shall be resolved between the Owner and the Builder to the Owner's approval, except for any structural details or design which is to be supplied by the Engineer.
 - All work to be carried out in a tradesman like manner and in accordance with the standards, codes and regulations of the Standards Association of Australia, National construction Code of Australia and any statutory authority having jurisdiction over the works.
 - All structural work is to be in accordance with the structural details prepared by a suitably qualified structural engineer. Including but not limited to all piers, footings, concrete slabs, retaining walls, steelworks, formwork, underpinning, additional structural loads, timber framing, wind bracing and associated connections. Builder to obtain, prior to finalising the tender unless previously obtained by owners.
 - All brickwork is to be selected by owner and is to comply with AS 1640. All masonry is to comply with AS 3700.
 - Provide all metalwork and flashings necessary to satisfactorily complete the works.
 - All timber construction to be in accordance with AS 1684 - "Timber Framing Code". Level & Grade where necessary under timber floors to provide a minimum clearance of 300mm under bearers or 400mm under joists. Adequate precautions shall be taken to ensure that the surface &/or seepage water does not collect or remain under floor area. Sustainable timbers and not rainforest or old growth timber will be use. Recycled timber or second hand timbers are to be sourced and used in preference to plantation timbers, if available and suitable.
 - All glazing installed is to comply with AS 1288, 2047 and in accordance with manufacturers recommendations.
 - All wall and ceiling linings to be plasterboard and villaboard or equal in wet areas. A breathable wall wrap is to be provided to all external walls. Timber cladding is to be battened out from timber frame to provide an 'air' gap to prevent condensation. Workmanship is to comply with the relevant Australian Standards or installed in accordance with manufacturer's specification. All bathrooms and wet areas to be waterproofed with a flexible membrane to manufacturer's specification and to AS 3740 and Part 3.8.1 of the Building Code of Australia Housing Provisions.
 - All Architraves and skirtings to the profile as selected by owner, and painted or stain finish as selected.
 - All plumbing and drainage work to be installed and completed by a licensed tradesman and in accordance with the statutory body having authority over the works. Connect all waste to Sydney Water sewer line.
 - Connect all stormwater to existing system or street drainage system in accordance with AS 3500 and part 3.1.2 Drainage of the Building Code of Australia Housing Provisions.
 - Smoke detector alarms to be installed in accordance with AS3786 and the Building Code of Australia.
 - If a member which provides structural support to the work is subject to attack by Termites protection measures are to comply with AS3660 and be installed to manufacturer's specification.
 - Stairs and Balustrades to comply with part 3.9.1 & 3.9.2 of the Building Code of Australia Housing Provisions.
 - Electrical works to be in accordance with SAA wiring rules and be done by a licenced tradesperson. Obtain electrical layout prior to proceeding. All electrical power (GPO's) and light outlets to be determined by owner.
 - Painting: All paints or other coatings shall be of the best quality materials & of approved manufacture. All priming materials shall be of an approved brand acceptable to the manufacturer of the finishing coats to be used. External joinery intended to be painted shall be primed on all faces at the place of assembly. Where new work or alteration work adjoins existing painted surfaces allow for repainting existing surfaces to provide uniform appearance. ZERO-VOC or LOW-VOC paints and primers only are to be used.
- Any work indicated on the plans but not specified and any item not shown on the plans which is obviously necessary as part of proper construction and/or finish, is to be considered as shown and specified and is to be undertaken at the Builder's expense.
- Variations will not be permitted without prior written approval by the owners.
 - The Builder shall provide sediment and siltration control measures as required by Council and maintain them throughout the duration of the works.
 - A legible copy of the plans bearing approval stamps, must be maintained on the job site at all times. Hours of construction shall be restricted to the times as required by the building approval.
 - The Builder is to arrange for all inspections required by the relevant authorities and/or lending institutions, to their requirements.
 - The Builder is to obtain approval for interruptions to existing services and minimise the duration and number of interruptions. Any interruptions to existing services and equipment is to be undertaken by appropriately qualified tradespersons.
 - The Builder shall restore, reinstate or replace any damage to existing structures or landscaping caused by the construction works or workmen.
 - Provide protection to existing trees to remain, or as required by the Approval Conditions.

COLOUR SCHEDULE

ROOFING to be Shale Grey;
BASIX Light colour.



CLADDING to be similar to below
Basalt or Wallaby
BASIX medium

Basalt®	Solar Absorptance 0.69
Wallaby®	Solar Absorptance 0.64



5.2
NATIONWIDE
HOUSE
ENERGY RATING SCHEME
64.3 MJ/m²
www.nathers.gov.au

Certificate no.: 0004943734
Assessor Name: Tracey Cools
Accreditation no.: HERA10033
Certificate date: 21 Jun 2020
Dwelling Address: 4B Cambridge Avenue
Narraweena, NSW 2099
www.nathers.gov.au

BASIX COMMITMENTS

WATER COMMITMENTS

Landscape
The applicant must plant indigenous or low water use species of vegetation throughout 100 square metres of the site.

Fixtures
The applicant must install showerheads with a minimum rating of 4 star (> 6 but <= 7.5 L/min) in all showers in the development.
The applicant must install a toilet flushing system with a minimum rating of 5 star in each toilet in the development.
The applicant must install taps with a minimum rating of 5 star in the kitchen in the development.
The applicant must install basin taps with a minimum rating of 5 star in each bathroom in the development.

Alternative water
Rainwater tank- Residence
The applicant must install a rainwater tank of at least 3000 litres on the site. This rainwater tank must meet, and be installed in accordance with, the requirements of all applicable regulatory authorities.
The applicant must configure the rainwater tank to collect rain runoff from at least 200 square metres of the roof area of the development (excluding the area of the roof which drains to any stormwater tank or private dam).
The applicant must connect the rainwater tank to:
• the cold water tap that supplies each clothes washer in the development
• at least one outdoor tap in the development (Note: NSW Health does not recommend that rainwater be used for human consumption in areas with potable water supply.)

THERMAL COMFORT COMMITMENTS

Floor Construction

Enclosed suspended timber framed floors with R3.0 insulation
Open Suspended concrete floor with R3.0 insulation required excluding Garage (no insulation required to Garage floor)
Timber between levels with no insulation required
Floor coverings: tiles to wet areas, carpet and timber elsewhere as per drawings

External Wall Construction

Light weight cladding with R2.5 insulation (insulation only value)
No insulation required to external garage walls
Medium colour modelled (0.475<SA<0.7)

Internal Wall Construction

Plasterboard on studs
R2.0 insulation required to internal Garage walls and Laundry walls shared with other internal areas

Ceiling Construction

Plasterboard ceiling with R3.5 insulation (insulation value only) where roof is above excluding Garage

Note: All ceiling penetrations have been modelled in accordance with NatHERS protocols, all downlights are assumed sealed LED downlights.

Roof Construction

Metal roof with a sarking/Foil (R-value: 0.00)
External Colour: Light (0.45>SA)

External Shading

Covered Deck. Eaves as per stamped plans

ENERGY COMMITMENTS

Hot water
The applicant must install the following hot water system in the development, or a system with a higher energy rating:
gas instantaneous with a performance of 6 stars.

Cooling System
The applicant must install the following cooling system, or a system with a higher energy rating, in at least 1 living area:
Ceiling Fans + 3 phase airconditioning; Energy Rating: EER 3.5-3.5
The applicant must install the following cooling system, or a system with a higher energy rating, in at least 1 bedroom:
Ceiling Fans + 3 phase airconditioning; Energy Rating: EER 3.5-3.5

Heating system
The applicant must install the following heating system, or a system with a higher energy rating, in at least 1 living area:
3 phase airconditioning; Energy Rating: EER 3.5-3.5
The applicant must install the following heating system, or a system with a higher energy rating, in at least 1 bedroom:
3 phase airconditioning; Energy Rating: EER 3.5-3.5

Ventilation
The applicant must install the following exhaust systems in the development:
At least 1 Bathroom: individual fan, ducted to facade or roof; Operation control: manual switch on/off
Kitchen: individual fan, ducted to façade or roof; Sealed to prevent insulation loss; Operation control: manual switch on/off
Laundry: individual fan, ducted to facade or roof; Operation control: manual switch on/ timer off
The applicant must ensure that the "primary type of artificial lighting" is fluorescent or light emitting diode (LED) lighting in each of the following rooms, and where the word "dedicated" appears, the fittings for those lights must only be capable of ac at least 5 of the bedrooms / study; at least 2 of the living / dining rooms; the kitchen; all bathrooms/toilets; the laundry; all hallways
ALL DOWN LIGHTS TO BE SEALED

Natural lighting
The applicant must install a window and/or skylight in the kitchen of the dwelling for natural lighting.
The applicant must install a window and/or skylight in 3 bathroom(s)/toilet(s) in the development for natural lighting.

Other
The applicant must install an induction cooktop & electric oven in the kitchen of the dwelling.
The applicant must install a fixed outdoor clothes drying line as part of the development.
The applicant must install a fixed indoor or sheltered clothes drying line as part of the development.

Survey Details provided by
CMS Surveyors Pty Limited
South Creek Road, Dee Why.
Levels are on Australian Height Datum.

BDAA Accredited number 6255
ABN 17 751 732 195

Sally Gardner Design and Draft
PLANS DRAWN FOR APPROVAL

SustainAbility Design™ Specialist

www.rfmconstructions.com.au

Licence Number 183670c

Client

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CONSTRUCTIONS
PTY LTD

NEW RESIDENCE
4B CAMBRIDGE AVE NARRAWEENA NSW 2099

NOTES and BASIX COMMITMENTS

Scale

Date

Monday, 22
June 2020

Job Number

19-0201

Drawn

S.G.

Drawing No.

N1

WINDOW SCHEDULE												
ID	W1	W2	W3	W4	W5	W7	W8	W9	W10	W11	W12	W14
W x H	3,600×1,500	600×900	600×900	600×900	1,300×1,800	3,200×2,250	2,700×450	2,700×450	750×2,250	950×450	600×900	1,800×1,500
SILL HEIGHT	900	1,500	1,500	1,500	600	0	1,200	1,200	0	1,800	1,500	1,050
HEAD HEIGHT	2,400	2,400	2,400	2,400	2,400	2,250	1,650	1,650	2,250	2,250	2,400	2,550
ELEVATION												

WINDOW SCHEDULE												
ID	W15	W16	W17	W18	W19	W19A	W20	W21	W22	W23	W24	W25
W x H	1,800×1,500	2,100×750	3,000×450	1,500×1,500	3,600×1,700	3,600×650	1,200×1,500	600×1,100	3,000×600	3,300×1,200	1,800×2,155	900×1,500
SILL HEIGHT	1,050	1,800	1,000	900	900	2,850	900	1,000	1,500	900	900	1,500
HEAD HEIGHT	2,550	2,550	1,450	2,400	2,600	3,500	2,400	2,100	2,100	2,100	3,055	3,000
ELEVATION												

WINDOW SCHEDULE										
ID	W26	W27	W28	W29	W30	W31	W-64	W-65	W-66	W-67
W x H	1,800×2,155	3,000×600	3,000×600	600×1,200	600×1,200	3,600×700	900×1,170	1,200×950	1,200×870	600×870
SILL HEIGHT	900	1,500	1,500	900	900	2,400	61,240	64,530	64,610	64,610
HEAD HEIGHT	3,055	2,100	2,100	2,100	2,100	3,100	62,410	65,480	65,480	65,480
ELEVATION										

DOOR & WINDOW NOTE:

All windows to be Powder Coated Aluminium framed performance glazing throughout with fly screens.

Type A Glazing: Awning + Casement + Bi-fold windows/doors:
U-value: 4.80 (equal to or lower than) SHGC: 0.34 (±10%)

Type B Glazing: Fixed + Sliding + Louvre windows/doors:
U-value: 4.80 (equal to or lower than) SHGC: 0.34 (±10%)

Given values are AFRC total window system values (glass and frame)

Front door to be Solid Core Timber '1270mm x 40mm' Feature door with Timber Framed Side and high light.

Garage Doors; Automatic Panel lift.

All other external doors to be Powder Coated Aluminium.

All Doors and Windows to be keyed alike deadlocks to all sashes & doors.

All windows and doors shall conform to the Relevant Australian Standard.

All windows and doors are to be weather stripped as per NCC.

All glazed assemblies will comply with As 2047 and AS 1288.

All glazing to have a max reflectivity index of 25%

GLAZING NOTE:

Window load classification to all new windows and glazed doors is to be confirmed by the engineer prior to ordering and installation.

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South Creek Road, Dee Why.
Levels are on Australian Height Datum.

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NEW RESIDENCE
4B CAMBRIDGE AVE NARRAWEENA NSW 2099

Drawing Title

WINDOW & DOOR SCHEDULES

Scale 1:1

Date Monday, 22 June 2020

Job Number 19-0201

Drawn S.G.

Drawing No. N2

THIS PLAN IS TO BE READ IN CONJUNCTION WITH THE CONDITIONS OF DEVELOPMENT CONSENT
DA2020/0941

5.2
NATIONWIDE HOUSE ENERGY RATING SCHEME
64.3 MJ/m²
www.nathers.gov.au

Certificate no.: 0004943734
Assessor Name: Tracey Cools
Accreditation no.: HERA10033
Certificate date: 21 Jun 2020
Dwelling Address: 4B Cambridge Avenue Narraweena, NSW 2099

DOOR SCHEDULE					
ID	D1	D2	D3	D4	D5
W x H	3,200×2,250	900×2,700	4,069×2,400	3,670×2,400	870×2,250

PVC/ Colorbond downpipes as per Hydraulic Engineers details.
All new downpipes to be located clear of windows.

Lysaght Colorbond 'custom Orb' roof sheeting
Fixed to structure in Accordance with Manufacturers Specifications.

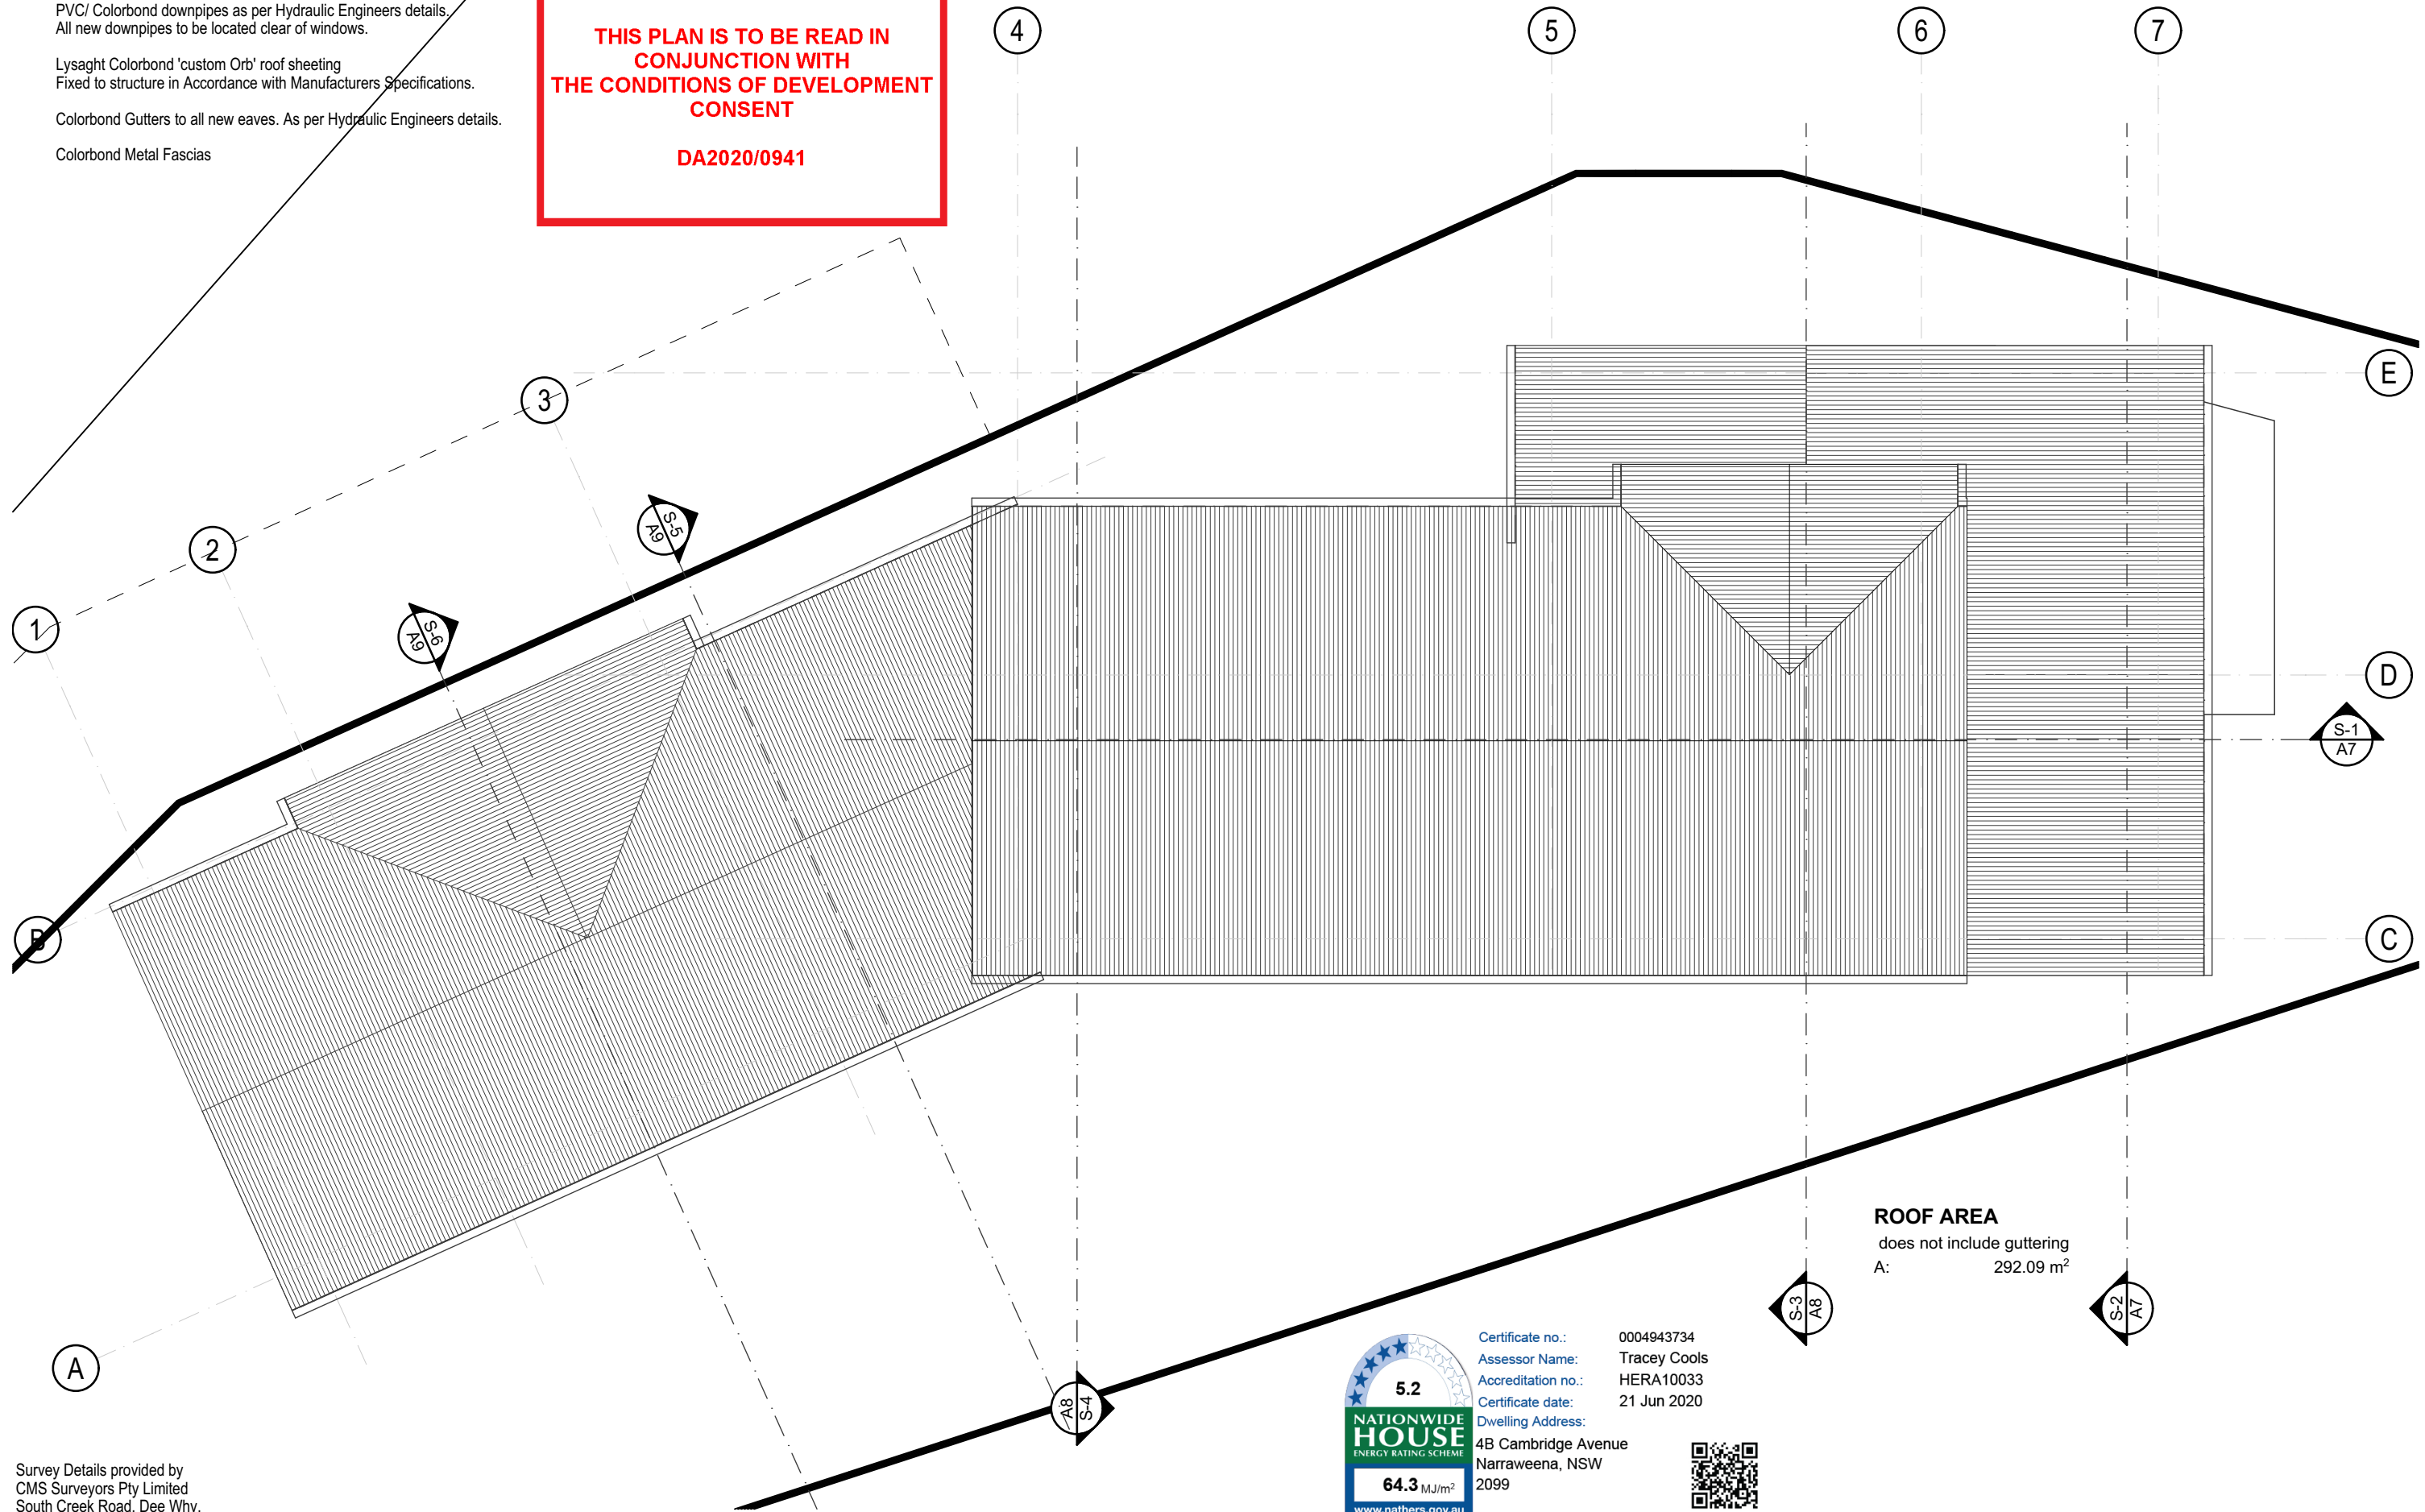
Colorbond Gutters to all new eaves. As per Hydraulic Engineers details.

Colorbond Metal Fascias

 northern
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council

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CONSENT**

DA2020/0941



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South Creek Road, Dee Why.
Levels are on Australian Height Datum.



BDAA Accreditation number 6255
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SALLY GARDNER DESIGN AND DRAFT
PLANS DRAWN FOR APPROVAL



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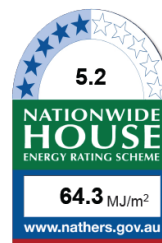


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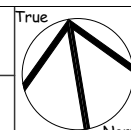
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Drawing Title **NEW RESIDENCE
4B CAMBRIDGE AVE NARRAWEENA NSW 2099
ROOF PLAN**



Certificate no.: 0004943734
Assessor Name: Tracey Cools
Accreditation no.: HERA10033
Certificate date: 21 Jun 2020
Dwelling Address:
4B Cambridge Avenue
Narraweena, NSW
2099

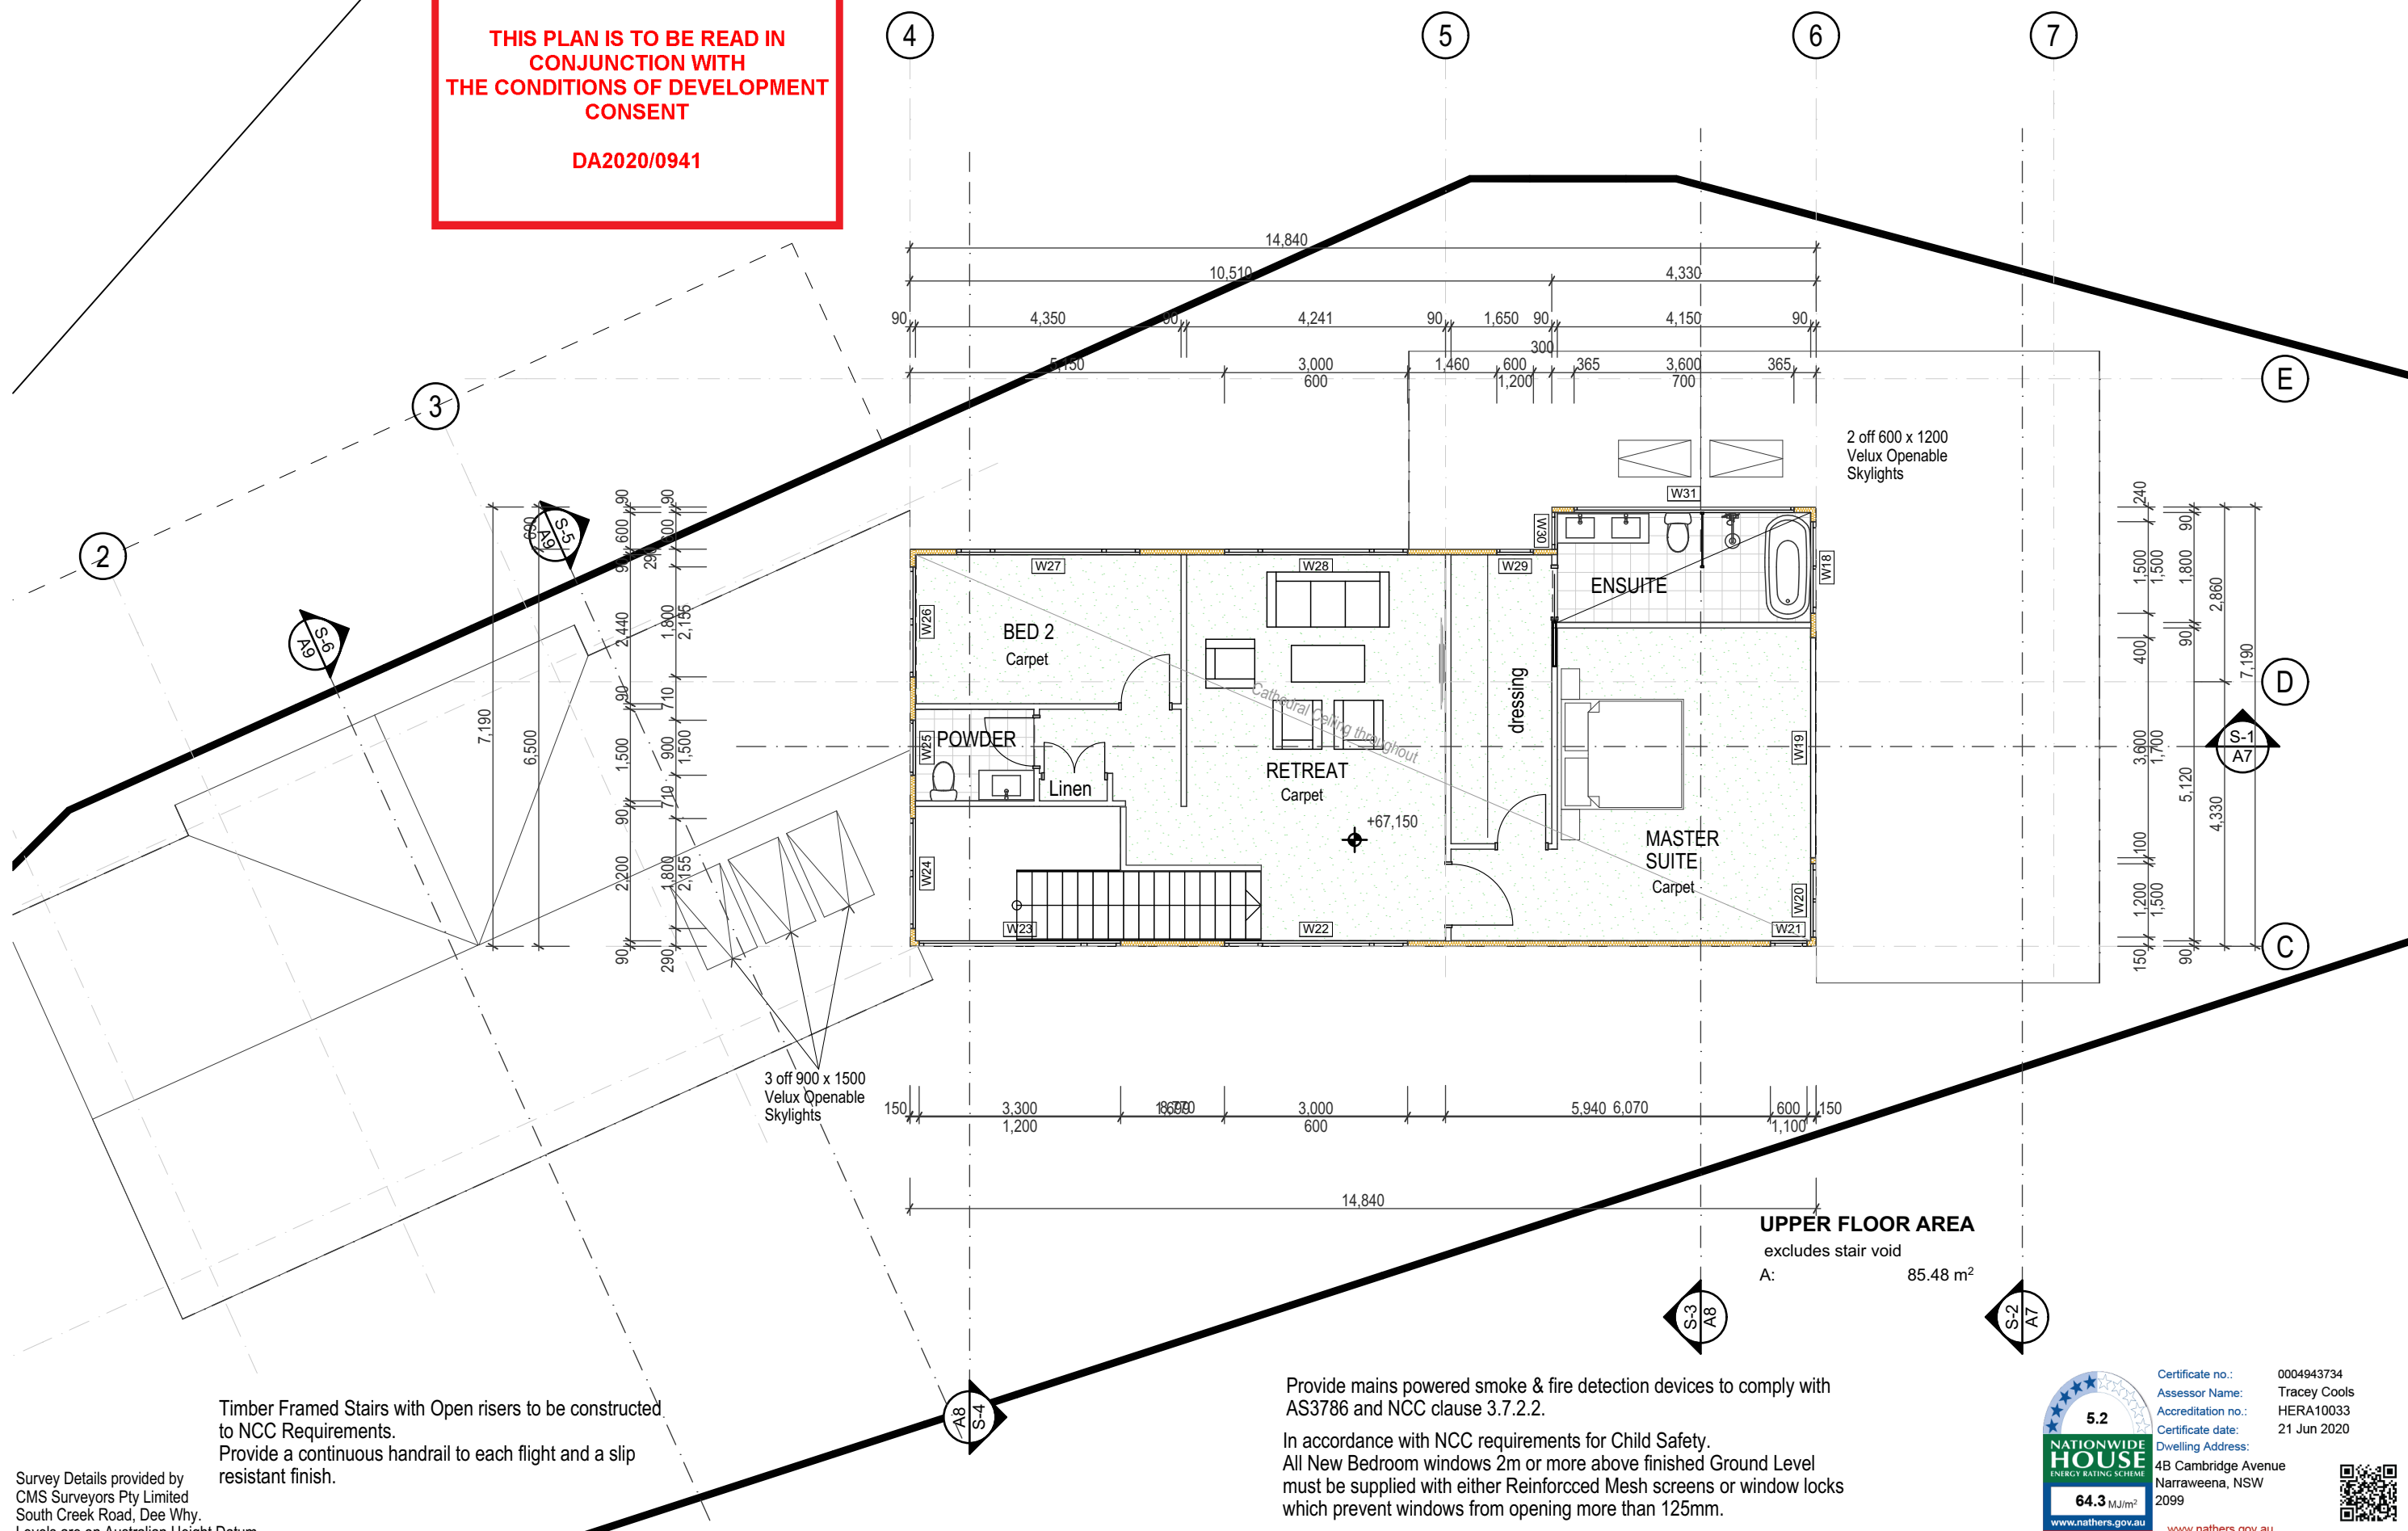
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Scale **1:100**
Date **Monday, 22
June 2020**

Job Number **19-0201**
Drawn **S.G.**
Drawing No. **A1**

DA2020/0941

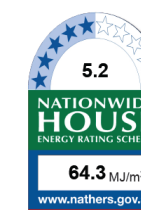


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South Creek Road, Dee Why.
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Timber Framed Stairs with Open risers to be constructed to NCC Requirements.
Provide a continuous handrail to each flight and a slip resistant finish.

Provide mains powered smoke & fire detection devices to comply with AS3786 and NCC clause 3.7.2.2.

In accordance with NCC requirements for Child Safety.
All New Bedroom windows 2m or more above finished Ground Level
must be supplied with either Reinforced Mesh screens or window locks
which prevent windows from opening more than 125mm.



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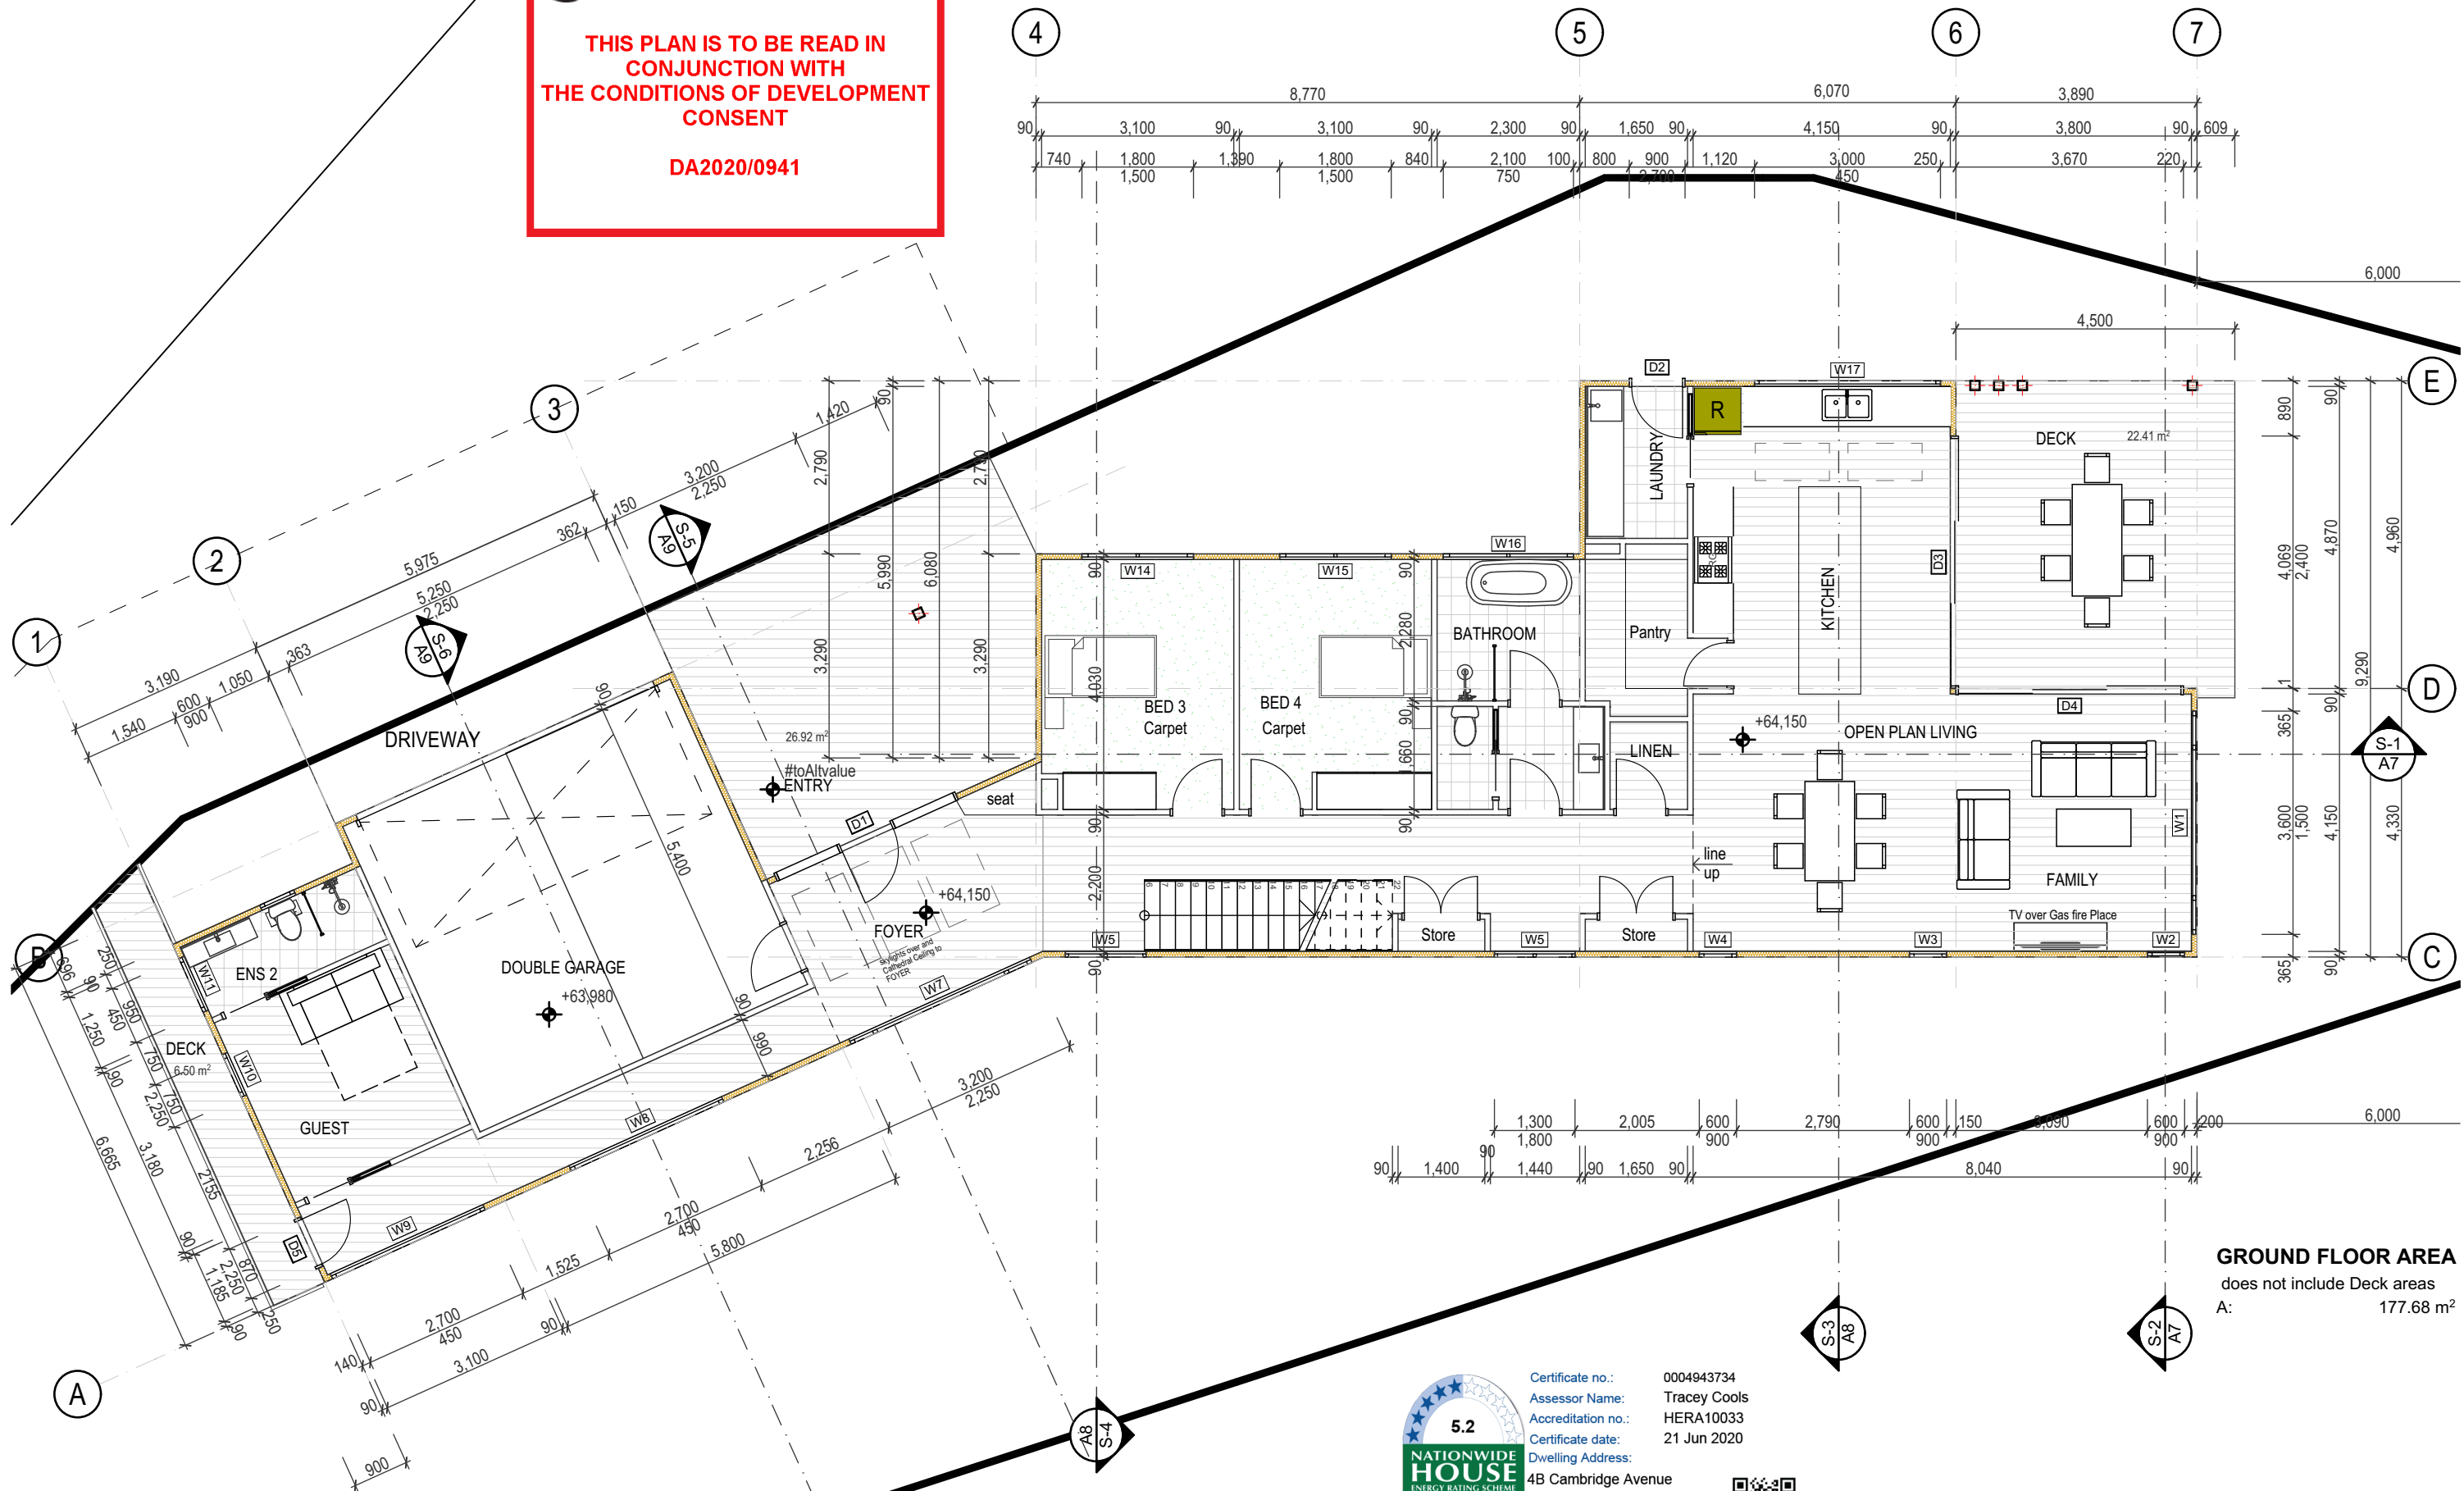
Dwelling Address:
4B Cambridge Avenue
Narraweena, NSW
2099



 **northern
beaches
council**

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CONSENT**

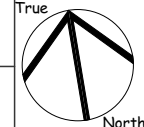
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Narrabeena, NSW
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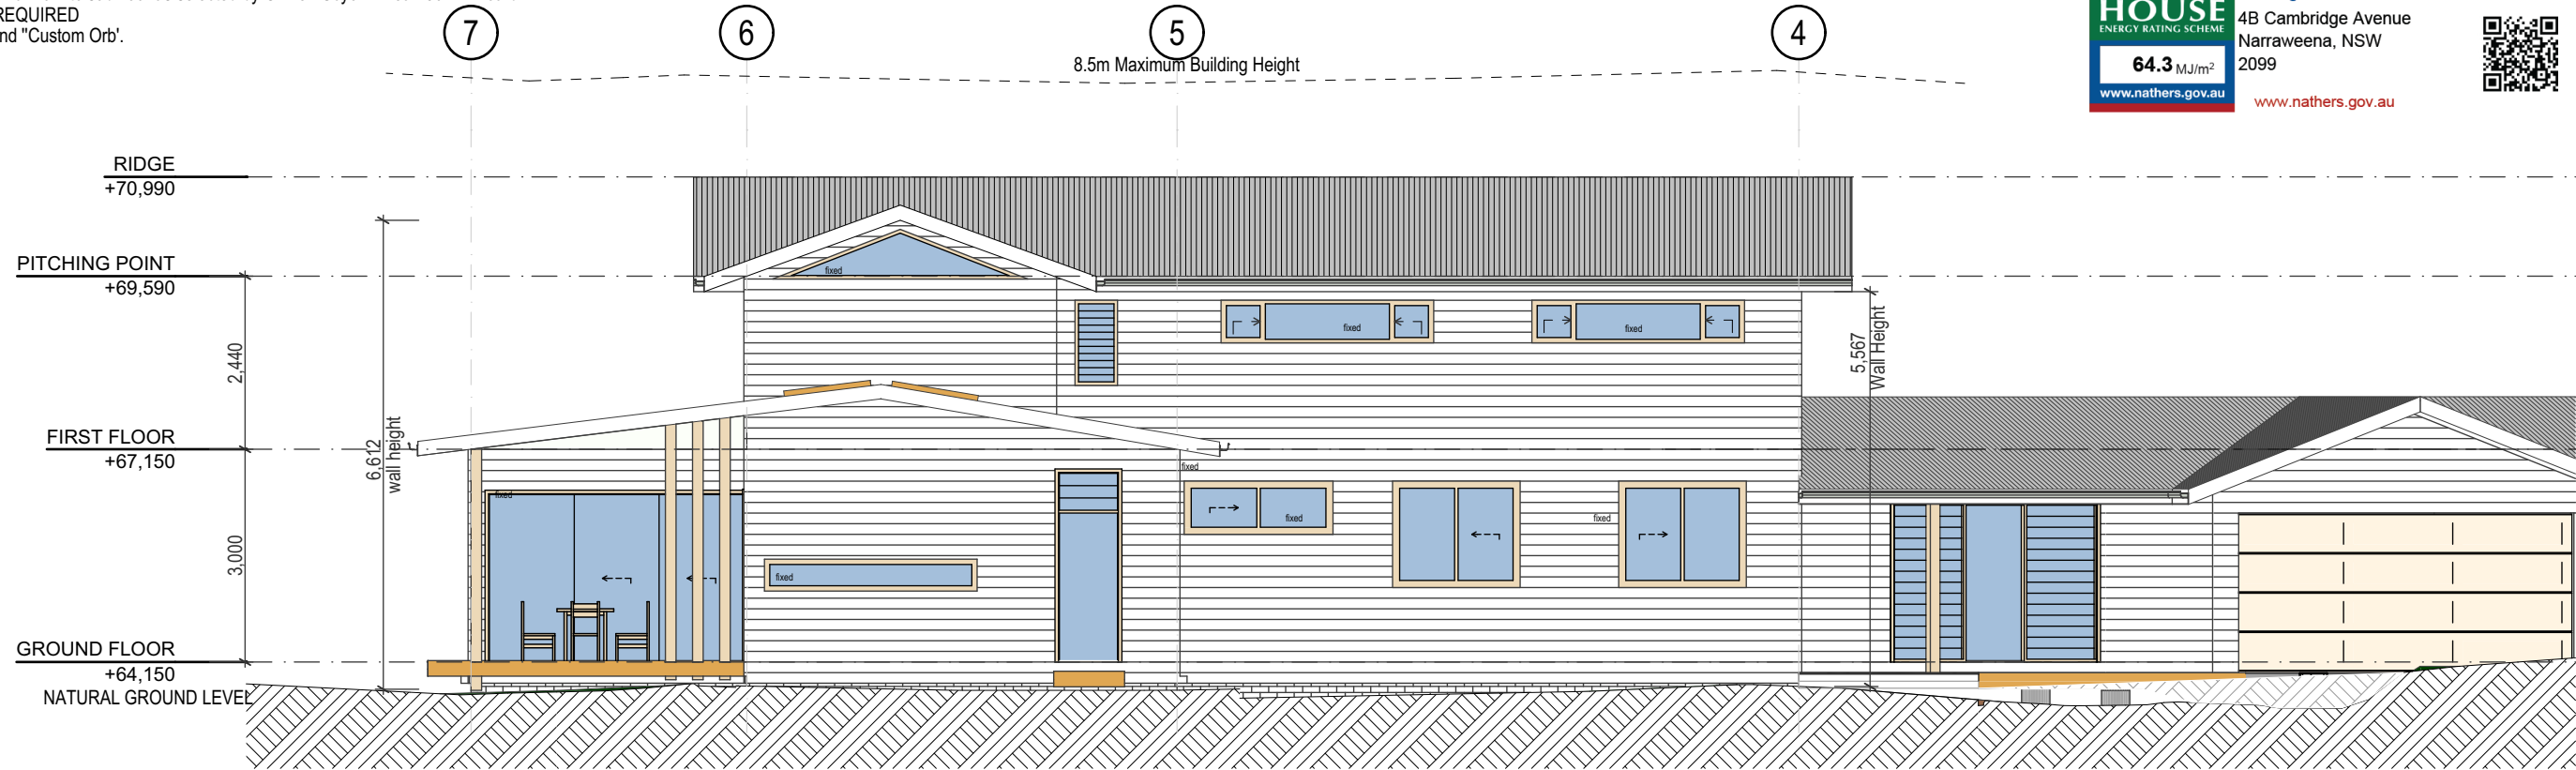
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Date **Monday, 22
June 2020**

Job Number **19-0201**
Drawn **S.G.**
Drawing No. **A3**

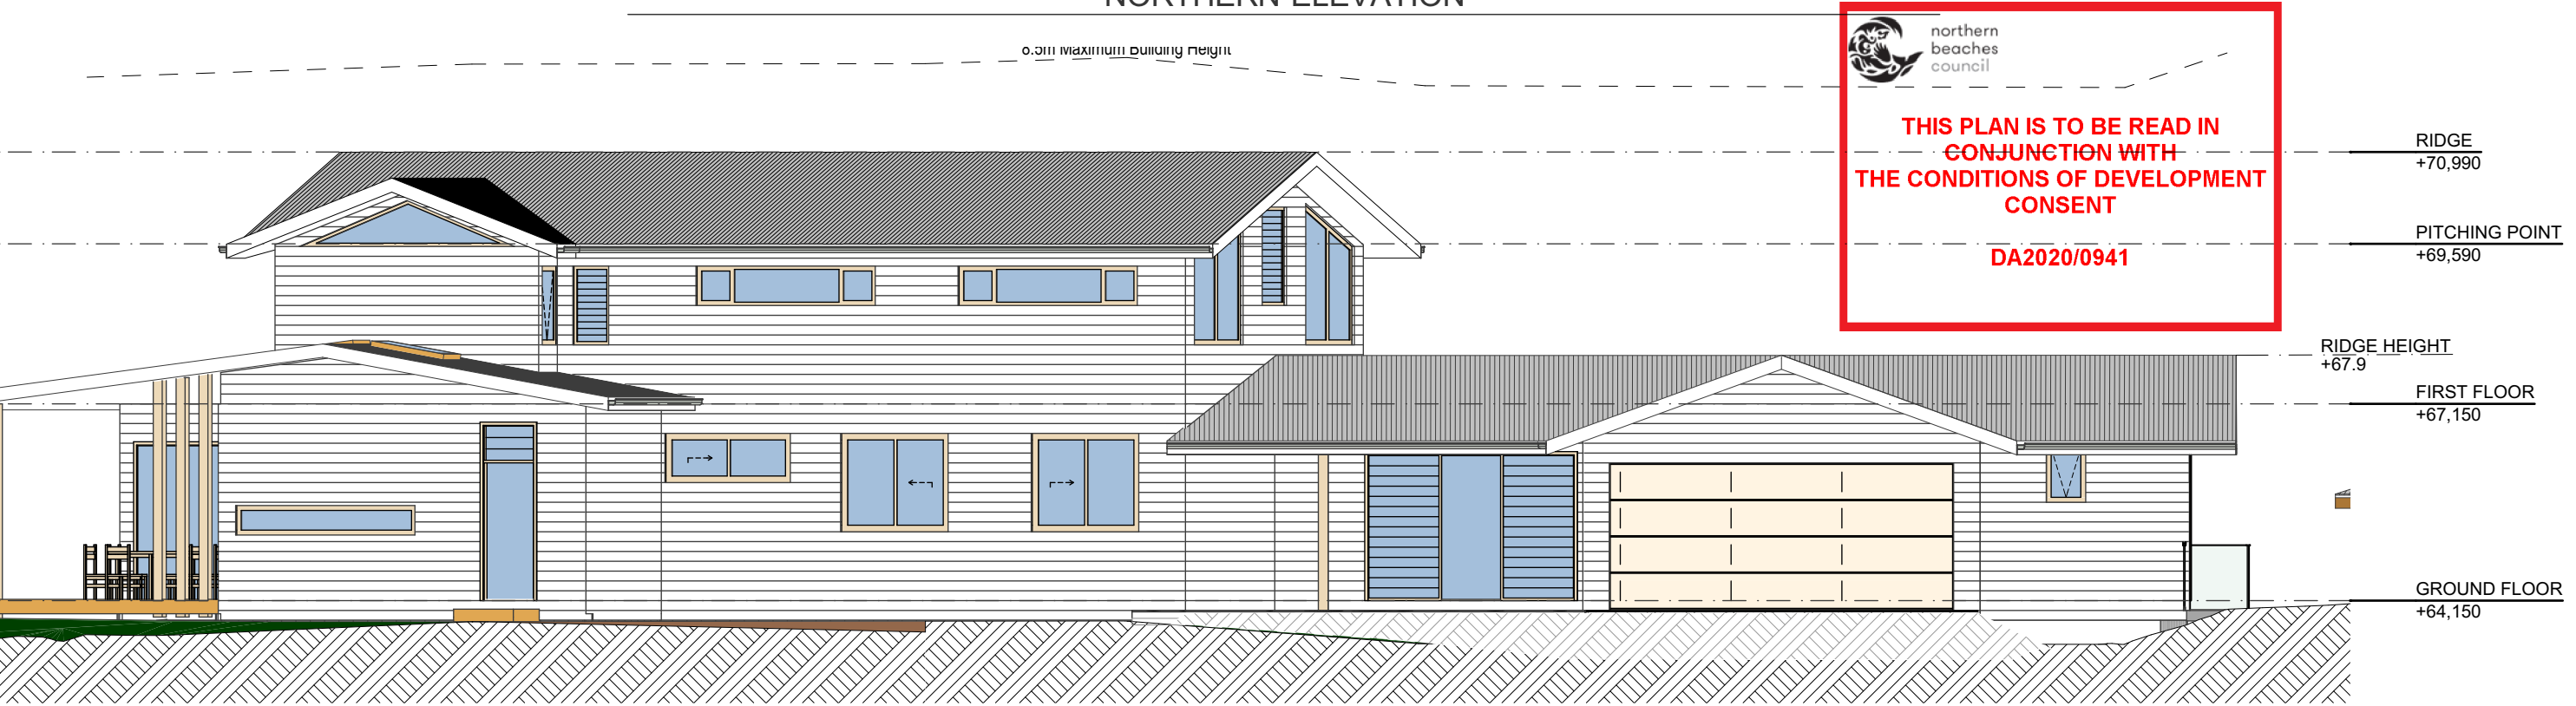
GENERAL
WINDOWS AND DOORS - All windows to be Powder Coated Aluminium with fly screens.
Front door to be Solid Core Timber '920mm x 40mm' Feature door with Timber Framed Side light.
Garage Doors; Automatic Panel lift.
All other external doors to be Powder Coated Aluminium.
EXTERNAL CLADDINGS - Brickwork to sub floor as selected by Owner. Scyon Linea 150mm Board.
BALUSTRADES - Glass IF REQUIRED
ROOFING - Lysaght colorbond 'Custom Orb'.



Certificate no.: 0004943734
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Narraweena, NSW
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
NORTHERN ELEVATION



NORTH WESTERN ELEVATION


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


ACCREDITED
BUILDING DESIGNER

BDAA Accreditation number 6255
ABN 17 751 732 195



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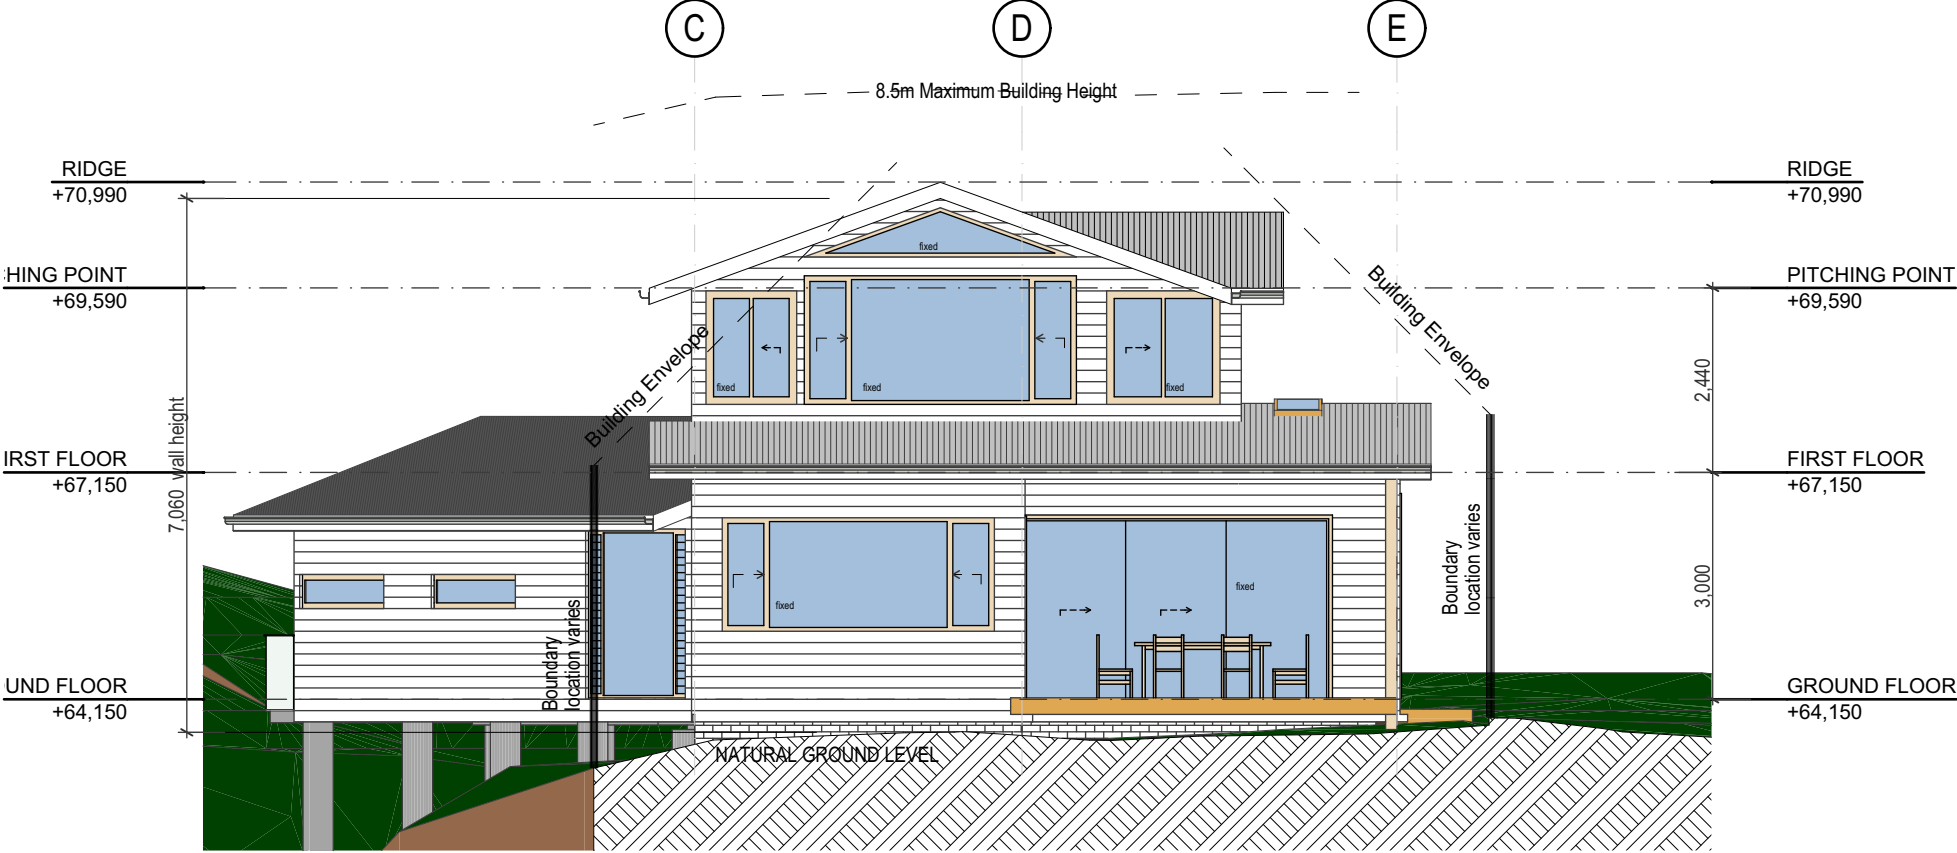
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Client
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NEW RESIDENCE
4B CAMBRIDGE AVE NARRAWEENA NSW 2099
ELEVATION SHEET 1

Scale 1:100	Job Number 19-0201
Date Monday, 22 June 2020	Drawn S.G.
	Drawing No. A4

GENERAL
WINDOWS AND DOORS - All windows to be Powder Coated Aluminium with fly screens.
Front door to be Solid Core Timber '920mm x 40mm' Feature door with Timber Framed Side light.
Garage Doors; Automatic Panel lift.
All other external doors to be Powder Coated Aluminium.
EXTERNAL CLADDINGS - Brickwork to sub floor as selected by Owner. Scyon Linea 150mm Board.
BALUSTRADES - Glass
ROOFING - Lysaght colorbond 'Custom Orb'.



EASTERN ELEVATION



WESTERN ELEVATION



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CMS Surveyors Pty Limited
South Creek Road, Dee Why.
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ACCREDITED
BUILDING DESIGNER

BDAA Accreditation number 6255
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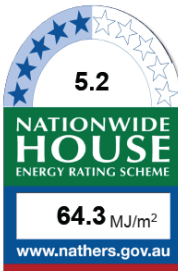
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NEW RESIDENCE
4B CAMBRIDGE AVE NARRAWEENA NSW 2099
Drawing Title
ELEVATION SHEET 2

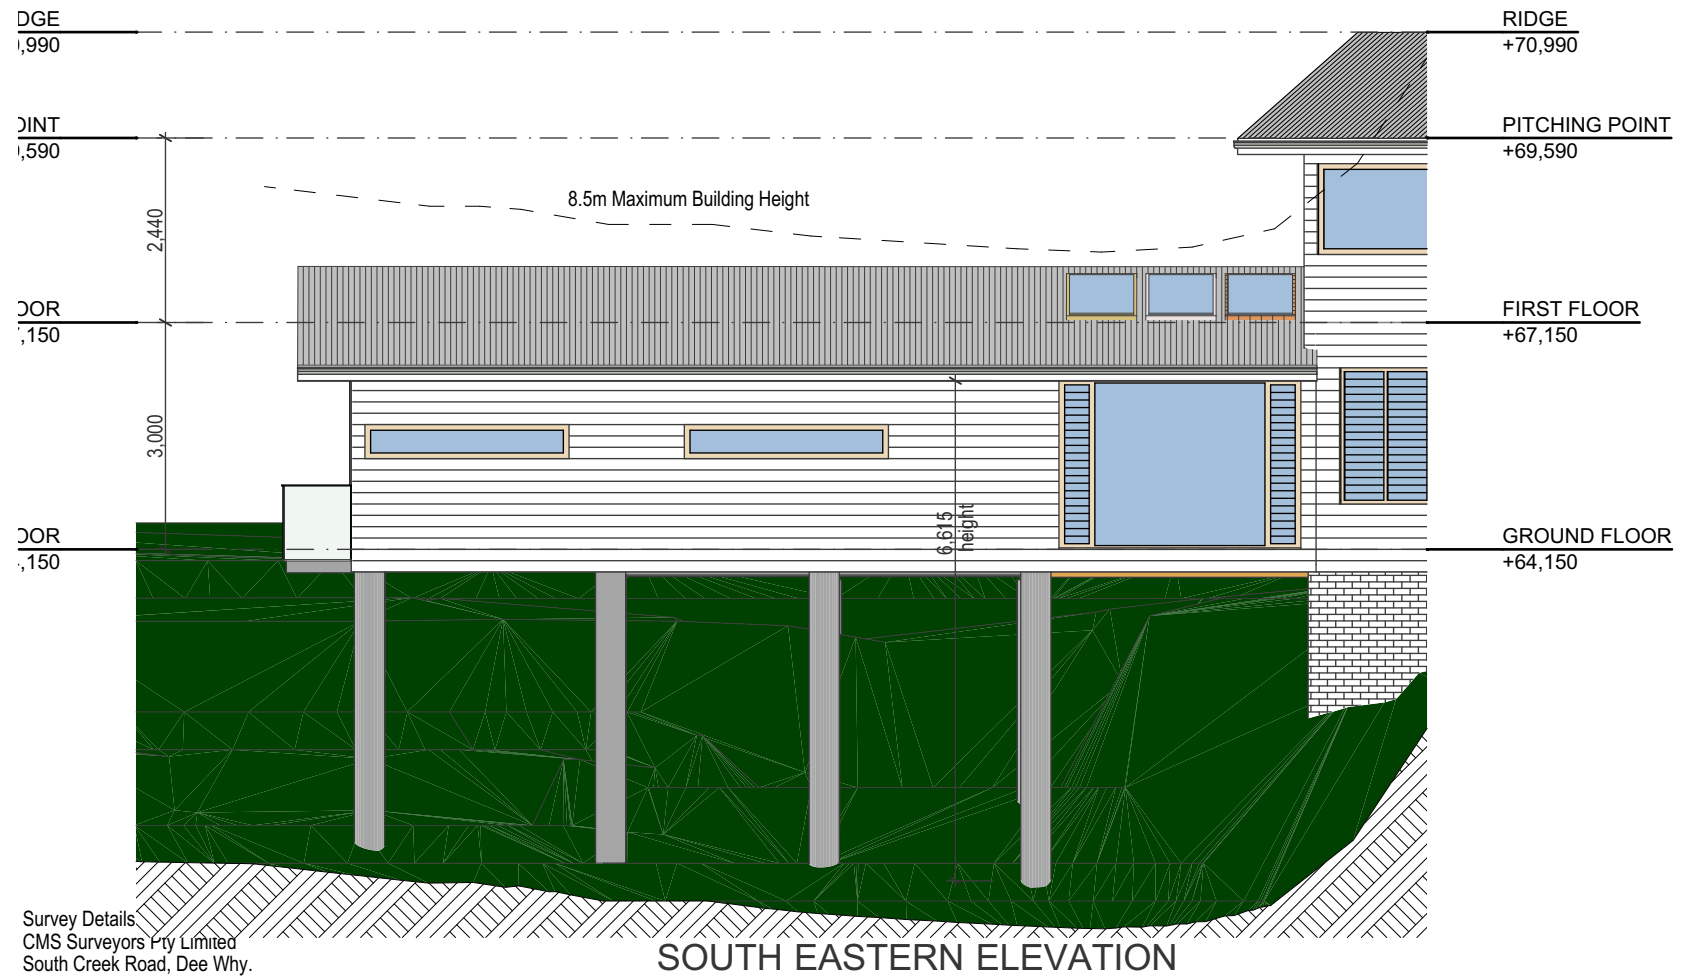
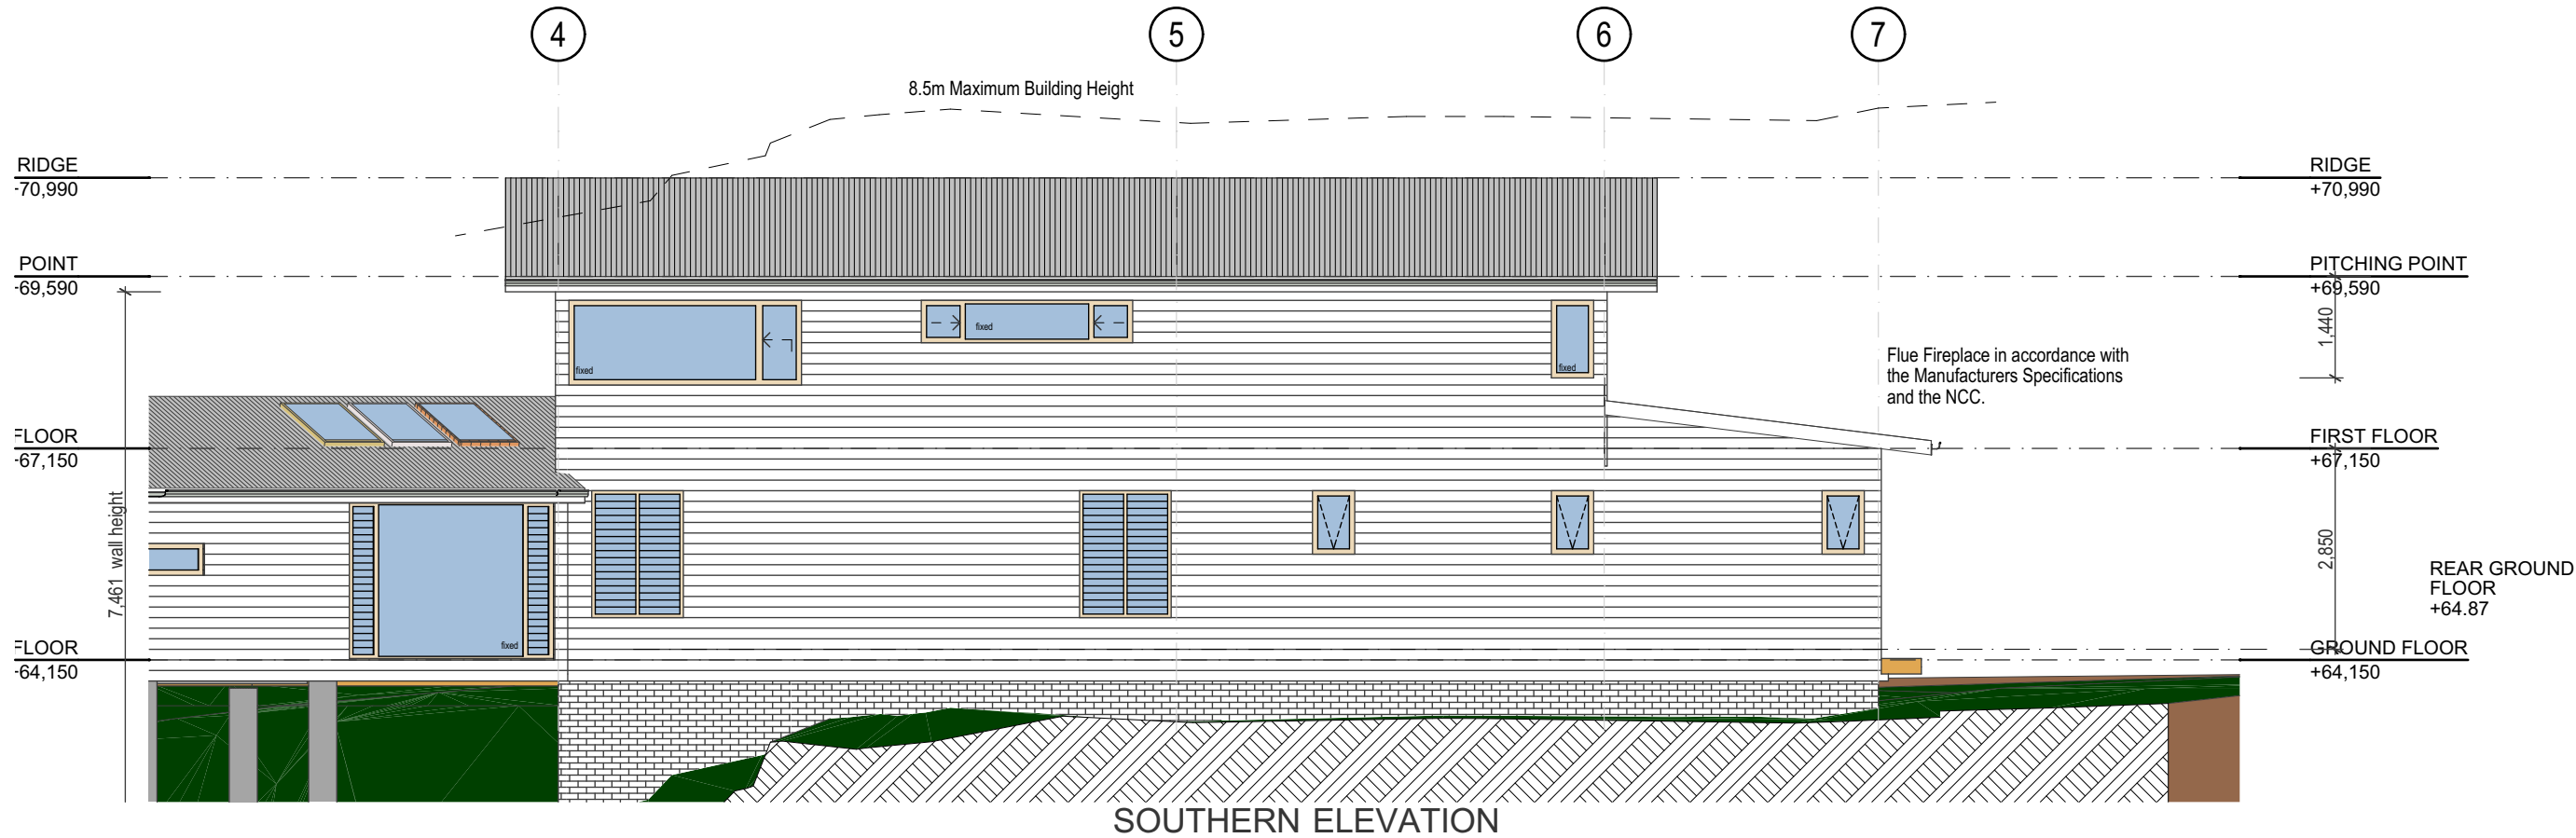
Scale	Job Number 19-0201		
Date	Drawn	Drawing No.	
Monday, 22 June 2020	S.G.	A5	



5.2
NATIONWIDE HOUSE
ENERGY RATING SCHEME
64.3 MJ/m²
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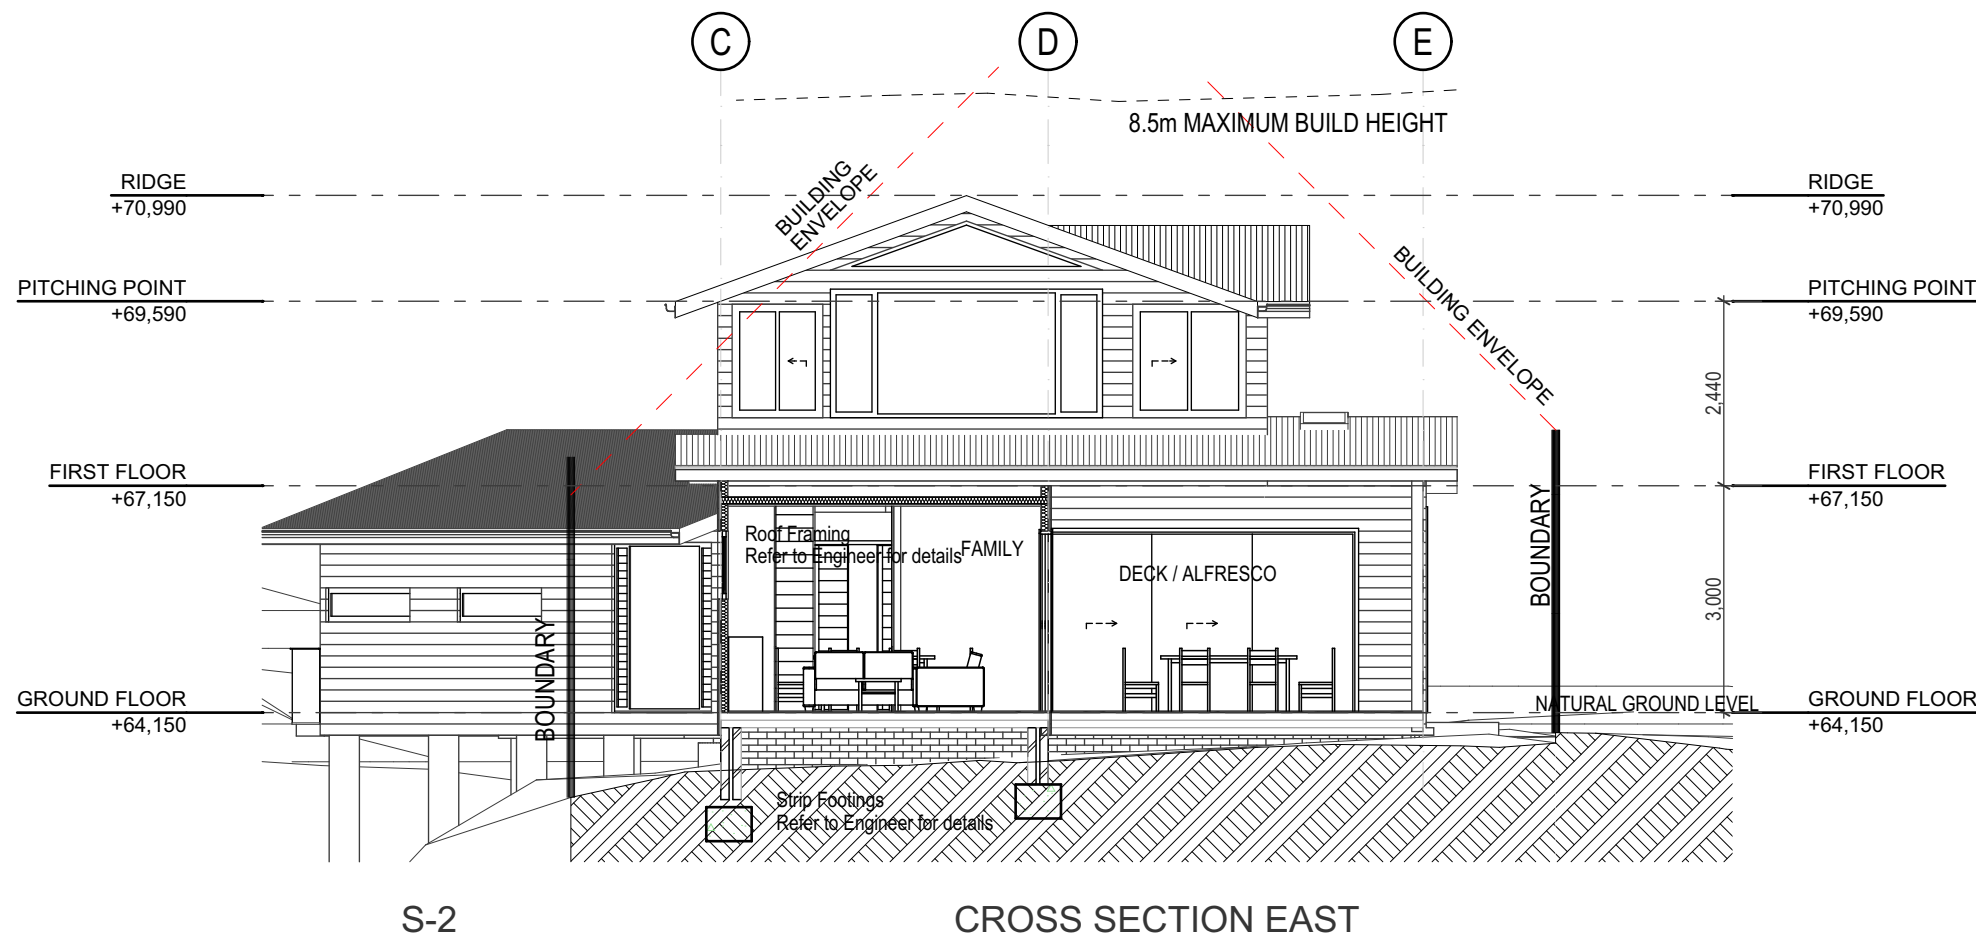
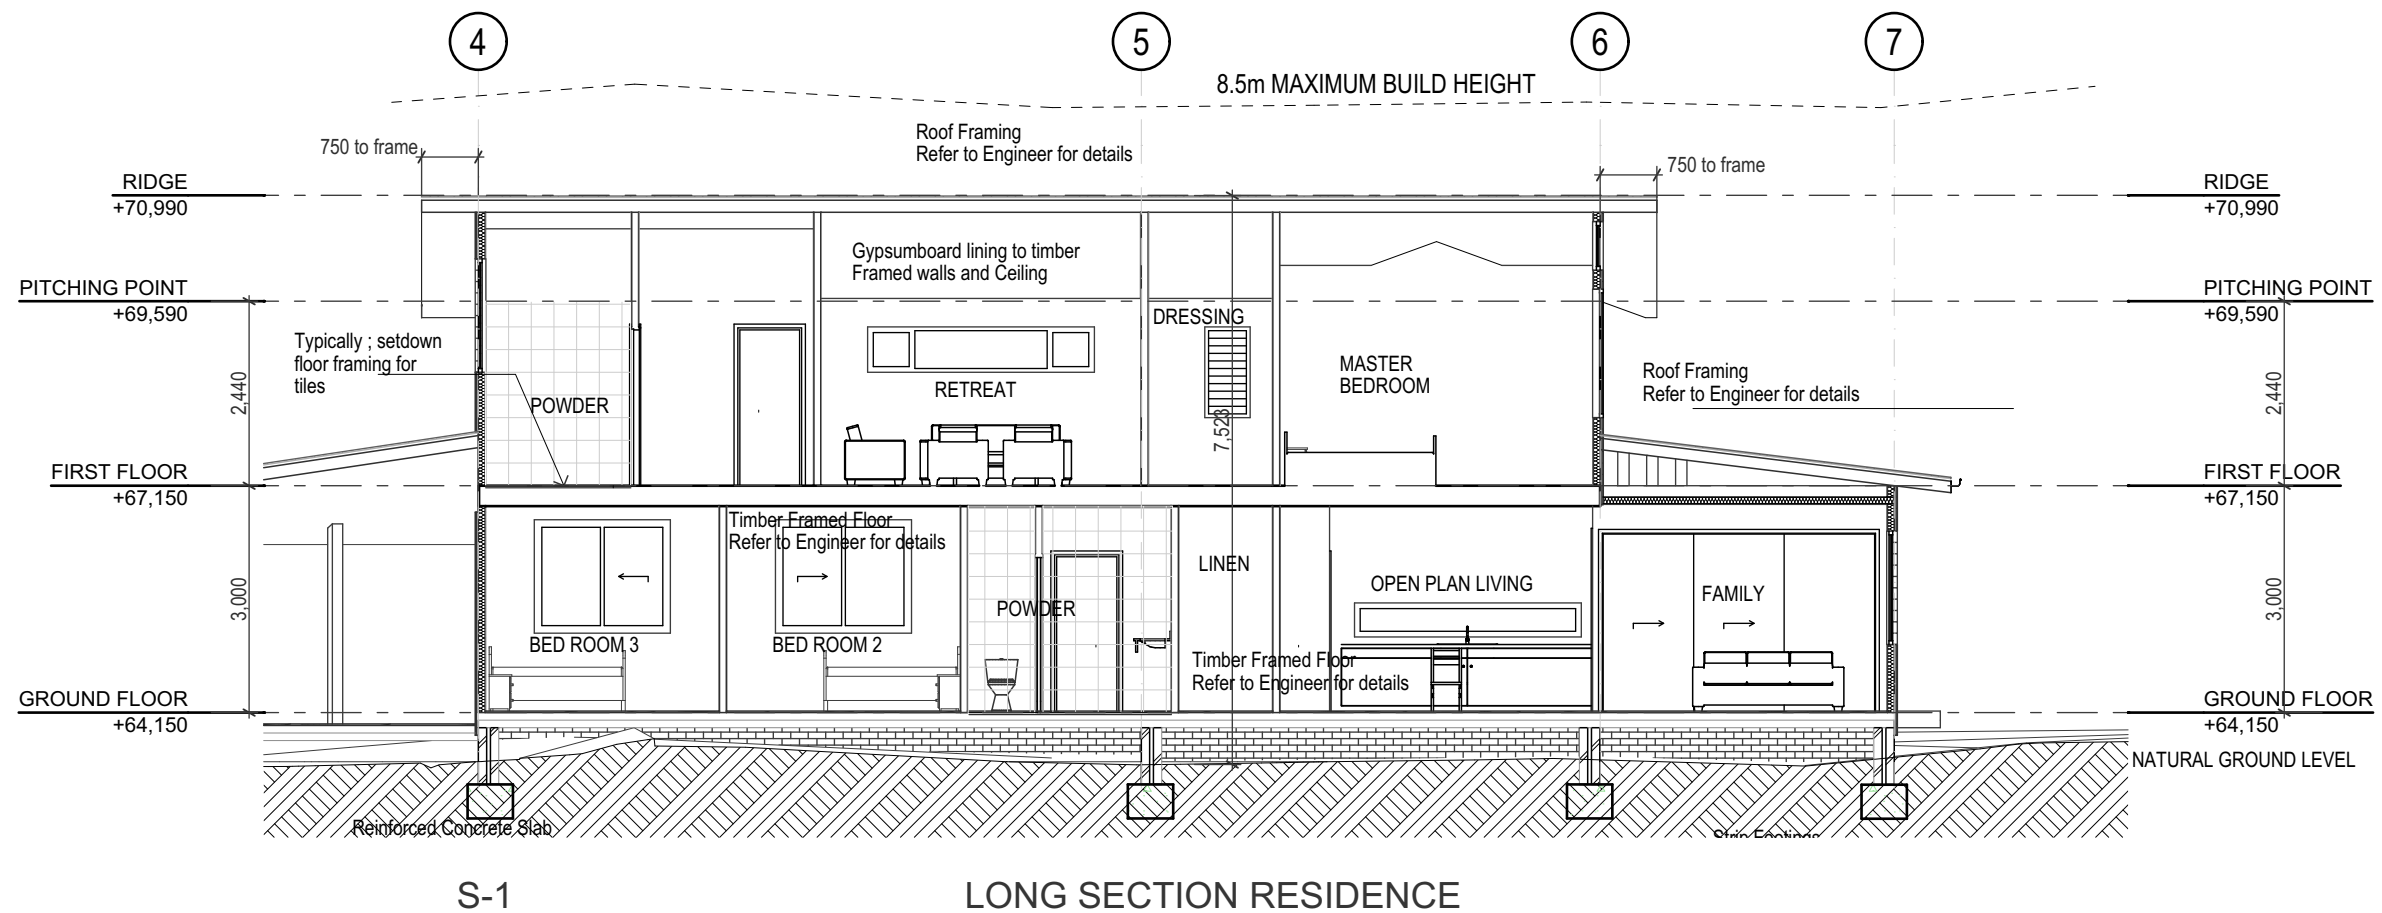
GENERAL
WINDOWS AND DOORS - All windows to be Powder Coated Aluminium with fly screens.
Front door to be Solid Core Timber '920mm x 40mm' Feature door with Timber Framed Side light.
Garage Doors; Automatic Panel lift.
All other external doors to be Powder Coated Aluminium.
EXTERNAL CLADDINGS - Brickwork to sub floor as selected by Owner. Scyon Linea 150mm Board.
BALUSTRADES - Glass
ROOFING - Lysaght colorbond "Custom Orb".



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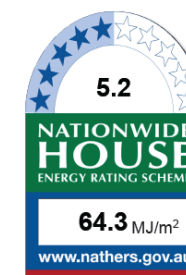
DA2020/0941

Survey Details
CMS Surveyors Pty Limited
South Creek Road, Dee Why.
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**THIS PLAN IS TO BE READ IN
CONJUNCTION WITH
THE CONDITIONS OF DEVELOPMENT
CONSENT**

DA2020/0941



Certificate no.: 0004943734
 Assessor Name: Tracey Cools
 Accreditation no.: HERA10033
 Certificate date: 21 Jun 2020
 Dwelling Address: 4B Cambridge Avenue
 Narrabeena, NSW 2099

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Survey Details provided by
 CMS Surveyors Pty Limited
 South Creek Road, Dee Why.
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BDAA Accreditation number 6255
 ABN 17 751 732 195
SALLY GARDNER DESIGN AND DRAFT
 PLANS DRAWN FOR APPROVAL



SDS
 Sustainability Design Specialist



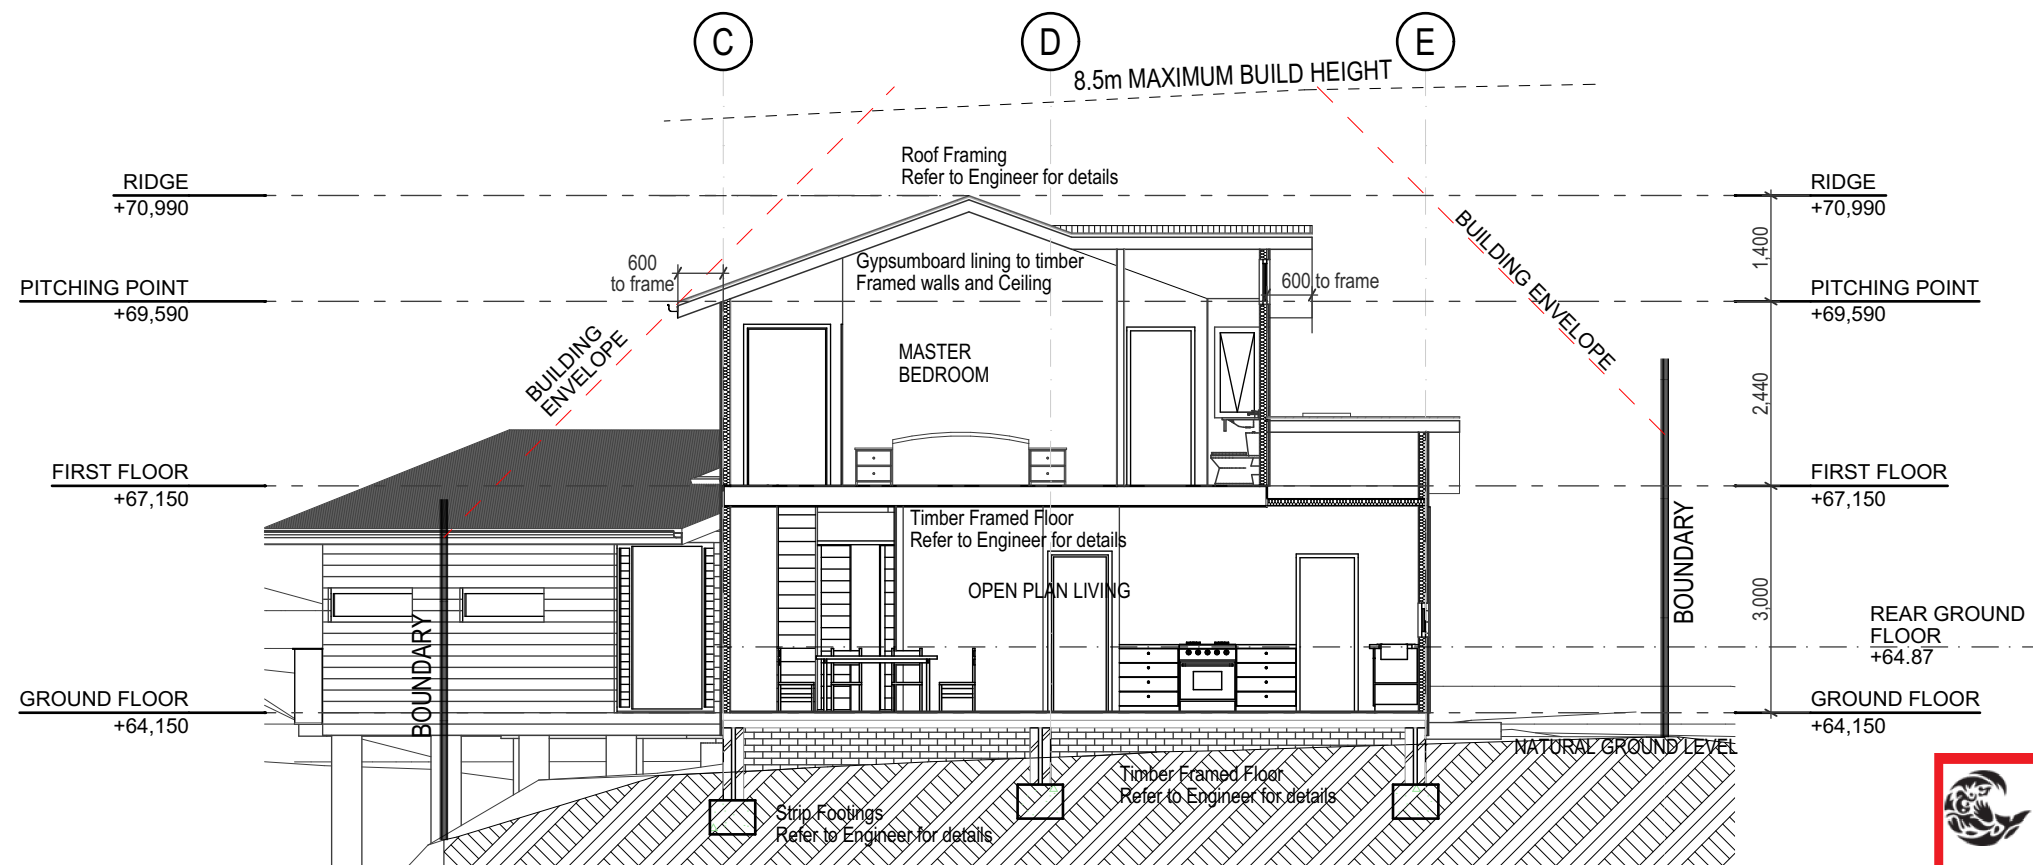
Client
RFM CONSTRUCTIONS PTY LTD

NEW RESIDENCE
4B CAMBRIDGE AVE NARRABEENA NSW 2099

SECTIONS SHEET 1

Scale **1:100**
 Date **Monday, 22 June 2020**

Job Number **19-0201**
 Drawn **S.G.**
 Drawing No. **A7**

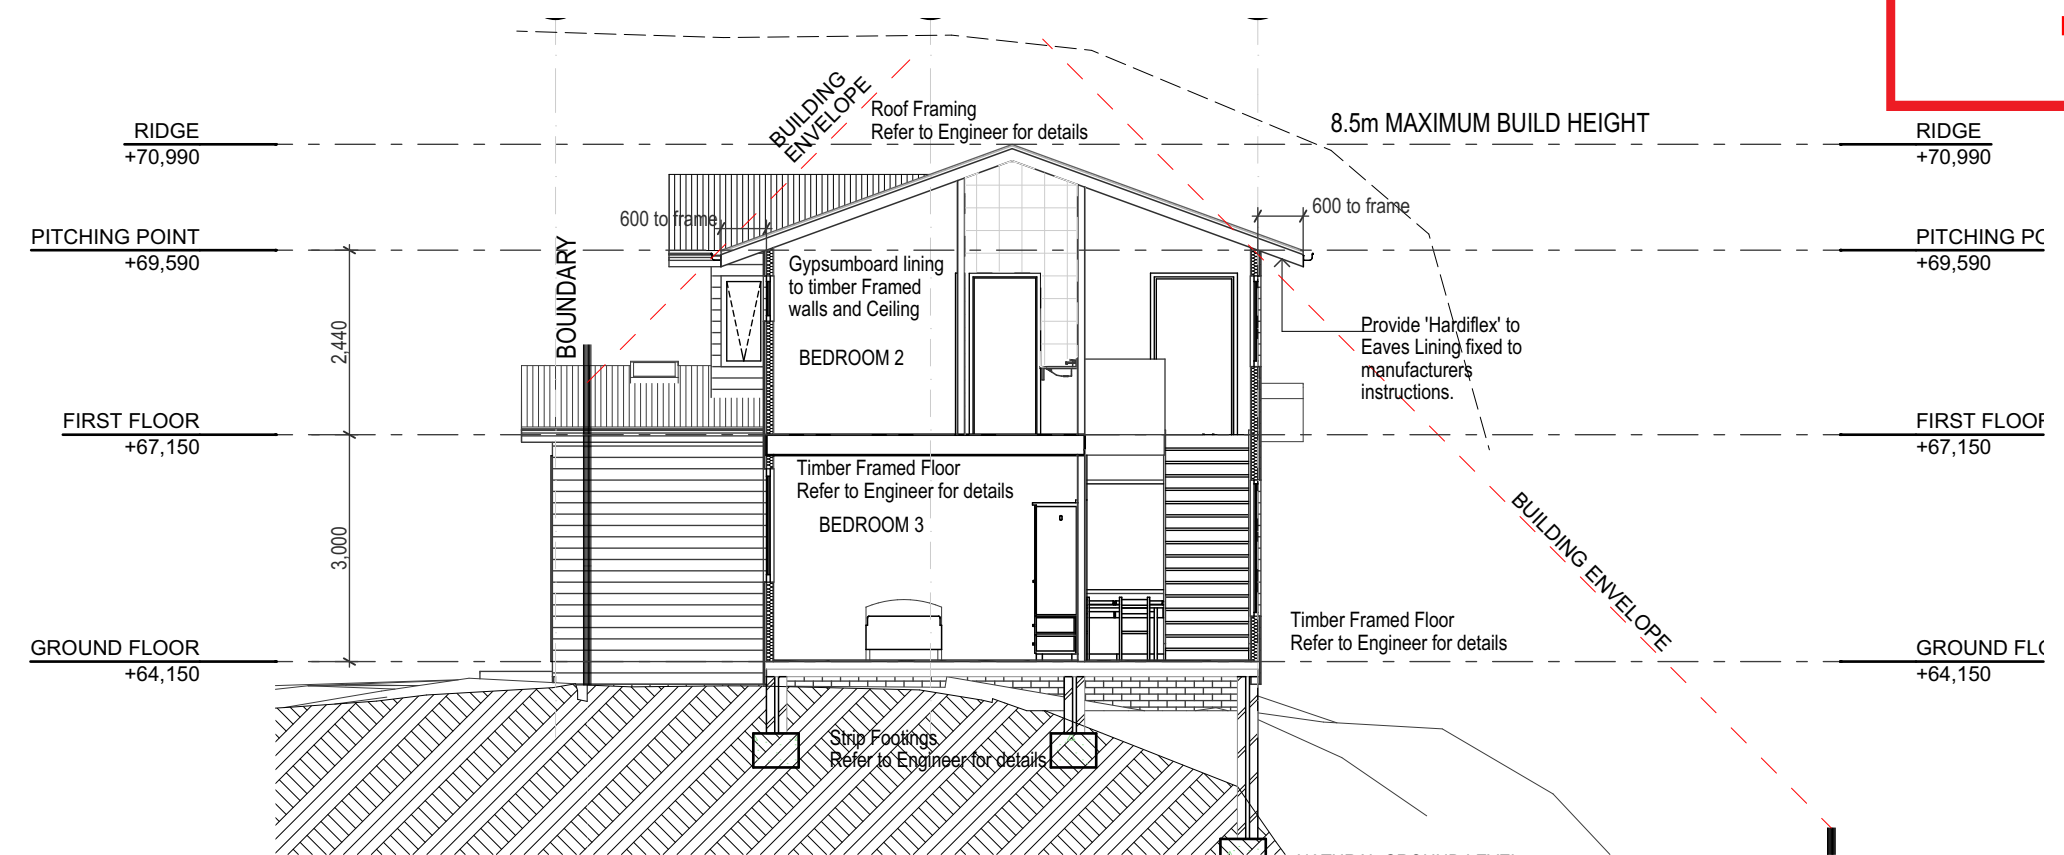


S-3

CROSS SECTION

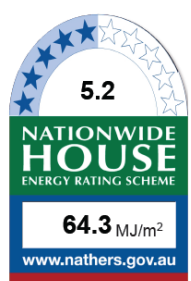
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DA2020/0941



S-4

CROSS SECTION WEST



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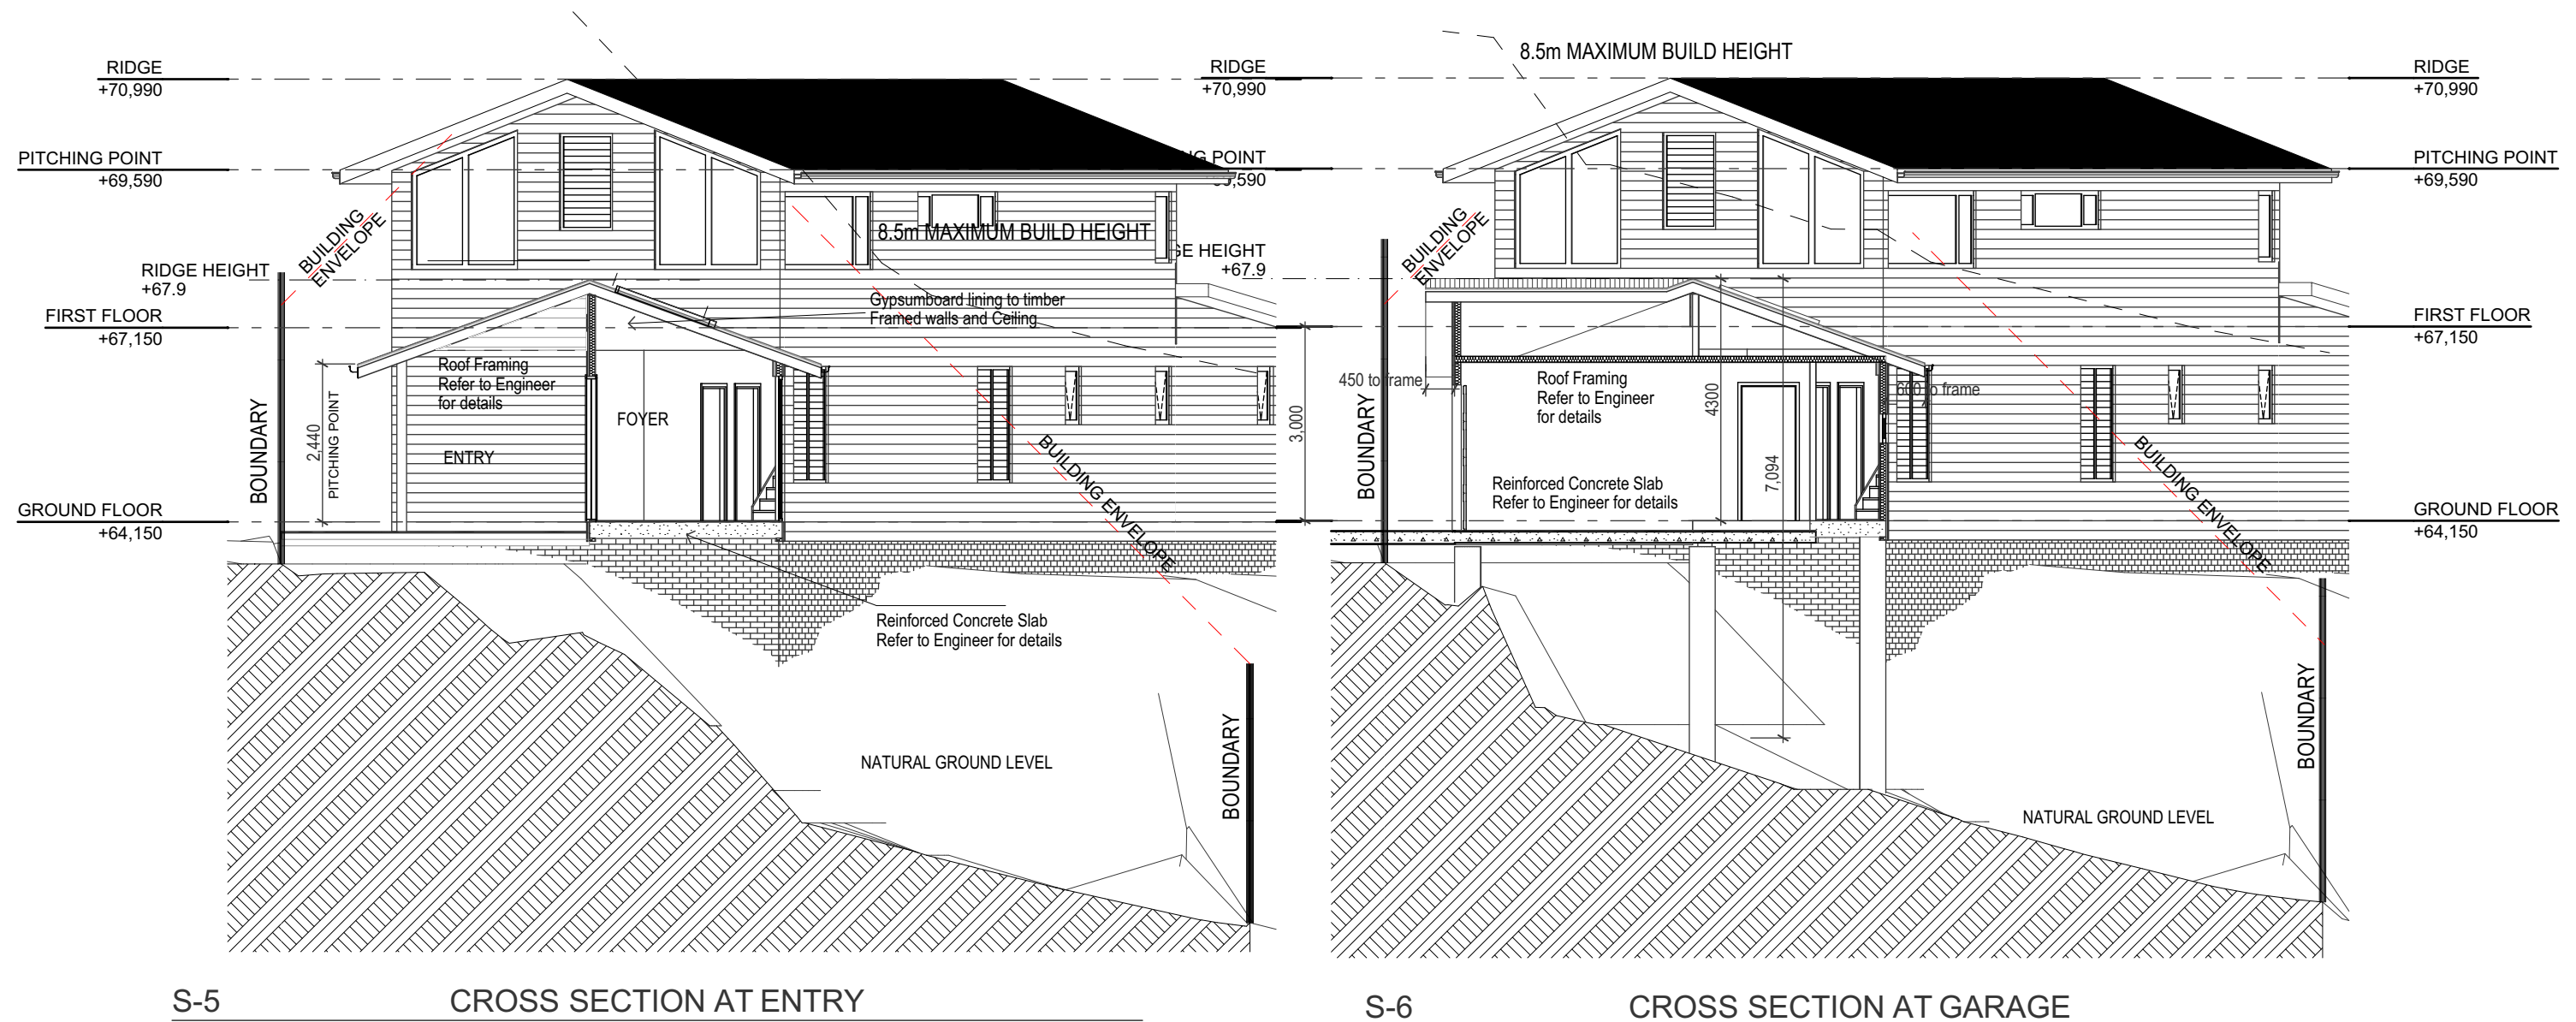
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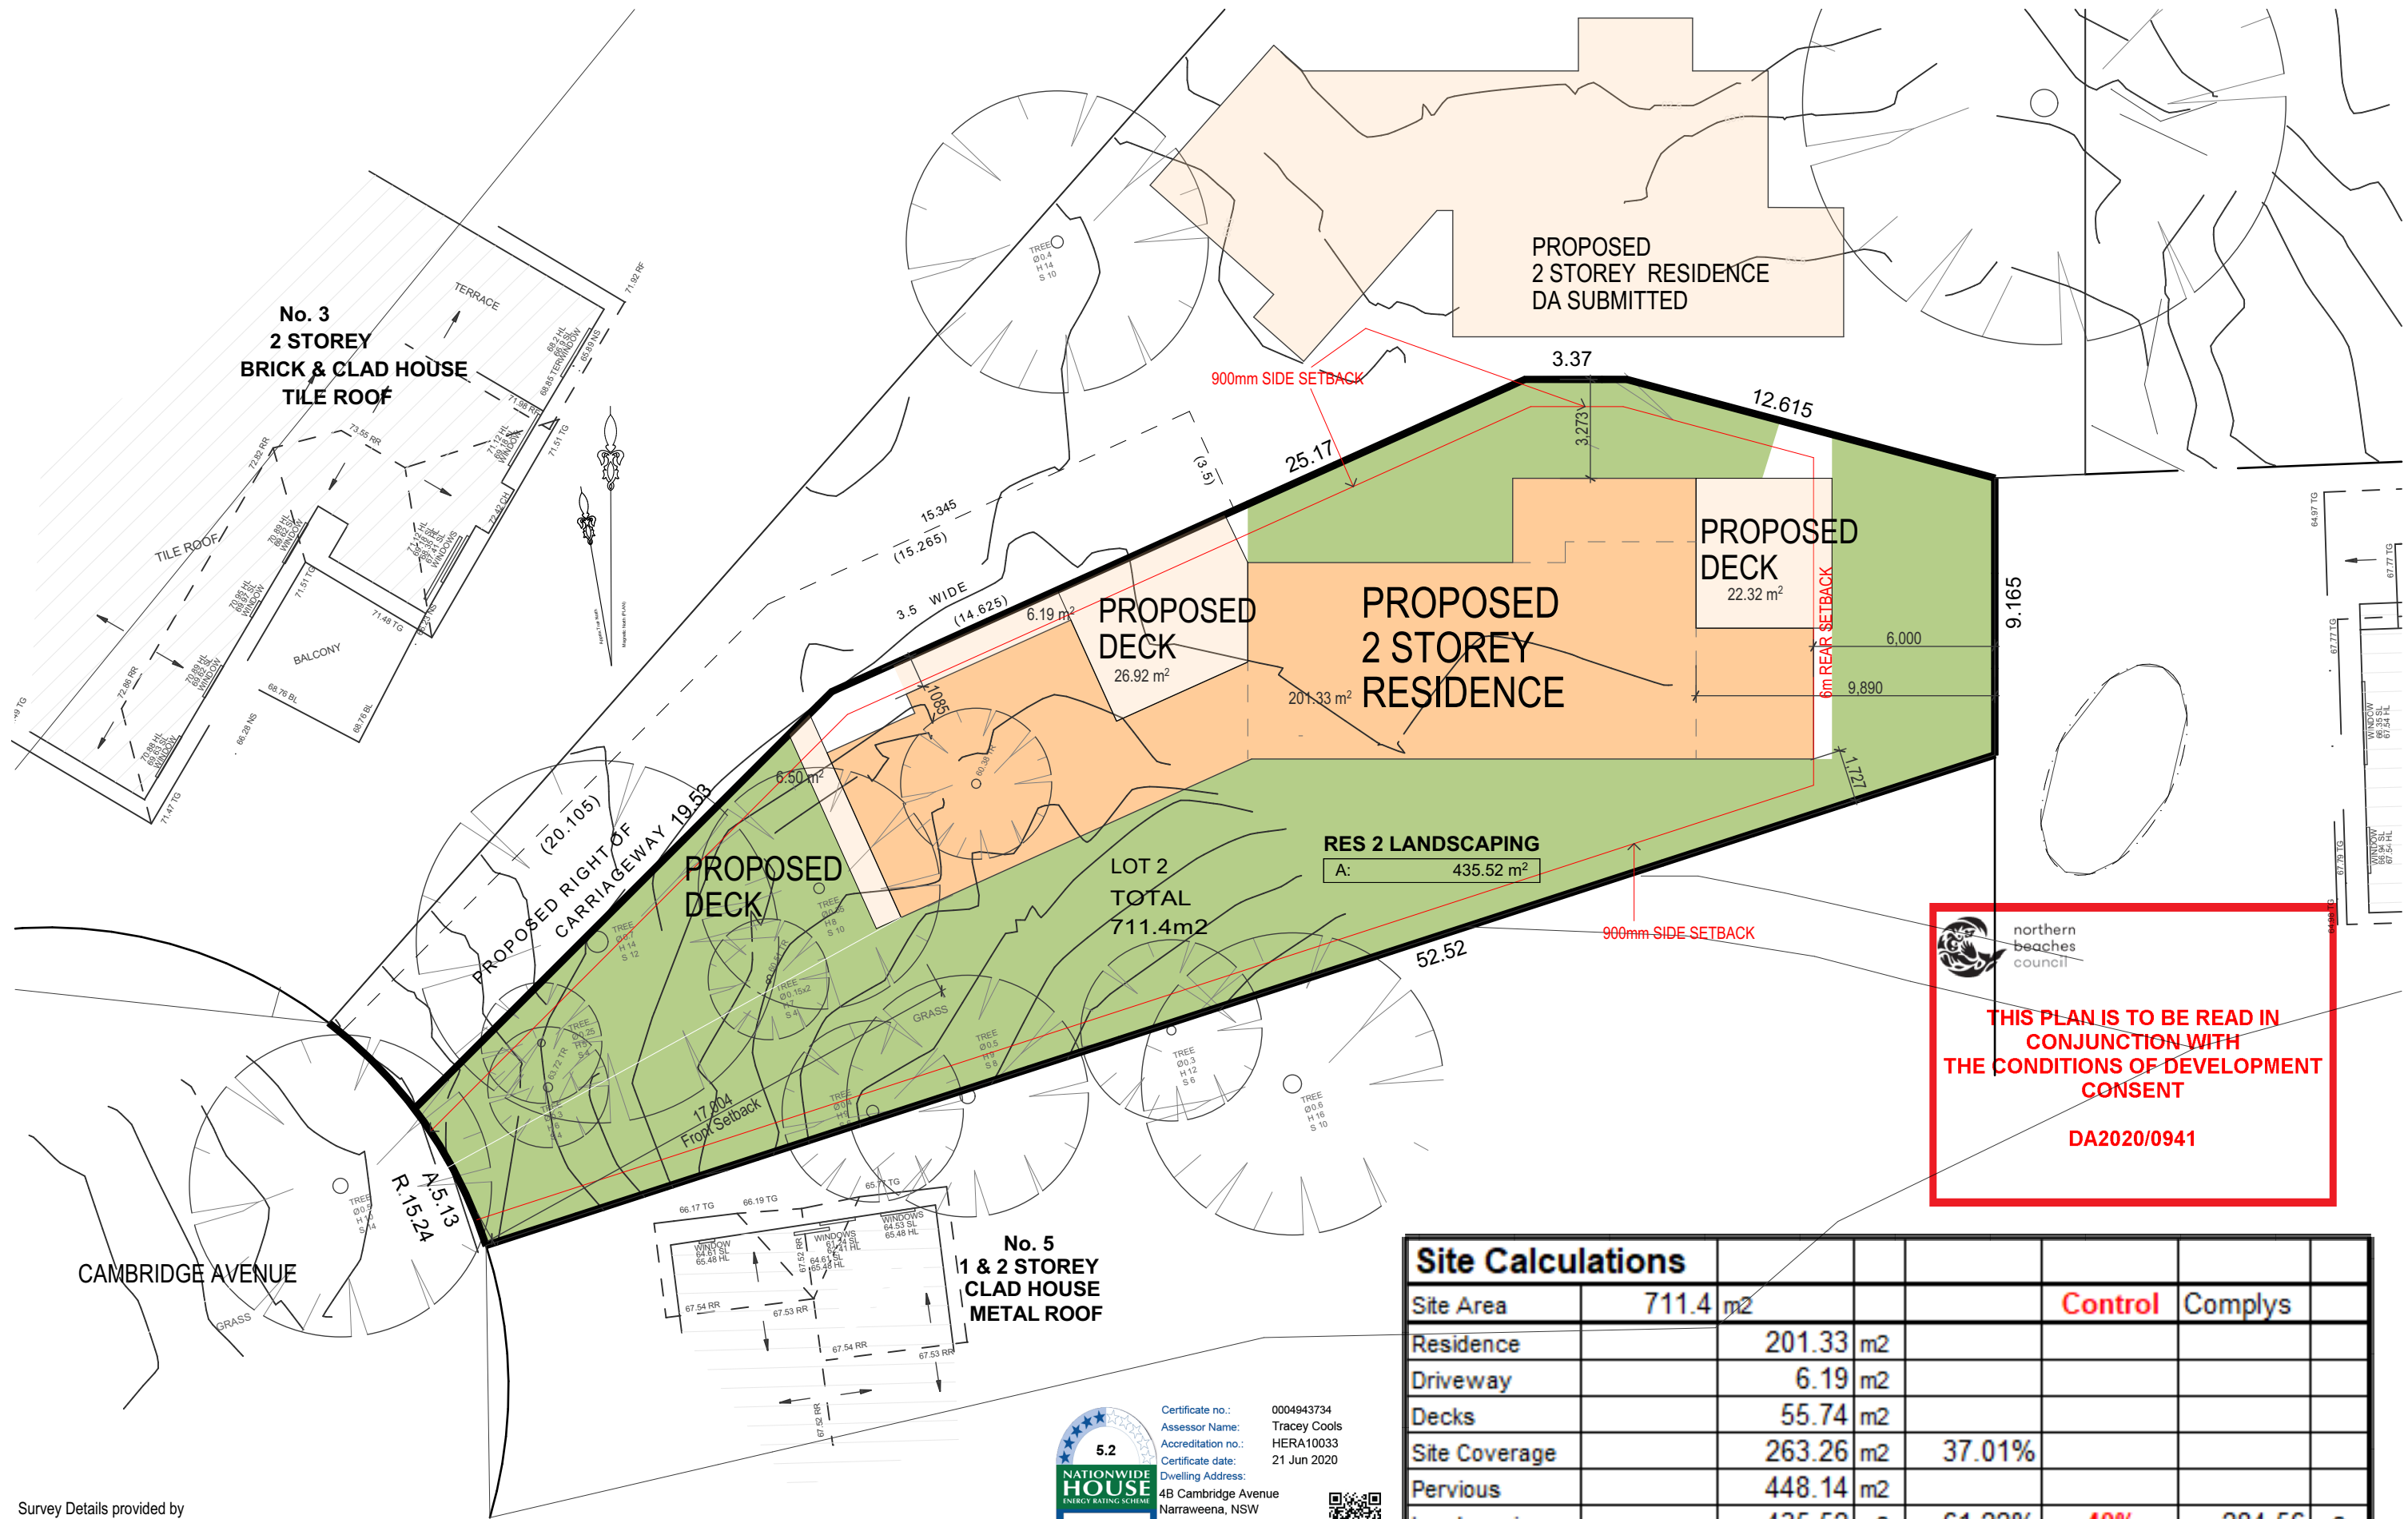
Client
RFM CONSTRUCTIONS PTY LTD

Drawing Title
**NEW RESIDENCE
 4B CAMBRIDGE AVE NARRABEENA NSW 2099**
SECTIONS SHEET 2

Scale 1:100	Job Number 19-0201
Date Monday, 22 June 2020	Drawn S.G.
	Drawing No. A8



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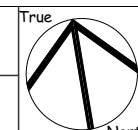


SustainAbility Design™ Specialist



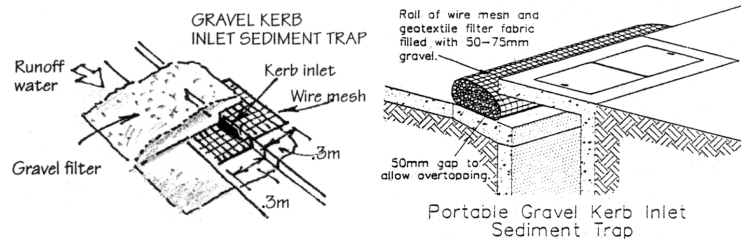
Client **RFM CONSTRUCTIONS PTY LTD**

NEW RESIDENCE
48 CAMBRIDGE AVE NARRAWEENA NSW 2099
Drawing Title **SITE PLAN AND CALCULATIONS**



Scale **1:200**
Date **Monday, 22 June 2020**

Job Number **19-0201**
Drawn **S.G.**
Drawing No. **S1**



GUTTER PROTECTION

Provide protection to down hill Grate in Gutter by means of Sand bags or blue metal wrapped in geotextile fabric. When soil or sand builds up around this sediment barrier, the material should be relocated to the site for disposal.

SITE ACCESS

Vehicular access to the site must be via a single entry point that is stabilised to prevent the tracking of sediment onto the roads and footpath. Soil, earth, mud, clay, concrete washing, paint or similar materials must be removed from the roadway, by means other than washing, on a daily basis.

ON-GOING WASTE MANAGEMENT

Residents to manage waste on a daily basis - by separating materials into re-usables, recyclables, waste and garden organics for inclusion in appropriate disposal bins. Bins to be placed kerbside on specified days for collection by council.

ON-SITE PRACTICES

All trenches must be filled immediately after services are laid. Excess materials such as cement, water from tool cleaning, paintbrushes and brick and concrete slurry, must not be washed into stormwater system. It is against the law to pollute waters with any solid, liquid or gas. Where possible construct a depression or earth dam below brick, concrete or tile cutting. If this is not possible, pass water through a filter.

SEDIMENT NOTE:

1. All Erosion and Sediment Control measures to be inspected and maintained daily, by the site manager.
2. Minimise disturbed areas, remove excess soil from excavation area as soon as possible.
3. All material stockpile to be clear from drains, gutters and footpaths, or within sediment fence.
4. Drainage to be connected to Stormwater as soon as possible. If stored on site, it must be filtered before releasing into the stormwater system or waterways.
5. Roads and footpaths to be swept daily.

BUILDING WASTE DISPOSAL

All waste materials are to be sorted and transported to the local authorized waste management centre for potential re-use or recycling. Garden waste to be delivered to an authorized Recycling centre for chipping for reuse as mulch. Any Asbestos materials located on the site during the demolition process is to be properly disposed of in accordance with the guidelines of the relevant regulatory authority. Every attempt will be made to keep waste to a minimum.

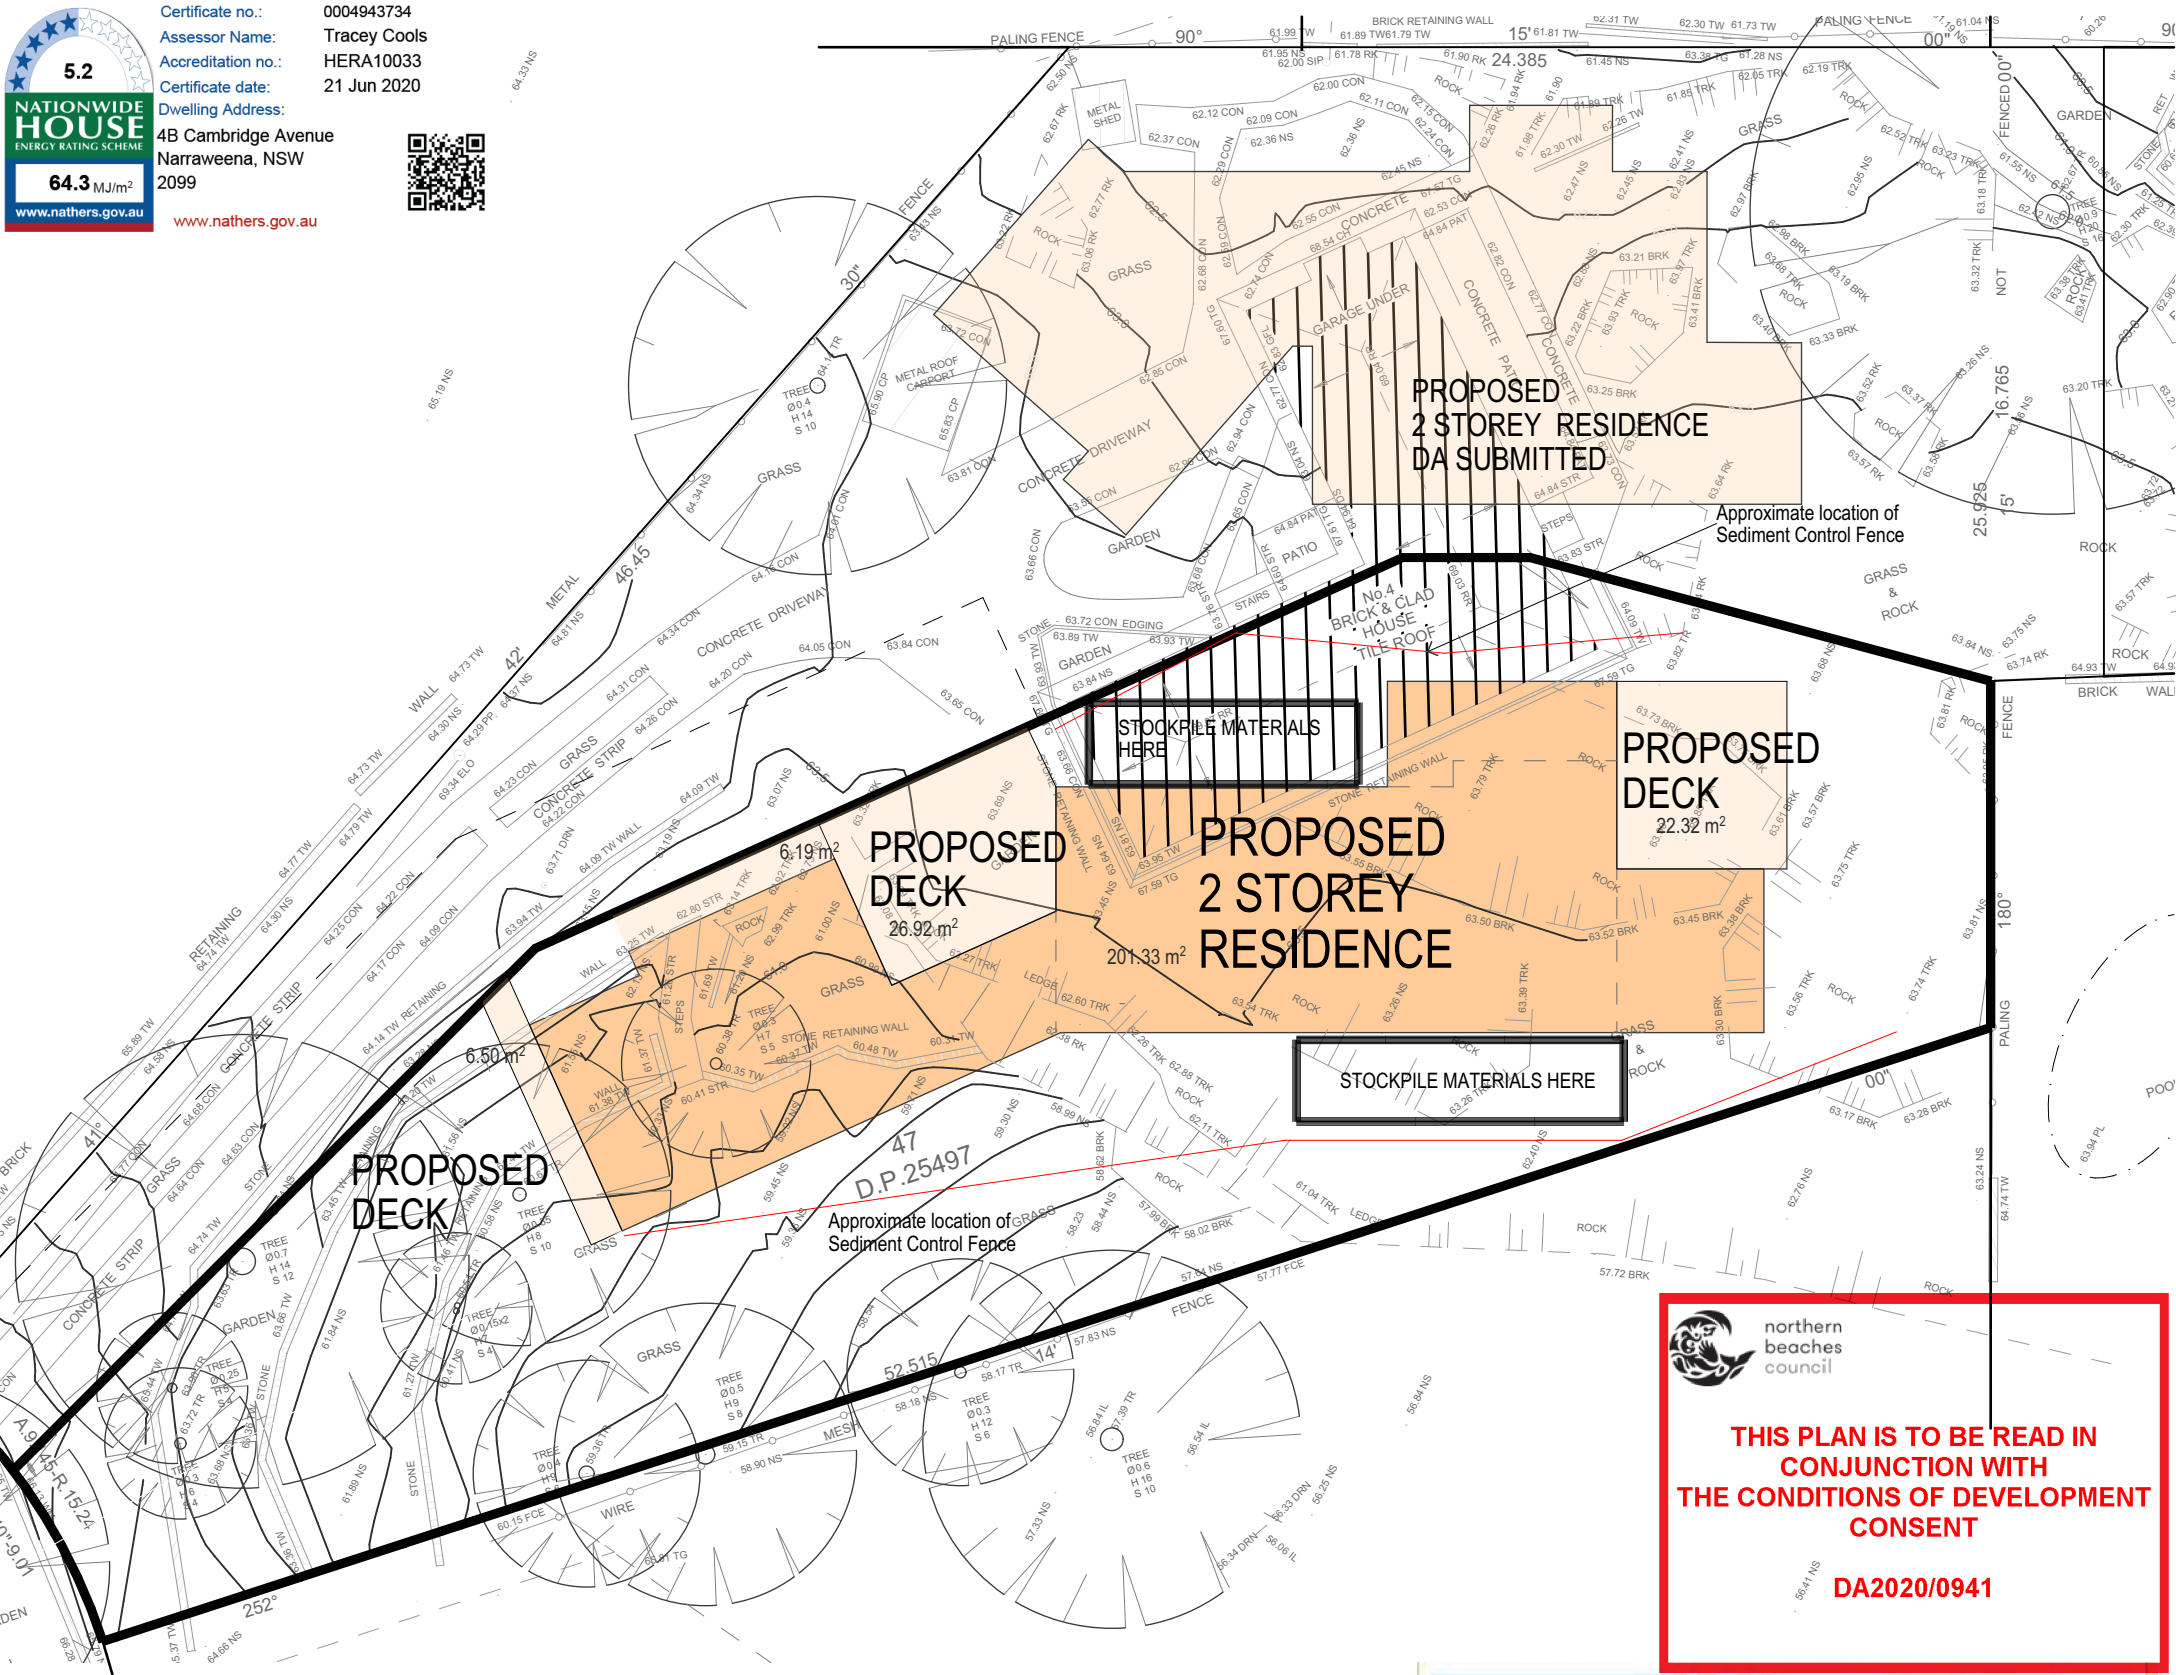
STOCK PILES

All stockpiles are to be kept on-site where possible. Any materials placed on the footpaths or nature strips require council's permission. All stockpiles are to be placed away from the drainage lines and street gutters. It is best to locate these on the highest part of the site if possible. Place waterproof covering over stockpiles. If required provide diversion drain & bank around stockpiles.

DUST CONTROL

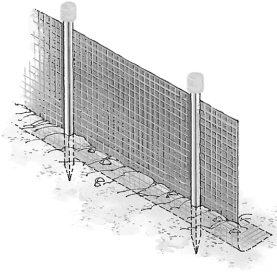
To reduce dust generated by wind action, the removal of the top soil is to be minimised. To prevent dust generation, watering down of the site, especially during the movement of machinery is required. Where excavating into rock, keep the surface moist to minimise dust. Construct a gravel entry/exit point using blue metal and restrict all vehicle movements within the site to a minimum. Ensure wind breaks, such as existing fences are maintained during the construction phase until new landscaping is provided or reinstated. Prevent dust by covering stockpiles.

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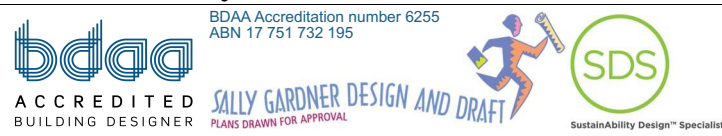


SEDIMENT CONTROL FENCE

- 1 Excavate a trench a minimum of 200mm wide and 200mm deep on the uphill side of the proposed line of silt fence.
- 2 Drive adequate length support posts to a depth (minimum 400mm) appropriate for the site conditions downhill of the trench.
A. Post spacing is typically at 2m centres with wire attached along the top between posts to assist with support of the silt fence.
B. Post spacing can be increased up to 4m centres if supported by 2.5mm diameter high tensile wire at mid height and along the top with hog rings, clips or pins every 150mm connecting the silt fence along the top wire.
- 3 Roll out silt fence and position up against the support posts and fold over top wire. Hog rings, clips or pins are used to attach the silt fence to the top wire (at the required spacing).
- 4 Bury bottom section along the base and up the side of the trench leaving a minimum exposed height of 600mm and backfill with soil. Compact to ensure good anchorage. Place safety caps on posts.

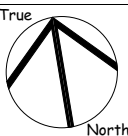


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NEW RESIDENCE
4B CAMBRIDGE AVE NARRAWEENA NSW 2099
Drawing Title
SITE MANAGEMENT, Sediment and Erosion Control



True Scale 1:200	Job Number 19-0201
Date Monday, 22 June 2020	Drawn S.G.
	Drawing No. S2