
NUMBER.	NAME.	REV.
A000 GENI	ERAL	
A001	COVER	В
A002	BASIX COMMITMENTS	В
A100 SITE		
A101	SITE - CONTEXT PLAN	В
A200 GENI	ERAL ARRANGEMENT PLANS	
A200 GENI	PLAN - EXISTING	В
A201	PLAN - DEMOLITION	В
A210	PLAN - PROPOSOSED GROUND FLOOR	B
A211	PLAN - PROPOSOSED FIRST FLOOR	В
A212	PLAN - PROPOSOSED ROOF	В
4300 GENI	ERAL ARRANGEMENT ELEVATIONS	
A300 GENI	ELEVATIONS - NORTH & EAST	В
A302	ELEVATIONS - SOUTH & WEST	В
A400 GENI	ERAL ARRANGEMENT SECTIONS	
A401	SECTIONS - PROPOSED	В
A402	SECTIONS - PROPOSED	A
A500 GENI	ERAL INFORMATION	
A501	MATERIAL PALETTE	В
A502	SHADOW DIAGRAMS	В
A503	PLAN - PROPOSED LANDSCAPE	В

DRAWING SYMBOLS

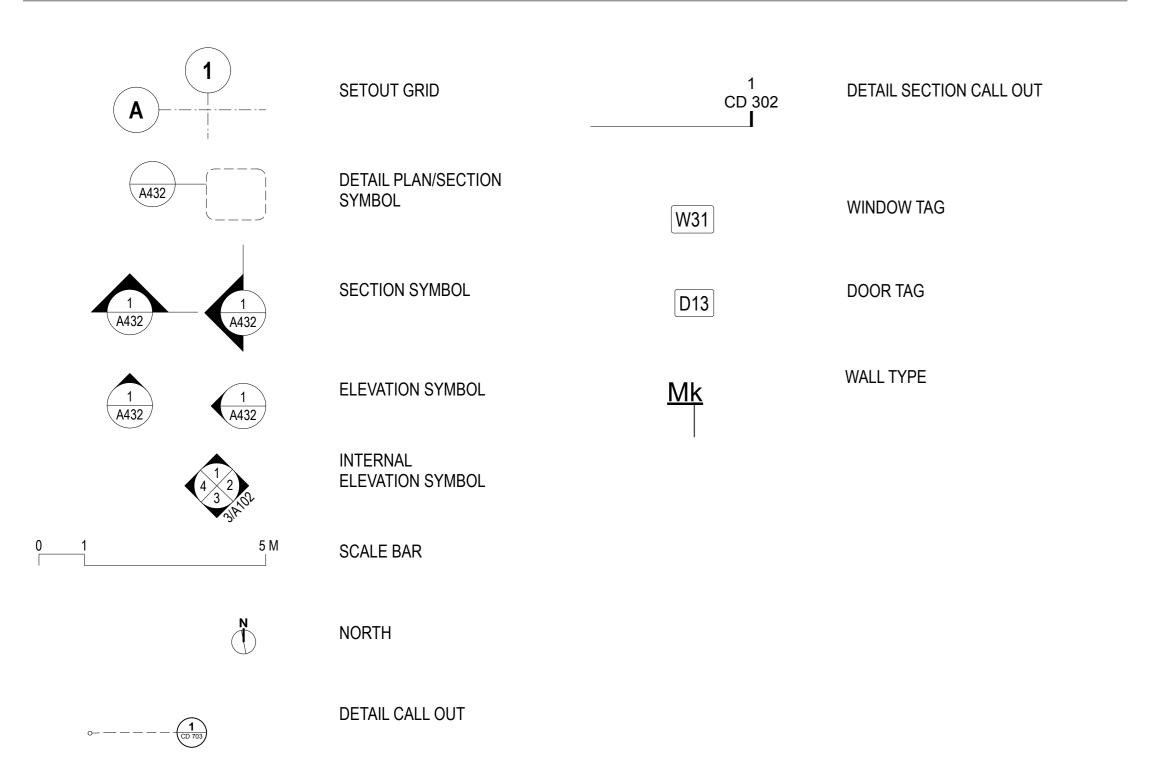

SCALE BAR



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SW 2095 8774

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REV	DATE	DESCRIPTION
Α	9/5/2025	Preliminary DA
В	10/7/2025	DA Submission

OUTNE		777.5					
CLIENT		TITLE					
Robyn Storer		COVER PAGE					
PROJECT	PROJECT ADRESS	DWG NO.	PROJECT NO.	SCALE @ A1	DRAWN	CHECKED	REV.
Manly Vale	44 Campbell Parade, Manly Vale	A001	2403	1:1	MB	TB	В

Schedule of BASIX commitments

Thermal Performance and Materials commitments

aluminium timber uPVC

composite

double

The applicant must install windows, glazed doors and skylights as described in the table below, in accordance with the specifications

The commitments set out below regulate how the proposed development is to be carried out. It is a condition of any development consent granted, or complying development certificate issued, for the proposed development, that BASIX commitments be complied with.

Water Commitments	Show on DA plans	Show on CC/CDC plans & specs	Certifier check
Landscape			
The applicant must plant indigenous or low water use species of vegetation throughout 152 square metres of the site.	~	~	
Fixtures			
The applicant must install showerheads with a minimum rating of 4 star (> 6 but <= 7.5 L/min plus spray force and/or coverage tests) in all showers in the development.		~	~
The applicant must install a toilet flushing system with a minimum rating of 4 star in each toilet in the development.		~	~
The applicant must install taps with a minimum rating of 4 star in the kitchen in the development.		~	
The applicant must install basin taps with a minimum rating of 4 star in each bathroom in the development.		~	
Alternative water			
Rainwater tank			
The applicant must install a rainwater tank of at least 3000 litres on the site. This rainwater tank must meet, and be installed in accordance with, the requirements of all applicable regulatory authorities.	~	~	~
The applicant must configure the rainwater tank to collect rain runoff from at least 80 square metres of the roof area of the development (excluding the area of the roof which drains to any stormwater tank or private dam).		~	~
The applicant must connect the rainwater tank to:			
the cold water tap that supplies each clothes washer in the development		•	~
 at least one outdoor tap in the development (Note: NSW Health does not recommend that rainwater be used for human consumption in areas with potable water supply.) 		✓	~

Water Commitments	Show on DA plans	Show on CC/CDC plans & specs	Certifier check
Swimming Pool			
The swimming pool must not have a volume greater than 36 kilolitres.	~	~	
The swimming pool must be outdoors.	~	~	

Maximum area - m2

Maximum area - m2

82.6

82.6

Thermal Performance and Materials commitments	Show on DA plans	Show on CC/CDC plans & specs	Certifier check
Simulation Method			
Assessor details and thermal loads			
The applicant must attach the certificate referred to under "Assessor Details" on the front page of this BASIX certificate (the "Assessor Certificate") to the development application and construction certificate application for the proposed development (or, if the applicant is applying for a complying development certificate for the proposed development, to that application). The applicant must also attach the Assessor Certificate to the application for an occupation certificate for the proposed development.			
The Assessor Certificate must have been issued by an Accredited Assessor in accordance with the Thermal Comfort Protocol.			
The details of the proposed development on the Assessor Certificate must be consistent with the details shown in this BASIX certificate, including the Cooling and Heating loads shown on the front page of this certificate and the "Construction" and "Glazing" tables below.			
The applicant must show on the plans accompanying the development application for the proposed development, all matters which the Assessor Certificate requires to be shown on those plans. Those plans must bear a stamp of endorsement from the Accredited Assessor to certify that this is the case. The applicant must show on the plans accompanying the application for a construction certificate (or complying development certificate, if applicable), all thermal performance specifications set out in the Assessor Certificate, and all aspects of the proposed development which were used to calculate those specifications.	~	~	~
The applicant must construct the development in accordance with all thermal performance specifications set out in the Assessor Certificate, and in accordance with those aspects of the development application or application for a complying development certificate which were used to calculate those specifications.		~	~
The applicant must show on the plans accompanying the development application for the proposed development, the locations of ceiling fans set out in the Assessor Certificate. The applicant must show on the plans accompanying the application for a construction certificate (or complying development certificate, if applicable), the locations of ceiling fans set out in the Assessor Certificate.	~	~	~

	_		
Energy Commitments	Show on DA plans	Show on CC/CDC plans & specs	Certifier check
Hot water			
The applicant must install the following hot water system in the development, or a system with a higher energy rating: electric heat pump with a performance of 26 to 30 STCs or better.	~	~	-
Cooling system			
The applicant must install the following cooling system, or a system with a higher energy rating, in at least 1 living area: 3-phase airconditioning; Energy rating: EER 3.0 - 3.5		~	~
The applicant must install the following cooling system, or a system with a higher energy rating, in at least 1 bedroom: 3-phase airconditioning; Energy rating: EER 3.0 - 3.5		~	~
Heating system			
The applicant must install the following heating system, or a system with a higher energy rating, in at least 1 living area: 3-phase airconditioning; Energy rating: EER 3.5 - 4.0		~	~
The applicant must install the following heating system, or a system with a higher energy rating, in at least 1 bedroom: 3-phase airconditioning; Energy rating: EER 3.5 - 4.0		~	~
Ventilation			
The applicant must install the following exhaust systems in the development:			
At least 1 Bathroom: individual fan, ducted to façade or roof; Operation control: manual switch on/off		-	-
Kitchen: individual fan, ducted to façade or roof; Operation control: manual switch on/off		~	~
Laundry: individual fan, ducted to façade or roof; Operation control: manual switch on/off		~	-
Auddinial Bulkduru		,	
Artificial lighting			

Thermal Performance and Materials commitments	Show on DA plans	Show on CC/CDC plans & specs	Certifier check
Construction			
The applicant must construct the floors, walls, roofs, ceilings and glazing of the dwelling in accordance with the specifications listed in the tables below.	~	~	~
The applicant must show through receipts that the materials purchased for construction are consistent with the specifications listed in the tables below.			-

Area - m ² 132.3 111.88	Insulation none
	none
111 00	
111.00	none
6.48	none
16.74	none
170.2	fibreglass batts or roll
9.5	fibreglass batts or roll
27.96	fibreglass batts or roll
208.6	none
17.6	none
155	ceiling: fibreglass batts or roll; roof: foil backed blanket.
1 2 2	6.74 70.2 .5 7.96 08.6

Energy Commitments	Show on DA plans	Show on CC/CDC plans & specs	Certifier check	
The applicant must install a window and/or skylight in 3 bathroom(s)/toilet(s) in the development for natural lighting.	~	~	~	
Swimming pool			•	
The applicant must install the following heating system for the swimming pool in the development (or alternatively must not install any heating system for the swimming pool): electric heat pump		~		
The applicant must install the following pump for the swimming pool in the development, or a pump with a higher energy rating: dual speed with a performance of 2 stars.		~		
The applicant must install a timer for the swimming pool pump in the development.		~		
Alternative energy				
The applicant must install a photovoltaic system as part of the development. The applicant must connect this system to the development's electrical system.	~	~	~	
The photovolatic system must consist of:				
 photovolatic collectors with the capacity to generate at least 2.8 peak kilowatts of electricity, installed at an angle between 0 degrees and 10 degrees to the horizontal facing north west 	-	-	-	
Other				
The applicant must install an induction cooktop & electric oven in the kitchen of the dwelling.		~		
The applicant must install a fixed outdoor clothes drying line as part of the development.		~		
The applicant must install a fixed indoor or sheltered clothes drying line as part of the development.				

Show on Show on CC/CDC Certifier Check

The applicant must install a window and/or skylight in the kitchen of the dwelling for natural lighting.

diode (LED) lamps.

Natural lighting

Manly Vale

2403

PROJECT NO.

SCALE @ A1

1:1

DWG NO.


A002





SITE PLAN - CONTEXT
Scale : 1:1000 @ A1

SITE PLAN - EXISTING
Scale : 1:250 @ A1

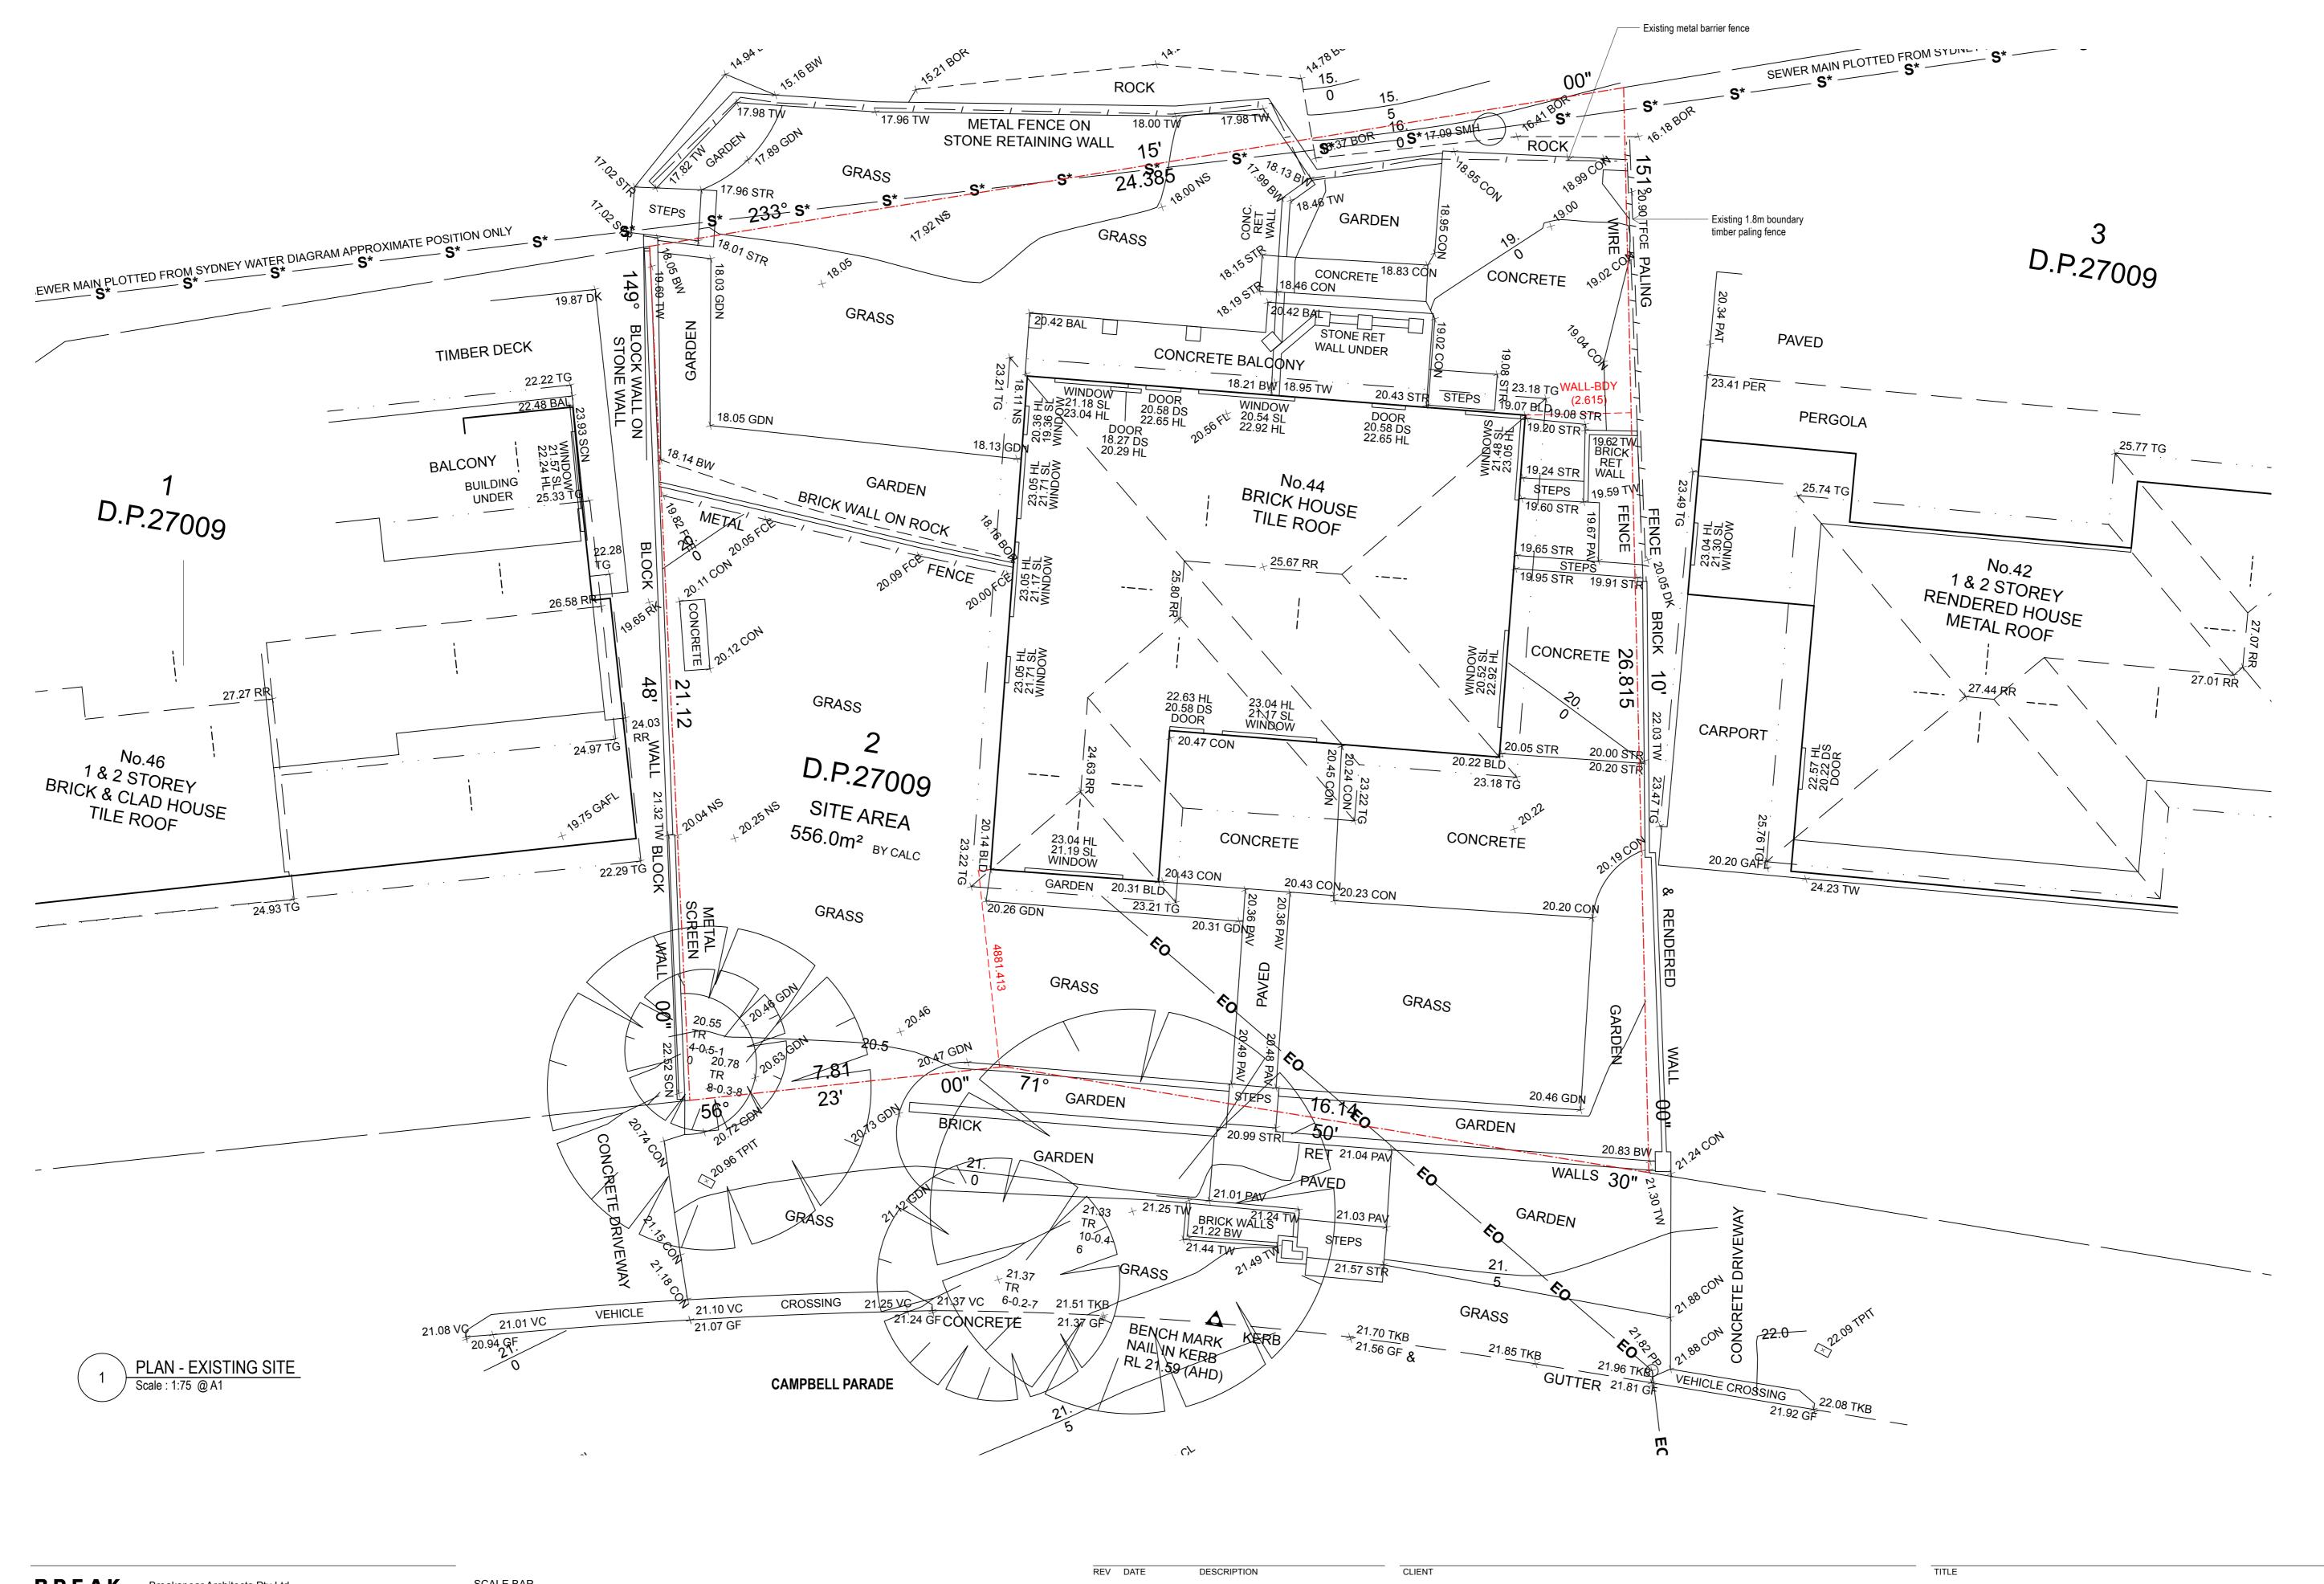

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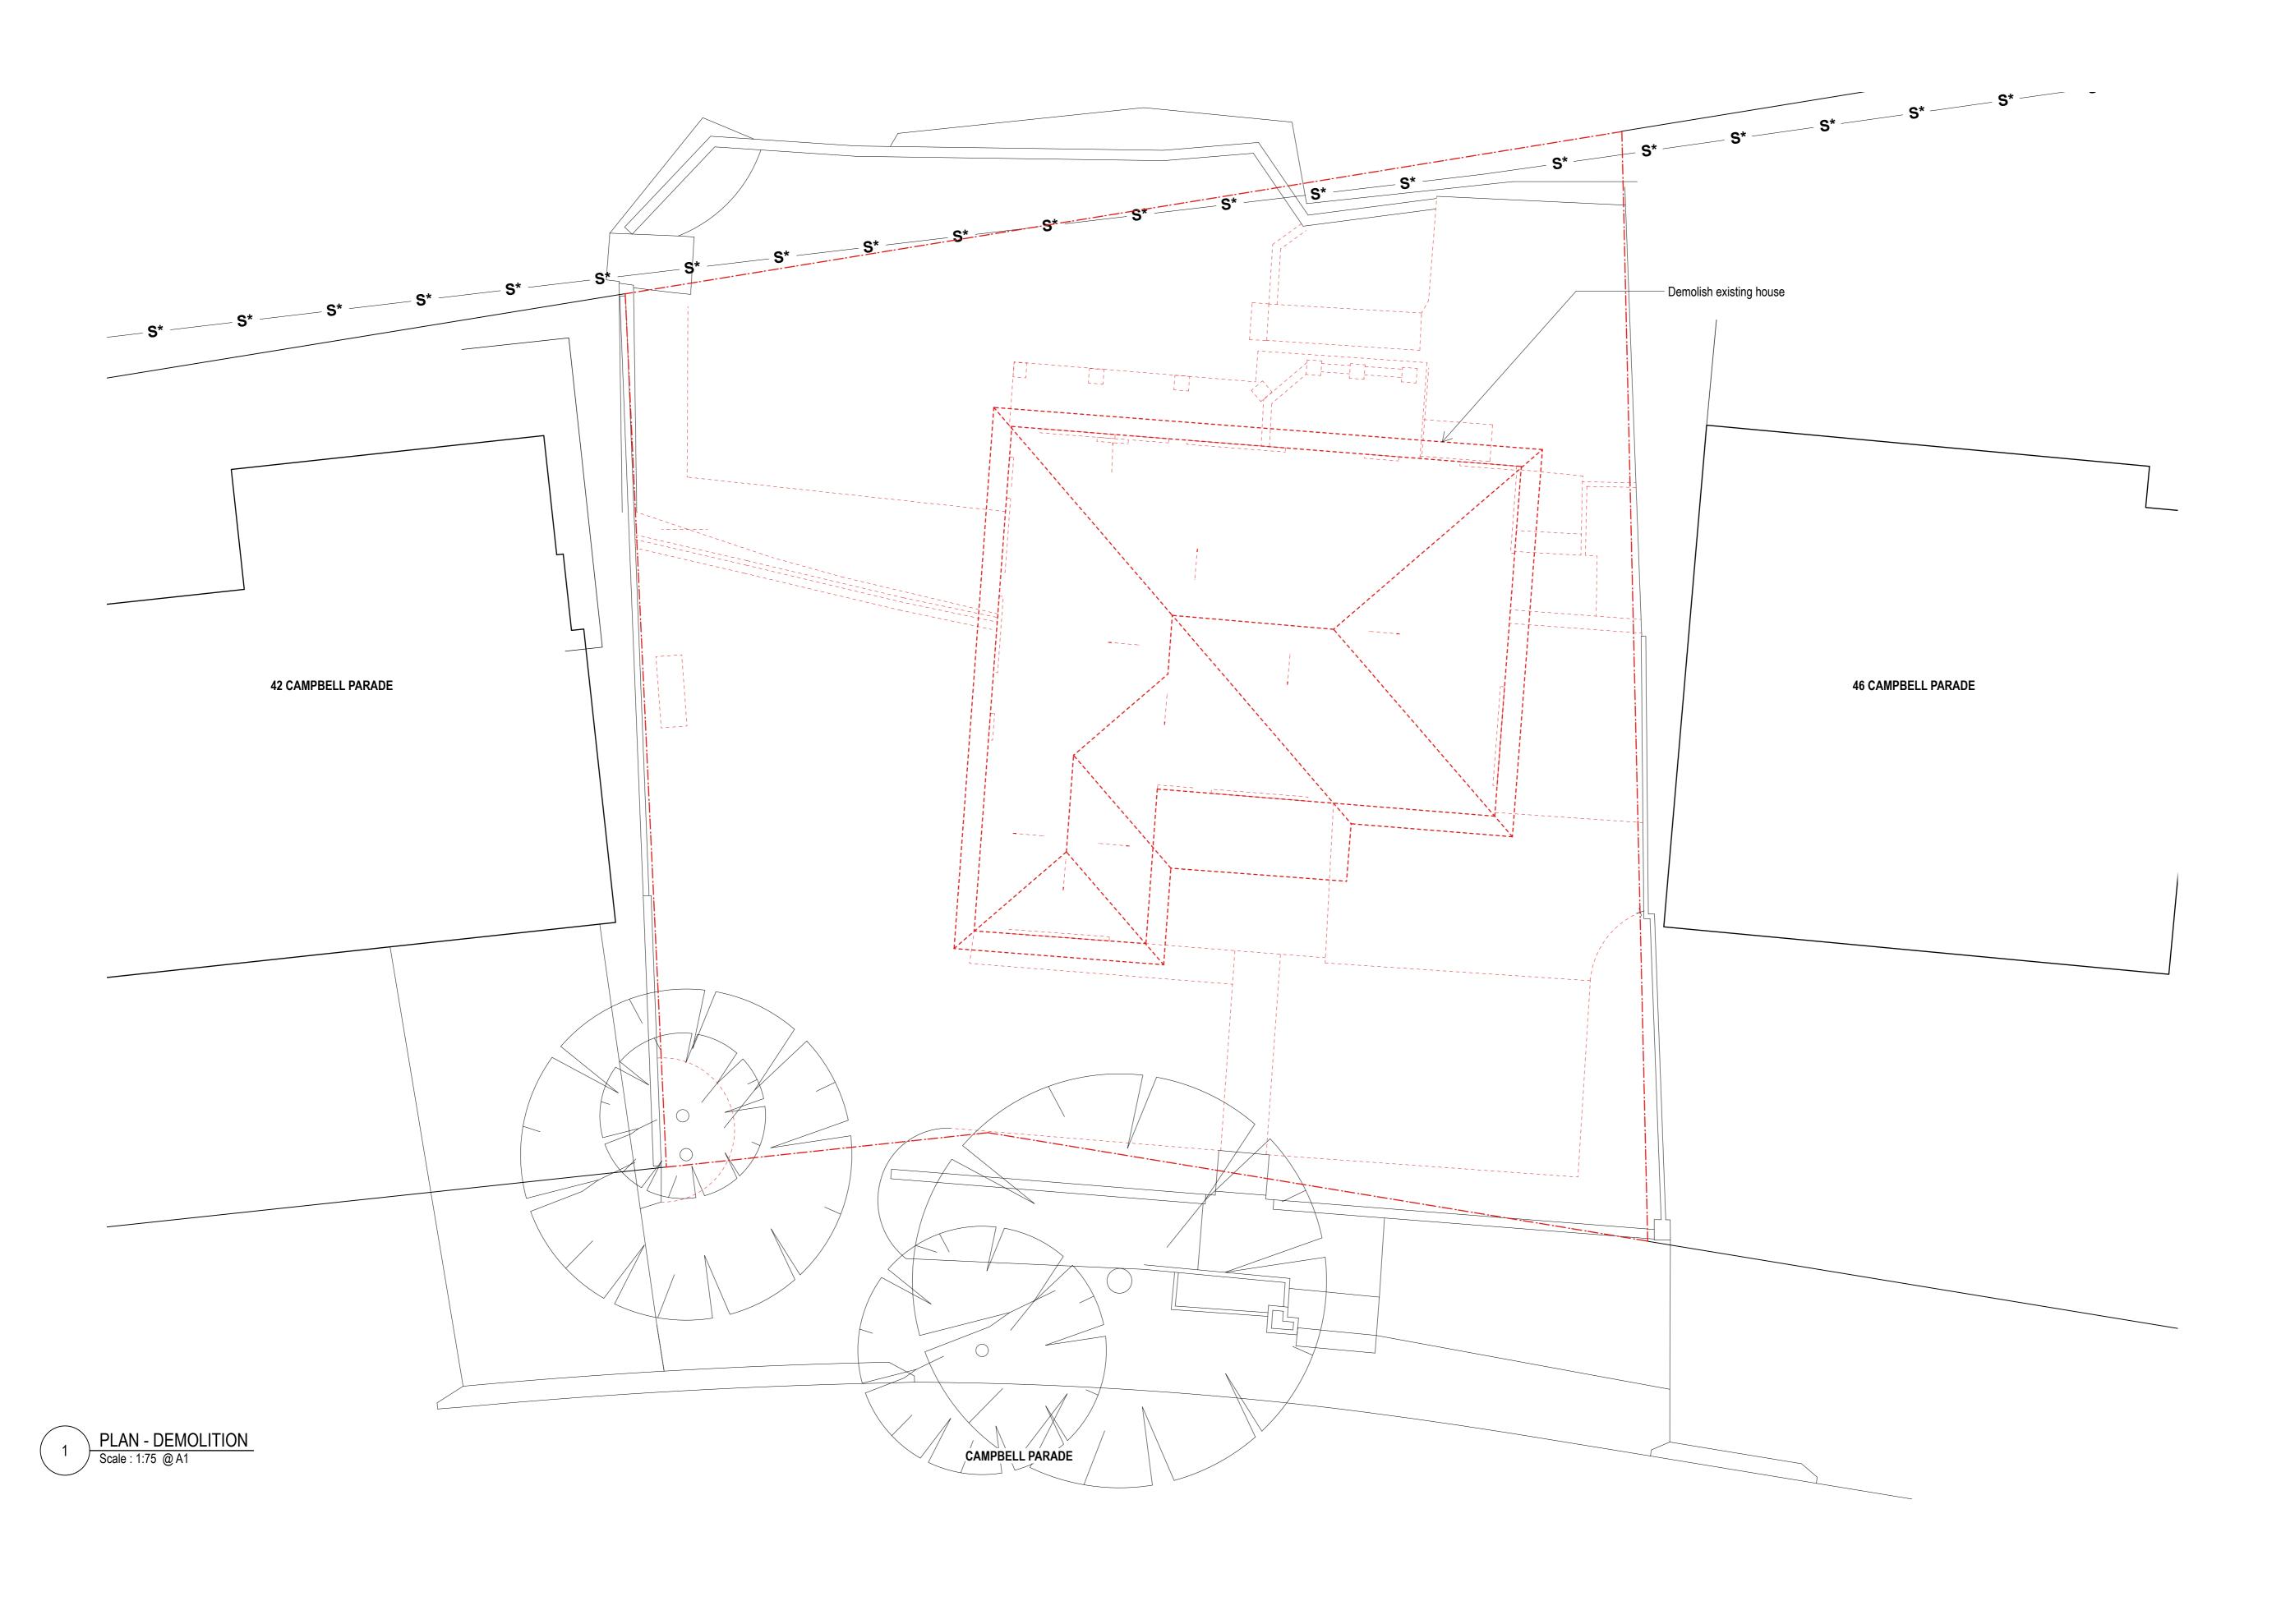
DEVELOPMENT CONSENT CONDITIONS.

ACCORDANCE WITH RELEVANT AUSTRALIAN STANDARDS, NCC/BCA &

_			
ı	REV	DATE	DESCRIPTION
	A	9/5/2025	Preliminary DA
I	В	10/7/2025	DA Submission

Robyn Storer PROJECT PROJECT ADRESS Manly Vale 44 Campbell Parade, Manly Vale

PLAN - EXISTING DWG NO. PROJECT NO. SCALE @ A1 CHECKED DRAWN 2403 1:75 A201 MB TB



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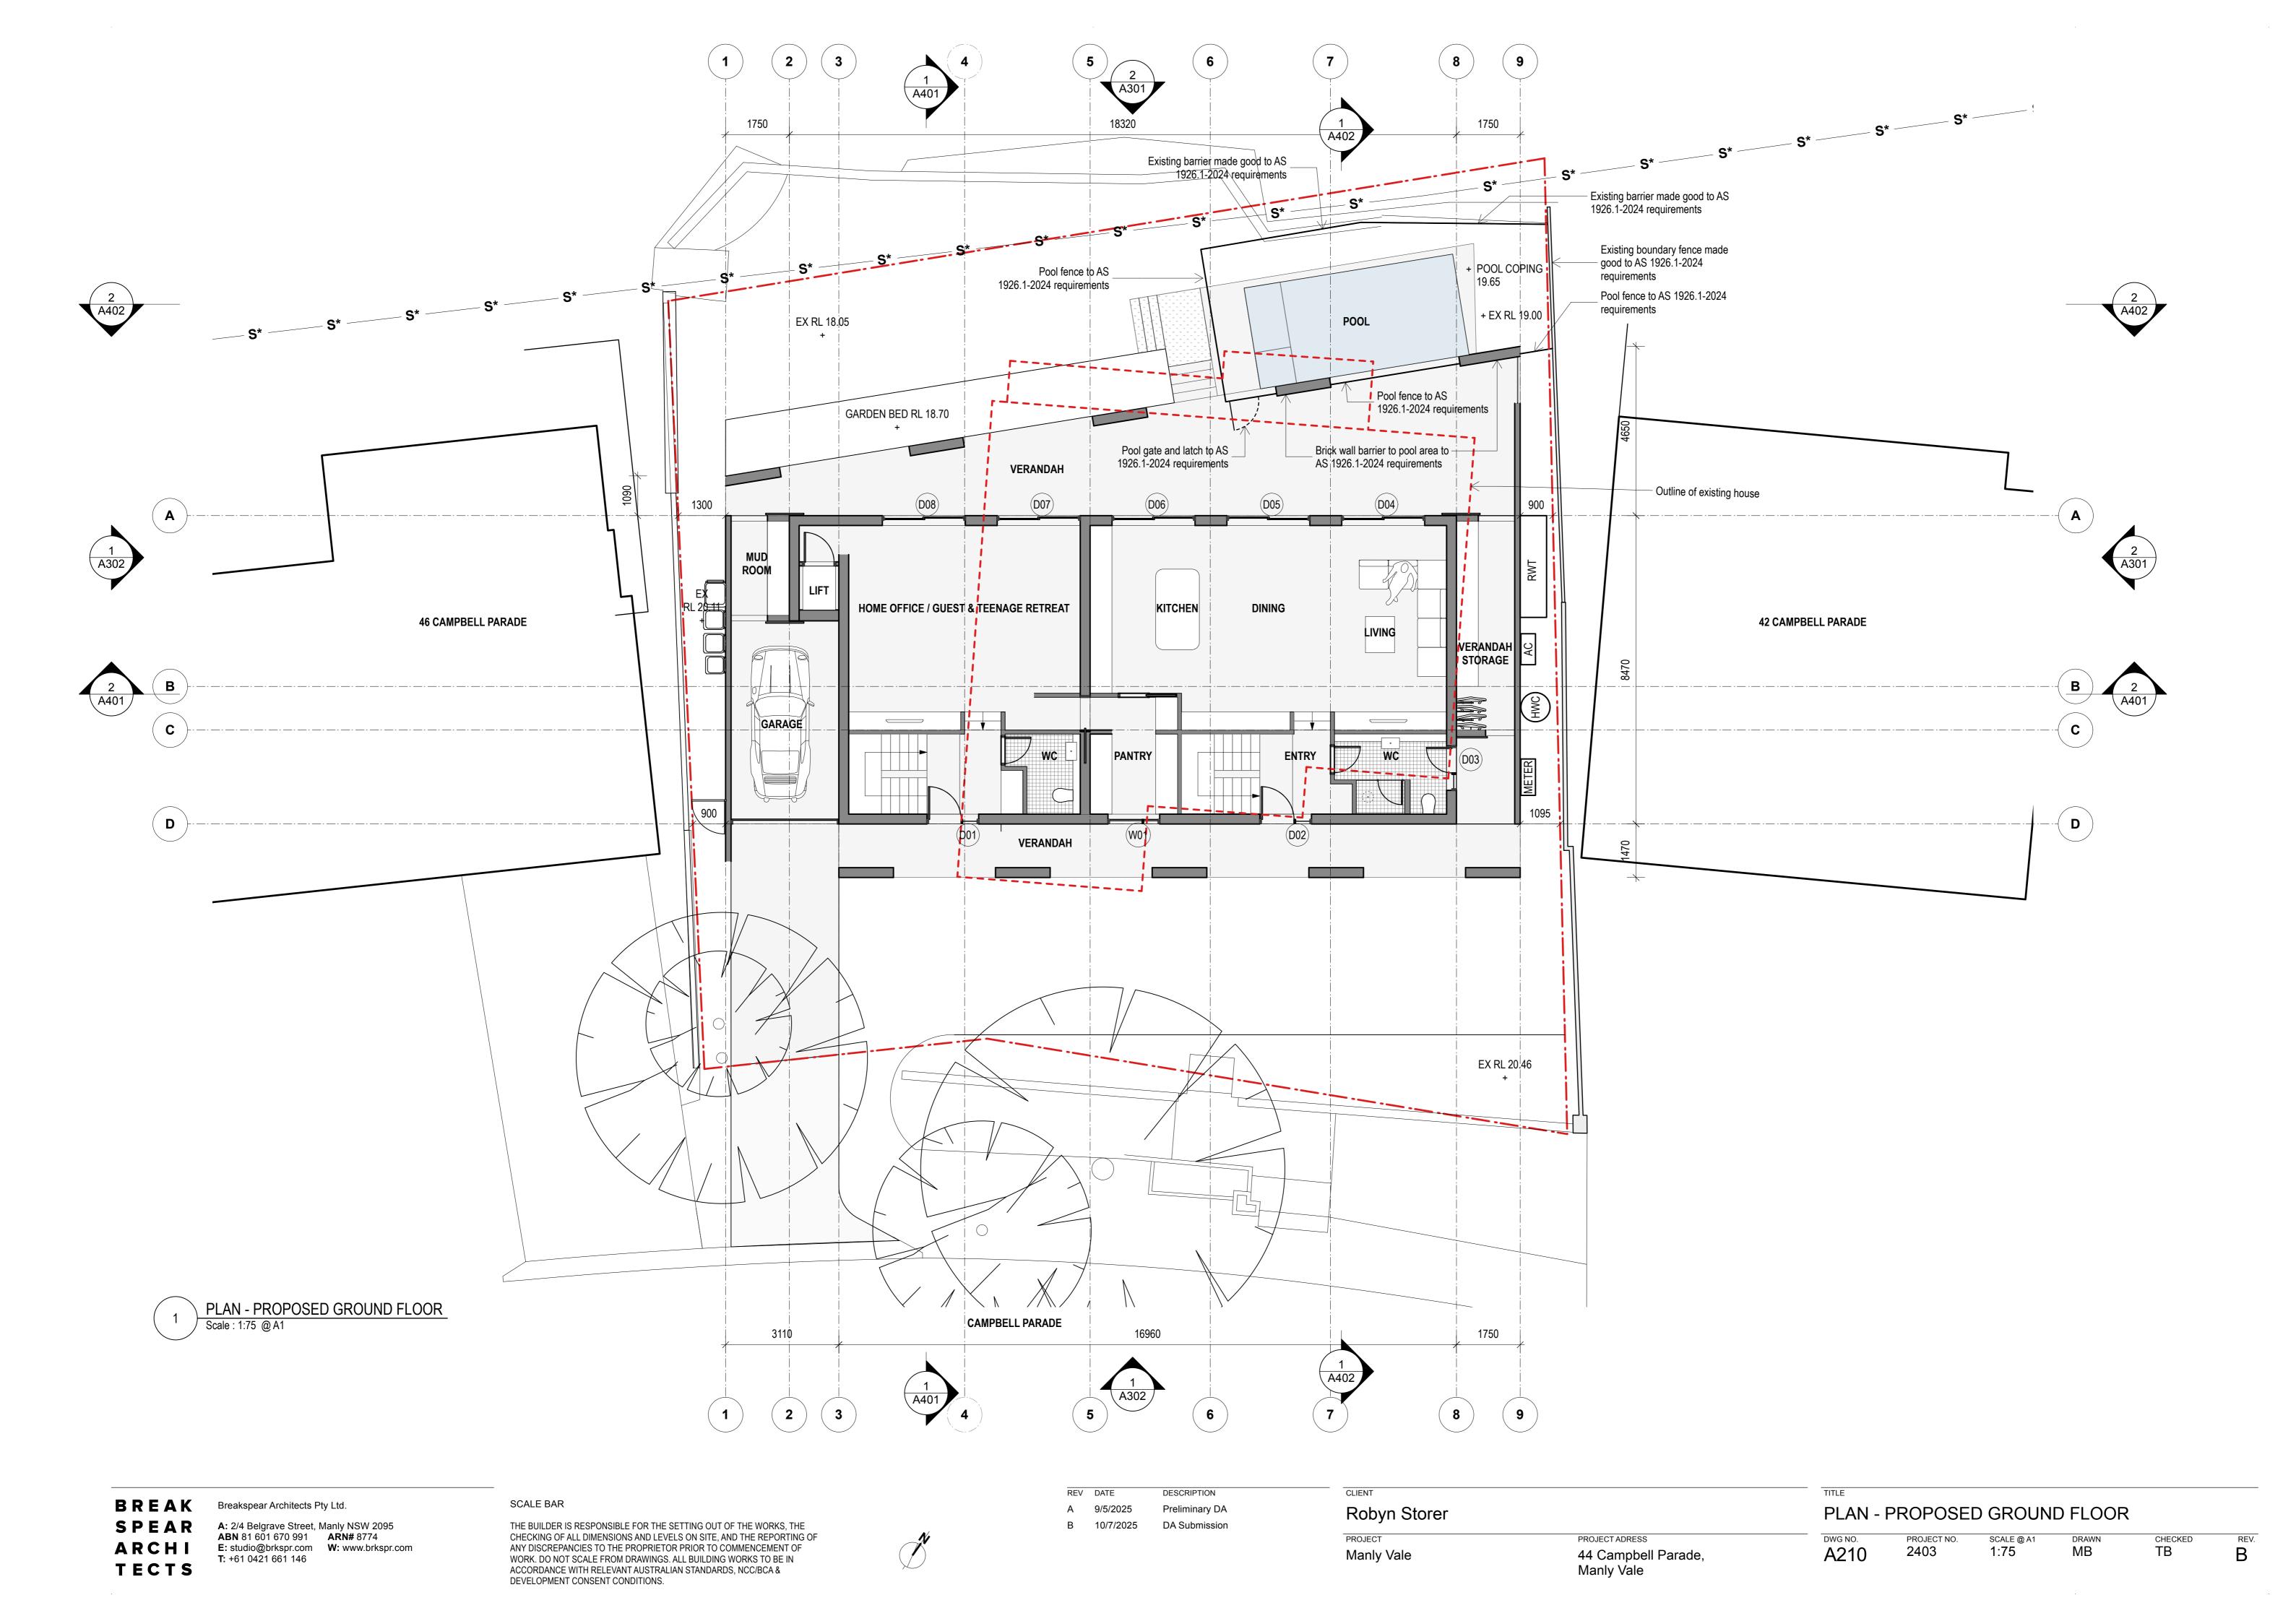
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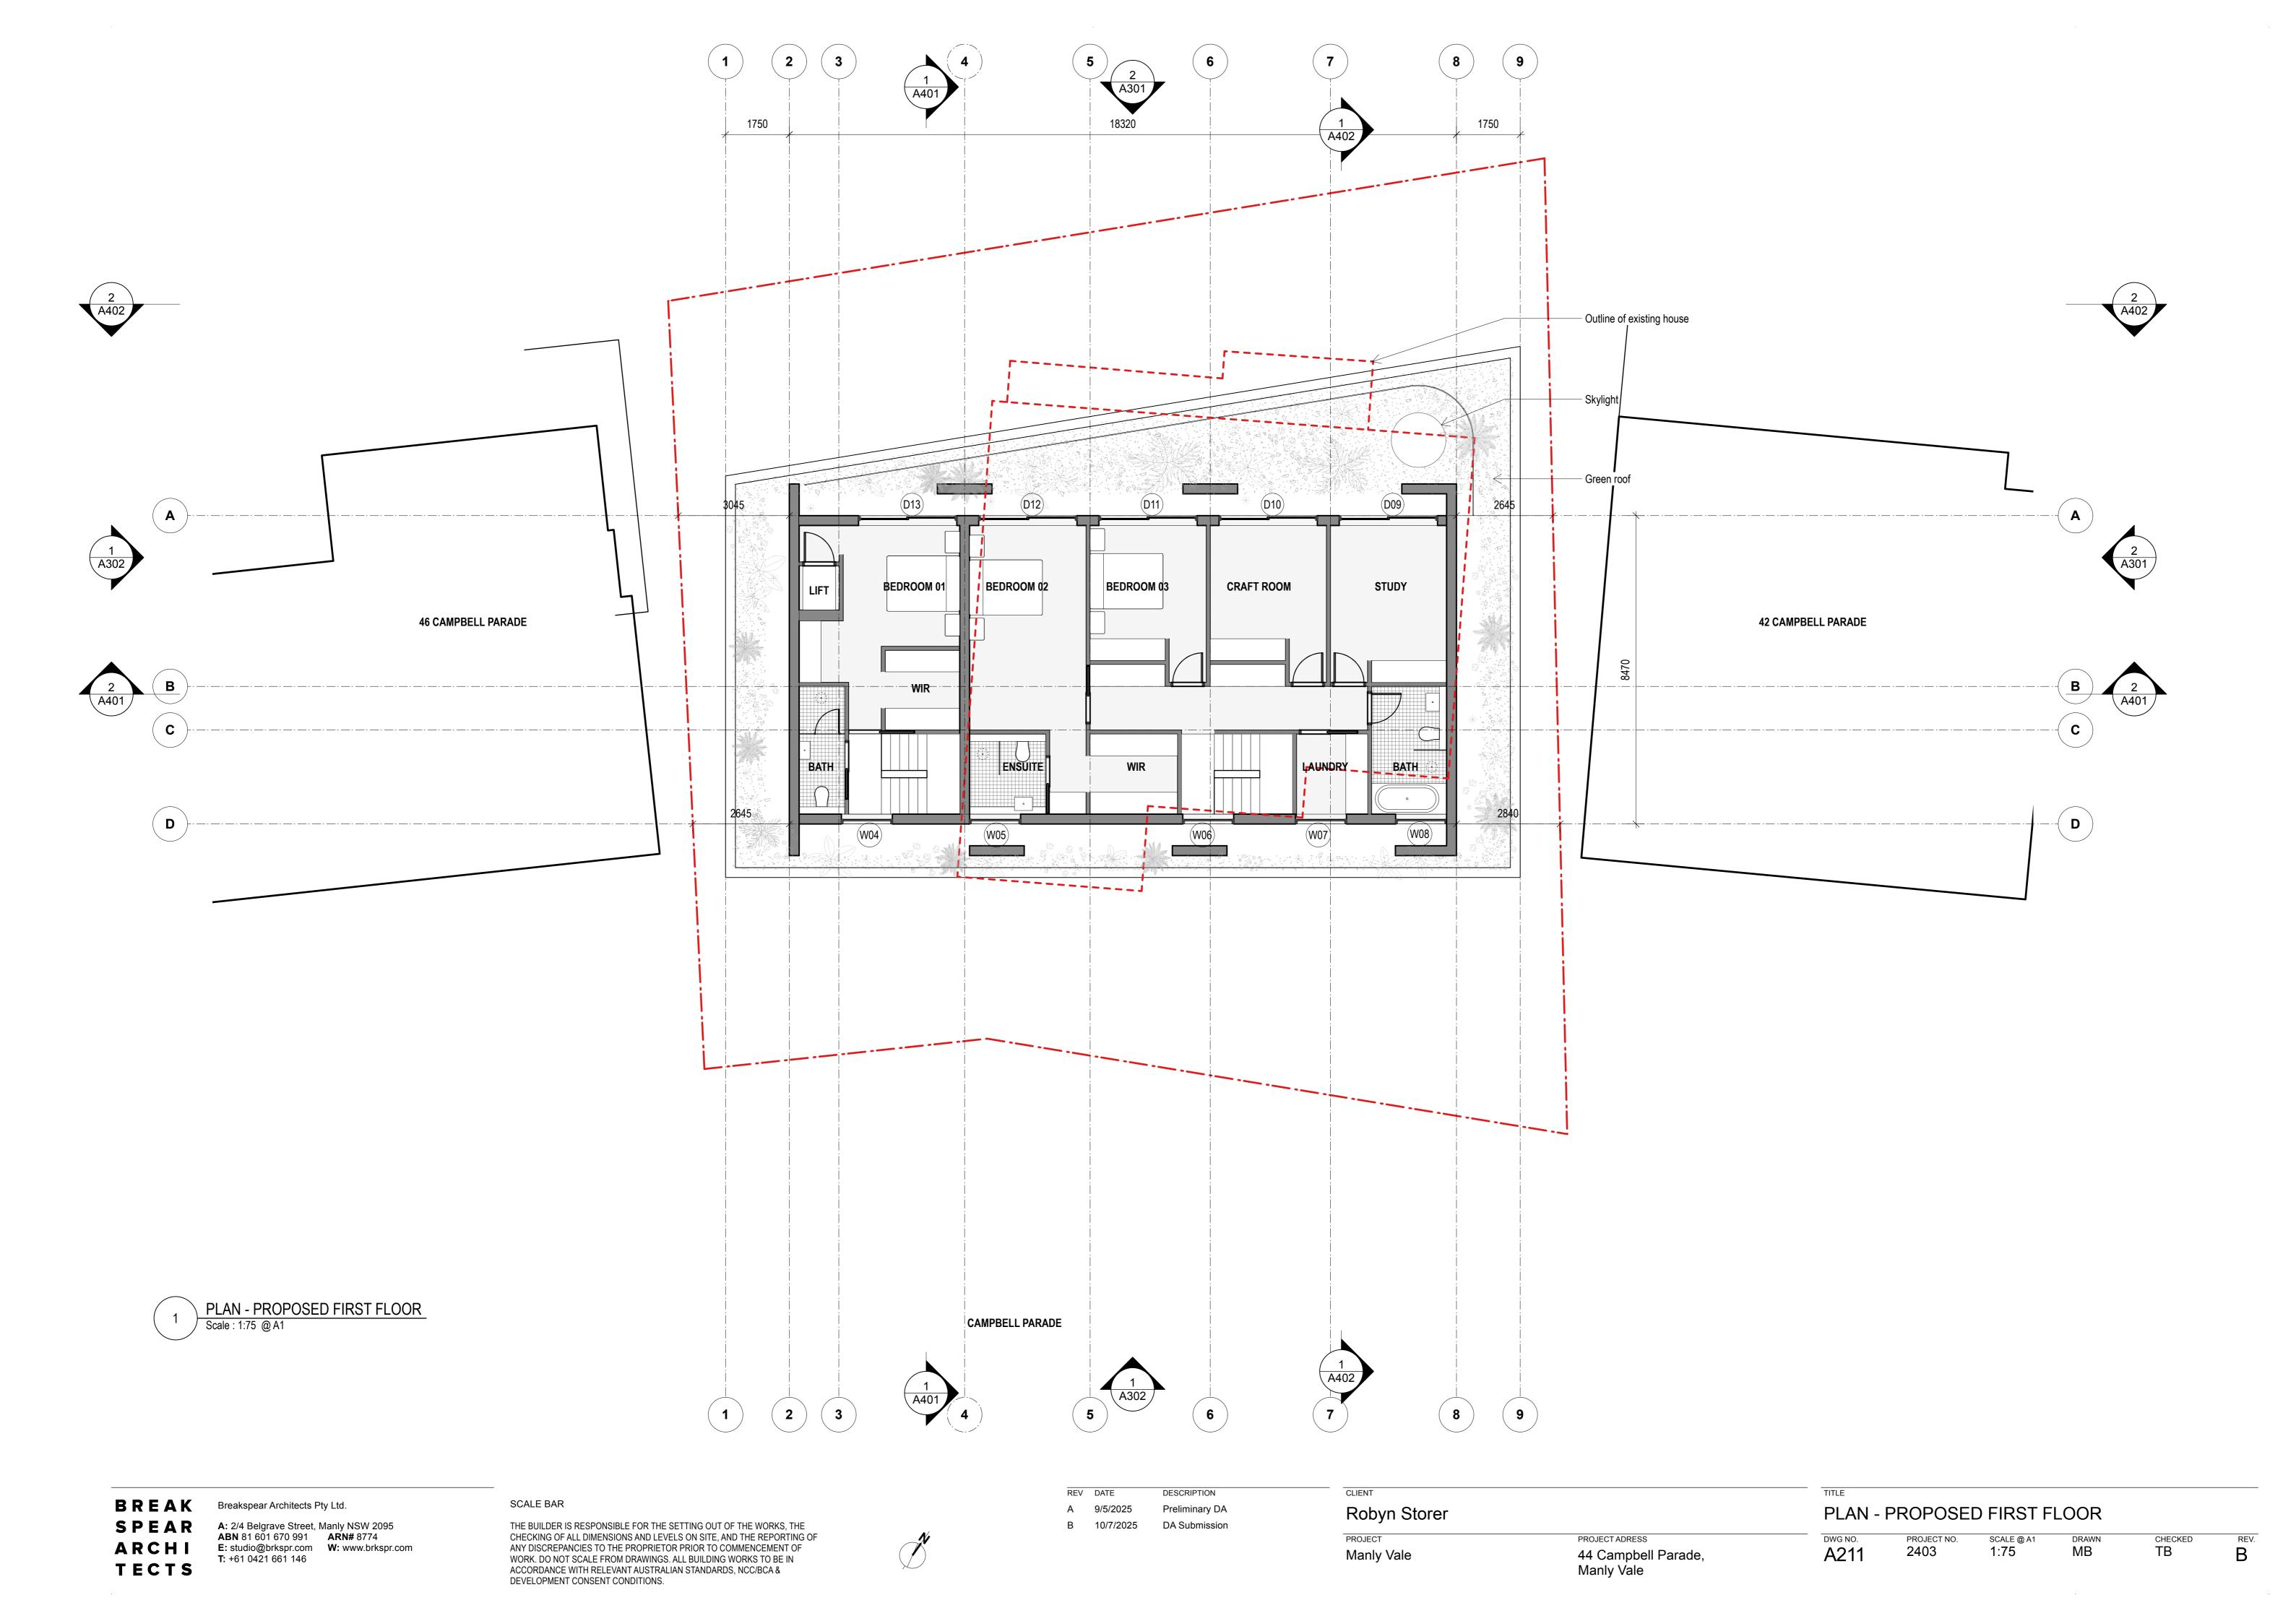
REV	DATE	DESCRIPTION
Α	9/5/2025	Preliminary DA
В	10/7/2025	DA Submission


Robyn Storer		
PROJECT	PROJECT ADRESS	DWG N
Manly Vale	44 Campbell Parade, Manly Vale	A20


PLAN - DEMOLITION

DWG NO. PROJECT NO. SCALE @ A1 DRAWN CHECKED REV.
A202 2403 1:75 MB TB B





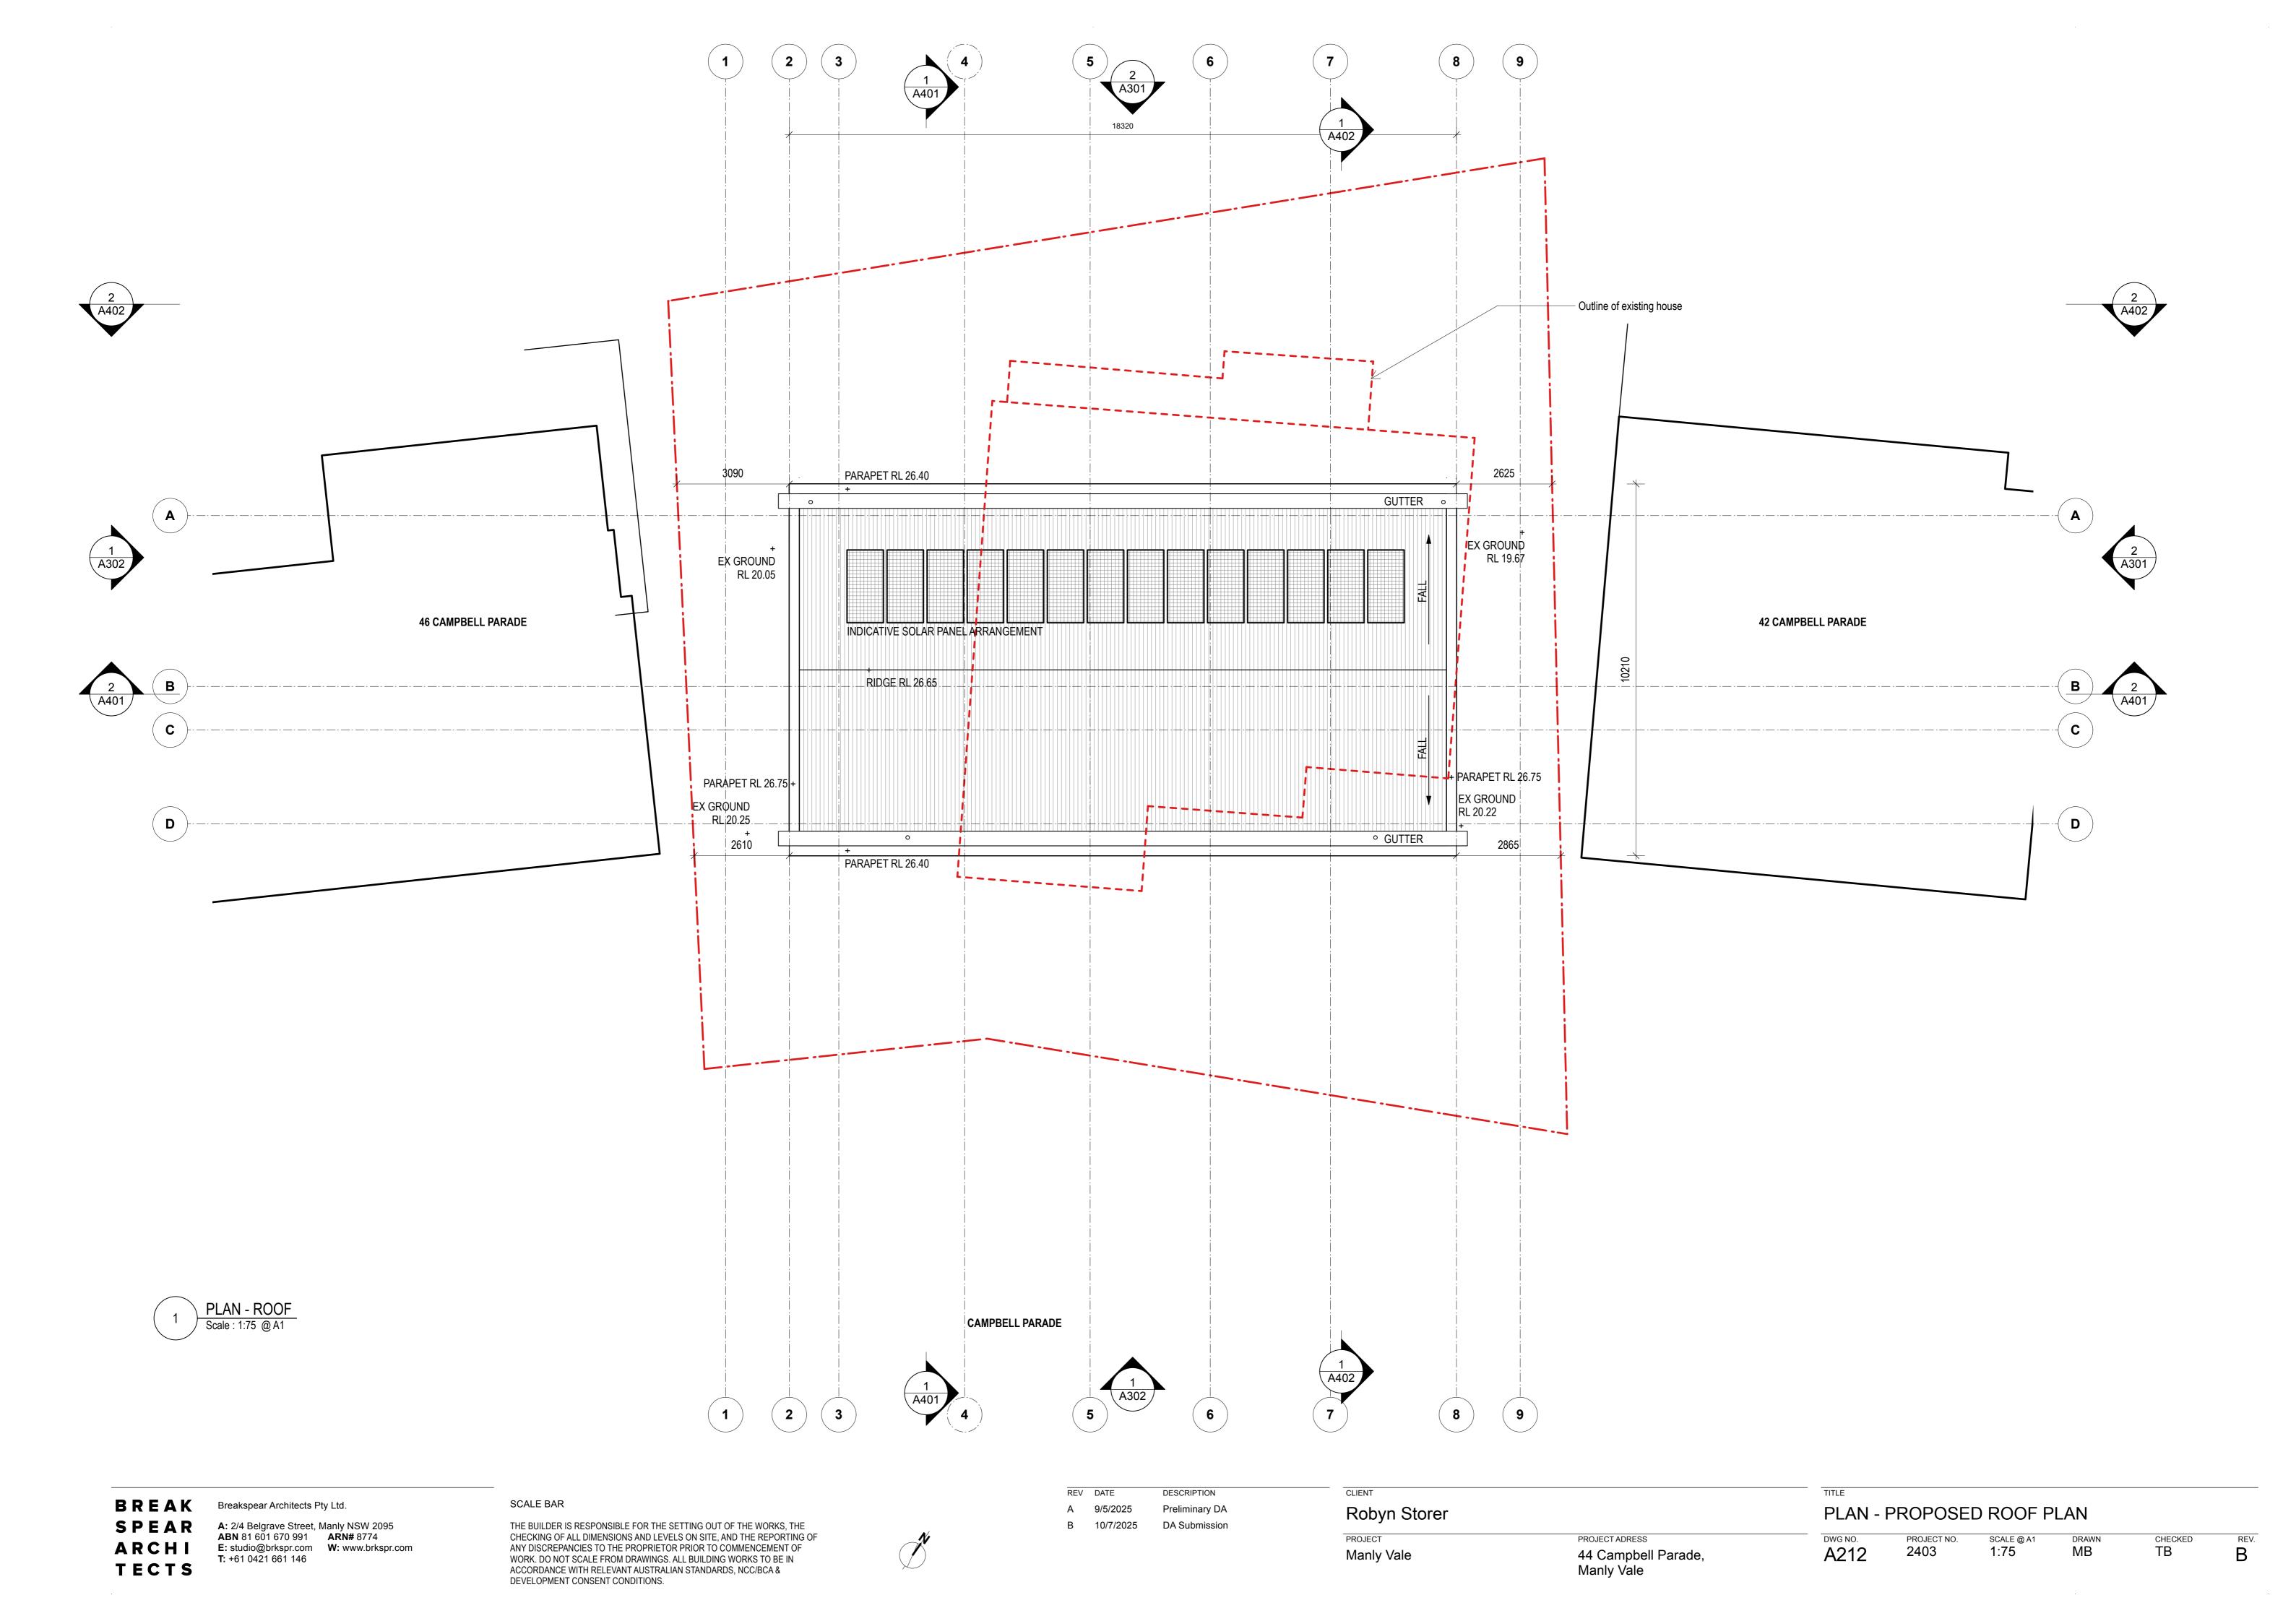

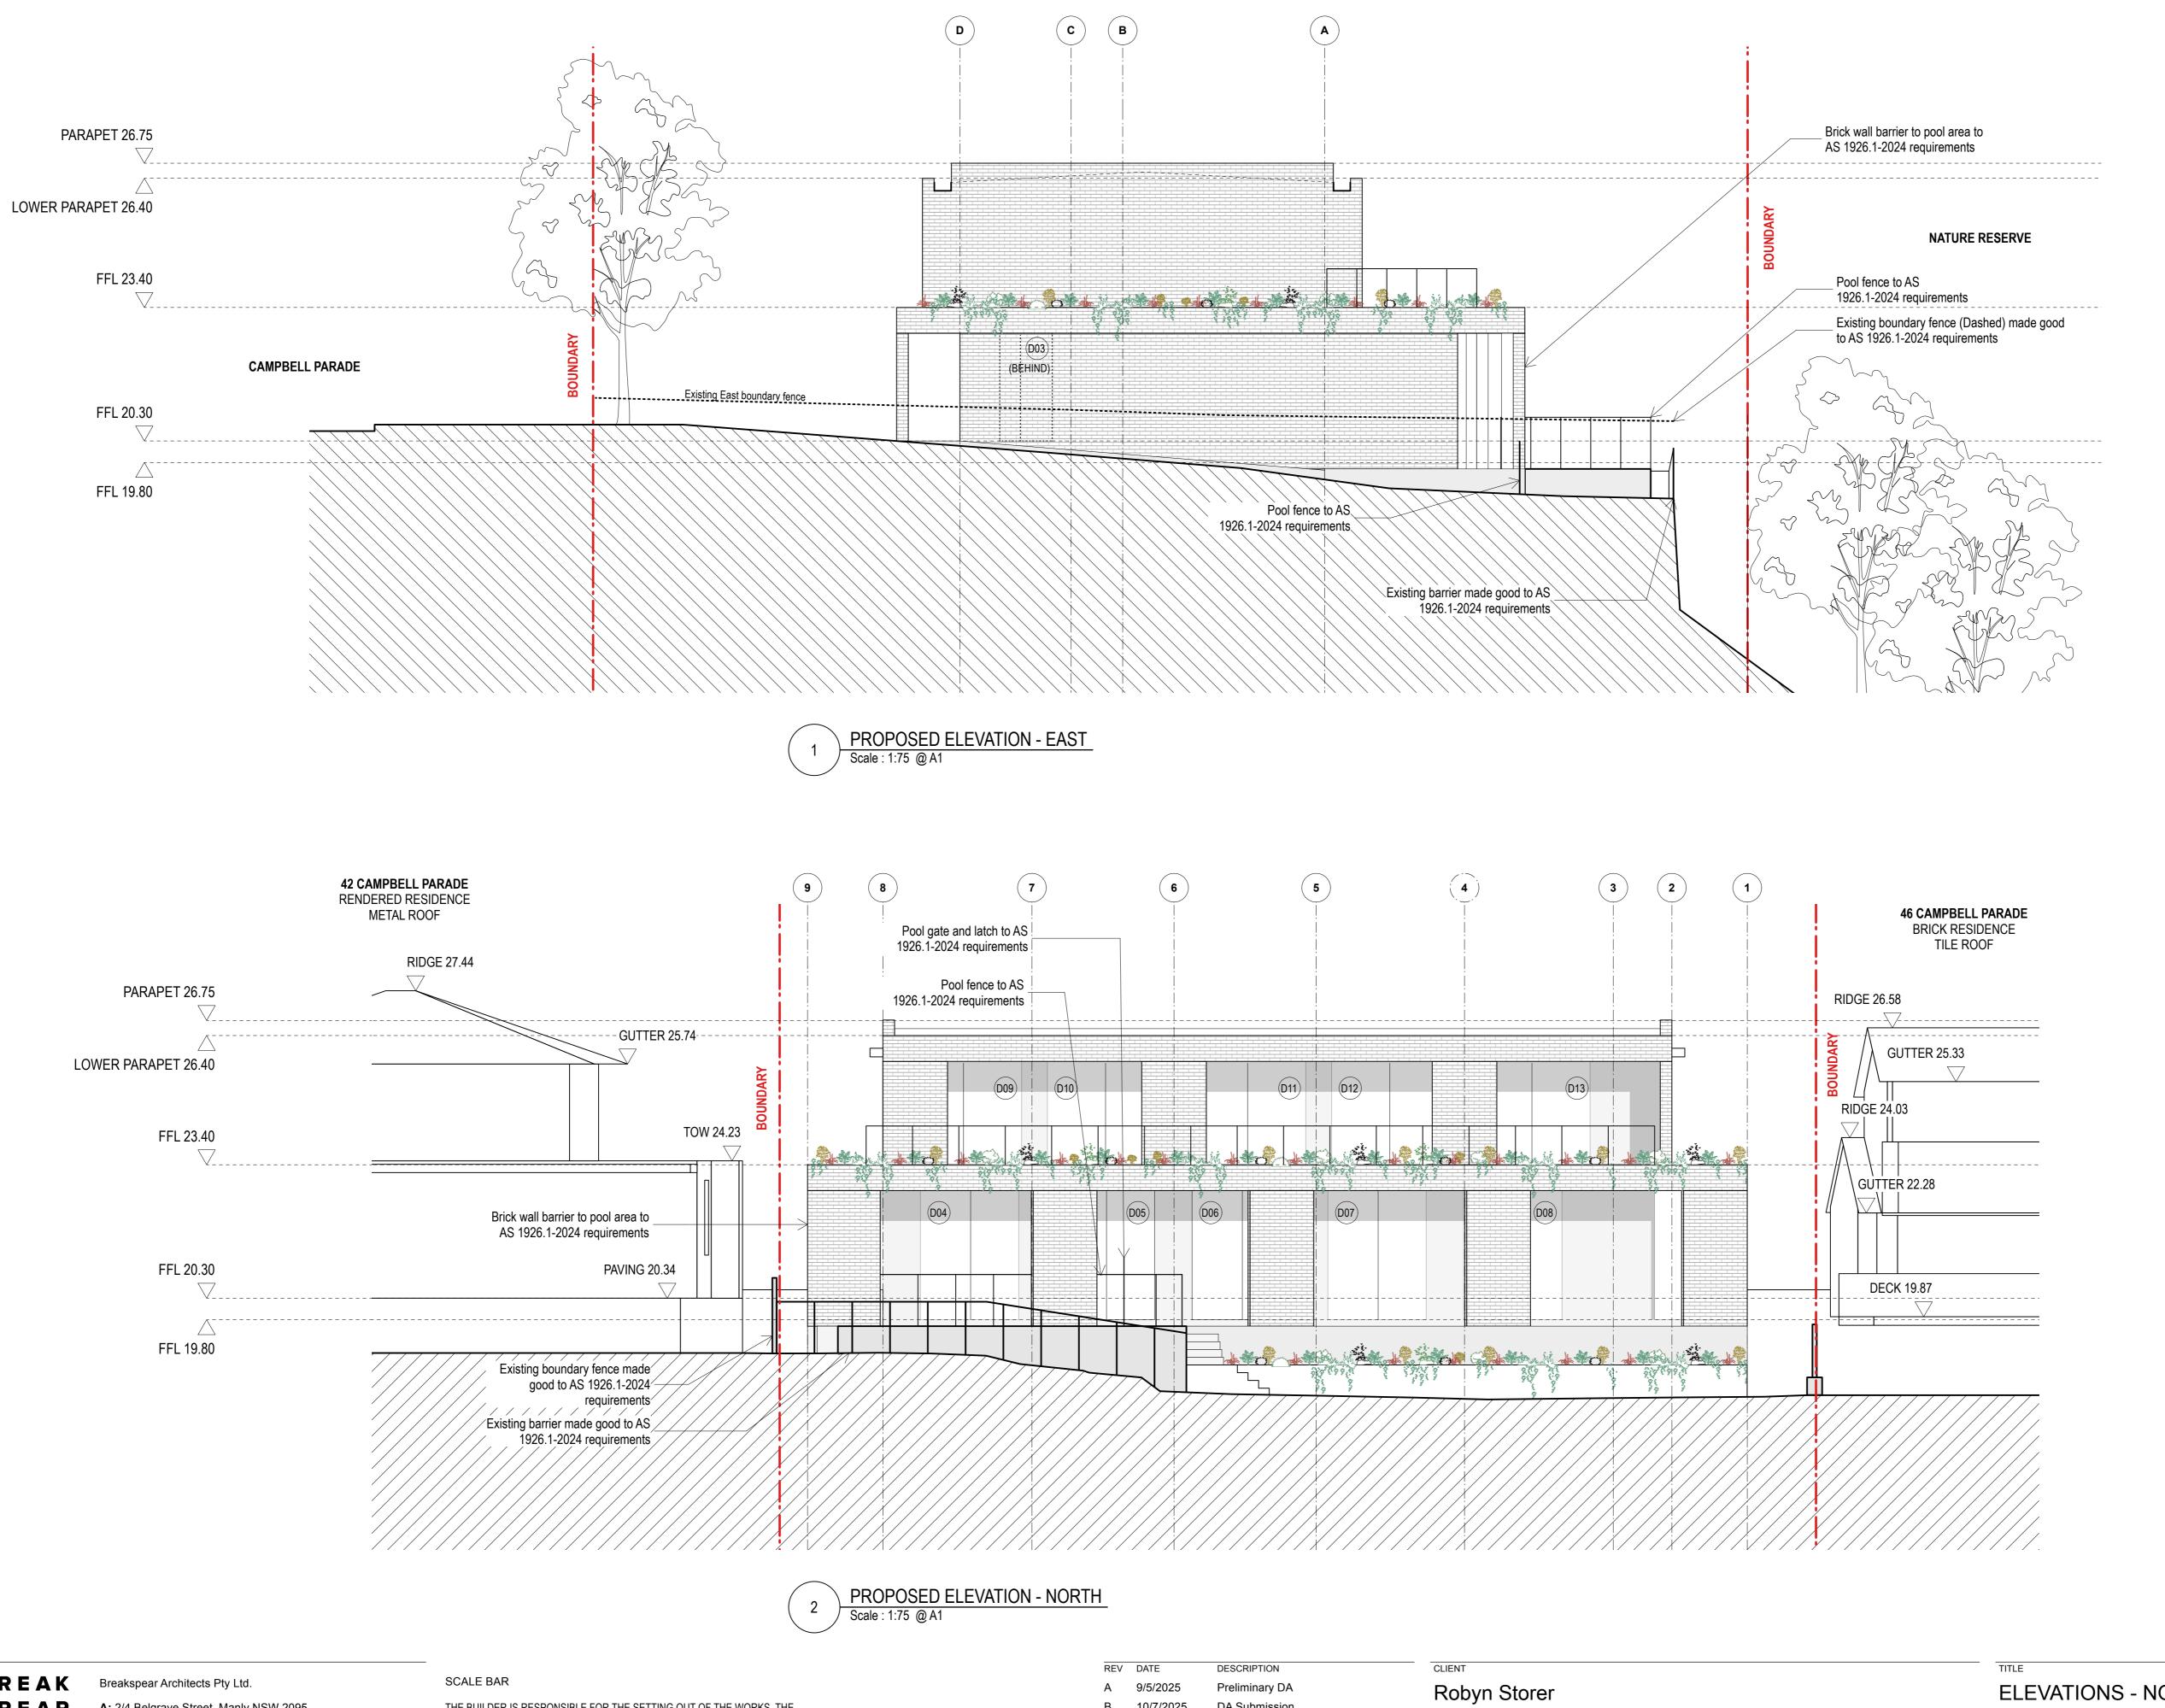


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B 10/7/2025 DA Submission

PROJECT PROJECT ADRESS 44 Campbell Parade, Manly Vale Manly Vale

ELEVATIONS - NORTH + EAST DWG NO. DRAWN MB PROJECT NO. SCALE @ A1 CHECKED 2403 1:75 A301 TB



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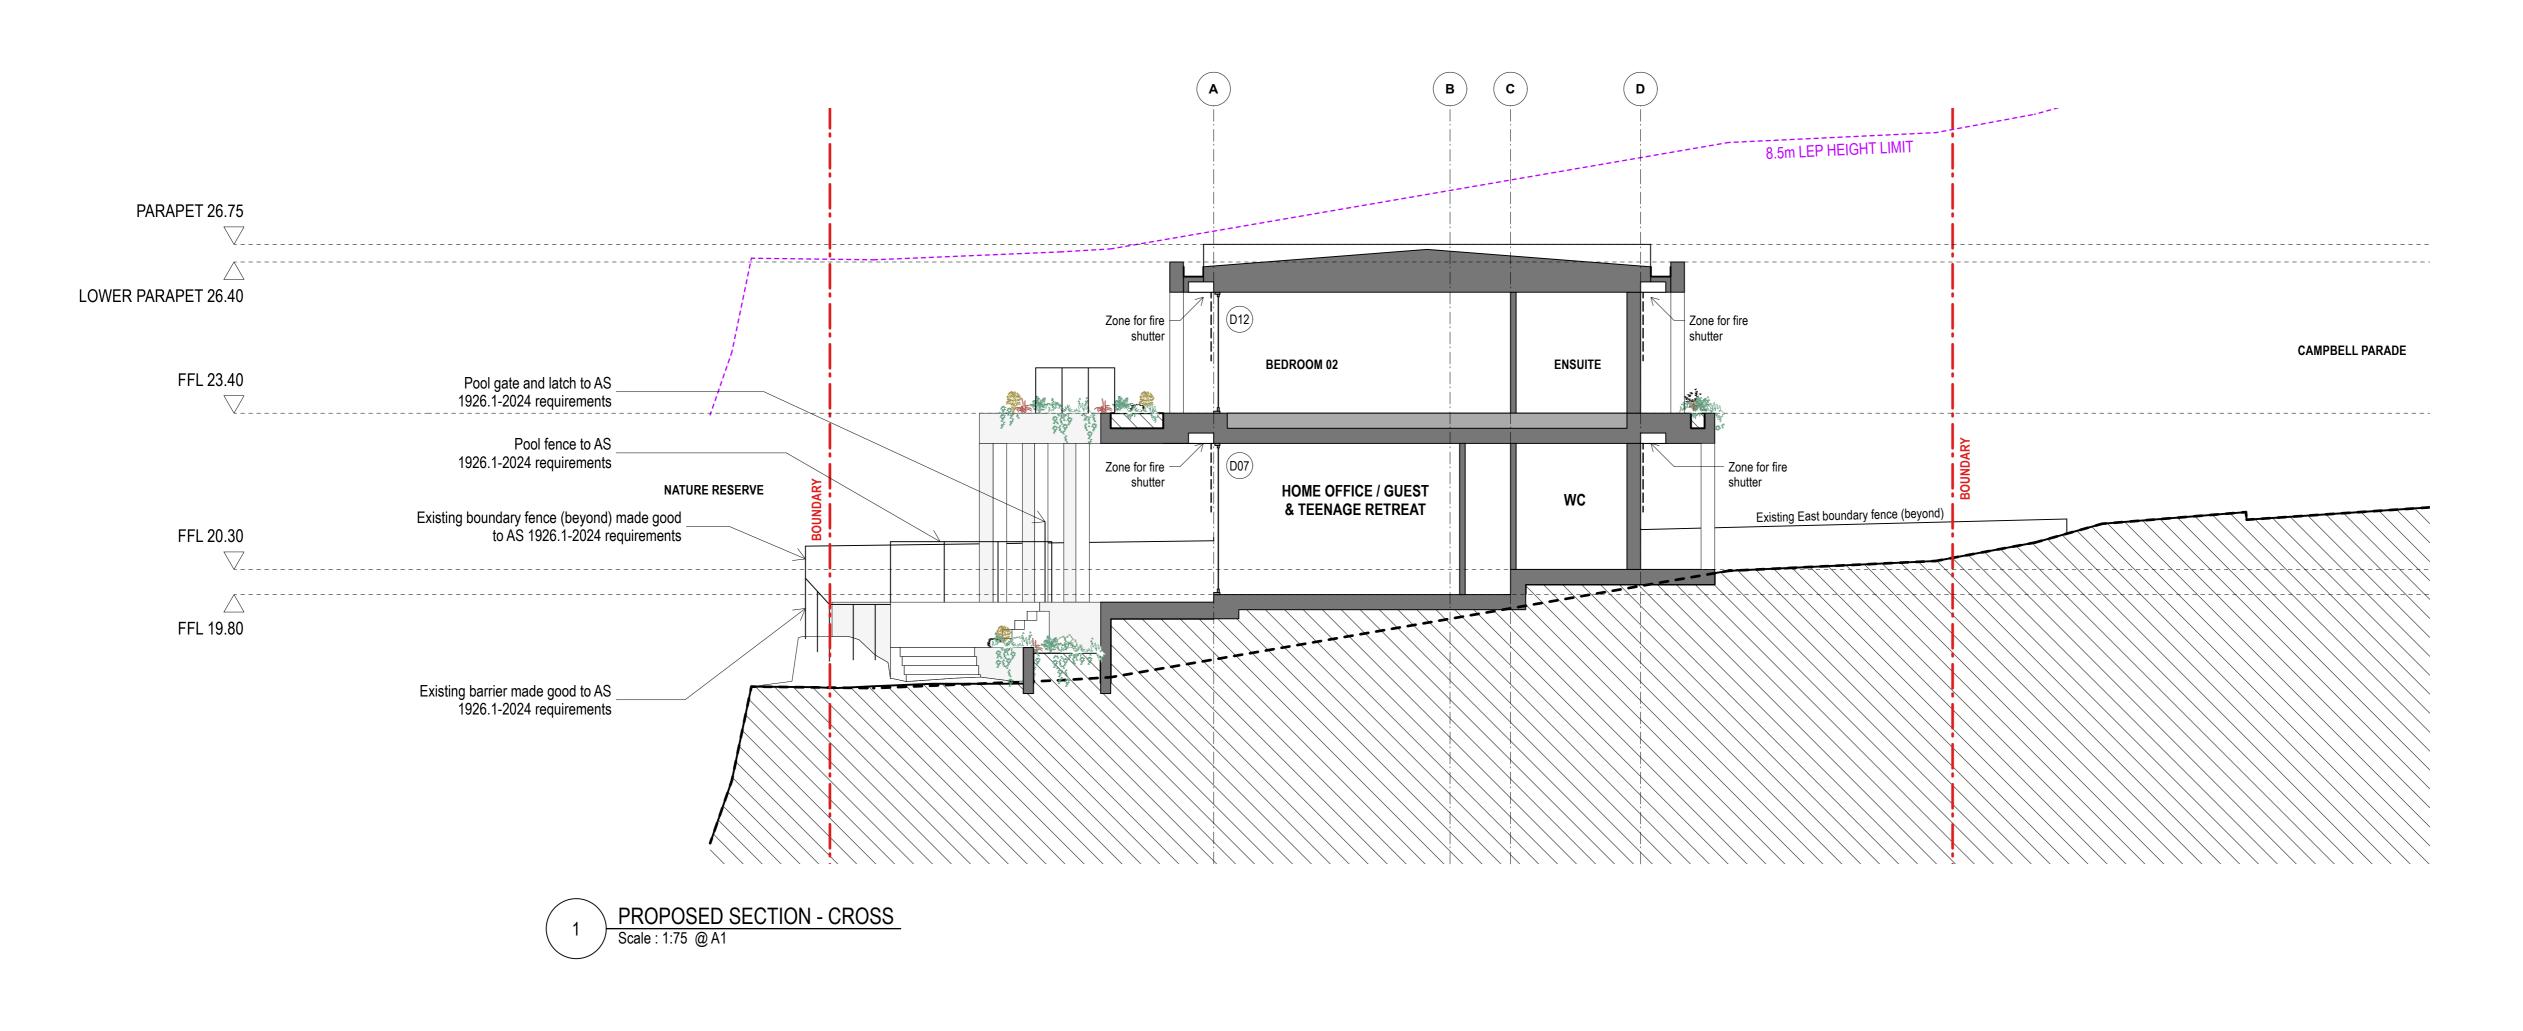
SCALE BAR

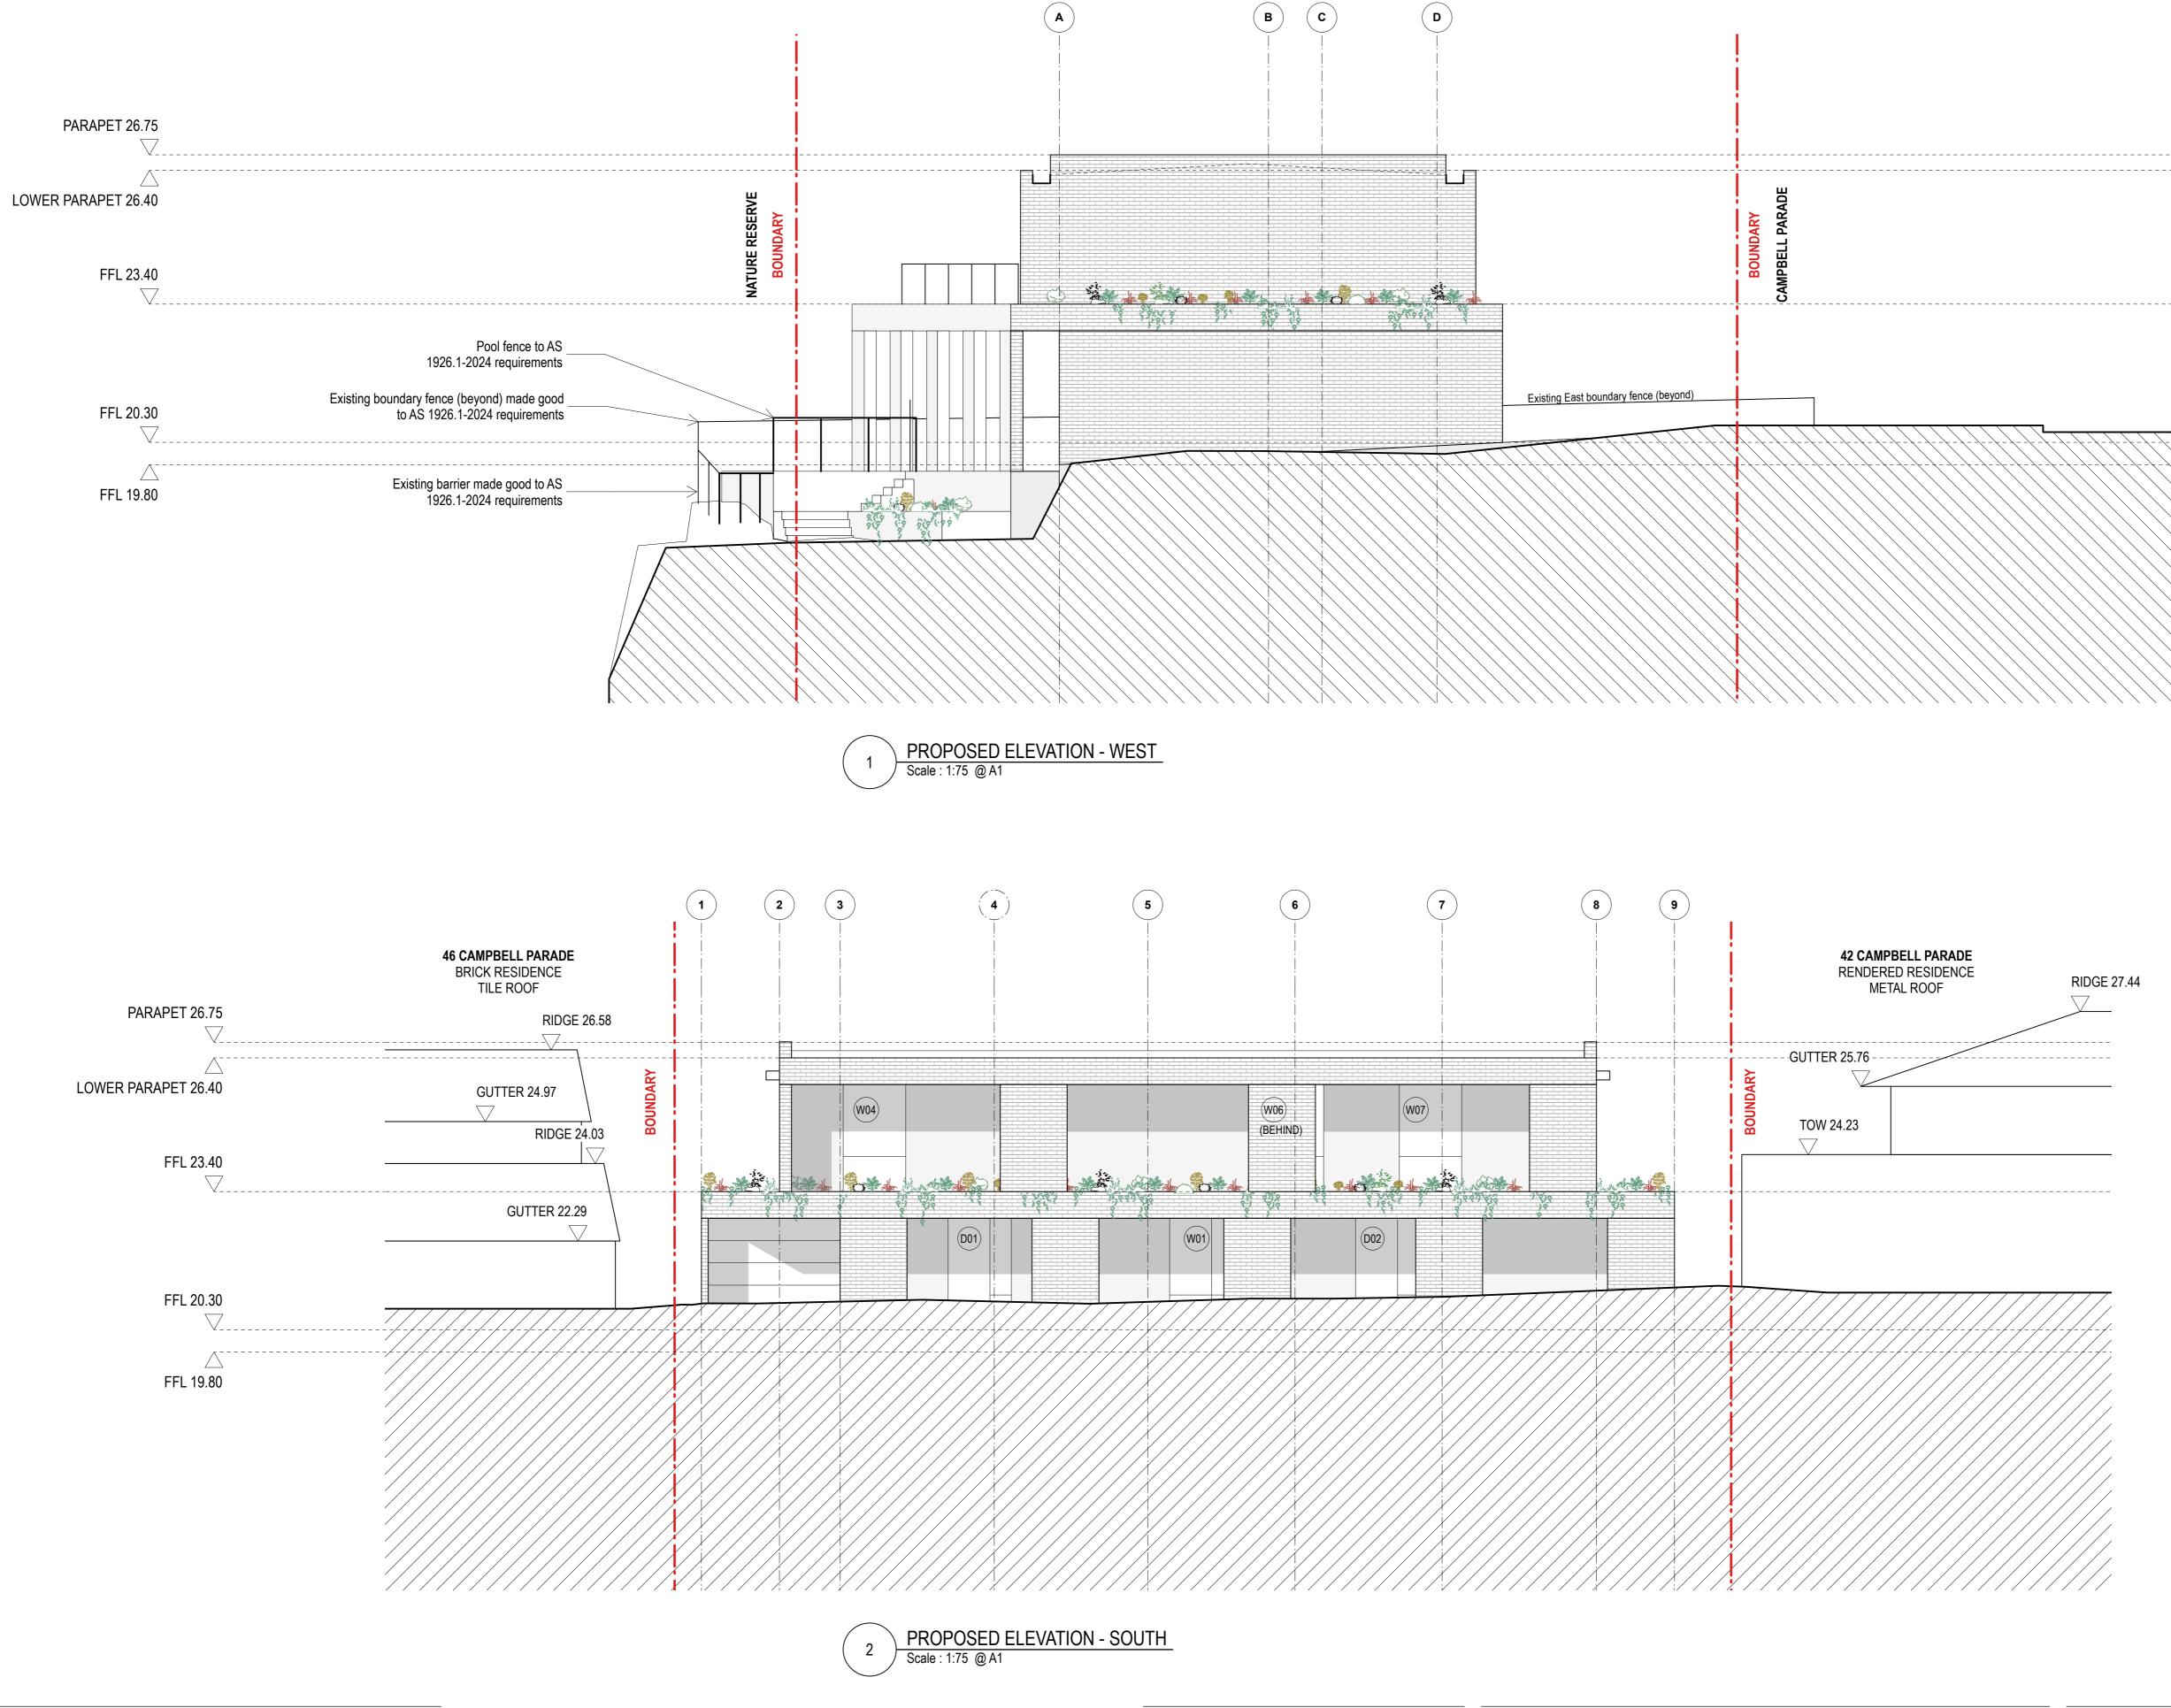
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В	10/7/2025	DA Submission

Robyn Storer		
PROJECT	PROJECT ADRESS	
Manly Vale	44 Campbell Parade, Manly Vale	






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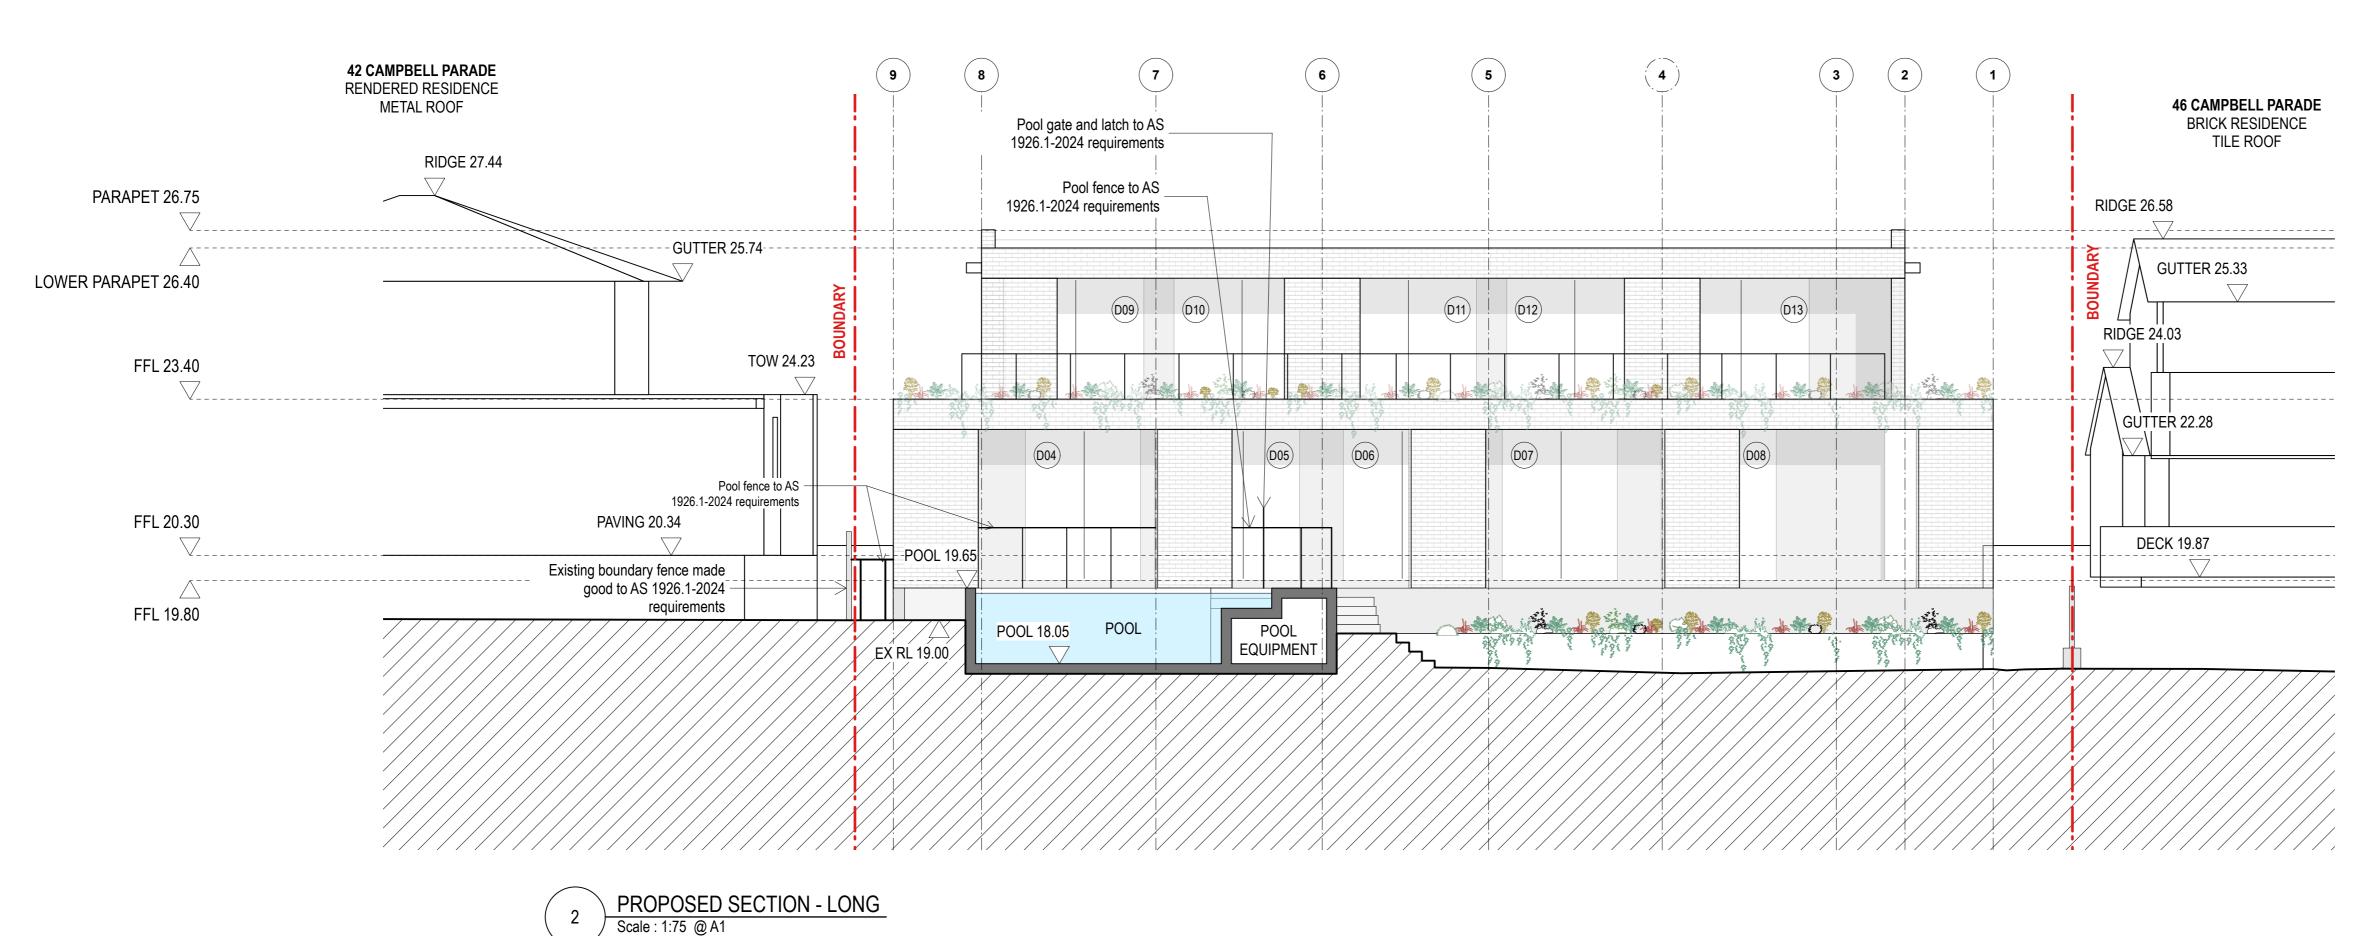
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REV	DATE	DESCRIPTION
Α	9/5/2025	Preliminary DA
В	10/7/2025	DA Submission

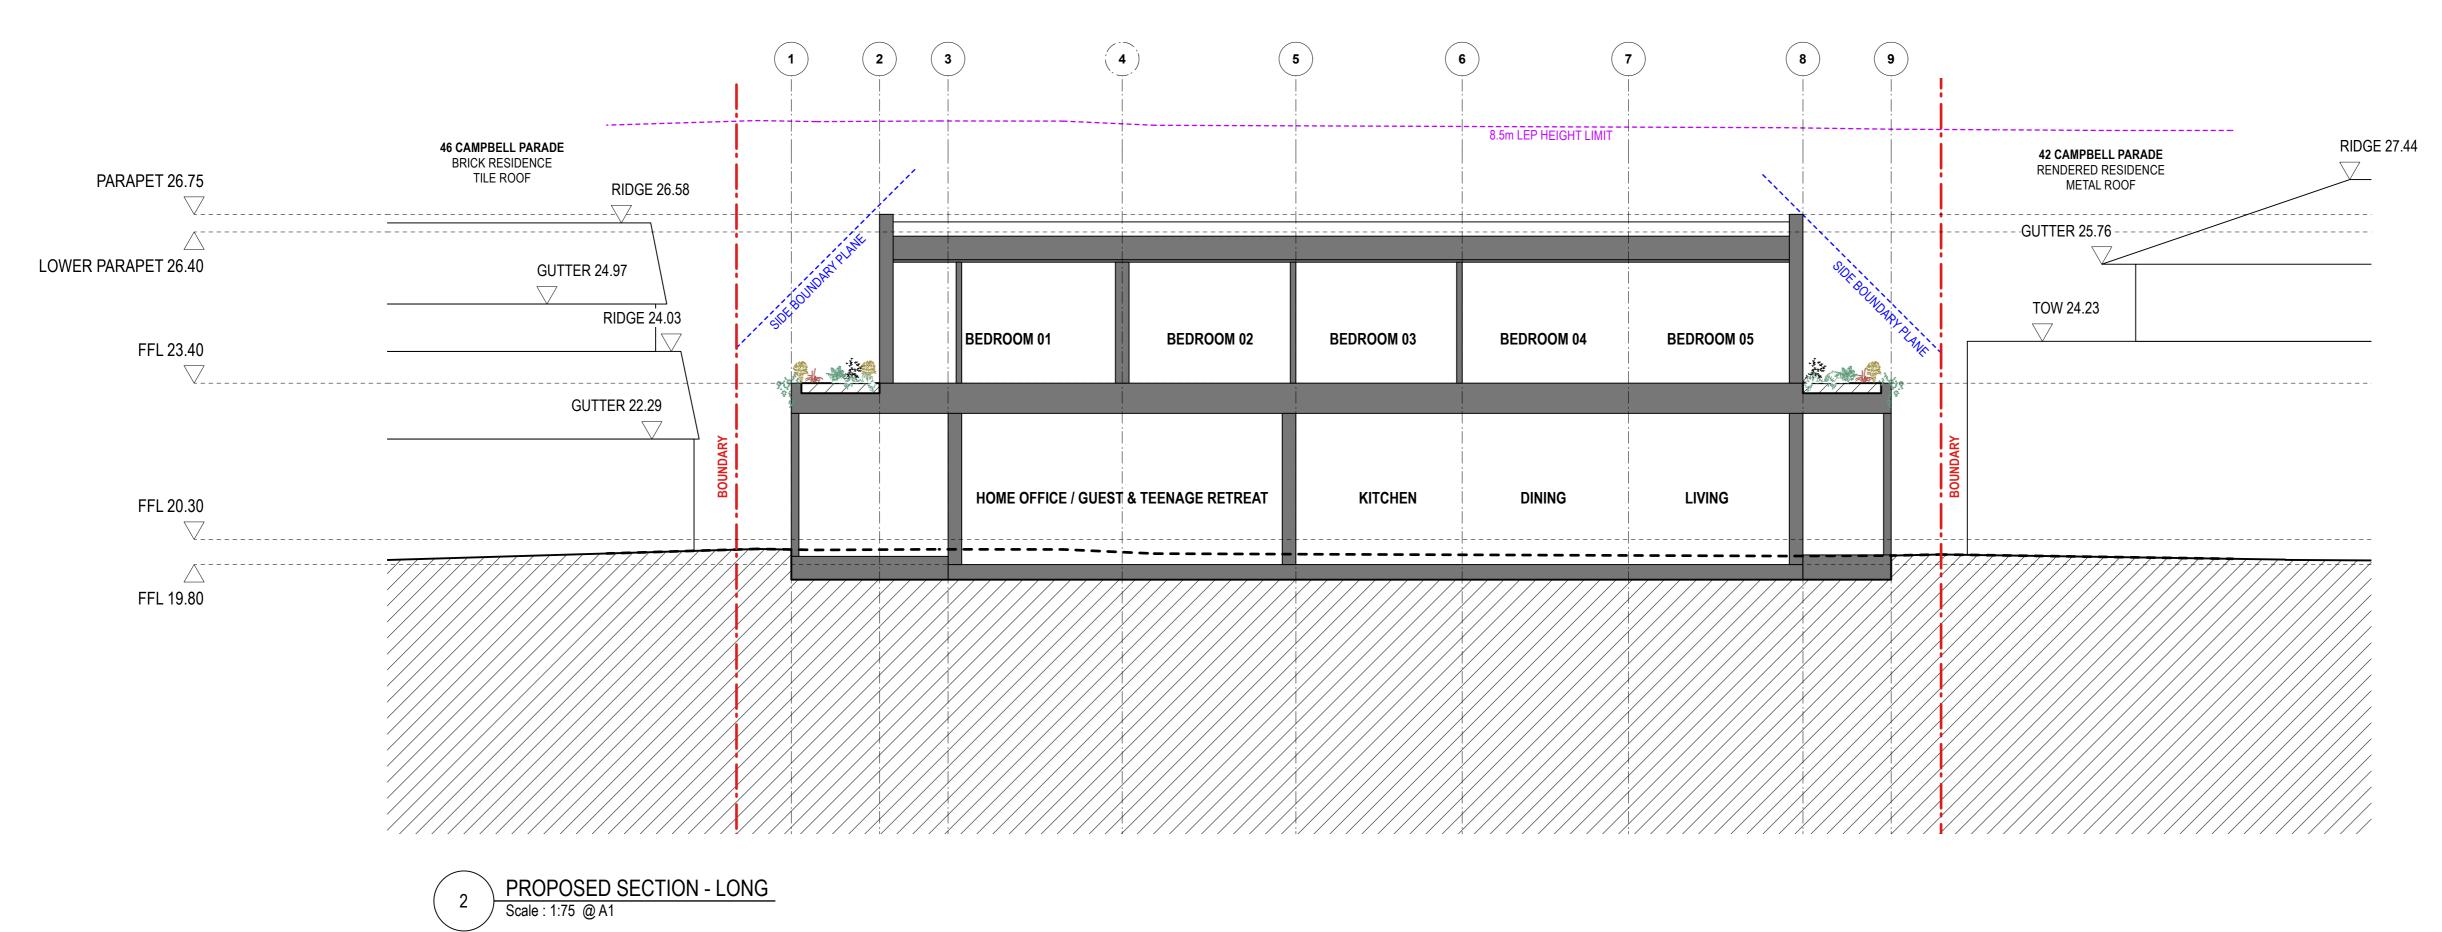CLIENT	
Robyn Storer	
PROJECT	PROJECT ADRESS
Manly Vale	44 Campbell Parade, Manly Vale





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REV DATE DESCRIPTION
A 10/7/2025 DA Submission

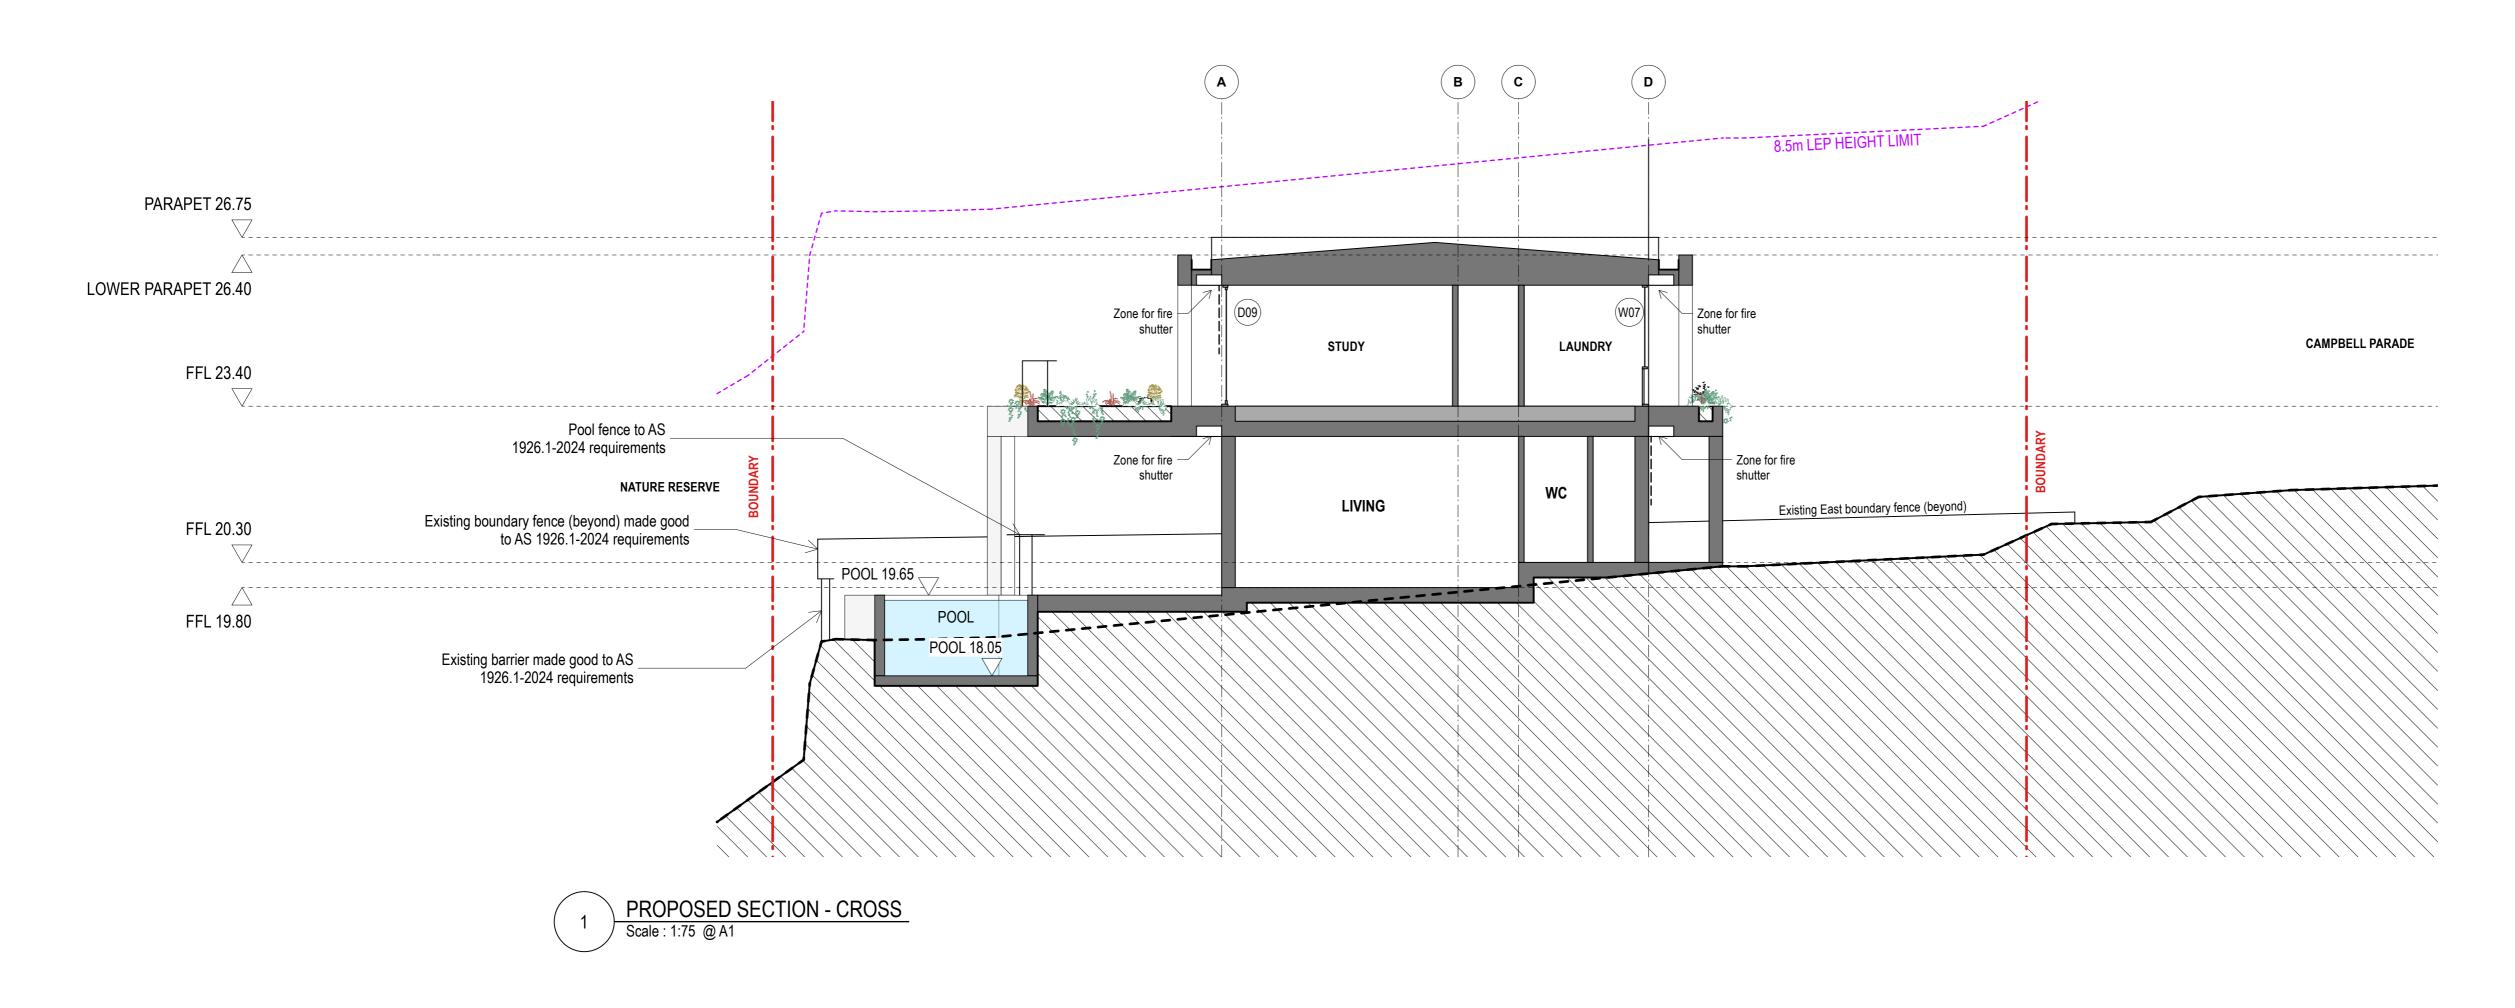Robyn Storer

PROJECT PROJECT ADRESS

Manly Vale


44 Campbell Parade,
Manly Vale

 SECTIONS - PROPOSED

 DWG NO.
 PROJECT NO.
 SCALE @ A1

 A402
 2403
 1:75

pa1 drawn checked MB TB

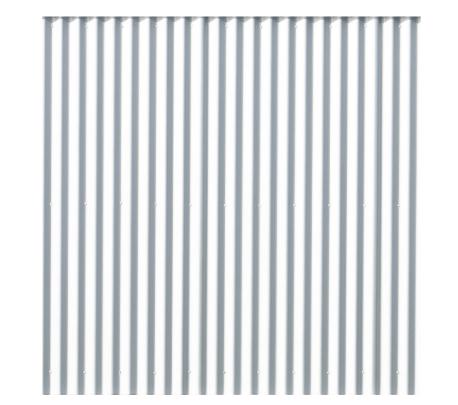

RFS-101 GREY METAL ROOF




BRK-101 LIGHT BRICK / LIGHT PAINTED BRICK




WD-01 ALUMINIUM FRAMED GLASS WINDOWS & DOORS




C0N-101 GREY CONCRETE / RENDER or BRK-101

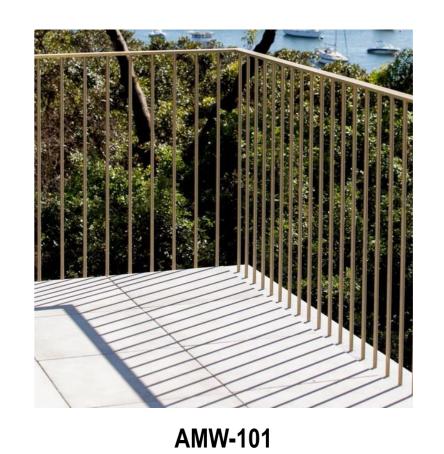

METAL BALUSTRADE

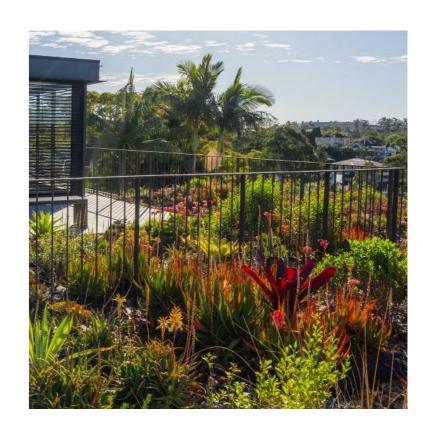


GREEN ROOF THE GREEN WALL ECO PILLOW SYSTEM OR EQUIVALENT

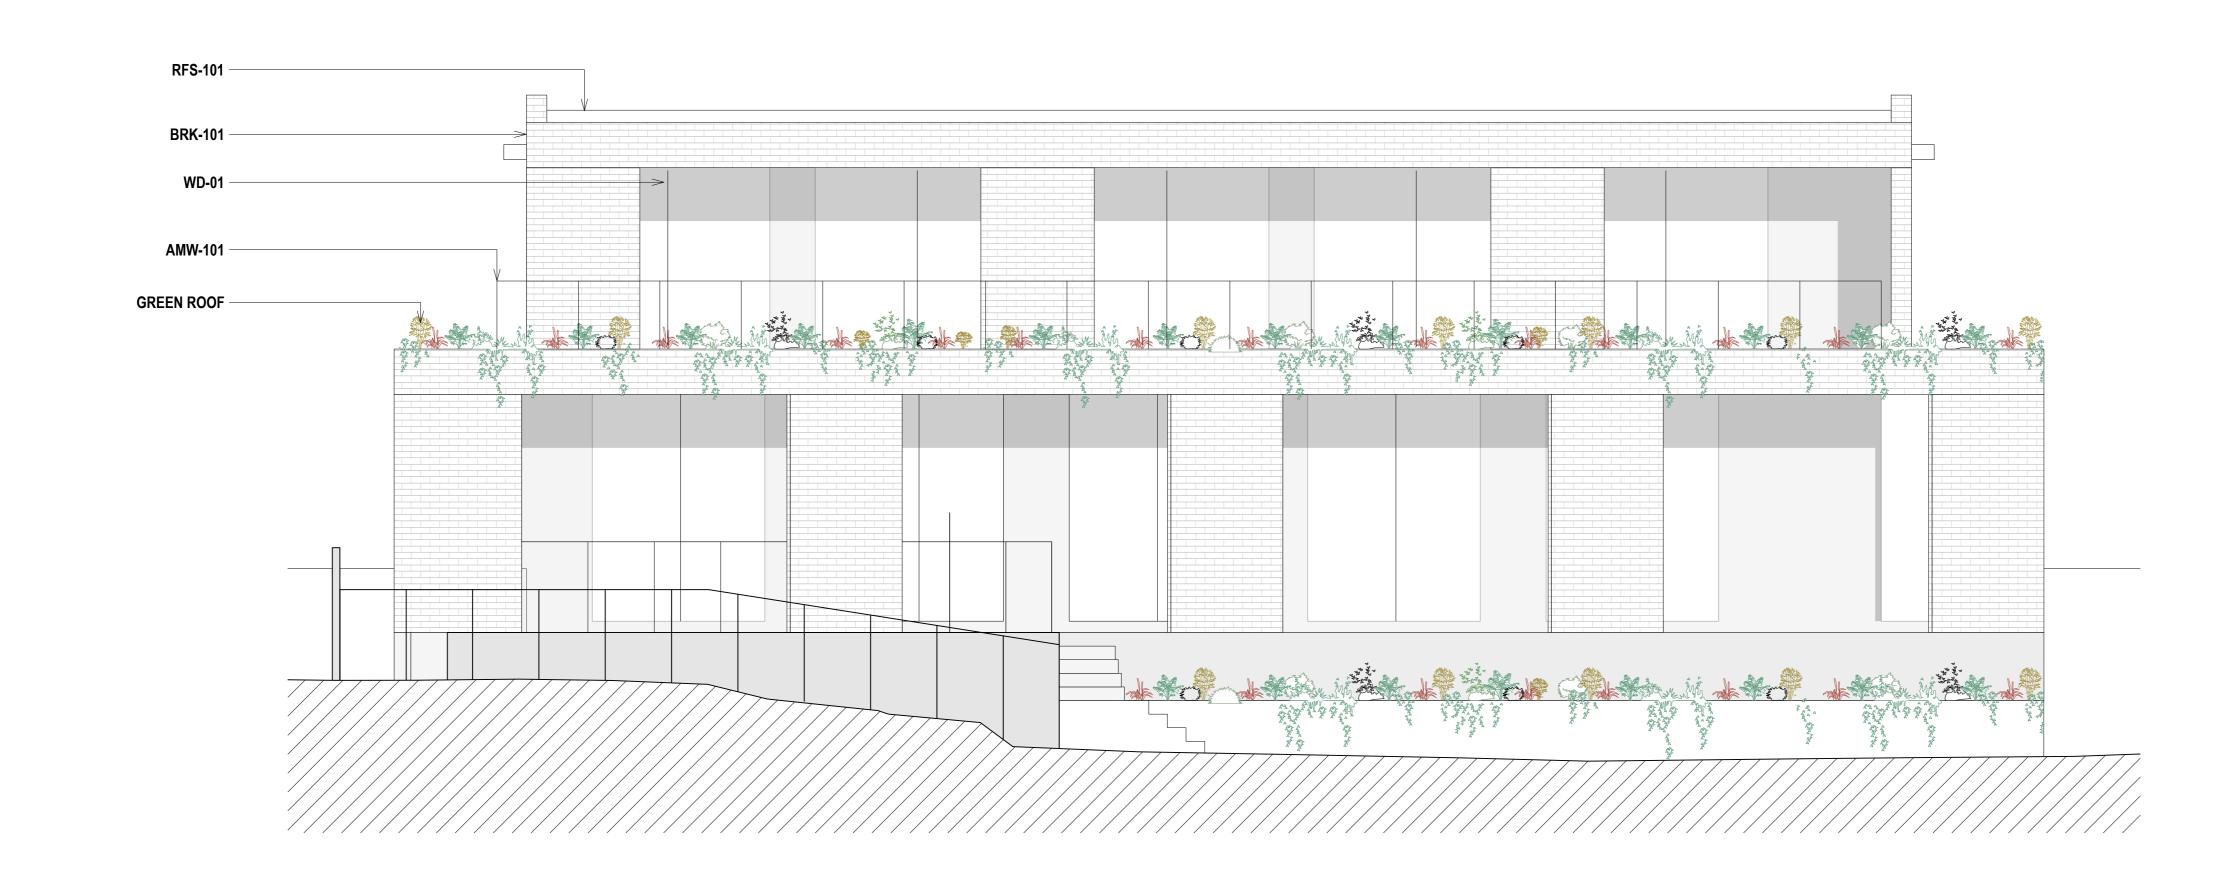


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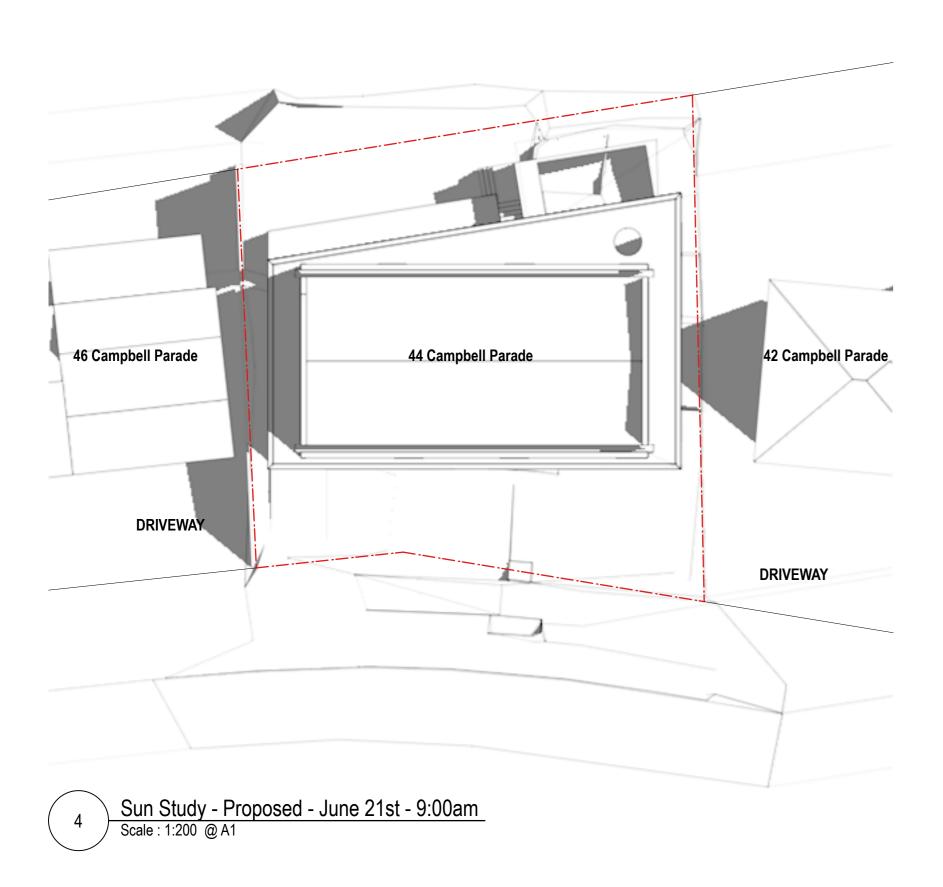
T: +61 0421 661 146

TB



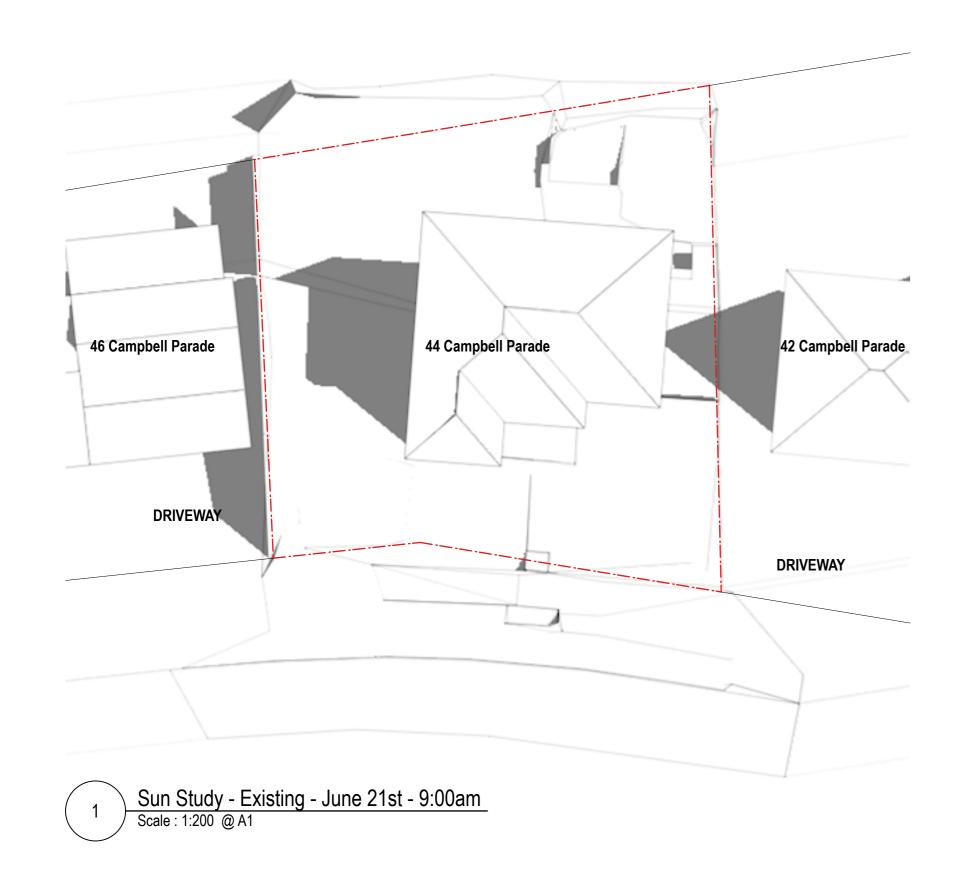

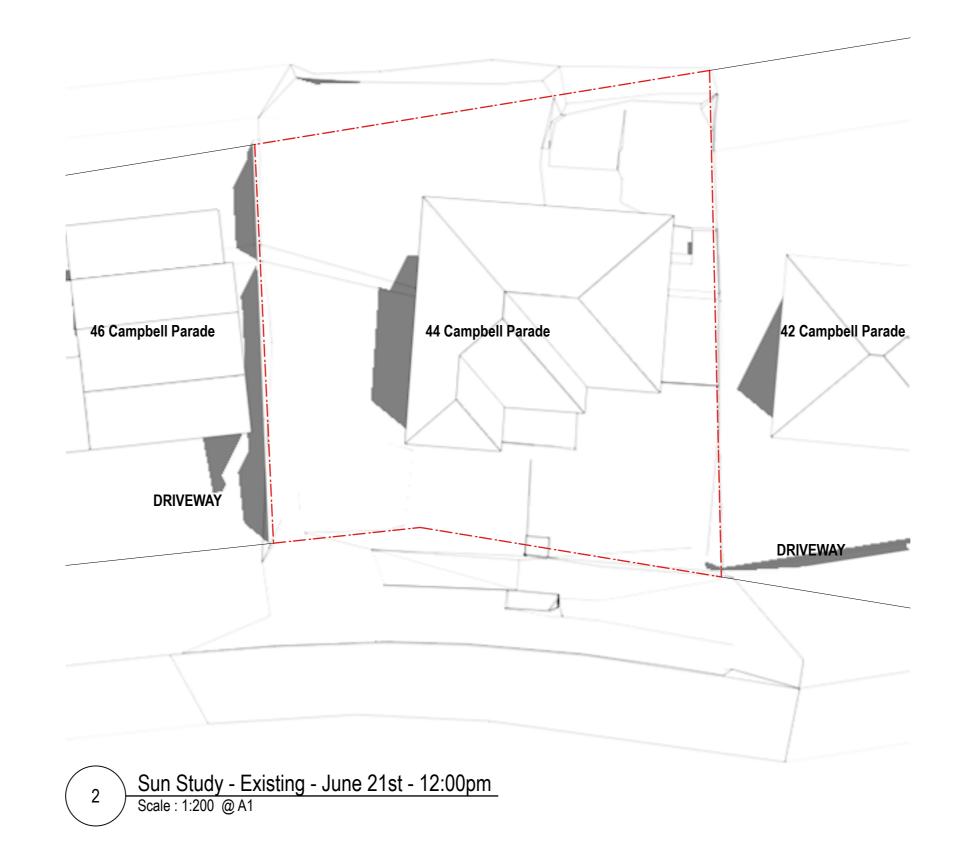




46 Campbell Parade

42 Campbell Parade

DRIVEWAY

DRIVEWAY

5 Sun Study - Proposed - June 21st - 12:00pm
Scale: 1:200 @ A1

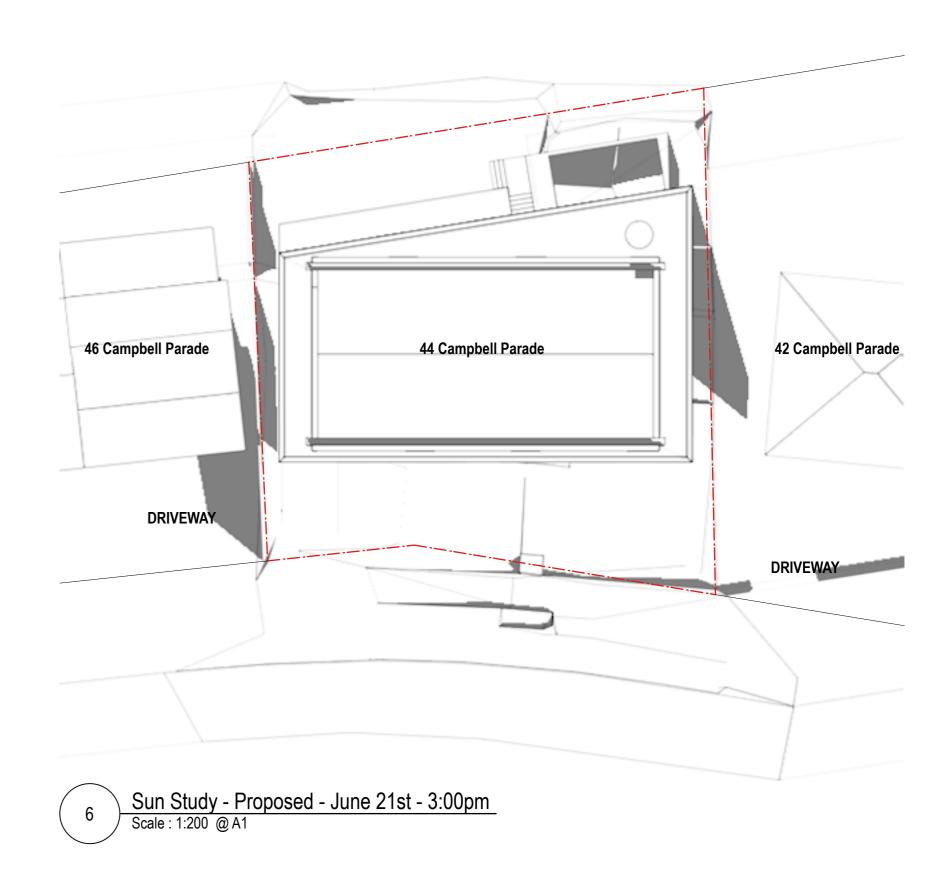

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Breakspear Architects Pty Ltd.

SPEAR
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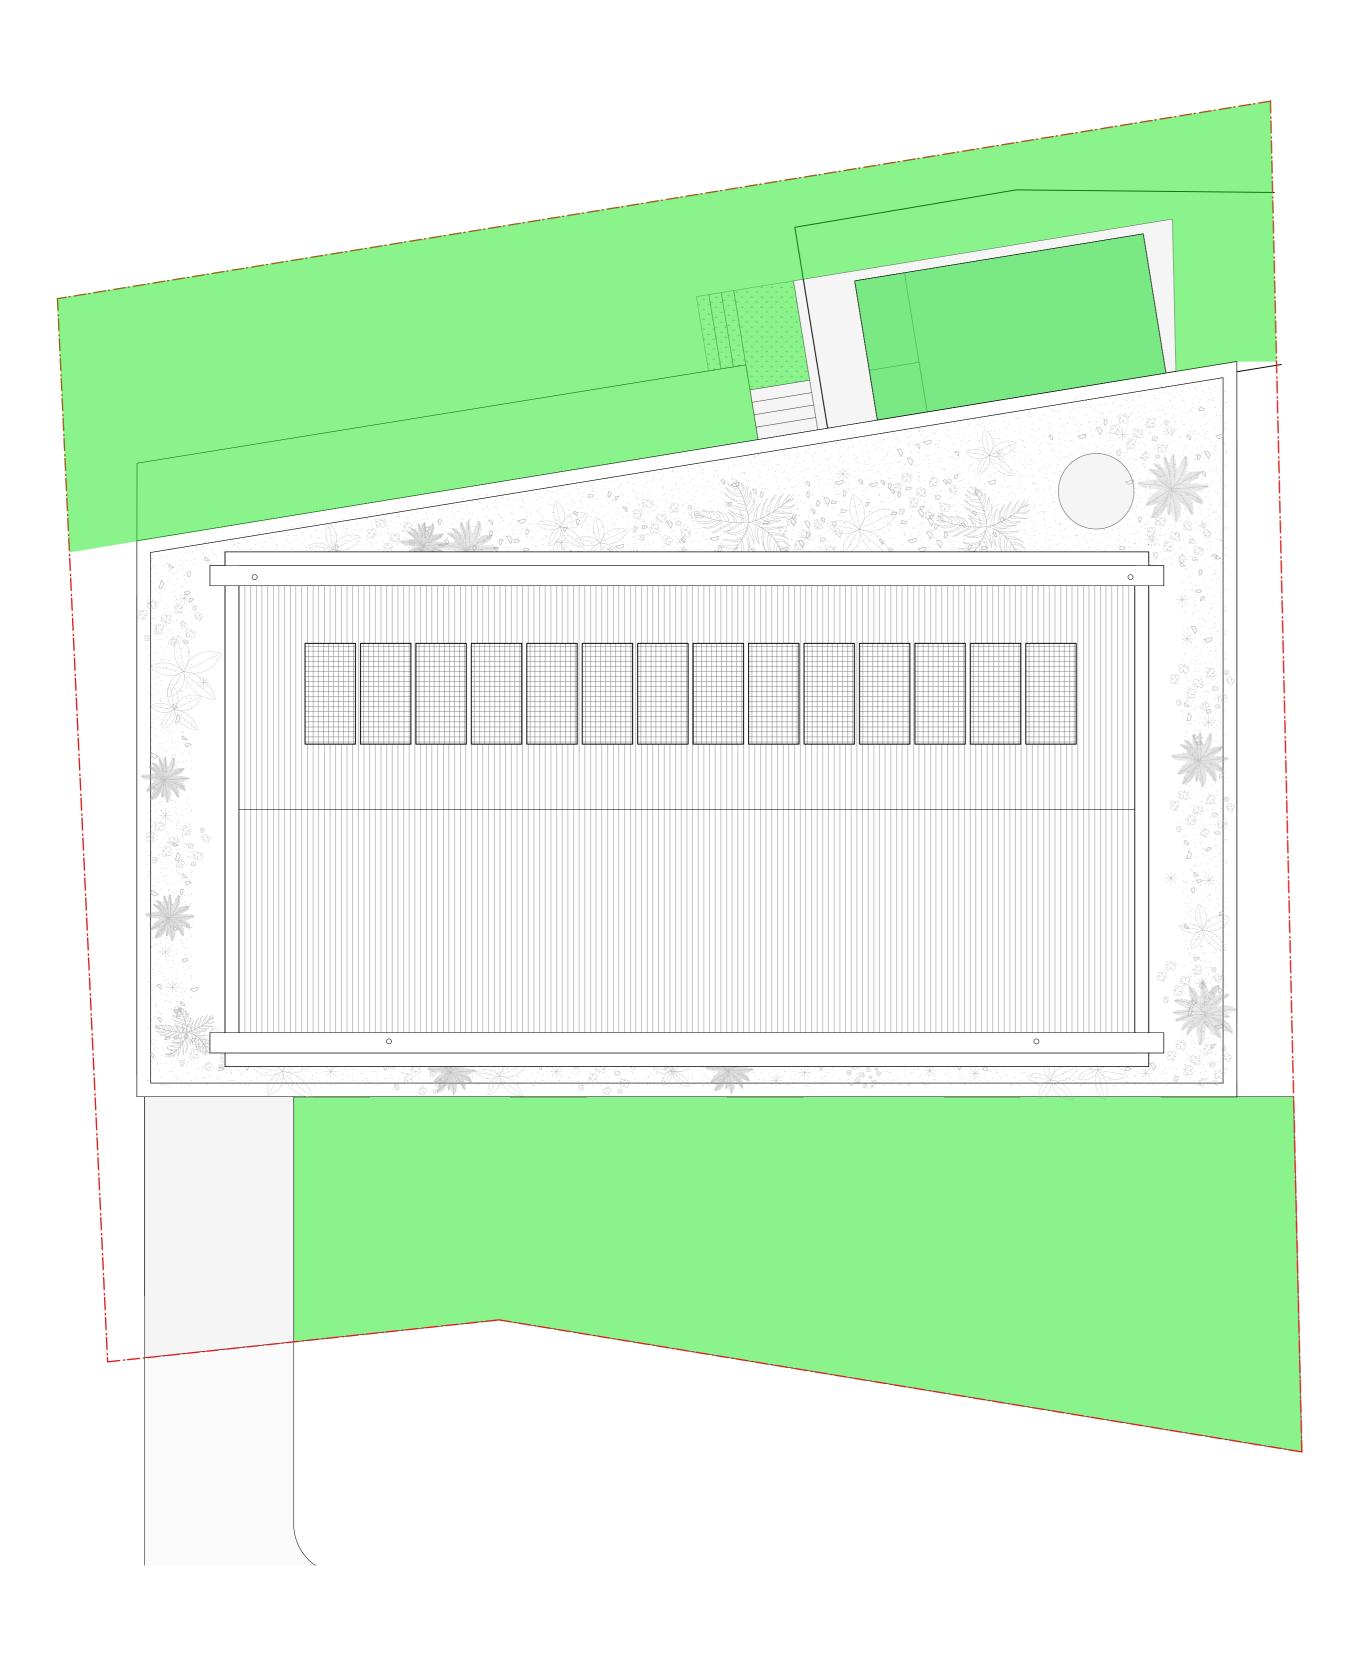
Robyn Storer

PROJECT PROJECT ADRESS

Manly Vale 44 Campbell Parade,
Manly Vale

SHADOW DIAGRAMS

DWG NO. PROJECT NO. SCALE @ A1 DRAWN CHECKED READ A502 2403 1:200 MB TB



1 PLAN - PROPOSED LANDSCAPE AREA
Scale : 1:75 @ A1

BREAK

LANDSCAPE AREA > 2M: 224.3 sqm SITE AREA: 556 sqm
LANDSCAPE AREA > 2M: 40% OF SITE AREA

Breakspear Architects Pty Ltd.

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