PROPOSED SWIMMING POOL 13 FRIENDSHIP PLACE, BEACON HILL, NSW 2100

DRAWING LIST -

SHEET:	TITLE:
H250_SP_00	COVER SHEET
H250_SP_01	SITE PLAN - EXISTING ARRANGEMENT
H250_SP_02	SITE PLAN - PROPOSED ARRANGEMENT
H250_SP_03	DETAILED PLAN - PROPOSED POOL

EXTERNAL CONSULTANT POOL PLANS -PRODUCED BY: THE LITTLE POOL CO. / RICKARD ENGINEERING

TITLE: SHEET:

TLPC 321-C

REFRESH 6m STANDARD (WITH TOP ENTRY SKIMMER)

TLPC 02-A GENERAL NOTES





LEVEL 3 397 RILEY STREET SURRY HILLS NSW 2010 PO BOX 1074 BROADWAY NSW 2007 TEL: + (61) 2 8039 7461 INFO@CPSPLANNING.COM.AU

DIMENSIONS: All dimensions are in millimetres unless otherwise noted. Do not scale from this drawing. Verify all dimensions on site prior to construction.

CIVIL, STRUCTURAL, HYDRAULIC, ELECTRICAL AND **SPECIALIST WATER FEATURE WORKS:**

Refer to specialist and consultant's drawings for all information contained within these documents relating to and nominated as specialist and consultant work. Specialist and consultant drawing information contained in the landscape documents are indicative only and not for construction or certification purposes.

Issue	Code	Issue Description	Ву	Chk	Date
Α	CA	FOR APPROVAL	NZ	GT	04.06.25

PROJECT

PROPOSED SWIMMING POOL 13 FRIENDSHIP PLACE, BEACON HILL

DRAWING TITLE

COVER SHEET

CLIENT

TRENT LANGLEY

Drawn : NZ Designed : NZ Project No.: H250

Sheet number H250_SP_00 REVISION





LEVEL 3 397 RILEY STREET SURRY HILLS NSW 2010 PO BOX 1074 BROADWAY NSW 2007 TEL: + (61) 2 8039 7461 INFO@CP\$PLANNING.COM.AU

DIMENSIONS:

All dimensions are in millimetres unless otherwise noted. Do not scale from this drawing.

Verify all dimensions on site prior to construction.

CIVIL, STRUCTURAL, HYDRAULIC, ELECTRICAL AND SPECIALIST WATER FEATURE WORKS:

Refer to specialist and consultant's drawings for all information contained within these documents relating to and nominated as specialist and consultant work. Specialist and consultant drawing information contained in the landscape documents are indicative only and not for construction or certification purposes.

	Issue	Code	Issue Description	Ву	Chk	Date	
	A	СА	FOR APPROVAL	NZ	GT	04.06.25	
PRE - Preliminary CA - Council Approval T - Tender CON - Constr							

PROJECT

PROPOSED SWIMMING POOL 13 FRIENDSHIP PLACE, BEACON HILL

DRAWING TITLE

SITE PLAN EXISTING ARRANGEMENT CLIENT

TRENT LANGLEY

Drawn : NZ Designed : NZProject No.: H250 Bar Scale 1:100 @ A1 / 1:200 @ A3 SHEET NUMBER H250_SP_01 REVISION Α






LEVEL 3 397 RILEY STREET SURRY HILLS NSW 2010 PO BOX 1074 BROADWAY NSW 2007 TEL: + (61) 2 8039 7461 INFO@CP\$PLANNING.COM.AU

DIMENSIONS:

All dimensions are in millimetres unless otherwise noted. Do not scale from this drawing. Verify all dimensions on site prior to construction.

CIVIL, STRUCTURAL, HYDRAULIC, ELECTRICAL AND **SPECIALIST WATER FEATURE WORKS:**

Refer to specialist and consultant's drawings for all information contained within these documents relating to and nominated as specialist and consultant work. Specialist and consultant drawing information contained in the landscape documents are indicative only and not for construction or certification purposes.

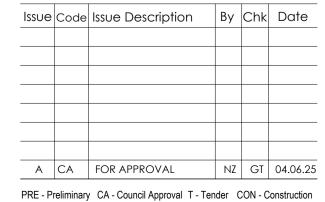


PROJECT


PROPOSED SWIMMING POOL 13 FRIENDSHIP PLACE, BEACON HILL

DRAWING TITLE

SITE PLAN PROPOSED ARRANGEMENT CLIENT

TRENT LANGLEY

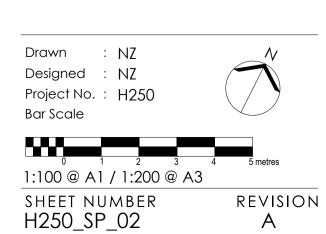

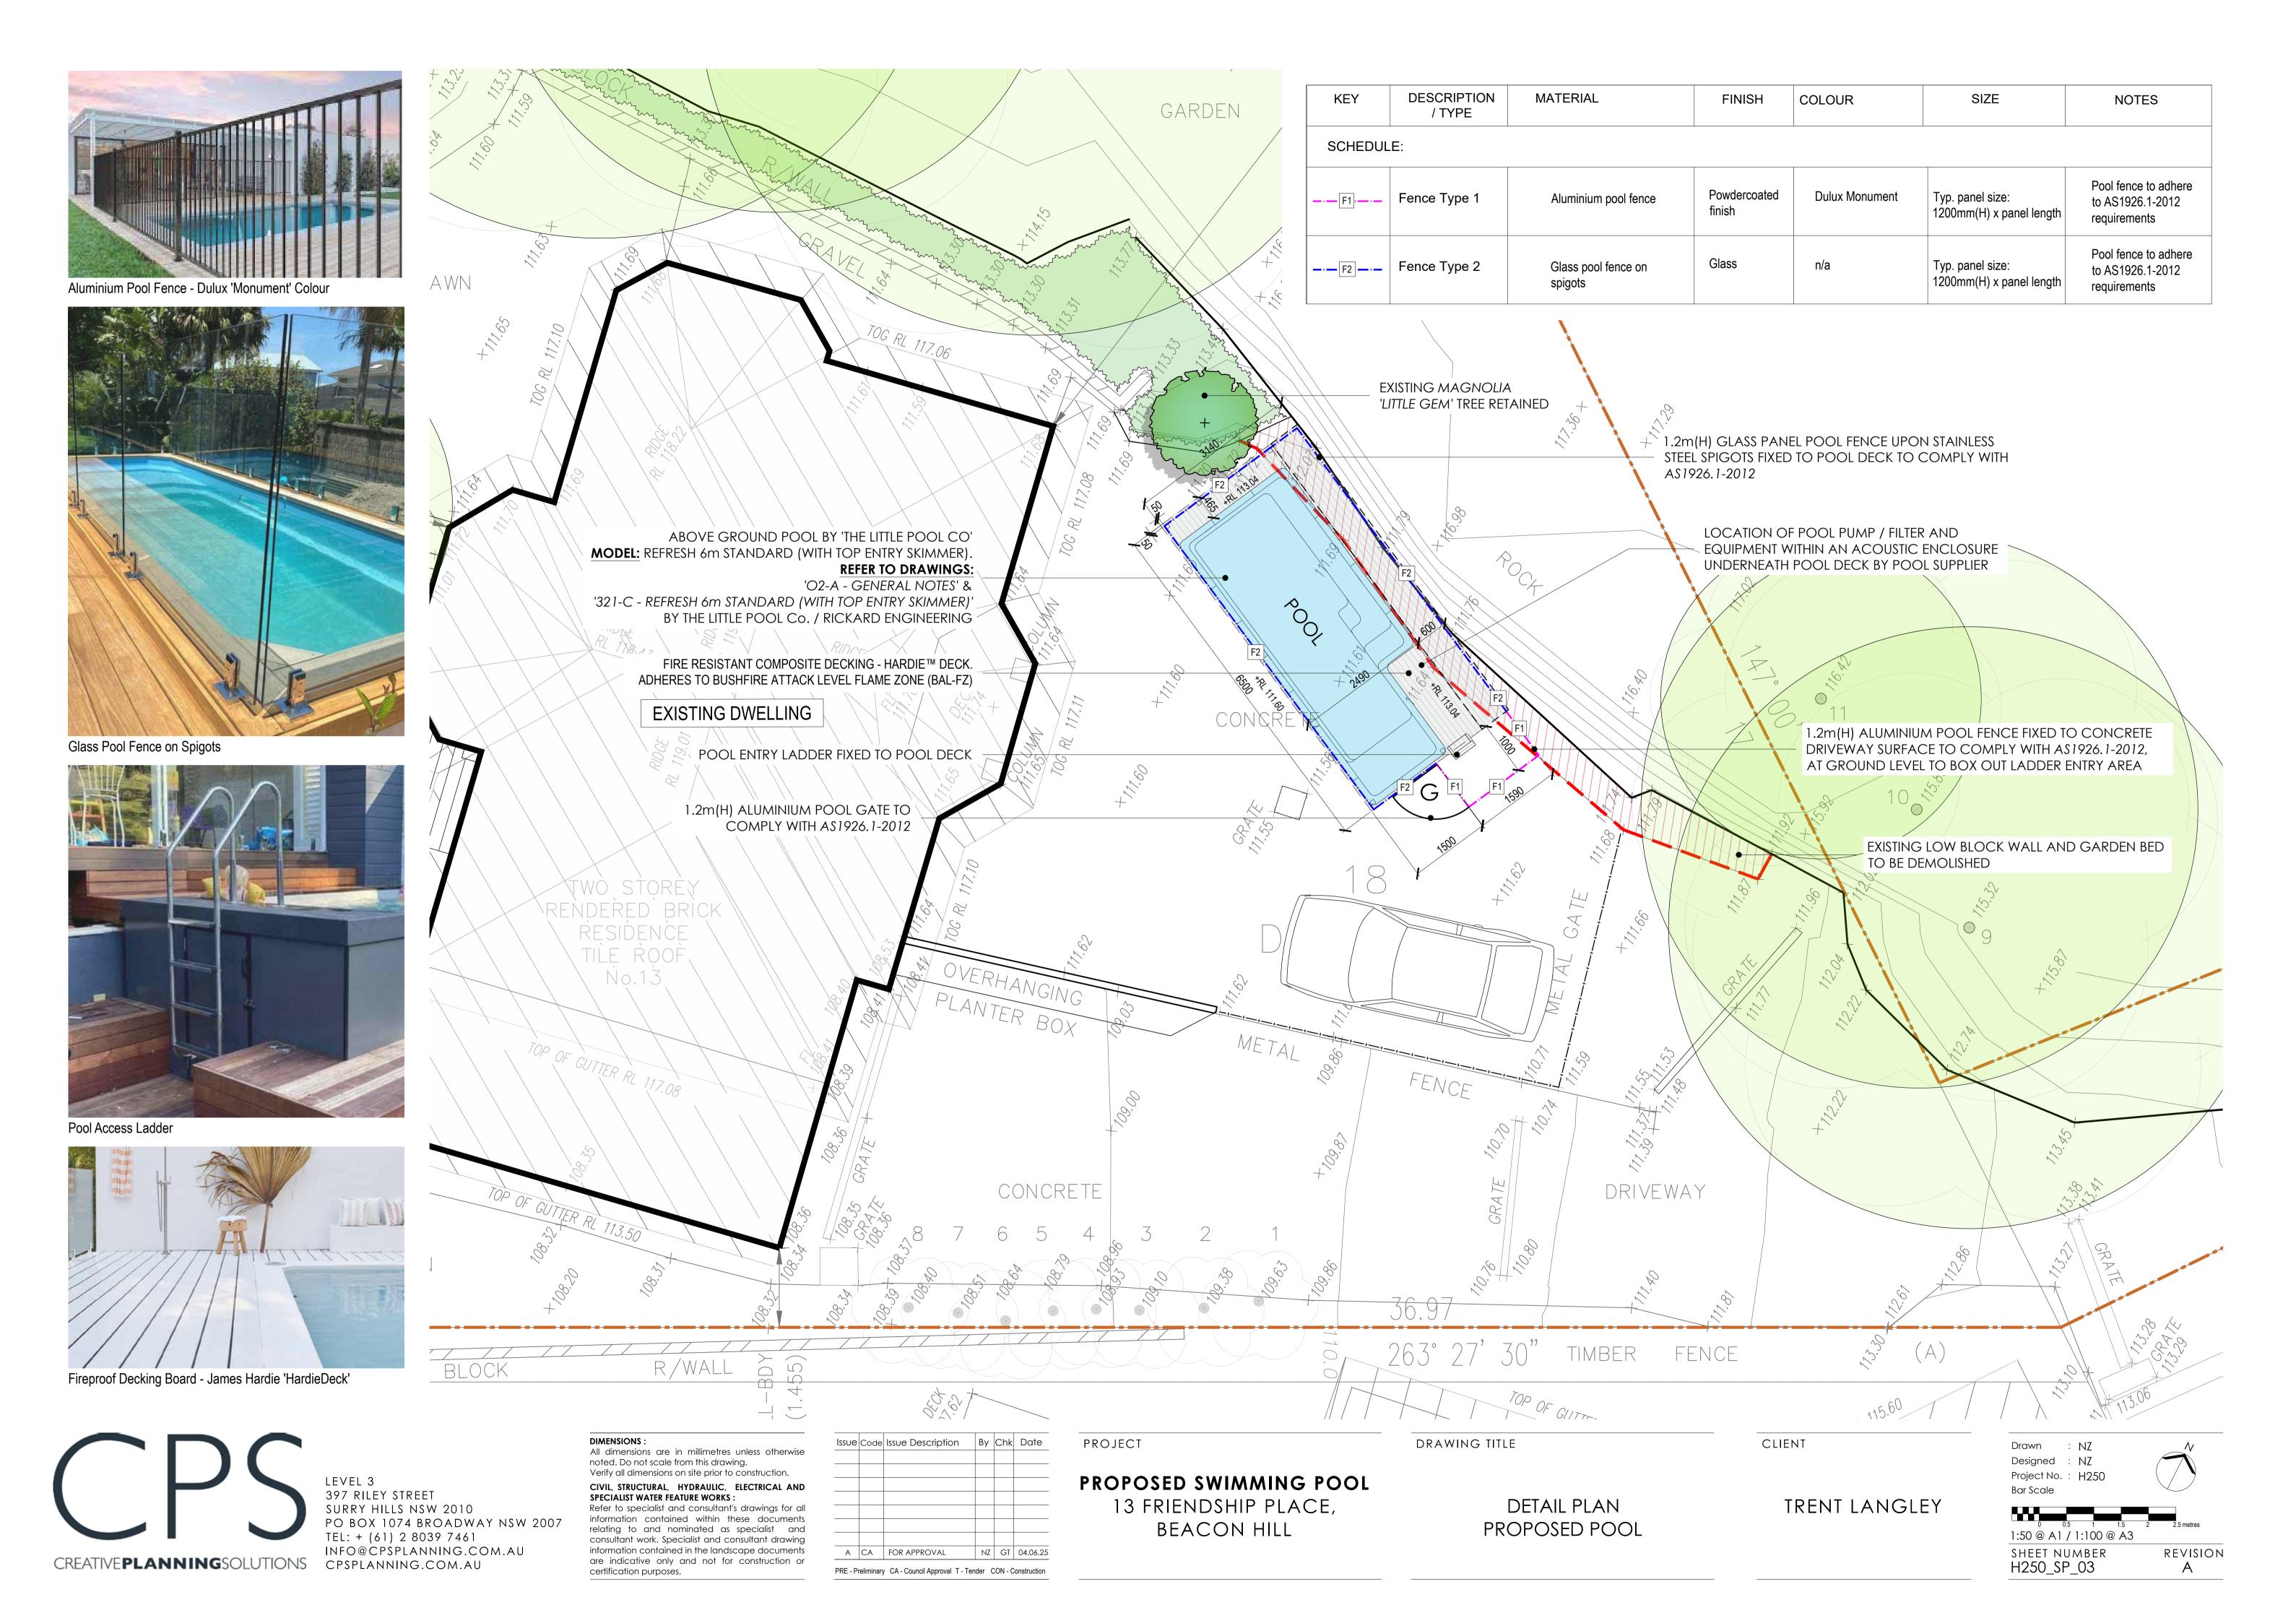

General

The Little Pool Co. provides a one piece self—supporting fiberglass pool which is sprayed over a mould and then strengthened with GRP exoskeleton. The exoskeleton and pool shell are connected together with stainless steel bolts together with adhesive. The Little Pool Co provides a range of pools which the 300 series drawings cover the installation Engineering requirements. When installed in accordance with Little Pool Co installation engineering drawings, the pools comply with applicable requirements of the following codes:

- AS 1839 (2021)
- AS 1838 (2021)

The Little Pool Co's pools come with the following additions to the standard pool:

- 1. Fiberglass extensions for pool covers (drawing 320)
- 2. Piered slab for sloping sites, bearing issues and sewers (drawing 402)
- 3. Timber deck design together with connection to exoskeleton (drawing 403 and 404)
- 4. Steel deck design together with connection to exoskeleton (drawing 409 and 404)
- 5. Requirements for in ground installation up to 600mm (drawing 405)
- 6. Balustrade fixing detail to pool exoskeleton (drawing 407)
- 7. Requirements for tiled finishes (drawing 408)
- 8. Requirements for installation on a paver base on ground (drawing 411)
- 9. Requirements for installation on a paver base in ground up to 600mm (drawing 415)

Note: The Little Pool Co. standard engineering drawings 00, 1300, and 1400 series can only be used for residential projects. For commercial projects, a registered design engineer with the appropriate experience needs to be engaged to ensure the Little Pool Co. pool meets the requirements of the site. Little Pool Co holds no responsibility for the use of their pools on commercial projects unless a site specific design is provided by a registered design professional prior to the purchase of the product.

Planning and Design:

- 1. It is important that all pool installations are approved by the relevant authority.
- 2. All planning documentation needs to comply with applicable requirements of the codes noted above, together with all Little Pool Co engineering requirements.
- 3. The ground conditions must be investigated to ensure the proposed installation method is appropriate for the site, this investigation should be provided to the pool owner.
- 4. A registered design professional with the appropriate qualifications needs to confirm that the ground conditions meet the requirements outlined within the Little Pool Co standard engineering.
- 5. A registered/licensed contractor must be engaged to complete structural building works related to the pool installation.
- 6. If the site is not deemed to suit the standard engineering by a registered design professional or registered/ licensed contractor, then site specific design solution needs to be completed prior to commencement of construction works. The design solution needs to comply with the requirements outlined within the Little Pool Co standard engineering.
- 7. If you have not been provided with the 400 series drawing set, contact your local agent prior to finalising your planning and design. Refer to The Little Pool Co. Drawing Register 01 for information.

Installation Methods

On Ground:

The Little Pool Co. requirements for pools installed on ground are covered in 300 series drawings, together with drawing 401 or 411. The pool requires a slab or paver base under it which is bearing onto uniform ground, which achieves at least 25 kPa. The finished surface level of the slab under the pool is required to be within \pm 5mm. For sites with poor ground conditions, slope stability issues or zones of influence, the pool can be supported on top of a piered slab. The requirements of the piered slab can be found in drawing 402. It is the pool owners and/or builders' responsibility to ensure that the site conditions are investigated but a suitable qualified engineer. If additional engineering is required to provide a uniform supporting base for the pool, then a suitable qualified engineering needs to be consulted.

In Ground:

The Little Pool Co. allows pools to be installed within the ground up to 600mm. The standard engineering for this type of installation is covered in drawing 405 (installed on a slab) or drawing 415 (installed on pavers).

Above Ground:

The Pools can also be installed on platforms above the ground, the requirements for this type of install is covered on drawing 406. The critical point to remember is that for all platforms supporting a little pool, the maximum deflection allowed is span/500. Additional to this is the finished surface level of the platform needs to be within \pm 5mm. Site specific certification is to be provided for all above ground installations by a suitably qualified engineer.

COPYRIGHT

All rights reserved.

These drawings, plans and specifications and the copyright therein are the property of The Little Pool Co. and must not be used, reproduced or copied wholly or in part without the written permission of The Little Pool Co.



INSTANT POOLS • TIMELESS STYLE

Proudly Manufactured By

19 School Drive, Tomago N.S.W. 2322 Ph: 1300 223 677 Email: info@littlepools.com.au



ACN 086 874 222

RICKARD

Specialist Civil & Structural Engineering Services
Suite 5, 121 Military Road, Neutral Bay, Sydney, NSW 2089, Australia
Phone: (+61) 2 9904 5610 www.rickardengineering.com ABN 47 164 127 468

STRUCTURAL DETAILS APPROVED BY CE RICKARD, M.Sc, FIStruct.E, FIE(Aust), MIPENZ QLD: RPEQ 2485 VIC: PE0003927 NSW: NPER 73285 NZ: PSA3584

GENERAL NOTES



Designed CER

Drawn

02A

THIS SHEET PROVIDES REFERENCE FOR ALL POOL DESIGNS AND RELATED DETAILS OF THE LITTLE POOL CO. RANGE. FURTHER INFORMATION IS AVAILABLE ONLY THROUGH SPECIFIC WRITTEN APPROVAL FROM A DIRECTOR OF THE LITTLE POOL CO.