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DA SUBMISSION

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Scale Bar 1:100

2m

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43 Old Pittwater Road, Brookvale, NSW2100

JUL 2018

1:100

TITLE JOB No. DATE SCALE Section 3 DWG No. DA202 A



EAST ELEVATION



WEST ELEVATION 2

DA SUBMISSION

43 Old Pittwater Road, Brookvale, NSW2100







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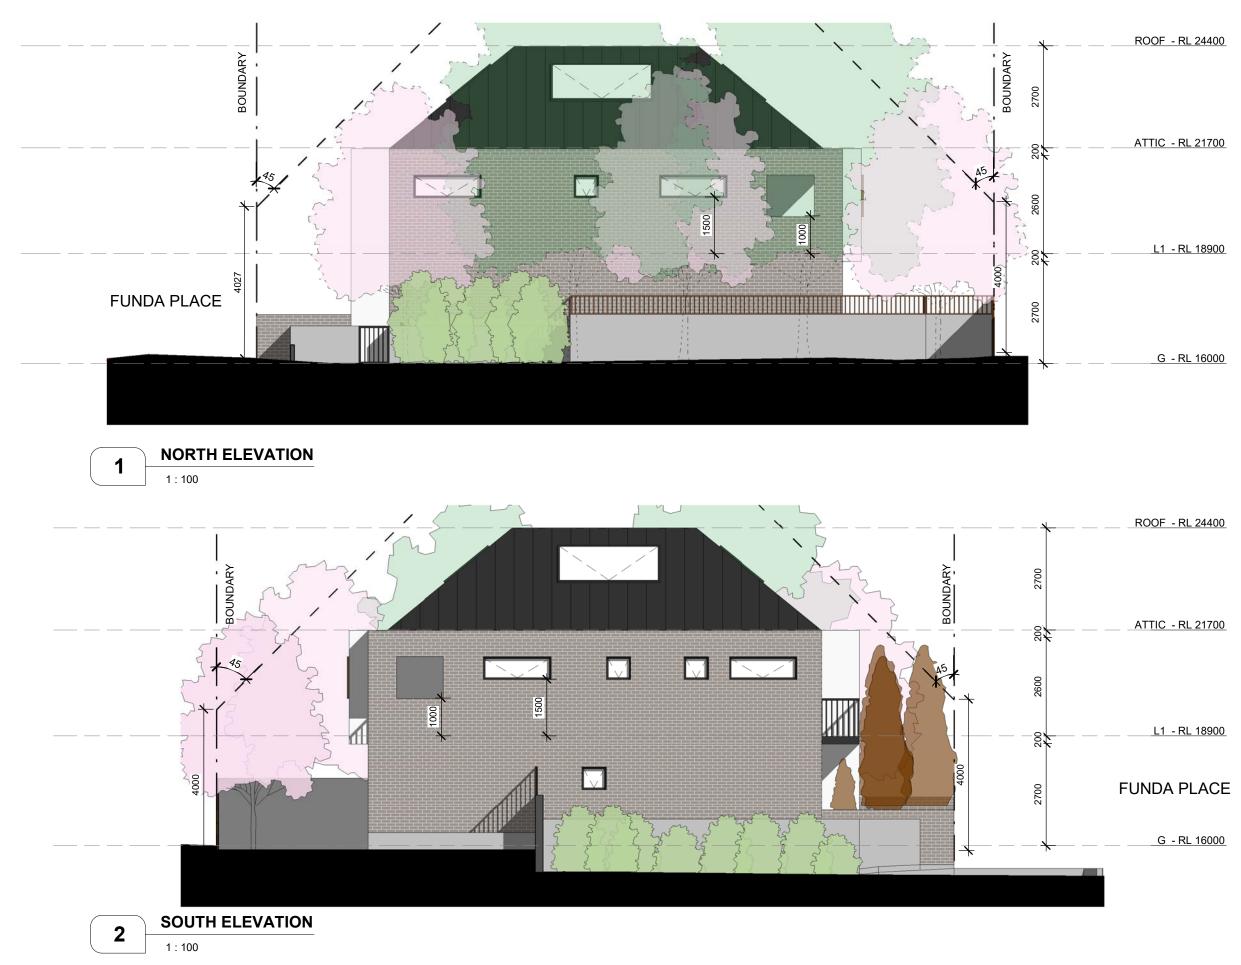
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TITLE

JOB No. DATE JUL 2018 SCALE Elevations - East and West DWG No. DA300 A







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43 Old Pittwater Road, Brookvale, NSW2100

TITLE 1m 2m Scale Bar 1:100

JOB No. DATE JUL 2018 SCALE 1:100 Elevations - North and South DWG No. DA301 A



DA SUBMISSION

43 Old Pittwater Road, Brookvale, NSW2100







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JOB No. HH01 DATE JUL 2018 SCALE DWG No. DA400 A

43 OLD PITTWATER ROAD, BROOKVALE LANDSCAPE DOCUMENT SET FOR DA

Drawing Register

No.	Title	Issue
LA-00	Cover Sheet	В
LA-01	Landscape Plan	В
LA-02	Landscape Plan	В
LA-03	Planting Palette	В
LA-04	Details and Specification	В

General Notes.

1. Location and spread of existing trees are indicative only. Locations are shown based on a combination of site survey and arborist report. 2. Refer to architect's drawings for fnishes and proposed RLs of architectural walls, exterior division partition walls, proposed clothes line locations, privacy fences and proposed concrete driveway. 3. Refer to stormwater engineer's drawings for final location of pits/ drain, underground OSD tank and top of pit levels.

4. This documentation set including typical details and specification notes is prepared for DA purpose only. It shall not be used for construction.

Area Calculation

	Site Boundary Total Site Area:	613.4m²
	Proposed External Landscaped Area Required External Landscaped Area Percentage:	50%
[]+[]	Type 1 Total External Landscaped Area: Total External Landscaped Area Percentage:	307m ² 50%
	Type 2 Deep Soil Landscape Area*: Deep Soil Landscape Area Percentage	253m² 41.2%
[]	Private Open Space (including balcony above) TH1 Total: TH2 Total: TH3 Total: TH4 Total:	76m² 44m² 44m² 71.5m²

^{*} Deep soil landscape area include areas with a minimum 1m soil depth, and exclude any hard paved surfaces/decks, and areas less than 1m wide in each direction

Existing Tree Schedule

ID	BOTANICAL NAME	COMMON NAME	HEIGHT(m)	SPREAD(m)	TPZ	COMMENT			
TREES	TREES TO BE RETAINED								
T6	Banksia ericifolia	Heath-leaved Banksia	5m	2m	2.0m	in neighbour's property			
T7	Tristaniopsis laurina	Water Gum	5m	2m	2.4m	in neighbour's property			
T9	Corymbia eximia	Yellow Bloodwood	11m	4m	5.6m	street tree			
TREES	S TO BE REMOVED								
T1	Nerium oleander	Oleander	4m	2m	-	to be removed			
T2	Cupressus sempervirens	Italian Cypress	10m	1.5m	-	to be removed			
T3	Nerium oleander	Oleander	6m	3m	-	to be removed			
T3a	Pittosporum undulatum	Sweet Pittosporum	7m	2m	-	to be removed			
T4	Araucaria heterophylla	Norfolk Island Pine	13m	4m	-	to be removed			
T5	Melaleuca bracteata	Black Tea Tree	8m	3.5m	-	to be removed			
T8	Glochidion ferdinandi	Cheese Tree	7m	2.5m	-	to be removed			

NOTE:

Tree heights and TPZ as per arboricultural impact assessment prepared by Urban Arbor, dated 08 August 2018.



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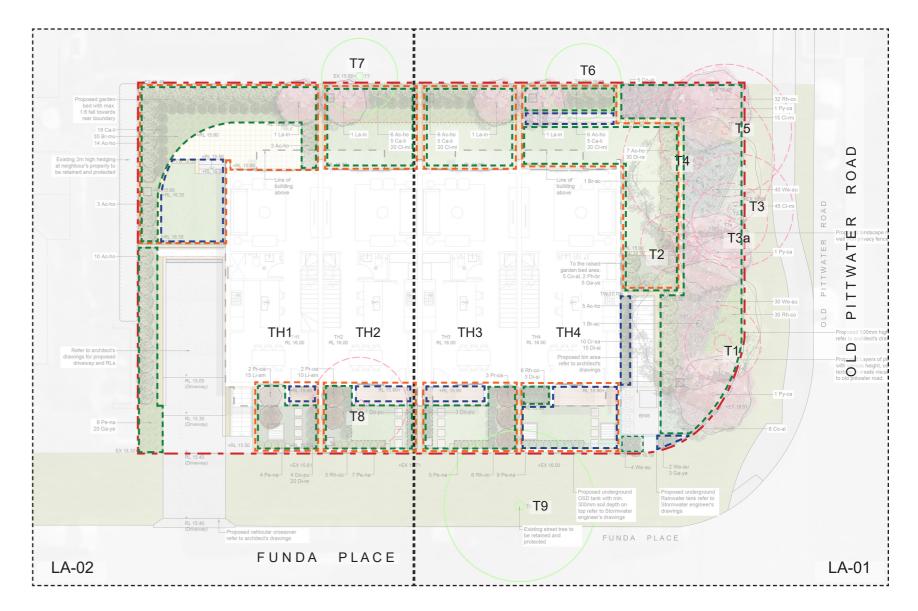
Landscape Design Statement

The proposed landscape design aims to created an oasis with a balance of low maintenance native plants and exotic deciduous trees where suitable for visual amenity and winter solar access. The landscape design include front courtyards, private backyards, and buffer planting zone along Old Pittwater Road frontage. Design strategy for each area as follows:

The front courtyards aim to enhance the sense of arrival by providing layers of planting with deciduous trees, shrubs and turf with stepping stones. The backyard aims to achieve leveled turf areas for outdoor activities with screen planting along rear boundary for privacy, and deciduous feature trees for visual amenity and winter solar access.

The planting buffer zone along Pittwater Road frontage aims to mitigate the visual impact of building facade and provide rich sensory experience to pedestrians. This is achieved by a great collection of tall canopy evergreen trees, small deciduous flowering trees, screening shrubs, and a combination of groundcover species.

Drip irrigation system is proposed to optimise establishment of plants and mitigate maintenance requirements afterwards. Private landscape areas including turf to be maintained by residents.






43 Old Pittwater Road, Brookvale ARCHITECT: EnHance Project Group Pty Ltd CHECKED: DATE CREATED: JOB NUMBER 10 AUG 2018

COVER SHEET LA-00

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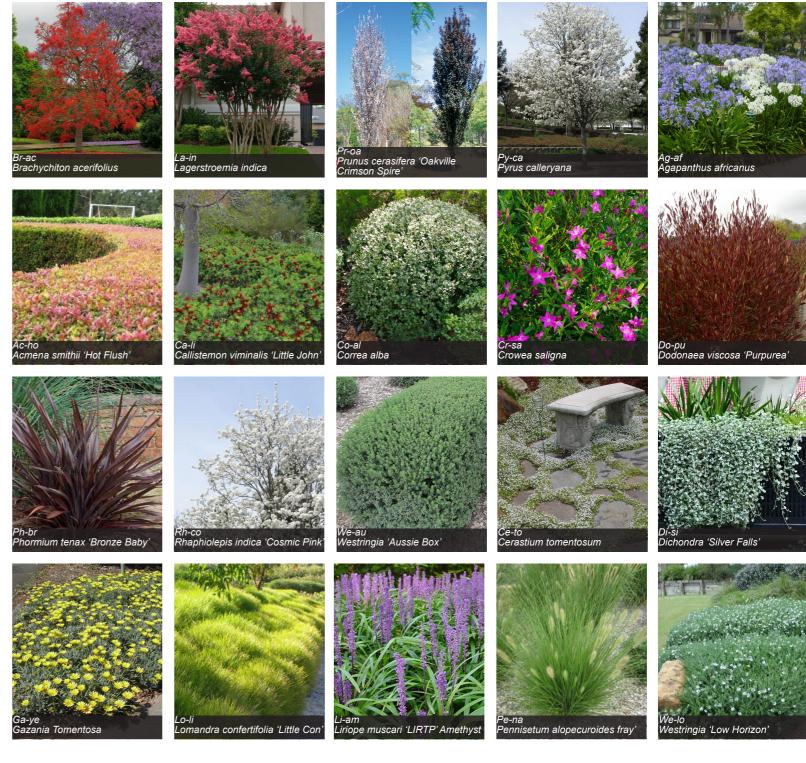


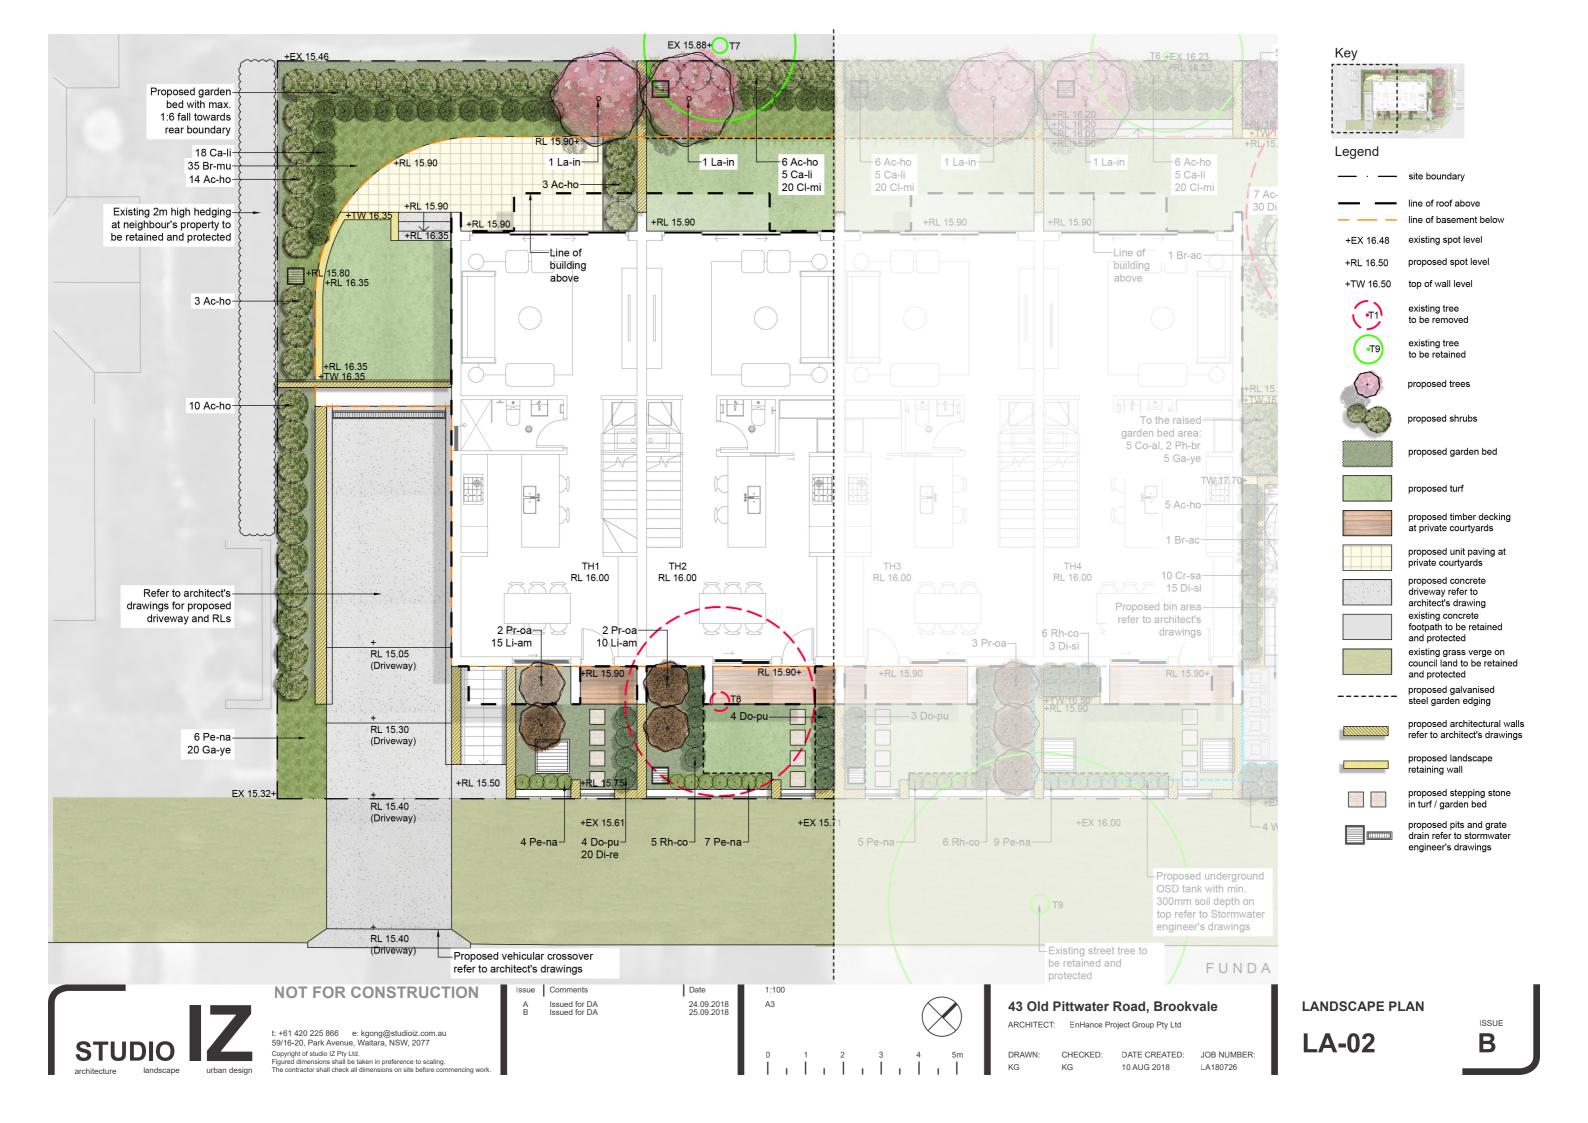

Planting Schedule

ID	BOTANICAL NAME	COMMON NAME	POT SIZE	MATURE HEIGHT	SPREAD	SPACING	Native	QTY
Trees								
Br-ac	Brachychiton acerifolius	Illawarra Flame Tree	75lt	25m	5m	As Shown	Yes	2
La-in	Lagerstroemia indica	Crepe Myrtle	45lt	6m	3m	As Shown	No	4
Pr-oa	Prunus cerasifera 'Oakville Crimson Spire'	Ornamental Plum	45lt	6m	2m	As Shown	No	7
Py-ca	Pyrus calleryana	Callery Pear	45lt	8m	5m	As Shown	No	3
Shrubs						<u> </u>		
Ag-af	Agapanthus africanus	Agapanthus	200mm	0.6m	0.6m	6/m2	No	-
Ac-ho	Acmena smithii 'Hot Flush'	Lilly Pilly	200mm	3m	1m	0.8m centres	Yes	-
Ca-li	Callistemon viminalis 'Little John'	Little John Bottlebrush	200mm	0.8m	0.8m	4/m2	Yes	-
Co-al	Correa alba	White Correa	200mm	1.5m	1m	0.8m centres	Yes	-
Cr-sa	Crowea saligna	Willow Leaf Crowea	200mm	0.8m	0.8m	0.5m centres	Yes	-
Do-pu	Dodonaea viscosa 'Purpurea'	Purple Hop Bush	200mm	2.5m	1.5m	As Shown	Yes	-
Ph-br	Phormium tenax 'Bronze Baby'	Bronze Baby Flax	140mm	0.75m	0.8m	As Shown	No	-
Rh-co	Rhaphiolepis indica 'Cosmic Pink'	Indian Hawthorn	200mm	0.8m	0.8m	0.4m centres	No	-
We-au	Westringia 'Aussie Box'	Aussie Box	200mm	0.8m	0.8m	0.5m centres	Yes	-
Groundo	overs							
Br-mu	Brachyscome multifida	Native Daisy	150mm	0.2m	0.3m	8/m2	Yes	-
Ce-to	Cerastium tomentosum	Snow in Summer	tube	0.1m	0.5m	7/m2	No	-
Cl-mi	Clivia miniata	Kaffir Lily	150mm	0.5m	0.5m	5/m2	No	-
Di-re	Dichondra repens	Kidney Weed	tube	0.2m	1.5m	6/m2	Yes	-
Di-si	Dichondra 'Silver Falls'	Kidney Weed	tube	0.2m	1m	6/m2	Yes	-
Ga-ye	Gazania Tomentosa	Silver Gazania	150mm	0.15m	1m	4/m2	No	T -
Lo-li	Lomandra confertifolia 'Little Con'	Little Con Grassy Mat-rush	140mm	0.3m	0.3m	9/m2	Yes	-
Li-am	Liriope muscari 'LIRTP' Amethyst	Amethyst Liriope	100mm	0.4m	0.4m	6/m2	No	-
Pe-na	Pennisetum alopecuroides 'Nafray'	Nafray Pennisetum	200mm	0.6m	0.6m	0.4m centres	Yes	-
We-lo	Westringia 'Low Horizon'	Low Horizon	200mm	0.3m	0.7m	3/m2	Yes	-
* Shrub a	I nd Groundcover quantity to be calculated at C	 C stage.						+

Planting Palette





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Date 24.09.2018 25.09.2018 NTS A3

43 Old Pittwater Road, Brookvale

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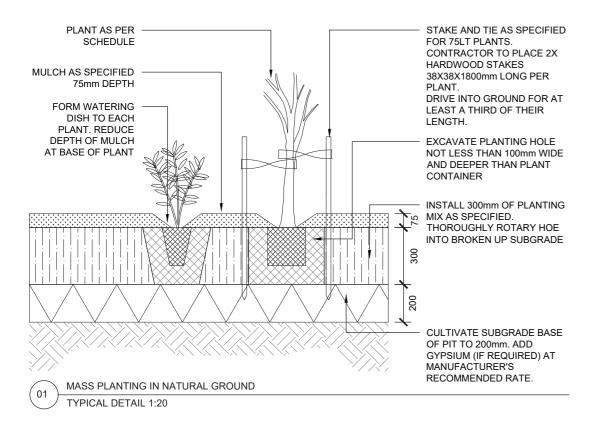
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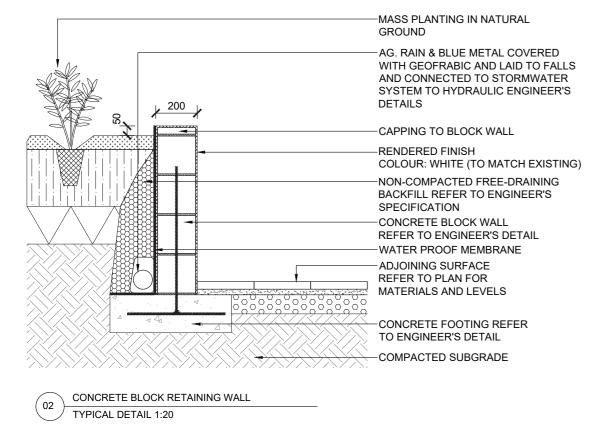
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PLANTING PALETTE

LA-03

B





Landscape Specification

Genera

Maintenance shall mean the care and maintenance of the landscape works by accepted horticultural practice as rectifying any defects that become apparent in the landscape works under normal use. The landscape contractor shall attend the site on a weekly basis to maintain the landscape works for the full term approved at CC stage of the maintenance period (commencing from practical completion).

Rubbish Removal

During the term of the maintenance period the Landscape Contractor shall undertake rubbish removal from the site on a weekly basis to ensure the site remains in tidy condition.

Weed Eradication

Weed growth that may occur in, planted or mulched areas is to be removed using environmentally acceptable methods i.e. nonresidual glyphosate herbicide, (e.g. 'Roundup', applied in accordance with the manufacturer's directions) or hand weeding.

Tree Replacement

Trees shall show signs of healthy vigorous growth and be free from disease and not exhibit signs of stress prior to handover to the client. Any trees or plant that die or fail to thrive, or are damaged or stolen will be replaced. Replacement material shall have the maintenance period extended in accordance with the landscape contract conditions. Trees and plant materials shall be equal to the minimum requirements of species specified and approved material delivered to site. Should the condition decline from the approved sample the Superintendent reserves the right to reject the tree / plants. Frequency: as required.

Pruning

Selective pruning may be required during the establishment period to promote a balanced canopy structure. These activities shall be carried out to the best horticultural and industry practice. All pruned material is to be removed from site.

<u>Irrigation</u>

A low volume drip irrigation system may be installed at the discretion of the Developer. Position of control box, solenoids and irrigation conduits to be designed by qualified irrigation engineer at CC stage. Controllers shall be mounted on a stable wall, power rack, or formed and constructed concrete based pedestal mount. Performance specification to be provided by landscape architect, nominally 25mm delivered to plant areas each week during establishment (depending on weather conditions). After establishment, irrigation rates can be decreased in certain areas of the landscape depending on the species.

Watering

Implement an appropriate hand watering regime in areas not irrigated in association with current watering programme to maintain plant health and vigour. The program shall reflect seasonal conditions and plant species. Frequency: Weekly or as required.

Drainage

All landscape areas are to have positive drainage to SW systems. If areas of poor drainage are identified on site then this should be brought to the site superindendants attention. Install agg lines if required.

<u>Soils</u>

Non-Australian native garden beds to have soil installed consisting of 50% existing site topsoil and 50% new topsoil equal or equivalent to 'Organic Garden Mix' as supplied by Australian Native Landscapes. Australian native garden beds to have soil installed consisting of 50% existing site topsoil and 50% new topsoil equal or equivalent to 'Native Low 'P' Mix' as supplied by Australian Native Landscapes. Topsoil to be installed to depth of 300mm for tree and mass planting garden beds, 100mm of turf underlay should be used under turf areas.

Cultivation

All garden beds to be cultivated to a min depth of 150mm and tree pits to the depth of the root ball only. If additives such as gypsum are required conduct this after cultivation into the top 100mm of soil.

Planting

All planting to be grown to NATSPEC specifications. Contractor to prepare site for planting including watering, handling, setting out and excavation. Excavate a hole for each plant large enough to provide not less than 100mm all around the root system of the plant. For tree planting each hole shall be dug with a shovel, backhoe or similar tool. Individual holes shall be excavated to allow root system to sit flat on the excavated hole and 400mm to each side of the root system. Backfill planting holes with existing site soil and topsoil as described in section 'Soil', plant / Tree shall be set plumb, with the root ball set slightly below the final soil level

Stakes and ties

For 75lt and 100lt plants 1.2-1.5m high place 2 Hardwood stakes 38x38x1800mm long per plant. Stakes are to be straight and free from knots or twists and pointed at one end. Drive stakes into the ground for at least a third of their length, avoiding damage to the root system. Provide two hessian ties 75mm wide top each staked plant. Ties to be fixed securely to the stakes, one tie at half the height of the main stem, others as necessary to stabilise the plant. Install tie around stake and stem in a figure of eight pattern.

Mulching

The Landscape Contractor shall supply and install 15mm Eucy Mulch to all garden beds shown on the landscape plans, to a minimum depth of 75mm. All mulch is to be free of deleterious matter such as soil, weeds and sticks. Mulched surfaces are to be kept clean and tidy and free of any deleterious material and foreign matter. Reinstate depths to a uniform level of 75mm with mulch as specified, mulch to be free of any wood material impregnated with CCA or similar toxic treatment. Maintain watering rings around trees. Top up mulch levels prior to handover to client.

<u>Turfing</u>

The landscape contractor shall supply and install Sir Walter Buffalo turf in stretcher pattern to all turf areas shown on the landscape plans and is to finish flush with adjacent surfaces. Turf to be a min thickness of 50mm with a 40mm mowing height. Contractor to allow for fertilising, laying, tamping, watering, top dressing, maintenance and mowing. The landscape contractor shall supply and install turf underlay under all turf areas, consisting of 100mm thick layer of screened top soil.

Pest and Disease Control

The Landscape Contractor shall spray for pests and disease infestations when the pest and fungal attack has been positively identified and when their populations have increased to a point that will become detrimental to plant growth. Apply all pesticides to manufacturer's directions.

Frequency: weekly inspection

Fertilising

Pellets shall be in the form intended to uniformly release plant food elements for a period of approximately nine months equal to Shirleys KOKEI pellets, analysis 6.3:1.8:2.9 or similar approved. KOKEI pellets shall be placed at the time of planting to the base of the plant, 50mm minimum from the root ball at a rate of two pellets per 300mm of top growth to a maximum of 8 pellets per tree. Generally check for signs of nutrient deficiencies (yellowing of leaves, failure to thrive), and adapt fertiliser regime to suit.

Fertiliser should be applied at the beginning and the end of the (summer) growing season.



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t: +61 420 225 866 e: kgong@studioiz.com.au 59/16-20, Park Avenue, Waitara, NSW, 2077 Copyright of studio IZ Pty Ltd. Figured dimensions shall be taken in preference to scaling. The contractor shall cheek all dimensions on site before com

Comments
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ARCHITECT: EnHance Project Group Pty Ltd

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DETAILS AND SPECIFICATION

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