PROPOSED RESIDENTIAL FLAT BUILDING (S4.55 MODIFICATIONS) 54 - 58 BEACONSFIELD STREET NEWPORT NSW



Drawing List

DA000	Cover Page			
DA001	Project Information			
DA004	Site Plan			
DA100	Ground Floor Plan			
DA101	First Floor Plan			
DA102	Second Floor Plan			
DA103	Roof Plan			
DA104	Basement Plan			
DA300	Section Sheet 1			
DA301	Section Sheet 2			
DA510	Landscape Area			
DA520	Height Limit Diagram			
DA522	4.2m Height Envelope Diagram			
DA530	Cross Ventilation Diagram			
DA560	Storage Calculation Diagram			
DA600	Solar Access Diagram			
DA601	Solar Access Diagram 2			
DA610	Shadow Diagram			

BASIX COMMENTS

ENERGY

DESIGN ELEMENT	COMPLIANCE CRITERIA
Central hot water system	Gas Instantaneous
	Internal & External Piping – R1.0 (~38 mm)
Cooking	Induction cooktop & electric oven
Mechanical heating and	Non-ducted air-conditioning (1-Phase) for all units (Living and Bedroom).
cooling	Minimum EER ratings – Cooling 3.0-3.5, Heating 3.5-4.0.
Apartment ventilation	Bathroom, laundry, and kitchen: individual fan, ducted to façade or roof – Interlocked to Light
Common area ventilation	Basement Car Park Area: Ventilation (supply and exhaust) with CO monitor + VSD Fans.
	Residential Waster Room: Exhaust only.
	Plantroom: Ventilation supply only, continuous.
	Ground floor lobbies, Corridors: No mechanical ventilation.
Apartment artificial lighting	LED throughout with dedicated fittings
Common area artificial	Lift: LED connected to lift call button.
lighting	Carpark, Residential waste room, Plantroom, Fire stairs, Ground WC, Floor lobbies, Corridors: LEDs controlled by Motion Sensors.
	Fire pump room: LEDs controlled by manual on/off switch.
Appliances in Apartments	Dishwashers: Minimum 4 Star Energy Rated
(minimum Energy Star rating)	Clothes Dyer: Minimum 2 Star Energy Rated
Photovoltaic Array	Minimum 10 kW peak PV.
Vertical transport	All Lifts with gearless traction and VVVF motor
	Lift Load Capacity: >= 1001 kg but <= 1500 kg

THERMAL COMFORT

DESIGN ELEMENT	COMPLIANCE CRITERIA
Glazed Doors / Windows	All apartments require the following glazing specification: Fixed and sliding windows U-Value = 3.60; SHGC = 0.47 (+/- 5%) Awning window U-Value = 4.30; SHGC = 0.47 (+/- 5%)
External Solid Walls	R2.5 bulk insulation, to achieve a total system R-value of R1.4
Exposed Roofs/Balconies	R3.0 bulk insulation, to achieve a total minimum R-value of R3.2 Medium or light colour
Suspended Floor Slabs (Enclosed floor levels between conditioned and internal non-conditioned spaces and open to outside)	R2.0 insulation to underside of suspended concrete slabs exposed to outside and unconditioned areas.
Floors Covering	Carpet in Bedrooms Timber in Living/Dining rooms

WATER

DESIGN ELEMENT	COMPLIANCE CRITERIA
Central systems & common areas	Showers: Minimum 4 Star (>6 but <= 7.5 L/min) WELS Rated Toilets: Minimum 4 Star WELS Rated All Taps: Minimum 5 Star WELS Rated
Dwelling Fixtures	Showers: Minimum 4 Star (>6 but <= 7.5 L/min) WELS Rated Toilets: Minimum 4 Star WELS Rated All Taps: Minimum 5 Star WELS Rated
Dwelling Fittings/Appliances	Washing Machine: not specified Dishwasher: Minimum 4 Star WELS Rated
Fire Sprinkler Water Test	Fire sprinkler test water is contained in a closed system
Alternative Water	Minimum 5,000L Rainwater tank to harvest roof area serving landscape irrigation and 1 car wash bay

GENERAL NOTES:

ALL WORKS TO COMPLY WITH BUILDING CODE OF AUSTRALIA, REQUIREMENTS OF RELEVENT STATUTORY AUTHORITIES / LOCAL GOVERNMENT & RELEVENT AUSTRALIAN BUILDING STANDARDS

DRAWINGS FOR THE PURPOSES OF DA ONLY (NOT FOR CONSTRUCTION) - FURTHER CONSULTANT AUTHORITY COORDINATION WILL BE REQUIRED AT CC STAGE WHICH MAY IMPACT ON DESIGN AND PLANNING LAYOUTS

ARCHITECTURAL PLANS TO BE READ IN CONJUNCTION WITH CONSULTANTS DRAWINGS, SPECIFICATIONS & REPORTS
COPYRIGHT OF DESIGN SHOWN HEREON IS RETAINED BY PBD ARCHITECTS AND AUTHORITY IS REQUIRED FOR ANY REPRODUCTION

AREA SCHEDLILES SUPPLIED ARE APPROXIMATE ONLY - FUTURE ALLOWANCE

AREA SCHEDULES SUPPLIED ARE APPROXIMATE ONLY - FUTURE ALLOWANCE FOR VERTICAL SERVICE DUCTS, STRUCTURAL WALL SYSTEMS AND CONSULTANTINPUT WILL BE REQUIRED

LEGEND:

ACCESS HATCH A/C CONDENSER UNITS

FIRE HYDRANT
FIRE HOSE REEL
FIRE STAIRS
GARBAGE CHUTE
HIGHLIGHT WINDOW
MECHANICAL RISER TO FUTURE DETAIL
MAILBOX TO FUTURE DETAIL
240L RECYCLING BIN
SKYLIGHT
STORAGE
HOT WATER LINITS

SK SKYLIGHT
ST STORAGE
HWU HOT WATER UNITS

MATERIALS LEGEND:

AFG ALUMINIUM FRAMED GLAZING
LV ALUMINIUM ELLIPTICAL FIXED LOUVERS
AW AWNING (TO FUTURE DETAIL)
CONC CONCRETE
FB FACE BRICK

FRAMELESS TOUCHENED GLASS BALUSTRADE (TO BCA/AUS

STANDARDS)

METAL BALUSTRADE
METAL CLADDING
METAL FENCING (TO FUTURE SELECTION)
COMPOSITE PANEL CLADDING
PRIVACY SCREEN (TO FUTURE SELECTION)
PAINT FINISH TYPEX
ROLLER DOOR
RIVER PEBBLES

STANDARDS)

MB METAL BALUSTRADE

MC METAL CLADDING

FCE METAL FENCING (TO FL

PC COMPOSITE PANEL CL

PSX PRIVACY SCREEN (TO FL

PTX PAINT FINISH TYPEX

RD ROLLER DOOR

RD RIVER PERBILES

RENDERED FINISH/SELECTED PAINT FINISH

TIMBER CLADDING EXTERNAL VENETIAN BLINDS

Issue	Date	Description
Α	28/11/2023	DEVELOPMENT APPPLICATION
В	7/05/2024	AMENDED DEVELOPMENT APPLICATION
С	29/05/2024	AMENDED DEVELOPMENT APPLICATION
D	12/06/2024	AMENDED DEVELOPMENT APPLICATION
F	20/01/2025	S4.55 ISSUE

JAK Newport Pty Ltd



P - 02 9698 8140 E - info@pbdarchitects.com.au W - pbdarchitects.com.au Level 2, 52 Albion Street, Surry Hills NSW 2010 ABN 36 147 035 550 Nominated Architect: Paul Buljevic NSW 7768

pbd architects

RESIDENTIAL FLAT BUILDING - KENZA

54 - 58 BEACONSFIELD STREET NEWPORT NSW

Cover Page

DRAWING BY:	CHECKED BY: KL	DATE: 21/01/2025
SCALE: NTS	DRAWING NO:	ISSUE:
PROJECT NO:	DA000	F

54-58 Beaconsfield Street **PROJECT SUMMARY**

SITE AREA Zone

PROPOSED SCHEME

Level	Unit.No	Туре	Internal Area (m2)	Terrace/ Balcony (m2)	Storage Compliance	Storage within apartment (m3)	Carpark Storage (m3)	Total Storage (m2)
	G01 3 BED 144 87 Y 14.4	14.4	4.8	19.2				
GROUND	G02	3 BED	150	61	Υ	19.2	4.8	24.0
	G03	3 BED	138	61	Υ	12.0	4.8	16.8
	101	3 BED	131	23	Y	7.2	4.8	12.0
	102	3 BED	132	109	Y	5.7	4.8	10.5
LEVEL 1	103	3 BED	155	46	Y	6.6	4.8	11.4
	104	3 BED	Balcony (m2) Compliance apartment (m3) Storage	4.8	11.4			
	105	Storage	4.8	16.2				
	201	3 BED	144 87 Y 14.4 150 131 23 Y 155 161 Y 16.6 155 27 Y 6.6 156 27 27 Y 6.6 27 27 27 27 27 27 27 2	4.8	12.0			
	202	3 BED	128	22	Υ	5.7	4.8	10.5
LEVEL 2	104 3 BED 162 71 Y 6.6 4.8 105 3 BED 161 76 Y 11.4 4.8 201 3 BED 131 23 Y 7.2 4.8 202 3 BED 128 22 Y 5.7 4.8 203 3 BED 155 27 Y 6.6 4.8	4.8	11.4					
	204	3 BED	156	27	Υ	6.6	4.8	11.4
	205	3 BED	161	15	Υ	11.4	7.2	18.6

LANDSCAPE	PERCENTAGE	AREA	
Required Landscaped Area	50%	1056.8	
Proposed Landscaped Area	50%	1061	

2113.5 m2

COMMUNAL OPEN SPACE

Required Communal Open Space	25%	528.37	
Proposed Communal Open Space	19%	398	

TOTAL PARKING

Required Car Parking	2 x13 Units + 4.3 Visitor= 30
Proposed Car Parking	30(incl 4 Visitor)

CROSS VENTILATION

Required Cross Ventilation	60%	7.8
Proposed Cross Ventilation	69%	9

SOLAR COMPLIANCE CHECK

UNIT	LIVING							
ONT	9AM	10AM	11AM	12PM	1PM	2PM	3PM	TOTAL
G01								0
G02								0
G03		Υ	Y	Y				2
101								0
102	Υ	Υ	Y	Y	Y	Y	Y	6
103	Υ	Υ	Y	Υ	Y	Υ	Y	6
104	Υ	Υ	Y	Y	Y	Y	Y	6
105	Υ	Υ	Y	Υ	Y	Υ	Υ	6
201	Υ	Υ	Y	Υ	Υ	Υ	Υ	6
202	Υ	Υ	Y	Υ	Υ	Υ	Υ	6
203	Υ	Υ	Y	Y	Υ	Υ	Υ	6
204	Υ	Υ	Y	Υ	Υ	Υ	Υ	6
205	Υ	Υ	Υ	Υ	Υ	Υ	Υ	6

Solar Access No Solar Access Non-Compliant

UNIT COMPLIANT 10 13 **TOTAL UNIT**

Solar Compliance

GENERAL NOTES:

ALL WORKS TO COMPLY WITH BUILDING CODE OF AUSTRALIA, REQUIREMENTS OF RELEVENT STATUTORY AUTHORITIES / LOCAL GOVERNMENT & RELEVENT AUSTRALIAN BUILDING STANDARDS

DRAWINGS FOR THE PURPOSES OF DA ONLY (NOT FOR CONSTRUCTION) - FURTHER CONSULTANT / AUTHORITY COORDINATION WILL BE REQUIRED AT CC STAGEWHICH MAY IMPACT ON DESIGN AND PLANNING LAYOUTS

ARCHITECTURAL PLANS TO BE READ IN CONJUNCTION WITH CONSULTANTS DRAWINGS, SPECIFICATIONS & REPORTS

COPYRIGHT OF DESIGN SHOWN HEREON IS RETAINED BY PBD ARCHITECTS AND AUTHORITY IS REQUIRED FOR ANY REPRODUCTION

AREA SCHEDULES SUPPLIED ARE APPROXIMATE ONLY - FUTURE ALLOWANCE FOR VERTICAL SERVICE DUCTS, STRUCTURAL WALL SYSTEMS AND CONSULTANTINPUT WILL BE REQUIRED

LEGEND:

AW AWNING
AH ACCESS HATCH
AC A/C CONDENSER UNITS
FH FIRE HYDRANT
FHR FIRE HOSE REEL
FS FIRE STAIRS
GC GARBAGE CHUTE
HW HIGHLIGHT WINDOW
MV MECHANICAL RISER TO FUTURE DETAIL
MB MAILBOX TO FUTURE DETAIL
R 240L RECYCLING BIN
SK SKYLIGHT
ST STORAGE
HWU HOT WATER UNITS

MATERIALS LEGEND:

AFG ALUMINIUM FRAMED GLAZING
LV ALUMINIUM ELLIPTICAL FIXED LOUVERS
AW AWNING (TO FUTURE DETAIL)
CONC CONCRETE
FB FACE BRICK
GB FRAMELESS TOUCHENED GLASS BALUSTRADE (TO BCA/AUS
STANDARDS)

GB FRAMELESS TOUCHENED GLASS BALUSTRADE STANDARDS)

MB METAL BALUSTRADE

MC METAL CLADDING

FCE METAL FENCING (TO FUTURE SELECTION)

PC COMPOSITE PANEL CLADDING

PSX PRIVACY SCREEN (TO FUTURE SELECTION)

PTX PAINT FINISH TYPEX

RD ROLLER DOOR

RP RIVER PEBBLES

RW RENDERED FINISH/SELECTED PAINT FINISH

TC TIMBER CLADDING

VB EXTERNAL VENETIAN BLINDS

VB EXTERNAL VENETIAN BLINDS

Issue	Date	Description
А	28/11/2023	DEVELOPMENT APPPLICATION
В	7/05/2024	AMENDED DEVELOPMENT APPLICATION
С	29/05/2024	AMENDED DEVELOPMENT APPLICATION
D	12/06/2024	AMENDED DEVELOPMENT APPLICATION
F	20/01/2025	S4.55 ISSUE



RE.STREET



P - 02 9698 8140 E - info@pbdarchitects.com.au W - pbdarchitects.com.au Level 2, 52 Albion Street, Surry Hills NSW 2010 ABN 36 147 035 550 Nominated Architect: Paul Buljevic NSW 7768

pbd architects


RESIDENTIAL FLAT BUILDING - KENZA

54 - 58 BEACONSFIELD STREET NEWPORT NSW

DRAWING TITLE:


Project Information


DRAWING BY:	CHECKED BY:	DATE:
AS	KL	21/01/2025
SCALE:	DRAWING NO:	ISSUE:
NTS	D D O O d	_
PROJECT NO:	DA001	F
2311		

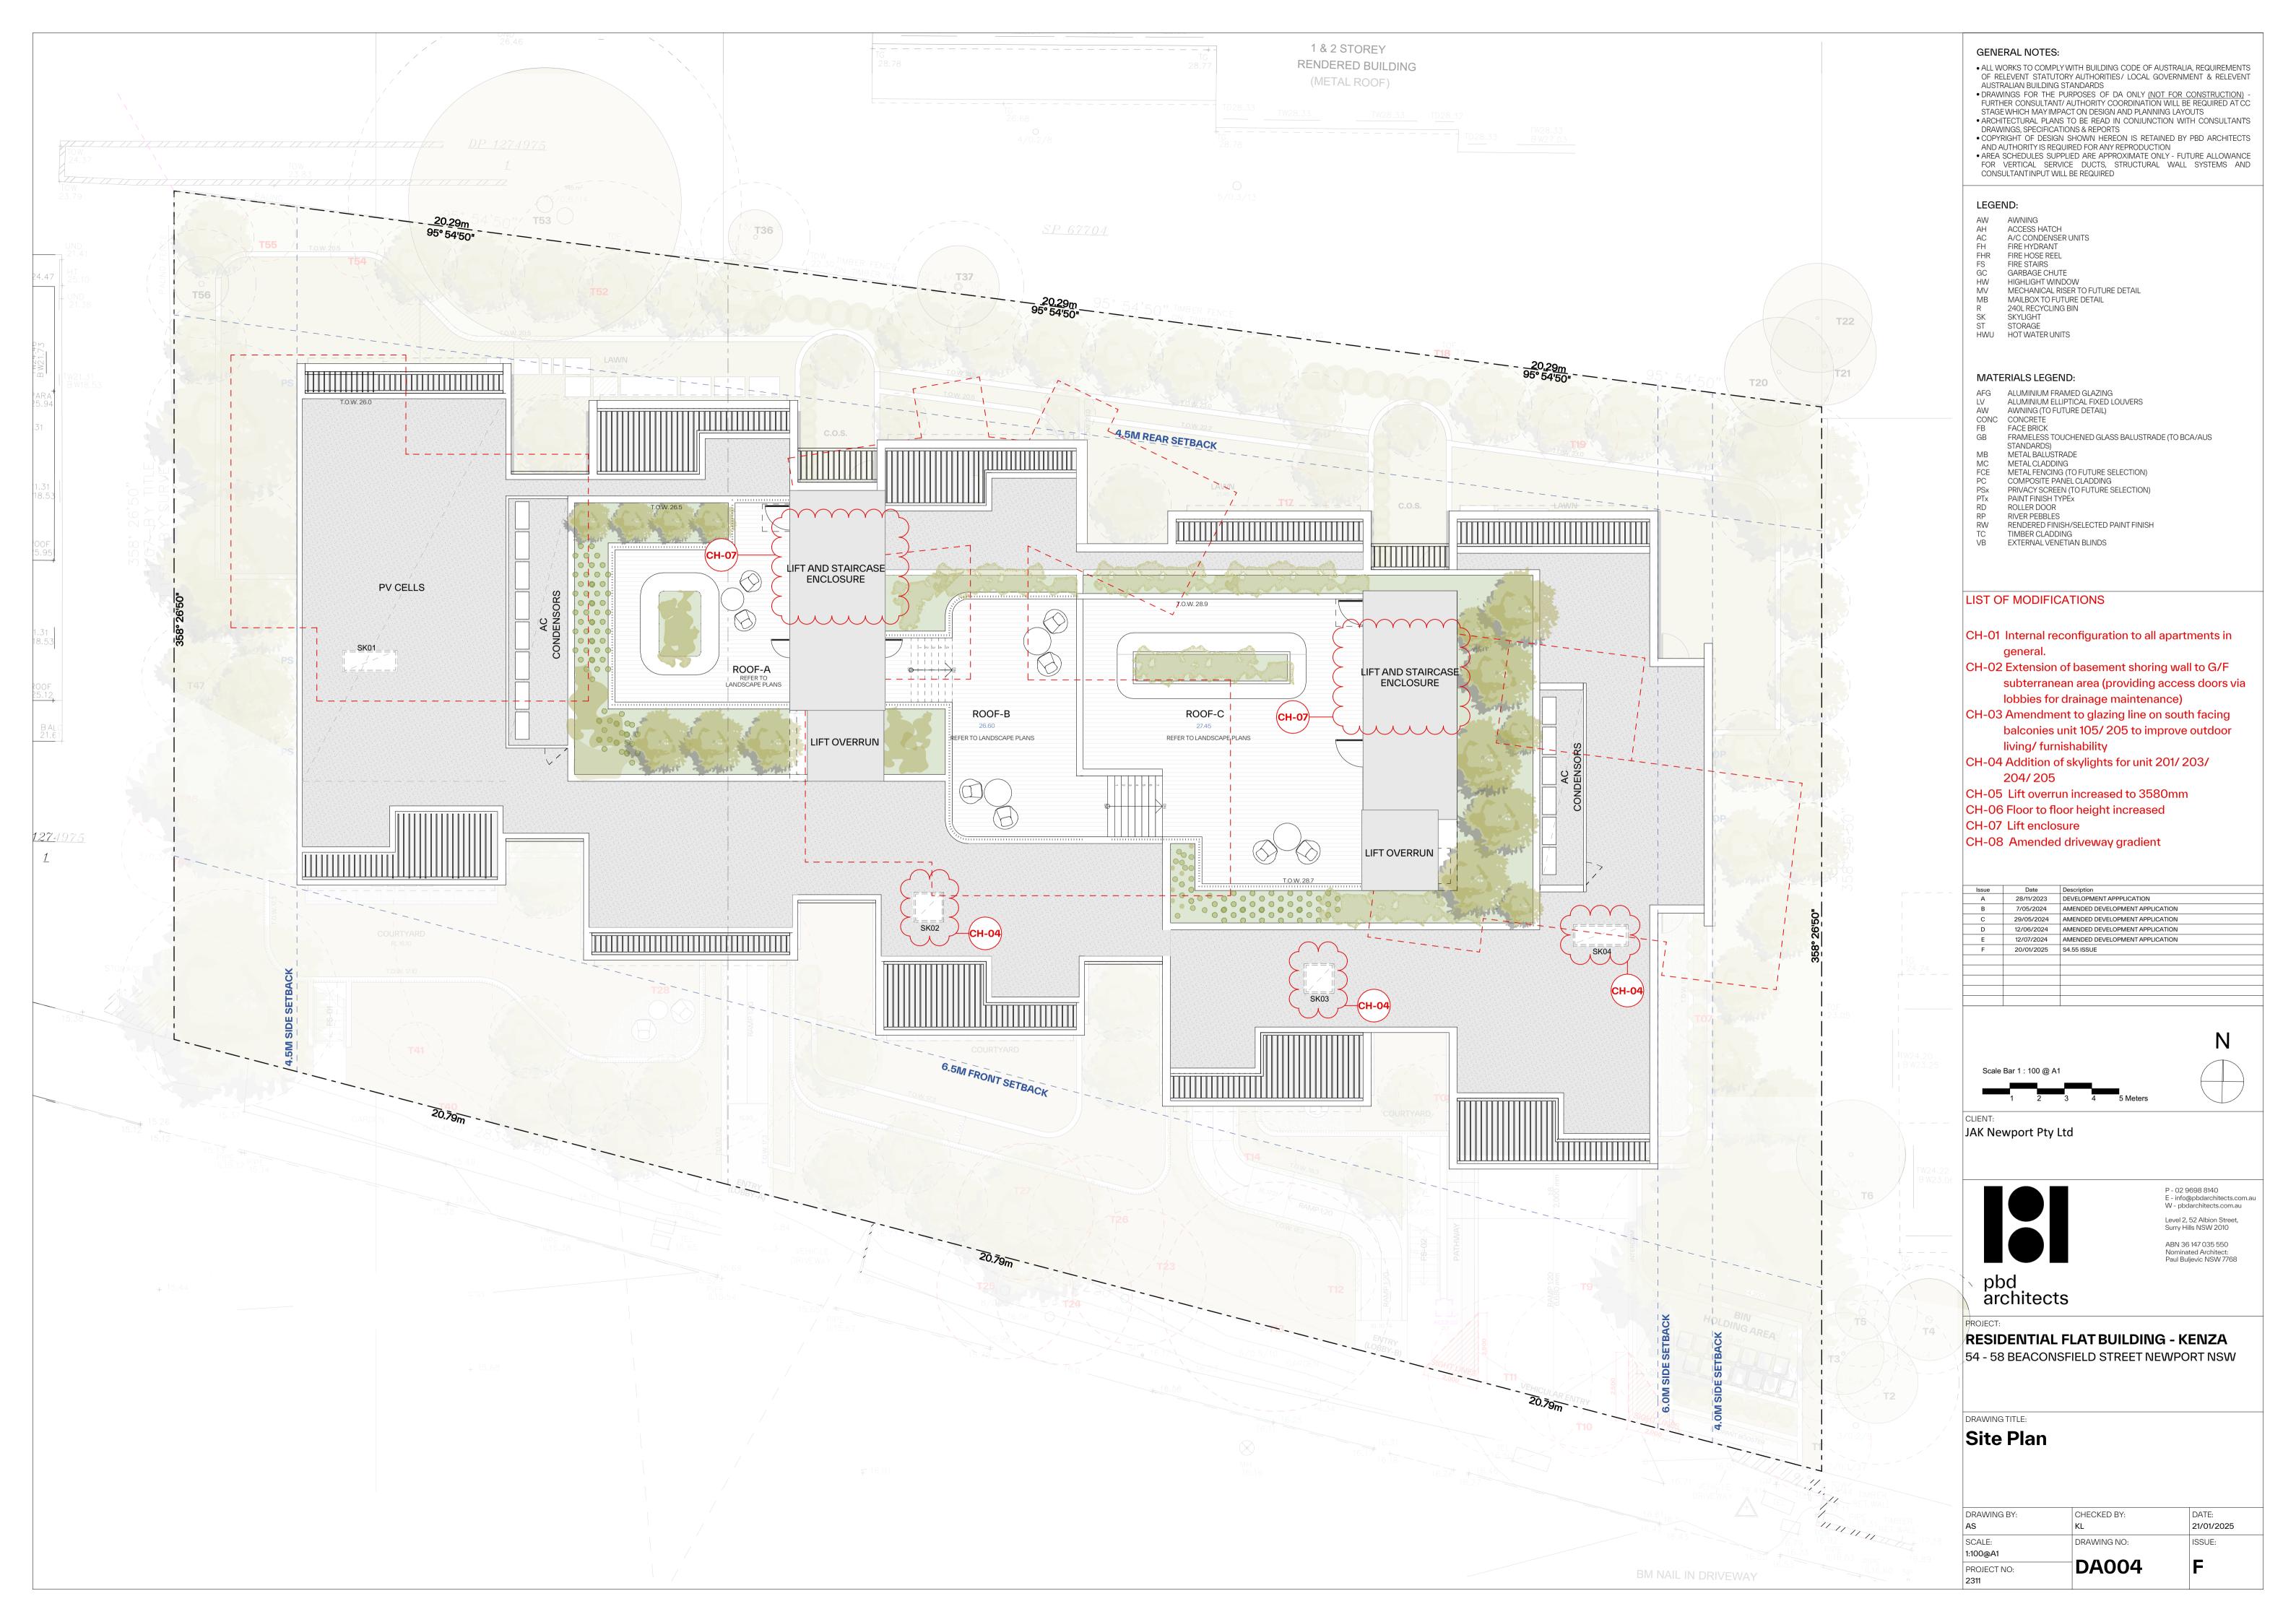





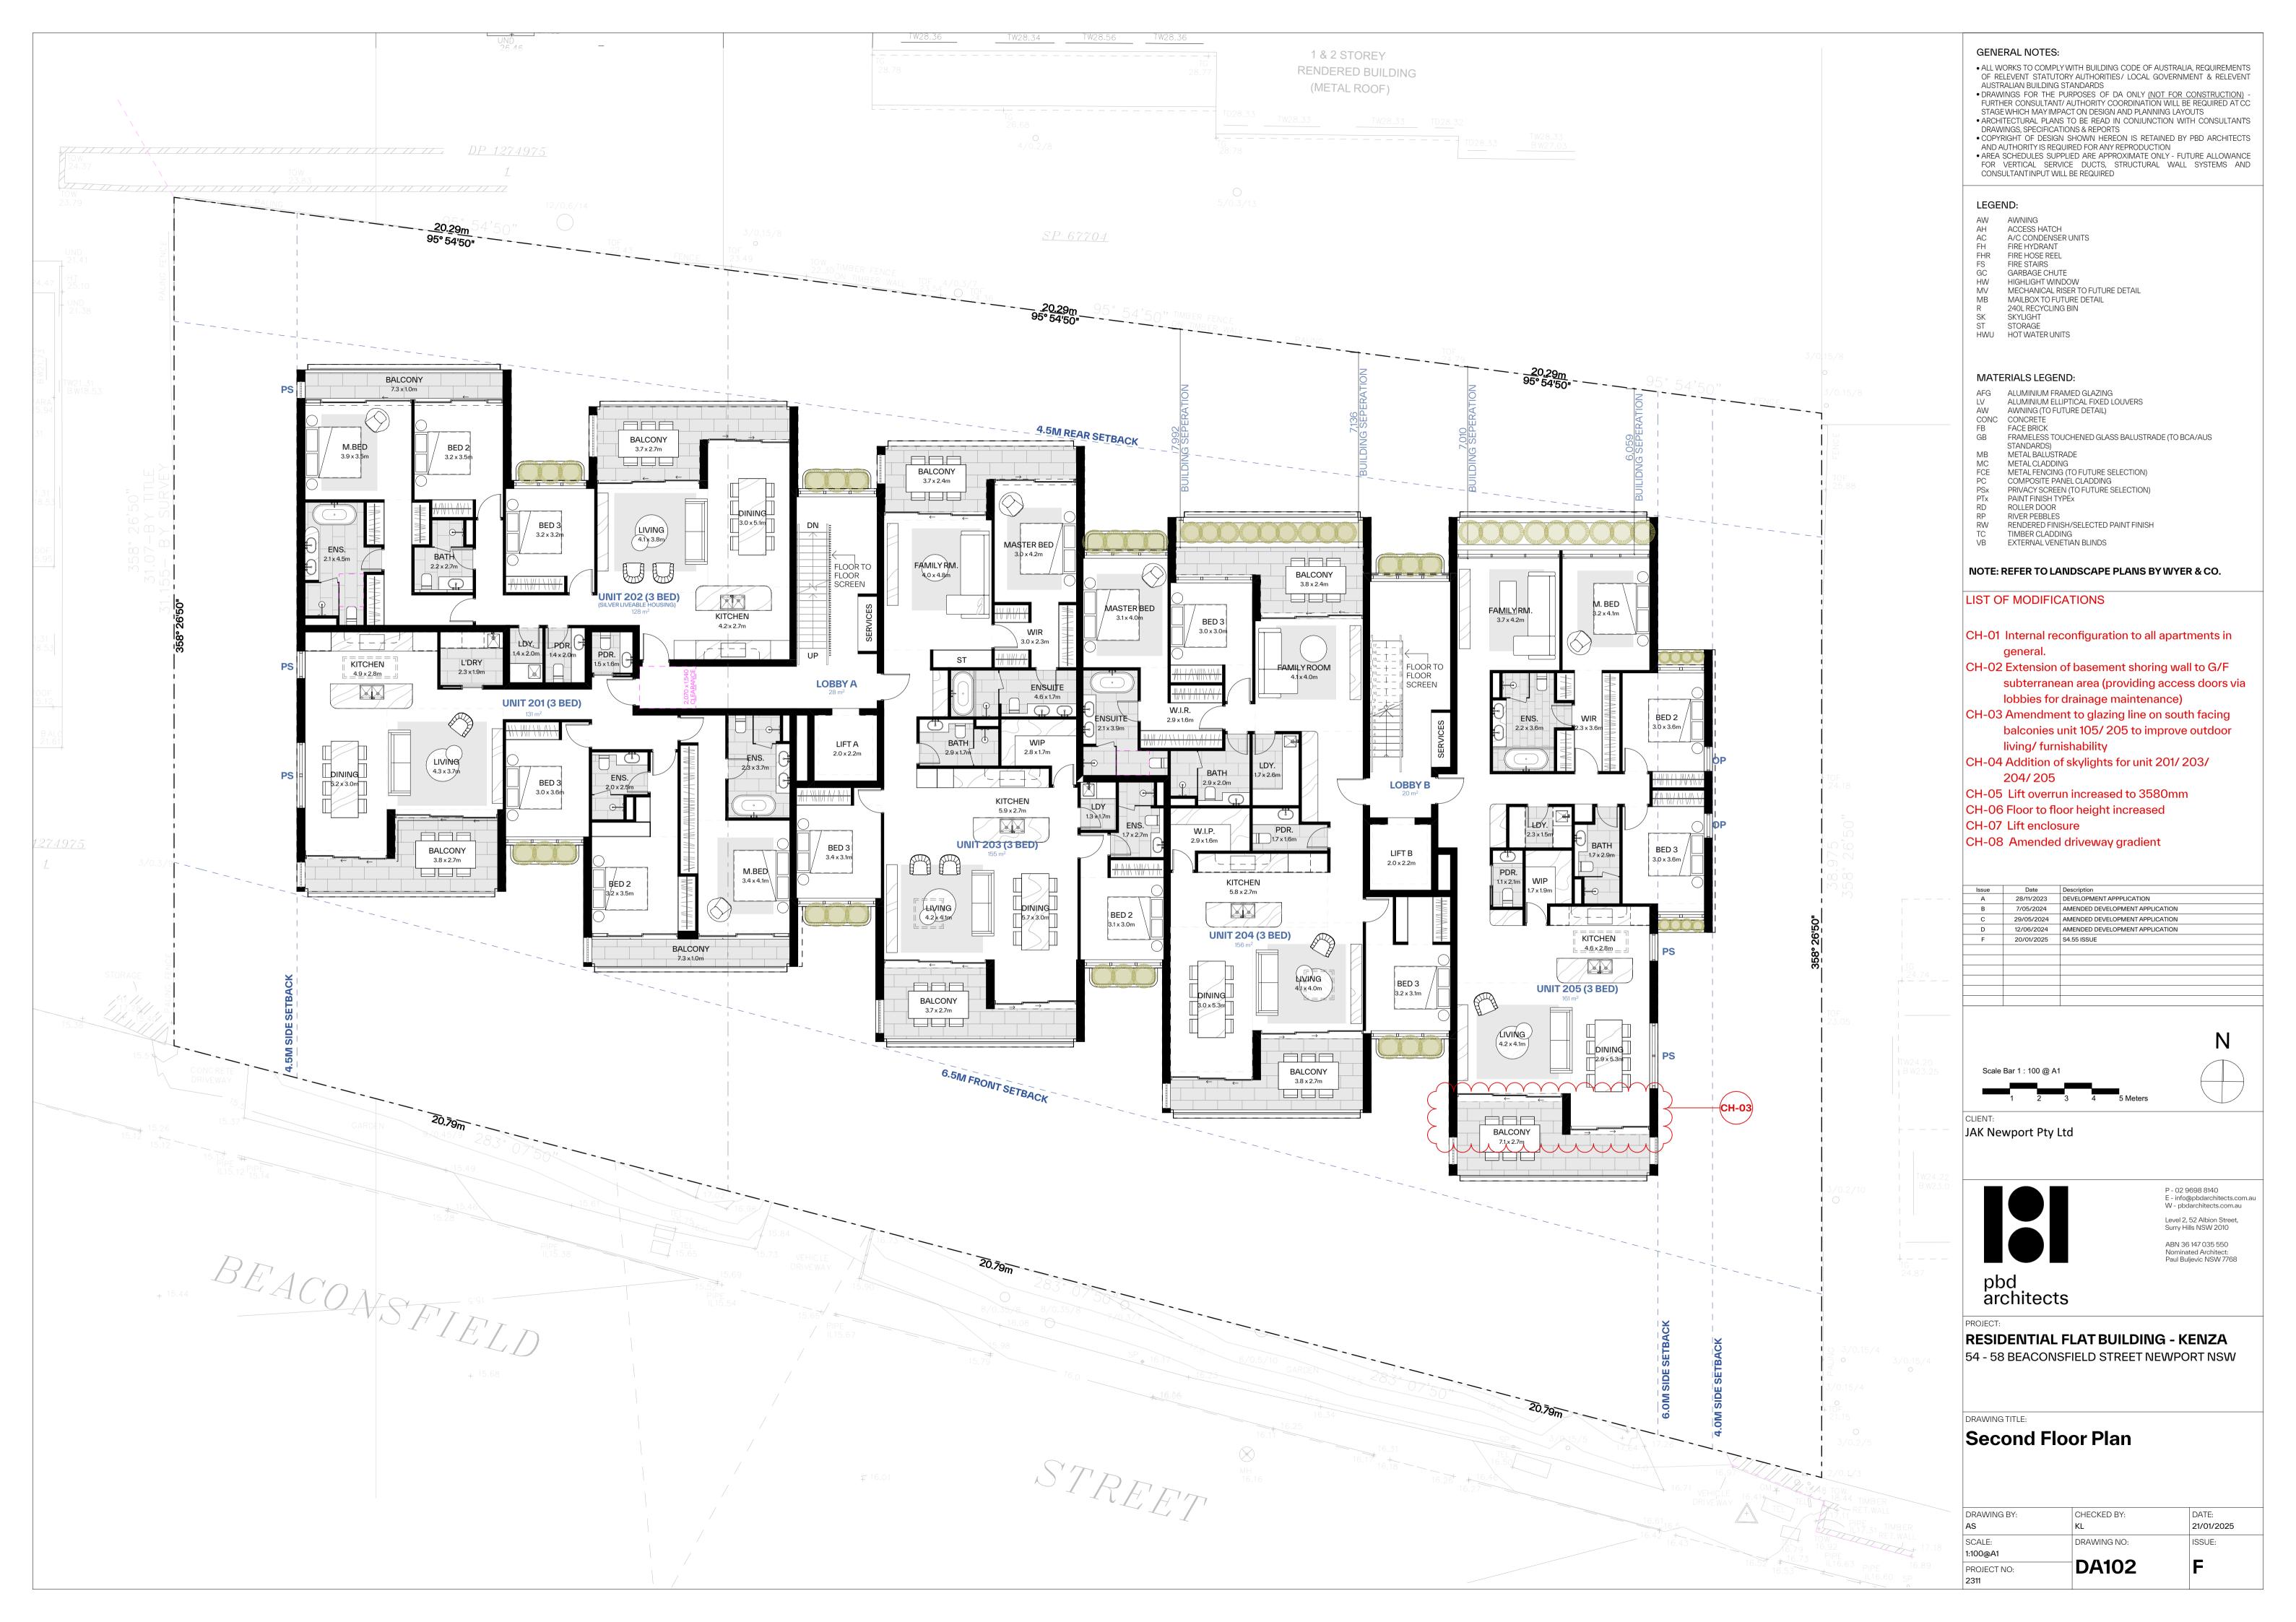

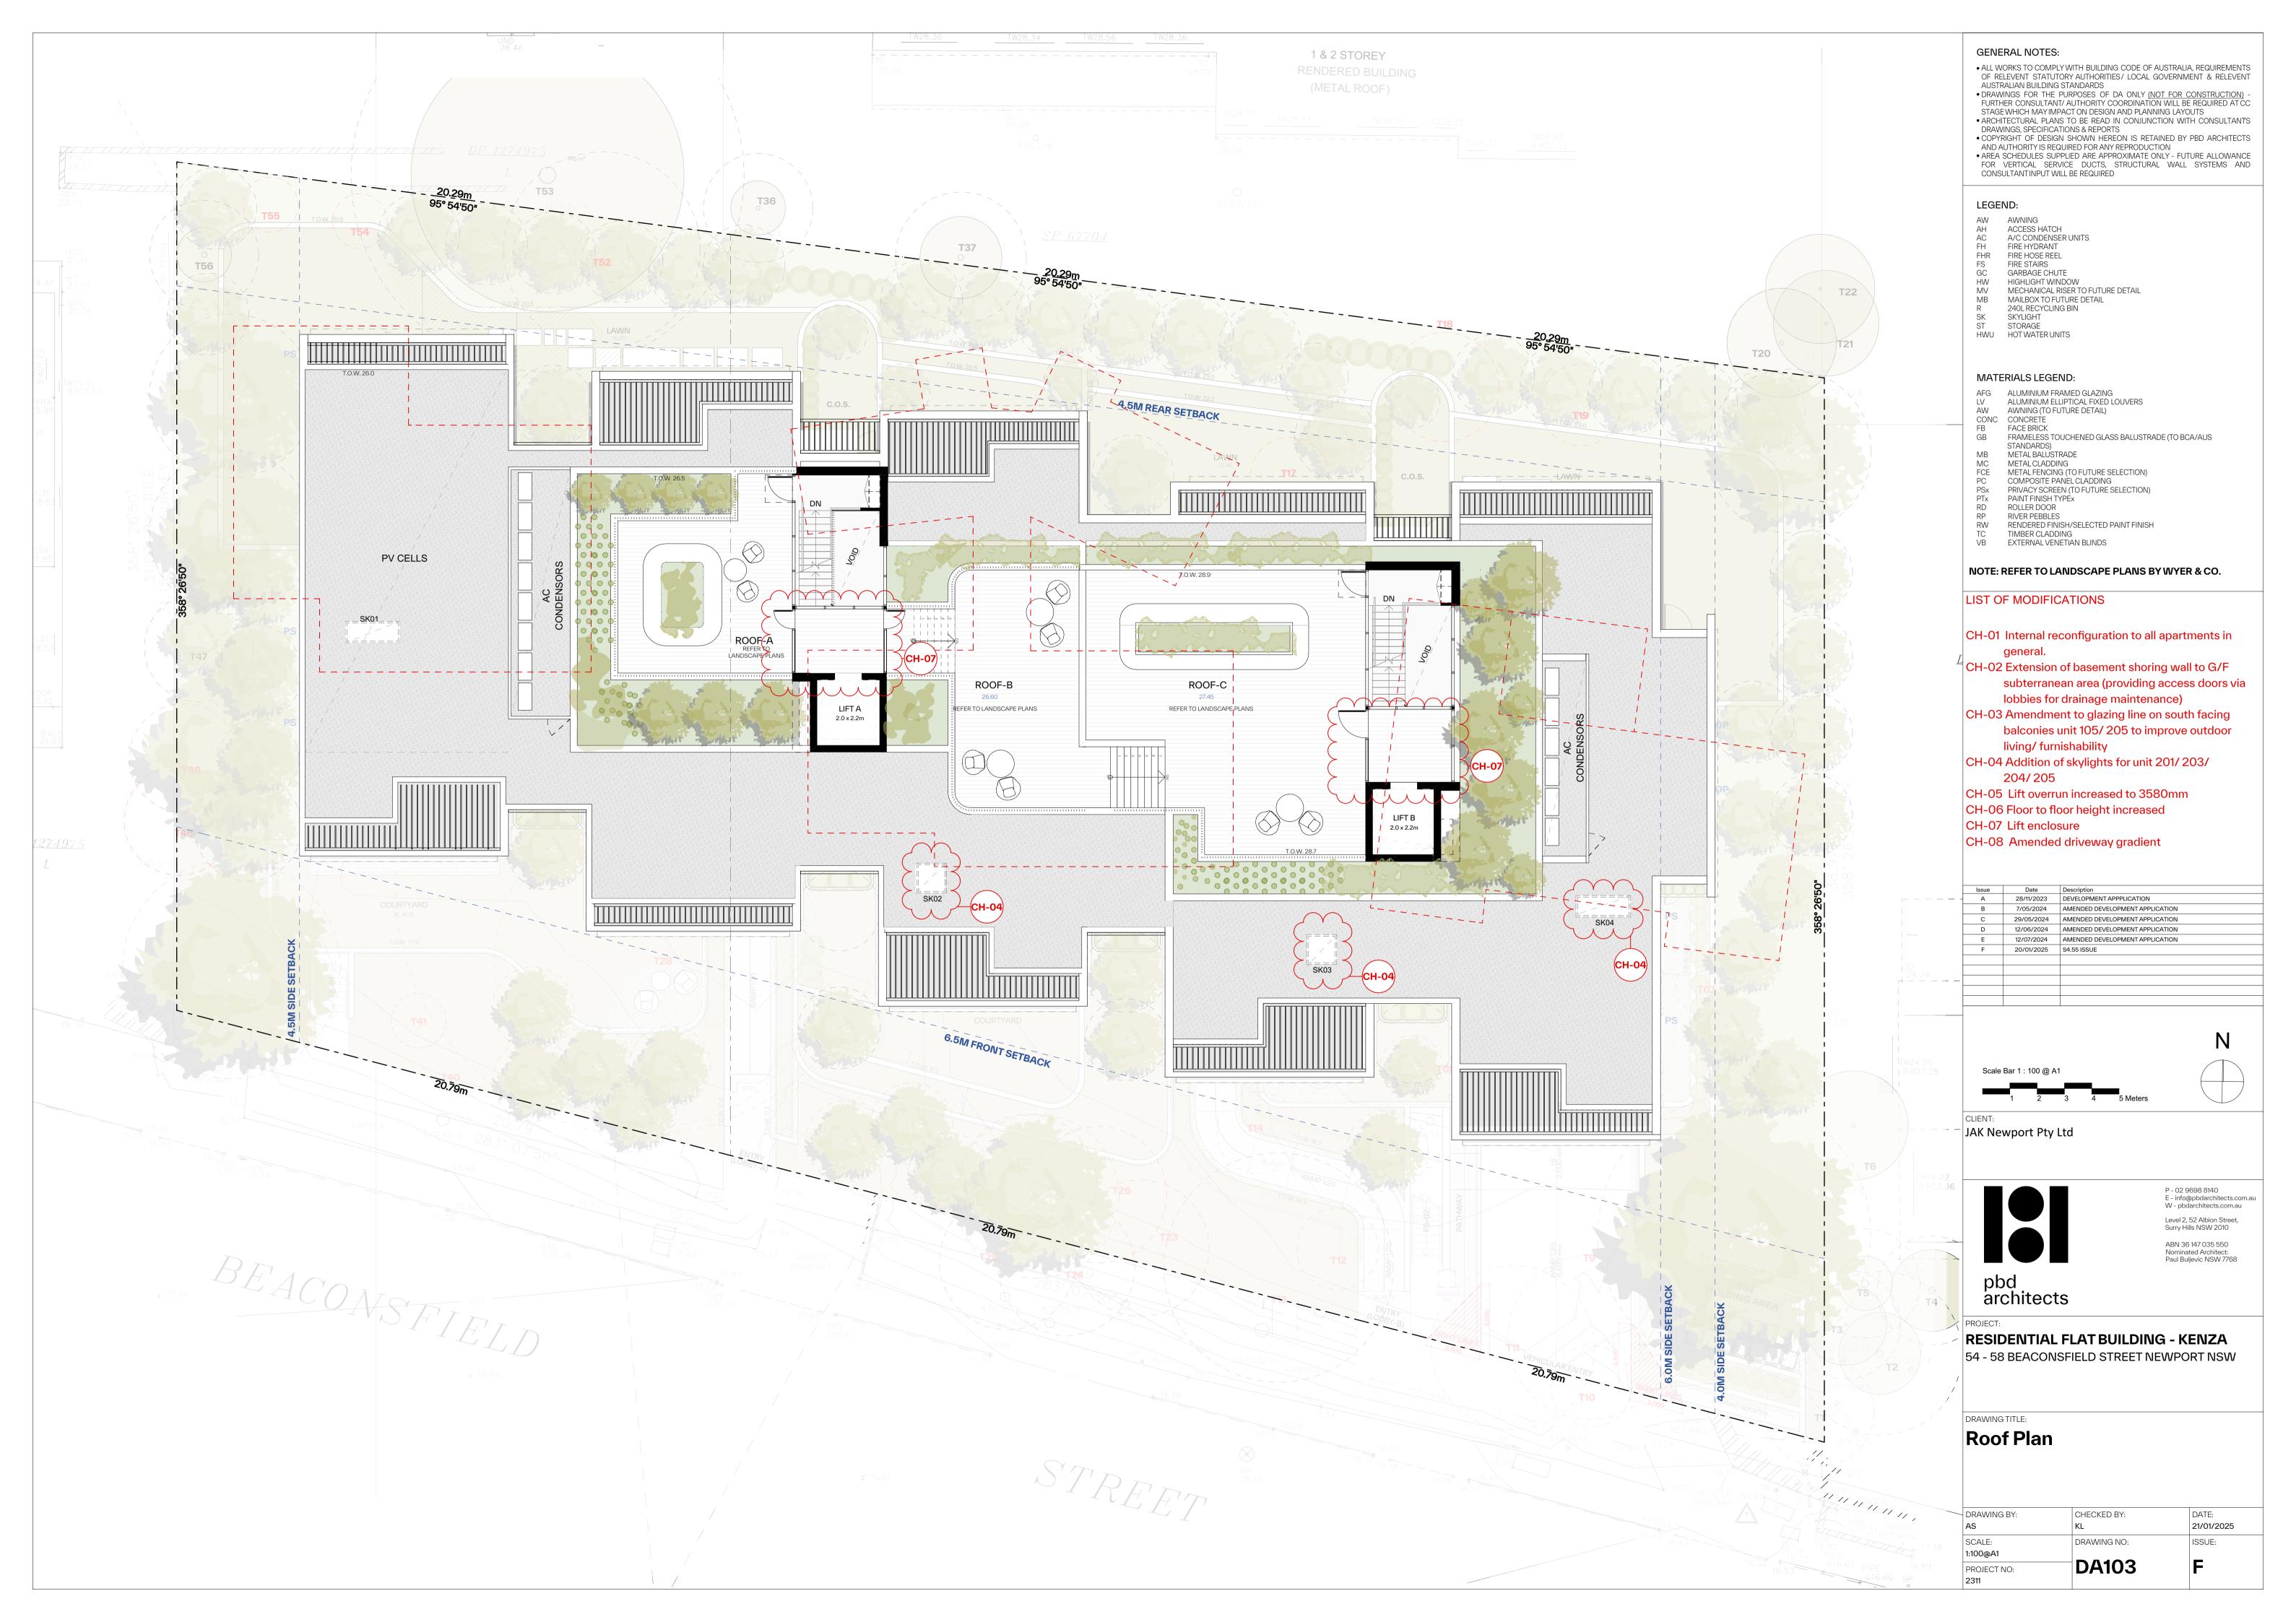



ALL WORKS TO COMPLY WITH BUILDING CODE OF AUSTRALIA, REQUIREMENTS OF RELEVENT STATUTORY AUTHORITIES / LOCAL GOVERNMENT & RELEVENT AUSTRALIAN BUILDING STANDARDS
 DRAWINGS FOR THE PURPOSES OF DA ONLY (NOT FOR CONSTRUCTION) - FURTHER CONSULTANT / AUTHORITY COORDINATION WILL BE REQUIRED AT CC STAGE WHICH MAY IMPACT ON DESIGN AND PLANNING LAYOUTS
 ARCHITECTURAL PLANS TO BE READ IN CONJUNCTION WITH CONSULTANTS DRAWINGS, SPECIFICATIONS & REPORTS
 COPYRIGHT OF DESIGN SHOWN HEREON IS RETAINED BY PBD ARCHITECTS

 COPYRIGHT OF DESIGN SHOWN HEREON IS RETAINED BY PBD ARCHITECTS
 AND AUTHORITY IS REQUIRED FOR ANY REPRODUCTION AREA SCHEDULES SUPPLIED ARE APPROXIMATE ONLY - FUTURE ALLOWANCE FOR VERTICAL SERVICE DUCTS, STRUCTURAL WALL SYSTEMS AND

FRAMELESS TOUCHENED GLASS BALUSTRADE (TO BCA/AUS

CH-01 Internal reconfiguration to all apartments in

subterranean area (providing access doors via lobbies for drainage maintenance)

balconies unit 105/205 to improve outdoor

Issue	Date	Description
Α	28/11/2023	DEVELOPMENT APPPLICATION
В	7/05/2024	AMENDED DEVELOPMENT APPLICATION
С	29/05/2024	AMENDED DEVELOPMENT APPLICATION
D	12/06/2024	AMENDED DEVELOPMENT APPLICATION
F	20/01/2025	S4.55 ISSUE



P - 02 9698 8140 E - info@pbdarchitects.com.au W - pbdarchitects.com.au Level 2, 52 Albion Street, Surry Hills NSW 2010 ABN 36147035550 Nominated Architect: Paul Buljevic NSW 7768

RESIDENTIAL FLAT BUILDING - KENZA 54 - 58 BEACONSFIELD STREET NEWPORT NSW

DRAWING BY:	CHECKED BY:	DATE:
AS	KL	21/01/2025
SCALE:	DRAWING NO:	ISSUE:
1:100@A1		_
PROJECT NO:	DA104	F
2311		





GENERAL NOTES:

 ALL WORKS TO COMPLY WITH BUILDING CODE OF AUSTRALIA, REQUIREMENTS OF RELEVENT STATUTORY AUTHORITIES/ LOCAL GOVERNMENT & RELEVENT AUSTRALIAN BUILDING STANDARDS
 DRAWINGS FOR THE PURPOSES OF DA ONLY (NOT FOR CONSTRUCTION) - FURTHER CONSULTANT/ AUTHORITY COORDINATION WILL BE REQUIRED AT CC STAGE WHICH MAY IMPACT ON DESIGN AND PLANNING LAYOUTS
 ARCHITECTURAL PLANS TO BE READ IN CONJUNCTION WITH CONSULTANT'S DRAWINGS, SPECIFICATIONS & REPORTS
 COPYRIGHT OF DESIGN SHOWN HERFON IS RETAINED BY PRD ARCHITECTS • COPYRIGHT OF DESIGN SHOWN HEREON IS RETAINED BY PBD ARCHITECTS AND AUTHORITY IS REQUIRED FOR ANY REPRODUCTION AREA SCHEDULES SUPPLIED ARE APPROXIMATE ONLY - FUTURE ALLOWANCE FOR VERTICAL SERVICE DUCTS, STRUCTURAL WALL SYSTEMS AND

LEGEND:

AW AWNING
AH ACCESS HATCH
AC A/C CONDENSER UNITS
FH FIRE HYDRANT
FHR FIRE HOSE REEL
FS FIRE STAIRS
GC GARBAGE CHUTE
HW HIGHLIGHT WINDOW
MV MECHANICAL RISER TO FUTURE DETAIL
MB MAILBOX TO FUTURE DETAIL
R 240L RECYCLING BIN
SK SKYLIGHT
ST STORAGE
HWU HOT WATER UNITS

CONSULTANTINPUT WILL BE REQUIRED

MATERIALS LEGEND:

AFG ALUMINIUM FRAMED GLAZING
LV ALUMINIUM ELLIPTICAL FIXED LOUVERS
AW AWNING (TO FUTURE DETAIL)
CONC CONCRETE
FB FACE BRICK
GB FRAMELESS TOUCHENED GLASS BALUSTE

FRAMELESS TOUCHENED GLASS BALUSTRADE (TO BCA/AUS STANDARDS)

STANDARDS)

MB METAL BALUSTRADE

MC METAL CLADDING

FCE METAL FENCING (TO FUTURE SELECTION)

PC COMPOSITE PANEL CLADDING

PSX PRIVACY SCREEN (TO FUTURE SELECTION)

PTX PAINT FINISH TYPEX

RD ROLLER DOOR

RP RIVER PEBBLES

RW RENDERED FINISH/SELECTED PAINT FINISH

TC TIMBER CLADDING

VB FXTERNAL VENETIAN BLINDS

EXTERNAL VENETIAN BLINDS

LIST OF MODIFICATIONS

CH-01 Internal reconfiguration to all apartments in

CH-02 Extension of basement shoring wall to G/F

subterranean area (providing access doors via lobbies for drainage maintenance)

CH-03 Amendment to glazing line on south facing balconies unit 105/205 to improve outdoor living/ furnishability


CH-04 Addition of skylights for unit 201/203/ 204/205

CH-05 Lift overrun increased to 3580mm

CH-06 Floor to floor height increased CH-07 Lift enclosure

CH-08 Amended driveway gradient

Issue	Date	Description
Α	28/11/2023	DEVELOPMENT APPPLICATION
В	7/05/2024	AMENDED DEVELOPMENT APPLICATION
С	29/05/2024	AMENDED DEVELOPMENT APPLICATION
D	12/06/2024	AMENDED DEVELOPMENT APPLICATION
F	20/01/2025	S4.55 ISSUE
G - WIP	Work in Progress	Not in Transmittal Set

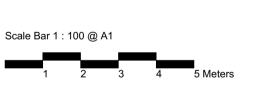

JAK Newport Pty Ltd



P - 02 9698 8140 E - info@pbdarchitects.com.au W - pbdarchitects.com.au Level 2, 52 Albion Street, Surry Hills NSW 2010 ABN 36 147 035 550 Nominated Architect: Paul Buljevic NSW 7768

pbd architects


RESIDENTIAL FLAT BUILDING - KENZA 54 - 58 BEACONSFIELD STREET NEWPORT NSW


DRAWING TITLE:

Elevation Sheet 1

PROJECT NO:	DA200	G - WIP
1:100@A1		
SCALE:	DRAWING NO:	ISSUE:
AS	KL	21/01/2025
DRAWING BY:	CHECKED BY:	DATE:



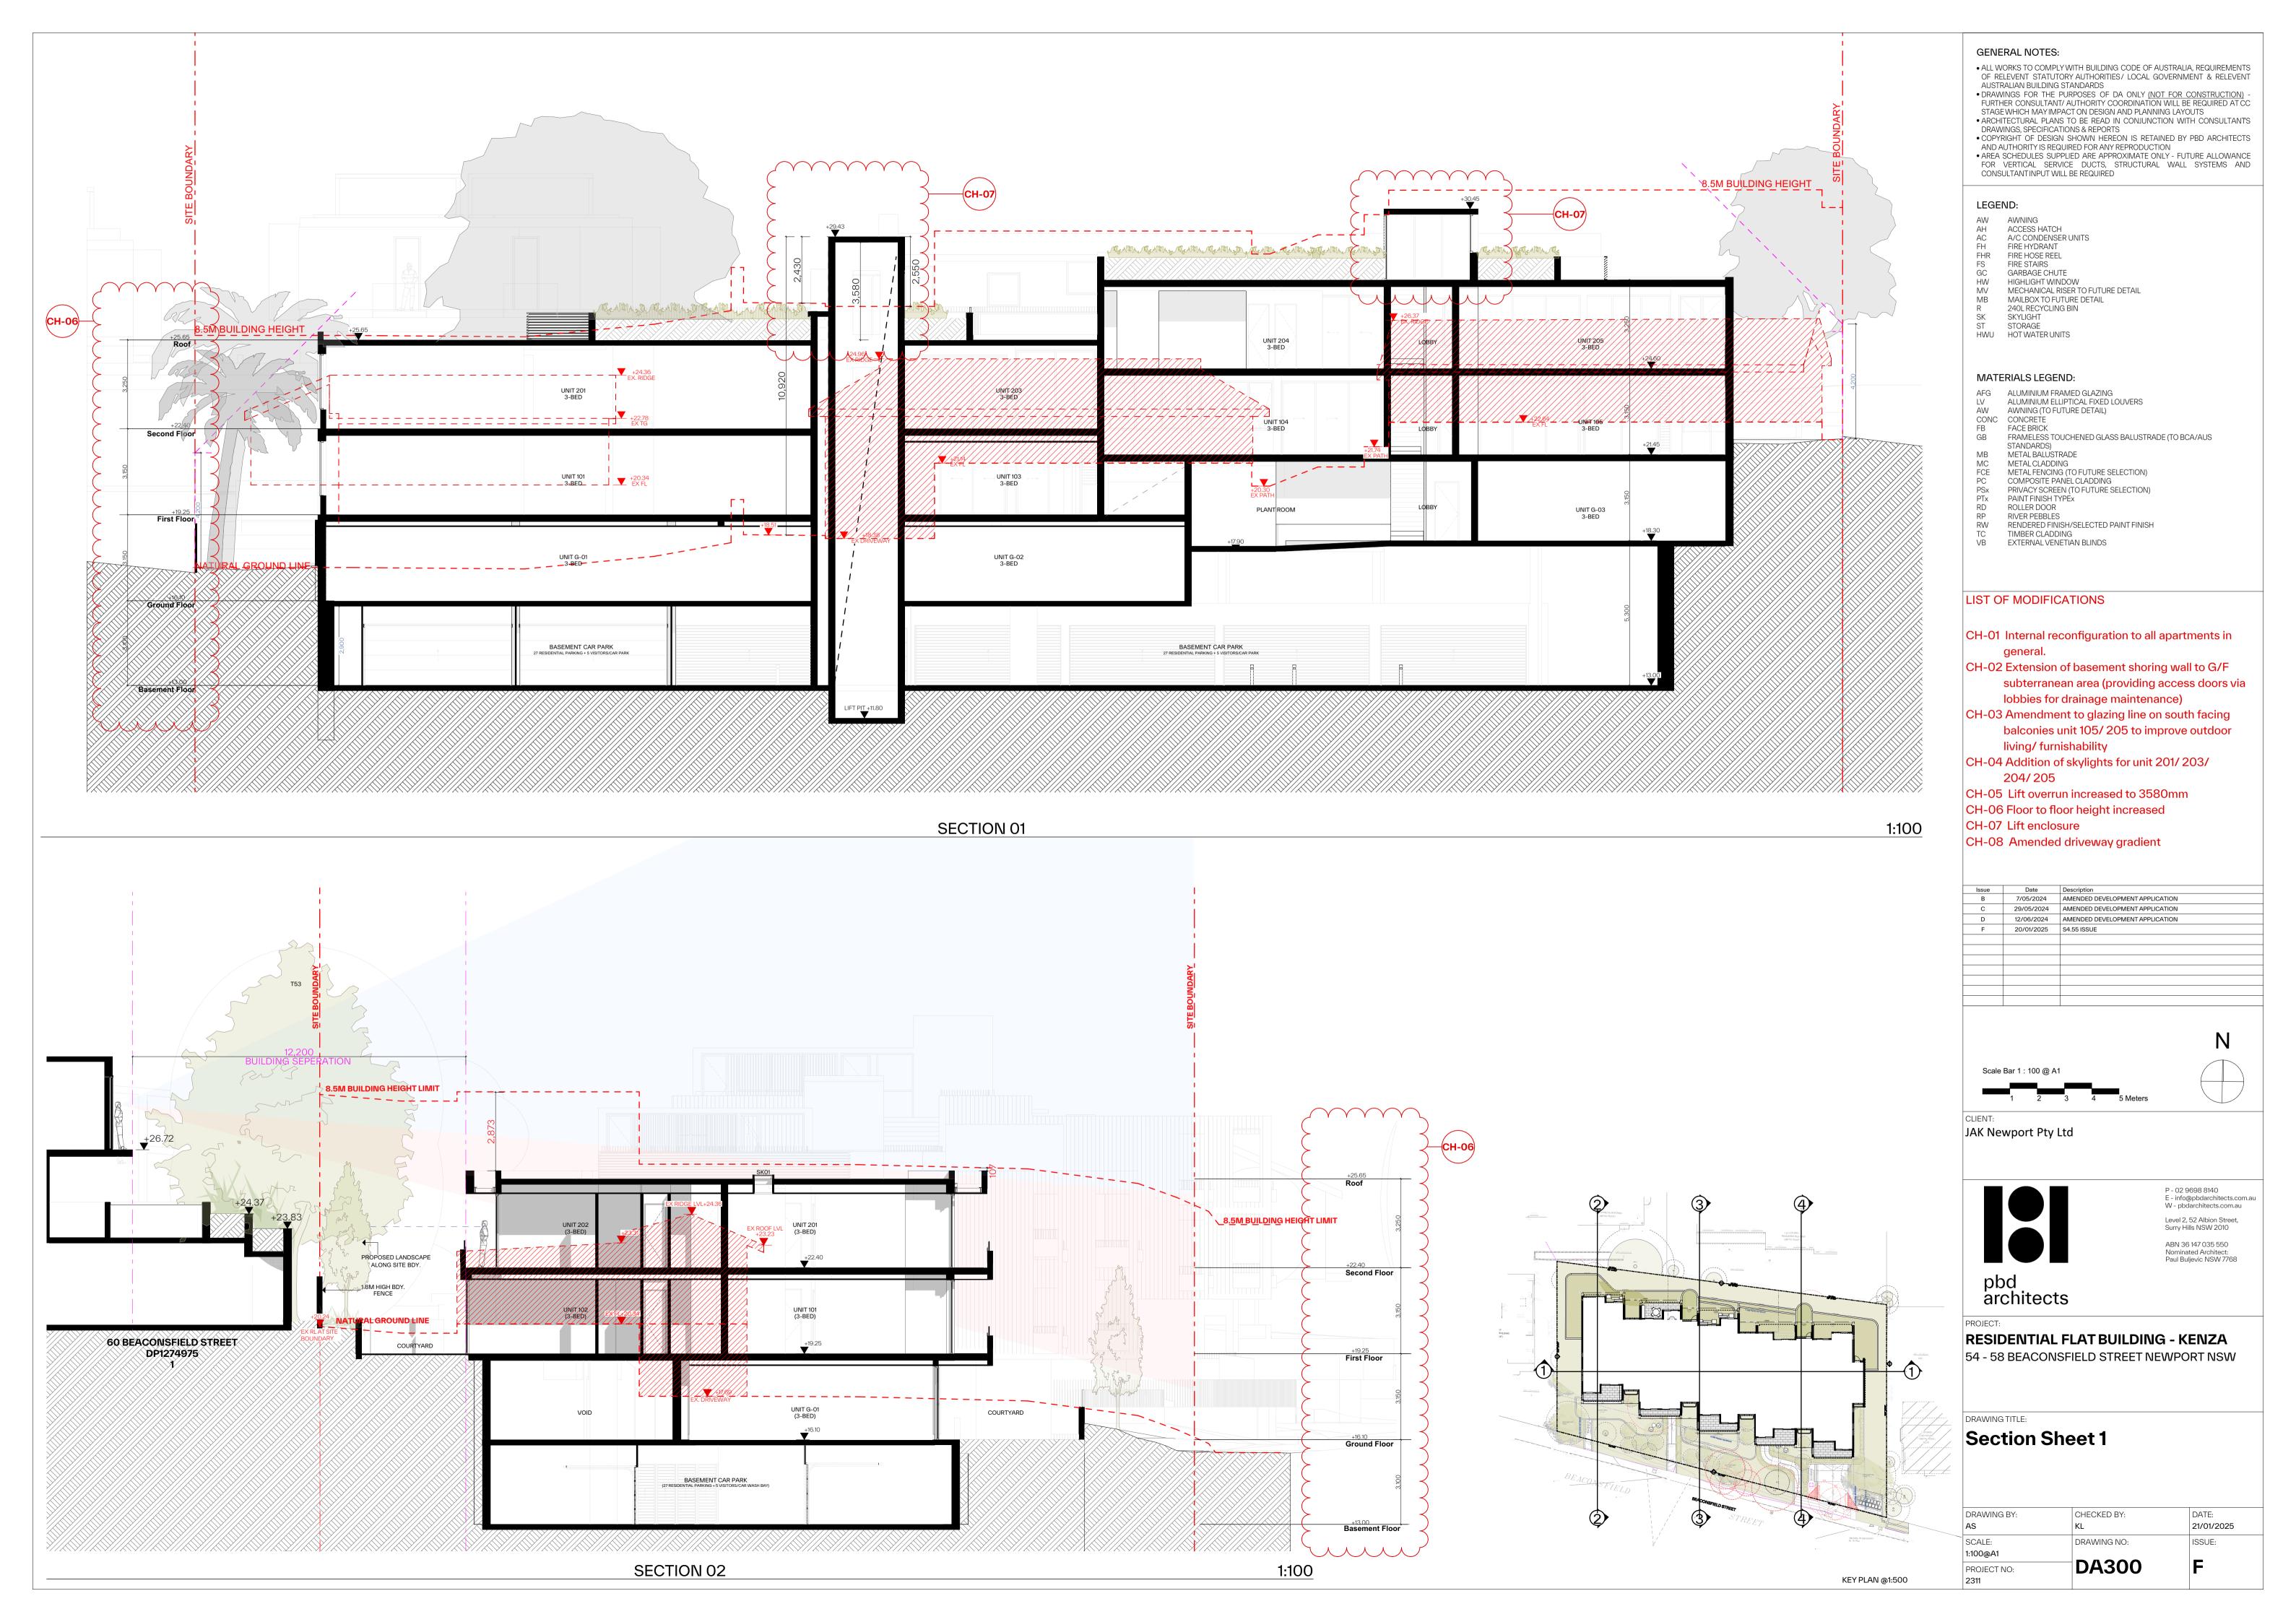

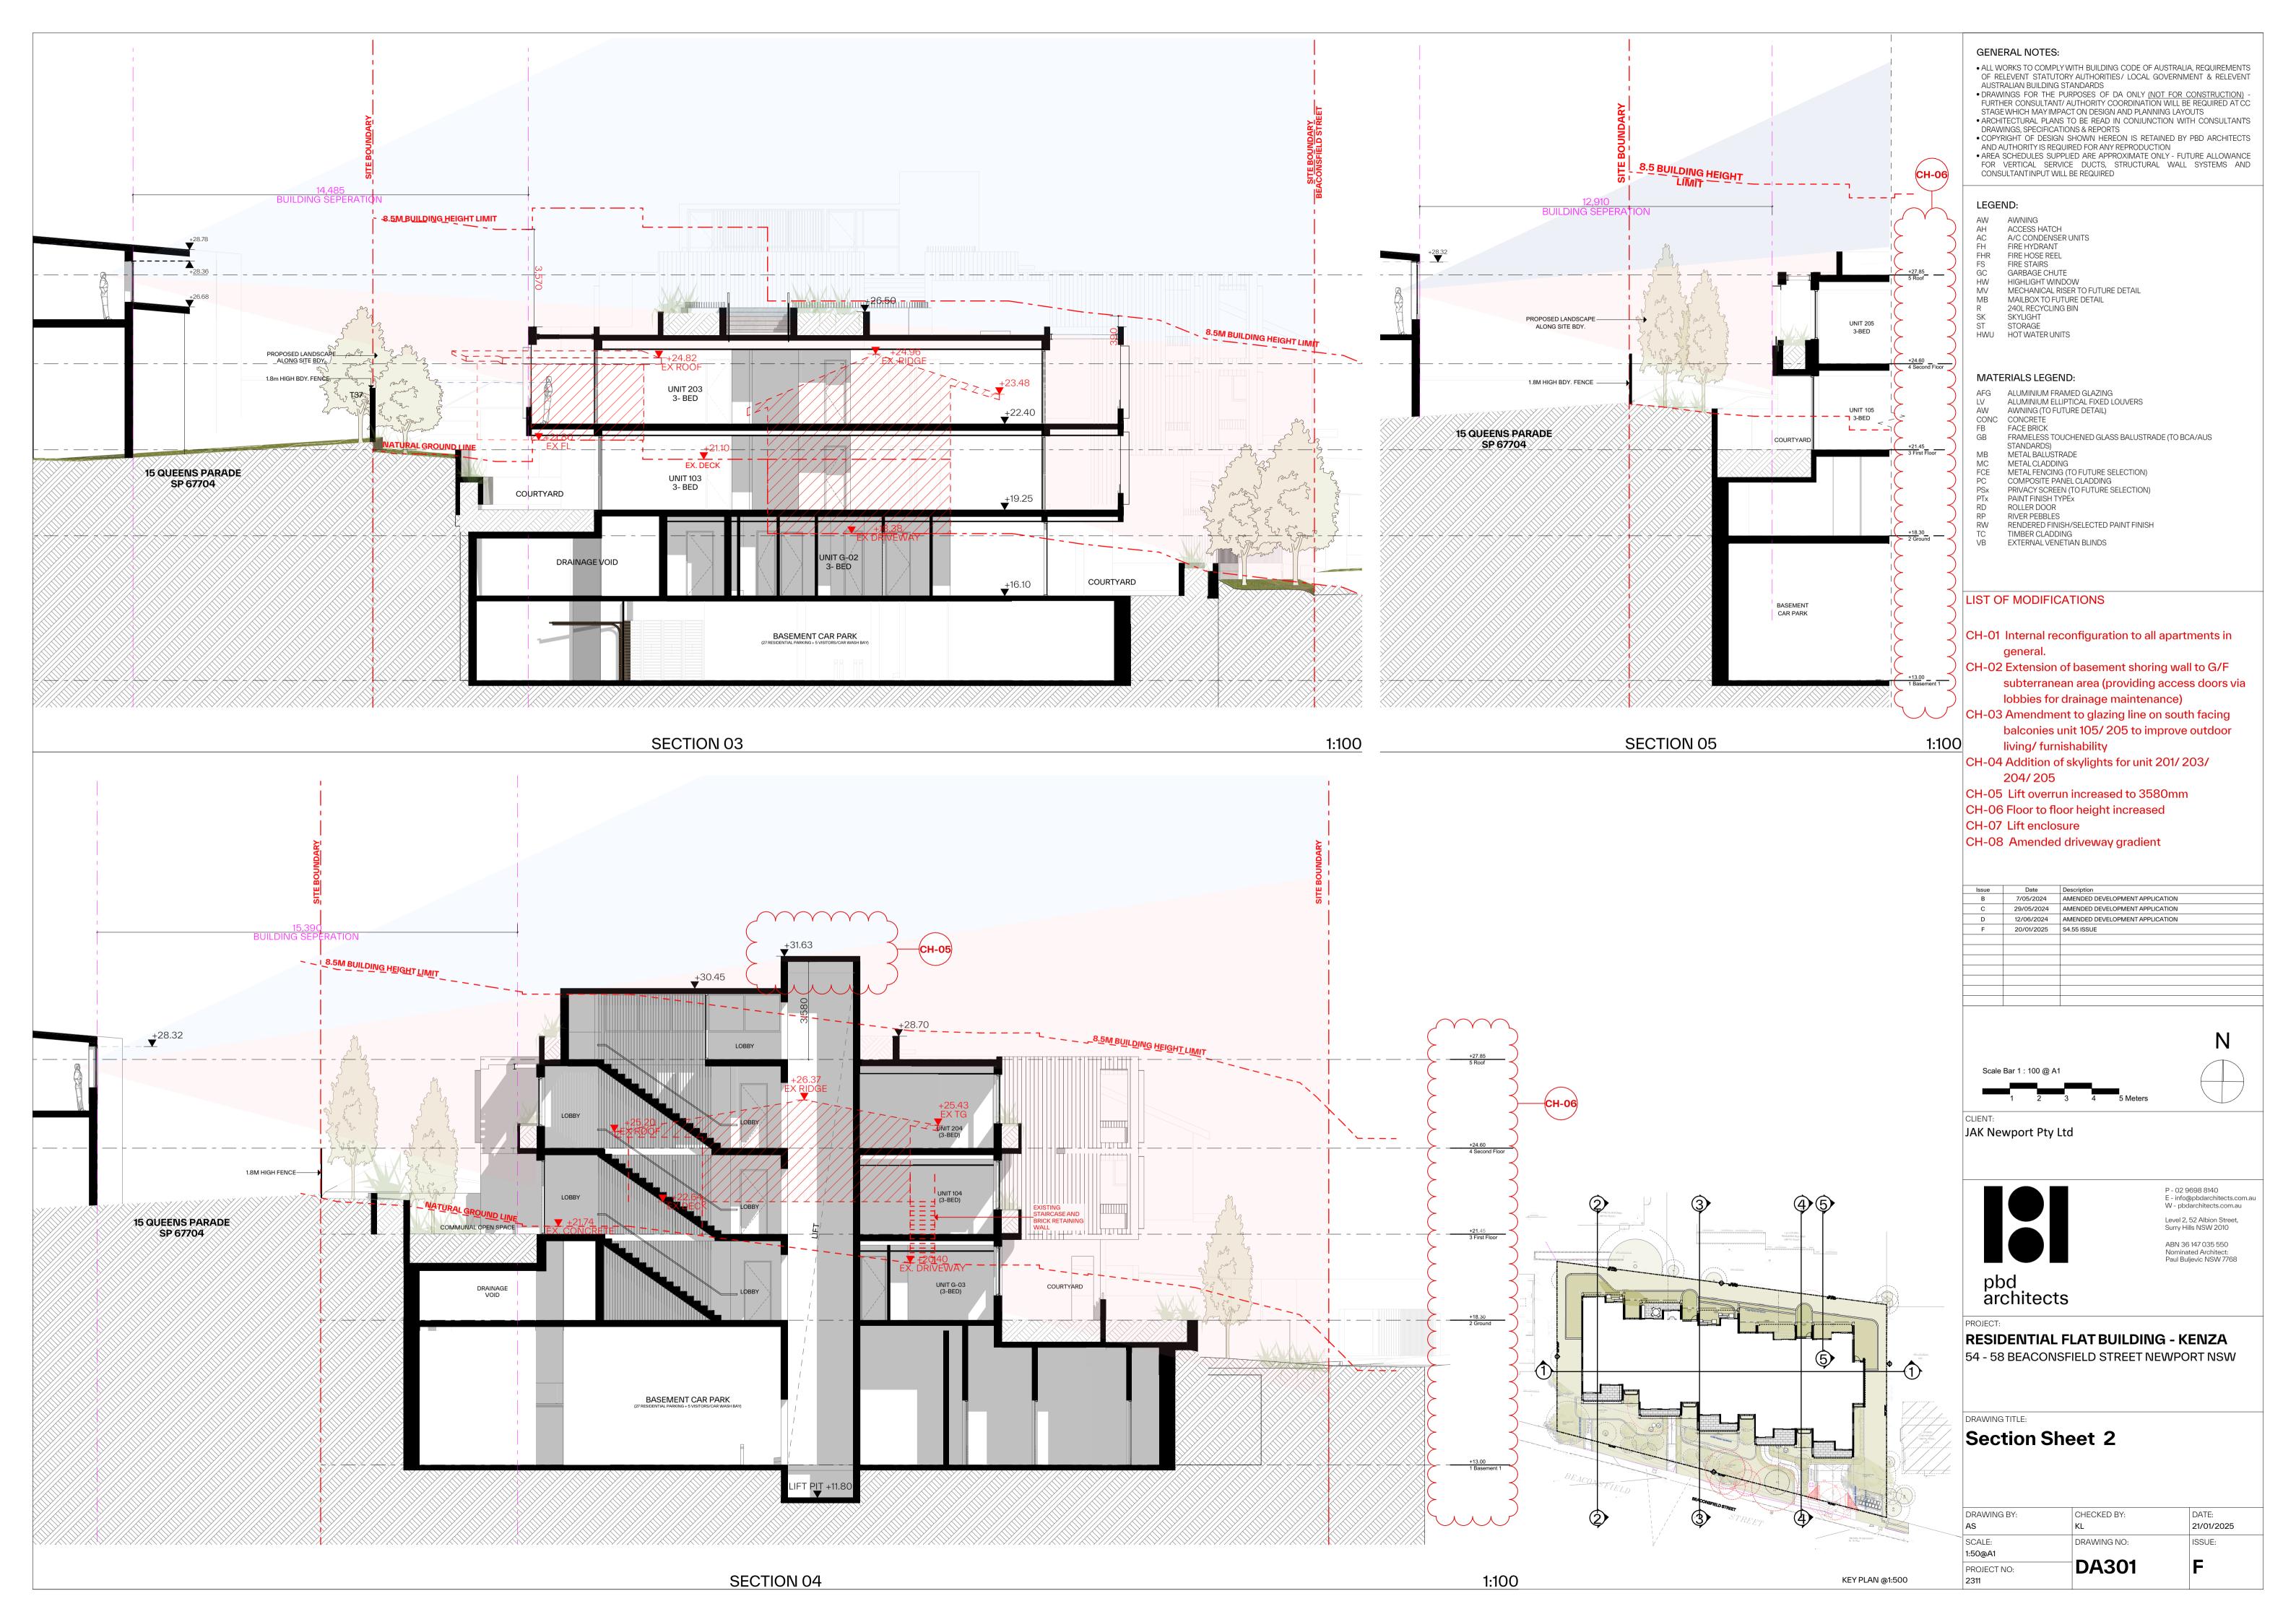



PROPERTY DETAILS:

SITE AREA: 2,113.5m² ZONE: R3 MEDIUM DENSITY RESIDENTIAL

LEGEND:

LANDSCAPED AREA

MIN. LANDSCAPED AREA: 50% MIN. LANDSCAPED AREA: 1,056m²

LANDSCAPED AREA SUMMARY

LEVEL First Floor Roof AREA 105 956

PROPOSED LANDSCAPED AREA: 50.2% PROPOSED LANDSCAPED AREA: 1061m²

GENERAL NOTES:

ALL WORKS TO COMPLY WITH BUILDING CODE OF AUSTRALIA, REQUIREMENTS OF RELEVENT STATUTORY AUTHORITIES / LOCAL GOVERNMENT & RELEVENT AUSTRALIAN BUILDING STANDARDS

DRAWINGS FOR THE PURPOSES OF DA ONLY (NOT FOR CONSTRUCTION) - FURTHER CONSULTANT AUTHORITY COORDINATION WILL BE REQUIRED AT CC STAGE WHICH MAY IMPACT ON DESIGN AND PLANNING LAYOUTS

ARCHITECTURAL PLANS TO BE READ IN CONJUNCTION WITH CONSULTANTS DRAWINGS, SPECIFICATIONS & REPORTS
COPYRIGHT OF DESIGN SHOWN HEREON IS RETAINED BY PBD ARCHITECTS AND AUTHORITY IS REQUIRED FOR ANY REPRODUCTION

AREA SCHEDLILES SUPPLIED ARE APPROXIMATE ONLY - FUTURE ALLOWANCE

 AREA SCHEDULES SUPPLIED ARE APPROXIMATE ONLY - FUTURE ALLOWANCE FOR VERTICAL SERVICE DUCTS, STRUCTURAL WALL SYSTEMS AND CONSULTANTINPUT WILL BE REQUIRED

LEGEND:

AWNING ACCESS HATCH AW AH AC FH FHR FS GC HW MV MB R A/C CONDENSER UNITS

FIRE HYDRANT

FIRE HOSE REEL FIRE STAIRS GARBAGE CHUTE

GARBAGE CHUTE
HIGHLIGHT WINDOW
MECHANICAL RISER TO FUTURE DETAIL
MAILBOX TO FUTURE DETAIL
240L RECYCLING BIN
SKYLIGHT
STORAGE

ST STORAGE HWU HOT WATER UNITS

MATERIALS LEGEND:

AFG ALUMINIUM FRAMED GLAZING
LV ALUMINIUM ELLIPTICAL FIXED LOUVERS
AW AWNING (TO FUTURE DETAIL)
CONC CONCRETE
FB FACE BRICK

FRAMELESS TOUCHENED GLASS BALUSTRADE (TO BCA/AUS

STANDARDS) METAL BALUSTRADE

METAL BALUSTRADE
METAL CLADDING
METAL FENCING (TO FUTURE SELECTION)
COMPOSITE PANEL CLADDING
PRIVACY SCREEN (TO FUTURE SELECTION)
PAINT FINISH TYPEX
ROLLER DOOR
RIVER PEBBLES
PENDEPED FINISH/SELECTED PAINT FINISH

MB MC FCE PC PSx PTx RD

RENDERED FINISH/SELECTED PAINT FINISH

TIMBER CLADDING EXTERNAL VENETIAN BLINDS

LIST OF MODIFICATIONS

CH-01 Internal reconfiguration to all apartments in

CH-02 Extension of basement shoring wall to G/F

subterranean area (providing access doors via lobbies for drainage maintenance)

CH-03 Amendment to glazing line on south facing balconies unit 105/205 to improve outdoor living/furnishability


CH-04 Addition of skylights for unit 201/203/ 204/205

CH-05 Lift overrun increased to 3580mm CH-06 Floor to floor height increased

CH-07 Lift enclosure

CH-08 Amended driveway gradient

Issue	Date	Description
Α	28/11/2023	DEVELOPMENT APPPLICATION
В	7/05/2024	AMENDED DEVELOPMENT APPLICATION
С	29/05/2024	AMENDED DEVELOPMENT APPLICATION
D	12/06/2024	AMENDED DEVELOPMENT APPLICATION
F	20/01/2025	S4.55 ISSUE

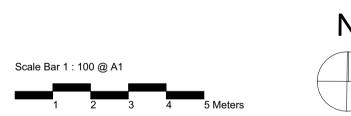

JAK Newport Pty Ltd



P - 02 9698 8140 E - info@pbdarchitects.com.au W - pbdarchitects.com.au Level 2, 52 Albion Street, Surry Hills NSW 2010 ABN 36 147 035 550 Nominated Architect: Paul Buljevic NSW 7768

pbd architects

RESIDENTIAL FLAT BUILDING - KENZA 54 - 58 BEACONSFIELD STREET NEWPORT NSW

Landscape Area


1,061 m²

Total

DRAWING BY:	CHECKED BY: KL	DATE: 21/01/2025
SCALE: 1:200, 1:0.67@A1	DRAWING NO:	ISSUE:
PROJECT NO: 2311	DA510	F



Height Limit Diagram 1

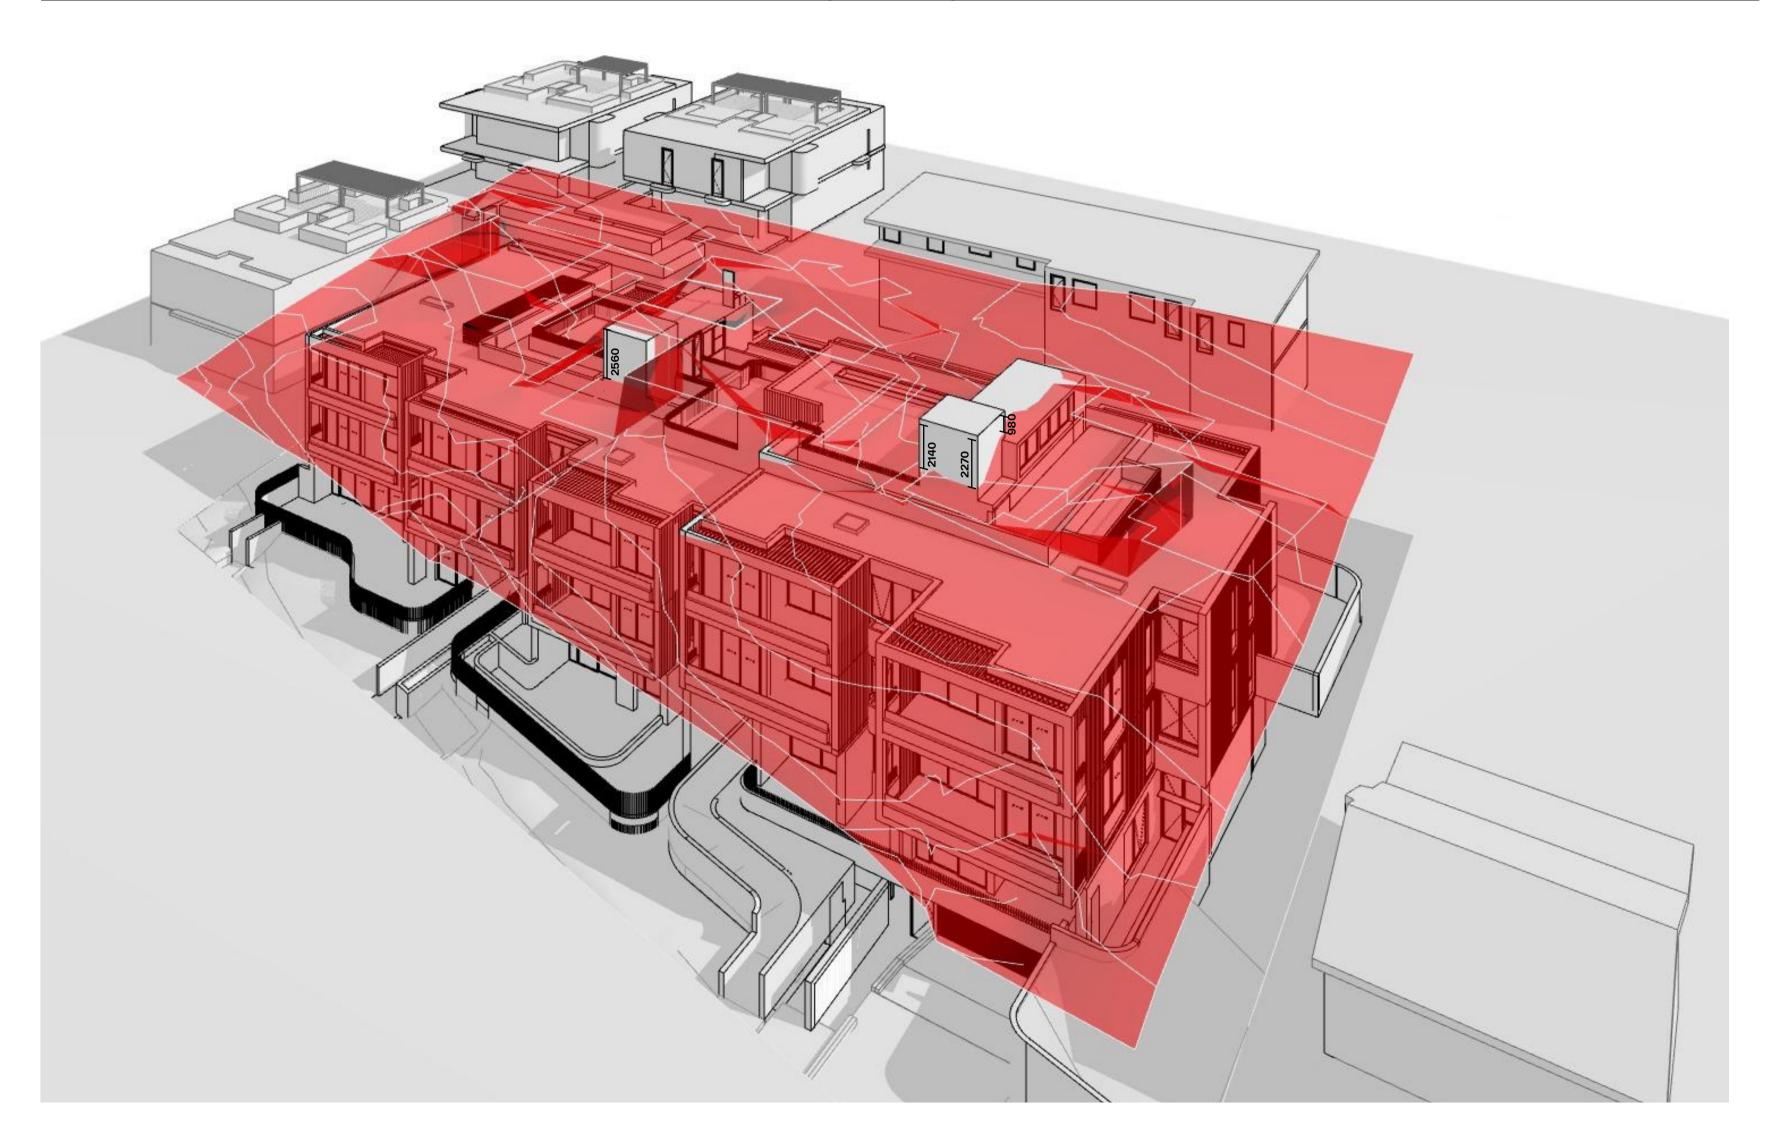

Height Limit Diagram 2

GENERAL NOTES:

ALL WORKS TO COMPLY WITH BUILDING CODE OF AUSTRALIA, REQUIREMENTS OF RELEVENT STATUTORY AUTHORITIES / LOCAL GOVERNMENT & RELEVENT AUSTRALIAN BUILDING STANDARDS

 DRAWINGS FOR THE PURPOSES OF DA ONLY (NOT FOR CONSTRUCTION) - FURTHER CONSULTANT / AUTHORITY COORDINATION WILL BE REQUIRED AT CC STAGE WHICH MAY IMPACT ON DESIGN AND PLANNING LAYOUTS

 ARCHITECTURAL PLANS TO BE READ IN CONJUNCTION WITH CONSULTANT'S DRAWINGS, SPECIFICATIONS & REPORTS

 COPYRIGHT OF DESIGN SHOWN HEREON IS RETAINED BY PRO ARCHITECTS.

 COPYRIGHT OF DESIGN SHOWN HEREON IS RETAINED BY PBD ARCHITECTS
 AND AUTHORITY IS REQUIRED FOR ANY REPRODUCTION AREA SCHEDULES SUPPLIED ARE APPROXIMATE ONLY - FUTURE ALLOWANCE
FOR VERTICAL SERVICE DUCTS, STRUCTURAL WALL SYSTEMS AND
CONSULTANTINPUT WILL BE REQUIRED

LEGEND:

AW AWNING
AH ACCESS HATCH
AC A/C CONDENSER UNITS
FH FIRE HYDRANT
FHR FIRE HOSE REEL
FS FIRE STAIRS
GC GARBAGE CHUTE
HW HIGHLIGHT WINDOW
MV MECHANICAL RISER TO FUTURE DETAIL
MB MAILBOX TO FUTURE DETAIL
R 240L RECYCLING BIN
SK SKYLIGHT
ST STORAGE
HWU HOT WATER UNITS

MATERIALS LEGEND:

AFG ALUMINIUM FRAMED GLAZING
LV ALUMINIUM ELLIPTICAL FIXED LOUVERS
AW AWNING (TO FUTURE DETAIL)
CONC CONCRETE
FB FACE BRICK
GB FRAMELESS TOUCHENED GLASS BALUSTRADE (TO BCA/AUS
STANDARDS)

GB FRAMELESS TOUCHENED GLASS BALUSTRADE STANDARDS)

MB METAL BALUSTRADE

MC METAL CLADDING

FCE METAL FENCING (TO FUTURE SELECTION)

PC COMPOSITE PANEL CLADDING

PSX PRIVACY SCREEN (TO FUTURE SELECTION)

PTX PAINT FINISH TYPEX

RD ROLLER DOOR

RP RIVER PEBBLES

RW RENDERED FINISH/SELECTED PAINT FINISH

TC TIMBER CLADDING


VB EXTERNAL VENETIAN BLINDS

EXTERNAL VENETIAN BLINDS

LEGEND:

HEIGHT PLANE

Issue	Date	Description
А	28/11/2023	DEVELOPMENT APPPLICATION
В	7/05/2024	AMENDED DEVELOPMENT APPLICATION
С	29/05/2024	AMENDED DEVELOPMENT APPLICATION
D	12/06/2024	AMENDED DEVELOPMENT APPLICATION
F	20/01/2025	S4.55 ISSUE

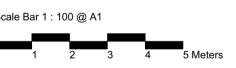

JAK Newport Pty Ltd



P - 02 9698 8140 E - info@pbdarchitects.com.au W - pbdarchitects.com.au Level 2, 52 Albion Street, Surry Hills NSW 2010 ABN 36147035550 Nominated Architect: Paul Buljevic NSW 7768


pbd architects

RESIDENTIAL FLAT BUILDING - KENZA 54 - 58 BEACONSFIELD STREET NEWPORT NSW

Height Limit Diagram

DRAWING BY:	CHECKED BY:	DATE:
AS	KL	21/01/2025
SCALE:	DRAWING NO:	ISSUE:
@A1		_
PROJECT NO:	DA520	F
2311		



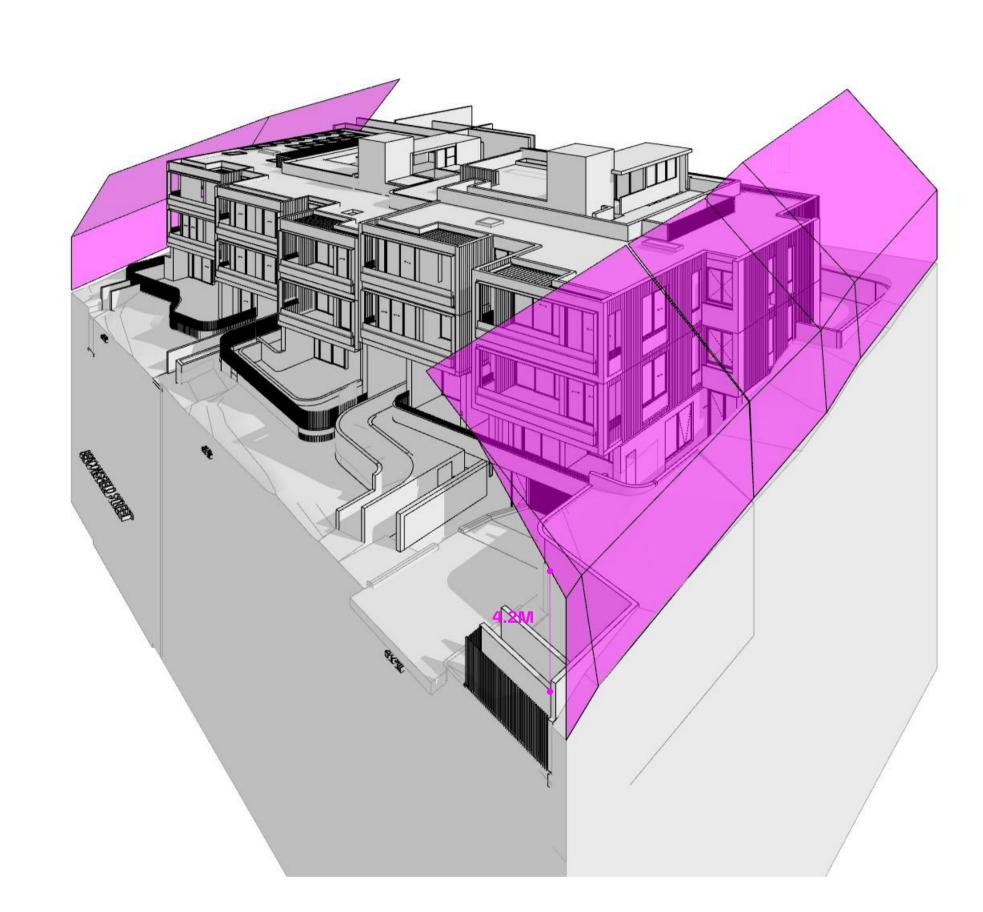

02 EASTERN SIDE BOUNDARY

GENERAL NOTES:

ALL WORKS TO COMPLY WITH BUILDING CODE OF AUSTRALIA, REQUIREMENTS OF RELEVENT STATUTORY AUTHORITIES / LOCAL GOVERNMENT & RELEVENT AUSTRALIAN BUILDING STANDARDS

 DRAWINGS FOR THE PURPOSES OF DA ONLY (NOT FOR CONSTRUCTION) - FURTHER CONSULTANT / AUTHORITY COORDINATION WILL BE REQUIRED AT CC STAGE WHICH MAY IMPACT ON DESIGN AND PLANNING LAYOUTS

 ARCHITECTURAL PLANS TO BE READ IN CONJUNCTION WITH CONSULTANT'S DRAWINGS, SPECIFICATIONS & REPORTS

 COPYRIGHT OF DESIGN SHOWN HEREON IS RETAINED BY PRO ARCHITECTS.

• COPYRIGHT OF DESIGN SHOWN HEREON IS RETAINED BY PBD ARCHITECTS AND AUTHORITY IS REQUIRED FOR ANY REPRODUCTION AREA SCHEDULES SUPPLIED ARE APPROXIMATE ONLY - FUTURE ALLOWANCE
FOR VERTICAL SERVICE DUCTS, STRUCTURAL WALL SYSTEMS AND
CONSULTANTINPUT WILL BE REQUIRED

LEGEND:

AW AWNING
AH ACCESS HATCH
AC A/C CONDENSER UNITS
FH FIRE HYDRANT
FHR FIRE HOSE REEL
FS FIRE STAIRS
GC GARBAGE CHUTE
HW HIGHLIGHT WINDOW
MV MECHANICAL RISER TO FUTURE DETAIL
MB MAILBOX TO FUTURE DETAIL
R 240L RECYCLING BIN
SK SKYLIGHT
ST STORAGE
HWU HOT WATER UNITS

MATERIALS LEGEND:

AFG ALUMINIUM FRAMED GLAZING
LV ALUMINIUM ELLIPTICAL FIXED LOUVERS
AW AWNING (TO FUTURE DETAIL)
CONC CONCRETE
FB FACE BRICK
GB FRAMELESS TOUCHENED GLASS BALUSTR
STANDARDS)

FRAMELESS TOUCHENED GLASS BALUSTRADE (TO BCA/AUS STANDARDS)

STANDARDS)

MB METAL BALUSTRADE

MC METAL CLADDING

FCE METAL FENCING (TO FUTURE SELECTION)

PC COMPOSITE PANEL CLADDING

PSX PRIVACY SCREEN (TO FUTURE SELECTION)

PTX PAINT FINISH TYPEX

RD ROLLER DOOR

RP RIVER PEBBLES

RW RENDERED FINISH/SELECTED PAINT FINISH

TC TIMBER CLADDING


VB EXTERNAL VENETIAN BLINDS

EXTERNAL VENETIAN BLINDS

LEGEND:

4.2M/45° HEIGHT ENVELOPE

Issue	Date	Description
Α	28/11/2023	DEVELOPMENT APPPLICATION
В	7/05/2024	AMENDED DEVELOPMENT APPLICATION
С	29/05/2024	AMENDED DEVELOPMENT APPLICATION
D	12/06/2024	AMENDED DEVELOPMENT APPLICATION
F	20/01/2025	S4.55 ISSUE

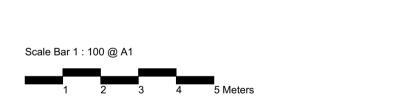

JAK Newport Pty Ltd



P - 02 9698 8140 E - info@pbdarchitects.com.au W - pbdarchitects.com.au Level 2, 52 Albion Street, Surry Hills NSW 2010 ABN 36 147 035 550 Nominated Architect: Paul Buljevic NSW 7768

pbd architects


RESIDENTIAL FLAT BUILDING - KENZA

54 - 58 BEACONSFIELD STREET NEWPORT NSW

4.2m Height Envelope Diagram

DRAWING BY:	CHECKED BY:	DATE:
AS	KL	21/01/2025
SCALE:	DRAWING NO:	ISSUE:
@A1		
PROJECT NO:	DA522	F
2311		



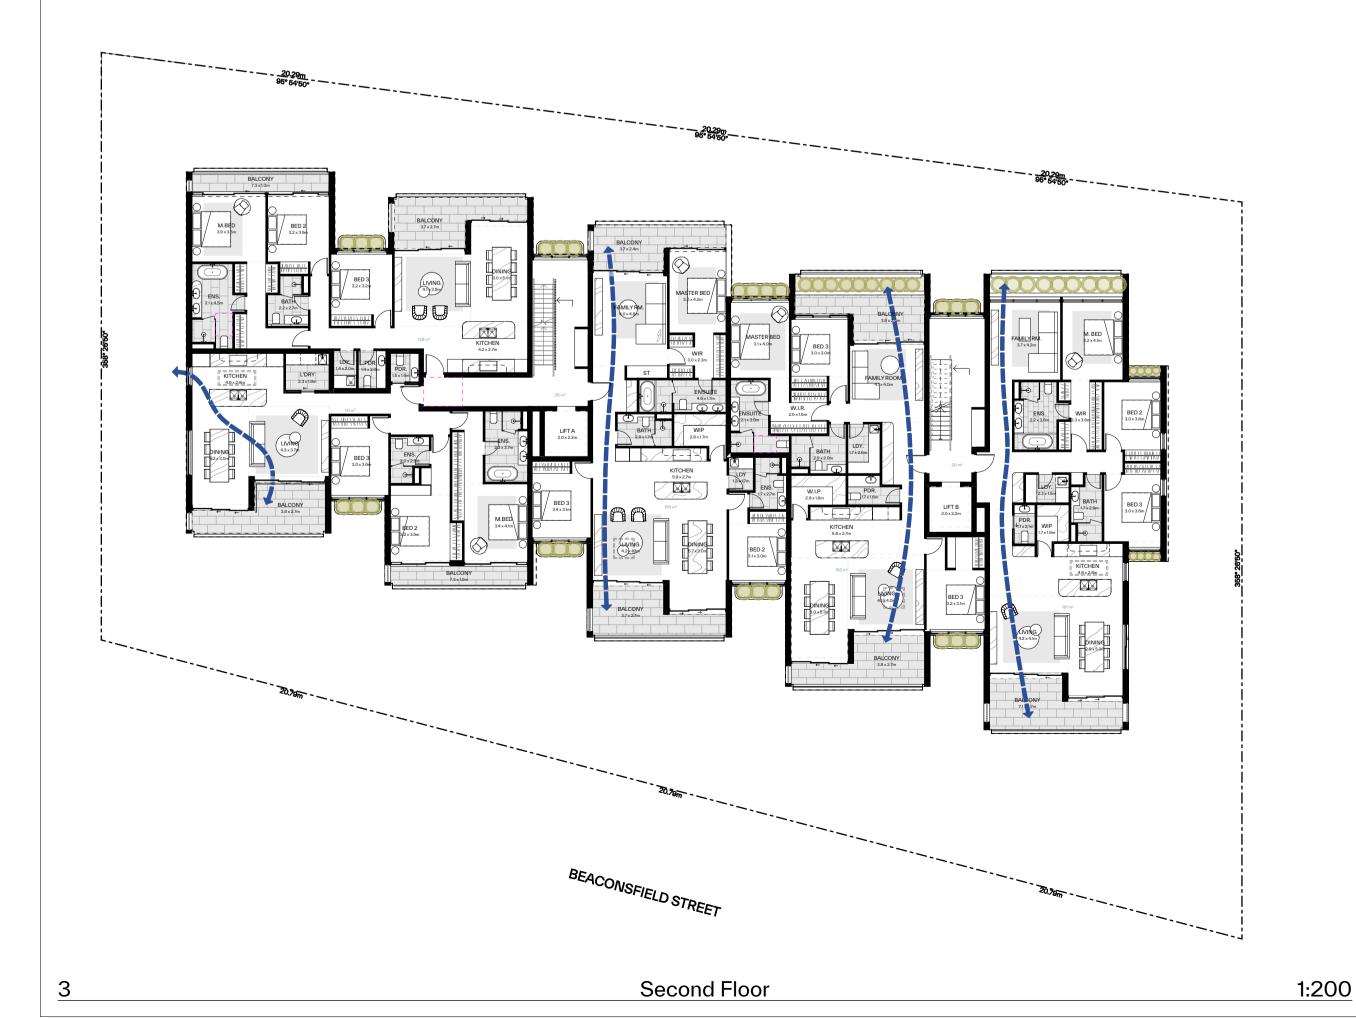

LEGEND: NATURALLY CROSS VENTILATED APARTMENTS

NATURAL VENTILATION CALCULATIONS

APARTMENT DESIGN GUIDE

- ALL HABITABLE ROOMS ARE NATURALLY VENTILATED
- AT LEAST 60% OF APARTMENTS ARE NATURALLY CROSS VENTILATED

TOTAL NUMBER OF APERTMENTS- 13 UNITS NATURALLY VENTILATED APARTMENTS- 9 UNITS (69%)

GENERAL NOTES:

ALL WORKS TO COMPLY WITH BUILDING CODE OF AUSTRALIA, REQUIREMENTS OF RELEVENT STATUTORY AUTHORITIES / LOCAL GOVERNMENT & RELEVENT AUSTRALIAN BUILDING STANDARDS

DRAWINGS FOR THE PURPOSES OF DA ONLY (NOT FOR CONSTRUCTION) - FURTHER CONSULTANT / AUTHORITY COORDINATION WILL BE REQUIRED AT CC STAGE WHICH MAY IMPACT ON DESIGN AND PLANNING LAYOUTS

ARCHITECTURAL PLANS TO BE READ IN CONJUNCTION WITH CONSULTANTS DRAWINGS, SPECIFICATIONS & REPORTS

COPYRIGHT OF DESIGN SHOWN HEREON IS RETAINED BY PRO ARCHITECTS. COPYRIGHT OF DESIGN SHOWN HEREON IS RETAINED BY PBD ARCHITECTS
 AND AUTHORITY IS REQUIRED FOR ANY REPRODUCTION AREA SCHEDULES SUPPLIED ARE APPROXIMATE ONLY - FUTURE ALLOWANCE FOR VERTICAL SERVICE DUCTS, STRUCTURAL WALL SYSTEMS AND

LEGEND:

AW AH AC FH FHR FS GC HW MV MB R ACCESS HATCH

A/C CONDENSER UNITS FIRE HYDRANT

FIRE HOSE REEL

FIRE STAIRS
GARBAGE CHUTE

CONSULTANTINPUT WILL BE REQUIRED

GARBAGE CHUTE
HIGHLIGHT WINDOW
MECHANICAL RISER TO FUTURE DETAIL
MAILBOX TO FUTURE DETAIL
240L RECYCLING BIN

SK SKYLIGHT
ST STORAGE
HWU HOT WATER UNITS

MATERIALS LEGEND:

AFG ALUMINIUM FRAMED GLAZING
LV ALUMINIUM ELLIPTICAL FIXED LOUVERS
AW AWNING (TO FUTURE DETAIL)
CONC CONCRETE
FB FACE BRICK
GB FRAMELESS TOUCHENED GLASS BALUSTE FRAMELESS TOUCHENED GLASS BALUSTRADE (TO BCA/AUS STANDARDS)

METAL BALUSTRADE

METAL BALUSTRADE
METAL CLADDING
METAL FENCING (TO FUTURE SELECTION)
COMPOSITE PANEL CLADDING
PRIVACY SCREEN (TO FUTURE SELECTION)
PAINT FINISH TYPEX
ROLLER DOOR
RIVER PEBBLES

MB MC FCE PC PSx PTx RD

RP RW

RENDERED FINISH/SELECTED PAINT FINISH TIMBER CLADDING

EXTERNAL VENETIAN BLINDS

LIST OF MODIFICATIONS

CH-01 Internal reconfiguration to all apartments in

CH-02 Extension of basement shoring wall to G/F

subterranean area (providing access doors via lobbies for drainage maintenance) CH-03 Amendment to glazing line on south facing

balconies unit 105/205 to improve outdoor living/ furnishability CH-04 Addition of skylights for unit 201/203/


204/205

CH-05 Lift overrun increased to 3580mm CH-06 Floor to floor height increased

CH-07 Lift enclosure

CH-08 Amended driveway gradient

Issue	Date	Description	
Α	28/11/2023	DEVELOPMENT APPPLICATION	
В	7/05/2024	AMENDED DEVELOPMENT APPLICATION	
С	29/05/2024	AMENDED DEVELOPMENT APPLICATION	
D	12/06/2024	AMENDED DEVELOPMENT APPLICATION	
F	20/01/2025	S4.55 ISSUE	

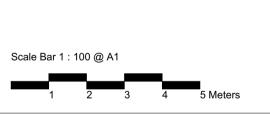

JAK Newport Pty Ltd



P - 02 9698 8140 E - info@pbdarchitects.com.au W - pbdarchitects.com.au Level 2, 52 Albion Street, Surry Hills NSW 2010 ABN 36 147 035 550 Nominated Architect: Paul Buljevic NSW 7768

pbd architects


RESIDENTIAL FLAT BUILDING - KENZA 54 - 58 BEACONSFIELD STREET NEWPORT NSW

Cross Ventilation Diagram

DRAWING BY:	CHECKED BY:	DATE:
AS	KL	21/01/2025
SCALE:	DRAWING NO:	ISSUE:
1:100, 1:200@A1		
PROJECT NO:	DA530	∣F
2211		



1:200

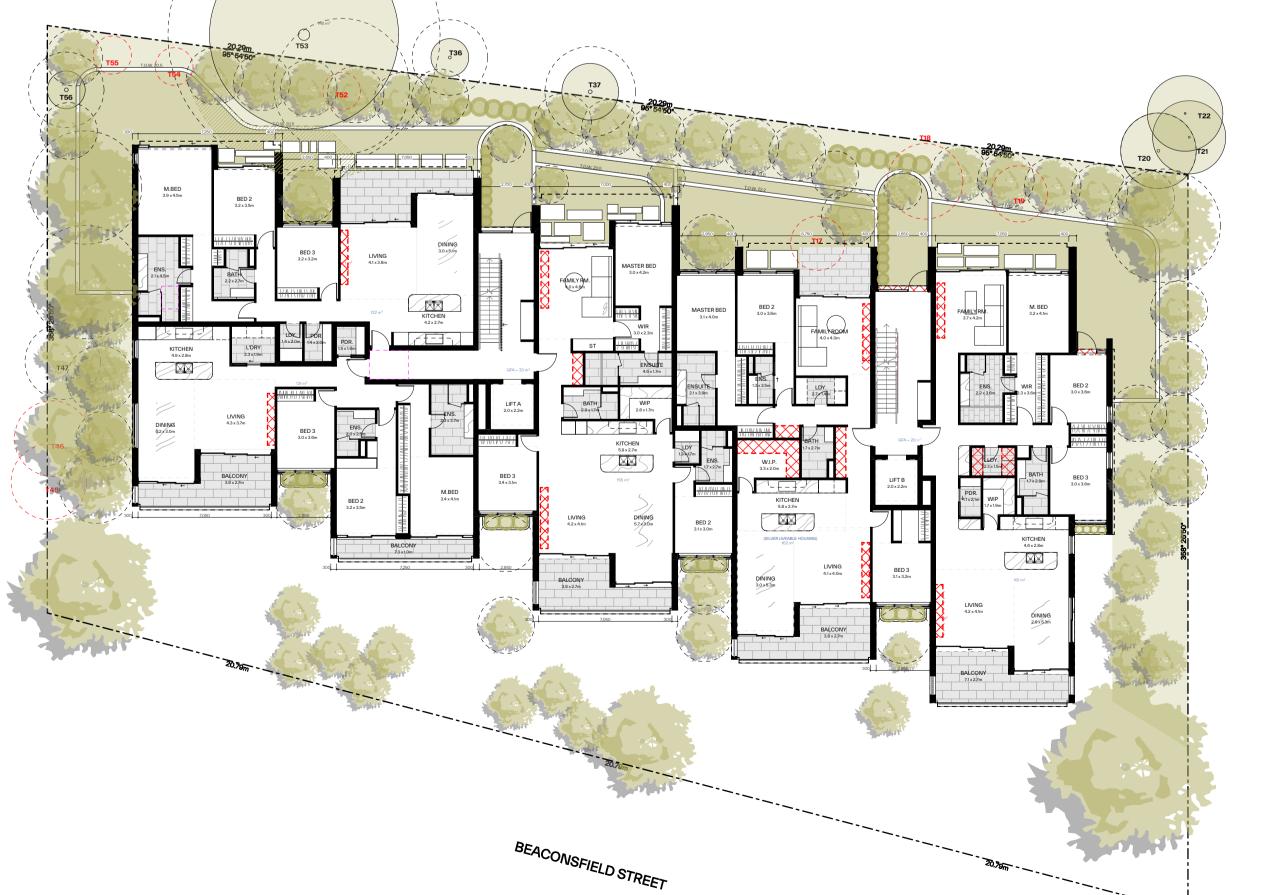

Typical Level (First & Second Floor Plan)

Basement 1

STORAGE - ADG REQUIREMENTS

1 BEDROOM 2 BEDROOM 8m3 3 BEDROOM

At least 50% of the required storage is to be located within the apartment



GENERAL NOTES:

ALL WORKS TO COMPLY WITH BUILDING CODE OF AUSTRALIA, REQUIREMENTS OF RELEVENT STATUTORY AUTHORITIES / LOCAL GOVERNMENT & RELEVENT AUSTRALIAN BUILDING STANDARDS

DRAWINGS FOR THE PURPOSES OF DA ONLY (NOT FOR CONSTRUCTION) - FURTHER CONSULTANT / AUTHORITY COORDINATION WILL BE REQUIRED AT CC STAGE WHICH MAY IMPACT ON DESIGN AND PLANNING LAYOUTS

ARCHITECTURAL PLANS TO BE READ IN CONJUNCTION WITH CONSULTANTS DRAWINGS, SPECIFICATIONS & REPORTS

COPYRIGHT OF DESIGN SHOWN HEREON IS RETAINED BY PRO ARCHITECTS.

 COPYRIGHT OF DESIGN SHOWN HEREON IS RETAINED BY PBD ARCHITECTS
 AND AUTHORITY IS REQUIRED FOR ANY REPRODUCTION AREA SCHEDULES SUPPLIED ARE APPROXIMATE ONLY - FUTURE ALLOWANCE FOR VERTICAL SERVICE DUCTS, STRUCTURAL WALL SYSTEMS AND

LEGEND:

ACCESS HATCH A/C CONDENSER UNITS

FIRE HYDRANT

FIRE HOSE REEL FIRE STAIRS
GARBAGE CHUTE

HIGHLIGHT WINDOW
MECHANICAL RISER TO FUTURE DETAIL
MAILBOX TO FUTURE DETAIL
240L RECYCLING BIN

SK SKYLIGHT
ST STORAGE
HWU HOT WATER UNITS

MATERIALS LEGEND:

AFG ALUMINIUM FRAMED GLAZING
LV ALUMINIUM ELLIPTICAL FIXED LOUVERS
AW AWNING (TO FUTURE DETAIL)
CONC CONCRETE
FB FACE BRICK
GB FRAMELESS TOUCHENED GLASS BALUSTF FRAMELESS TOUCHENED GLASS BALUSTRADE (TO BCA/AUS STANDARDS)

METAL BALUSTRADE

METAL BALUSTRADE
METAL CLADDING
METAL FENCING (TO FUTURE SELECTION)
COMPOSITE PANEL CLADDING
PRIVACY SCREEN (TO FUTURE SELECTION)
PAINT FINISH TYPEX
ROLLER DOOR
RIVER PEBBLES

RENDERED FINISH/SELECTED PAINT FINISH

TIMBER CLADDING EXTERNAL VENETIAN BLINDS

LIST OF MODIFICATIONS

CH-01 Internal reconfiguration to all apartments in

CH-02 Extension of basement shoring wall to G/F subterranean area (providing access doors via

lobbies for drainage maintenance) CH-03 Amendment to glazing line on south facing balconies unit 105/205 to improve outdoor


living/ furnishability CH-04 Addition of skylights for unit 201/203/ 204/205

CH-05 Lift overrun increased to 3580mm CH-06 Floor to floor height increased

CH-07 Lift enclosure

CH-08 Amended driveway gradient

A	28/11/2023	DEVELOPMENT APPPLICATION
В	7/05/2024	AMENDED DEVELOPMENT APPLICATION
С	29/05/2024	AMENDED DEVELOPMENT APPLICATION
D	12/06/2024	AMENDED DEVELOPMENT APPLICATION
F	20/01/2025	S4.55 ISSUE

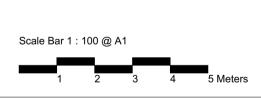

JAK Newport Pty Ltd



P - 02 9698 8140 E - info@pbdarchitects.com.au W - pbdarchitects.com.au Level 2, 52 Albion Street, Surry Hills NSW 2010 ABN 36 147 035 550 Nominated Architect: Paul Buljevic NSW 7768


pbd architects

RESIDENTIAL FLAT BUILDING - KENZA 54 - 58 BEACONSFIELD STREET NEWPORT NSW


Storage Calculation Diagram

DRAWING BY:	CHECKED BY:	DATE:
AS	KL	21/01/2025
SCALE:	DRAWING NO:	ISSUE:
1:200@A1		
PROJECT NO:	DA560	F
2311		



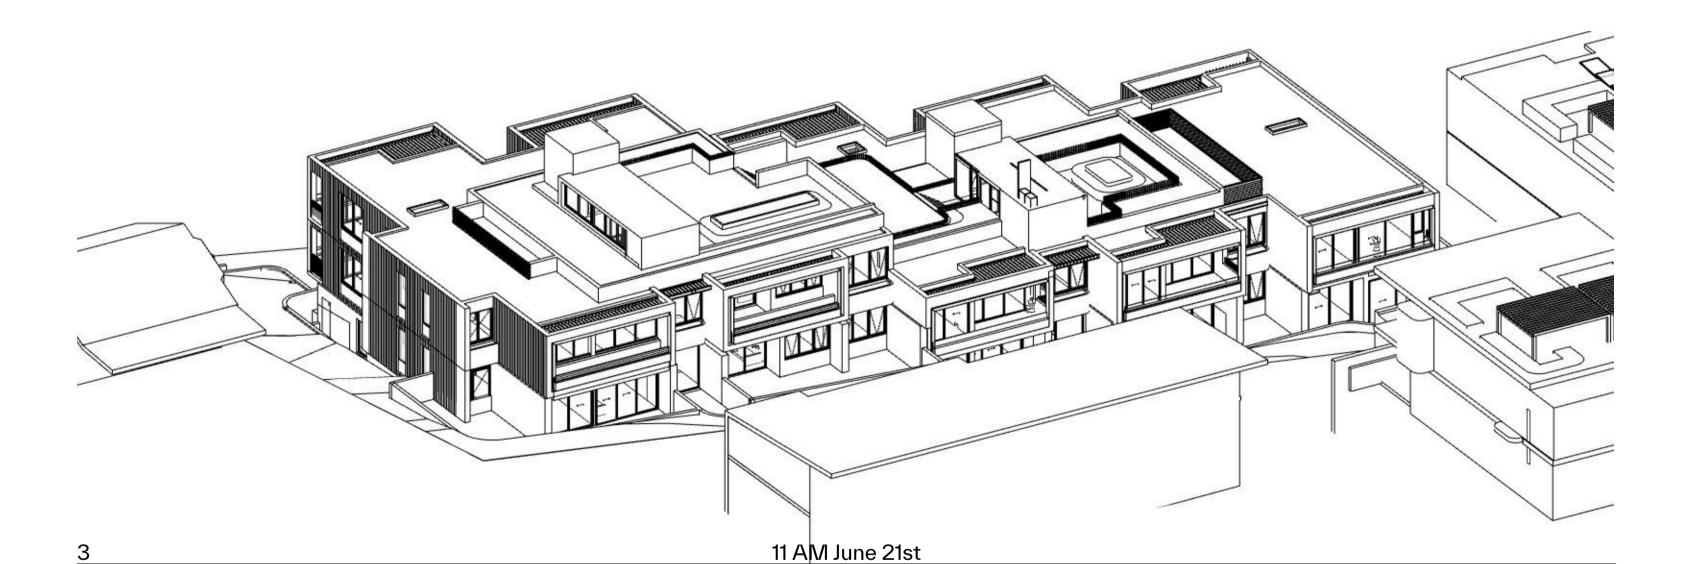

10 AM June 21st

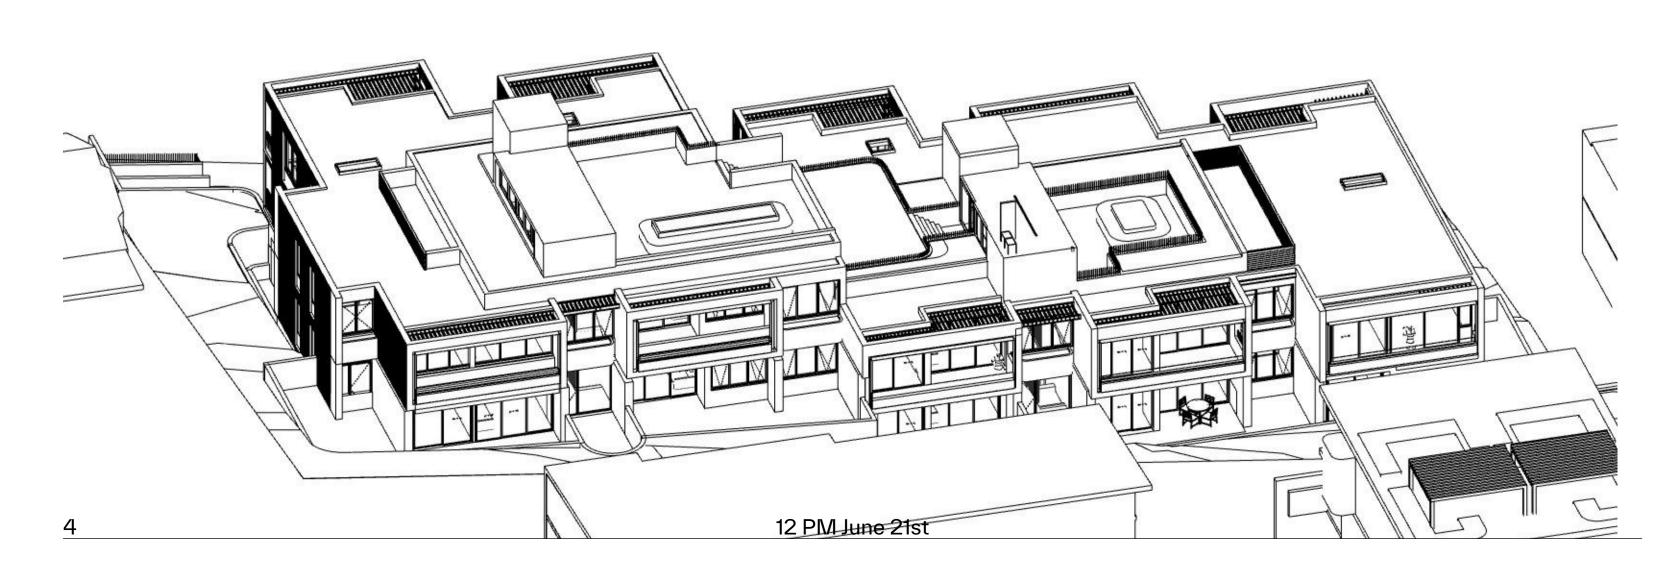

SOLAR COMPLIANCE CHECK

TOTAL UNIT

UNIT		LIVING						
UNII	9AM	10AM	11AM	12PM	1PM	2PM	3РМ	TOTAL
G01								0
G02								0
G03	у	Y	Y					2
101						Y	Y	1
102			Y	Y	Υ	Y	Y	4
103			Y	Y	Υ	Y	Y	4
104	Υ	Υ	Υ	Y	Y	Υ	Y	6
105	Υ	Υ	Υ	Y	Υ	Υ	Υ	6
201	Υ	Υ	Υ	Υ	Υ	Υ	Υ	6
202		Υ	Υ	Υ	Υ	Υ	Υ	5
203		Υ	Υ	Υ	Υ	Υ	Υ	5
204	Υ	Υ	Υ	Υ	Υ	Y	Υ	6
205	Y	Υ	Υ	Υ	Υ	Υ	Υ	6

Solar Access Compliant No Solar Access Non-Compliant **UNIT COMPLIANT**

Solar Compliance 76.9%

GENERAL NOTES:

ALL WORKS TO COMPLY WITH BUILDING CODE OF AUSTRALIA, REQUIREMENTS OF RELEVENT STATUTORY AUTHORITIES / LOCAL GOVERNMENT & RELEVENT AUSTRALIAN BUILDING STANDARDS

DRAWINGS FOR THE PURPOSES OF DA ONLY (NOT FOR CONSTRUCTION) - FURTHER CONSULTANT / AUTHORITY COORDINATION WILL BE REQUIRED AT CC STAGEWHICH MAY IMPACT ON DESIGN AND PLANNING LAYOUTS

ARCHITECTURAL PLANS TO BE READ IN CONJUNCTION WITH CONSULTANTS DRAWINGS, SPECIFICATIONS & REPORTS

COPYRIGHT OF DESIGN SHOWN HEREON IS RETAINED BY PBD ARCHITECTS AND AUTHORITY IS REQUIRED FOR ANY REPRODUCTION

AREA SCHEDULES SUPPLIED ARE APPROXIMATE ONLY - FUTURE ALLOWANCE FOR VERTICAL SERVICE DUCTS, STRUCTURAL WALL SYSTEMS AND CONSULTANTINPUT WILL BE REQUIRED

LEGEND:

AW AWNING
AH ACCESS HATCH
AC A/C CONDENSER UNITS
FH FIRE HYDRANT
FHR FIRE HOSE REEL
FS FIRE STAIRS
GC GARBAGE CHUTE
HW HIGHLIGHT WINDOW
MV MECHANICAL RISER TO FUTURE DETAIL
MB MAILBOX TO FUTURE DETAIL
R 240L RECYCLING BIN
SK SKYLIGHT
ST STORAGE
HWU HOT WATER UNITS

MATERIALS LEGEND:

AFG ALUMINIUM FRAMED GLAZING
LV ALUMINIUM ELLIPTICAL FIXED LOUVERS
AW AWNING (TO FUTURE DETAIL)
CONC CONCRETE
FB FACE BRICK
GB FRAMELESS TOUCHENED GLASS BALUSTRADE (TO BCA/AUS
STANDARDS)

GB FRAMELESS TOUCHENED GLASS BALUSTRADE STANDARDS)

MB METAL BALUSTRADE

MC METAL CLADDING

FCE METAL FENCING (TO FUTURE SELECTION)

PC COMPOSITE PANEL CLADDING

PSX PRIVACY SCREEN (TO FUTURE SELECTION)

PTX PAINT FINISH TYPEX

RD ROLLER DOOR

RP RIVER PEBBLES

RW RENDERED FINISH/SELECTED PAINT FINISH

TC TIMBER CLADDING

VB EXTERNAL VENETIAN BLINDS

EXTERNAL VENETIAN BLINDS

29/05/2024 AMENDED DEVELOPMENT APPLICATION 12/06/2024 AMENDED DEVELOPMENT APPLICATION



JAK Newport Pty Ltd




P - 02 9698 8140 E - info@pbdarchitects.com.au W - pbdarchitects.com.au Level 2, 52 Albion Street, Surry Hills NSW 2010 ABN 36 147 035 550 Nominated Architect: Paul Buljevic NSW 7768


pbd architects


RESIDENTIAL FLAT BUILDING - KENZA 54 - 58 BEACONSFIELD STREET NEWPORT NSW

Solar Access Diagram

DRAWING BY:	(CHECKED BY:	DATE:
AS	k	KL	21/01/2025
SCALE:	С	DRAWING NO:	ISSUE:
NTS			_
PROJECT NO:		DA600	F
2311			

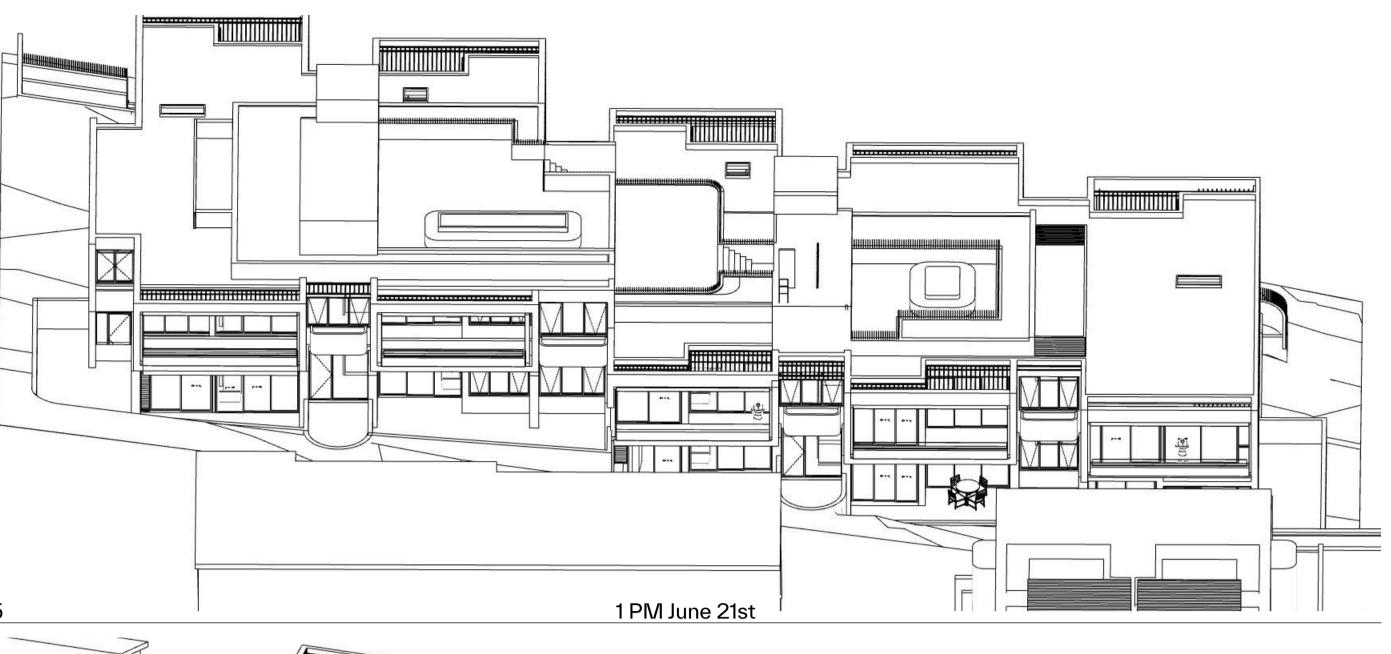

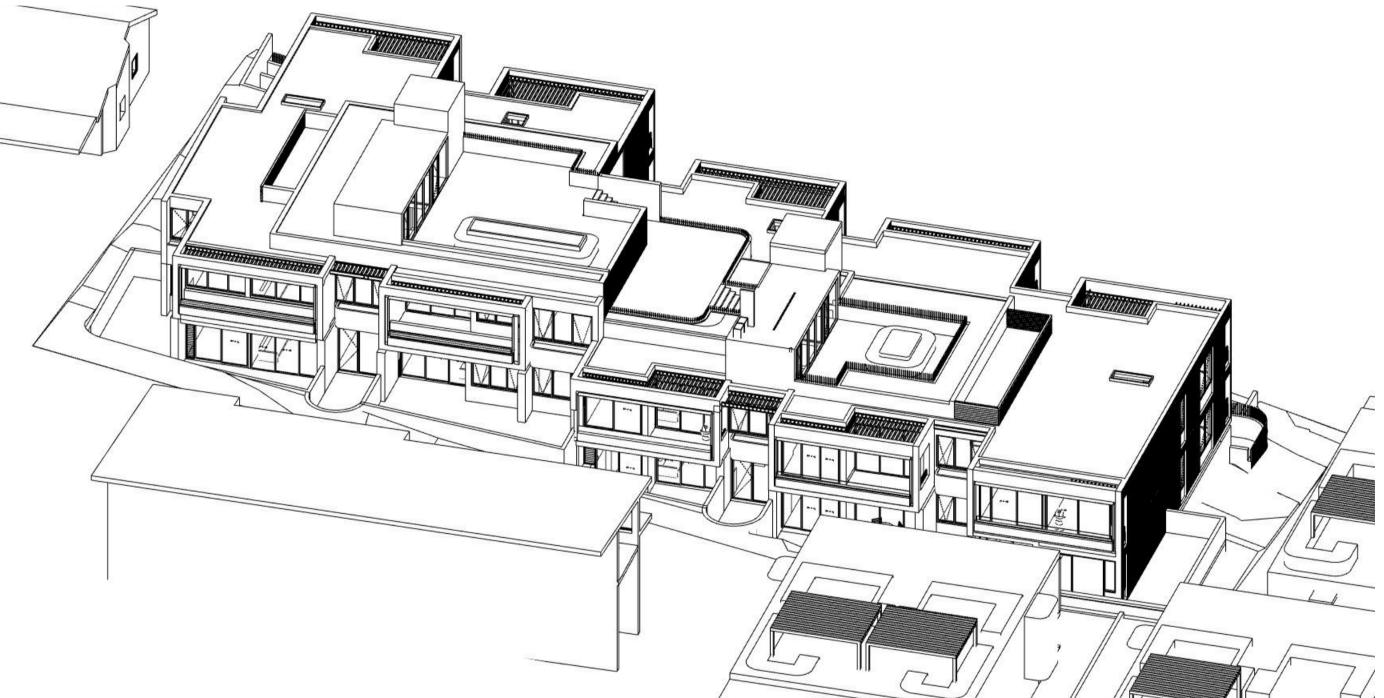

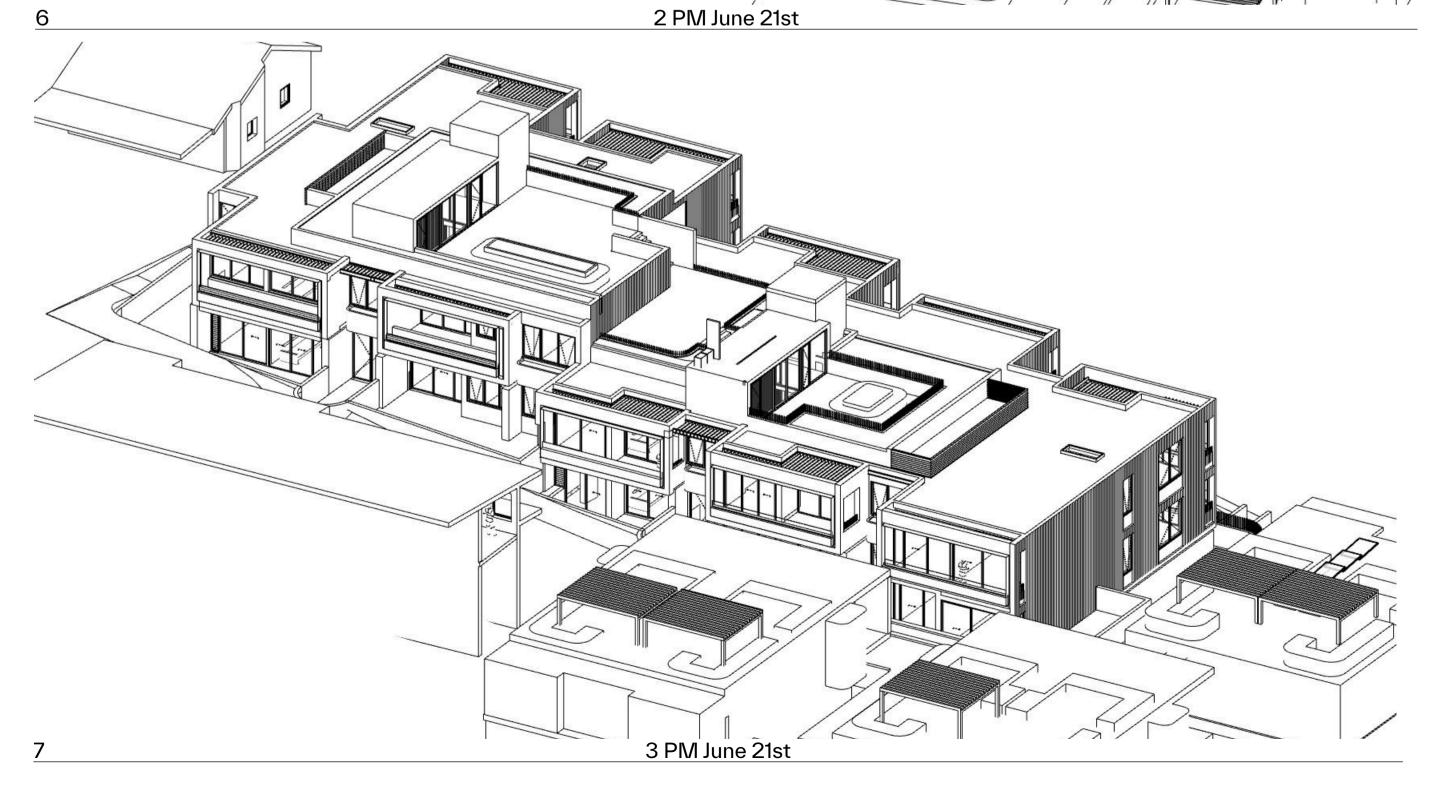

SOLAR COMPLIANCE CHECK

TOTAL UNIT

LINUT		LIVING						
UNIT	9AM	10AM	11AM	12PM	1PM	2PM	3РМ	TOTAL
G01								0
G02								0
G03	у	Y	Y					2
101						Y	Y	1
102			Y	Y	Y	Y	Υ	4
103			Y	Y	Y	Y	Y	4
104	Y	Υ	Y	Y	Y	Y	Y	6
105	Υ	Υ	Y	Y	Y	Y	Y	6
201	Y	Υ	Y	Y	Y	Y	Y	6
202		Υ	Y	Y	Y	Y	Y	5
203		Υ	Y	Υ	Y	Υ	Υ	5
204	Υ	Υ	Y	Υ	Y	Υ	Υ	6
205	Υ	Υ	Υ	Υ	Υ	Υ	Υ	6

Solar Access Compliant No Solar Access Non-Compliant **UNIT COMPLIANT**

Solar Compliance 76.9%

GENERAL NOTES:

ALL WORKS TO COMPLY WITH BUILDING CODE OF AUSTRALIA, REQUIREMENTS OF RELEVENT STATUTORY AUTHORITIES / LOCAL GOVERNMENT & RELEVENT AUSTRALIAN BUILDING STANDARDS

 DRAWINGS FOR THE PURPOSES OF DA ONLY (NOT FOR CONSTRUCTION) - FURTHER CONSULTANT / AUTHORITY COORDINATION WILL BE REQUIRED AT CC STAGE WHICH MAY IMPACT ON DESIGN AND PLANNING LAYOUTS

 ARCHITECTURAL PLANS TO BE READ IN CONJUNCTION WITH CONSULTANTS DRAWINGS, SPECIFICATIONS & REPORTS

 COPYRIGHT OF DESIGN SHOWN HEREON IS RETAINED BY PBD ARCHITECTS AND AUTHORITY IS REQUIRED FOR ANY REPRODUCTION

 AREA SCHEDULES SUPPLIED ARE APPROXIMATE ONLY - FUTURE ALLOWANCE FOR VERTICAL SERVICE DUCTS, STRUCTURAL WALL SYSTEMS AND CONSULTANTINPUT WILL BE REQUIRED

LEGEND:

AW AWNING
AH ACCESS HATCH
AC A/C CONDENSER UNITS
FH FIRE HYDRANT
FHR FIRE HOSE REEL
FS FIRE STAIRS
GC GARBAGE CHUTE
HW HIGHLIGHT WINDOW
MV MECHANICAL RISER TO FUTURE DETAIL
MB MAILBOX TO FUTURE DETAIL
R 240L RECYCLING BIN
SK SKYLIGHT
ST STORAGE
HWU HOT WATER UNITS

MATERIALS LEGEND:

AFG ALUMINIUM FRAMED GLAZING
LV ALUMINIUM ELLIPTICAL FIXED LOUVERS
AW AWNING (TO FUTURE DETAIL)
CONC CONCRETE
FB FACE BRICK
GB FRAMELESS TOUCHENED GLASS BALUSTRADE (TO BCA/AUS
STANDARDS)

GB FRAMELESS TOUCHENED GLASS BALUSTRADE STANDARDS)

MB METAL BALUSTRADE

MC METAL CLADDING

FCE METAL FENCING (TO FUTURE SELECTION)

PC COMPOSITE PANEL CLADDING

PSX PRIVACY SCREEN (TO FUTURE SELECTION)

PTX PAINT FINISH TYPEX

RD ROLLER DOOR

RP RIVER PEBBLES


RW RENDERED FINISH/SELECTED PAINT FINISH

TC TIMBER CLADDING

VB EXTERNAL VENETIAN BLINDS

EXTERNAL VENETIAN BLINDS

Issue	Date	Description
А	28/11/2023	DEVELOPMENT APPPLICATION
В	7/05/2024	AMENDED DEVELOPMENT APPLICATION
С	29/05/2024	AMENDED DEVELOPMENT APPLICATION
D	12/06/2024	AMENDED DEVELOPMENT APPLICATION
F	20/01/2025	S4.55 ISSUE

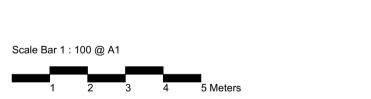

JAK Newport Pty Ltd




P - 02 9698 8140 E - info@pbdarchitects.com.au W - pbdarchitects.com.au Level 2, 52 Albion Street, Surry Hills NSW 2010 ABN 36 147 035 550 Nominated Architect: Paul Buljevic NSW 7768

pbd architects

RESIDENTIAL FLAT BUILDING - KENZA 54 - 58 BEACONSFIELD STREET NEWPORT NSW

Solar Access Diagram 2

PROJECT NO: 2311	DA601	F
SCALE: NTS	DRAWING NO:	ISSUE:
DRAWING BY:	CHECKED BY: KL	DATE: 21/01/2025

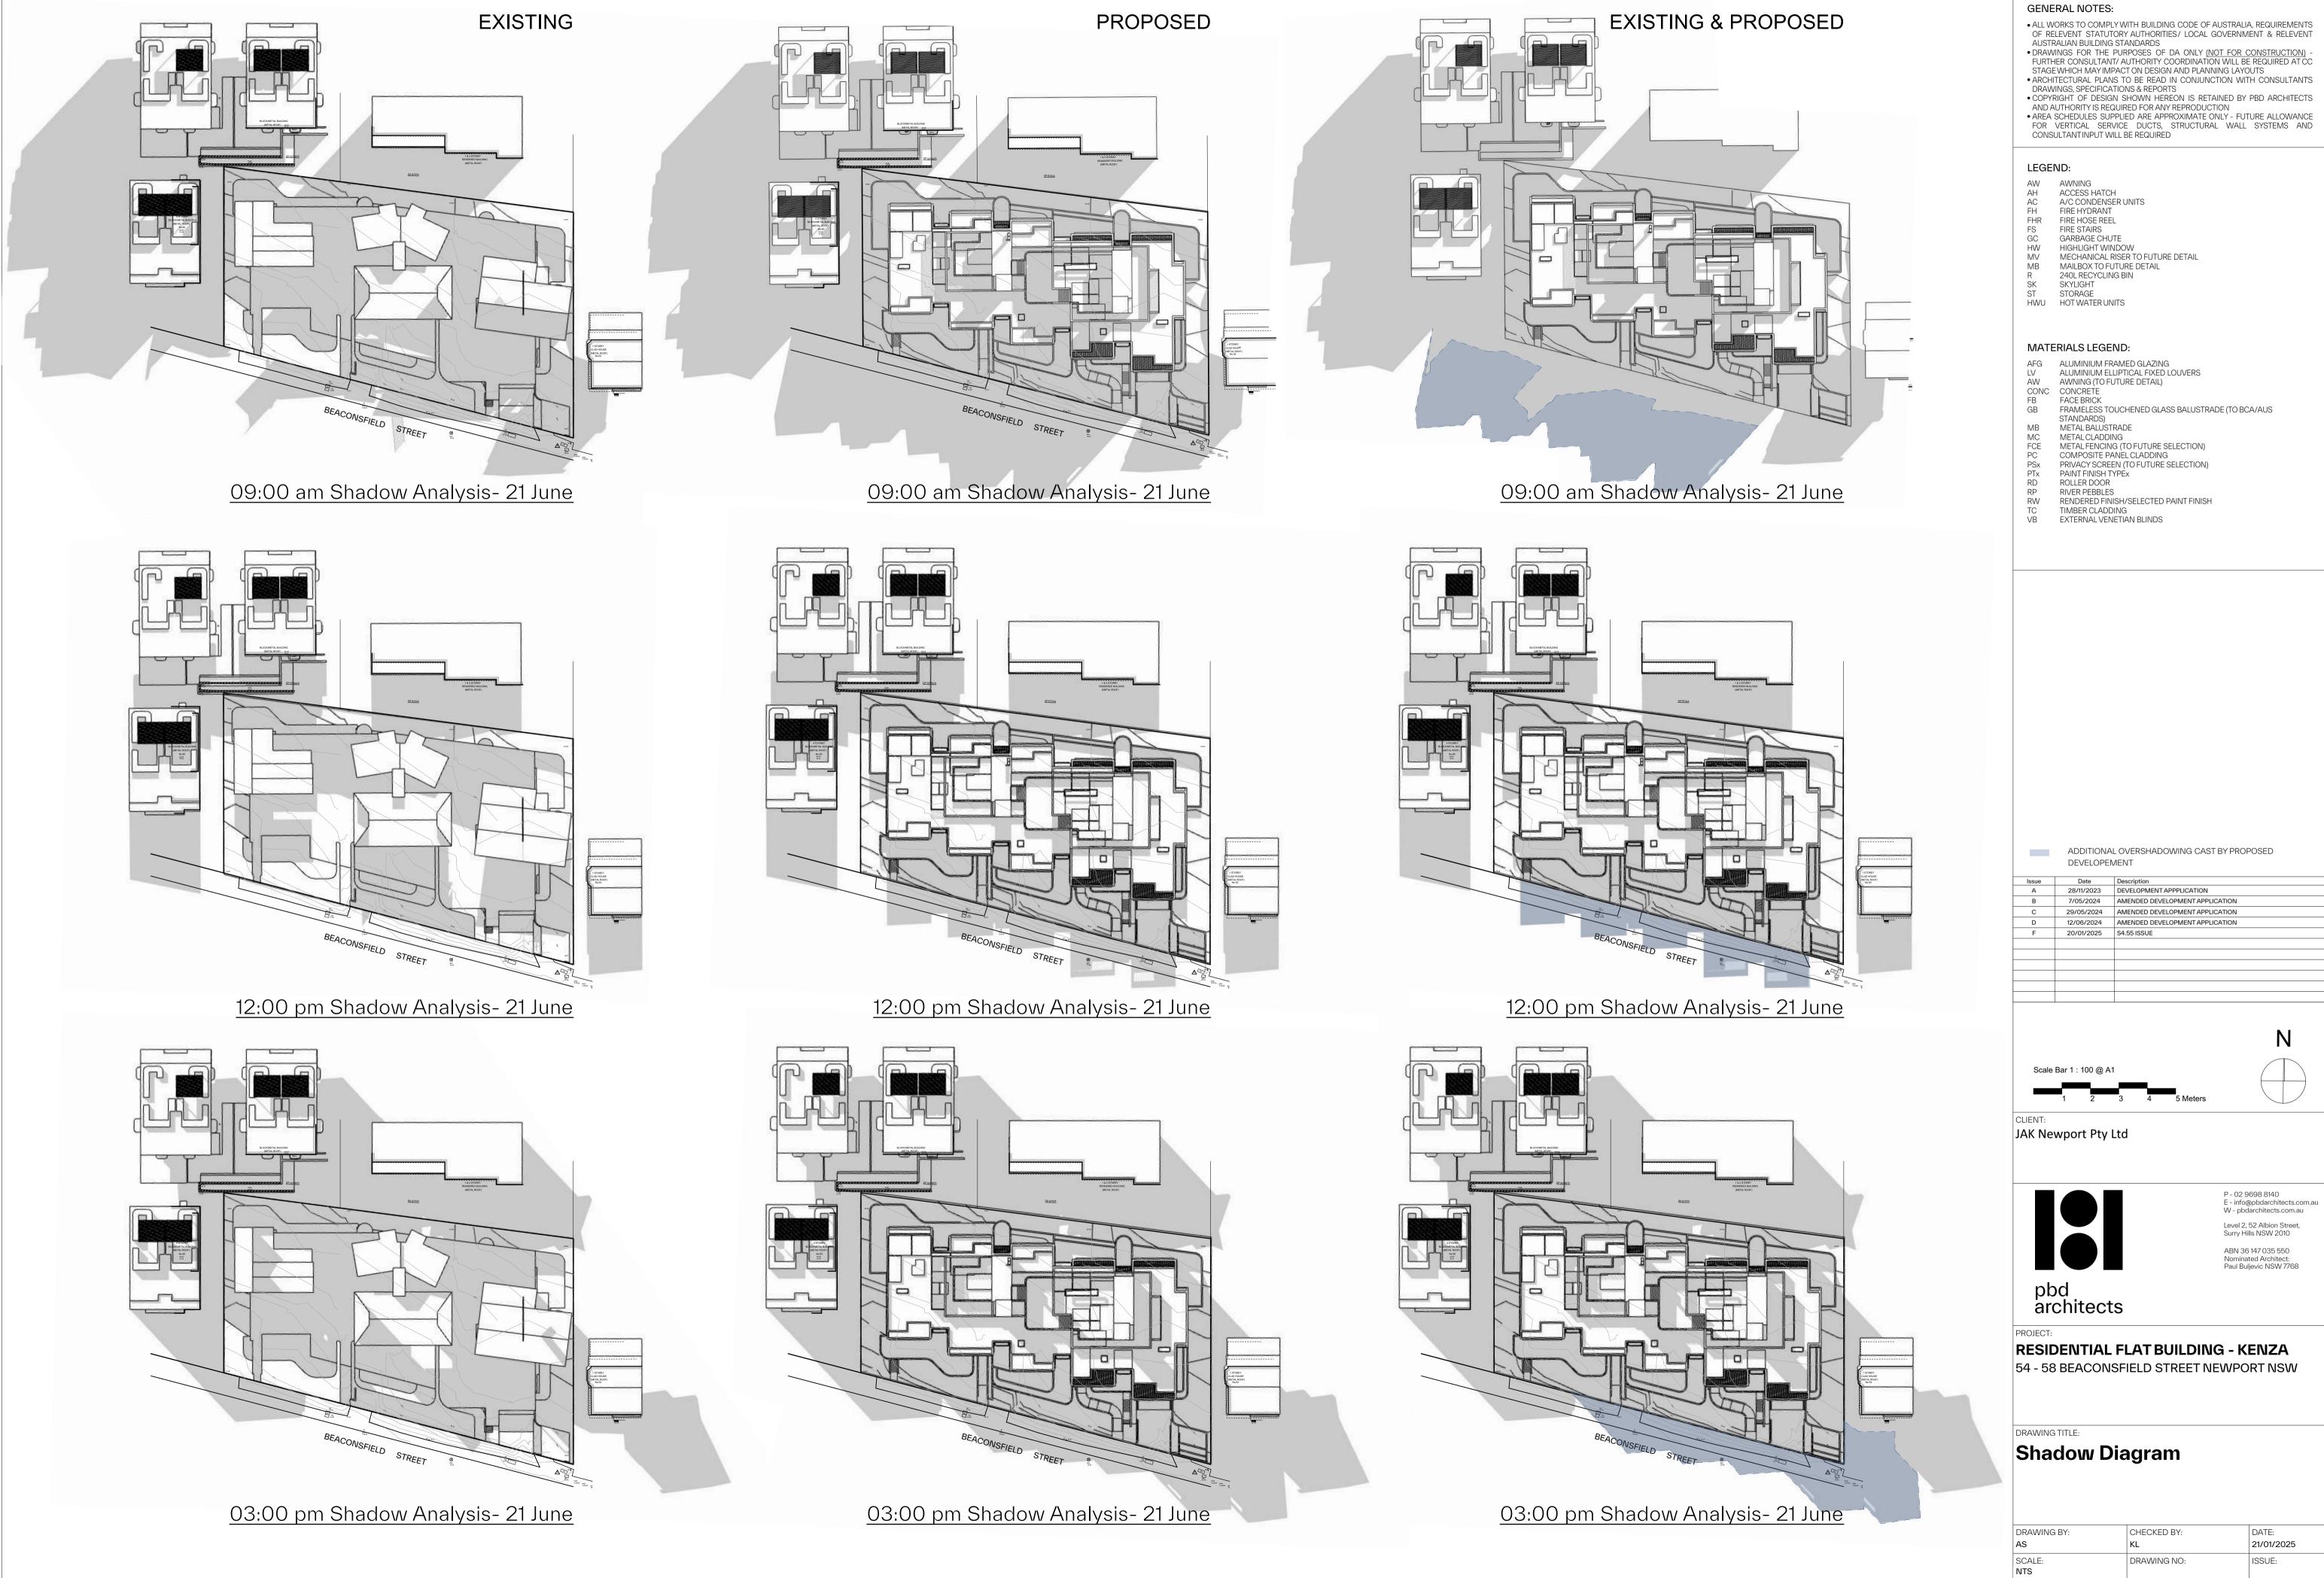

FRAMELESS TOUCHENED GLASS BALUSTRADE (TO BCA/AUS

ADDITIONAL OVERSHADOWING CAST BY PROPOSED



P - 02 9698 8140 E - info@pbdarchitects.com.au W - pbdarchitects.com.au Level 2, 52 Albion Street, Surry Hills NSW 2010 ABN 36147035550 Nominated Architect: Paul Buljevic NSW 7768

54 - 58 BEACONSFIELD STREET NEWPORT NSW

SCALE: NTS	DA610	ISSUE:
	DRAWING NO:	21/01/2025 ISSUE:
DRAWING BY:	CHECKED BY:	DATE: