

Lot 1 in DP550275 title notations:
1 RESERVATIONS AND CONDITIONS IN
THE CROWN GRANT(S)
2 BK 2899 NO 914 COVENANT
AFFECTING PART

<u>JUTILITY ASSETS LEGEND</u>		
ELECTRICITY	EU	EU
COMMS TELEPHONE LINE	T	T
COMMS OPTICAL FIBRE	OU	OU
COMMS HOUSE CONNECTION	TH	TH
WATER MAIN		
RECYCLED WATER MAIN	WR	WR
WATER HOUSE CONNECTION	WH	WH
LOW PRESSURE GAS		
GAS HOUSE CONNECTION	GH	GH
SEWER MAIN	S	S
STORMWATER PIPE	SW	SW

UTILITY MAPPING NOTES:
Subsurface utility investigation was undertaken by Atrea Pty Ltd, the plan is to be read in conjunction with the subsurface utility investigation report.
Positions are based on Astrea Class A & B point surface indicator(s) located during field survey. Confirmation of the exact position should be made to the relevant authorities prior to any excavation work. Other services may still exist. This plan shows a representation of the dwg model. this model should be viewed in a cadd environment to interpret this information.
This utility plan is valid for 28 days starting from the date of the issue, as underground utility works are often updated.
Electricity cables are not necessarily enclosed in conduits and are not necessarily covered with markers, tape or other indicators of their presence. All services have been electronically traced in the field and are shown here for diagrammatic purposes only. Depths shown are approximate only and should be verified prior to works.
his plan includes information describing the location of subterranean features, which were purported to exist at the time of the survey. This information was compiled from a combination of field techniques and available data from cooperating utility authorities. Whilst all care has been taken in the preparation of this plan of survey, we cannot guarantee that the plan is without flaw of any kind.

CLASS A: Information is the highest possible level of accuracy and is obtained by exposing the underground utility using a on-destructive excavation (pot holing) technique. The vertical information for this locating method is to the top or shallowest part of located service. The 3D location is recorded by survey as an X, Y, Z coordinate.

CLASS B: Information is collected by designating the horizontal and vertical locations of underground utilities by using electromagnetic pipe and cable locators, sondes or flexi-trace, ground penetrating radar and acoustic pulse equipment. This is the most common form of utility locating and although an X, Y and Z axis can be established, it is not always entirely accurate due to differing electromagnetic fields, soil conditions and multiple banks of cables affecting the locating signal.

CLASS C: Information is collected by correlating the survey of visible utility surface features such as marker plates or water hydrants and acquired Dial-Before-You-Dig plans to "draw" a string which shows the approximate position of services. This method does not usually show multiple banks of cables and does not always show three dimensional information. Electronically traced locate marks with poor scratchy signals are represented as QL-C.

CLASS D: Information is the most basic level of utility locations using only information based on existing Dial-Before-You-Dig plans and by measuring boundary offsets. This method of utility locations should always be treated as an indication of the presence of a service only and should not be used for design. GPR scans are also represented as Class D because the GPR image cannot be confirmed to its origin point. Depths on GPR scan results are estimated.

GENERAL SURVEY LEGEND:

DP - DRAINAGE PIT
PDJM - DRAINAGE JUNCTION MANHOLE
PSMH - SEWER MANHOLE
PWHY - HYDRANT
PWSV - STOP VALVE
PGUL - GULLY PIT
PGPM - GAS MARKER
PGTP - GAS TEST POINT
PPPL - POWER POLE
PTSP - TELSTRA PIT
TK - TOP OF KERB
PC - PRAM RAMP LP - LIP OF GUTTER
FP - FOOTPATH DW - DRIVEWAY

TN/A 0.4 A
33.15


DIAL BEFORE YOU DIG
www.1100.com.au

<small>QUALITY LEVEL SERVICE MATERIAL & SIZE</small>	<p><u>GENERAL SURVEY NOTES :</u></p> <ul style="list-style-type: none"> * THIS TITLEBLOCK IS AN INTEGRAL PART OF THIS DWG AND SHOULD NOT BE REMOVED * COORDINATE SYSTEM MGA 2020 * LEVEL DATUM IS AHD * IT IS THE RESPONSIBILITY OF ANY USER OF THIS DATA TO ENSURE ANY OTHER DATA BEING INTEGRATED IS ON THE SAME COORDINATE SYSTEM * REFER TO THE FACE OF THE PLAN FOR TITLE NOTATIONS 						
SCALE 1:100 							
							
<table border="1" style="width: 100%; border-collapse: collapse;"> <tr> <td style="padding: 5px;">ORIGIN</td> <td style="padding: 5px;">SSM 14684 E 339632.551 N 62</td> </tr> <tr> <td style="padding: 5px;">ORIENTATION</td> <td style="padding: 5px;">SSM 14684 TO PM 3</td> </tr> <tr> <td style="padding: 5px;">AHD ORIGIN</td> <td style="padding: 5px;">SSM 758 RL 27.868</td> </tr> </table>		ORIGIN	SSM 14684 E 339632.551 N 62	ORIENTATION	SSM 14684 TO PM 3	AHD ORIGIN	SSM 758 RL 27.868
ORIGIN	SSM 14684 E 339632.551 N 62						
ORIENTATION	SSM 14684 TO PM 3						
AHD ORIGIN	SSM 758 RL 27.868						

REMOVED R DATA	CLIENT : HARDI AGED CARE PLAN IN RELATION TO : GORDON ST, MANLY VALE SHOWING : TOPOGRAPHICAL UTILITY MAPPING IN ACCORD. AS4588.1-2019
10	
709.649 52	PURPOSE: ENGINEERING D
	SHEET 01 OF

	DIGITAL SURVEY SOLUTIONS UTILITY MAPPING SUITE 6.01, TRINITI II, TRINITI BUSINESS PARK 39 DELHI ROAD, NORTH RYDE 2113 SCOTT DEVERIDGE 0425 285 270 www.astrea.com.au
SURVEY AND SERVICE WITH	
GN	


JOB REFERENCE : A4089		I/D 7453
DWG No.: A4089-TOPO & UTIL		
SURVEYOR: KF, JB	SCOTT DEVERIDGE	
DATE OF SURVEY: SEP 2023	REGISTERED LAND SURVEYOR	
UTILITY LOCATOR: MB	UNDER THE SURVEYING AND SPATIAL INFORMATION ACT, 200	
© ASTREA 2023 - UNAUTHORISED USE IS PROHIBITED		
REV.	10/10/2023	DATE

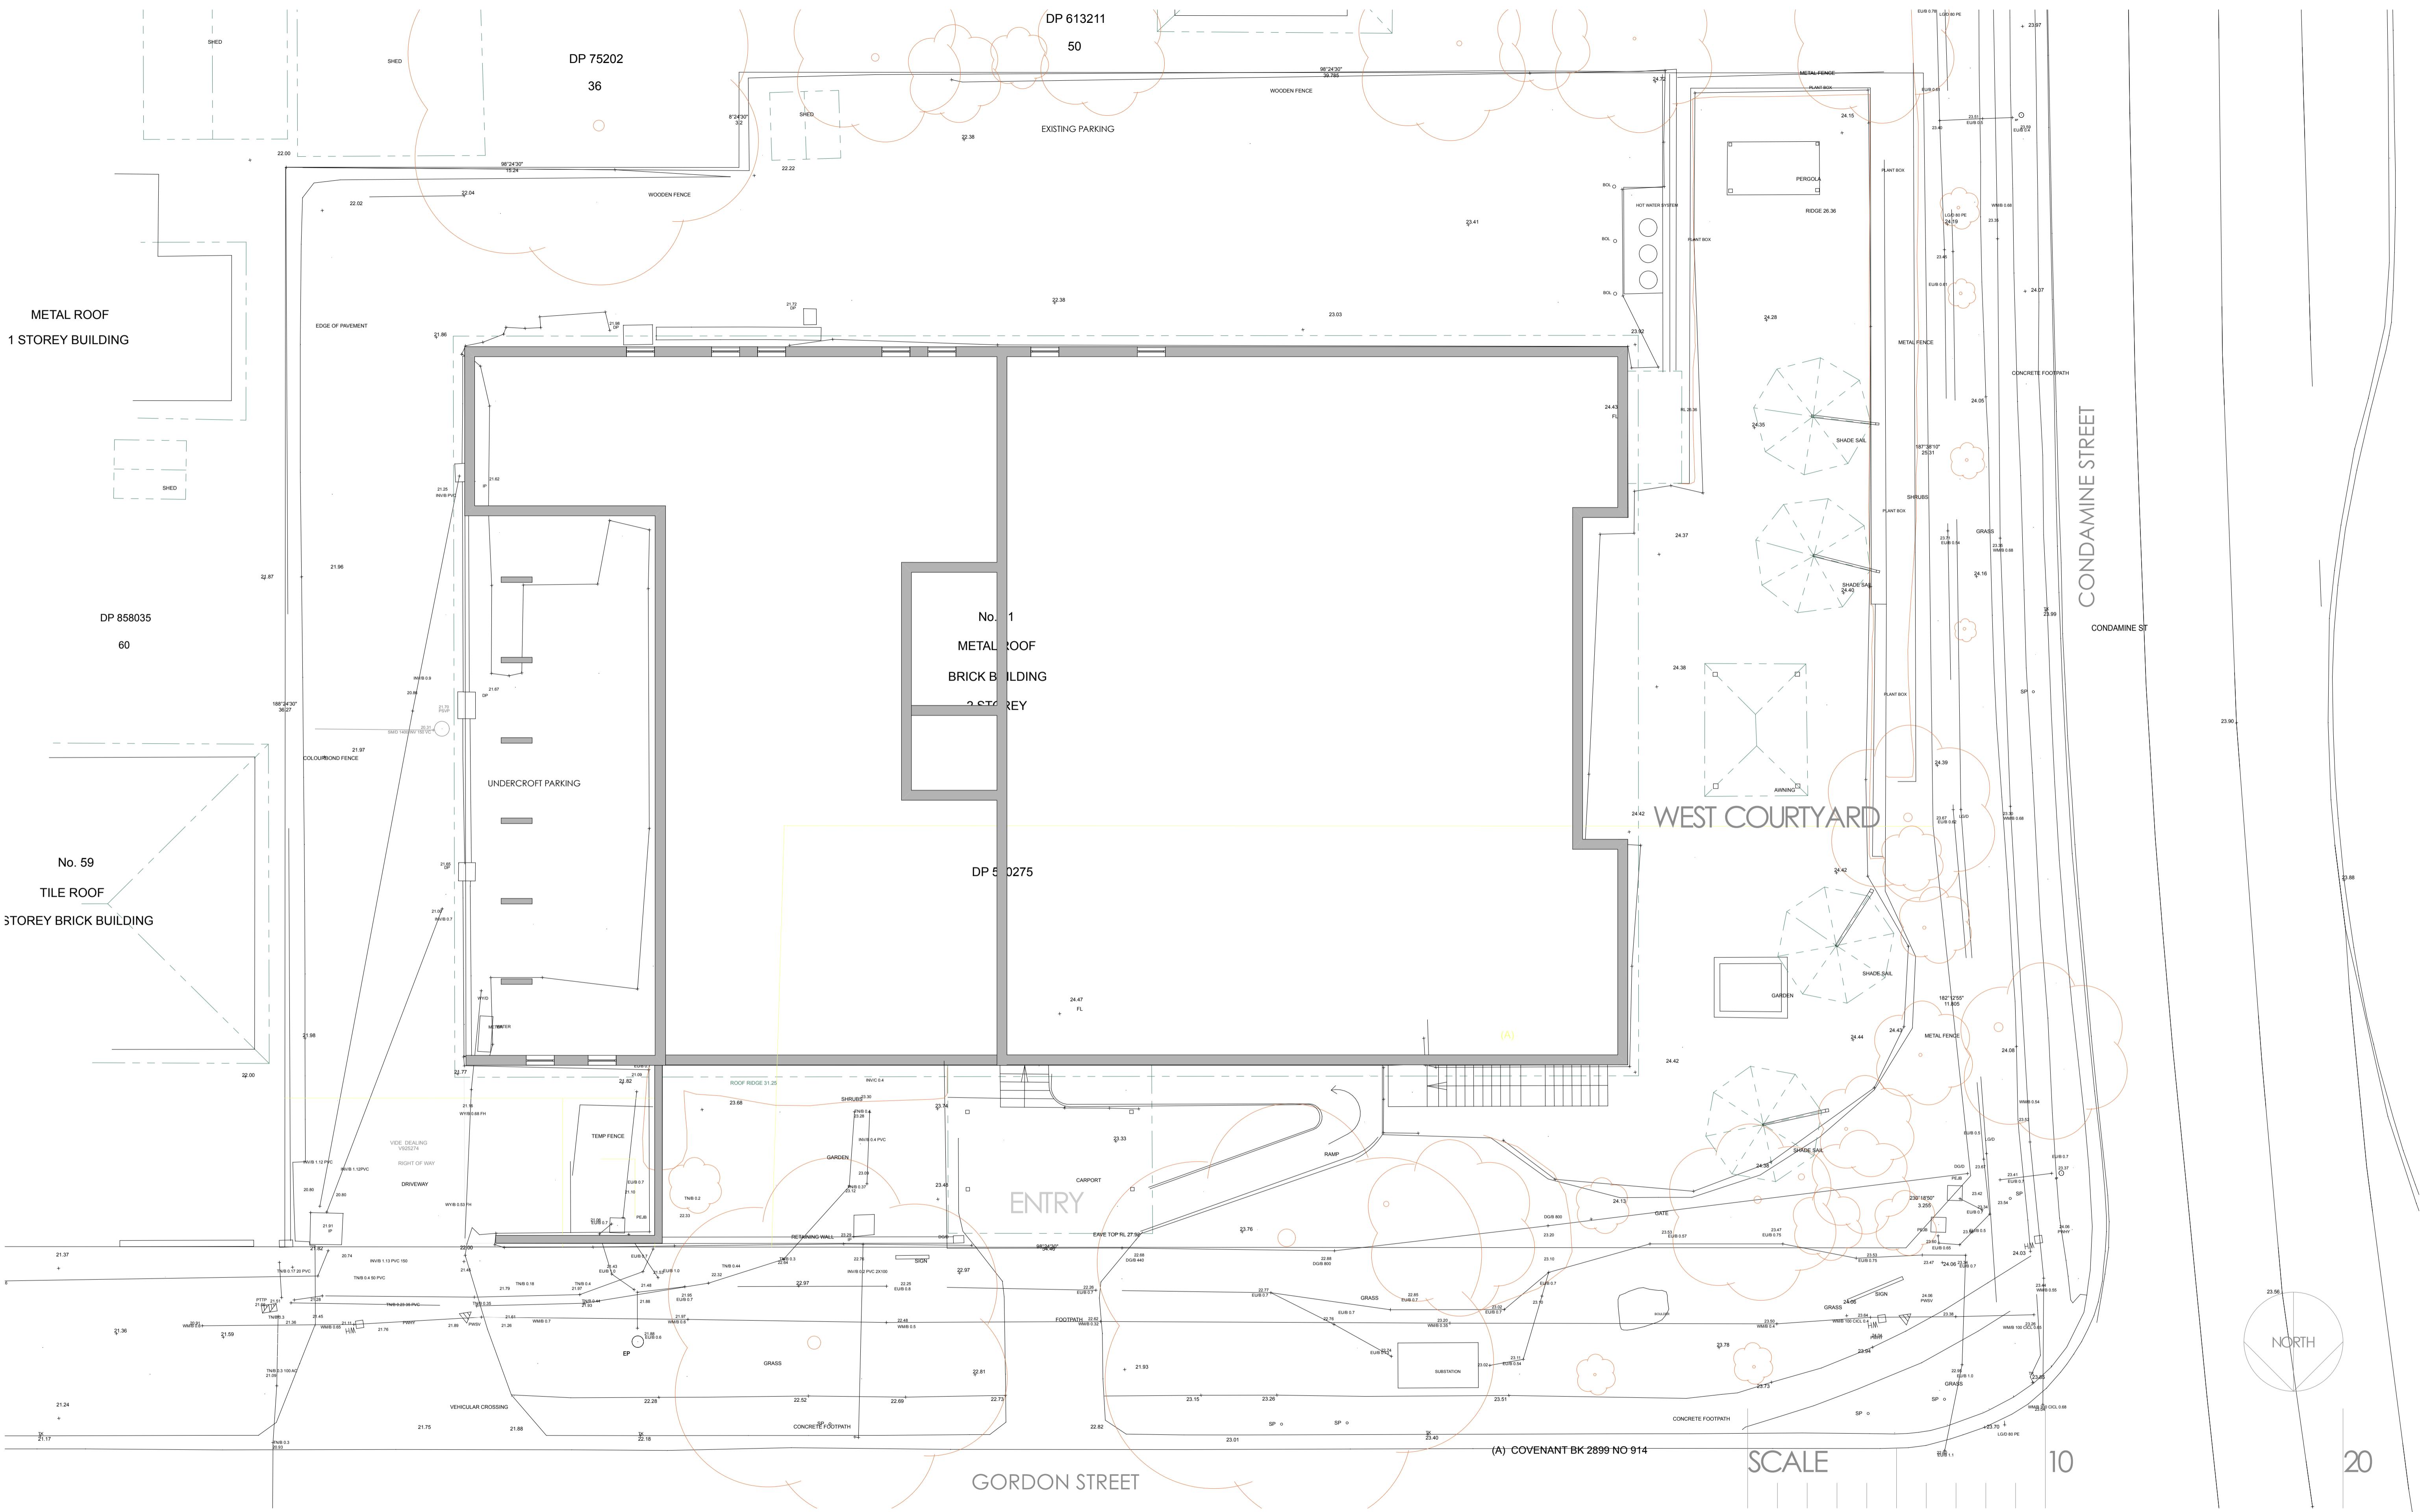





D
C
A
Rev
Issue




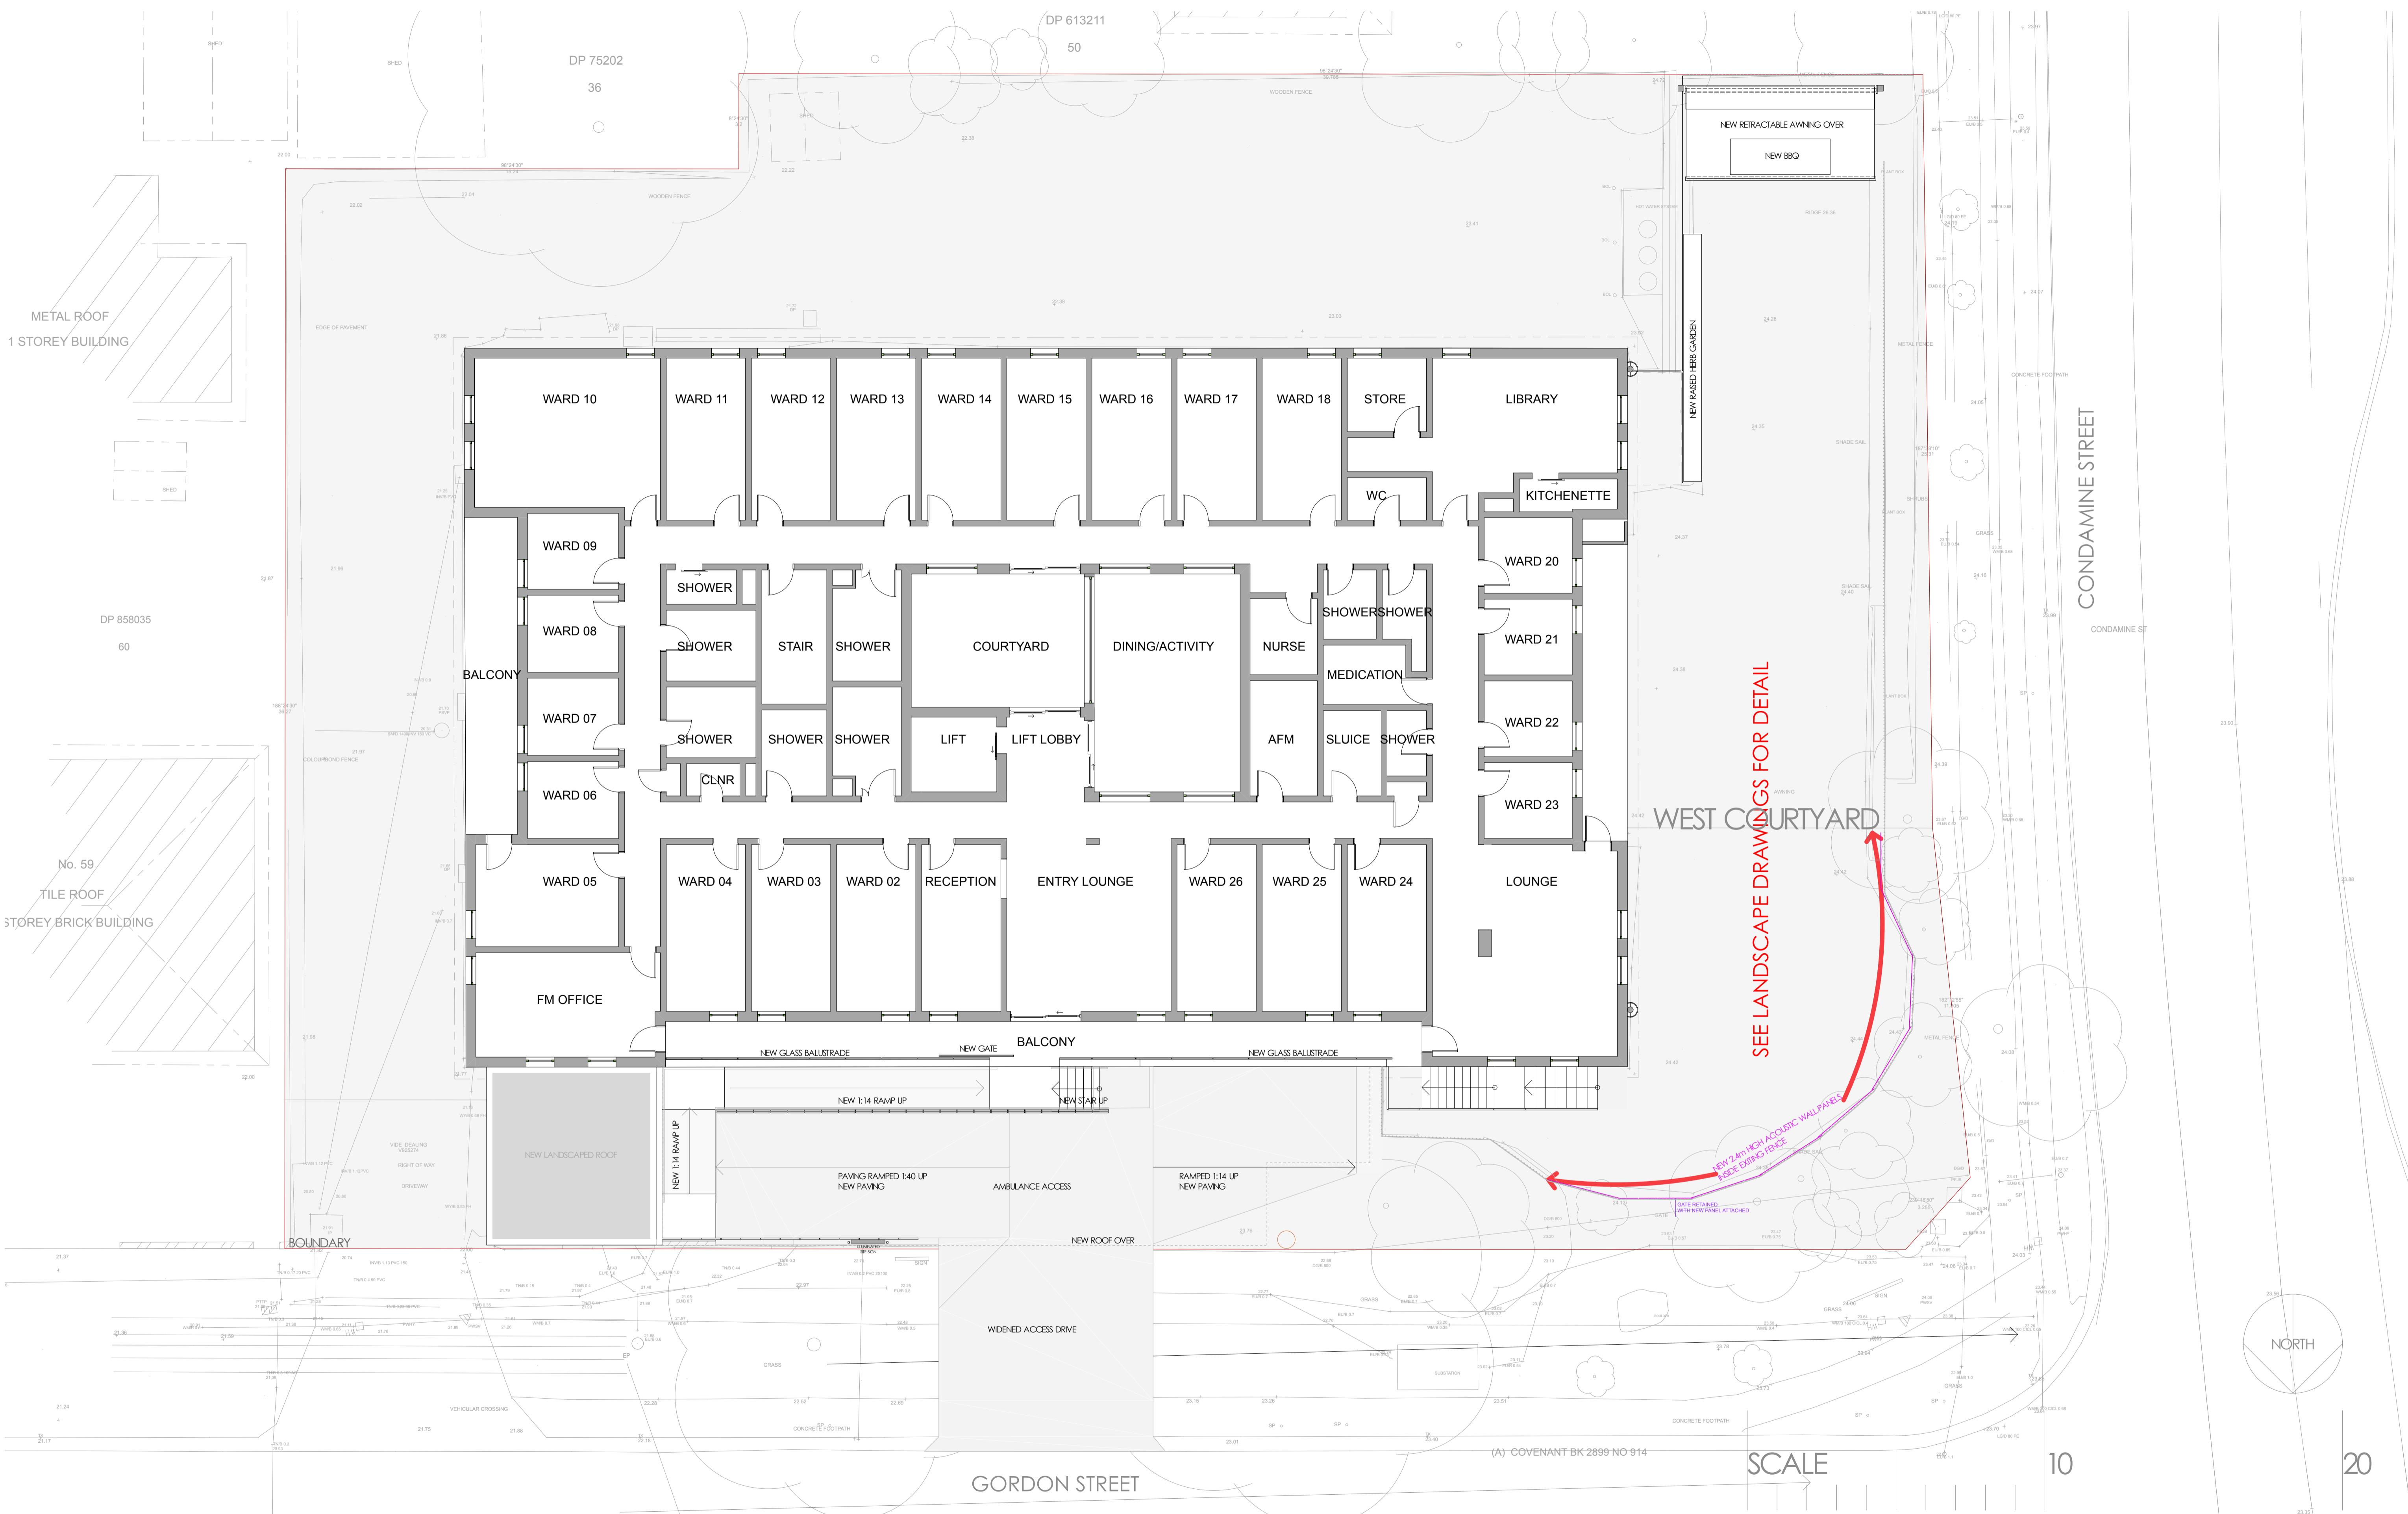

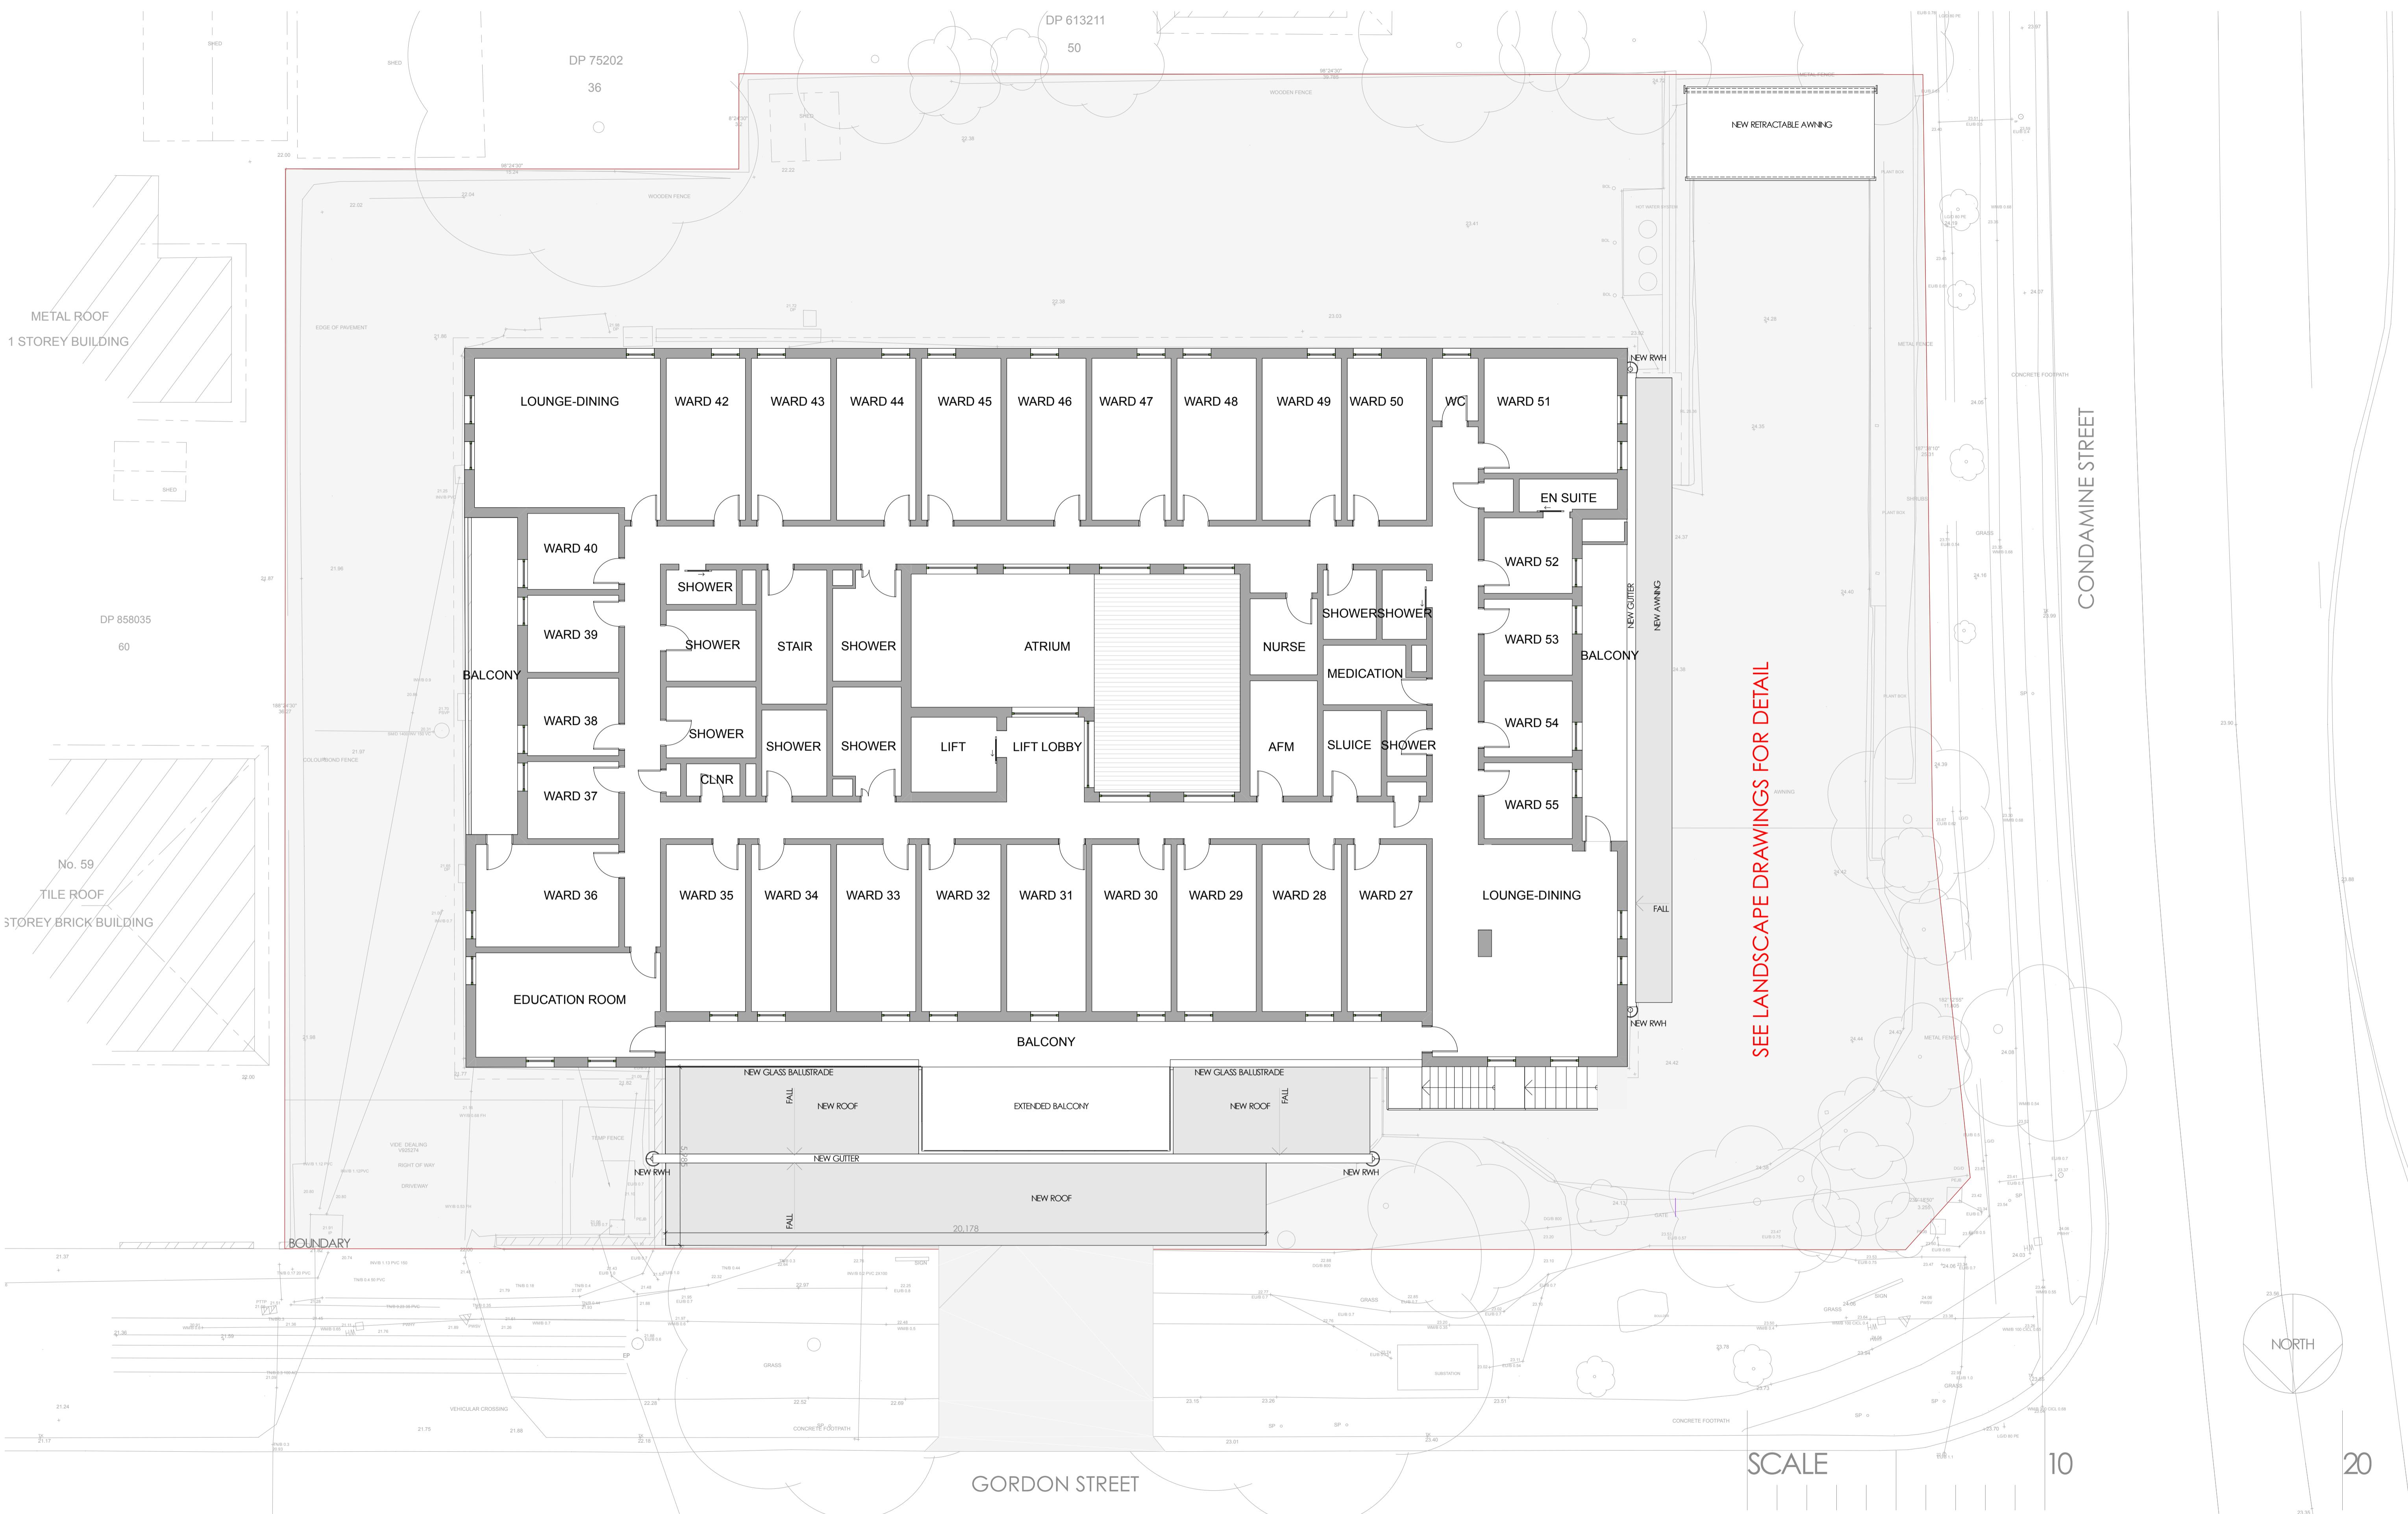

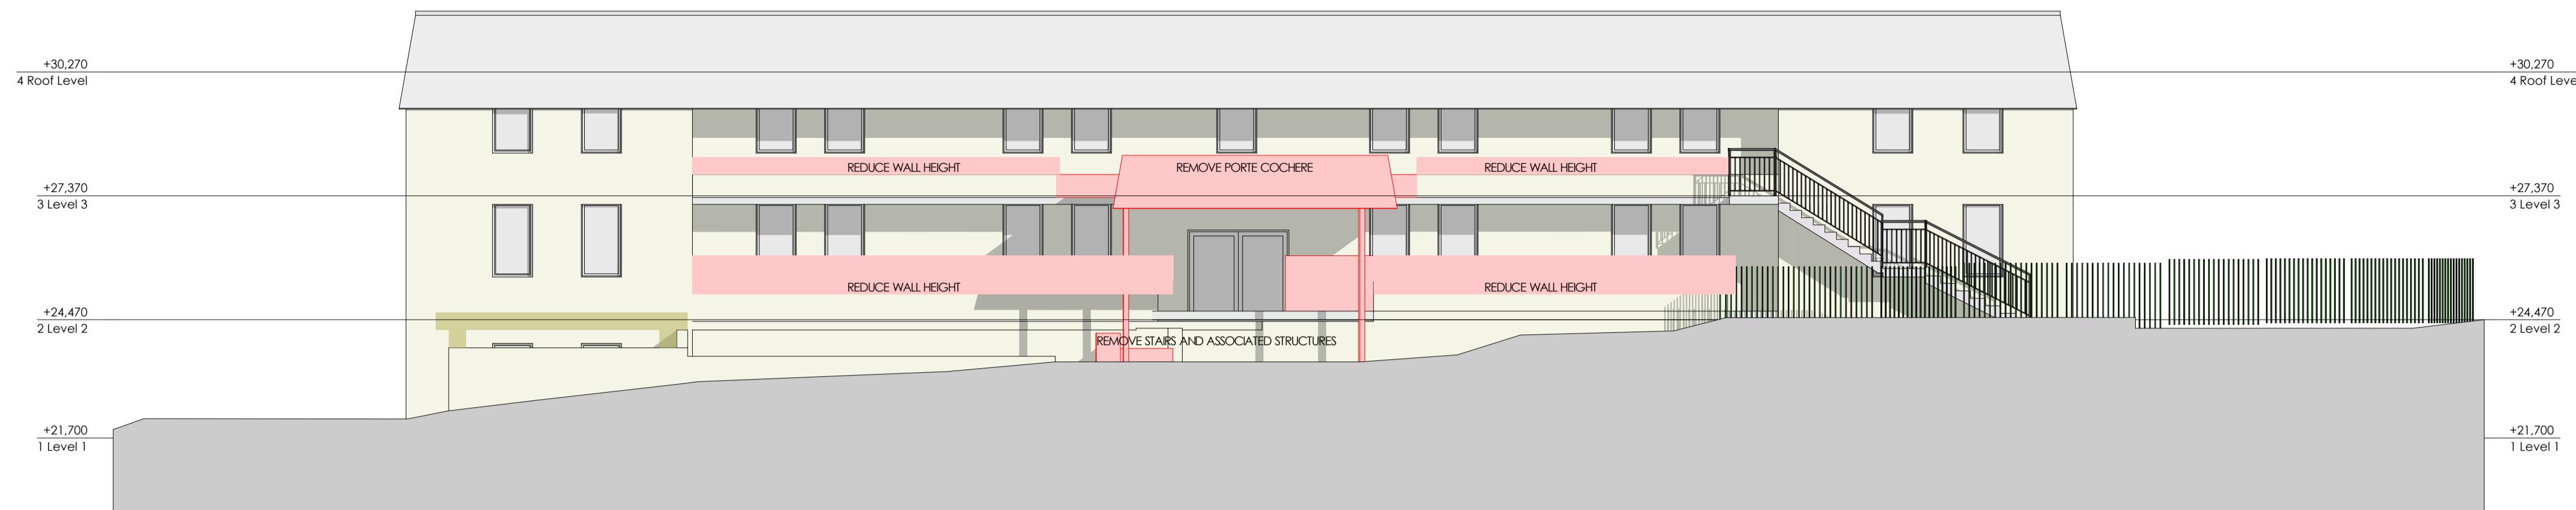


NORTH ELEVATION EXISTING

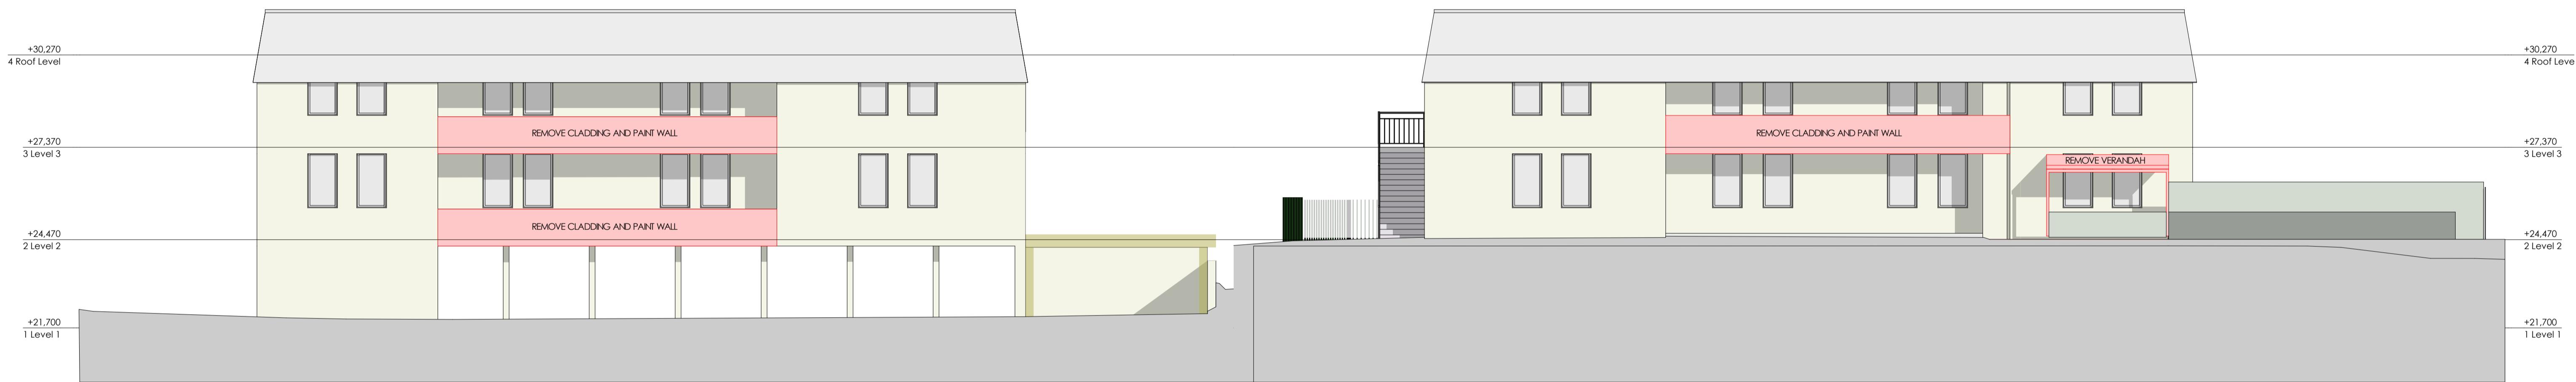


EAST ELEVATION EXISTING

WEST ELEVATION EXISTING

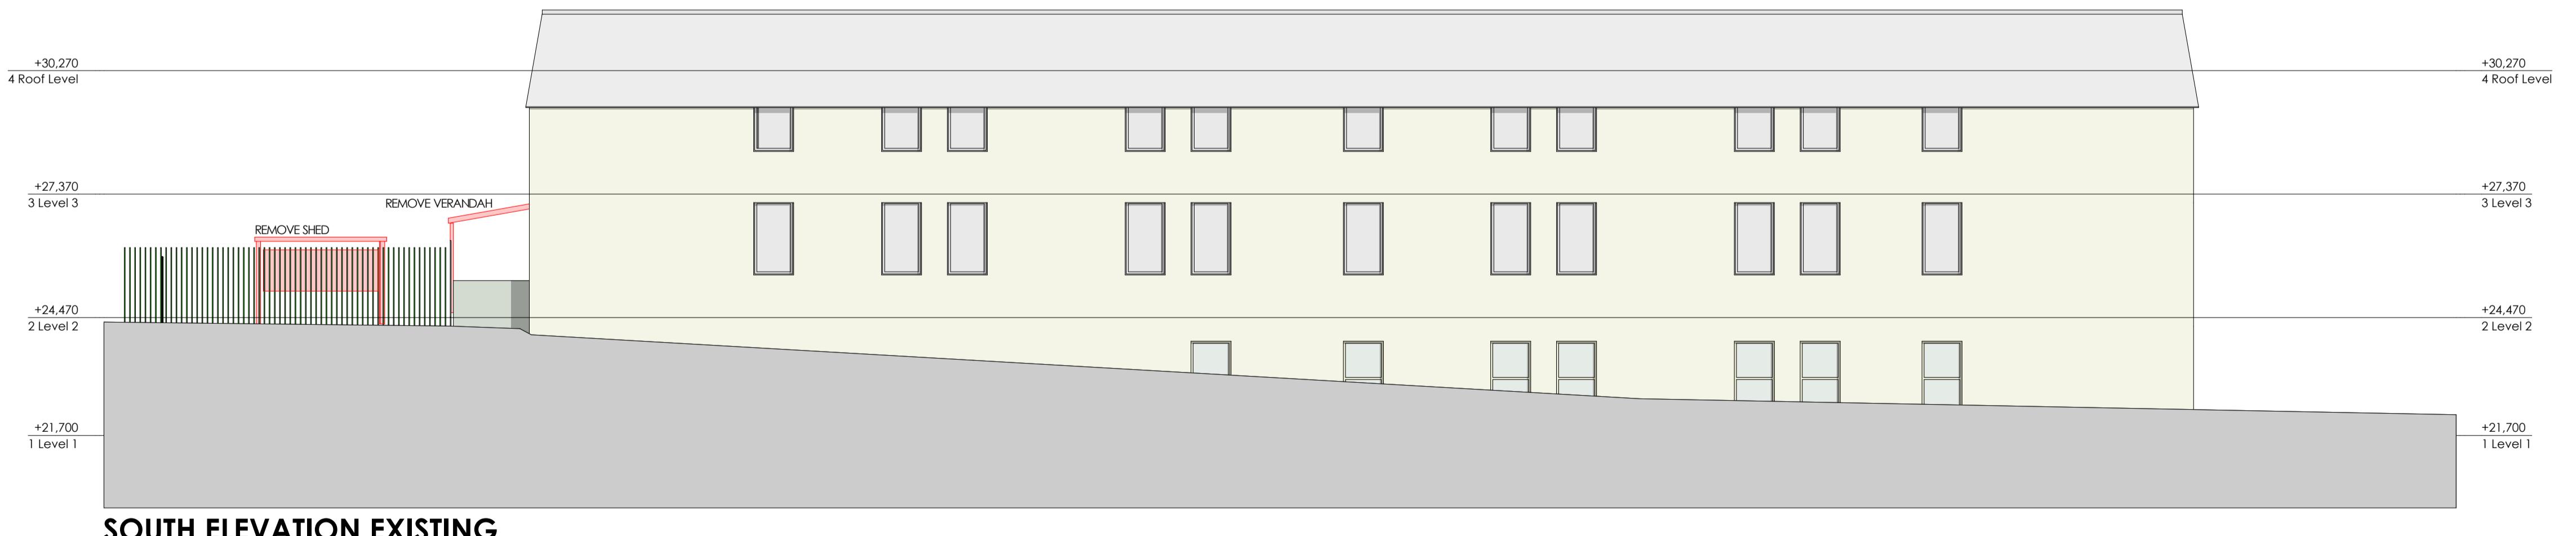

SOUTH ELEVATION EXISTING

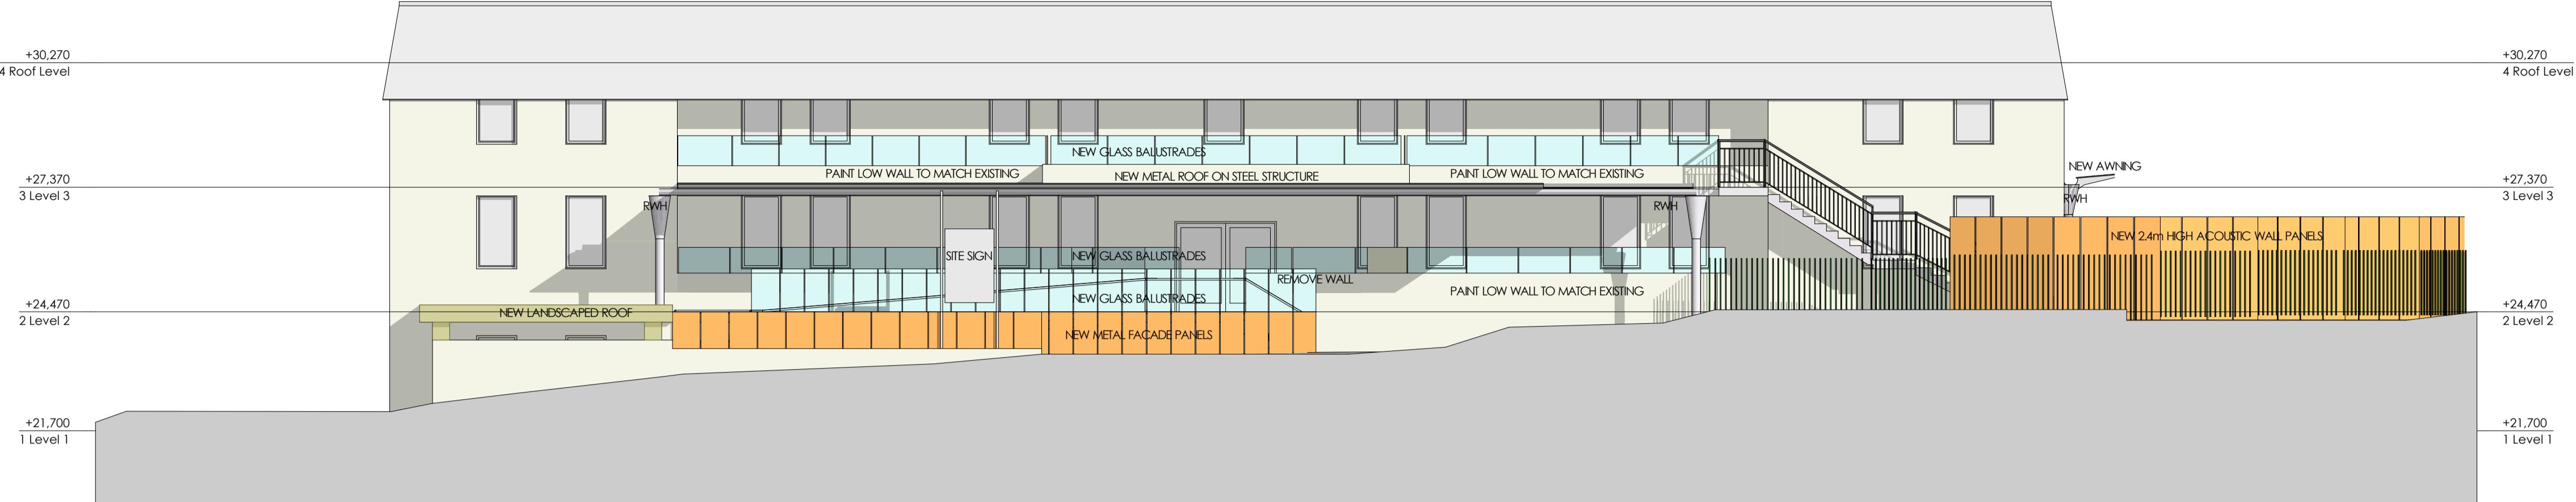


NORTH ELEVATION (GORDON STREET)



EAST ELEVATION

WEST ELEVATION (CONDAMINE STREET)

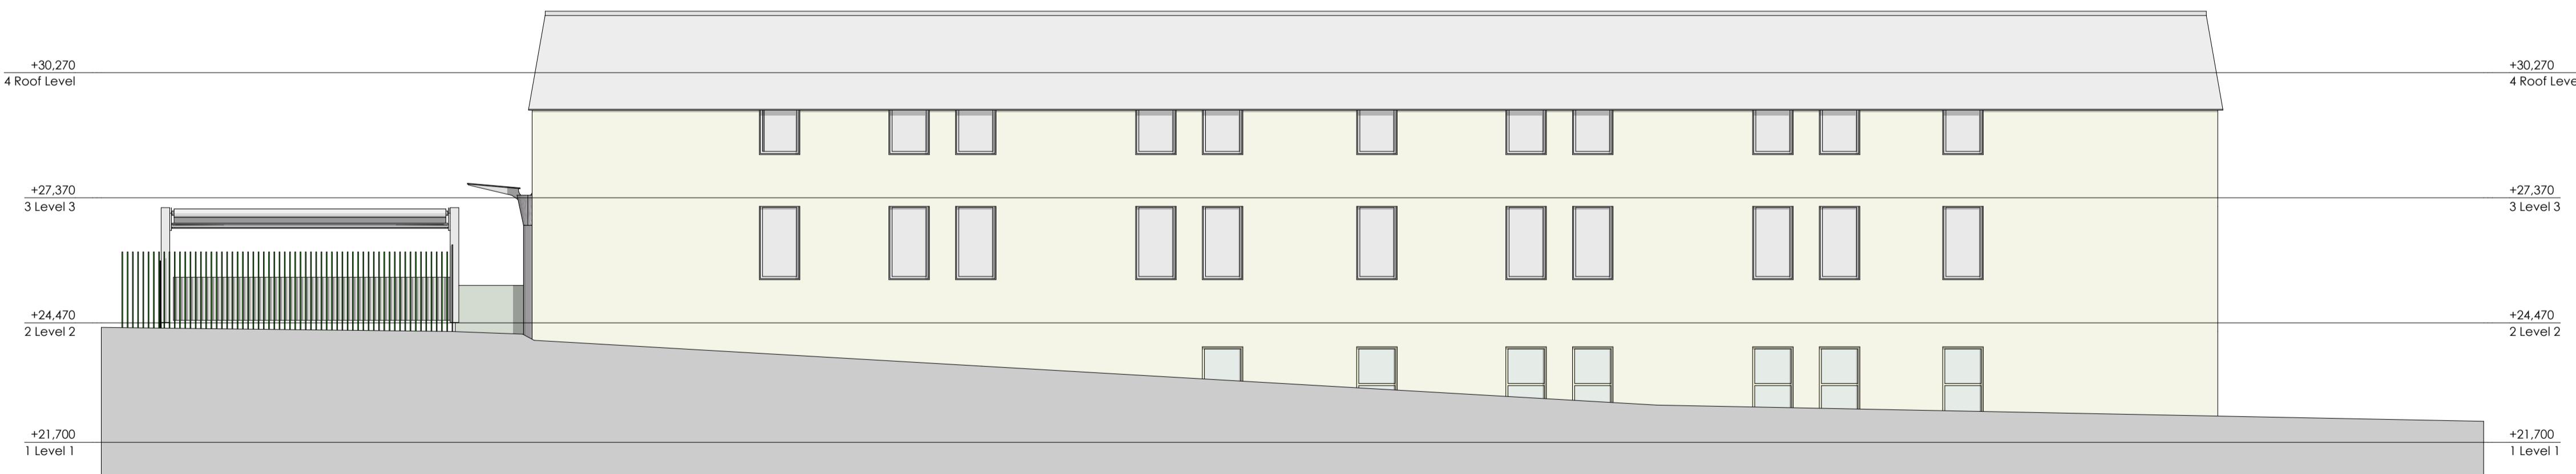


SOUTH ELEVATION



GORDON STREET ENTRY EXISTING



GORDON STREET ENTRY PROPOSED

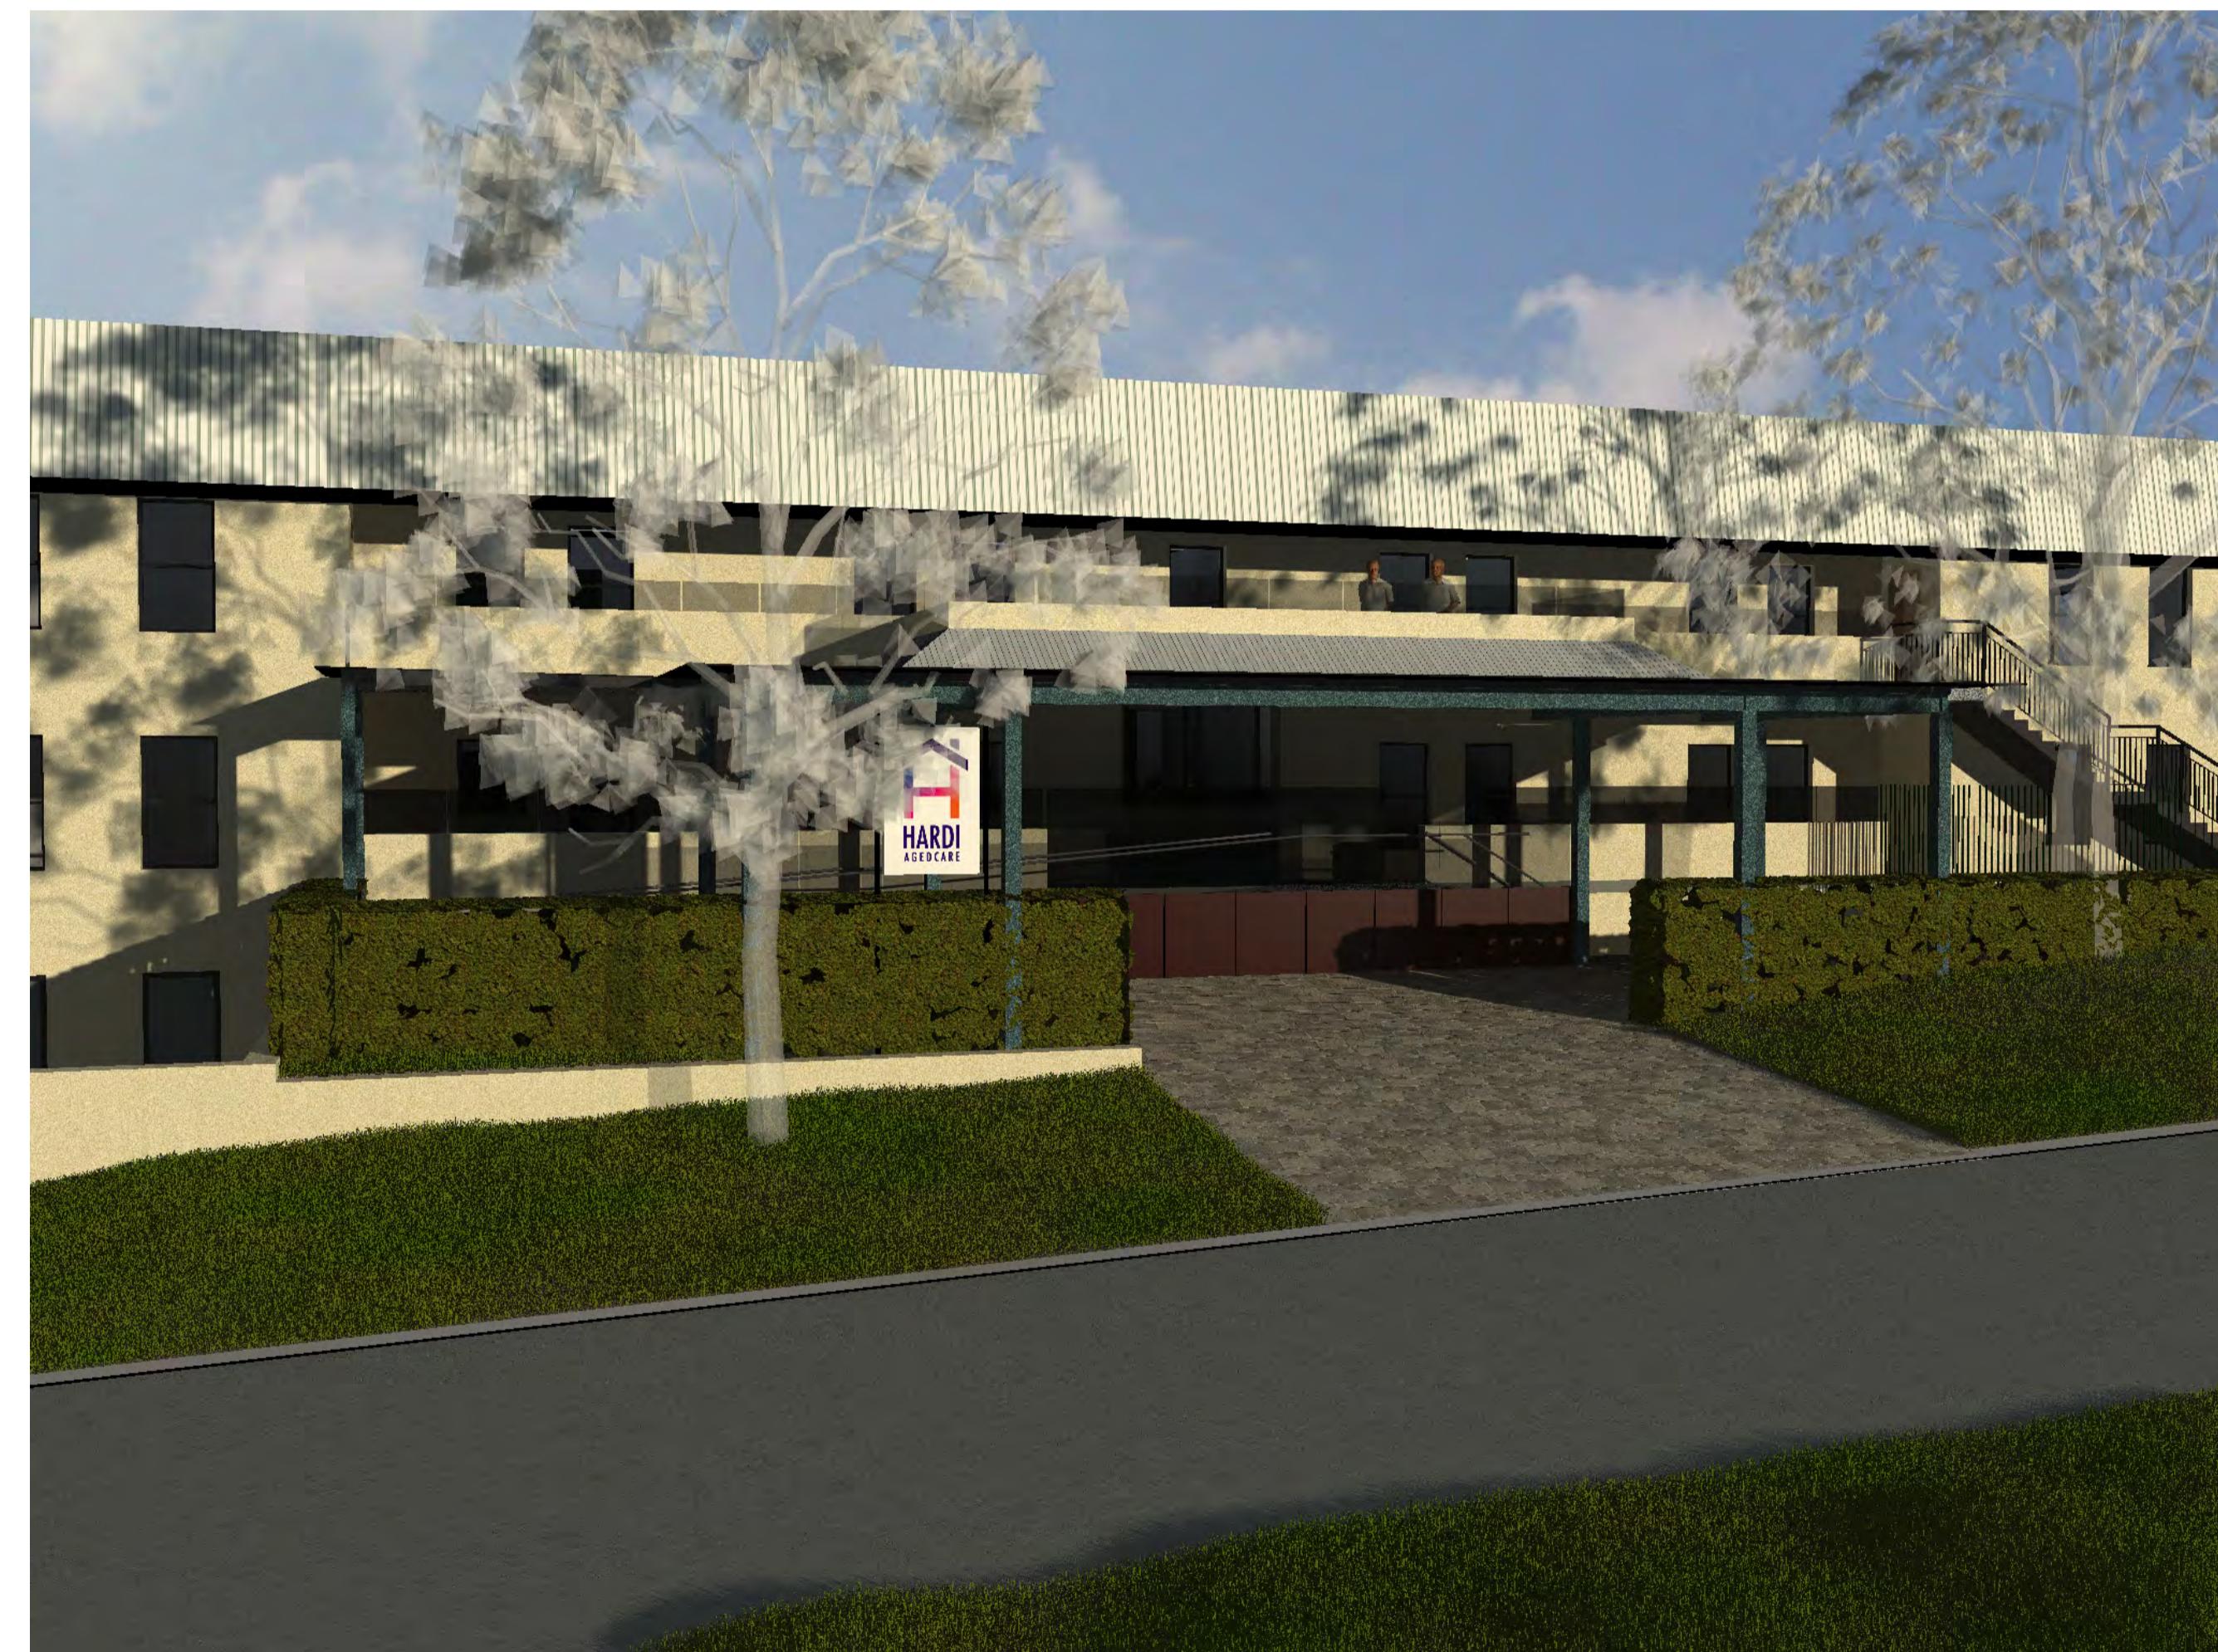





GORDON STREET ENTRY EXISTING



GORDON STREET ENTRY PROPOSED

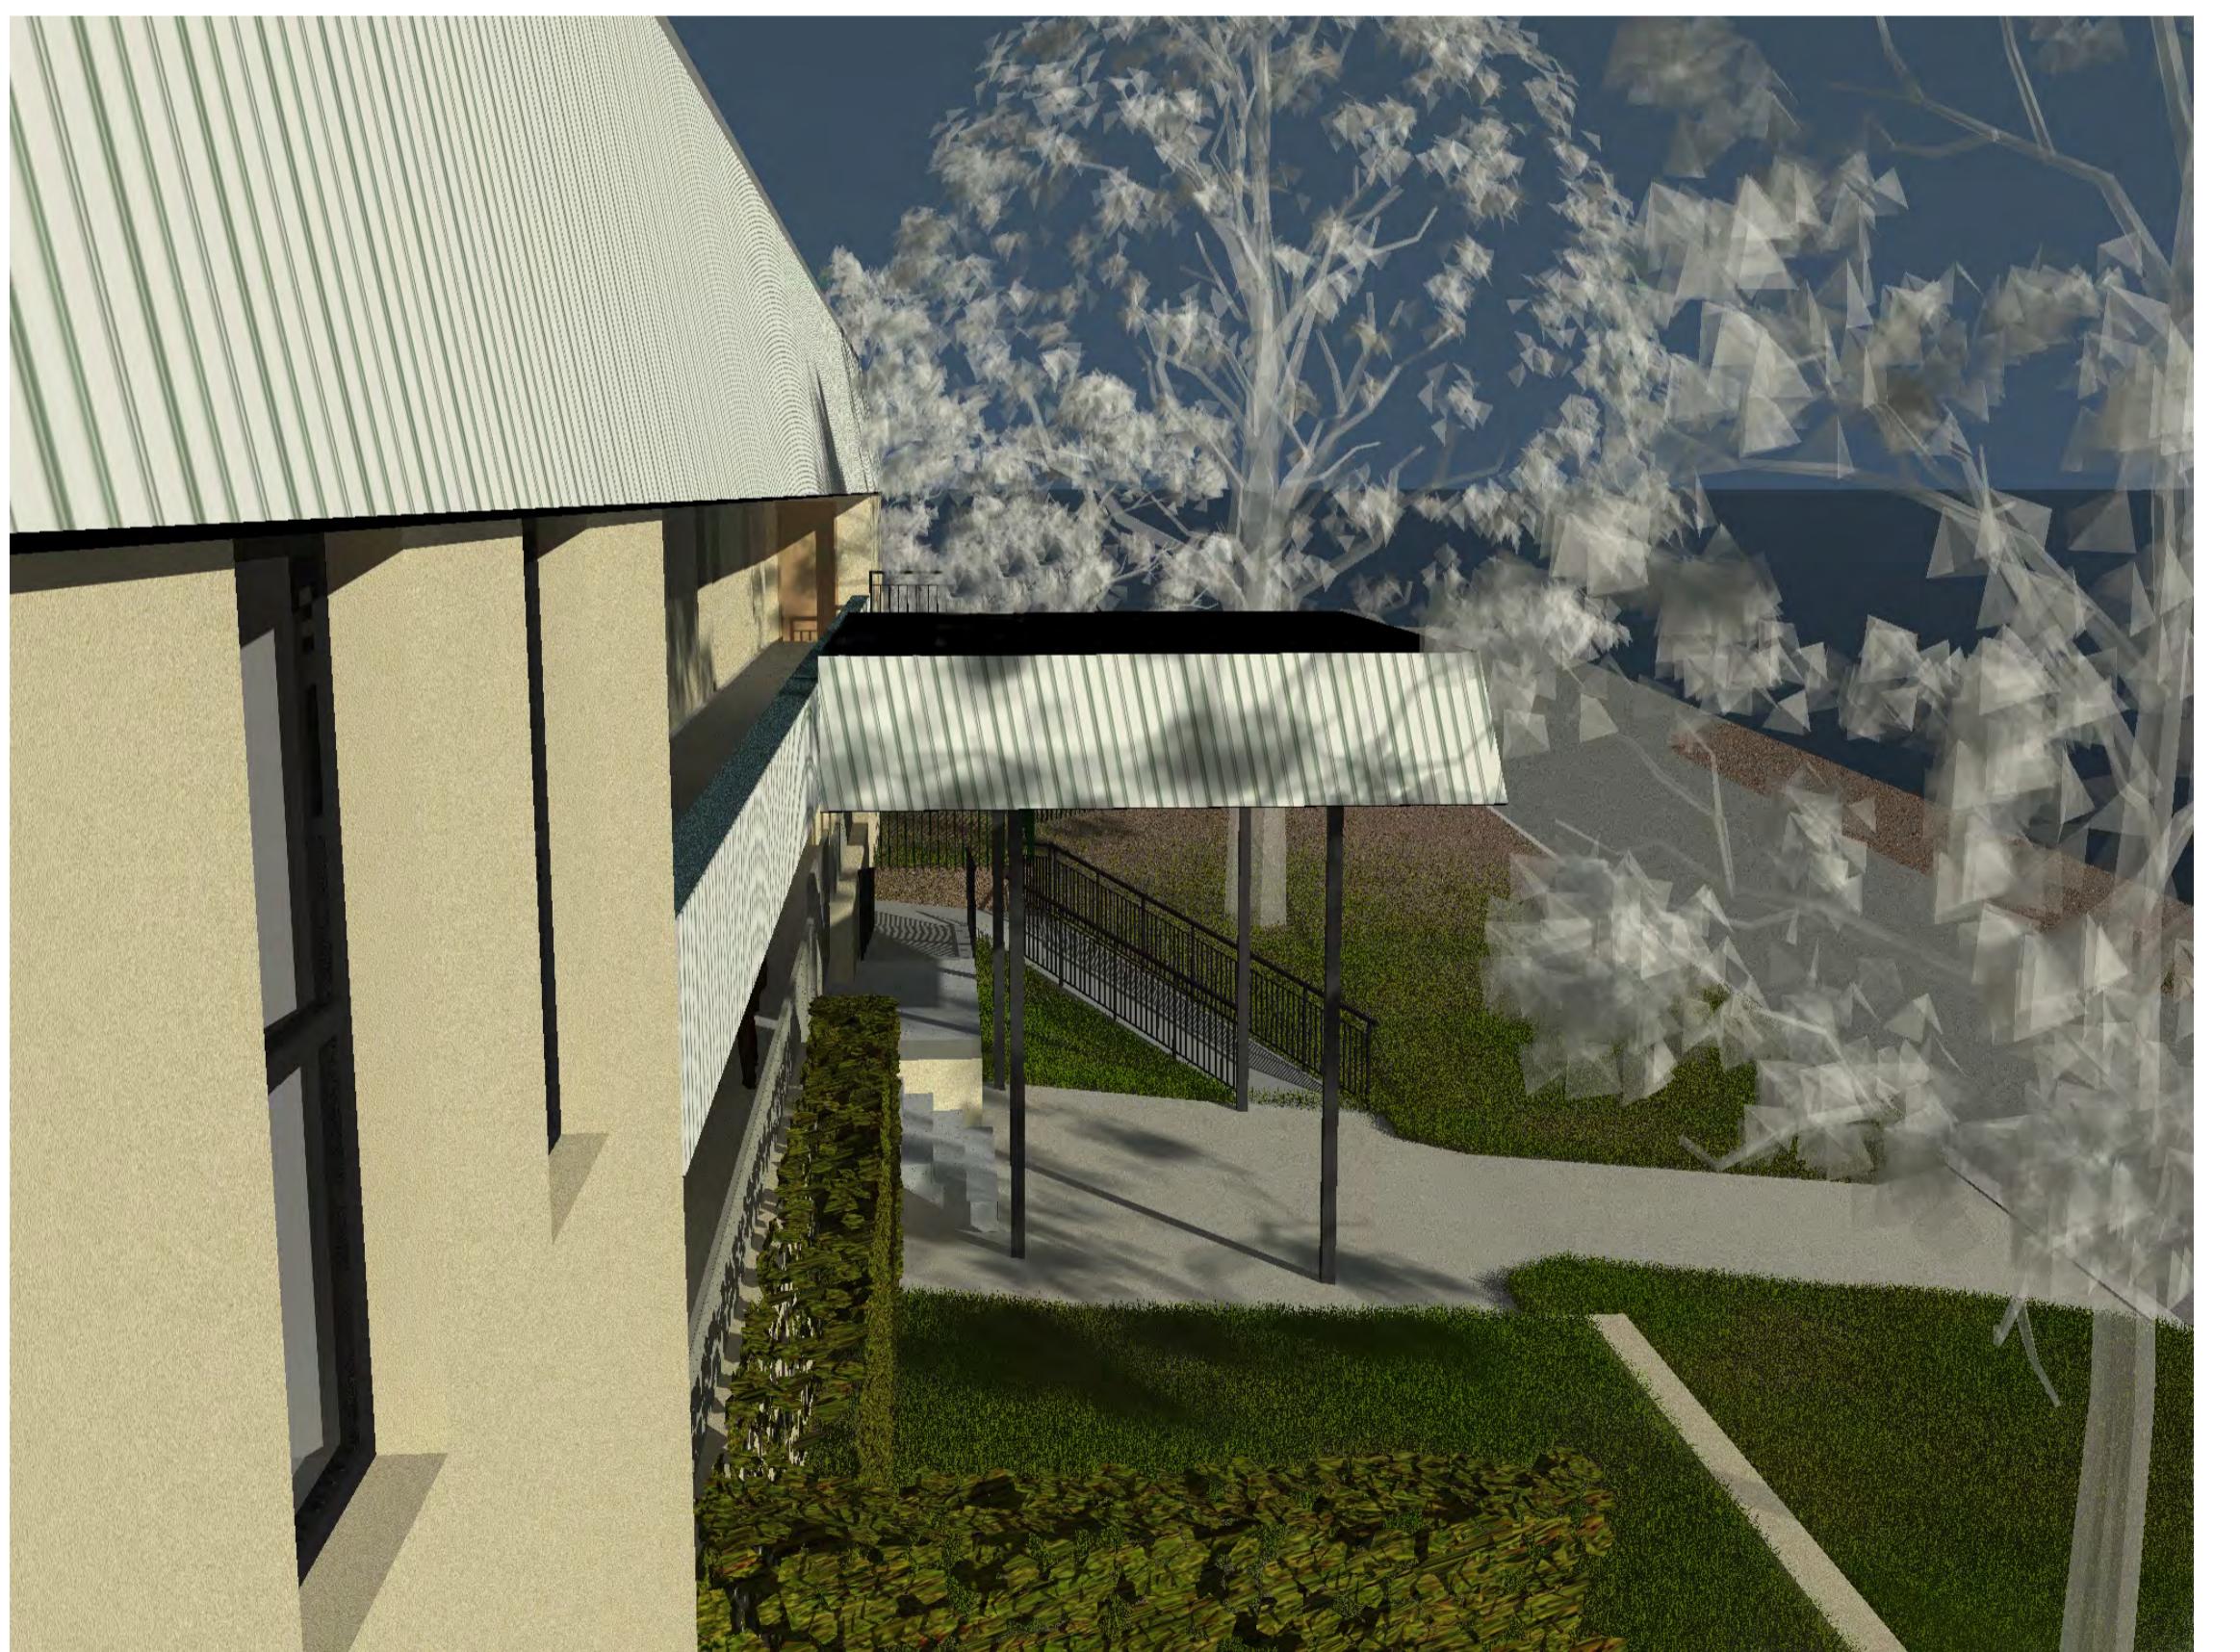

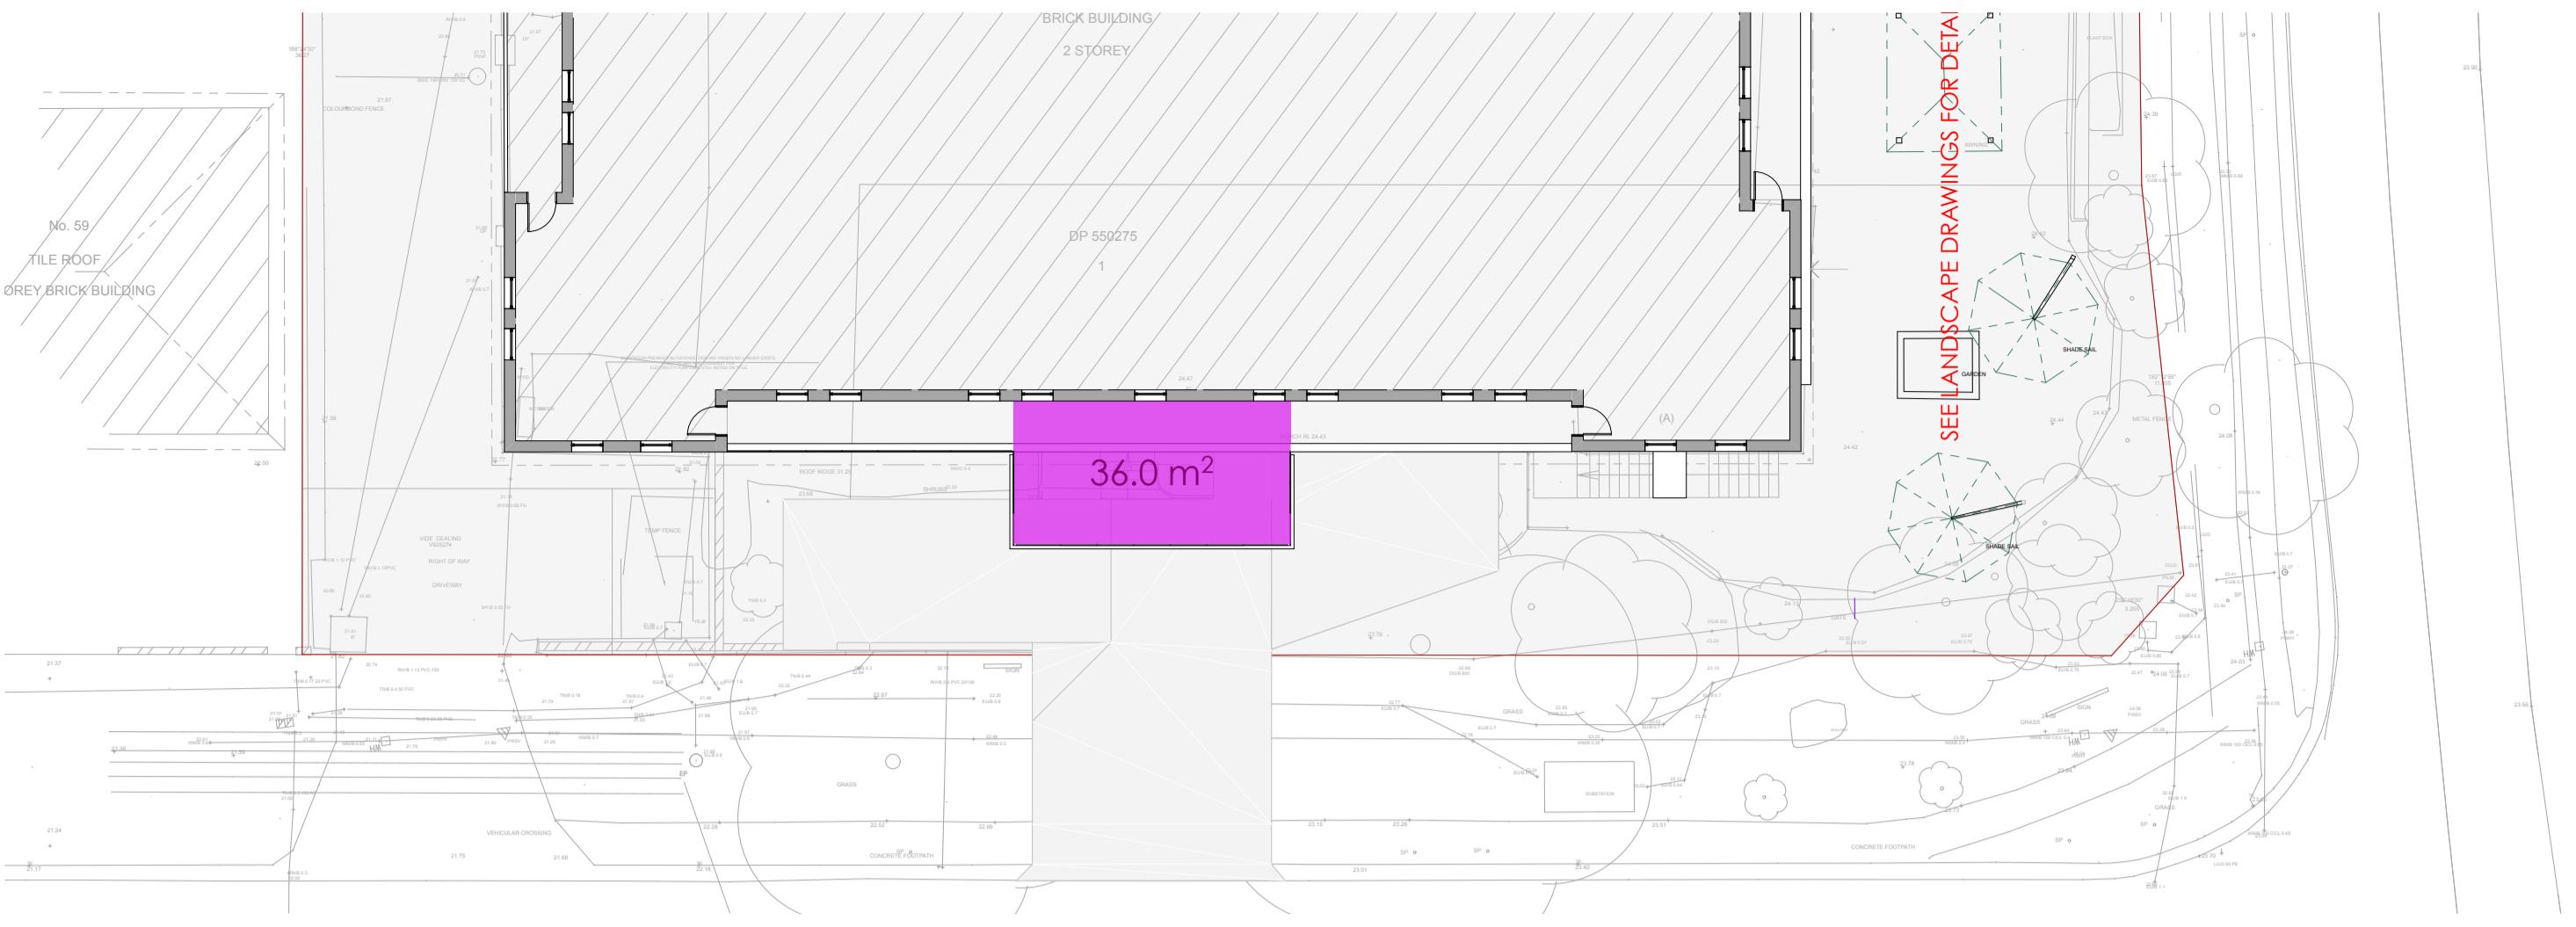

NEW LANDSCAPE AREA - UPPER

