

SOIL AND WATER MANAGEMENT NOTES

INTRODUCTORY NOTES

1. THIS IS A CONCEPTUAL SOIL AND WATER MANAGEMENT PLAN (SWMP). IT IS INTENDED TO INDCIATE THAT THE CIVIL WORKS REQUIRED FOR THE DEVELOPMENT OF THE SITE CAN BE UNDERTAKEN WITHOUT POLLUTION TO RECEIVING WATERS DURING THE CONSTRUCTION PHASE. THE LOCATIONS, SIZES AND TYPES OF CONTROL MEASURES SHOWN ARE SUGGESTED OPTIONS ONLY. 2. ALL REFERENCES OF DETAILS, TESTING AND PROCEDURES ARE TO BE FOLLOWED AS SPECIFIED IN THE DEPARTMENT OF HOUSING "MANAGING URBAN STORMWATER SOILS CONSTRUCTION" MANUAL, MARCH 2004, HERE IN REFERRED TO AS THE "BLUE BOOK". 3. THESE CONCEPT PLANS ARE TO BE READ IN CONJUNCTION WITH THE ENGINEERING PLANS AND OTHER PLANS OR WRITTEN INSTRUCTIONS THAT MAY BE ISSUED AND RELATING TO THE DEVELOPMENT OF THE SITE. 4. ALL CONTRACTORS SHALL FULLY RESEARCH AND UNDERSTAND THEIR RESPONSIBILITIES IN MINIMISING THE POTENTIAL FOR SOIL EROSION AND POLLUTION TO DOWNSTREAM LANDS AND WATERWAYS.

EROSION CONTROL

- 1. CLEARLY VISIBLE BARRIER FENCING SHALL BE INSTALLED AT THE DISCRETION OF THE SUPERINTENDENT TO ENSURE TRAFFIC CONTROL AND PROHIBIT UNNECESSARY SITE DISTURBANCE. VEHICULAR ACCESS TO THE SITE SHALL BE LIMITED TO ONLY THOSE ESSENTIAL FOR CONSTRUCTION WORK AND THEY SHALL ENTER SITE ONLY THROUGH THE STABILISED ACCESS POINTS.
- 2. WHERE PRACTICAL, FOOT AND VEHICULAR TRAFFIC WILL BE KEPT AWAY FROM ALL RECENTLY STABLISED AREAS.
- 3. AT ALL TIMES, AND IN PARTICULAR DURING WINDY AND DRY WEATHER, LARGE, UNPROTECTED AREAS WILL BE KEPT MOIST (NOT WET) BY SPRINKLING WITH WATER TO KEEP DUST UNDER CONTROL.

PROJECT

1. WATER WILL BE PREVENTED FROM ENTERING THE PERMANENT DRAINAGE SYSTEM UNLESS IT IS RELATIVELY SEDIMENT FREE (I.E. THE CATCHMENT AREA HAS BEEN PERMANENTLY LANDSCAPED/STABLISED AND/OR ANY LIKELY SEDIMENT HAS BEEN FILTERED THROUGH AN

APPROVED STRUCTURE). PROVIDE FLOCULANT TO EARTH BASIN AS REQ'D. 2. TEMPORARY SOIL AND WATER MANAGEMENT STRUCTURES WILL BE REMOVED ONLY AFTER THE LANDS THEY ARE PROTECTING ARE STABILISED/ REHABILITATED.

OTHER MATTERS

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- 1. ANY EXISTING TREES WHICH FORM PART OF THE FINAL LANDSCAPING PLAN WILL BE PROTECTED FROM CONSTRUCTION ACTIVITIES BY: (A) PROTECTING THEM WITH BARRIER FENCING OR SIMILAR MATERIALS
- INSTALLED OUTSIDE THE DRIP LINE. (B) ENSURING THAT NOTHING IS NAILED TO THEM.

STOCKPILES WITHIN THE DRIP LINE.

- (C) PROHIBITING PAVING, GRADING, SEDIMENT WASH OR PLACING OF
- 2. EROSION AND SEDIMENT CONTROL MEASURES SHALL BE INSPECTED TO ENSURE THAT THEY OPERATE EFFECTIVELY. REPAIRS AND OR MAINTENANCE SHALL BE UNDERTAKEN REGULARLY AND AS REQUIRED, PARTICULARLY FOLLOWING STORM EVENTS.
- 3. THE CONTRACTOR SHALL PROVIDE ALL MONITORING CONTROLS & TESTING.
- 4. SITE REVEGETATION AND REHABILIATION SHALL BE UNDERTAKEN AS
- SOON AS PRACTICABLE THROUGHOUT CONSTRUCTION OPERATIONS. 5. CONSTRUCTION SHALL BE PROGRAMMED SO THAT THE TIME OF
- EXPOSURE OF WORKING SURFACES IS MINIMISED.
- 6. ALL SPOIL DEPOSITED DURING CARTAGE OF MATERIALS FROM OR TO THE SITE SHALL BE REMOVED IMMEDIATELY TO THE SATISFACTION OF COUNCIL
- (PUBLIC ROADS) AND THE OWNER (PRIVATE ROADS).
- 7. WHERE REQUIRED GUTTERS AND ROADWORKS SHALL BE SWEPT REGULARLY TO MAINTAIN THEM FREE FROM SEDIMENT.

LEGEND

PROPOSED SEDIMENT FENCE

— — — SITE BOUNDARY

REFER DRAWING C03 FOR SEDIMENT CONTROL DETAILS.

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REVISED KERB RETURN 16-03-21 ISSUED FOR AUTHORITY APPROVAL 08-09-20 DATE DATE REVISION REVISION



27 BELLEVUE AVENUE **AVALON**

CONSTRUCT BY DESIGN

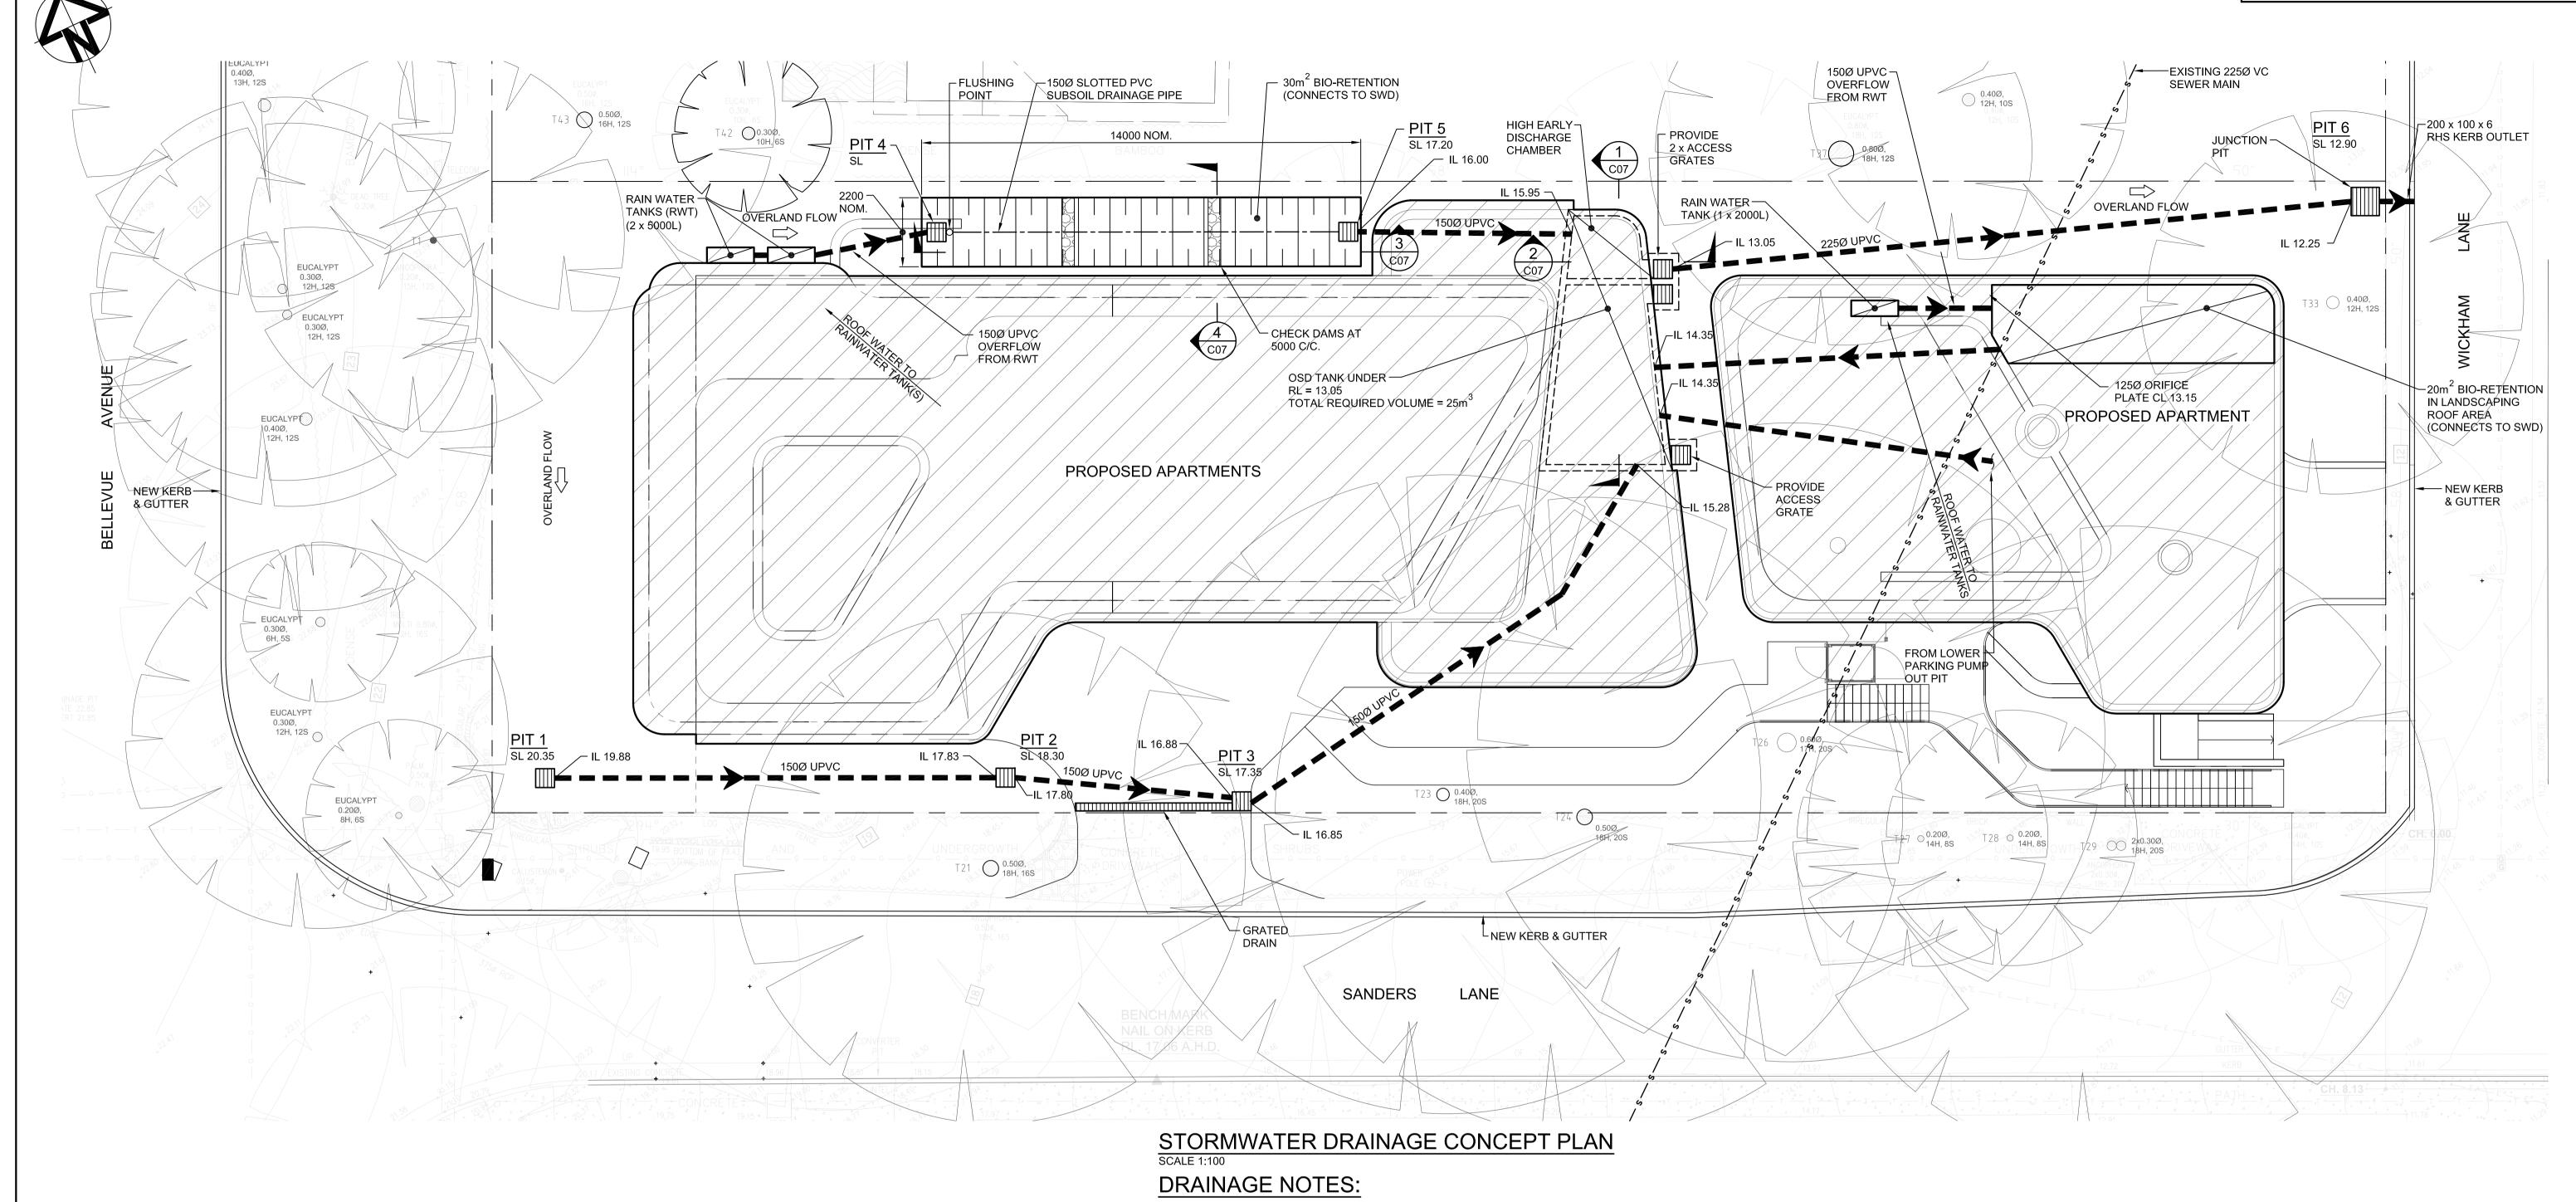
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SEDIMENT AND EROSION **CONTROL PLAN**

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1. FOR DRAINAGE NOTES REFER DWG. C01.

PIT SCHEDULE						
PIT No.	SIZE	LID TYPE (TO AS.3996)				
1	450 x 450	SURFACE INLET PIT FLUSH GRATE CLASS 'A'				
2	450 x 450	SURFACE INLET PIT FLUSH GRATE CLASS 'A'				
3	450 x 450	SURFACE INLET PIT FLUSH GRATE CLASS 'D'				
4	450 x 450	SURFACE INLET PIT FLUSH GRATE CLASS 'A'				
5	900 x 900	SURFACE INLET PIT FLUSH GRATE CLASS 'A'				
6	450 x 450	SURFACE INLET PIT FLUSH GRATE CLASS 'A'				

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PIT NOTES:

- 1. PITS DEEPER THAN 1000 TO HAVE STEP IRONS.
- 2. ALL GRATES TO BE CAST INTO NEW SLABS. 3. ALL OSD/PIT/TRENCH DRAIN LIDS AND GRATES TO BE TO
- AS 3996. REFER TO PLANS/SECTIONS FOR CLASS OF PIT/GRATE. 4. ALL PIT SURFACE LEVELS TO BE CONFIRMED ON SITE. ANY
- SIGNIFICANT VARIATIONS FROM PROVIDED SURFACE LEVELS, ENGINEER TO BE ADVISED FOR ANY CHANGES TO THE PIPE INVERT LEVELS.

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3	GENERALLY REVISED, OSD RELOCATED	16-03-21					
2	ISSUED FOR AUTHORITY APPROVAL	08-09-20					
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PROJECT

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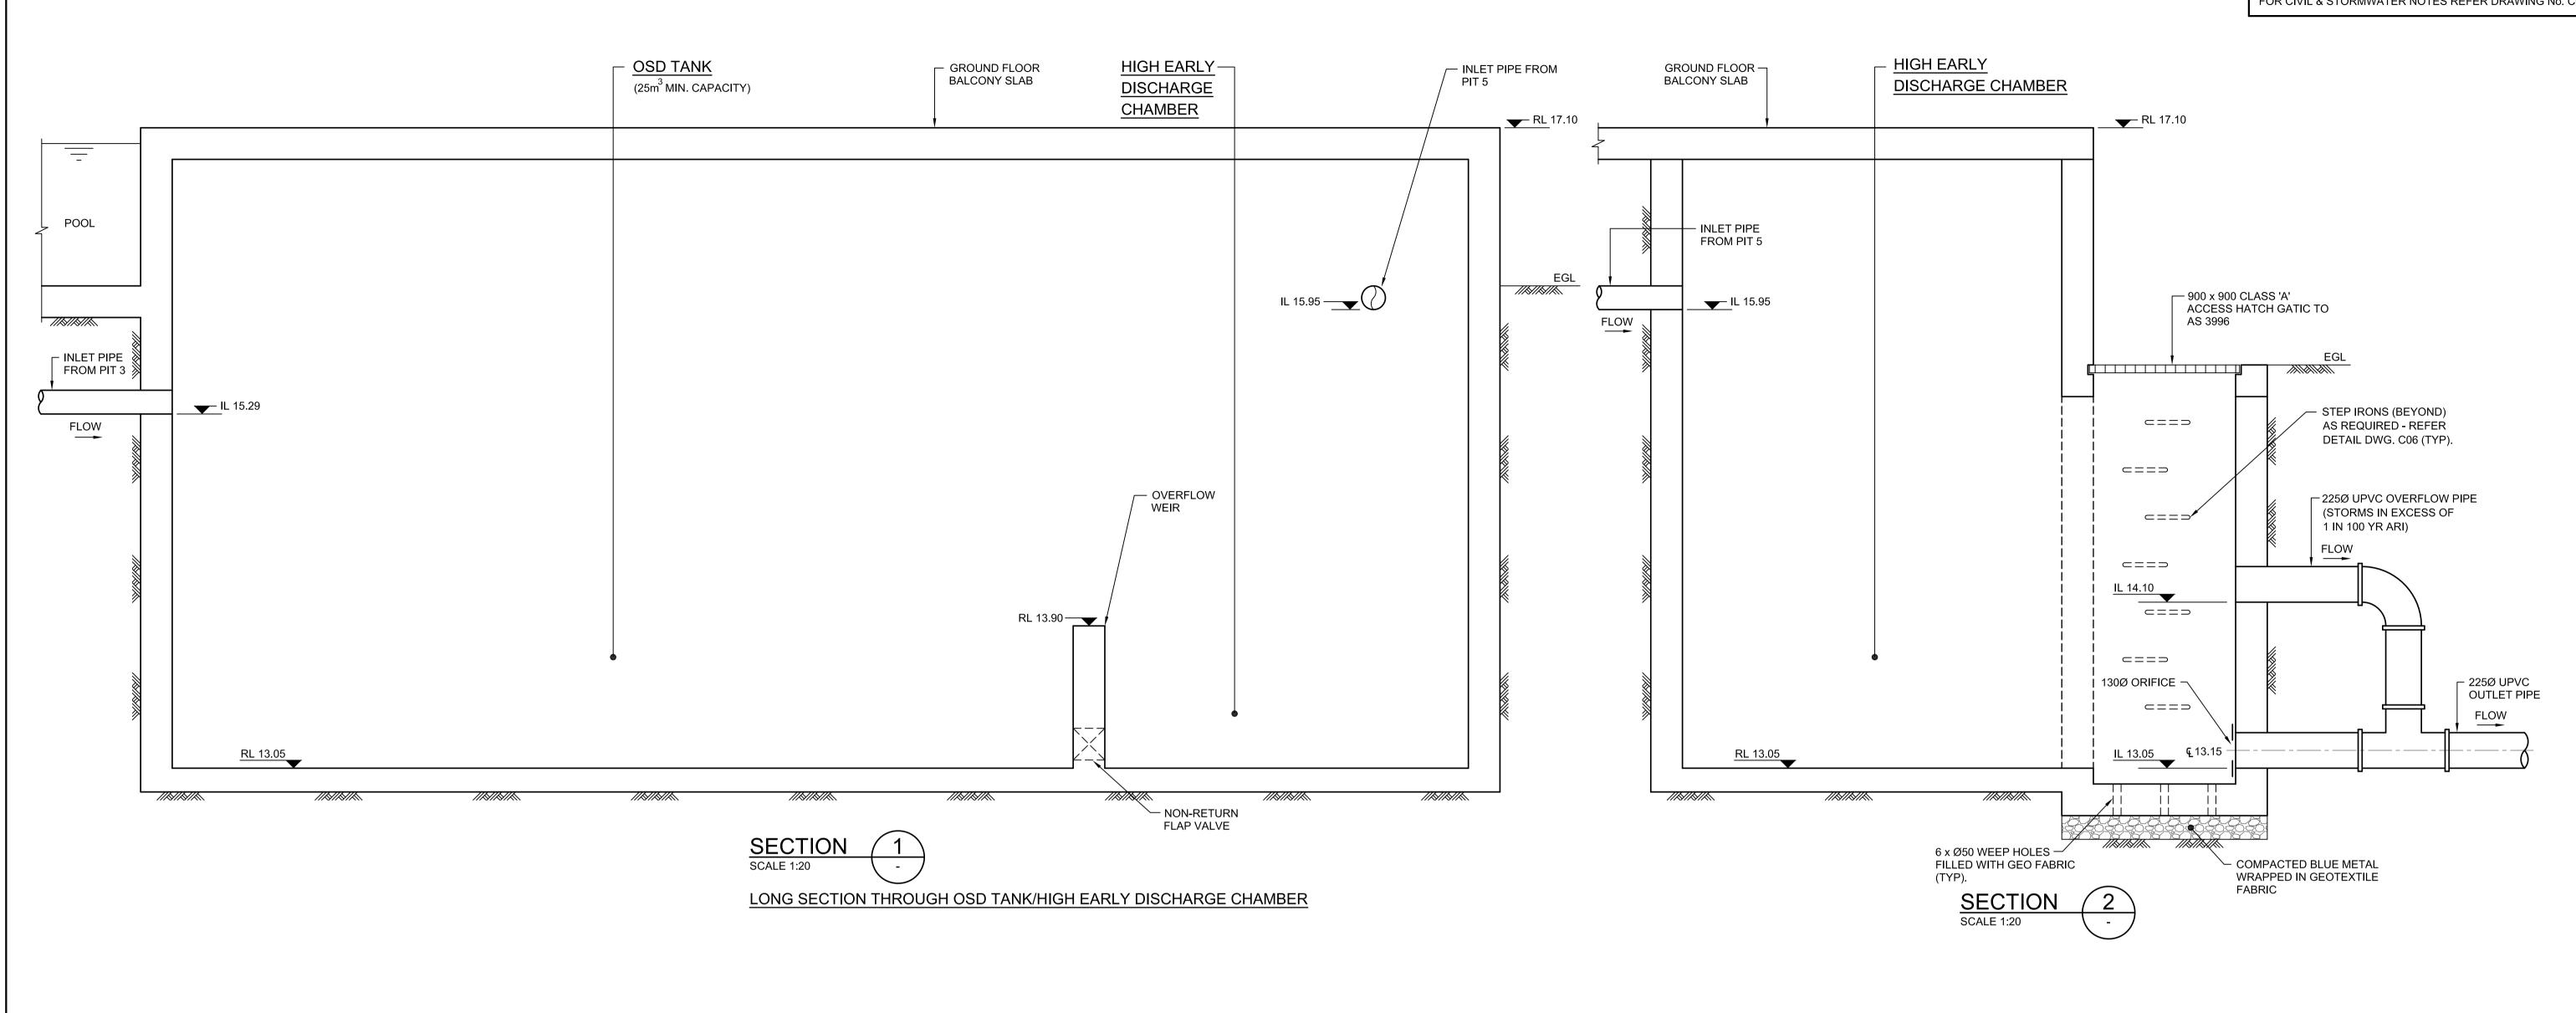
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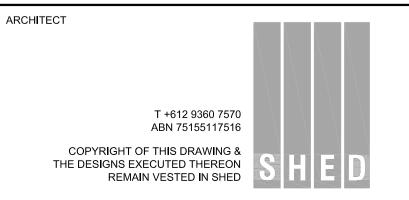
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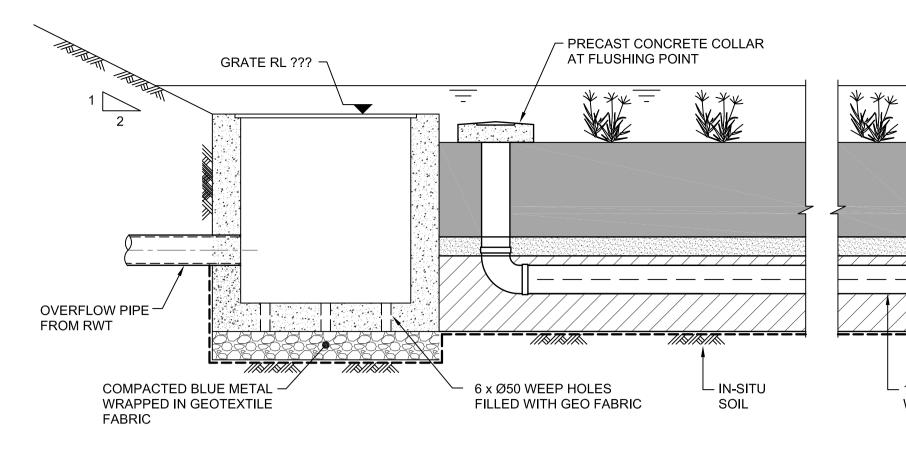
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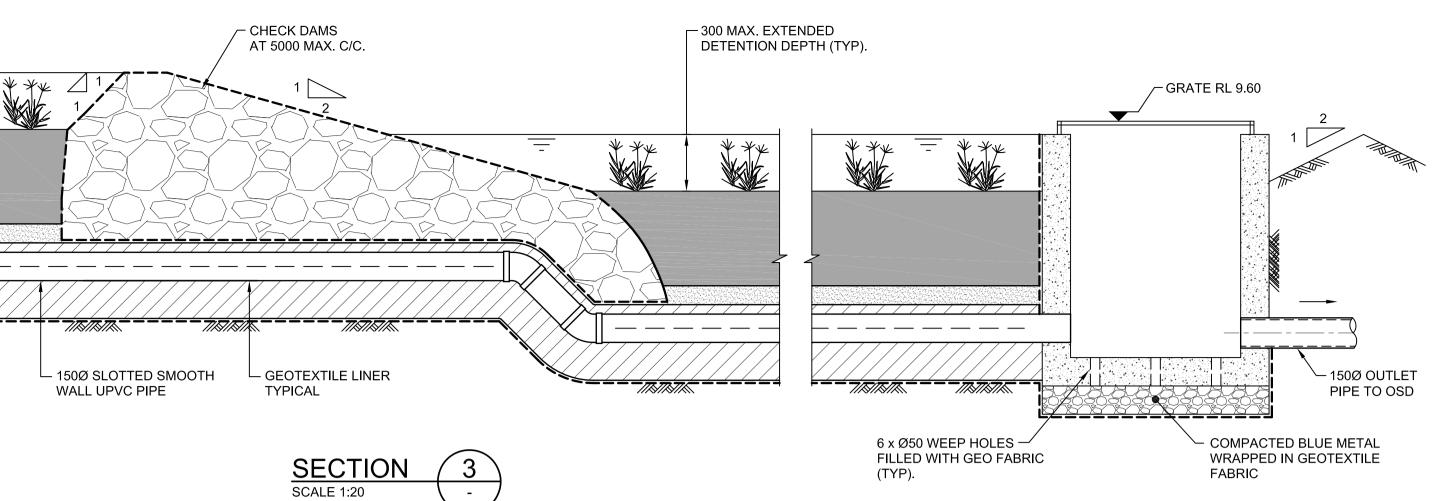
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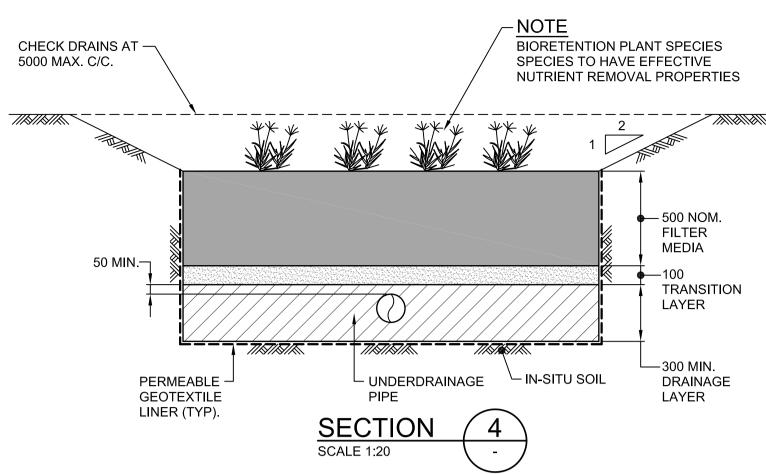
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STORMWATER DRAINAGE DETAILS SHEET 2								
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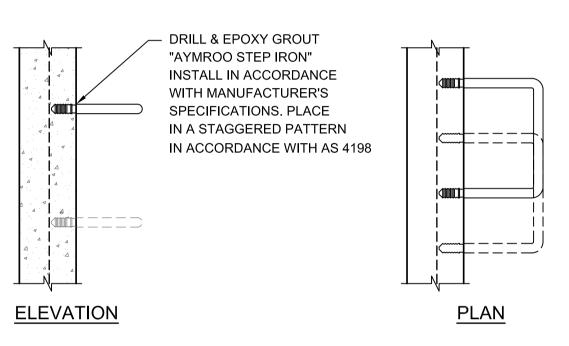


LONG SECTION THROUGH BIORETENTION BASIN



TYPICAL BIORETENTION DRAINAGE DETAIL

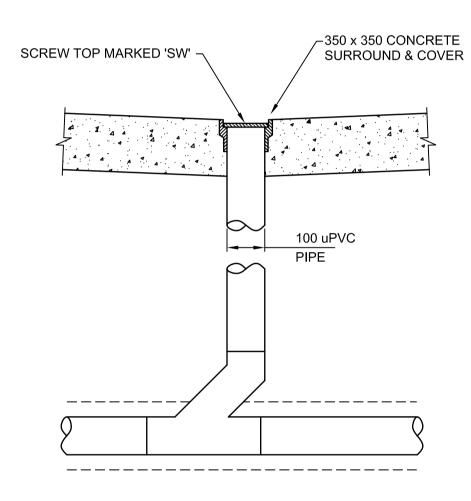
REFER TO CIVIL NOTES & DETAILS OF FILTER MEDIA, TRANSITION AND DRAINAGE LAYERS ON DWG. C01.



DETAILS OF STEP IRONS

SCALE 1:10 NOTE:

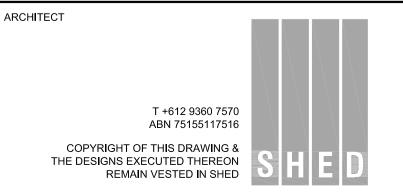
- 1. WHEN POSITIONED IN STRAIGHT ALIGNMENT, STEP TO BE 400 WIDE. 2. STAGGERED STEPS TO BE 200 WIDE, STEPS TO BE STAGGERED 200.
- CENTRE TO CENTRE FOR ALTERNATE STEPS.
- 3. SPACING OF STEPS TO BE UNIFORM TO WITHIN ±8mm IN EACH PIT.



TYPICAL CLEANING EYE DETAIL

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STORMWATER DRAINAGE **DETAILS SHEET 3** DATE SCALE SEPT 2020 NOTED AT A1 DRAWN JDW REVIEWED SCM DESIGNED DRAWING No. Tel: +61 (0)2 8666 7888 Fax: +61 (0)2 8666 7878 Email.cad@mg.com.au

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