

- 2 All dimensions that relate to site boundaries and easments are subjuct to verification by site survey.

 All work to be in accordance with BUILDING CODE of AUSTRALIA & to the satisfaction of local council requirements & other authorities.

 All timber construction to be in accordance with the "IMBER FRAMING" code.
- Any detailing in addition to what is supplied shall be resolved between the owner and the builder to the owner's approval, except for any structual details or design which is to be supplied by Structual Engineer.
- Roof water & sub—soil draininge to be disposed of in the approved manner or as directed by local council inspir All electrical power & light outlets to be determined by owner. Make good and repair all existing finishes damaged by new ork. Reuse existing material where possible.

17/04/24 DATE ISSUED FOR DA AMENDMENT No.


MICHAL KORECKY


21 NALYA ROAD, NARRAWEENA NSW 2099 ABN: 79 393 130 294

Email: koreckym@gmail.com www.plansdesign.com.au Phone: 99813332, Mob: 0438 148 944 **ALTERATIONS AND ADDITIONS** No 45 OXFORD FALLS ROAD BEACON HILL

JIRI AND MARCELA ALBRECHT

17/04/24 | SCALE: AS NOTED DRAWN: MK ISSUE: SHEET: 18080

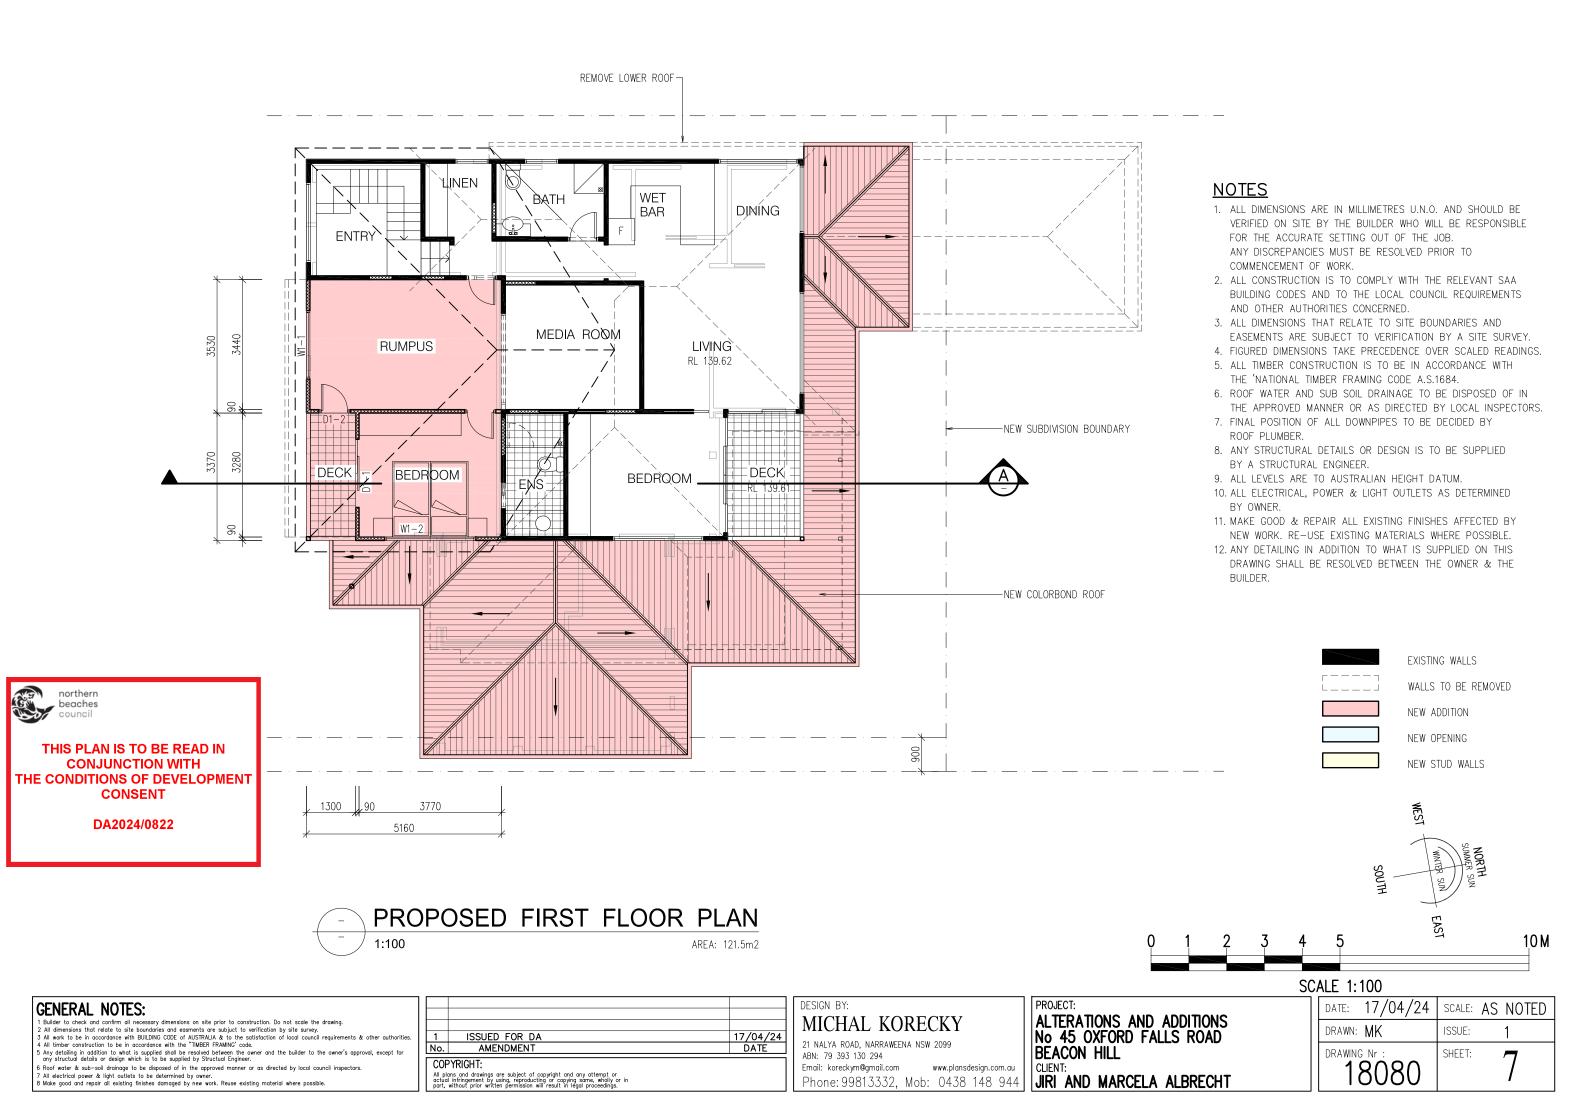


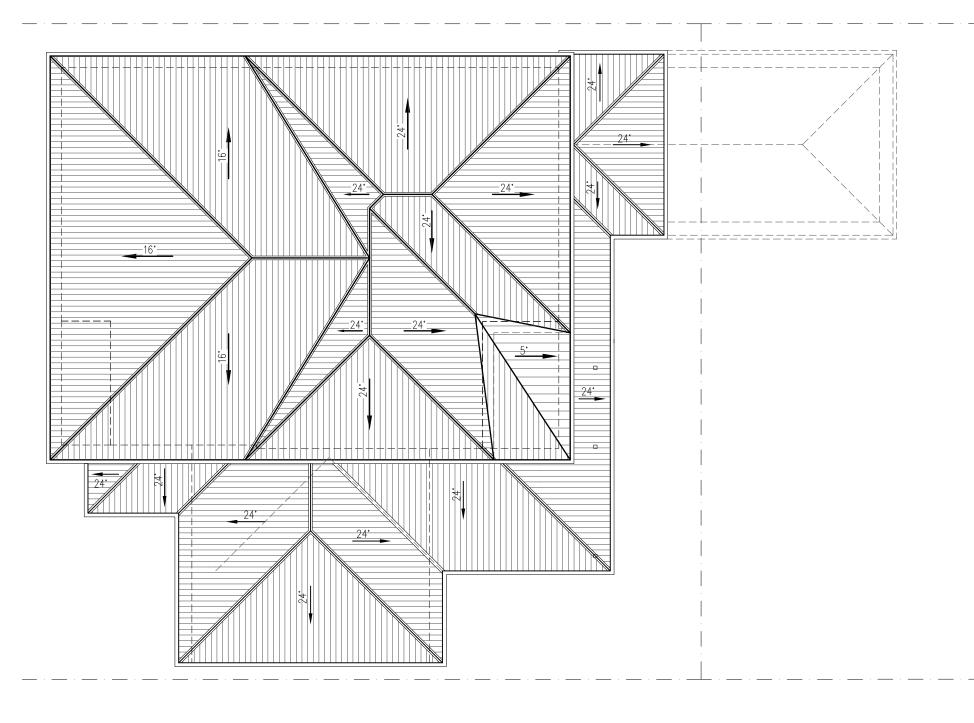



DA2024/0822



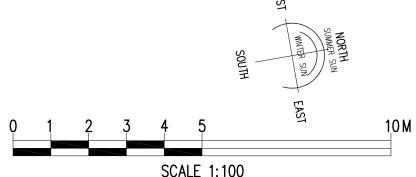

GENERAL NOTES:

- B Builder to check and confirm all necessary dimensions on site prior to construction. Do not scale the drawing.

 2 All dimensions that relate to site boundaries and easments are subjuct to verification by site survey.

 3 All work to be in accordance with BILIDING CODE of ALDISTRALA & to the satisfaction of local council requirements & other authorities.

 4 All timber construction to be in accordance with the "IMBER FRAMING" code.

 5 Any detailing in addition to what is supplied shall be resolved between the owner and the builder to the owner's approval, except for any structual details or design which is to be supplied by Structual Engineer.

 6 Roof water & sub-soil drainage to be disposed of in the approved manner or as directed by local council inspectors.

 7 All electrical power & light outlets to be determined by owner.

 8 Make good and repair all existing finishes damaged by new work. Reuse existing material where possible.

1	ISSUED FOR DA	17/04/24			
No.	AMENDMENT	DATE			
COPYRIGHT: All plans and drawings are subject of copyright and any attempt or actual intringement by using, reproducting or copying same, wholly or in port, without prior written permission will result in legal proceedings.					

DESIGN BY:

MICHAL KORECKY

21 NALYA ROAD, NARRAWEENA NSW 2099
ABN: 79 393 130 294
Email: koreckym@gmail.com www.plansdesign.com.au
Phone: 998133332, Mob: 0438 148 944

PROJECT:

ALTERATIONS AND ADDITIONS No 45 OXFORD FALLS ROAD BEACON HILL CLIENT:
JIRI AND MARCELA ALBRECHT

(CALE 1:100				
		DATE: 17/04/24	SCALE:	AS NOTED	
		DRAWN: MK	ISSUE:	1	
		DRAWING Nr : 18080	SHEET:	8	







PROPOSED SOUTH ELEVATION 1:100

10 M SCALE 1:100


GENERAL NOTES:

- 2 All dimensions that relate to the building some state of All timers construction to the vertication of the state of All timers construction to the occordance with a state of All timers construction to be in accordance with the "IMBER FRAMING" code.
- Any detailing in addition to what is supplied shall be resolved between the owner and the builder to the owner's app any structual details or design which is to be supplied by Structual Engineer.
- 6 Roof water & sub-soil drainage to be disposed of in the approved manner or as directed by local or 7 All electrical power & light outlets to be determined by owner. 8 Make good and repair all existing finishes damaged by new work. Reuse existing material where possil
- 17/04/24 DATE ISSUED FOR DA AMENDMENT No.

DESIGN BY: MICHAL KORECKY

21 NALYA ROAD, NARRAWEENA NSW 2099 ABN: 79 393 130 294 Phone: 99813332, Mob: 0438 148 944 ALTERATIONS AND ADDITIONS No 45 OXFORD FALLS ROAD BEACON HILL JIRI AND MARCELA ALBRECHT


17/04/24 | SCALE: AS NOTED DRAWN: MK ISSUE: SHEET: 9 18080

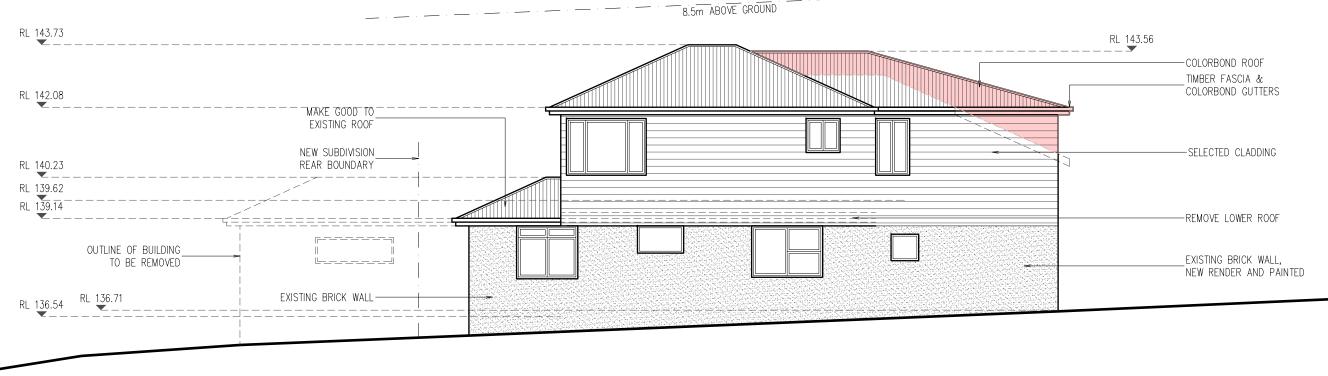



NOTES

- 1. ALL DIMENSIONS ARE IN MILLIMETRES U.N.O. AND SHOULD BE VERIFIED ON SITE BY THE BUILDER WHO WILL BE RESPONSIBLE FOR THE ACCURATE SETTING OUT OF THE JOB. ANY DISCREPANCIES MUST BE RESOLVED PRIOR TO COMMENCEMENT OF WORK.
- 2. ALL CONSTRUCTION IS TO COMPLY WITH THE RELEVANT SAA BUILDING CODES AND TO THE LOCAL COUNCIL REQUIREMENTS AND OTHER AUTHORITIES CONCERNED.
- 3. ALL DIMENSIONS THAT RELATE TO SITE BOUNDARIES AND EASEMENTS ARE SUBJECT TO VERIFICATION BY A SITE SURVEY.
- 4. FIGURED DIMENSIONS TAKE PRECEDENCE OVER SCALED READINGS.
- 5. ALL TIMBER CONSTRUCTION IS TO BE IN ACCORDANCE WITH THE 'NATIONAL TIMBER FRAMING CODE A.S.1684.
- 6. ROOF WATER AND SUB SOIL DRAINAGE TO BE DISPOSED OF IN THE APPROVED MANNER OR AS DIRECTED BY LOCAL INSPECTORS.
- 7. FINAL POSITION OF ALL DOWNPIPES TO BE DECIDED BY ROOF PLUMBER.
- 8. ANY STRUCTURAL DETAILS OR DESIGN IS TO BE SUPPLIED BY A STRUCTURAL ENGINEER.
- 9. ALL LEVELS ARE TO AUSTRALIAN HEIGHT DATUM.
- 10. ALL ELECTRICAL, POWER & LIGHT OUTLETS AS DETERMINED
- 11. MAKE GOOD & REPAIR ALL EXISTING FINISHES AFFECTED BY NEW WORK. RE-USE EXISTING MATERIALS WHERE POSSIBLE.
- 12. ANY DETAILING IN ADDITION TO WHAT IS SUPPLIED ON THIS DRAWING SHALL BE RESOLVED BETWEEN THE OWNER & THE

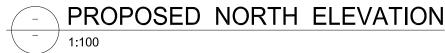


GENERAL NOTES:

TILED PATIO-

- 2 All dimensions that relate to site boundaries and easments are subjuct to verification by site survey.

 All work to be in accordance with SUILDING CODE of AUSTRALIA & to the satisfaction of local council requir.

 All timber construction to be in accordance with the "MIMBER FRANCO code.
- Any detailing in addition to what is supplied shall be resolved between the owner and the builder to the owner's app any structual details or design which is to be supplied by Structual Engineer.
- 5 Roof water & sub-soil drainage to be disposed of in the approved manner or as directed by local cou 7 All electrical power & light outlets to be determined by owner. 3 Make good and repair all existing finishes damaged by new work. Reuse existing material where possibl

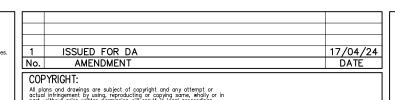

MICHAL KORECKY


21 NALYA ROAD, NARRAWEENA NSW 2099 ABN: 79 393 130 294

Phone: 99813332, Mob: 0438 148 944

ALTERATIONS AND ADDITIONS No 45 OXFORD FALLS ROAD BEACON HILL JIRI AND MARCELA ALBRECHT

0	ALE 1:100		
	DATE: 17/04/24	SCALE:	AS NOTED
	DRAWN: MK	ISSUE:	1
	DRAWING Nr : 18080	SHEET:	10

10 M

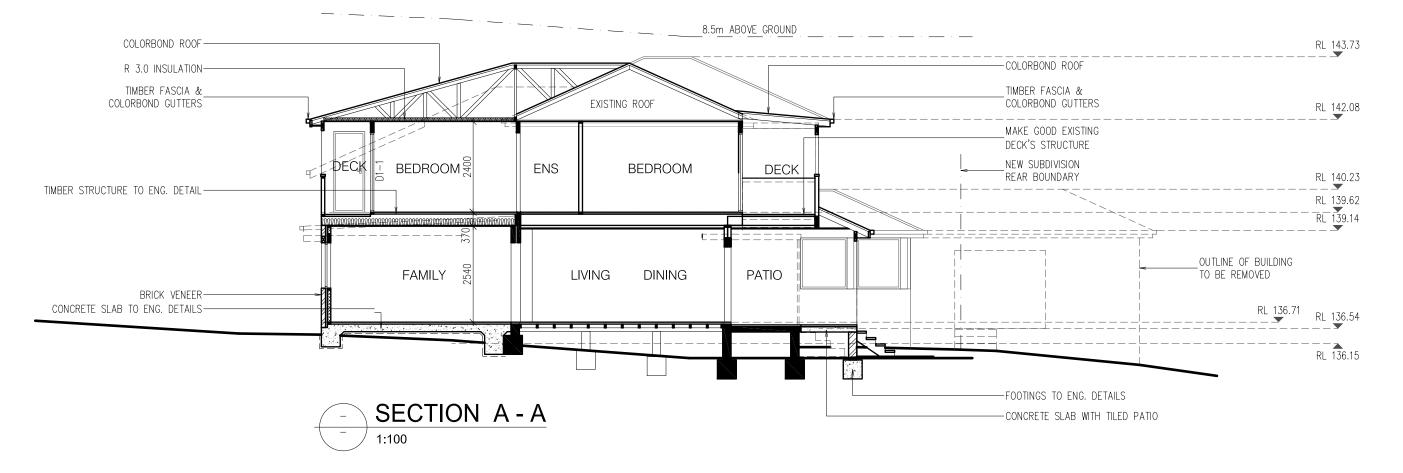

	WINDOWS AND DOOR SCHEDULE (FOR BASIX PURPOSES ONLY)						
ODIENT		SIZE		ADEA (m2)	SHADING DEVICE	FRAME AND GLASS TYPE	
ORIENT.	W	Н	AREA (m2)	SHADING DEVICE	MIN. REQUIREMENTS		
WG-1	SOUTH	1800	1200	2.16	NONE	standard aluminium single clear	
WG-2	SOUTH	1800	1200	2.16	NONE	standard aluminium single clear	
WG-3	SOUTH	1800	1200	2.16	NONE	standard aluminium single clear	
WG-4	NORTH	1890	1350	2.55	EAVE/PERGOLA >=450mm	standard aluminium, low—E	
WG-5	EAST	1160	1350	1.57	EAVE/PERGOLA >=450mm	standard aluminium, low—E	
WG-6	NORTH	900	2230	2.00	EAVE/PERGOLA >=900mm	standard aluminium single clear	
DG-1	NORTH	1990	2230	4.44	EAVE/PERGOLA >=900mm	standard aluminium single clear	
DG-2	EAST	2100	2070	4.35	EAVE/PERGOLA >=900mm	standard aluminium single clear	
W1-1	SOUTH	1810	1100	2.00	NONE	standard aluminium single clear	
W1-2	EAST	2410	600	1.45	NONE	standard aluminium single clear	
D1-1	SOUTH	1800	2100	3.78	EAVE/PERGOLA >=900mm	standard aluminium single clear	
D1-2	EAST	820	2130	1.75	EAVE/PERGOLA >=900mm	standard aluminium single clear	

BASIX COMMITMENTS CERTIFICATE NUMBER A1731377_02

NATURAL LIGHTING

THE APPLICANT MUST ENSURE A MINIMUM OF 40% OF NEW OR ALTERED LIGHT FIXTURES ARE FITTED WITH FLUORESCENT, COMPACT FLUORESCENT, OR LIGHT-EMITTING-DIODE (LED) LAMPS.

THE APPLICANT MUST ENSURE NEW OR ALTERED SHOWERHEADS HAVE A FLOW RATE NO GREATER THAN 9 LITRES PER MINUTE OR A 3 STAR WATER RATING.

THE APPLICANT MUST ENSURE NEW OR ALTERED TOILETS HAVE A FLOW RATE NO GREATER THAN 4 LITRES PER AVERAGE FLUSH OR A MINIMUM 3 STAR WATER RATING.

THE APPLICANT MUST ENSURE NEW OR ALTERED TAPS HAVE A FLOW RATE NO GREATER THAN 9 LITRES PER MINUTE OR MINIMUM 3 STAR WATER RATING.

WINDOWS AND GLAZED DOORS

(SEE WINDOW SCHEDULE)

CONCRETE SLAB ON GROUND FLOOR: NIL

EXTERNAL WALL: FRAMED (WEATHERBOARD, FIBRO, METAL CLAD): R1.30 (OR R1.70 INCLUDING CONSTRUCTION)

EXTERNAL WALL: BRICK VENEER, R1.16 (OR R1.70 INCLUDING CONSTRUCTION)

FLAT CEILING, PITCHED ROOF: CEILING: R3.0 (UP), ROOF: FOIL/SARKING, MEDIUM (SOLAR ABSORPTANCE 0.475 - 0.70)



SCALE 1:100

GENERAL NOTES:

- 2 All dimensions that relate to site boundaries and easments are subjuct to verification by site survey.

 All work to be in accordance with BUILDING CODE of AUSTRALIA & to the satisfaction of local council requirements & other authorities.

 All timber construction to be in accordance with the "Miller FRAMING" code.
- 6 Roof water & sub-soil drainage to be disposed of in the approved manner or as directed by local council inspectors. 7 All electrical power & light outlets to be determined by owner. 8 Make good and repair all existing finishes damaged by new work. Reuse existing material where possible.
- Any detailing in addition to what is supplied shall be resolved between the owner and the builder to the owner's approval, except for any structual details or design which is to be supplied by Structual Engineer.
- 17/04/24 DATE ISSUED FOR DA AMENDMENT No.

DESIGN BY: MICHAL KORECKY

21 NALYA ROAD, NARRAWEENA NSW 2099 ABN: 79 393 130 294

Email: koreckym@gmail.com Phone: 99813332, Mob: 0438 148 944 ALTERATIONS AND ADDITIONS No 45 OXFORD FALLS ROAD BEACON HILL

JIRI AND MARCELA ALBRECHT

17/04/24 | SCALE: AS NOTED DATE: DRAWN: MK ISSUE: DRAWING Nr SHEET: 18080

10 M