

PROPOSED TENANCY PLAN



DESIGNS CONTAINED IN THESE DRAWINGS
AND SPECIFICATIONS ARE THE PROPERTY OF
ARCHISPECTRUM AND ARE SUBJECT TO
COPYRIGHT LAWS. THEY MUST NOT BE
REPRODUCED IN WHOLE OR PART, OR USED
IN ANY OTHER WAY WITHOUT WRITTEN

CONSENT.
DO NOT SCALE DIMENSIONS. ALL DIMENSIONS




25.05.2021 DA Issue to Council

Kiss My Axe Pty Ltd 40 Winbourne Rd, Brookvale NSW 2100 **Proposed Tenancy Plan**

Kiss My Axe Pty Ltd 40 Winbourne Rd, Brookvale NSW 2100 SCALE: 1:100 @ A3 SHEET SIZE: DRAWN: Peter S

A3

DA02 a

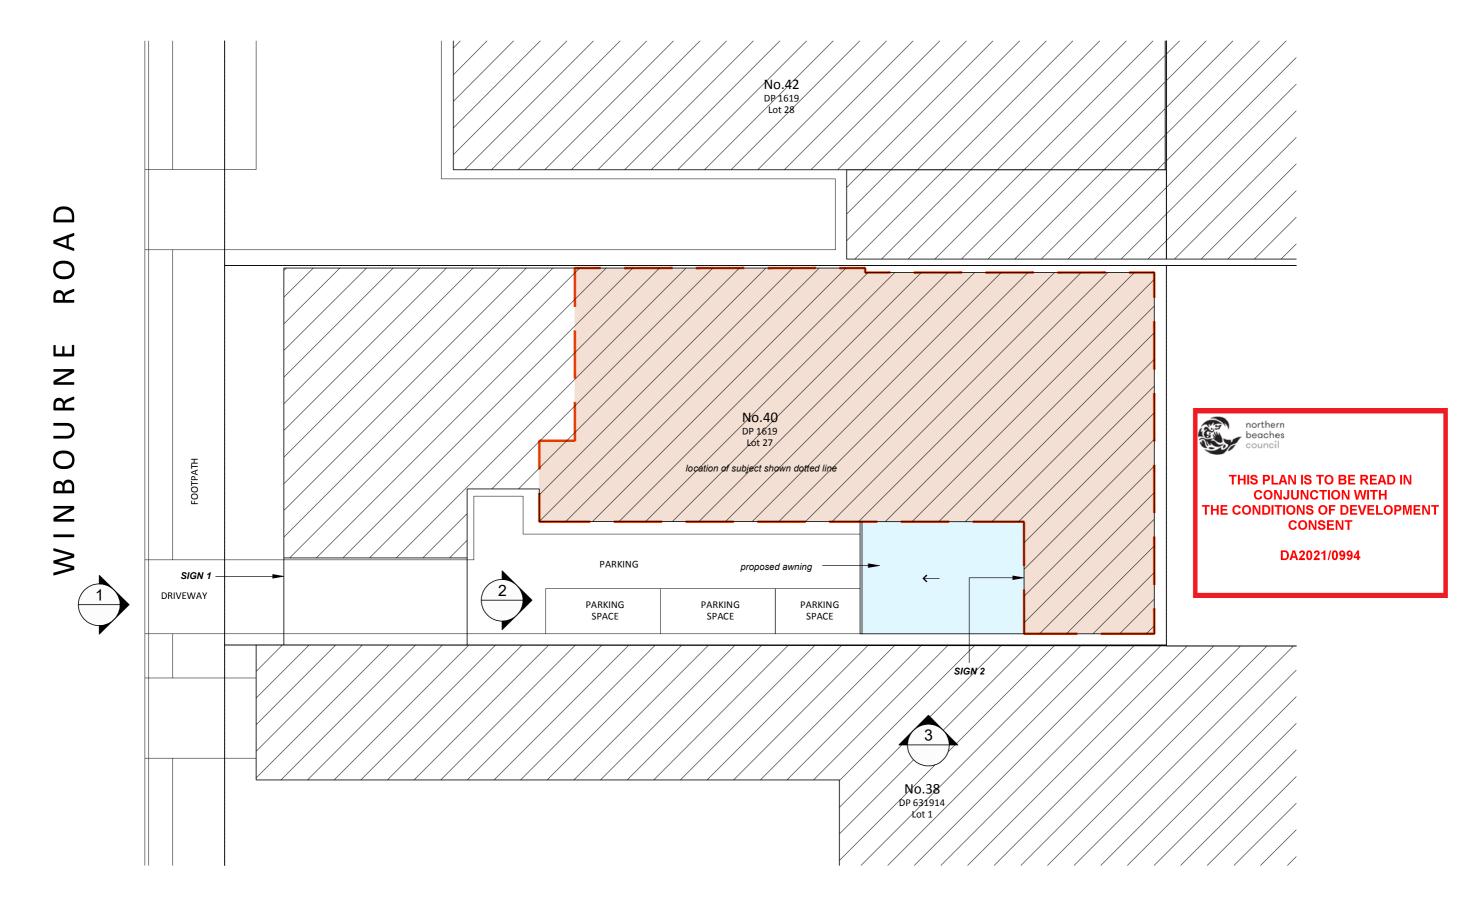

SITE PLAN SCALE: 1:200


25.05.2021 DA Issue to Council

Kiss My Axe Pty Ltd 40 Winbourne Rd, Brookvale NSW 2100 Site Plan

Kiss My Axe Pty Ltd 40 Winbourne Rd, Brookvale NSW 2100 scale: 1:200 @ A3 SHEET SIZE:
DRAWN: Peter S A3


DA03 a


DESIGNS CONTAINED IN THESE DRAWINGS
AND SPECIFICATIONS ARE THE PROPERTY OF
ARCHISPECTRUM AND ARE SUBJECT TO
COPYRIGHT LAWS. THEY MUST NOT BE
REPRODUCED IN WHOLE OR PART, OR USED
IN ANY OTHER WAY WITHOUT WRITTEN
CONSENT.
DO NOT SCALE DIMENSIONS. ALL DIMENSIONS
SHOULD BE VERIFIED ON SITE BEFORE
COMMENCEMENT OF ANY WORKS. IN CASE OF
ANY DISCREPANCIES, IT SHOULD BE VERIFIED
BEFORE CONTINUING FURTHER WORKS.

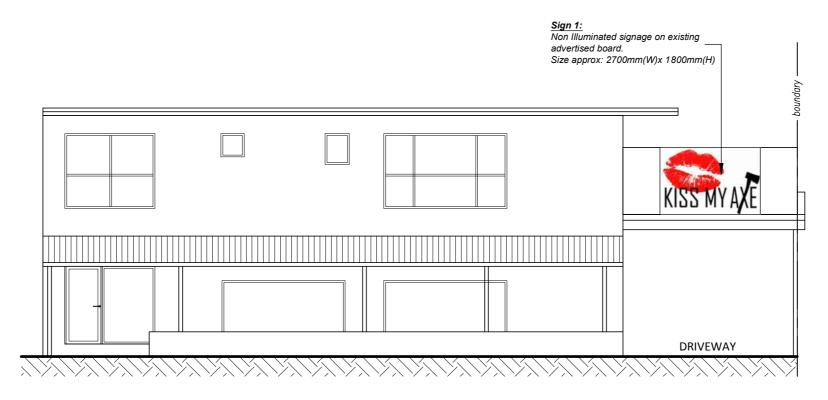





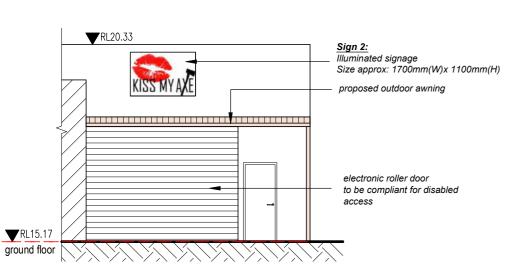

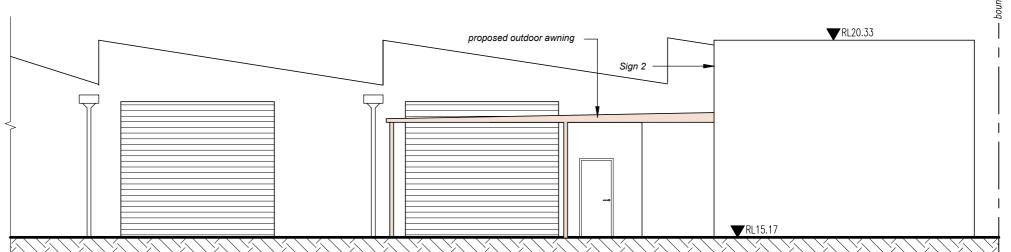

ELEVATION 2 (Entry) SCALE: 1:100

ELEVATION 3 (East Elevation)

NAMY OTHER WAY WITHOUT WRITTEN CONSENT.

ONSENT.

DO NOT SCALE DIMENSIONS. ALL DIMENSIONS SHOULD BE VERIFIED ON SITE BEFORE COMMENCEMENT OF ANY WORKS. IN CASE OF Suite C5, 8 Allen St, Waterloo NSW 2017 | A.B.N. 40 966 067 144 m: 0419 670 108 | ph; (02) 8399 2807 | e: office@archispectrum.com.au

DESIGNS CONTAINED IN THESE DRAWINGS
AND SPECIFICATIONS ARE THE PROPERTY OF
ARCHISPECTRUM AND ARE SUBJECT TO
COPYRIGHT LAWS. THEY MUST NOT BE
REPRODUCED IN WHOLE OR PART, OR USED
IN ANY OTHER WAY WITHOUT WRITTEN

25.05.2021 DA Issue to Council

Kiss My Axe Pty Ltd

40 Winbourne Rd, Brookvale NSW 2100

External Elevations & Signage Details

Kiss My Axe Pty Ltd 40 Winbourne Rd, Brookvale NSW 2100 SCALE: 1:100 @ A3 SHEET SIZE:

A3 DA04 a