

DRAWING INDEX				
DRAWING NO.	DRAWING TITLE			
DA102-01	GENERAL LAYOUT & SITE PLAN			
DA102-02	PLAN & SECTION ALONG PIPE			
DA102-03	SEDIMENT AND EROSION CONTROL PLAN & DETAILS			



SITE PLAN



SCALE 1:100 @ A1	0 .	1 .	2	4	6	8	10 metres
SCALE 1:200 @ A3							2

Α	FINAL DESIGN	17/01/20	AS	SN
Issue	Description	Date	Drawn	Approved



 Sydney
 Postal

 9/4 Central Avenue, Thomleigh N.S.W. 2120
 PO BOX 22, Thomleigh N.S.W. 2120

 Phone 02 9875 4500
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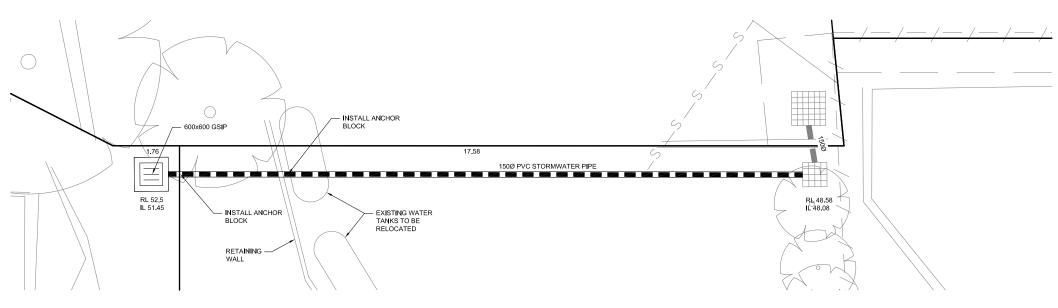
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	DAVID ROYLE 7 BUSHRANGERS HILL NEWPORT NSW 2106

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PROPOSED SUBDIVISION	
OVER LOT 1 DP634714 BUNGAN HEAD ROAD, NEWPORT	


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5800	-/3				





NEW STORMWATER PIPE PLAN SCALE 1: 50

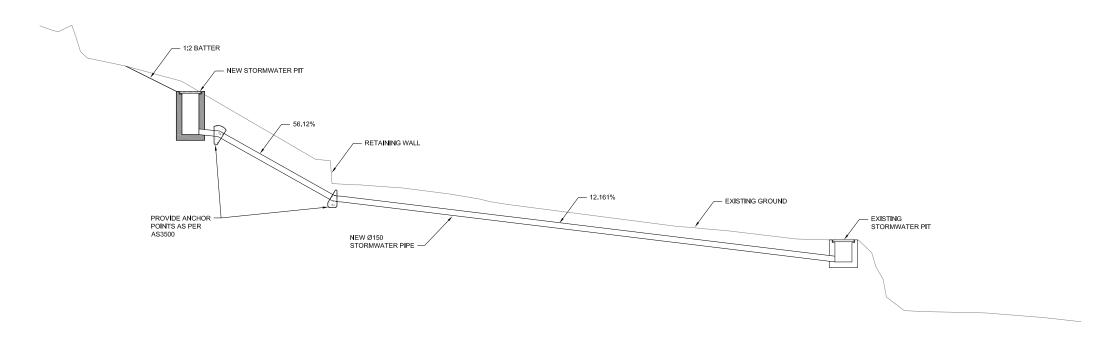

LONGITUDINAL SECTION ALONG STORMWATER PIPE SCALE 1: 50



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Α	FINAL DESIGN	17/01/20	AS	SN
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SCALE 1:50 @ A1 0 0.5 1 SCALE 1:100 @ A3



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	DAVID ROYLE 7 BUSHRANGERS HILL NEWPORT NSW 2106

1	Project:	Deslaned:	AS	Scale:	AS SHOWN	A1	Drawing Title:
I	PROPOSED SUBDIVISION	Designeu:	AS	Scale:	AS SHOWN		PLAN & SECTION ALONG PIPE
I	OVER LOT 1 DP634714	Drawn:	AS	Datum:	A.H.D		•
I	BUNGAN HEAD ROAD, NEWPORT	Checked:	SN	Date:	JANUARY 20:	20	•


NORTHERN BEACHES

GENERAL NOTES:

- 1. ALL EROSION AND SEDIMENT CONTROL MEASURES, INCLUDING REVEGETATION AND STORAGE OF SOIL AND TOPSOIL. SHALL BE IMPLEMENTED TO THE REQUIREMENTS OF THE "ENVIRONMENT PROTECTION AUTHORITY" AND "DEPT OF LAND AND WATER CONSERVATION". MEASURES OUTLINED IN THE SEDIMENT & EROSION CONTROL PLAN MUST BE IMPLEMENTED PRIOR TO AND MAINTAINED DURING AND AFTER THE CONSTRUCTION WORKS.
- 2. TOPSOIL FROM ALL AREAS TO BE DISTURBED SHALL BE STOCKPILED AND LATER RESPREAD TO AID REVEGETATION IN
- 3. ALL DRAINAGE WORKS SHALL BE CONSTRUCTED AND STABILIZED AS EARLY AS POSSIBLE DURING DEVELOPMENT.
- 4 ALL TAIL-OUT DRAINS SHALL BE GRASSED AND TRAPEZOIDAL IN SECTION. STRAW BALES SHALL BE PLACED AS A SEDIMENT CONTROL DEVICE WHERE REQUIRED.
- 5. VEHICULAR TRAFFIC SHALL BE CONTROLLED DURING DEVELOPMENT CONFINING ACCESS WHERE POSSIBLE TO PROPOSED OR EXISTING ROAD ALIGNMENTS. AREAS TO BE LEFT UNDISTURBED SHALL BE MARKED OFF.
- DISTURBANCE OF VEGETATION SHALL BE LIMITED TO FILL AREAS, ROADWAYS AND DRAINAGE LINES, NO LOT GRADING SHALL BE CARRIED OUT IN UNDISTURBED AREAS WITHOUT CONSULTATION WITH COUNCIL'S ENGINEER.
- 7. ALL DISTURBED AREAS SHALL BE REVEGETATED WITHIN 14 WORKING DAYS FROM THE CONCLUSION OF LAND SHAPING.
- 8. MINIMISE DUST BY WATERING WHEN REQUIRED.

STOCKPILE NOTES:

- 9. SPOIL AND TOPSOIL STOCKPILES SHALL BE LOCATED AWAY FROM DRAINAGE LINES AND AREAS WHERE WATER MAY CONCENTRATE.
- 10. IF STOCKPILES ARE TO BE IN PLACE FOR LONGER THAN 14 DAYS THEN THEY SHALL BE STABILIZED BY COVERING WITH A MULCH OR WITH TEMPORARY VEGETATION.
- 11. FOLLOWING CONSTRUCTION, TOPSOIL SHALL BE RESPREAD TO A MINIMUM DEPTH OF 100MM ON THE BARE SOIL SURFACES

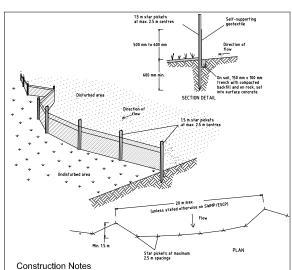

- Construct sediment fences as close as possible to being parallel to the contours of the site, but with small returns as shown in the drawing to limit the catchment area of any one section. The catchment area should be small enough to limit water flow it concentrated at one point to 50 litres per second in the design storm event, usually the 10-year event.

 2. Cut a 150-mm deep trench along the upslope line of the fence for the bottom of the fabric to
- 3. Drive 1.5 metre long star pickets into ground at 2.5 metre intervals (max) at the downslope 3. Drive 15 metric wing star pickers into ground a 12,3 metre intervals inhard at ownisciple edge of the french. Ensure any star pickers are fitted with safety caps.

 4. Fix self-supporting geotextile to the upslope side of the posts ensuring it goes to the base of the trench. Fix the geotextile with wire ties or as recommended by the manufacturer. Only use geotextile specifically produced for sediment fencing. The use of shade cloth for this purpose is not salification;

 5. Join sections of fabric at a support post with a 150-mm overlap.

 6. Backfill the trench over the base of the fabric and compact it thoroughly over the geotextile.

SEDIMENT FENCE

A FINAL DESIGN

ssue Description

SD 6-8

AND REVEGETATE.

12. ALL STOCKPILES TO BE (MAX) 2M HIGH AND PROTECTED WITH SILT FENCE.

SPECIAL NOTES:


- 13. LOCATION AND EXTENT OF SOIL AND WATER MANAGEMENT DEVICES IS DIAGRAMMATIC ONLY AND THE ACTUAL REQUIREMENTS SHALL BE CONFIRMED ON SITE.
- 14. THIS PLAN IS TO BE READ IN CONJUNCTION WITH THE GUIDELINES SET OUT IN "MANAGING URBAN STORMWATER SOILS AND CONSTRUCTION " -4TH EDITION AND THE ACCOMPANYING ROAD AND DRAINAGE PLANS.
- 15. CONFORMITY WITH THIS PLAN SHALL IN NO WAY REDUCE THE RESPONSIBILITY OF THE CONTRACTOR TO PROTECT AGAINST WATER DAMAGE DURING THE COURSE OF THE CONTRACT.
- 16. MANAGEMENT DEVICES SHALL BE MAINTAINED ON A REGULAR BASIS, WHERE CLEANING IS REQUIRED, THE SEDIMENT SHALL BE REMOVED TO A POINT NOMINATED BY THE ENGINEER.
- 17. PRIOR TO THE COMMENCEMENT OF ANY EARTHWORKS, AND AFTER THE ROAD CENTERLINES HAVE BEEN PEGGED AND/OR PERMANENTLY MARKED, THE SITE MUST BE INSPECTED BY COUNCIL'S REPRESENTATIVE AND THE APPLICANT'S REPRESENTATIVE TO IDENTIFY AND APPROPRIATELY MARKS A) THE TREES TO BE RETAINED. B) ALL TREES TO BE LEFT UNDISTURBED AND TO BE CORDONED OFF.
- 18. NO TREES SHALL BE REMOVED WITHOUT COUNCIL'S CLEARANCE.
- 19. MANAGEMENT DEVICES TO REMAIN UNTIL THE END OF THE

SEDIMENT CONTROL DEVICES:

- 20. ALL STRAW BALES SHALL BE BOUND WITH WIRE. STRAW BALES SHALL BE PLACED END TO END IN A SINGLE ROW AND EMBEDDED INTO THE SOIL TO A DEPTH OF 100MM, EACH BALE SHALL BE SECURELY ANCHORED WITH TWO STEEL STAKES DRIVEN 450MM INTO THE GROUND AND LOCATED ON THE BALE
- 21. SILT FENCES SHALL BE CONSTRUCTED BY STRETCHING A FILTER FABRIC (PROPEX OR SIMILAR) BETWEEN POSTS AT 2M (3M MAX) CENTRES. FABRIC SHALL BE BURIED 150MM ALONG ITS LOWER EDGE.

ADDITIONAL NOTES:

- 22. MINIMUM 300mm WIDE STRIP OF TURF IS REQUIRED BEHIND
- 23. TURF AROUND ALL SURFACE INLET PITS AT 1m WIDE

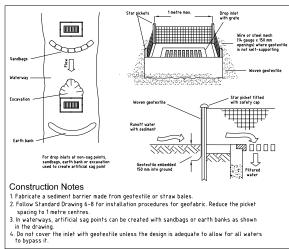

GEOTEXTILE INLET FILTER

PO BOX 22, Thomleigh N.S.W. 2120

PROPOSED SUBDIVISION OVER LOT 1 DP634714 BUNGAN HEAD ROAD, NEWPORT

esigned: AS Scale: AS SHOWN SEDIMENT AND EROSION CONTROL PLAN & DETAILS rawn: AS Datum; A.H.D.

necked: SN Date: JANUARY 2020

NORTHERN BEACHES


EROSION AND SEDIMENT CONTROL LEGEND

ACCORDING TO: LANDCOM SOILS AND CONSTRUCTION Vol.1, 4th EDITION, MARCH 2004

SEDIMENT FENCE TO SD 6-8

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DA102-03 r Ref: Sheet No 3 / 3



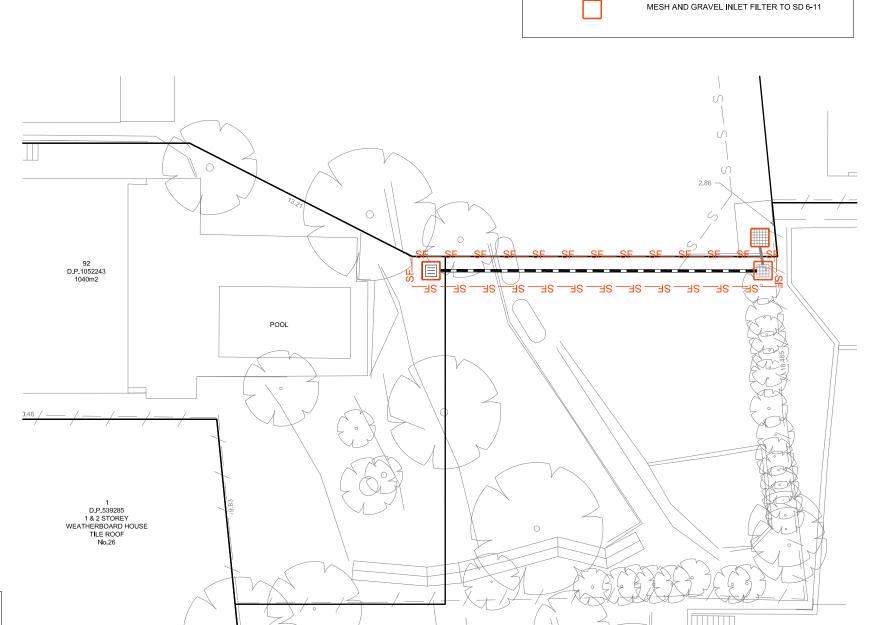

FOR DA APPROVAL

17/01/20 AS SN

mepstead & ASSOCIATES

SD 6-12

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