

SITE INFORMATION SUMMARY COUNCIL NORTHERN BEACHES (PITTWATER) SITE AREA 622.7 m² **OSD CALCULATION SUMMARY** 182 m² (29 %) **EXISTING IMPERVIOUS AREA** 402 m² (65 %) PROPOSED IMPERVIOUS AREA 220 m² **INCREASE** 15.0 m⁻³ **OSD REQUIREMENT** NOTE: AS THIS SITE IS LOCATED AT THE END OF THE CATCHMENT, A LAG IN FLOWS IS LIKELY TO COINCIDE WITH THE PEAK FLOWS FROM THE CATCHMENT. OSD IS THEREFORE NOT RECOMMENDED FOR THIS DEVELOPMENT. NIL OSD PROVIDED **LEGEND** DP1 • 150mm Ø DOWNPIPE TO RWT 100mm Ø DOWNPIPE TO RWT 100mm Ø SPREADER 100mm Ø STORMWATER PIPELINE, UNO

NO INVESTIGATION OF UNDERGROUND SERVICES HAS BEEN MADE. ALL RELEVANT AUTHORITIES SHOULD BE NOTIFIED PRIOR TO ANY EXCAVATION ON OR NEAR THE SITE

DEVELOPERS & EXCAVATORS MAY BE HELD FINANCIALLY RESPONSIBLE BY THE ASSET OWNER SHOULD THEY DAMAGE UNDERGROUND NETWORKS.

CARELESS DIGGING CAN:

CAUSE DEATH OR SERIOUS INJURY TO WORKERS AND THE GENERAL PUBLIC INCONVENIENCE USERS OF ELECTRICITY, GAS, WATER AND COMMUNICATIONS

LEAD TO CRIMINAL PROSECUTION AND

DAMAGES CLAIMS
CAUSE EXPENSIVE FINANCIAL LOSSES

TO BUSINESS
CUT OFF EMERGENCY SERVICES
DELAY PROJECT COMPLETION TIMES
WHILE THE DAMAGE IS REPAIRED

MINIMISE YOUR RISK AND DIAL BEFORE YOU DIG. - TEL. 1100

Architect RAPID PLANS ISSUED FOR DA SUBMISSION 27/07/19 REVISION AMENDMENT



2/25 Seabeach Avenue, Mona Vale ABN - 90 625 916 341

Project	
	63 GONDOLA ROAD
	NORTH NARRABEEN
1	NONTHINANNADLLN

EG EG 27/07/2019 Checked Approved EG 1:200 ËĞ

SITE DRAINAGE PLAN

1100 **BEFORE YOU DIG**


> Drawing number Revision D01

NOTES:

- ALL PIPES TO BE 100mm Ø, LAID AT 1 % MINIMUM GRADE AND uPVC TO AS 1254.2002 U.N.O.
- ALL PIPES SHALL BE LAID ON A 75mm SAND BED, COMPACTED TO 100% S.M.D.D. BELOW PAVEMENTS.

 (NO COMPACTION REQUIRED BELOW LANDSCAPING)

 COVER TO SURFACE FROM TOP OF PIPE TO BE 300mm MINIMUM. BACKFILL TO BE ADEQUATELY CONSOLIDATED AROUND PIPES BY METHOD OF RAMMING AND WATERING IN. TRENCHES TO BE FILLED WITH GRANULAR MATERIAL AS SPECIFIED.
- DOWN PIPE LOCATIONS ARE INDICATIVE ONLY. LOCATIONS TO BE CONFIRMED WITH ARCHITECT PRIOR TO COMMENCEMENT OF WORK. - PROVIDE CLEANING EYES AND LEAF CATCHERS TO ALL DOWNPIPES
- ALL WORK TO BE IN ACCORDANCE WITH LOCAL COUNCIL STANDARDS AND SPECIFICATIONS.
- ALL LEVELS SHOWN ARE TO AHD
 ENSURE THAT ALL PITS AND STORMWATER PIPES ARE LOCATED CLEAR FROM TREE ROOT SYSTEMS.
- ALL EXISTING EARTHENWARE PIPES TO BE UPGRADED TO UPVC.
 ALL WORKS TO BE IN ACCORDANCE WITH AS 3500-2003 NATIONAL PLUMBING DRAINAGE CODE PART 3 STORMWATER DRAINAGE.
- SUB-SOIL DRAINS ARE TO BE INSTALLED IN ACCORDANCE WITH AS3500.3 ALONGSIDE WALLS THAT IMPEDE THE NATURAL FLOW OF GROUNDWATER. THIS MAY ALSO INVOLVE TRENCHING INTO THE CLAY
- EXISTING ROOF DRAINAGE AND SITE DRAINAGE SYSTEM TO BE CHECKED AND UPGRADED AS REQUIRED. BUILDER TO INSPECTION AND UPGRADE DRAINAGE IN ACCORDANCE WITH AS 3500.3 IF REQUIRED.

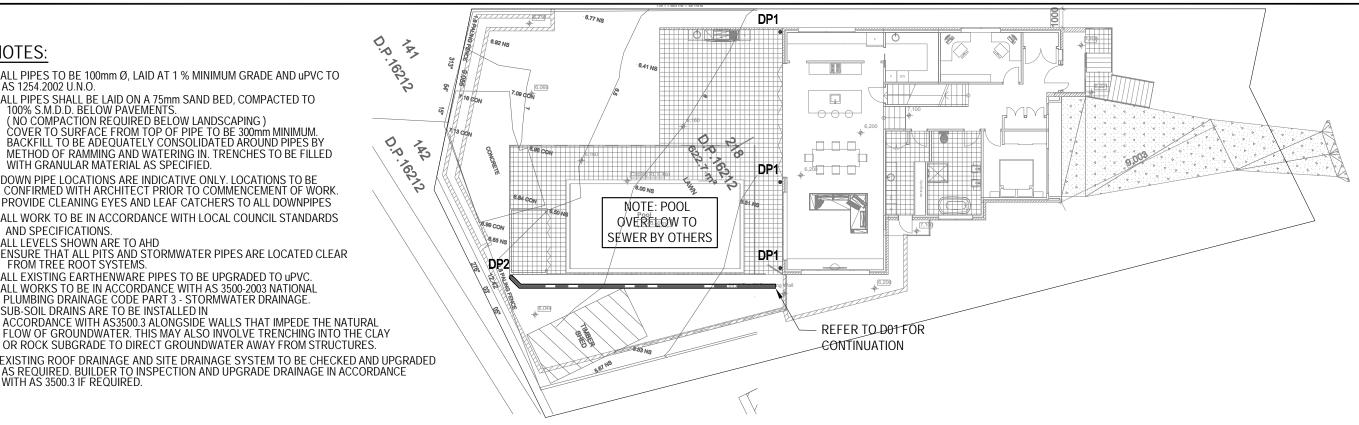


BOUNDARY 450 x 450 MAXI MESH SCREEN RH3030 & HANDLE **GRATE** 100 100 Ø uPVC INLET PIPE 4 4 **OUTLET PIPE** BIDIM A24 OR SIMILAR AT MIN 1% FALL GEOTEXTILE FILTER FABRIC Ø20mm WEEP BLUE METAL HOLES AT 200 CTS

PRECAST OR CAST INSITU PIT REFER STORMWATER NOTES ALTERNATIVE POLYPROPYLENE PIT BY MANUFACTURER

BOUNDARY PIT DETAIL SCALE = NTS

GROUND FLOOR DRAINAGE PLAN

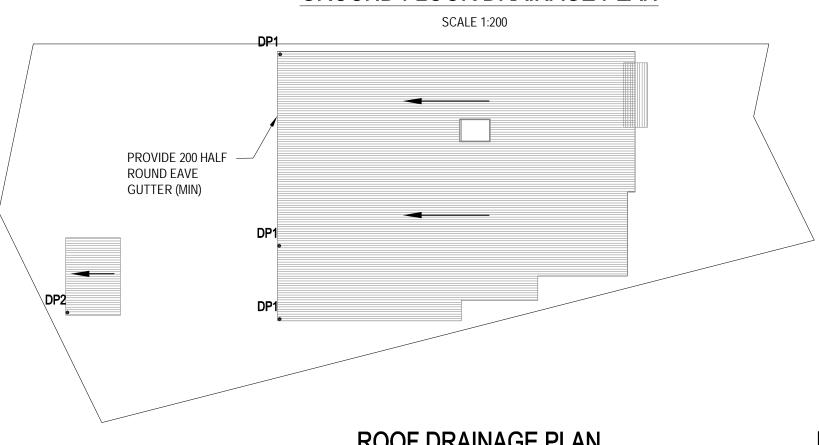

ROOF DRAINAGE PLAN

SCALE 1:200

ISSUE FOR DA

27/07/2019

1:200 Revision

Scale

			- BEEMAN
			Architect
			RAPID PLANS
-	ISSUED FOR DA SUBMISSION	27/07/19	9 RATIDI EANS
REVISION	AMENDMENT	DATE	

6	GREENWOOD CONSULTING ENGINEERS
2/2	25 Seabeach Avenue, Mona Vale

ABN - 90 625 916 341

63 GONDOLA ROAD	Drawn EG Checked	Designed EG Approved	
NORTH NARRABEEN	EG	EG	
Title	Drawing number		
FIRST FLOOR / LOWER ROOF PLAN		DO2	