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18/03/2019

Michal Korecky

TOTAL SITE AREA: 545.8m2

TO OSD TANK VOLUME:

 $545.8 \times 0.02 = 10.92 \text{m}$

RAIN WATER TANK - 5m3

REVISED OSD VOLUME: 10.92 - 5.0 = 5.92m³ REVISED OSD VOLUME: $10.92 - 5.0 = 5.92 \text{m}^3 + 20\% = 7.104 \text{m}^3$

= 2.1 l/s

= 3.0 l/s

= 3.6 l/s

0.59 | 0.6

67.8 | 75

75.4

76

71.6

SUPERINTENDENT OR DESIGN ENGINEER.

ALL WORK IS TO BE CARRIED OUT IN ACCORDANCE WITH THE DETAILS SHOWN ON THE DRAWINGS AND SPECIFICATION.

READ THESE PLANS IN CONJUNCTION WITH APPROVED ARCHITECTURAL, STRUCTURAL, HYDRAULIC AND MECHANICAL DRAWINGS AND SPECIFICATION.

ALL PLUMBING WITHIN THE SITE MUST BE CARRIED OUT IN ACCORDANCE WITH

THE CONTRACTOR MUST VERIFY ALL DIMENSIONS AND EXISTING LEVELS ON SITE

PRIOR TO COMMENCEMENT OF WORKS, REPORT ANY DISCREPANCIES TO THE

RELEVANT PROVISIONS OF AUSTRALIAN STANDARD AS/NZS 3500.3-2003

PLUMBING AND DRAINAGE - STORMWATER DRAINAGE.

DO NOT SCALE FROM THE DRAWINGS.

ALL LEVELS ARE TO AUSTRALIAN HEIGHT DATUM. (AHD)

WHERE NEW WORK ABUTS EXISTING, THE CONTRACTOR SHALL ENSURE THAT A SMOOTH EVEN PROFILE, FREE FROM ABRUPT CHANGES, IS OBTAINED.

TOPSOIL. (TOPSOIL DEPTH VARIES).

DESIGN LEVELS GIVEN ARE TO FINISHED SURFACE LEVEL AND INCLUSIVE OF

THE CONTRACTOR SHALL ARRANGE ALL SURVEY SETOUT TO BE CARRIED OUT BY A REGISTERED SURVEYOR.

CARE IS TO BE TAKEN WHEN EXCAVTING NEAR EXISTING SERVICES. NO MECHANICAL EXCAVATIONS ARE TO BE UNDERTAKEN OVER TELECOM OR

ELECTRICAL SERVICES. HAND EXCAVTE IN THESE AREAS. ALL BUILDING SURROUND SHOULD BE GRADED TO ENSURE OVERLAND FLOW

FROM UPSTRAM AREAS CAN DRAIN AROUND THE FOUNDATIONS, WALLS OF

ALL EXCAVTION SHORING OF EXCAVATION ANS STABILITY OF ADJACENT STRUCTURES SHALL BE THE RESPONSIBILITY OF THE CONTRACTOR.

CONDITION AND NO PART SHALL BE OVERSTRESSED.

DURING CONSTRUCTION, THE STRUCTURE SHALL BE MAINTAINED IN A STABLE

WORKMANSHIP AND MATERIALS SHALL CONFORM WITH THE REQUIREMENTS OF

THE RELEVANT SAA CODES, BCA REQUIREMENTS AND THE SPECIFICATION, BY-LAWS AND ORDINANCIES OF THE RELEVANT AUTHORITIES.

PROPRIETARY PRODUCTS USED SHALL BE INSTALLED TO MANUFACTURERS SPECIFICATION AND TO THE SATISFACTION OF THE SUPERINTENDENT.

EXTERNAL WORKS

GENERAL NOTES

ALL ACTIVITIES AND WORKS EXTERNAL TO THE SITE, OR THAT AFFECT PUBLIC ROADS, ARE TO BE CARRIED OUT IN ACCORDANCE WITH COUNCIL'S CODES AND STANDARDS.

PUBLIC FOOTPATHS SHALL BE RECONSTRUCTED TO THE SATISFACTION OF COUNCIL'S DIRECTOR OF ENGINEERING SERVICES. A ROAD OPENING PERMIT SHALL BE OBTAINED FOR ALL WORKS CARRIED OUT IN A PUBLIC OR COUNCIL CONTROLLED LAND. RESTORATION OF LANDSCAPING, ROADS AND PATHS SHALL BE TO COUNCIL'S REQUIREMENTS. ALL OTHER RESTORATION SHALL BE TOTHE SATISFACTION OF THE AFFECTED PARTIES.

WHERE WORKS ARE UNDERTAKEN ON PUBLIC ROADS. ADEQUATE TRAFFIC CONTROL AND DIRECTIONS TO MOTORISTS SHALL BE PROVIDED.

PITS DEEPER THAN 1200mm TO BE FITTED WITH STEP IRONS AT 300mm CENTRES AND STAGGERED.

APPROVED PRECAST PITS MAY BE USED.

DIAMETER 100mm HOLE FOR SUBSOIL DRAINAGE OUTLET TO BE LOCATED 100mm ABOVE INVERT OF ALL INLET PIPES. DIAMETER 100mm SUBSOIL DRAINAGE TO EXTEND FOR A DISTANCE OF 3.0m UPSTREAM OF PIT (AT EACH INLET PIT) WITH THE UPSTREAM END SEALED.

ALL CONNECTIONS TO THE EXISTING DRAINAGE PITS SHALL BE MADE IN A TRADESMAN LIKE MANNER AND THE INTERNAL WALLL OF THE PIT AT THE POINT OF ENTRY SHALL BE CEMENT RENDERED TO ENSURE A SMOOTH FINISH.

PIT GRATES AND SOLID COVERS SHALL BE CLASS 'B' IN NON TRAFFIC AREAS AND CLASS 'D' IN TRAFFIC AREAS IN ACCORDANCE WITH

EXISTING PIPES WHICH FORM NO PART OF THE DRAINAGE SYSTEM SHALL BE REMOVED OR SANDFILLED AS INDICATED ON THE PLANS.

PIPE LENGTHS MEASURED ARE BETWEEN PIT CENTRES.

ALL DRAINAGE PIPES LESS THAN 300mm DIAMETER SHALL BE SEWER GRADE upvc with solvent welded joints (U.N.O.). All pipe junctions and TAPERS SHALL BE VIA. PURPOSE MADE FITTINGS.

MINIMUM GRADE TO DRAINAGE PIPES TO BE 1.5% U.N.O.

MINIMUM PIPE SIZE TO BE 100mm DIAMETER U.N.O.

THE CONTRACTOR IS TO SUPPLY AND INSTALL ALL FITTINGS AND SPECIALS INCLUDING VARIOUS PIPE ADAPTORS TO ENSURE PROPER CONNECTION BETWEEN DISSIMILAR PIPEWORK.

RAINWATER RE—USE NOTES AND SPECIFICATIONS ROOF WATER ONLY TO BE DRAINED TO THE RAINWATER STORAGE TANKS.

The rainwater storage tanks are to be connected for Re-use as required by the basix certificate.

RAINWATER STORAGE TANKS TO BE CONFIGURED IN ACCORDANCE WITH SYDNEY WATER SPECIFICATIONS 'GUIDELINES FOR RAINWATER TANKS ON RESIDENTIAL

PROVIDE MAINS 'TOP-UP' SUPPLY TO RAINWATER TANKS. MAINS TOP-UP ZONE TO BE BASED ON THE DAILY NON-POTABLE USAGE THAT MAY BE EXPECTED FROM THE TANK.

PROVIDE A MECHANICAL PUMPING ARRANGEMENT (IN SOUND-PROOF HOUSING) TO PUMP SUPPLIERS SPECIFICATION TO SUIT INTENDED USAGE OF RAINWATER STORAGE. PUMPING ARRANGEMENTS MUST COMPLY WITH EPA GUIDELINES.

INLETS TO RAINWATER TANKS MUST BE SCREENED TO PREVENT THE ENTRY OF FOREIGN MATTER,

A SIGN MUST BE AFFIXED TO THE RAINWATER TANKS AND HOSE TAPS AS PER AS3500.1 CLEARLY STATING THAT THE WATER IN THE TANK IS RAINWATER AND IS NOT TO BE USED FOR

'FIRST FLUSH' DEVICE TO BE PROVIDED TO EACH DOWNPIPE OR IF PREFERRED A SINGLE DEVICE TO BE PROVIDED ON THE UPSTREAM SIDE OF STORAGE TANK FOR EACH PIPED INLET TO STORAGE TANK. A SINGLE FIRST FLUSH DEVICE MAY BE PROVIDED IN LIEU OF EACH

RAINWATER TANKS TO BE PLACED ON A STRUCTURALLY ADEQUATE BASE IN ACCORDANCE WITH THE MANUFACTURER'S OR STRUCTURAL ENGINEER'S DETAILS.

THE TANK MUST NOT BE INSTALLED OVER ANY MAINTENANCE STRUCTURE OR FITTINGS USED BY A PUBLIC AUTHORITY.

RAINWATER TANKS AND ASSOCIATED PLUMBING WORKS TO BE INSTALLED AND CONFIGURED BY A LICENSED PLUMBER. PUMP TO BE INSTALLED BY A LICENSED ELECTRICIAN.


SCALE: AS NOTED DRAWN: MK ISSUE: DRAWING Nr

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COLLAROY NSW 2097 CLIENT: BRENDAN & SIMONE WAIGHTS



ROOF PLAN 1:100

LEGEND

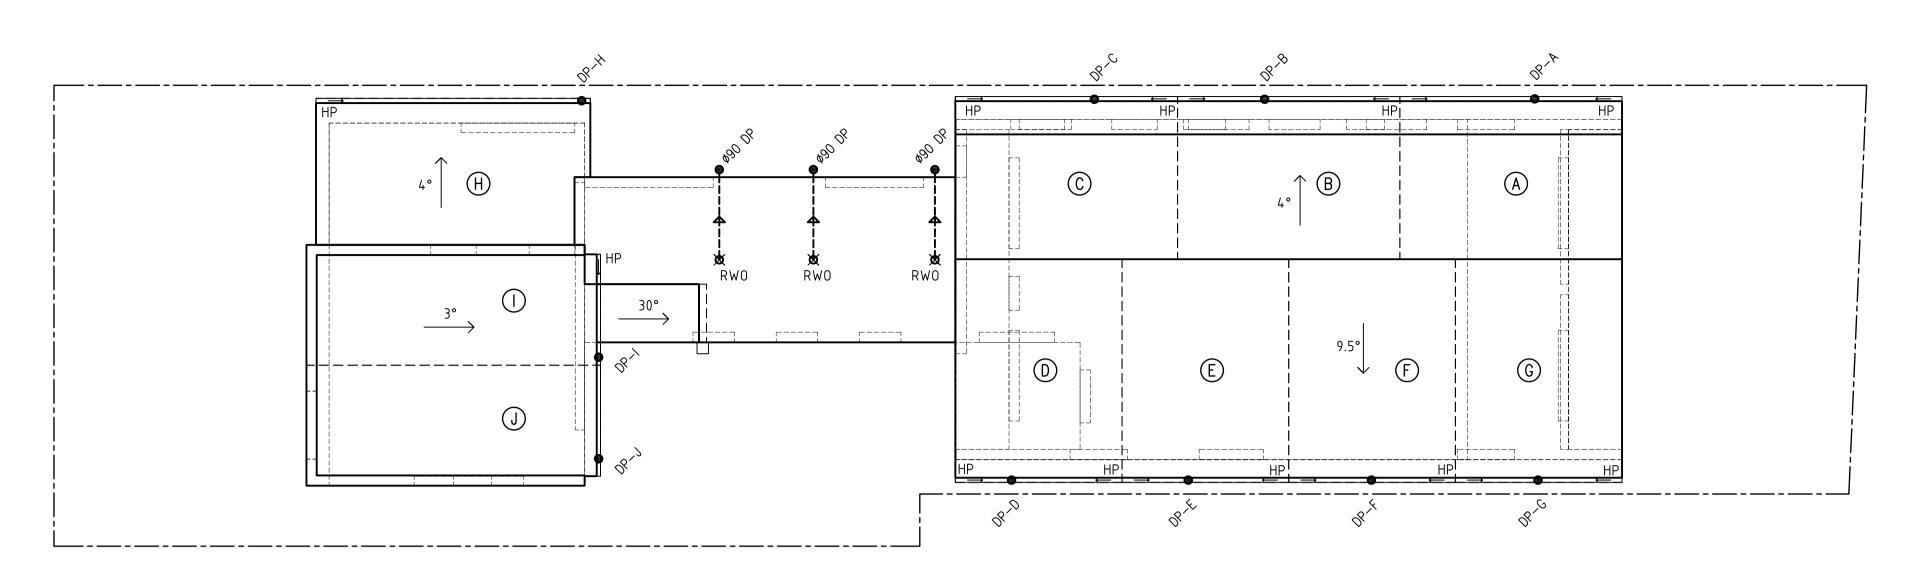DOWN PIPE HIGH POINT RAIN WATER OUTLET = RWO

SUBCATCHMENT AREAS FOR GUTTERS & DOWNPIPES (ARI 20 YEARS)					
VERTICAL DOWNPIPE	SUB-CATCHMENT				
	PLAN AREA (m2)	CATCHMENT AREA (m2)	MIN. EFFECTIVE GUTTER CROSS—SECT. AREA (mm2)	DP CROSS-SECT.	
А	25.3	26.1	6600	Ø90	
В	25.3	26.1	6600	ø90	
С	25.3	26.1	6600	ø90	
D	26.1	28.5	6600	ø90	
Е	26.1	28.5	6600	ø90	
F	26.1	28.5	6600	ø90	
G	26.1	28.5	6600	ø90	
Н	27.4	28.2	6600	ø90	
ı	24.7	25.5	6600	ø90	
J	24.7	25.5	6600	ø90	


ISSUED FOR DEVELOPMENT APPLICATION ONLY

EAVES GUTTER SPECIFICATION.

EAVES GUTTER GRADIENTS TO BE 1:500 OR GREATER. EAVES GUTTER TO HAVE AN EFFECTIVE CROSS SECTIONAL AREA AS PER TABLE ABOVE.

DOWNPIPES CROSS-SECTION TO BE AS PER TABLE ABOVE.

FASCIA TO BE A MINIMUM OF 14mm ABOVE GUTTER OVERFLOW.

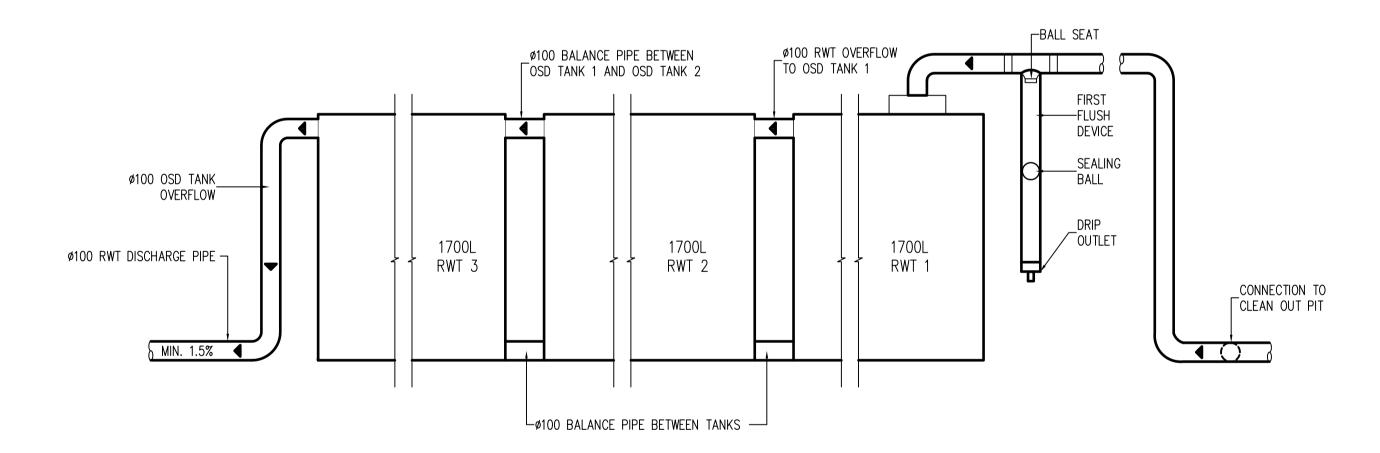

RAIN WATER TANKS SECTION (TYPICAL)

PROVIDE A MECHANICAL PUMPING ARRANGEMENT (IN SOUND-PROOF HOUSING) TO PUMP SUPPLIERS SPECIFICATION TO SUIT INTENDED USAGE OF RAINWATER STORAGE. PUMPING ARRANGEMENTS MUST COMPLY WITH EPA GUIDELINES.

GENERAL NOTES

ALL PLUMBING WITHIN THE SITE MUST BE CARRIED OUT IN ACCORDANCE WITH RELEVANT PROVISIONS OF AUSTRALIAN STANDARD AS/NZS 3500.3-2003

THE CONTRACTOR MUST VERIFY ALL DIMENSIONS AND EXISTING LEVELS ON SITE PRIOR TO COMMENCEMENT OF WORKS, REPORT ANY DISCREPANCIES TO THE

ALL WORK IS TO BE CARRIED OUT IN ACCORDANCE WITH THE DETAILS SHOWN

READ THESE PLANS IN CONJUNCTION WITH APPROVED ARCHITECTURAL,

SMOOTH EVEN PROFILE, FREE FROM ABRUPT CHANGES, IS OBTAINED.

CARE IS TO BE TAKEN WHEN EXCAVTING NEAR EXISTING SERVICES. NO MECHANICAL EXCAVATIONS ARE TO BE UNDERTAKEN OVER TELECOM OR

ELECTRICAL SERVICES. HAND EXCAVTE IN THESE AREAS.

CONDITION AND NO PART SHALL BE OVERSTRESSED.

BY-LAWS AND ORDINANCIES OF THE RELEVANT AUTHORITIES.

STRUCTURAL, HYDRAULIC AND MECHANICAL DRAWINGS AND SPECIFICATION.

WHERE NEW WORK ABUTS EXISTING, THE CONTRACTOR SHALL ENSURE THAT A

DESIGN LEVELS GIVEN ARE TO FINISHED SURFACE LEVEL AND INCLUSIVE OF

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ALL BUILDING SURROUND SHOULD BE GRADED TO ENSURE OVERLAND FLOW FROM UPSTRAM AREAS CAN DRAIN AROUND THE FOUNDATIONS, WALLS OF

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DURING CONSTRUCTION, THE STRUCTURE SHALL BE MAINTAINED IN A STABLE

WORKMANSHIP AND MATERIALS SHALL CONFORM WITH THE REQUIREMENTS OF THE RELEVANT SAA CODES, BCA REQUIREMENTS AND THE SPECIFICATION,

PROPRIETARY PRODUCTS USED SHALL BE INSTALLED TO MANUFACTURERS SPECIFICATION AND TO THE SATISFACTION OF THE SUPERINTENDENT.

ALL ACTIVITIES AND WORKS EXTERNAL TO THE SITE, OR THAT AFFECT PUBLIC ROADS, ARE TO BE CARRIED OUT IN ACCORDANCE WITH COUNCIL'S

PUBLIC FOOTPATHS SHALL BE RECONSTRUCTED TO THE SATISFACTION OF COUNCIL'S DIRECTOR OF ENGINEERING SERVICES. A ROAD OPENING

PATHS SHALL BE TO COUNCIL'S REQUIREMENTS. ALL OTHER RESTORATION

WHERE WORKS ARE UNDERTAKEN ON PUBLIC ROADS, ADEQUATE TRAFFIC

PITS DEEPER THAN 1200mm TO BE FITTED WITH STEP IRONS AT 300mm

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SHALL BE TOTHE SATISFACTION OF THE AFFECTED PARTIES.

CONTROL AND DIRECTIONS TO MOTORISTS SHALL BE PROVIDED.

PERMIT SHALL BE OBTAINED FOR ALL WORKS CARRIED OUT IN A PUBLIC OR COUNCIL CONTROLLED LAND. RESTORATION OF LANDSCAPING, ROADS AND

STRUCTURES SHALL BE THE RESPONSIBILITY OF THE CONTRACTOR.

PLUMBING AND DRAINAGE - STORMWATER DRAINAGE.

DO NOT SCALE FROM THE DRAWINGS.

SUPERINTENDENT OR DESIGN ENGINEER.

ON THE DRAWINGS AND SPECIFICATION.

TOPSOIL. (TOPSOIL DEPTH VARIES).

BY A REGISTERED SURVEYOR.

EXTERNAL WORKS

CODES AND STANDARDS.

CENTRES AND STAGGERED.

APPROVED PRECAST PITS MAY BE USED.

(AT EACH INLET PIT) WITH THE UPSTREAM END SEALED.

AND CLASS 'D' IN TRAFFIC AREAS IN ACCORDANCE WITH

REMOVED OR SANDFILLED AS INDICATED ON THE PLANS.

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TAPERS SHALL BE VIA. PURPOSE MADE FITTINGS.

MINIMUM GRADE TO DRAINAGE PIPES TO BE 1.5% U.N.O.

RAINWATER RE—USE NOTES AND SPECIFICATIONS
ROOF WATER ONLY TO BE DRAINED TO THE RAINWATER STORAGE TANKS.

THE RAINWATER STORAGE TANKS ARE TO BE CONNECTED FOR RE-USE

RAINWATER STORAGE TANKS TO BE CONFIGURED IN ACCORDANCE WITH SYDNEY WATER SPECIFICATIONS 'GUIDELINES FOR RAINWATER TANKS ON RESIDENTIAL

MINIMUM PIPE SIZE TO BE 100mm DIAMETER U.N.O.

DISSIMILAR PIPEWORK.

AS REQUIRED BY THE BASIX CERTIFICATE.

ALL LEVELS ARE TO AUSTRALIAN HEIGHT DATUM. (AHD)

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RAINWATER TANKS AND ASSOCIATED PLUMBING WORKS TO BE INSTALLED AND

CONFIGURED BY A LICENSED PLUMBER. PUMP TO BE INSTALLED BY A LICENSED ELECTRICIAN.

DOCUMENT	CERTIFICATION

Michal Korecky

I AM A QUALIFIED CIVIL ENGINEER. I HOLD THE FOLLOWING QUALIFICATIONS: MEngSc (Civil) MIEAUST.
I HEREBY STATE THAT THESE PLANS OR DETAILS COMPLY WITH THE CONDITIONS OF DEVELOPMENT CONSENT, THE PROVISIONS OF THE BUILDING CODE OF AUSTRALIA AND/OR PELEVANT AUSTRALIAN INDUSTRY STANDARDS. DATE: 18/03/2019

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DRAWING Nr : 18040	SHEET: SW-2
DRAWN: MK	ISSUE: 1
DATE: 18/03/19	SCALE: AS NOTED