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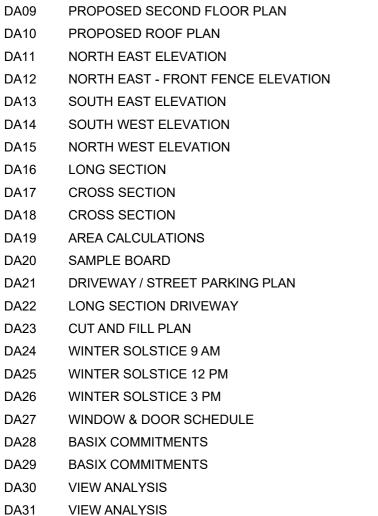
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PLANS PUBLISHED 05 June 2025

DEVELOPMENT APPLICATION

These plans are for Council Approval only.

NO.	DRAWING NAME
DA00	COVER
DA01	NOTATION
DA02	SAFTEY NOTES
DA03	SUB-DIVISION PLAN
DA04	SITE ANALYSIS
DA05	SITE / SEDIMENT EROSION / WASTE MANAGEMENT
DA06	PROPOSED BASEMENT FLOOR PLAN
DA07	PROPOSED GROUND FLOOR PLAN
DA08	PROPOSED FIRST FLOOR PLAN
DA09	PROPOSED SECOND FLOOR PLAN
DA10	PROPOSED ROOF PLAN
DA11	NORTH EAST ELEVATION
DA12	NORTH EAST - FRONT FENCE ELEVATION
DA13	SOUTH EAST ELEVATION
DA14	SOUTH WEST ELEVATION
D 4 4 5	NODILL MEGT ELEVATION





Star rating

7.1

HOUSE





35 Moore road, Freshwater, NSW 2096



SITE INFORMATION	
ADDRESS	35 Moore Road, Freshwater NSW 2096
LOT	15/1/DP7022
AREA	385.2m ²

WARRINGAH LOCAL ENVIRO	ONMENTAL PLAN 2011 CONTROLS	
	CONTROL	COMPLIANCE
ZONING	R2: LOW DENSITY RESIDENTIAL	YES*
		State Environmental Planning Policy (Housing)
		2021 overrules this LEP, allowing dual
		occupancies to be constructed on land zoned R2
BUILDING HEIGHT	8.5m	
MINIMUM LOT SIZE	450m	NO: Torrens title subdivision
		YES: Strata subdivision
LANDSLIDE RISK LAND	AREA A – SLOPES <5	Geotechnical report not required.
	AREA B - FLANKING SLOPES 5 TO 25	

WARRINGAH DEVELOPMENT CO	ONTROL PLAN 2011	
	CONTROL	COMPLIANCE
FRONT SETBACK	6.5m	NO
SIDE SETBACK	0.9m	YES
REAR SETBACK	6.5m	YES
SIDE BOUNDARY ENVELOPE	5m	YES
MAXIMUM WALL HEIGHT	7.2m	YES
MINIMUM LANDSCAPED AREA	40% OF SITE AREA = 154.08m ² or 77.04m ² per lot	YES
MINIMUM PARKING SPACES	2 per lot	YES

IMPORTANT NOTATION FOR BUILDERS

- All dimensions are to be confirmed on-site by the builder/subcontractor, any incongruencies must be reported to the Designer in writing before the commencement of any work.
- No Survey has been made on the boundaries. All bearings, distances, and areas have been taken from the contour survey plan. A Survey must be carried out to confirm the exact boundary locations.
- No construction work shall commence until a site survey confirming the site boundaries has been completed. The contractor is to ensure that the approved boundary setbacks are confirmed and used, the boundary setbacks take precedence over all other dimensions. The Survey work must be performed by a registered Surveyor. - In the event of encountering any discrepancies on these drawings, specification, or subsequent instructions issued,
- the Builder/Subcontractor shall contact the designer in writing before proceeding further with any work. The builder/subcontractor is responsible to ensure that all materials installed on-site are fit for purpose and comply with
- the NCC and relevant Australian Standards. The builder is to obtain written confirmation of material selection by the Client prior to ordering.
- All construction, control joints, and expansion joints in the walls, floors, and other locations shall be in strict accordance with the structural engineering details. No joints or breaks other than specified are allowed without written permission from the Engineer
- Measurements for the fabrication of secondary components such as windows, doors, internal frames, structural steel components, and the like, are not to be taken from these documents. Measurements must be taken on-site to suit the work as constructed
- All structural components shall be in strict accordance with details and specifications as prepared by a suitably qualified structural engineer.
- All existing structures need to be examined for structural adequacy, and it is the Contractor's responsibility to ensure that a certificate of structural adequacy is available prior to the start of any work.

SPECIFICATION

- "Approval" obtained by either an 'Accredited Certifying Authority' or 'Local Council'
- The Owner will directly pay all fees associated with the following:
- Building approval from council or accredited certifier, any footpath and kerb deposits with the local council, insurance fees to Building Services Corporation, Long Service Leave levy fees and approval fees by water and sewerage authority. All other fees are to be paid by the builder. The amount of any local authority deposits which are forfeited due to damage or other causes, will be deducted from payments due to the builder.
- -The Builder is to provide at his/her own expense adequate Public Risk Insurance and arrange indemnification under the Workers Compensation Act. Works insurance to be as stated in the contract conditions
- All tenderers are to visit the site to satisfy themselves as to the nature and extent of the Works, facilities available and difficulties entailed in the works as Variations will not be allowed due to work arising owing to neglect of this clause.
- These drawings shall be read in conjunction with all structural and other consultant's drawings and specifications and with any such written instructions as may be issued during the course of the contract.
- Set out dimensions shown on this drawing shall be verified by the builder on site before commencement of any work.
- Dimensions shall not be obtained by scaling the drawings, use figured dimensions. All dimensions are in millimetres. - The Builder is to ensure all construction, levels and other items comply with the conditions of the Building Approval.
- Any detailing additional to that which is supplied shall be resolved between the Owner and the Builder, to the Owner's approval. Except for any structural details or design, which is to be supplied by the Engineer.
- All work to be carried out in a tradesman like manner and in accordance with the standards, codes and regulations of Standards Australia, the National Construction Code and any statutory authority having jurisdiction over the works. - All structural work is to be in accordance with the structural details prepared by a suitably qualified structural engineer, including but not limited to all piers, footings, concrete slabs, retaining walls, steelworks, formwork, underpinning additional structural loads, timber framing, wind bracing and associated connections. Builder to obtain prior to finalising the tender, unless previously obtained by owners.
- All brickwork is to be selected by the Owner, and is to comply with AS 1640.
- All masonry is to comply with AS 3700.

is more than 4m

- Provide all metalwork and flashings necessary to satisfactorily complete the works.
- All timber construction to be in accordance with AS 1684 Residential timber-framed construction. Level and grade where necessary under timber floors to provide a minimum clearance of 300mm under bearers or 400mm under joists. Adequate precautions shall be taken to ensure that the surface and/or seepage water does not collect or remain under
- Sustainable timbers, and not rainforest or old growth timber will be used. Recycled timber or second hand timbers are to be sourced and used in preference to plantation timbers, if available and suitable
- All glazing installation is to comply with AS 1288, AS 2047 and in accordance with manufacturers recommendations. - All wall and ceiling linings in wet areas to be plasterboard and villaboard, or equal. A breathable wall wrap is to be provided to all external walls. Timber cladding is to be battened out from timber frame to provide an 'air' gap to prevent condensation. Workmanship is to comply with the relevant Australian Standards or installed in accordance with manufacturer's specifications. All bathrooms and wet areas to be waterproofed with a flexible membrane to manufacturer's specifications and to AS 3740, Part H4D2 and Section 10; Part 10.2 of the 2022 NCC.
- All Architraves and skirtings to the profile as selected by owner, and painted or stain finish as selected
- All plumbing and drainage work to be installed and completed by a licensed tradesman and in accordance with the statutory body having authority over the works. Connect all waste to Sydney Water sewer line
- Connect all stormwater to existing system or street drainage system in accordance with AS 3500, Part H2D2 and Section 3: Part 3.3 of the 2022 NCC.
- Smoke detector alarms are to be installed in accordance with AS 3786, Part H3D6 and Section 9; Part 9.5 of the 2022
- If a member which provides structural support to the works is subject to termite attack, management measures are to comply with AS 3660 and Section 3; Part 3.4 of the 2022 NCC. Termite management system to be installed to manufacturer's specifications.
- Stairs and Balustrades to comply with Part H5D2, H5D3 and Section 11; Part 11.2 and 11.3 of the 2022 NCC. Provide a handrail along the full length of the flight and a slip resistant finish to the edge of the nosings to comply with 3.9.1 and 3.9.2 of the NCC. No horizontal elements to facilitate climbing between 150mm and 760mm where floor to level below
- Electrical works to be in accordance with SAA wiring rules and be done by a licenced tradesperson. Obtain electrical layout prior to proceeding. All electrical power (GPO's) and light outlets to be determined by the Owner
- Painting: All paints or other coatings shall be of the best quality materials & of approved manufacture. All priming materials shall be of an approved brand acceptable to the manufacturer of the finishing coats to be used. External iginery intended to be painted shall be primed on all faces at the place of assembly. Where new work or alteration work adjoins existing painted surfaces allow for repainting existing surfaces to provide uniform appearance.
- ZERO-VOC or LOW-VOC paints and primers only are to be used.
- Any work indicated on the plans but not specified and any item not shown on the plans which is obviously necessary as part of proper construction and/or finish, is to be considered as shown and specified and is to be undertaken as part of the contract. Variations will not be permitted without prior written approval by the owners
- The Builder shall provide sediment and siltration control measures as required by Council, and maintain them throughout the duration of the works
- A legible copy of the plans bearing approval stamps, must be maintained on the job site at all times. Hours of construction shall be restricted to the times as required by the building approval.
- The Builder is to arrange for all inspections required by the relevant authorities and/or lending institutions, to their

- The Builder is to obtain approval for interruptions to existing services and minimise the duration and number of interruptions. Any interruptions to existing services and equipment is to be undertaken by appropriately qualified tradespersons
- The Builder shall restore, reinstate or replace any damage to existing structures or landscaping caused by the
- Provide protection to existing trees to remain, or as required by the Approval Conditions.

GENERAL NOTATION

- Approved means by the 'relevant local authority' or council?
- All work and materials to comply with the current Australian standards at the time of commencement, where
- The builder is to comply with all ordinances, local authority regulations and the requirements of all services supply authorities having jurisdiction over the works.
- All new downpipes are to be connected to the existing stormwater system.
- All timber sizes and concrete details to be confirmed by the builder prior to commencement of any work
- All gutters, downpipes to be colorbond.
- All wall and ceiling linings to be plasterboard or cement render as selected, and villa board in wet areas. To comply with relevant Australian standards, and installed in accordance with manufacturers specification

NCC 2022 & AS COMPLIANCES SPECIFICATIONS

- Structure Part H1 & Section 2 of NCC
- Structural Provisions PART H1D2 & PART 2.2 of NCC
- Site Preparation Part H1D3 & Section 3 of NCC
- Earthworks Part 3.2 of NCC Drainage - Part 3.3 of NCC
- Termite Risk Management Part 3.4 of NCC
- Footings & Slabs Part H1D4 & Section 4 of NCC
- Footings, Slabs & Associated Elements Part 4.2 of NCC
- Masonry Part H1D5 & Section 5 of NCC
- Masonry Veneer Part 5.2 of NCC
- Cavity Masonry Part 5.3 of NCC
- Unreinforced Single Leaf Masonry Part 5 4 of NCC
- Isolated Piers Part 5.5 of NCC
- Masonry Components & Accessories Part 5.6 of NCC
- Waetherproofing of Masonry Part 5.7 of NCC
- Framing Part H1D6 & Section 6 of NCC
- Sub Floor Ventilation Part 6.2 of NCC
- Structural Steel Members Part 6.3 of NCC
- Roof & Wall Cladding Part H1D7 & Section 7 of NCC
- Sheet Roofing Part 7.2 of NCC
- Roof Tiles & Shingles Part 7.3 of NCC - Gutters & Downpipes - Part 7.4 of NCC
- Timber & Composite Wall Cladding Part 7.5 of NCC
- Glazing Part H1D8 & Section 8 of NCC
- Windows & External Glazed Doors Part 8.2 of NCC
- Glass Part 8.3 of NCC
- Glazing Human Impact Part 8.4 of NCC
- Damp & Weatherproofing Part H2 of NCC
- Fire Safety Part H3 & Section 9 of NCC
- Fire Separation of External Walls Part 9.2 of NCC - Fire Protection of Separating Walls & Floors - Part 9.3 of NCC
- Fire Protection of Garage Top Dwellings Part 9.4 of NCC
- Smoke Alarms & Evacuation Lighting Part 9.5 of NCC
- Health & Amenity Part H4 & Section 10 of NCC
- Wet Area Waterproofing Part 10.2 of NCC
- Room Heights Part 10.3 of NCC
- Facilities Part 10.4 of NCC
- Light Part 10.5 of NCC
- Ventilation Part 10.6 of NCC
- Sound Insulation Part 10.7 of NCC
- Condensation Management Part 10.8 of NCC
- Safe Movement & Access Part H5 & Section 11 of NCC - Stairway & Ramp Construction - Part 11.2 of NCC
- Barriers & Handrails Part 11.3 of NCC
- Ancillary Provisions Part H7 & Section 12 of NCC
- Construction in Alpine Areas Part 12.2 of NCC
- Attachment of Framed Decks & Balconies to External Walls of Buildings Using a Waling Plate Part 12.3 of NCC Heating Appliances, Fireplaces, Chimneys & Flues - Part 12.4 of NCC
- Swimming Pools Part H7P1 & NSW H7D2 of NCC
- Construction in Bushfire Prone Areas Part NSW H7D4 of NCC - Energy Efficiency - Part H6 & Section 13 of NCC
- Building Fabric Part 13.2 of NCC
- External Glazing Part 13.3 of NCC
- Building Sealing Part 13.4 of NCC - Ceiling Fans - Part 13.5 of NCC
- Whole of Home Energy Usage Part 13.6 of NCC
- Services Part 13.7 of NCC

- Pool Fencing & other provisions Regulations & AS 1926
- Demolition Works to comply with AS 2601-2001 The Demolition of Structures.
- Waterproofing of Wet Areas to comply with AS 3740:2021
- All plumbing & drainage work to comply with AS 3500:2021
- All plasterboard work to comply with AS 2588:2018
- All structural steel work to comply with AS 4100:2020 & AS 1554.1:2014
- All concrete work to comply with AS 3600:2018
- All roof sheeting work to comply with AS 1562.1:2018
- All skylights to comply with AS 4285:2019 - All ceramic tiling to comply with AS 3958.1-2007 & 3958.2-1992
- All glazing assemblies to comply with AS 2047-2014 & AS 1288:2021
- All timber retaining walls to comply with AS 1720, AS 1170
- All retaining walls to comply with AS 3700:2018 & AS 3600:2018 - All construction in bushfire-prone areas to comply with AS 3959:2018



THIS SET OF DRAWING SHOULD BE READ & KEPT IN ITS ENTIRETY. NO INDIVIDUAL PAGE SHOULD BE SEPARATED FROM THE REST OF THE SET. EACH NOTATION LISTED ON THIS PAGE APPLY TO ALL PAGES OF THIS SET.

SAFTEY NOTES

THESE NOTES MUST BE READ AND UNDERSTOOD BY ALL INVOLVED IN THE PROJECT. THIS INCLUDES (but is not excluded to): OWNER, BUILDER, SUB-CONTRACTORS, CONSULTANTS, RENOVATORS, OPERATORS, MAINTENORS, DEMOLISHERS.

1. FALLS, SLIPS, TRIPS

a) WORKING AT HEIGHTS

DURING CONSTRUCTION

Wherever possible, components for this building should be prefabricated off-site or at ground level to minimise the risk of workers falling more than two metres. However, construction of this building will require workers to be working at heights where a fall in excess of two metres is possible and injury is likely to result from such a fall. The builder should provide a suitable barrier wherever a person is required to work in a situation where falling more than two metres is a possibility.

DURING OPERATION OR MAINTENANCE

For houses or other low-rise buildings where scaffolding is appropriate: Cleaning and maintenance of windows, walls, roof or other components of this building will require persons to be situated where a fall from a height in excess of two metres is possible. Where this type of activity is required, scaffolding, ladders or trestles should be used in accordance with relevant codes of practice, regulations or legislation. For buildings where scaffold, ladders, trestles are not appropriate: Cleaning and maintenance of windows, walls, roof or other components of this building will require persons to be situated where a fall from a height in excess of two metres is possible. Where this type of activity is required, scaffolding, fall barriers or Personal Protective Equipment (PPE) should be used in accordance with relevant codes of practice, regulations or legislation.

b) SLIPPERY OR UNEVEN SURFACES

FLOOR FINISHES Specified

If finishes have been specified by designer, these have been selected to minimise the risk of floors and paved areas becoming slippery when wet or when walked on with wet shoes/ feet. Any changes to the specified finish should be made in consultation with the designer or, if this is not practical, surfaces with an equivalent or better slip resistance should be chosen.

FLOOR FINISHES By Owner

If designer has not been involved in the selection of surface finishes. the owner is responsible for the selection of surface finishes in the pedestrian trafficable areas of this building. Surfaces should be selected in accordance with AS HB 197:1999 and AS/ NZ 4586:2004.

STEPS, LOOSE OBJECTS AND UNEVEN SURFACES

Due to design restrictions for this building, steps and/ or ramps are included in the building which may be a hazard to workers carrying objects or otherwise occupied. Steps should be clearly marked with both visual and tactile warning during construction, maintenance, demolition and at all times when the building operates as a workplace. Building owners and occupiers should monitor the pedestrian access ways and in particular access to areas where maintenance is routinely carried out to ensure that surfaces have not moved or cracked so that they become uneven and present a trip hazard. Spills, loose material, stray objects or any other matter that may cause a slip or trip hazard should be cleaned or removed from access ways. Contractors should be required to maintain a tidy work site during construction, maintenance or demolition to reduce the risk of trips and falls in the workplace. Materials for construction or maintenance should be stored in designated areas away from access ways and work areas.

2. FALLING OBJECTS

LOOSE MATERIALS OR SMALL OBJECTS

Construction, maintenance or demolition work on or around this building is likely to involve persons working above ground level or above floor levels. Where this occurs one or more of the following measures should be token to ovoid objects falling from the area where the work is being carried out onto persons below.

- 1. Prevent or restrict access to areas below where the work is
- being carried out.
- 2. Provide toeboards to scaffolding or work platforms.
- 3. Provide protective structure below the work area
- 4. Ensure that all persons below the work area have Personal

Protective Equipment (PPE).

BUILDING COMPONENTS

During construction, renovation or demolition of this building, parts of the structure including fabricated steelwork, heavy panels and many other components will remain standing prior to or after supporting parts are in place. Contractors should ensure that temporary bracing or other required support is in place at all times when collapse which may injure persons in the area is a possibility. Mechanical lifting of materials and components during construction, maintenance or demolition presents a risk of falling objects. Contractors should ensure that appropriate lifting devices are used, that loads are properly secured and that access to areas below the load is prevented or restricted.

3. TRAFFIC MANAGEMENT

For building on a major road, narrow road or steeply sloping road: Parking of vehicles or loading/ unloading of vehicles on this roadway may cause a traffic hazard. During construction, maintenance or demolition of this building designated parking for workers and loading areas should be provided. Trained traffic management personnel should be responsible for the supervision of these areas. For building where on-site loading/ unloading is restricted: Construction of this building will require loading and unloading of materials on the roadway. Deliveries should be well planned to ovoid congestion of loading areas and trained traffic management personnel should be used to supervise loading/ unloading areas. For all buildings: Busy construction and demolition sites present a risk of collision where deliveries and other traffic are moving within the site. A traffic management plan supervised by trained traffic management personnel should be adopted for the work site.

4. SERVICES

GENERAL

Rupture of services during excavation or other activity creates a variety of risks including release of hazardous material. Existing services are located on or around this site. Where known, these ore identified on the plans but the excel location and extent of services may vary from that indicated. Services should be located using on appropriate service (such as Dial Before You Dig), appropriate excavation practice should be used and, where necessary, specialist contractors should be used. Locations with underground power: Underground power lines MAY be located in or around this site. All underground power lines must be disconnected or carefully located and adequate warning signs used prior to any construction, maintenance or demolition commencing. Locations with overhead power lines: Overhead power lines MAY be near or on this site. These pose a risk of electrocution if struck or approached by lifting devices or other plant and persons working above ground level. Where there is a danger of this occurring, power lines should be, where practical, disconnected or relocated. Where this is not practical adequate warning in the form of bright coloured tape or signage should be used or a protective barrier provided.

5. MANUAL TASKS

Components within this design with a moss in excess of 25kg should be lifted by two or more workers or by mechanical lifting device. Where this is not practical, suppliers or fabricators should be required to limit the component mass. All material packaging, building and maintenance components should clearly show the total moss of packages and where practical all items should be stored on site in a way which minimises bending before lifting. Advice should be provided on safe lifting methods in all areas where lifting may occur. Construction, maintenance and demolition of this building will require the use of portable tools and equipment. These should be fully maintained in accordance with manufacturer's specifications and not used where faulty or (in the case of electrical equipment) not carrying a current electrical safety tag. All safety guards or devices should be regularly checked and Personal Protective Equipment should be used in accordance with manufacturer's specification.

6. HAZARDOUS SUBSTANCES

ASBESTOS

For alterations to a building constructed prior to 1990: If this existing building was constructed prior to:

1990 - it therefore may contain asbestos

1986 - it therefore is likely to contain asbestos

either in cladding material or in fire retardant insulation material. In either case, the builder should check and, if necessary, take appropriate action before demolishing, culling, sanding, drilling or otherwise disturbing the existing structure

POWDERED MATERIALS

Many materials used in the construction of this building con cause harm if inhaled in powdered form. Persons working on or in the building during construction, operational maintenance or demolition should ensure good ventilation and wear Personal Protective Equipment including protection against inhalation while using powdered material or when sanding, drilling, cutting or otherwise disturbing or creating powdered material.

TREATED TIMBER

The design of this building may include provision for the inclusion of treated limber within the structure. Dust or furnes from this material can be harmful. Persons working on or in the building during construction, operational maintenance or demolition should ensure good ventilation and wear Personal Protective Equipment including protection against inhalation of harmful material when sanding, drilling, cutting or using treated timber in any way that may cause harmful material to be released. Do not burn treated timber.

VOLATILE ORGANIC COMPOUNDS

Many types of glue, solvents, spray packs, paints, varnishes and some cleaning materials and disinfectants have dangerous emissions. Areas where these are used should be kept well ventilated while the material is being used and for a period after installation. Personal Protective Equipment may also be required. The manufacturer's recommendations for use must be carefully considered at all times.

SYNTHETIC MINERAL FIBRE

Fibreglass, rockwool, ceramic and other material used for thermal or sound insulation may contain synthetic mineral fibre which may be harmful if inhaled or if it comes in contact with the skin, eyes or other sensitive parts or the body. Personal Protective Equipment including protection against inhalation of harmful material should be used when installing, removing or working near bulk insulation material.

TIMBER FLOORS

This building may contain timber floors which have an applied finish. Areas where finishes are applied should be kept well ventilated during sanding and application and for a period after installation. Personal Protective Equipment may also be required. The manufacturer's recommendations for use must be carefully considered at all times.

7. CONFINED SPACES

EXCAVATION

Construction of this building and some maintenance on the building will require excavation and installation of items within excavations. Where practical, installation should be carried out using methods which do not require workers to enter the excavation. Where this is not practical, adequate support for the excavated area should be provided to prevent collapse. Warning signs and barriers to prevent accidental or unauthorised access to all excavations should be provided.

ENCLOSED SPACES

For buildings with enclosed spaces where maintenance or other access may be required: Enclosed spaces within this building may present a risk to persons

entering for construction, maintenance or any other purpose. The design documentation calls for warning signs and barriers to unauthorised access. These should be maintained throughout the life of the building. Where workers are required to enter enclosed spaces, air testing equipment and Personal Protective Equipment should be provided.

SMALL SPACES

For buildings with small spaces where maintenance or other access may be required: Some small spaces within this building will require access by construction or maintenance workers. The design documentation calls for warning signs and barriers to unauthorised access. These should be maintained throughout the life of the building. Where workers are required to enter small spaces they should be scheduled so that access is for short periods. Manual lifting and other manual activity should be restricted in small spaces.

8. PUBLIC ACCESS

Public access to construction and demolition sites and lo areas under maintenance causes risk to workers and public. Warning signs and secure barriers to unauthorised access should be provided. Where electrical installations, excavations, plant or loose materials are present they should be secured when not fully supervised.

9. OPERATIONAL USE OF BUILDING RESIDENTIAL BUILDINGS

This building has been designed as a residential building. If it, at a later date, it is used or intended to be used as a workplace, the provisions of the Work Health and Safely Act 2011 or subsequent replacement Act should be applied to the new use.


NON-RESIDENTIAL BUILDINGS


For non-residential buildings where the end-use has not been identified: This building has been designed to requirements of the classification identified on the drawings. The specific, use of the building is not known at the time of the design and a further assessment of the workplace health and safety issues should be undertaken at the time of fit-out for the end-user. For non-residential buildings where the end-use is known: This building has been designed for the specific use as identified on the drawings. Where a change of use occurs at a later dale a further assessment of the workplace health and safety issues should be undertaken.

10. OTHER HIGH RISK ACTIVITY

All electrical work should be carried out in accordance with Code of Practice: Managing Electrical Risks at the Workplace, AS/ NZ 3012 and all licensing requirements. All work using Plant should be carried out in accordance with Code of Practice: Managing Risks of Plant at the Workplace. All work should be carried out in accordance with Code of Practice: Managing Noise and Preventing Hearing Loss at Work. Due to the history of serious incidents it is recommended that particular care be exercised when undertaking work involving steel construction and concrete placement. All the above applies.



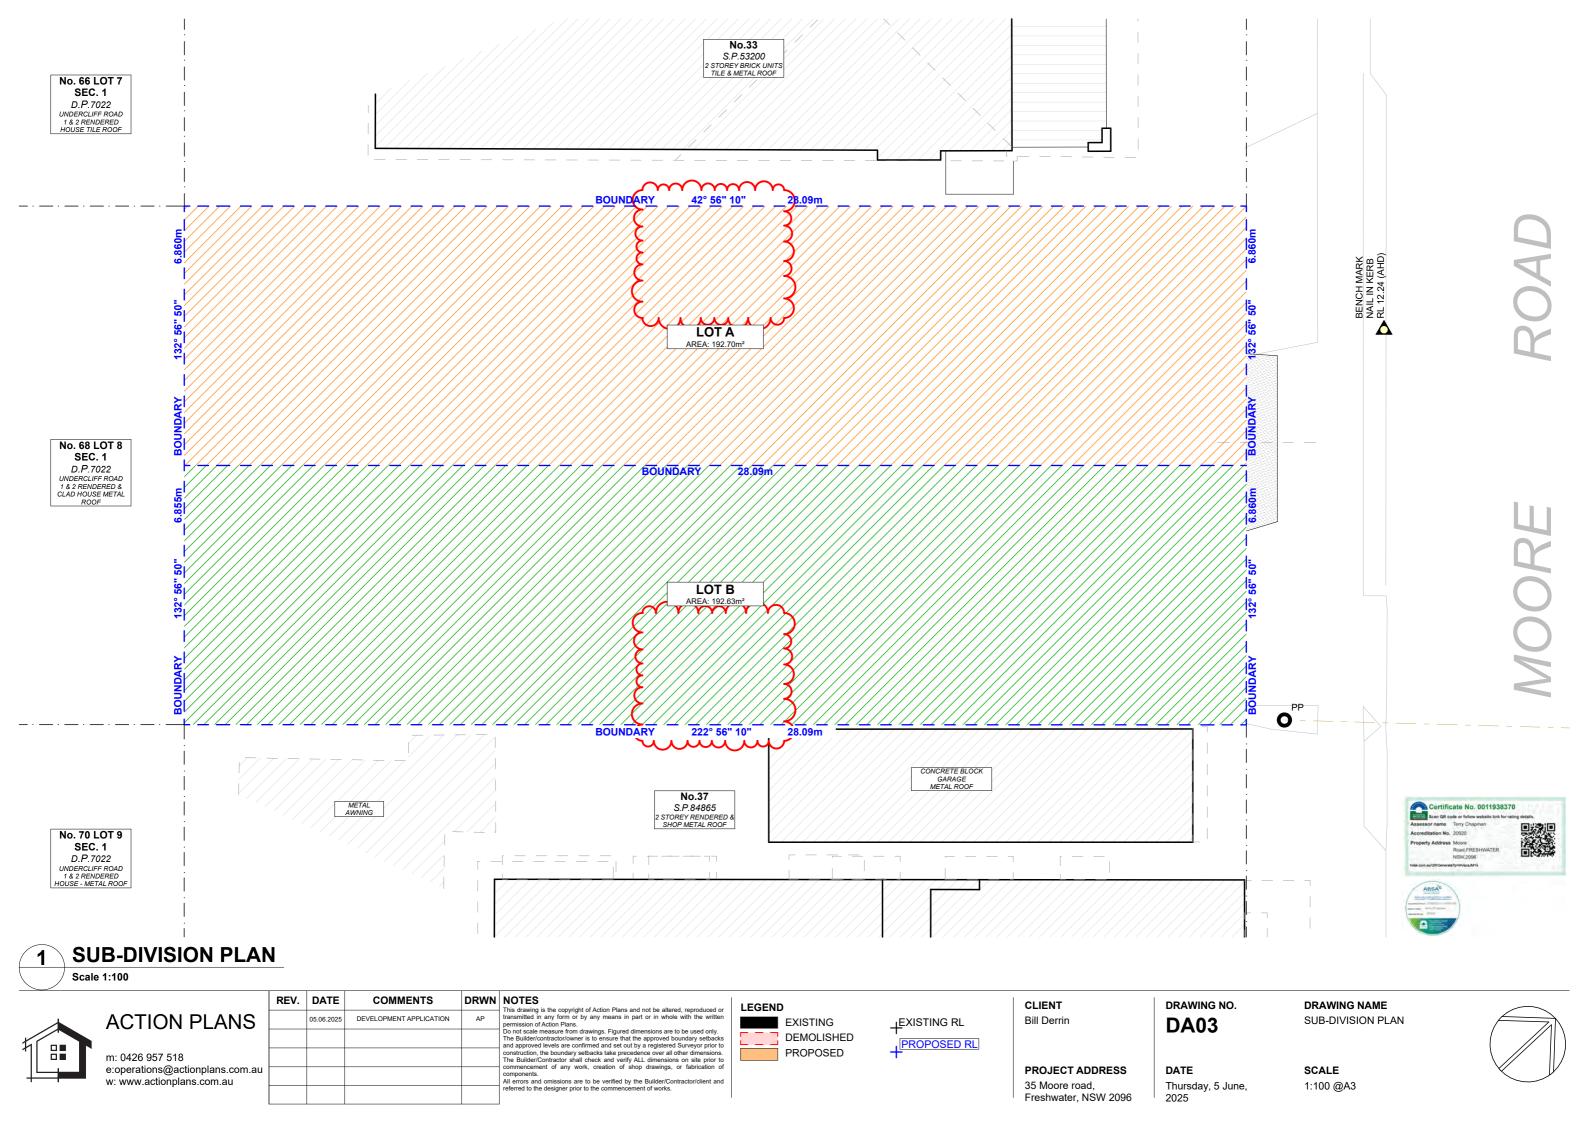

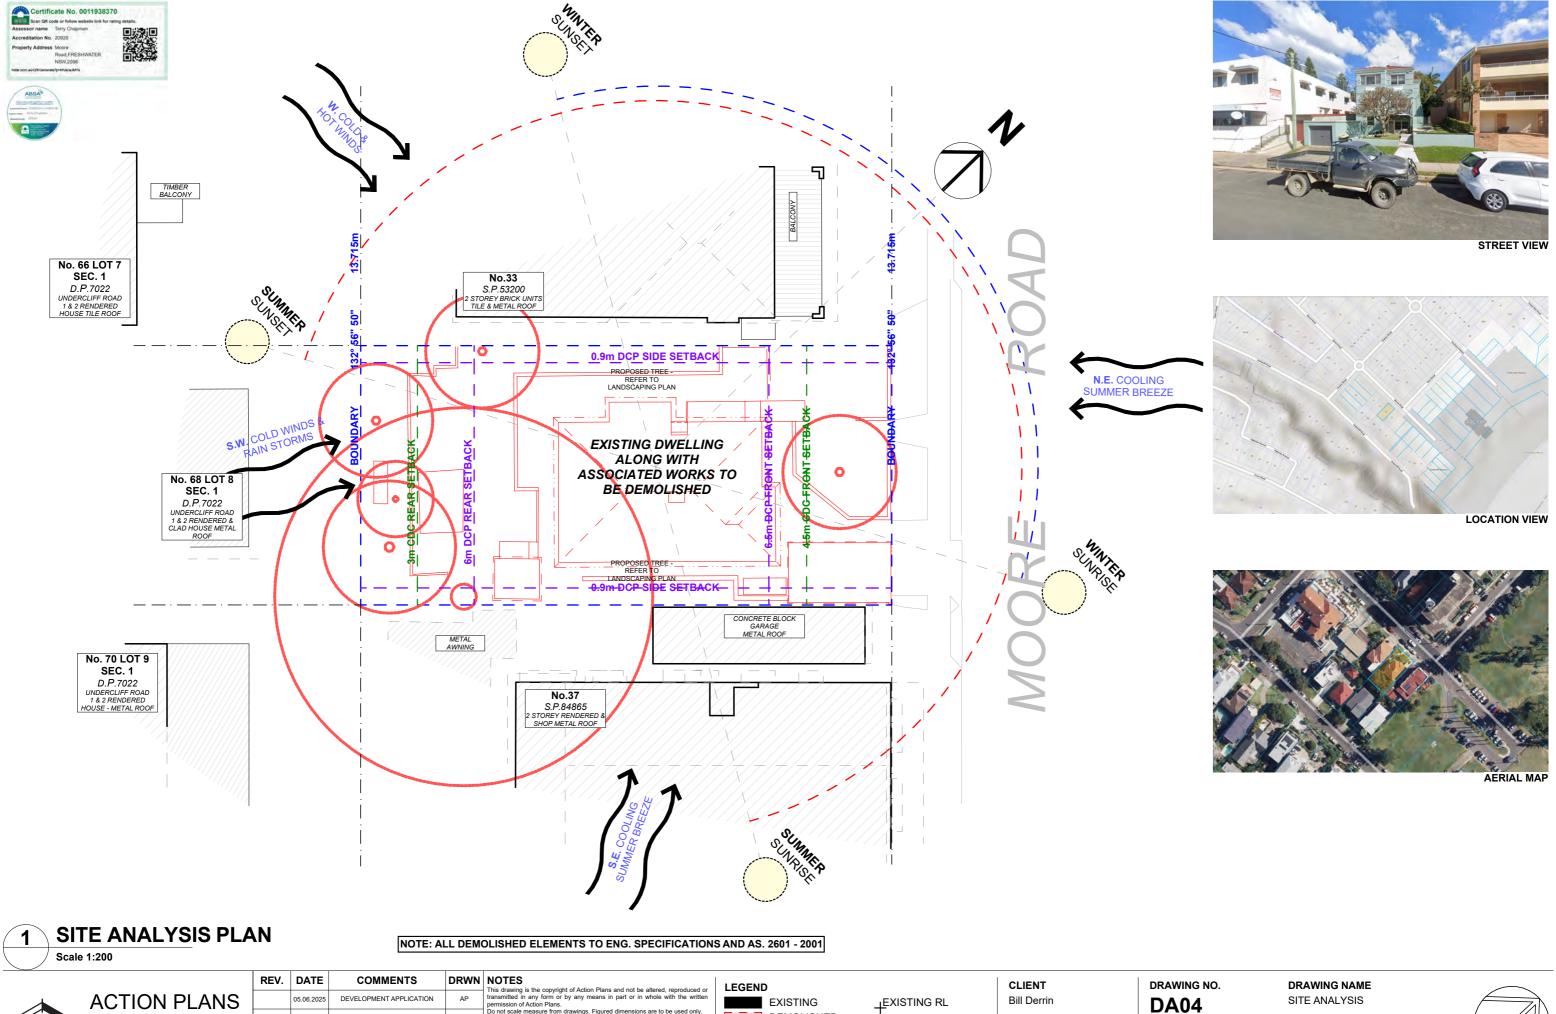

DEMOLISHED

PROPOSED

Do not scare inequire from forming single dimensions are to be asset only. The Builderic microtractoriowners is to ensure that the approved boundary setbacks and onstruction levels are confirmed and set out by a registered Surveyor prior to construction, the boundary setbacks take precedence over all other dimensions. The BuilderiContract of shall check and verify ALL dimensions on site prior to commencement of any work, creation of shop drawings, or fabrication of

components.

All errors and omissions are to be verified by the Builder/Contract referred to the designer prior to the commencement of works.

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PROPOSED RL

PROJECT ADDRESS

Freshwater, NSW 2096

35 Moore road,


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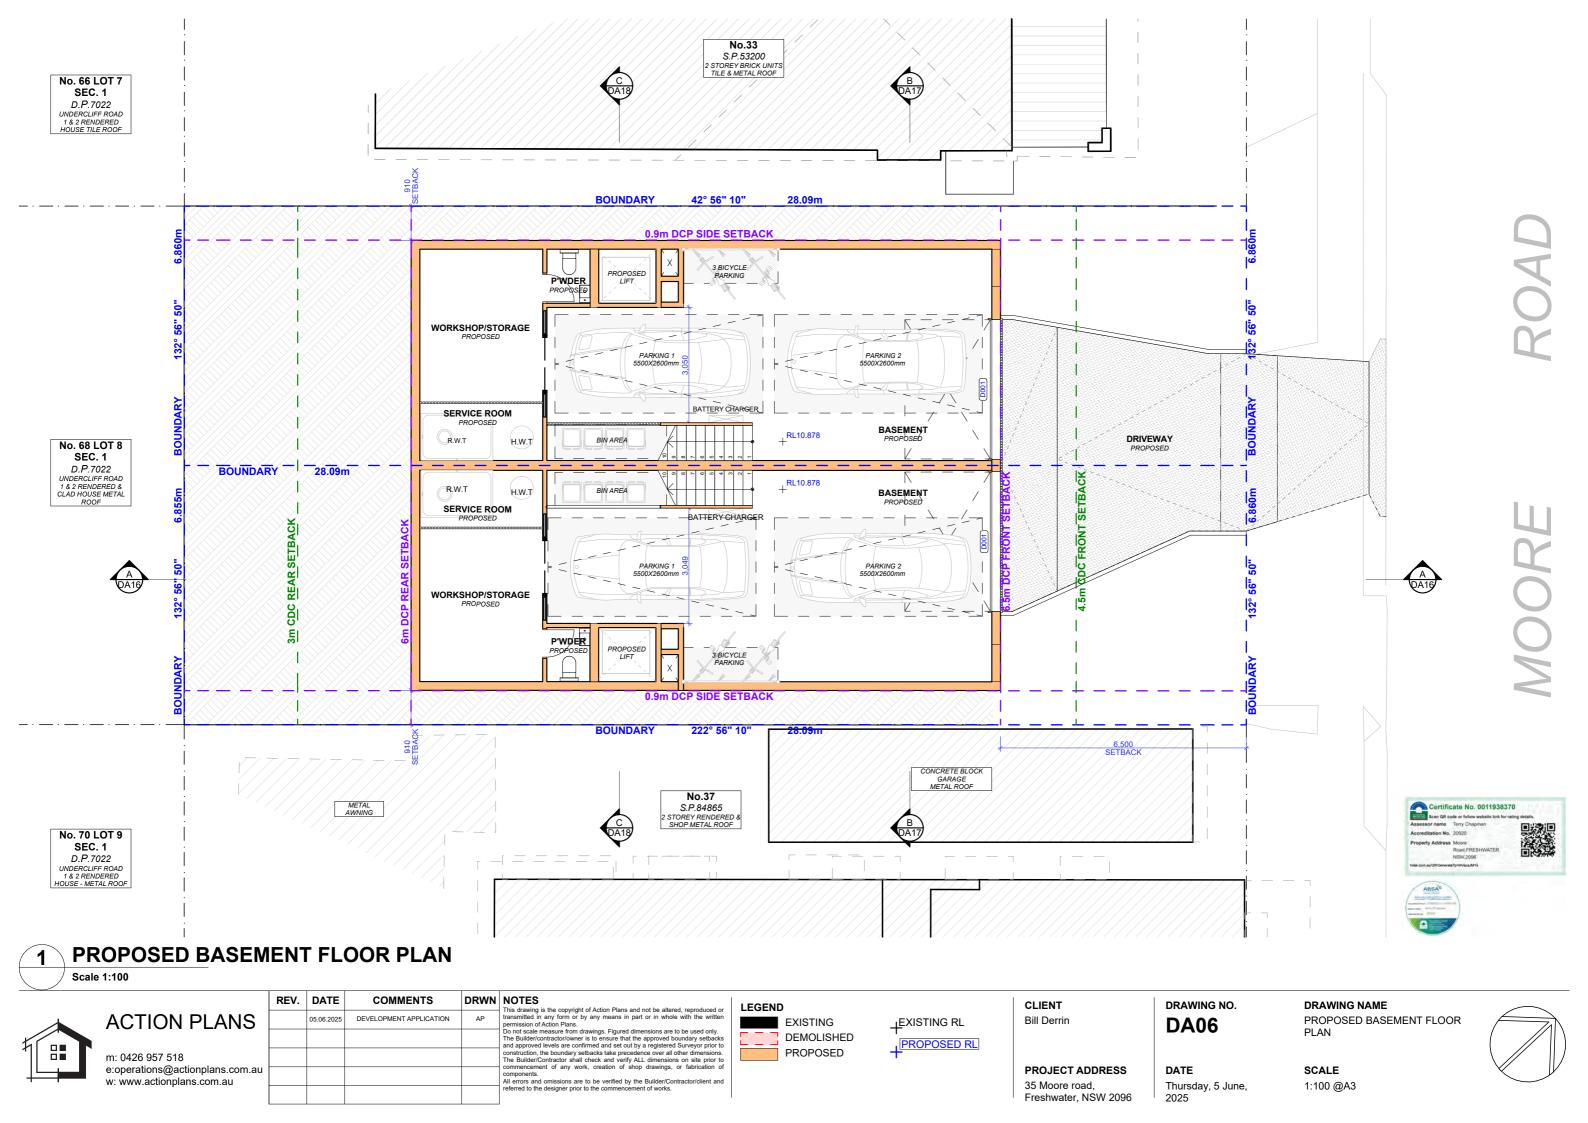
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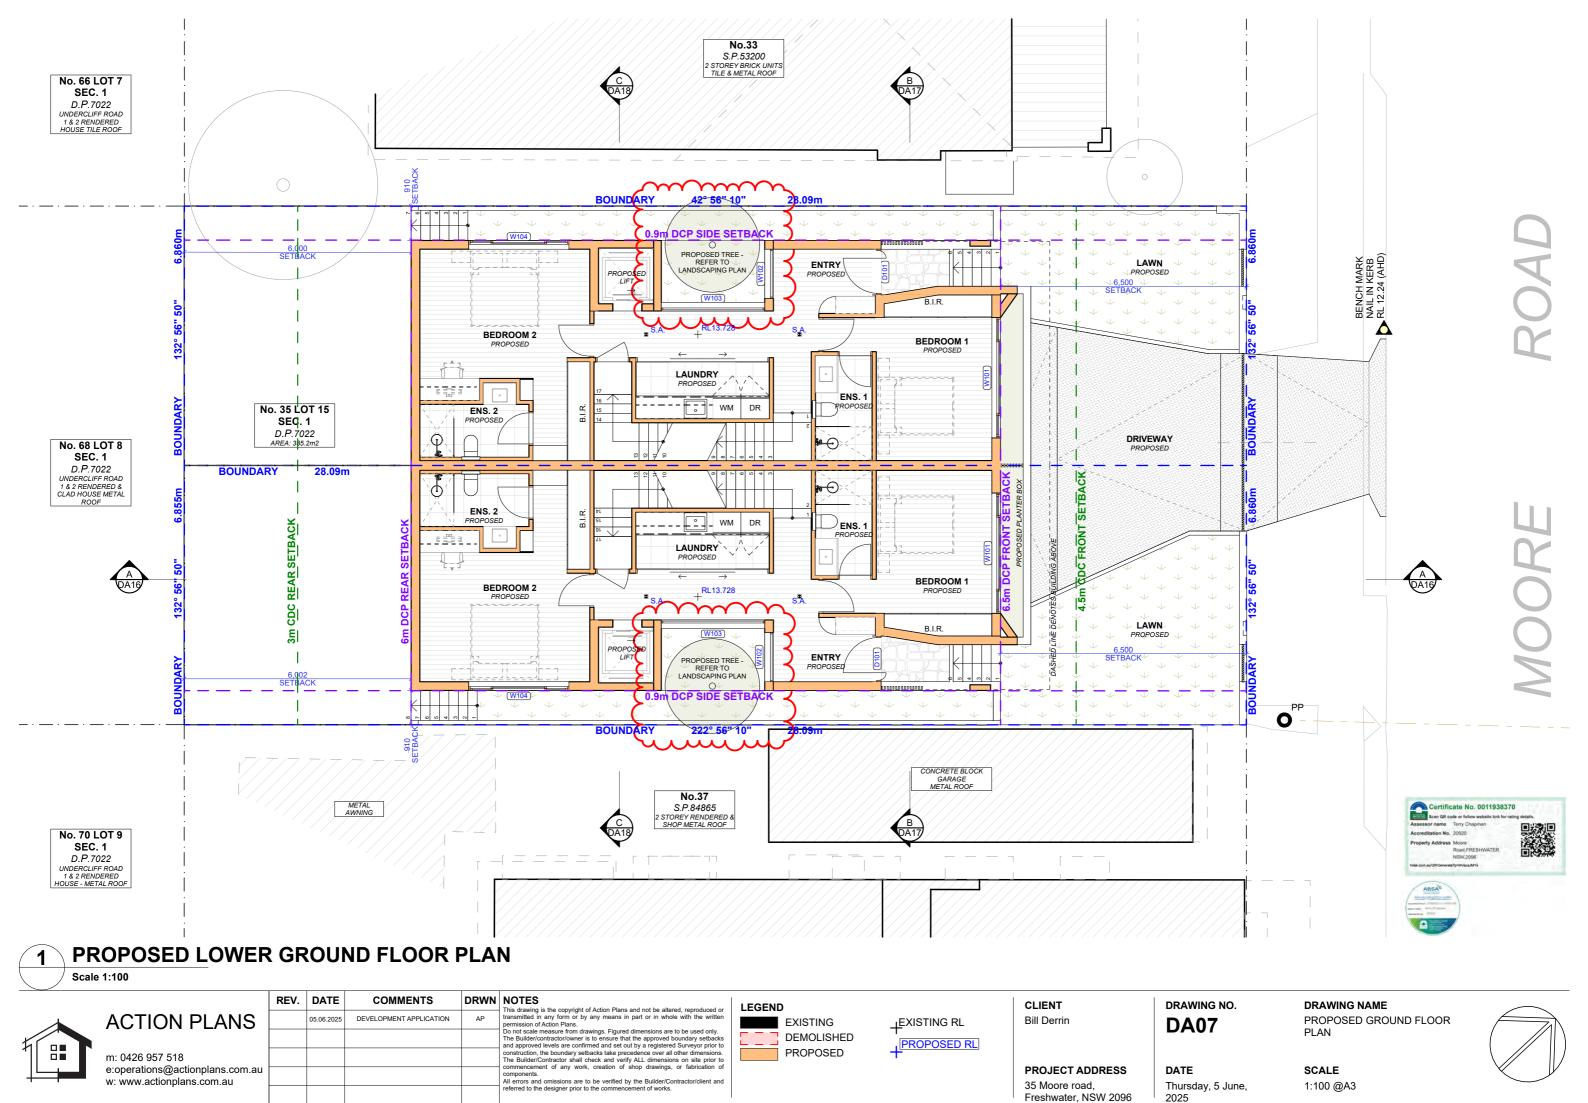
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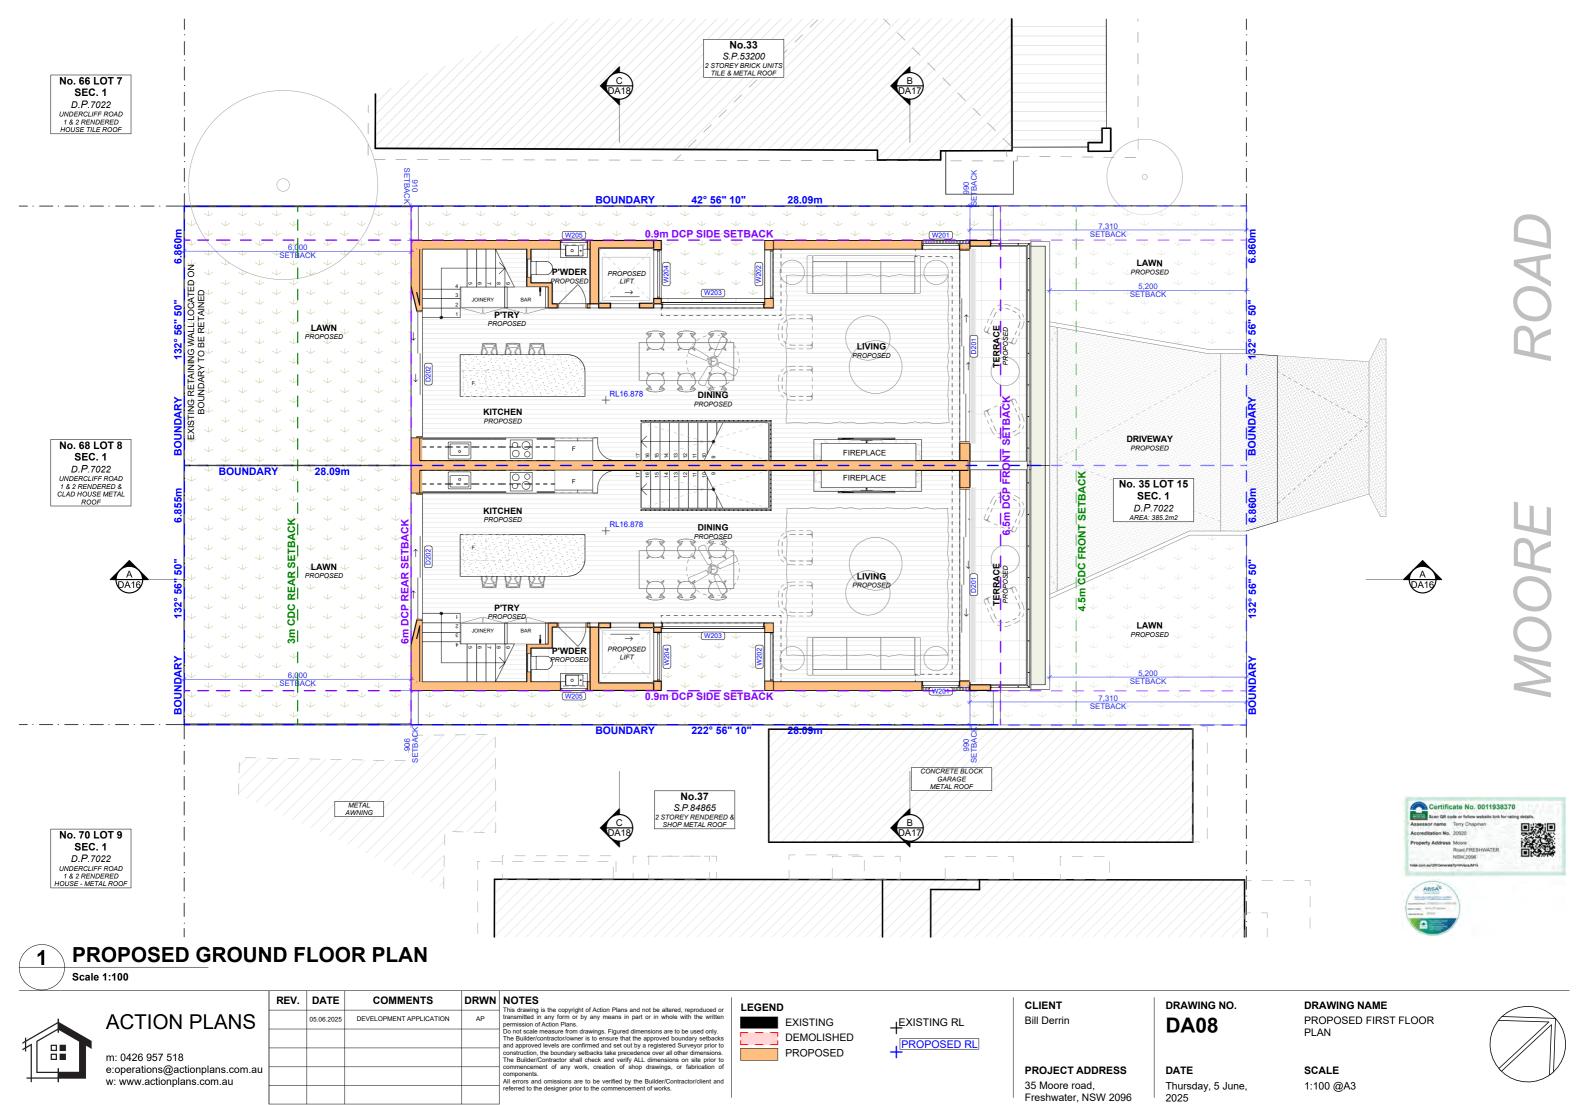
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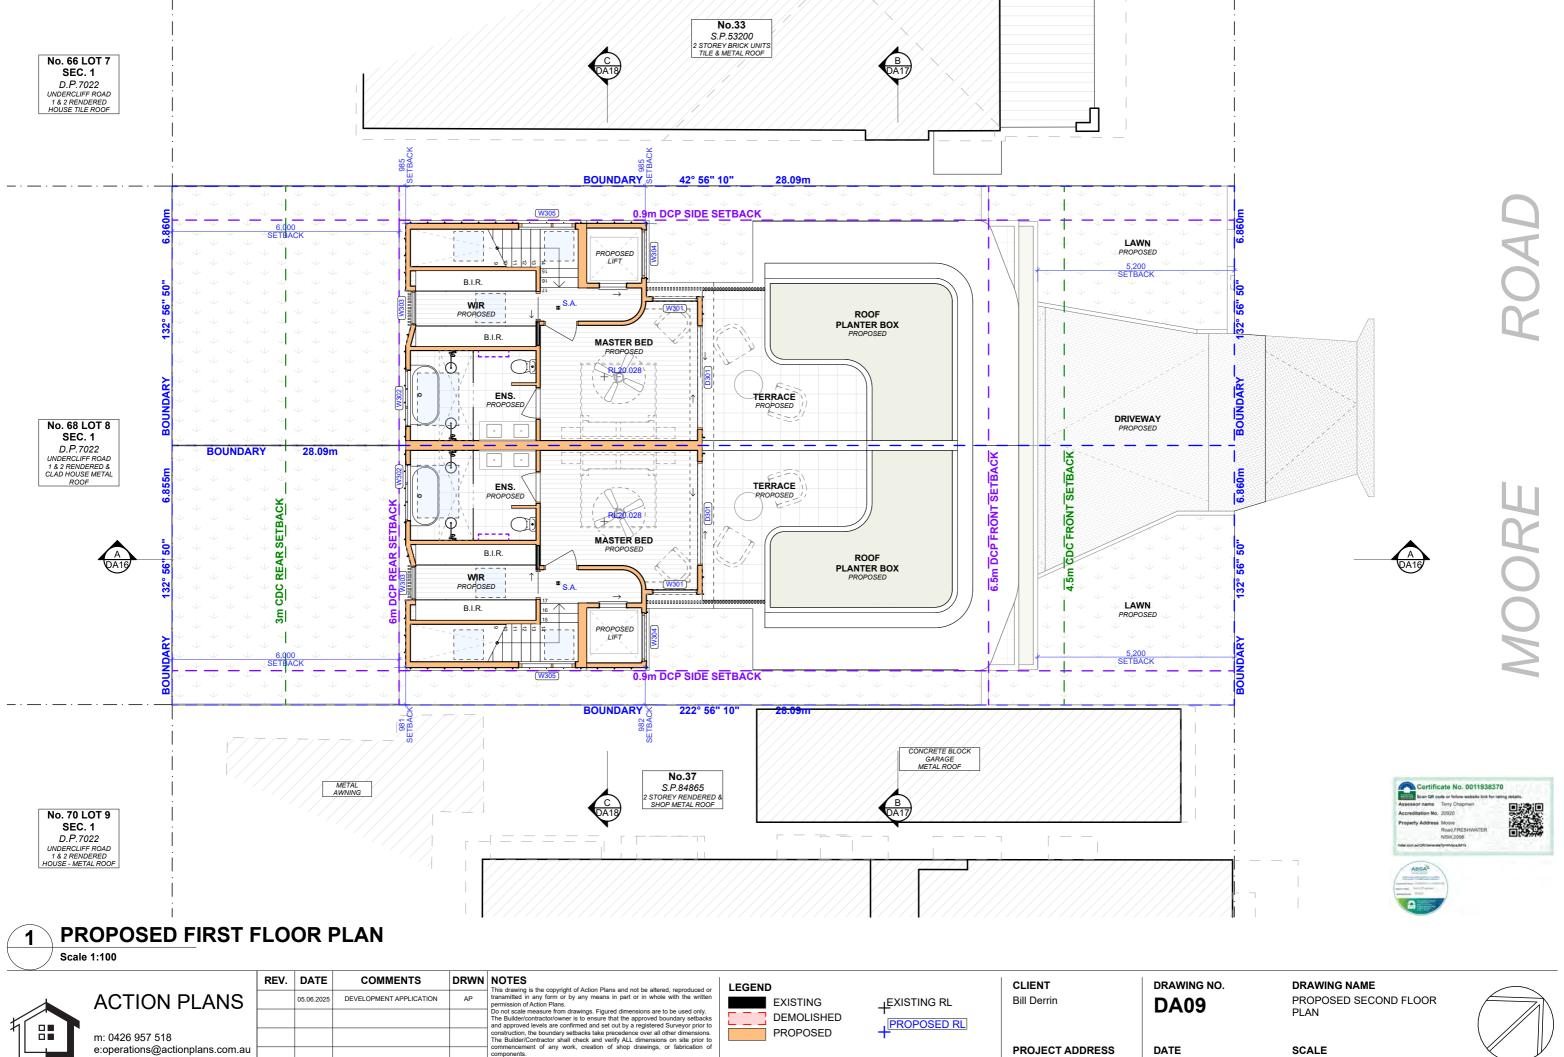
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All errors and omissions are to be verified by the Builder/Contracto referred to the designer prior to the commencement of works.

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Freshwater, NSW 2096

35 Moore road,

DATE

2025

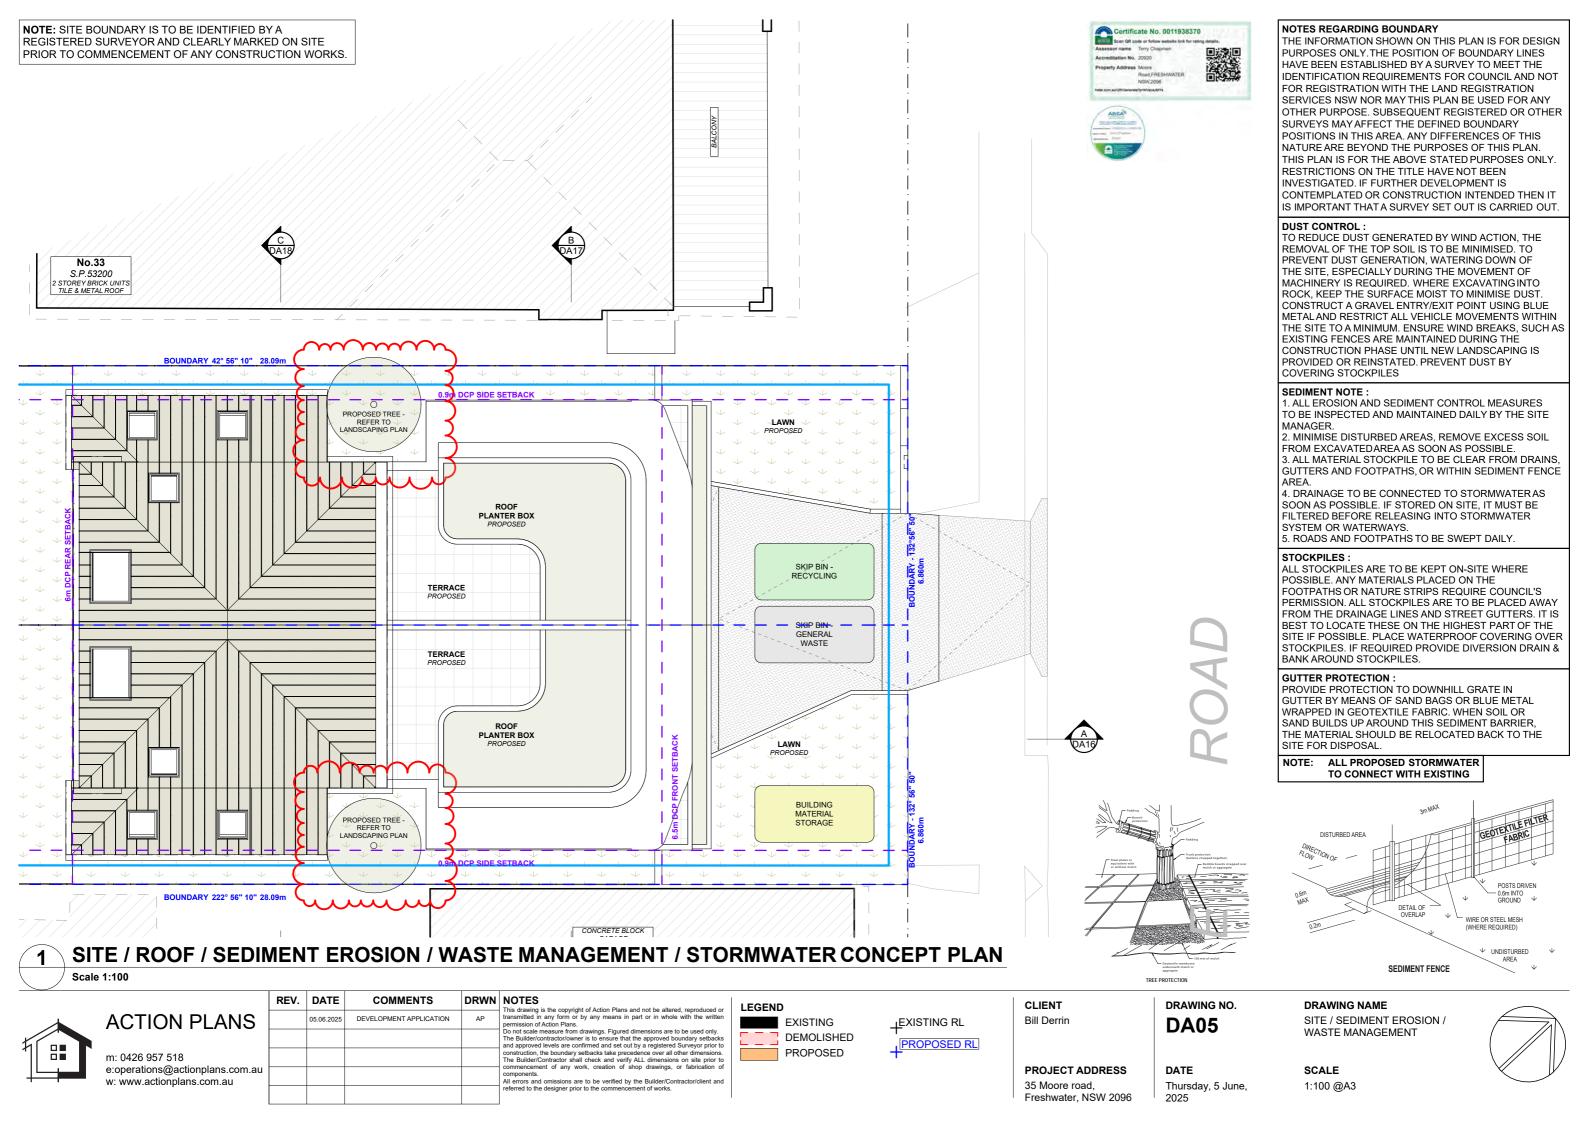
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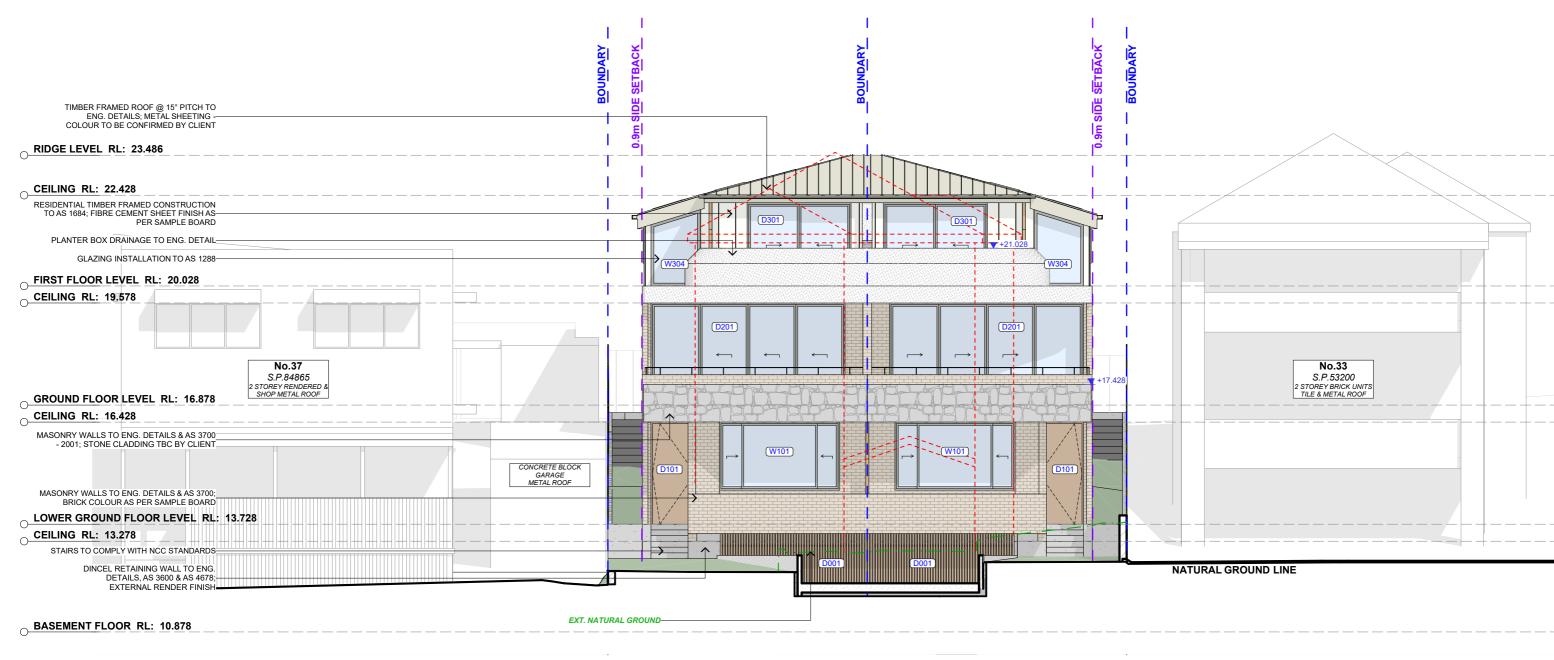
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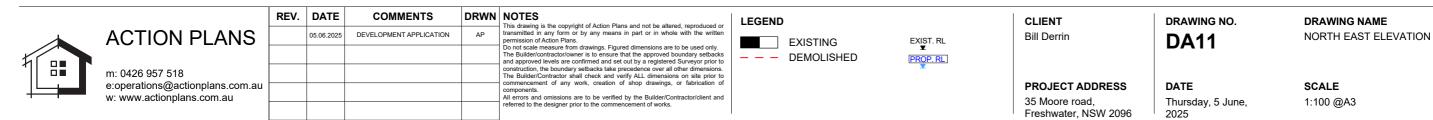
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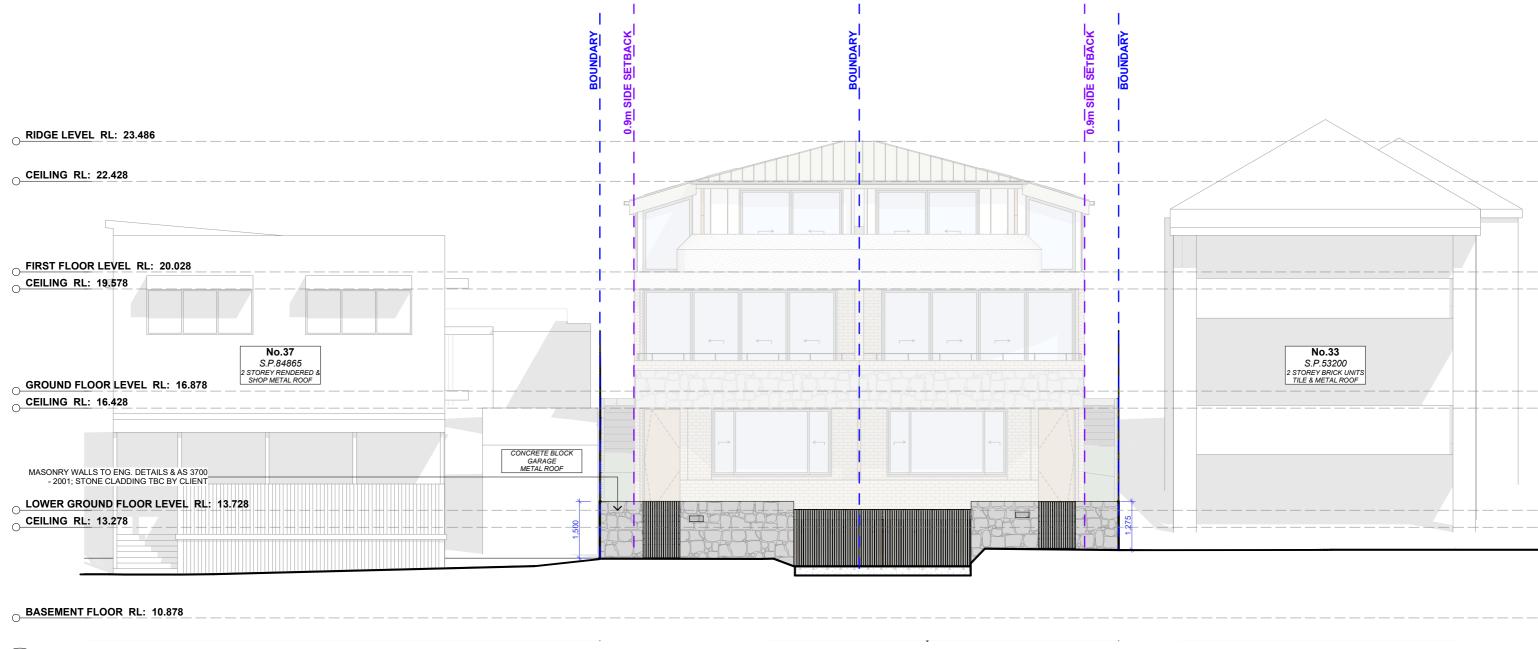










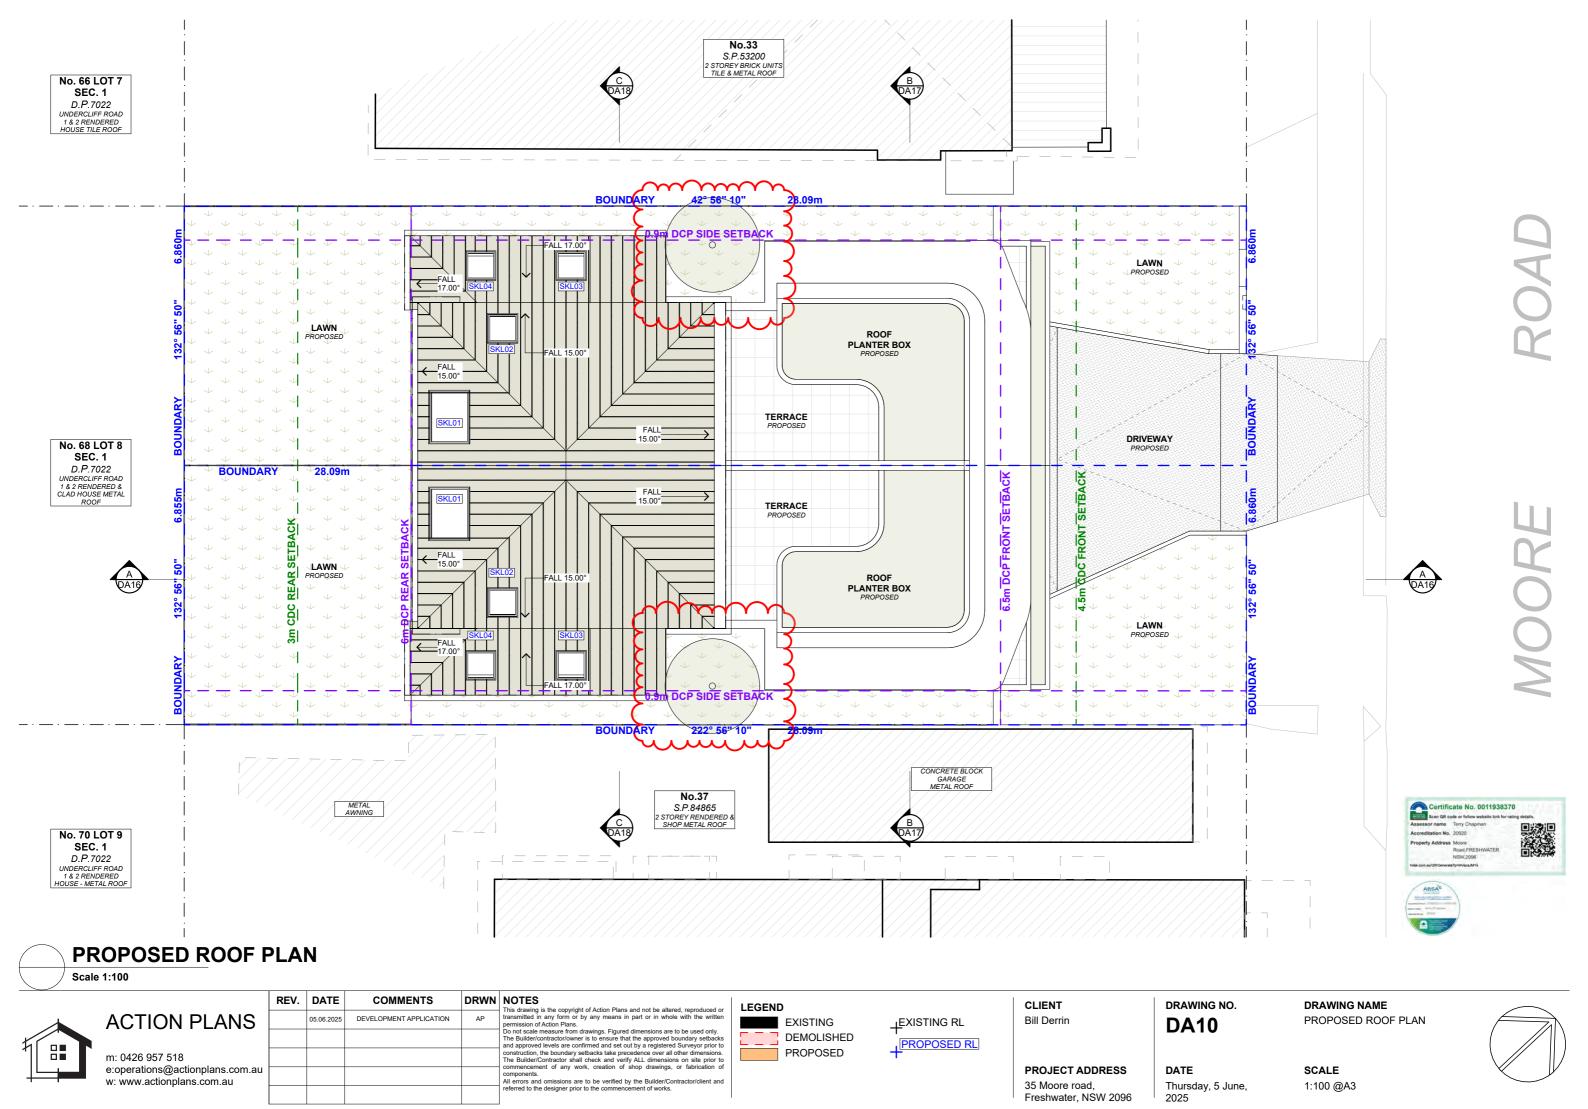

NORTH EAST - FRONT FENCE ELEVATION Scale 1:100

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REV.	DATE	COMMENTS	DRWN	NOTES
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				components. All errors and omissions are to be verified by the Builder/Contractor/client and
				referred to the designer prior to the commencement of works.



EXIST. RL ▼

PROP. RL

CLIENT	DRAW
Bill Derrin	DA

RAWING NO.	
A12	


DRAWING NAME NORTH EAST - FRONT FENCE ELEVATION

PROJECT ADDRESS
35 Moore road,
Freshwater, NSW 2096

DATE
Thursday, 5 June,
2025

SCALE , 1:100 @A3



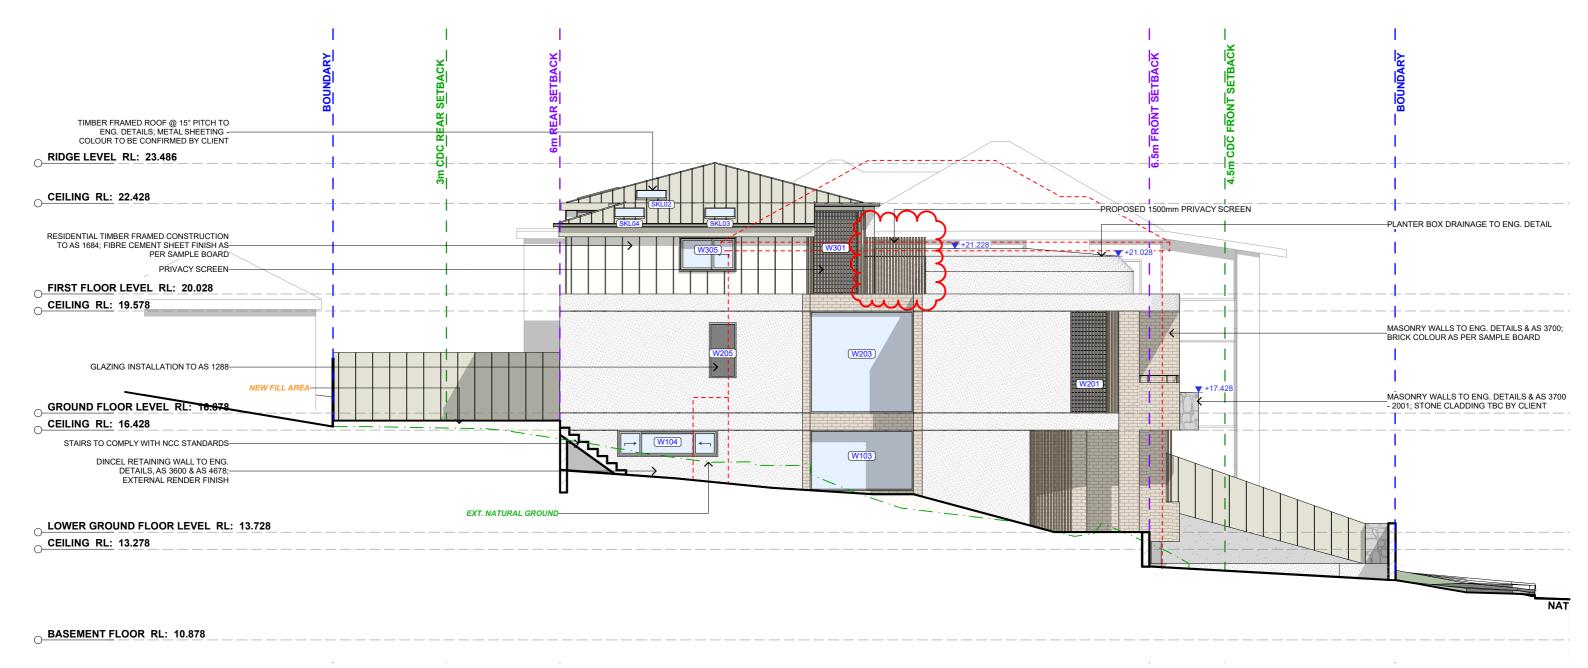





F	REV.	DATE	COMMENTS	DRWI	ľ
		05.06.2025	DEVELOPMENT APPLICATION	AP	



CLIENT
Bill Derrin

35 Moore road,

PROJECT ADDRESS

DRAWING NO. **DA13**

DRAWING NAME SOUTH EAST ELEVATION

DATE Thursday, 5 June, Freshwater, NSW 2096 2025

SCALE 1:100 @A3





CEILING RL: 13.278

O BASEMENT FLOOR RL: 10.878

SOUTH WEST ELEVATION

Scale 1:100

m: 0426 957 518 e:operations@actionplans.com.au w: www.actionplans.com.au

ACTION PLANS

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LEGEND

EXISTING
--- DEMOLISHED

EXIST. RL
PROP. RL

CLIENT DRAWING NO.
Bill Derrin DA 1/

PROJECT ADDRESS

Freshwater, NSW 2096

35 Moore road,


DA14 DRAWING NAME
SOUTH WEST ELEVATION


DATEThursday, 5 June, 2025

SCALE


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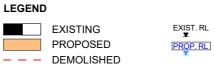




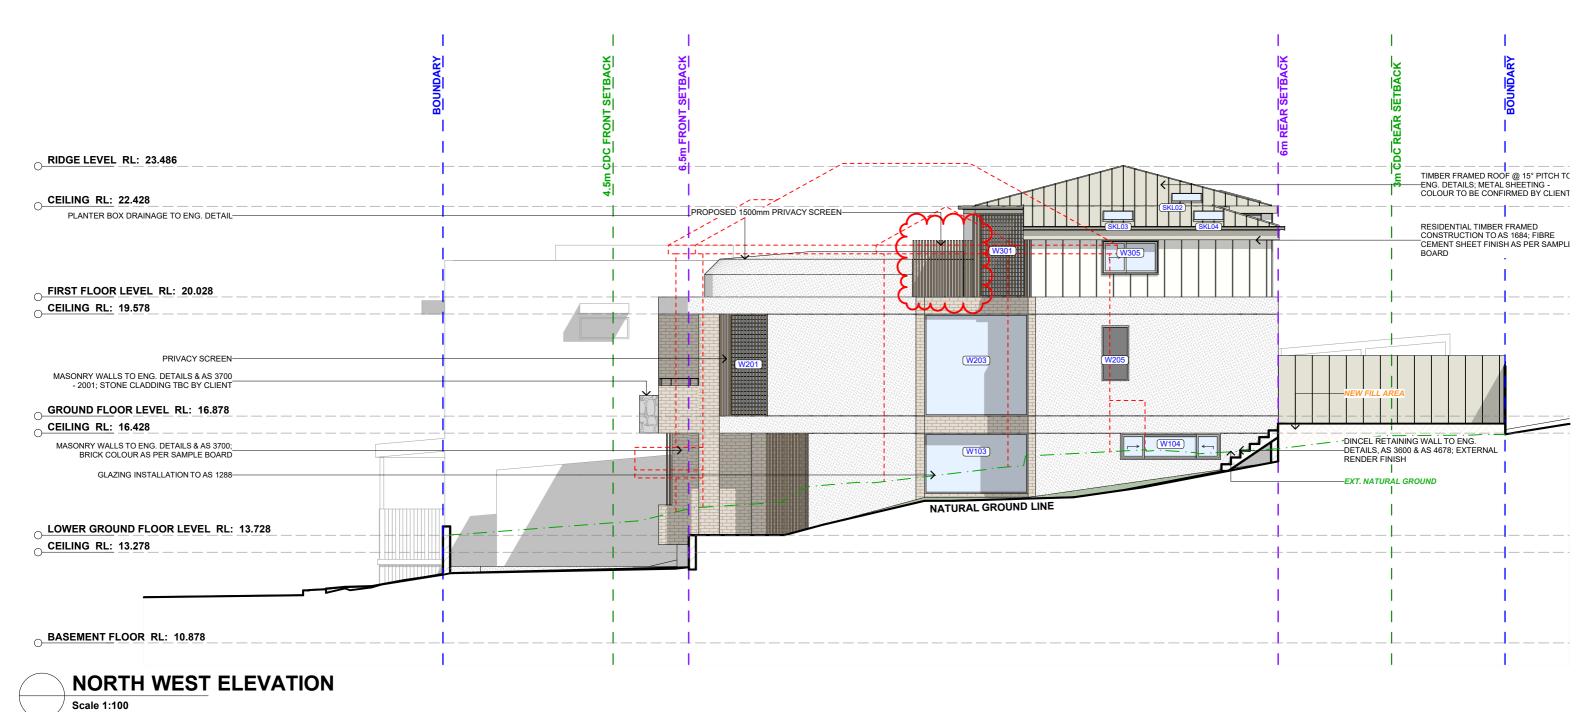

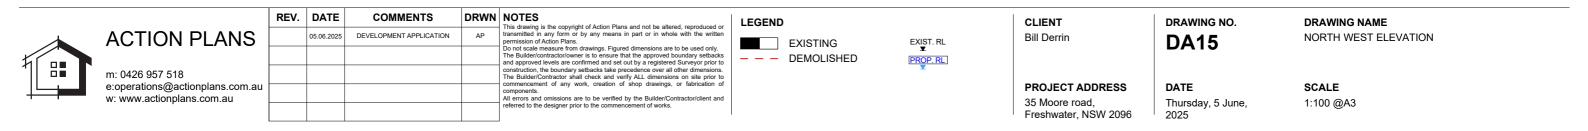

REV.	DATE	COMMENTS	DRWN
	05.06.2025	DEVELOPMENT APPLICATION	AP

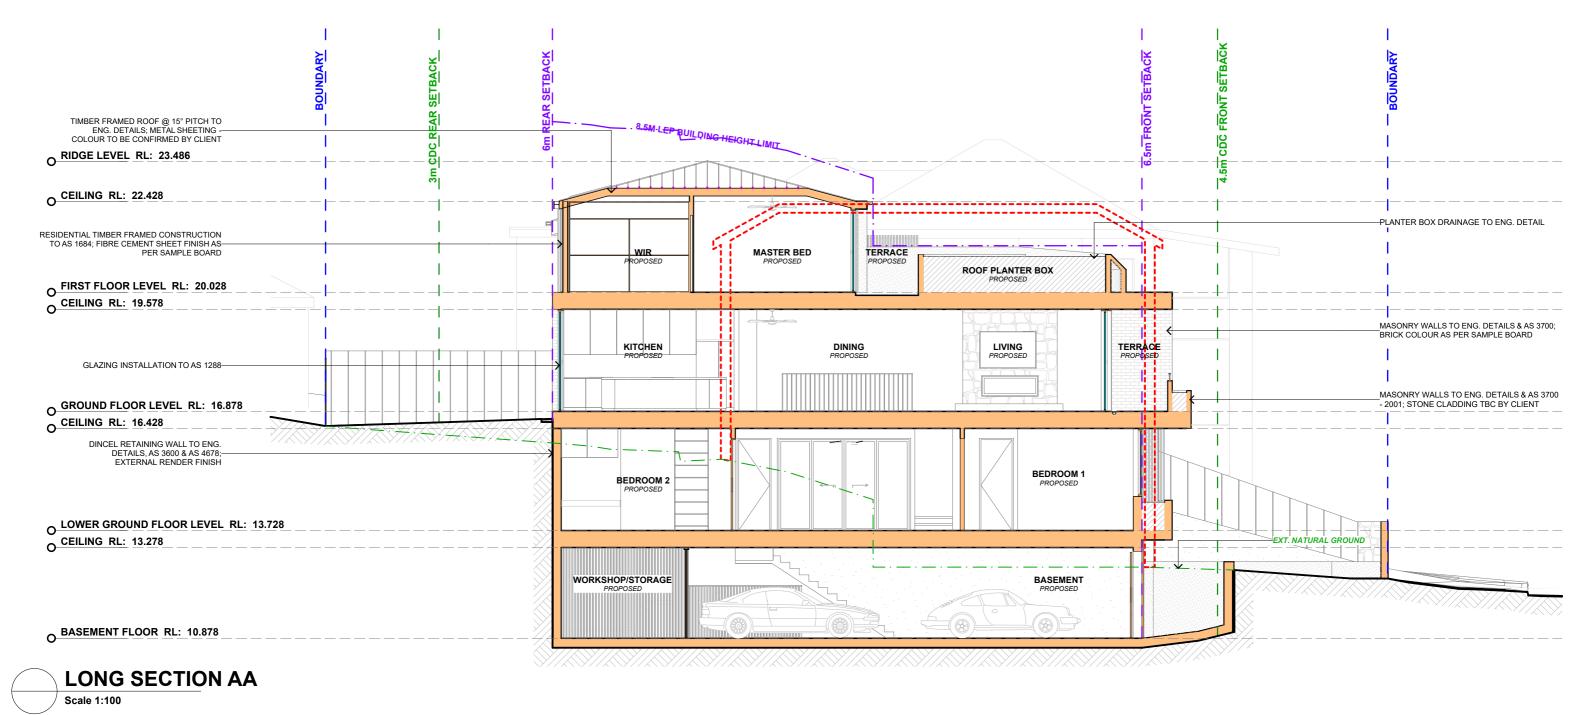

CLIENT
Bill Derrin
PROJECT ADDRESS

35 Moore road,

Freshwater, NSW 2096


DA16

DRAWING NAME LONG SECTION

DATEThursday, 5 June, 2025

SCALE 1:100 @A3



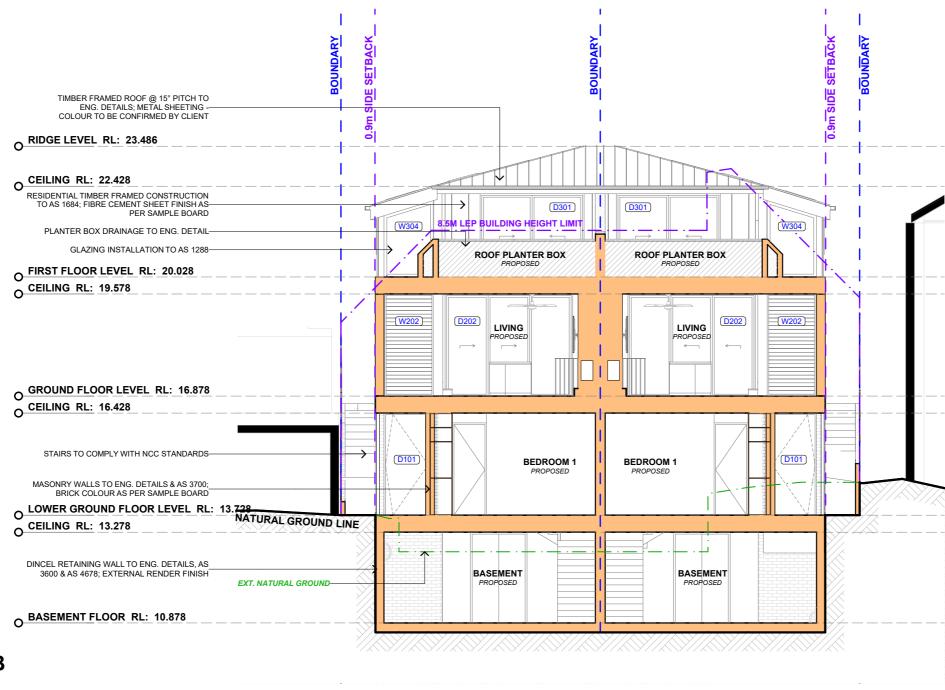





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REV.	DATE	COMMENTS	DRWN
	05.06.2025	DEVELOPMENT APPLICATION	AP



PROPOSED --- DEMOLISHED

EXIST. RL ▼ PROP. RL Bill Derrin

CLIENT

PROJECT ADDRESS 35 Moore road, Freshwater, NSW 2096


DRAWING NO. **DA17**

DRAWING NAME CROSS SECTION

Thursday, 5 June, 2025

SCALE 1:100 @A3



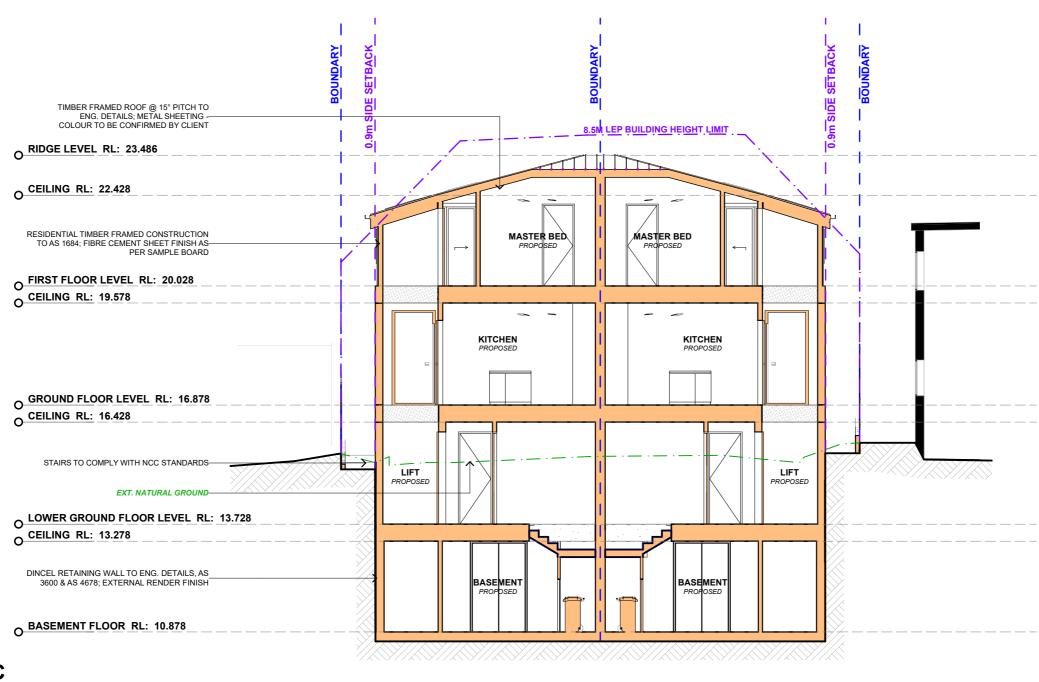




	ACTION PLANS
打 :::	m. 0406 057 540

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CLIENT DRAWING NO. Bill Derrin

DA18

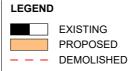
DRAWING NAME CROSS SECTION

SCALE

1:100 @A3

PROJECT ADDRESS 35 Moore road, Freshwater, NSW 2096


Thursday, 5 June, 2025

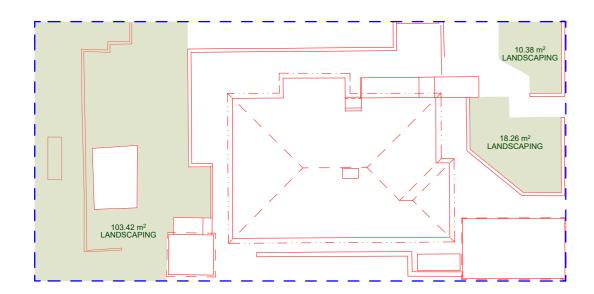

1

EXISTING AREA CALCULATIONS

Scale 1:200

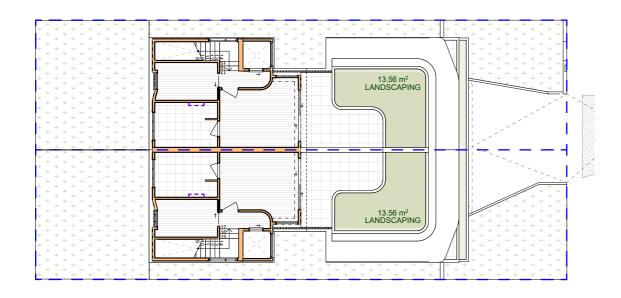




PROPOSED AREA CALCULATIONS - SECOND FLOOR LEVEL

Scale 1:200

SITE AREA: 385.2m²
LANDSCAPE AREA CONTROL: 40% OF SITE AREA (154.08m²)




EXISTING LANDSCAPED AREA = 132.06m² (34.28%)

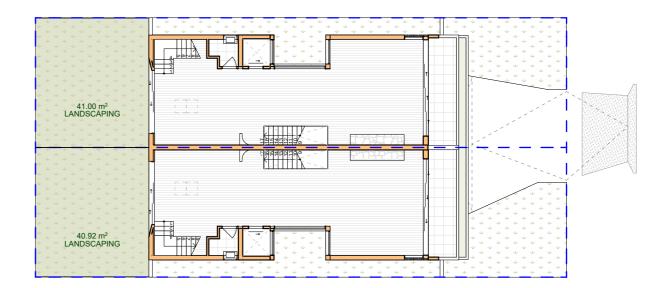

PROPOSED AREA CALCULATIONS - FIRST FLOOR PLAN

Scale 1:200

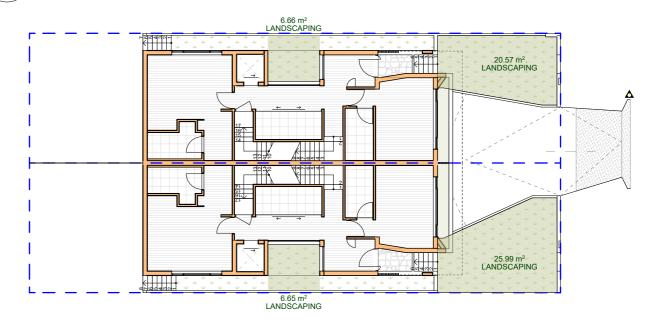

PROPOSED AREA CALCULATIONS - GROUND FLOOR PLAN Scale 1:200

PROPOSED LANDSCAPED AREA = 168.91m² (43.84%)

DRAWING NO.

Scan OR code or follow website link for rating details.

Assessor name Terry Chapman

Accreditation No. 20920

Property Address Moore

Road, FRESHWATER

NSW 2096

ACTION PLANS

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REV	. DATE	COMMENTS	DRWN
	05.06.2025	DEVELOPMENT APPLICATION	AP

LEGEND

LANDSCAPED AREA

CLIENT Bill Derrin

35 Moore road,

Freshwater, NSW 2096

PROJECT ADDRESS DATE

DATEThursday, 5 June,

2025

AREA CALCULATIONS

SCALE

1:200 @A3

DRAWING NAME









METAL FRAMED WINDOWS AND **DOORS**



LIGHT COLOURED BRICKWORK



LIGHT COLOURED EXTERNAL RENDER

Freshwater, NSW 2096



TIMBER CLAD GARAGE DOORS



STONE CLADDING



LIGHT PAINTED BOARD & BATTEN FIBRE CEMENT SHEETING



ACTION PLANS

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REV. DATE

COMMENTS

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DRWN NOTES

LEGEND

CLIENT Bill Derrin

PROJECT ADDRESS DATE 35 Moore road, Thursday, 5 June,


DRAWING NO. **DA20**


2025

DRAWING NAME SAMPLE BOARD

SCALE @A3



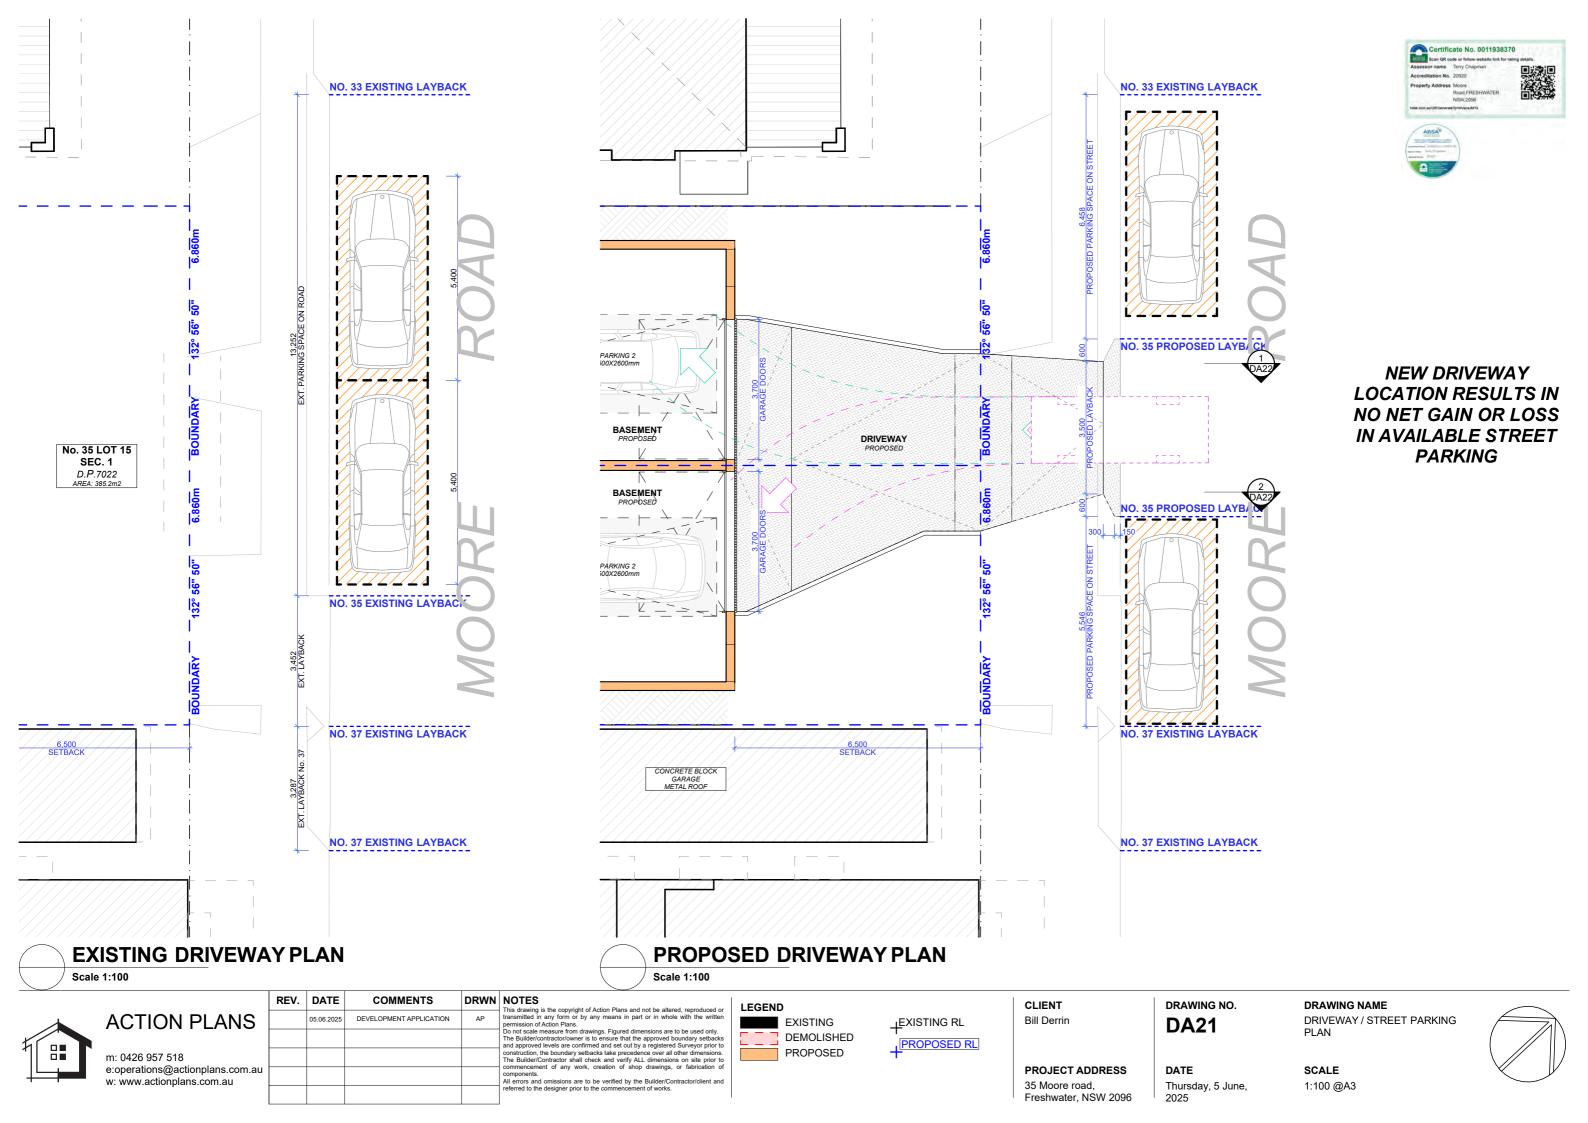


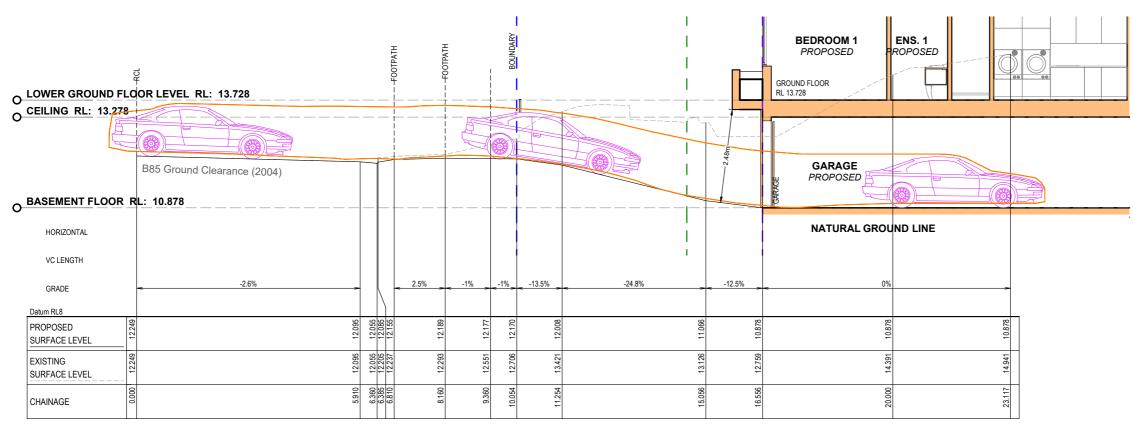



DRIVEWAY LONG SECTION 1

Scale 1:100

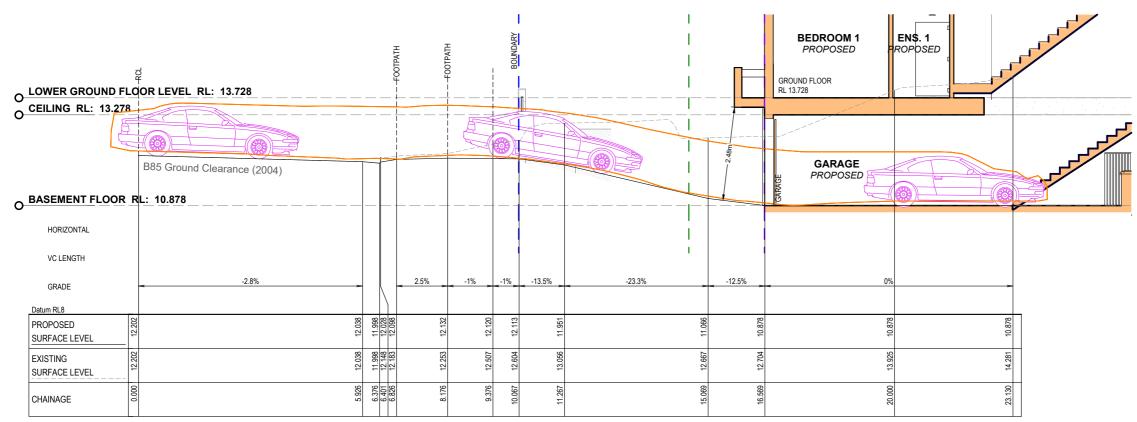

DRIVEWAY LONG SECTION 2

Scale 1:100

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ACTION PLANS

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LEGEND

CLIENT Bill Derrin

PROJECT ADDRESS 35 Moore road, Freshwater, NSW 2096


DRAWING NO. **DA22**


DATE

Thursday, 5 June, 2025

DRAWING NAME LONG SECTION DRIVEWAY

SCALE 1:100 @A3

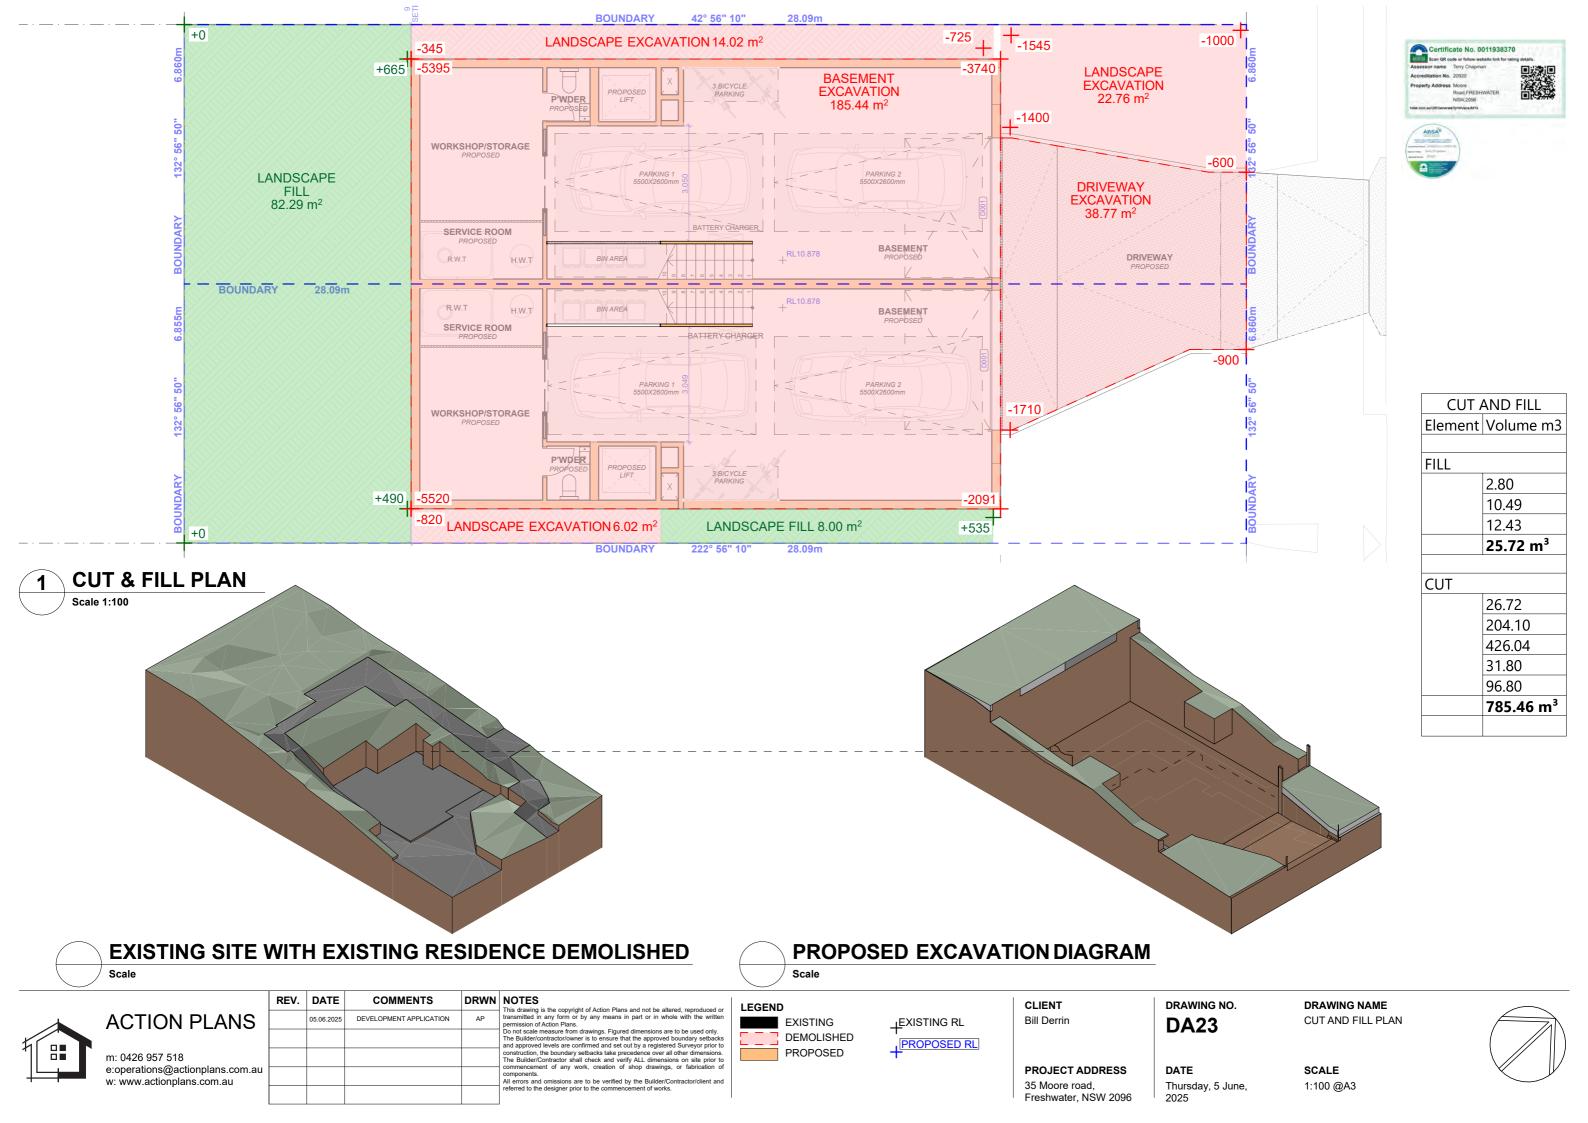

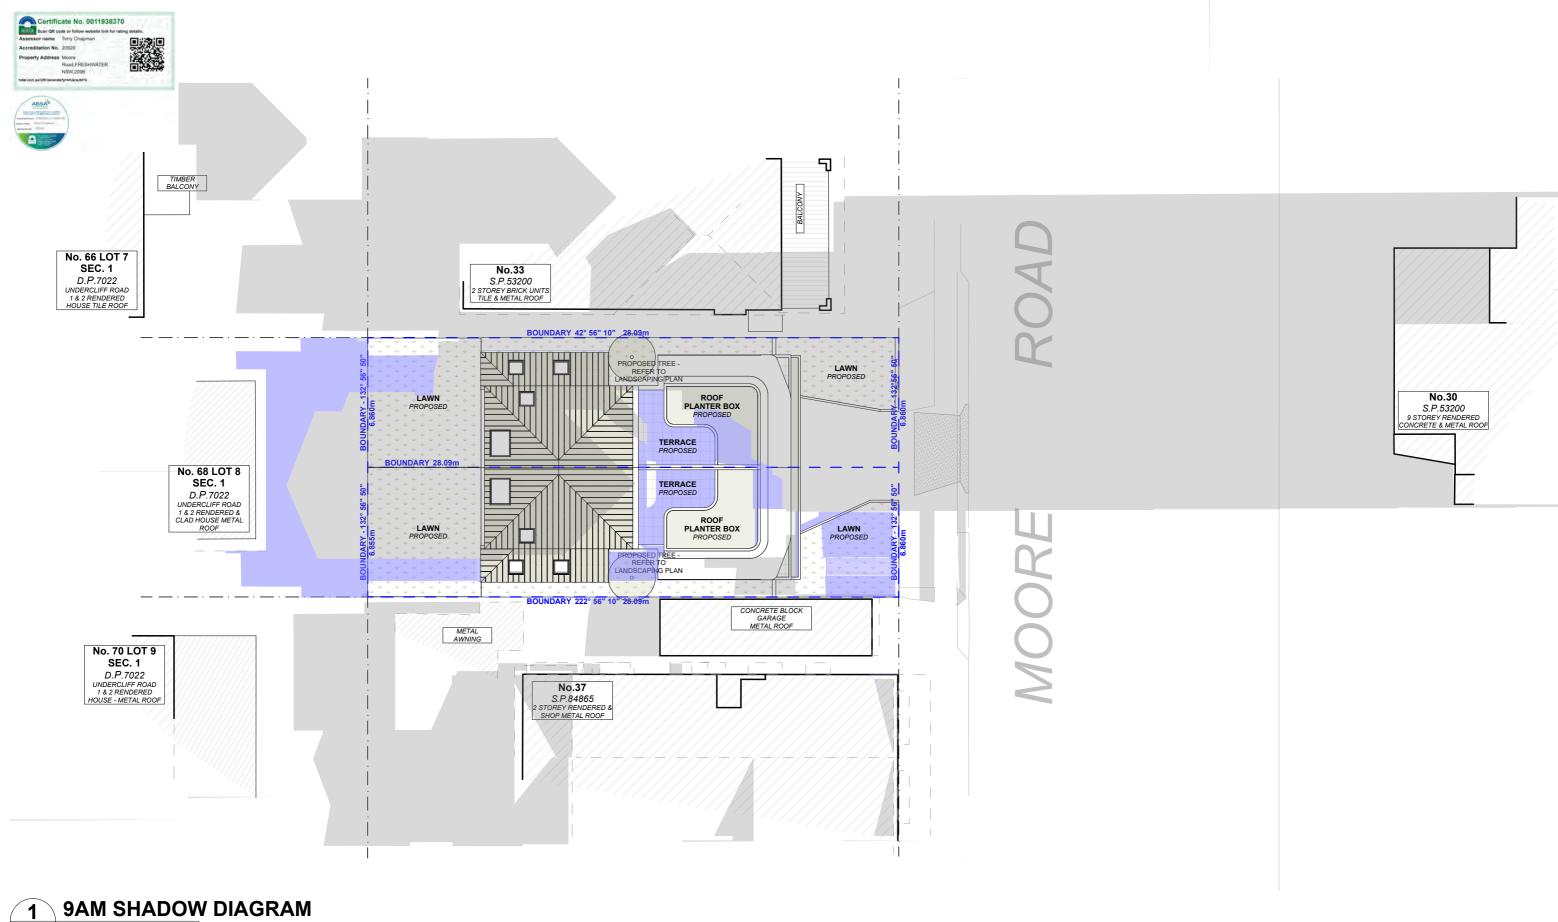

Scale 1:200

ACTION PLANS

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l	REV.	DATE	COMMENTS	DRWN	NOTES
İ		05.06.2025	DEVELOPMENT APPLICATION	AP	 This drawing is the copyright of Action Plans and not be altered, reproduced or transmitted in any form or by any means in part or in whole with the written permission of Action Plans.
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					components. All errors and omissions are to be verified by the Builder/Contractor/client and
ı					referred to the designer prior to the commencement of works.

LEGEND

EXISTING SHADOWS PROPOSED SHADOWS CLIENT Bill Derrin

PROJECT ADDRESS 35 Moore road, Freshwater, NSW 2096 DRAWING NO.


DA24

DRAWING NAME WINTER SOLSTICE 9 AM

DATE Thursday, 5 June, 2025

SCALE 1:200 @A3



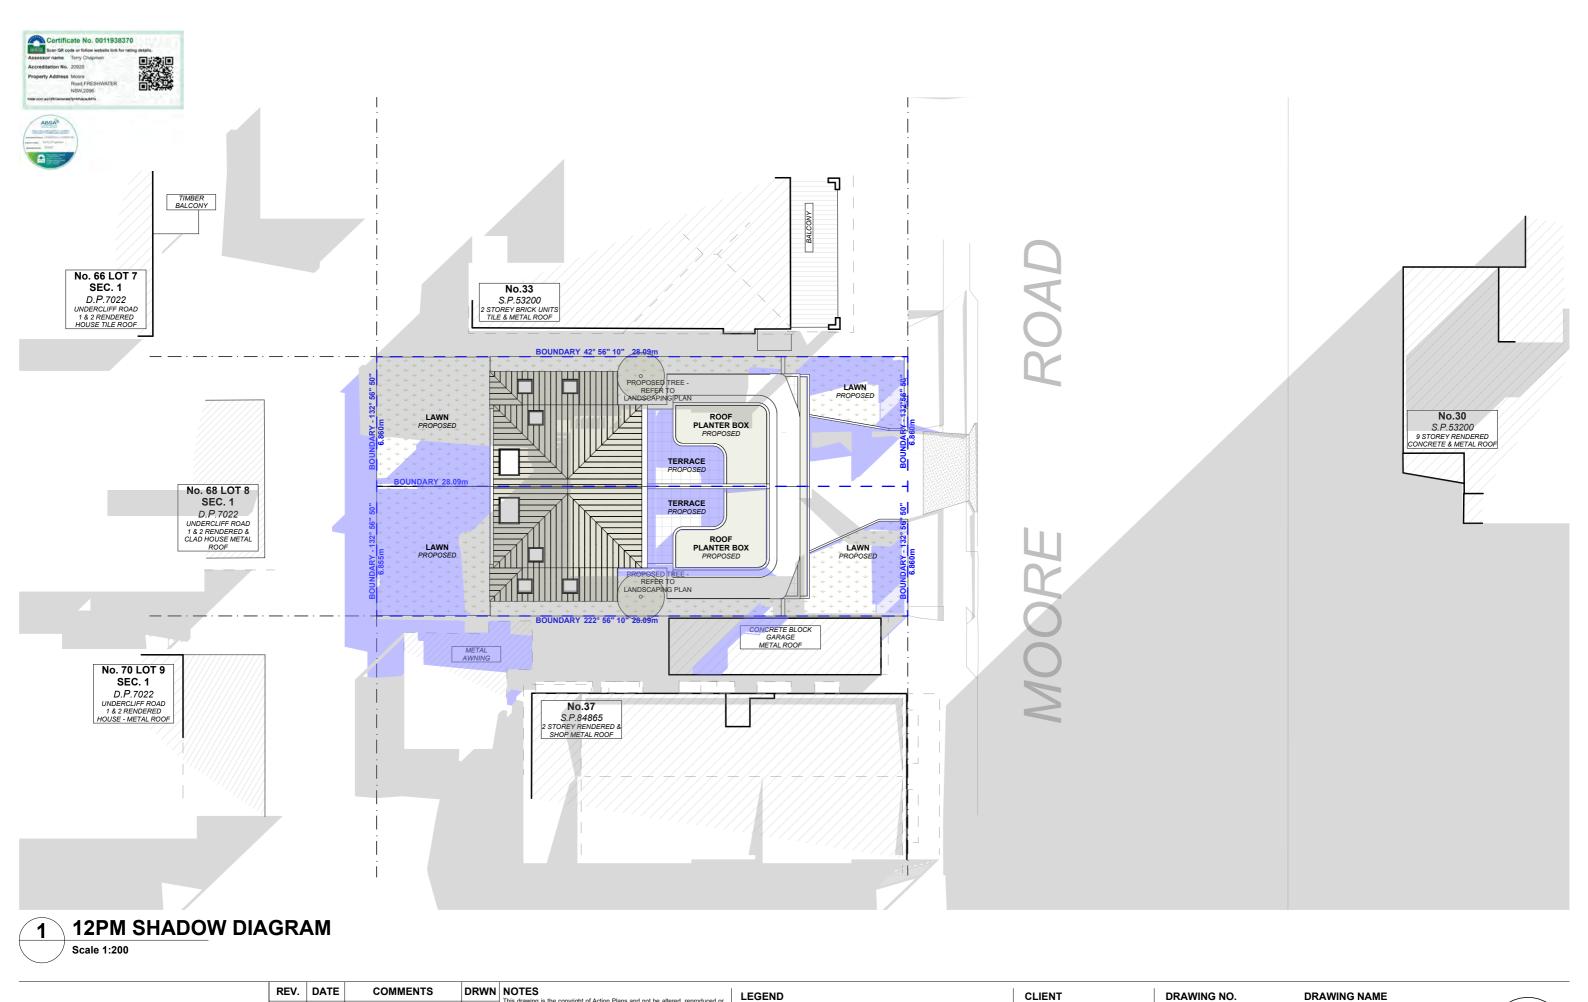

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DEVELOPMENT APPLICATION 05.06.2025

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components.

All errors and omissions are to be verified by the Builder/Contractor/client and referred to the designer prior to the commencement of works.

LEGEND

EXISTING SHADOWS PROPOSED SHADOWS

CLIENT Bill Derrin

PROJECT ADDRESS 35 Moore road, Freshwater, NSW 2096

DRAWING NO. **DA25**

Thursday, 5 June,


DATE


2025

WINTER SOLSTICE 12 PM

SCALE 1:200 @A3



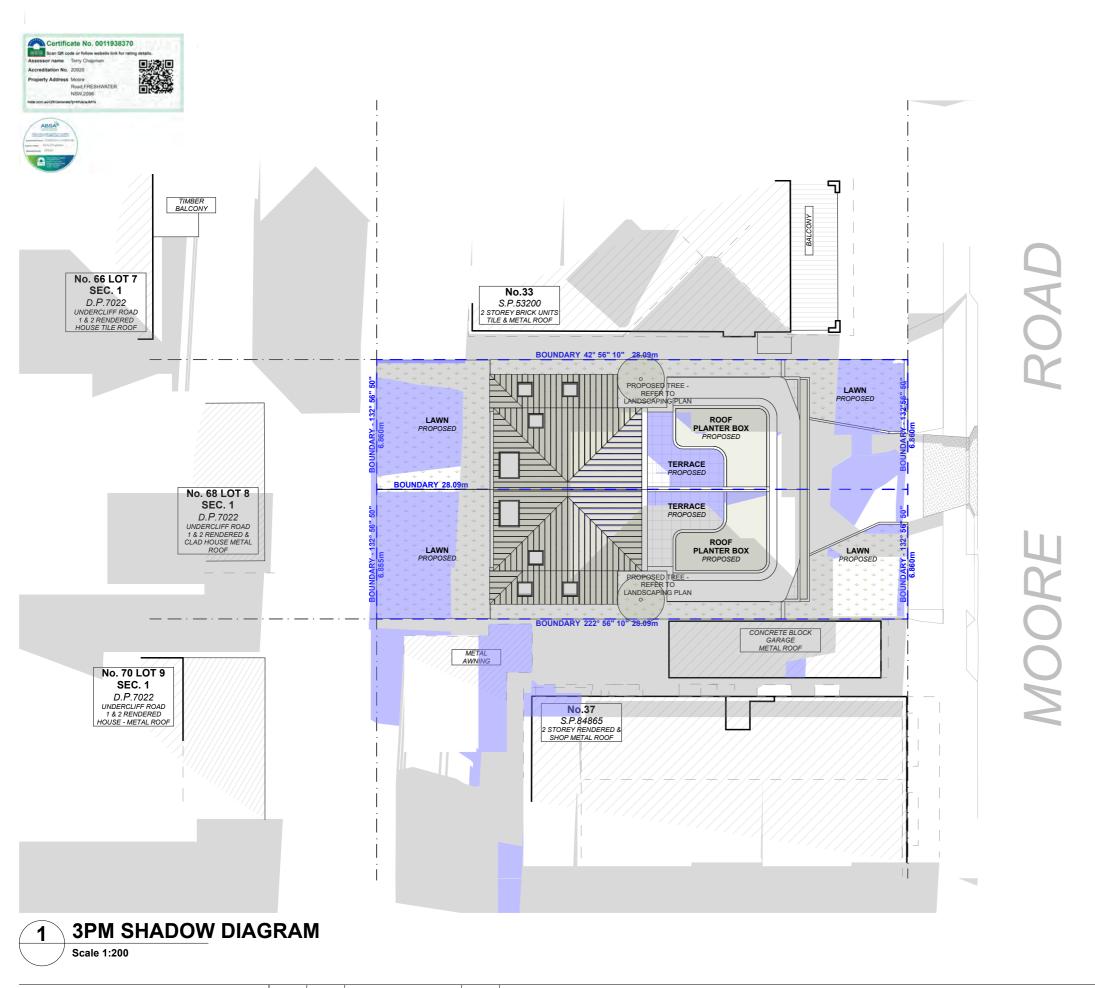

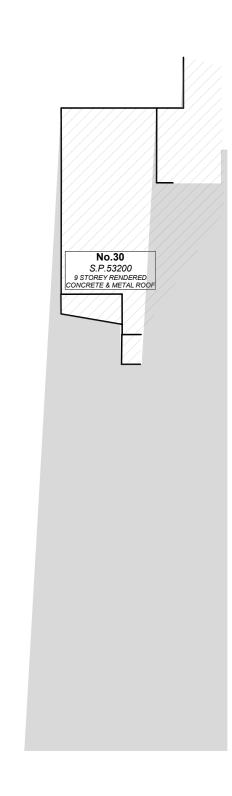

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-"	
4	

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				referred to the designer prior to the commencement of works.	

LEGEND

EXISTING SHADOWS

PROPOSED SHADOWS

CLIENT Bill Derrin


PROJECT ADDRESS 35 Moore road, Freshwater, NSW 2096 DA26

DATEThursday, 5 June, 2025

DRAWING NAMEWINTER SOLSTICE 3 PM

SCALE 1:200 @A3



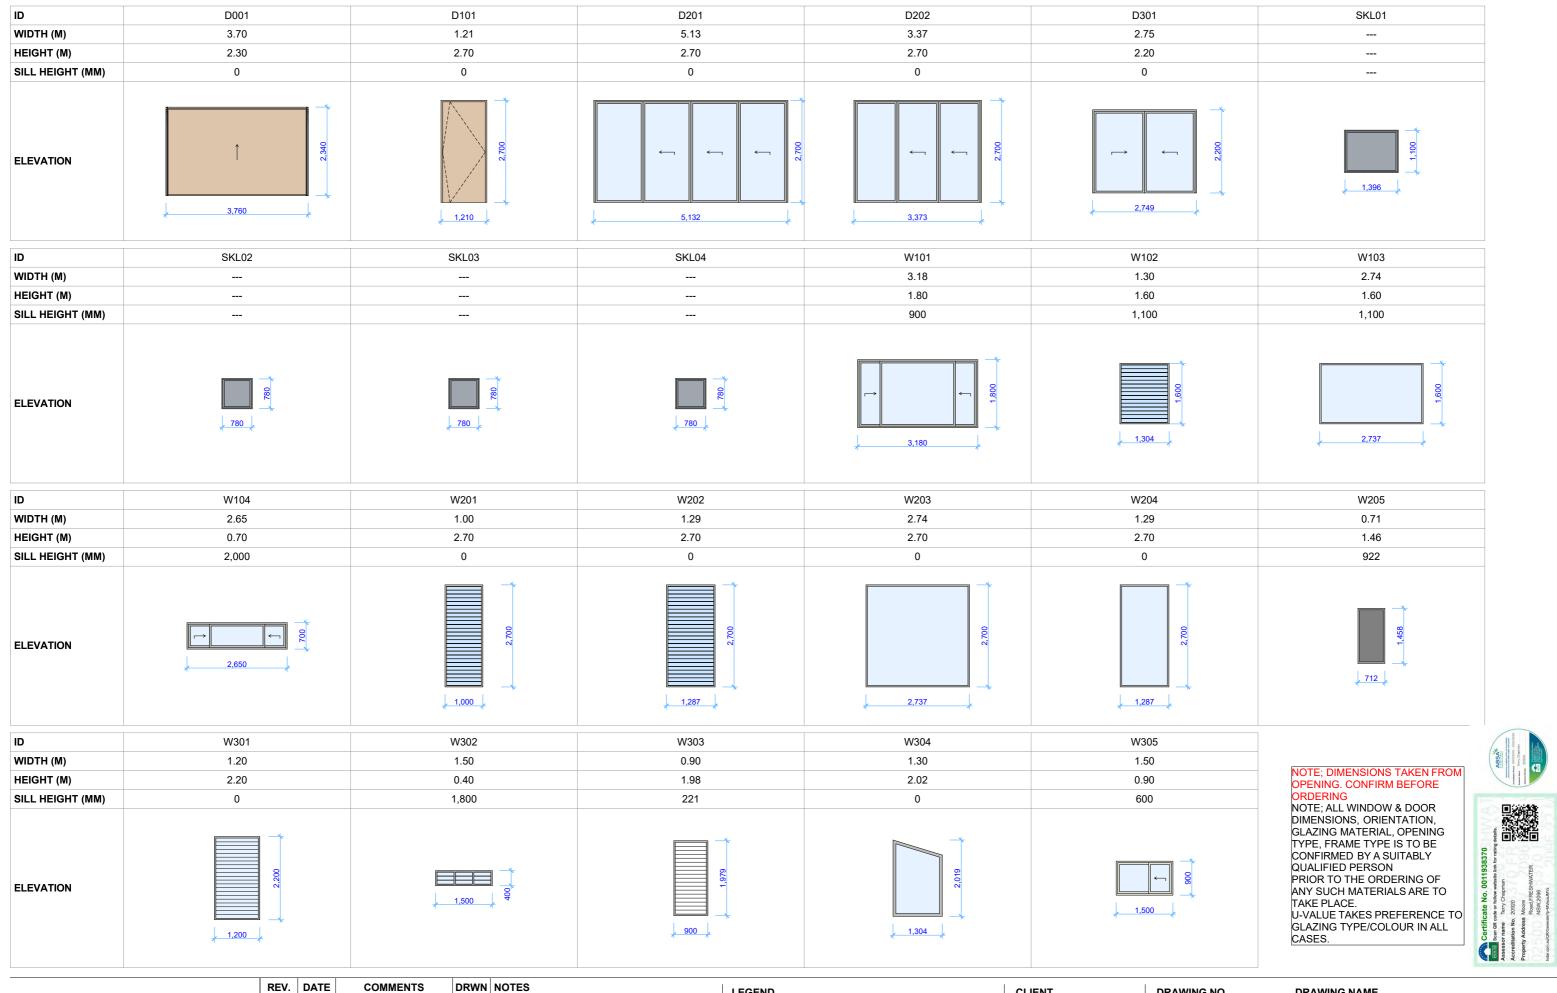



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	05.06.2025	DEVELOPMENT APPLICATION	AP	tra
				TI aı
				CC
				cc
				re

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LEGEND

CLIENT Bill Derrin

PROJECT ADDRESS

35 Moore road, Freshwater, NSW 2096

DRAWING NO. **DA27**

2025

DATE Thursday, 5 June, DRAWING NAME

WINDOW & DOOR SCHEDULE

SCALE @A3





			Besix Possiiromonts S		Aulti Du ollino			
Dual Occupancy			Basix Requirements S Prepared by Chapman Enviro			3		
35 Moore Road			www.basixcertificates.com.au					
Freshwater	NSW	2096	1300 004 914				CHA	PMAN
Water Target		40	Water Score		43			
Energy Target		72	Energy Score		72			
- 87 - 8								
Basix Commitments Total area of garden & lawn (m²) 78.5 ea Area of indigenous/low water use plants (m²) 0								
Landscaping	Landscaping Total area of garden & lawn (m²) 78.5 ea Area of indigenous/low water use plants (m²) 0							
Fixtures	Shower hea	ads	4 star (> 6 but <= 7.5 L/min)		Toilets	4 star	All taps	4 star
			, , ,					
	Minimum F	Rainwater tai	nk size (L) 2000 ea	Co	llect run off fr	rom roof area of at lea	st (m²)	43.6 ea
Alternative Water	Toilet co	onnection	Laundry connection	Landscane	connection	Pool top up	1	Spa top up
		'es	Yes		Yes	n/a		n/a
	Hat water o	u ct o m	Gas instantaneous			Rating 6 star		
	Hot water s		Individual fan, ducted to facado	e or roof			switch on/off	:
	Kitchen ver		Individual fan, ducted to facade				switch on/off	
	Laundry vei		Individual fan, ducted to facad	e or roof			switch on/off	
Energy	Cooling - liv		1-phase airconditioning			Rating EER 3.0 Rating EER 3.0		4
	Cooling - be		1-phase airconditioning 1-phase airconditioning			Rating EER 3.0 Rating EER 3.0		Zoned
	Heating - be		1-phase airconditioning			Rating EER 3.0		
	Alternate E		Photovoltaic system able to ge				watts of electi	
	Gas cookto	p & electric o	oven Outd	oor clothes	line required	N	o indoor cloth	esline required
		The	rmal Performance Assessment	Based on th	ne Following F	Requirements		
Floor Types	Concrete sl	ab on ground			No insulatio			
rioui Types	Suspended	concrete sla	b	with	R2.3 unders	lab insulation		
-1 4 .	Tiles	Wet Areas			Timber	Living Areas/ Bedroo	oms	
Floor Coverings	Carpet	n/a			Concrete	Garage		
	Dincel (200	mm) - Basen	nent Level	with	No insulatio	n required	Colour	Light
F 1 1347. II.			Framed - Ground & 1st Floor	with			Colour	
External Walls	Cavity brick	(with	R1.1 cavity	board	Colour	
	Timber framed Fibro clad on battens with Sarking and R2.5 bulk insulation Colour Ligh					Light		
Internal Walls	Plasterboar	rd		with	No insulatio	n required		
Party Walls	Dincel (200	mm) with pla	asterhoard					
Ceiling (floor over)	Concrete at	bove plasterl	poard	with		lab insulation - All bas		nternai ceilings
Ceilings (roof over)		bove plasterl		with		lab insulation - Exclud	e garage only	
ge (reer eren)	Timber above plasterboard. with R6.0 bulk insulation							
Roof	Metal			with	R1.3 roof bla		Colour	Medium
NOOI	Concrete			with	Waterproof	membrane only	Colour	Medium
	AF single gl	azed Comfor	rt Plus	Fixed Glass		BRD-041-001-001 U-V	alue 6.15 or les	s SHGC 0.74 +/- 5%
				Louvres		BRZ-006-009-001 U-V	alue 4.90 or less	s SHGC 0.46 +/- 5%
	to all windows and glazed doors unless noted otherwise		Sliding Wind		BRD-149-005-001 U-V		-	
	to all window	s and glazed do	oors unless noted otherwise	Sliding Doors	5	BRD-033-010-001 U-V	alue 4.30 or les	S SHGC 0.59 +/- 5%
Windows and Doors -								
Unit A		glazed clear		Sliding Doors	s	BRD-141-014-001 U-V		
	_	D201 & D202 o	only	Fixed Glass		BRD-153-040-001 U-V	alue 2.70 or les	s SHGC 0.53 +/- 5%
	Fixed Window	v - vv 103 only						
	AF = Aluminiu	ım Framed	TB = Thermally Broken Aluminium Fr	amed		TF = Timber Framed		
	AF single gl	azed Comfor	rt Plus	Fixed Glass		BRD-041-001-001 U-V	alue 6.15 or les	s SHGC 0.74 +/- 5%
				Louvres		BRZ-006-009-001 U-V		
				Sliding Wind		BRD-149-005-001 U-V		
Windows and Doors	to all window	s and glazed do	oors unless noted otherwise	Sliding Doors	S	BRD-033-010-001 U-V	alue 4.30 or les	s SHGC 0.59 +/- 5%
Windows and Doors -								
Unit B	AF double g	glazed clear		Sliding Doors	S	BRD-035-029-001 U-V	alue 2.70 or les	s SHGC 0.51 +/- 5%
	_	D201 & D202 o	-	Fixed Glass		BRD-153-040-001 U-V	alue 2.70 or les	s SHGC 0.53 +/- 5%
	Fixed Window	v - W103 & W2	03 only					
	AF = Aluminiu	ım Framed	ITB = Thermally Broken Aluminium Fr	l amed		TF = Timber Framed		
			dicates downlights, then these are to				<u>.</u>	
	-	-	to be fitted with self-closing dampers					
			be installed in accordance with Part 3					
	If there is a di	screpancy betv	veen this document and the Nathers C	ertificate, the	n the Nathers C	ertificate shall take preced	ence	
Notes	Ceiling Fans (1400mm) requi	red in the Dining Living Area x 2 & Ma	ster Bed				
		,						

This document to be read in conjunction with the Basix Certificate and Nathers Universal Certificate

LEGEND



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CLIENT
Bill Derrin

DRAWING NO.

DRAWING NAME
BASIX COMMITMENTS

SCALE

@A3

PROJECT ADDRESS

35 Moore road, Freshwater, NSW 2096 **DATE**Thursday, 5 June, 2025

BASIX COMMITMENT

BASIX™Certificate

Multi Dwelling




Project name	35 M	oore Road	
Street address	35 M	DORE ROAD FRESH	WATER 2096
Local Government Area	NOR	THERN BEACHES	
Plan type and plan number	Depo	sited Plan 7022	
Lot No.	15		
Section no.	1		
No. of residential flat buildings	0		
Residential flat buildings: no. of dwellings	0		
Multi-dwelling housing: no. of dwellings	2		
No. of single dwelling houses	0		
Project score			
Water	~	43	Target 4
Thermal Performance	~	Pass	Target P
Energy	~	72	Target 7
Materials	V	-42	Target n

ertificate Prepared by
ne / Company Name: CHAPMAN ENVIRONMENTAL SERVICES PTY LTD
N (if applicable):

Project address	
Project name	35 Moore Road
Street address	35 MOORE ROAD FRESHWATER 2096
Local Government Area	NORTHERN BEACHES
Plan type and plan number	Deposited Plan 7022
Lot No.	15
Section no.	1
Project type	
No. of residential flat buildings	0
Residential flat buildings: no. of dwellings	0
Multi-dwelling housing: no. of dwellings	2
No. of single dwelling houses	0

Common area lawn (m²)	0	
Common area garden (m²)	0	
Area of indigenous or low water use species (m²)	0	
Assessor details and therm	al loads	
Assessor number	20920	
Certificate number	0011938370	
Climate zone	56	
Project score		
Water	✓ 43	Target 40
Thermal Performance	✓ Pass	Target Pass
Energy	✔ 72	Target 72
Materials	✓ -42	Target n/a

Description of project		

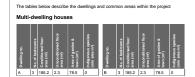

No common areas specified.

Schedule	of	BASIX	commitments

ne commitments set out below regulate how the proposed development is to be carriedout. It is a condition of any develop evelopment certificate issued, for the proposed development, that BASIX commitments be complied with.	ment consen	granted, or complying	19
Commitments for multi-dwelling housing			
) Dwellings			
i) Water	Show on DA plans	Show on CC/CDC plans & specs	Certifier check
a) The applicant must comply with the commitments listed below in carrying out the development of a dwelling listed in a table below.			
b) The applicant must plant indigenous or low water use species of vegetation throughout the area of land specified for the dwelling in the "Indigenous species" column of the table below, as private landscaping for that dwelling. (This area of indigenous vegetation is to be contained within the "Area of garden and lawn" for the dwelling specified in the "Description of Project" table).	~	~	
c) If a rating is specified in the table below for a fixture or appliance to be installed in the dwelling, the applicant must ensure that each such fixture and appliance meets the rating specified for it.		~	-
d) The applicant must install an on demand hot water recirculation system which regulates all hot water use throughout the dwelling, where indicated for a dwelling in the "HW recirculation or diversion" column of the table below.		V	-
e) The applicant must install:			
(aa) a hot water diversion system to all showers, kitchen sinks and all basins in the dwelling, where indicated for a dwelling in the "HW recirculation or diversion" column of the table below; and			v
(bb) a separate diversion tank (or tanks) connected to the hot water diversion systems of at least 100 litres. The applicant must connect the hot water diversion tank to all toilets in the dwelling.		•	-
 e) The applicant must not install a private swimming pool or spa for the dwelling, with a volume exceeding that specified for it in the table below. 	V	~	
) If specified in the table, that pool or spa (or both) must have a pool cover or shading (or both).		~	
g) The pool or spa must be located as specified in the table.	~	~	
h) The applicant must install, for the dwelling, each alternative water supply system, with the specified size, listed for that dwelling in the table below. Each system must be configured to collect run-off from the areas specified (excluding any area which supplies any other alternative water supply system), and to divent overflow as specified. Each system must be connected as specified.	~	~	~

					_	
ASIX	Department of Planning, Housing and Infrastructure	www.basix.nsw.gov.au	Version: 4.03 / EUCALYPTUS_03_01_0	Certificate No.: 1796655M	Thursday, 22 May 2025	page 6/16

	Pixtures					Appliances individual pool								illulviddal spa		
Dwelling no.	All shor hear		All toilet flushing systems	All kitchen taps	All bathroom taps	HW recirculation or diversion	All clothes washers	All dish- washers	Volume (max volume)	Pool cover	Pool locatio		ool haded	Volume (max volume	cover	Spa shaded
All dwellings		= 7.5	4 star	4 star	4 star	-	-	-	-	-	-	-		-	-	-
								Alternati	ve water sou	irce						
Dwelling	no.		native wat ly systems		Size	Configur	ration			Landso	tion	Toilet connecti (s)		indry inection	Pool top- up	Spa top-up
All dwelling	Il deellings Individual water tank (No. Tank size (min) 2000 Tank size (min) 2000 43.6 square meters of norla sace, 43.6 square meters of norla sace, 43.6 square meters of norla sace, 63.6 square meters of norla meters of normal sace, 63.6 square mete							es	yes		no	no				
(ii) Energ	ly .												Show on DA plans		w on CC/CDC s & specs	Certifier check
(b) The application central	pplica ied by al syste	nt mus that sy em to t	t install eac stem. If the he dwelling	h hot wat table spe , so that t	er system spe ecifies a centr he dwelling's	ted below in car scified for the di all hot water sys hot water is sup	welling in the stem for the d pplied by that	table below, s welling, then to central system	to that the dw the applicant m.	elling's ho must con	ot water in nect that	s	~		•	~
						and laundry of have the operat				cified for t	hat room	in			•	V
(in) The applicant must install the cooling year heating systems has specified for the desting under the "Living seess" and "Redoction seess" on the cooling of the state of the cooling of the state of										~						
between living areas and bedrooms. (e) This commitment applies to each room or area of the dwelling which is referred to in a heading to the "Artificial lighting" column of the table below (but only to the existent specified for flast room or area). The applicant must ensure that the "primary type of artificial lighting" for each such room in the dwelling is fluorecent lighting or light ensuring dode (ELD) displays. If the term "bedscated" is specified for a postfular sorror or area, here the right filtings in ant room or area must only be capitally of the group used for fluorecent and the specified for a postful arror or area in that room or area must only be capitally of the group used for fluorecent and the specified for a postful arror or area.										~						

	, , , , , , , , , , , , , , , , , , , ,						
BASIX	Department of Planning, Housing and	www.basix.nsw.gov.au	Version: 4.03 / EUCALYPTUS_03_01_0	Certificate No.: 1796655M	Thursday, 22 May 2025	page 7/1	16

(ii) Energy									Show o		Show on (plans & sp		Certifier check
the tab	le below (t		lighting' column of uch room or area is	~			•	~					
(g) This co	mmitment	applies if the a	pplicant installs	a water h	eating system for the	dwel	ling's pool or spa. The ap	pplicant must:					
(aa							e table below (or alternation control the pool's pump; as			-		•	
(bb							table below (or alternative introl the spa's pump.	ely must not install			•	•	
(h) The ap	plicant mu	st install in the	dwelling:										
(aa) the kitch table be	en cook-top and low;	oven specified	for that d	welling in the "Appliar	nces	& other efficiency measur	res" column of the			V	•	
	the table	e, and ensure th	at the appliance	e has that	minimum rating; and		nces & other efficiency m				· •		-
(cc)	any cloth	es drying line s	pecified for the	dwelling ir	n the "Appliances & ot	ther e	efficiency measures" colu	mn of the table.			•	•	
(i) If specifi ventilat		table, the applic	ant must carry	out the de	velopment so that each	ch re	frigerator space in the dw	elling is "well			v	•	
							e "Photovoltaic system" h ling's electrical system.	eading of the	~		·	•	~
	Н	ot water	Bath	room ven	tilation system		Kitchen ventil	lation system		Laur	ndry vent	ilation sys	stem
Dwelling no.	Hot wat	er system	Each bathro	om	Operation control		Each kitchen	Operation control	Each I	aundry		Operation	on control
All dwellings	gas insta star	intaneous - 6	individual fan, to façade or ro		manual switch on/of	f	individual fan, ducted to façade or roof	manual switch on/off	individu to faça			manual s	witch on/off
			Coo	ling			He	sating			Nati	ural lightir	ng
Dwelling r	10.	living areas		bedroor	n areas	livi	ing areas	bedroom areas		No. o	f bathroo lets	ms M	ain kitchen
All dwelling		1-phase aircond	Dissing	1-nhace	airconditioning -	1.0	hase airconditioning -	1-nhase aircondition		2		ve	

relling no.	Photovoltaic s output in peak	ystem (min rated electr kW)	rical	Photovoltaic collector installation	Orientatio	n inputs	
twellings	-				-		
Thermal Performance a	nd Materials				Show on DA plans	Show on CC/CDC plans & specs	Certifier check
"Assessor Certificate") to the applicant is applying fi	the development applica or a complying developn	tion and construction cer tent certificate for the pro	rtificate ap oposed de	ront page of this BASIX certificate (the plication for the proposed development (or, if velopment, to that application). The applicant lificate for the proposed development.			
The Assessor Certificate	must have been issued b	y an Accredited Assesso	or in accor	dance with the Thermal Comfort Protocol.			
The details of the propose Certificate, including the d				tent with the details shown in this BASIX			
	ocol requires to be show	n on those plans. Those		r the proposed development, all matters which st bear a stamp of endorsement from the	~		
	all thermal performance :	specifications set out in the		on certificate (or complying development or Certificate, and all aspects of the proposed		~	
	ance with those aspects	of the development appli		ance specifications set out in the Assessor application for a complying development		~	~
Where there is an in-slab	heating or cooling system	m, the applicant must:			~	~	~
(aa) Install insulation v	with an R-value of not les	s than 1.0 around the ve	ertical edge	es of the perimeter of the slab; or			
Department of Planning, I	Unuring and use	v.basix.nsw.gov.au Vers	sinn: 4 f/3 / l	EUCALYPTUS 03 01 0 Certificate No.: 17966	55M 1	Thursday, 22 May 2025	D800

III) I nermai Performan	ce and Materials		Show on DA plans	Show on CC/CDC plans & specs	Certifier check
	ded floor, install insulation with an R-value of not less than 1 perimeter of the slab.	.0 underneath the slab and around the vertical			
(h) The applicant must o	onstruct the floors and walls of the development in accordan	ce with the specifications listed in the table below.	~	~	-
(i) The applicant must show on The plans accompanying The development application for The proposed development, The locations of ceiling fans set out in The Assessor Certificate.					
The applicant must sh certificate, if applicab	ow on the plans accompanying the application for a construitle), the locations of ceiling fans set out in the Assessor Certi	ction certificate (or complying development ficate.		~	
		Thermal loads			
Dwelling no.	Area adjusted heating load (in MJ/m ² /yr)	Area adjusted cooling load (in MJ/m²/yr)	Area adju	sted total load (in MJ/	m²/yr)
	16.5	29 200			


Dwelling no.							Thermal loads				
Dweiling no.		Area :	adjusted hea	ting load (in MJ/m	i²lyr) .	Area adjusted	cooling load (in l	MJ/m²/yr)	Area adjuste	d total load (ii	n MJ/m²/yr)
All other dwellin	ngs	17.3			1	11.6			28.900		
						Construction	f floors and wall				
	-			Suspended floor		Suspended		Suspended			rammed earth or
Dwelling no.	(m²)	crete slab on	ground	Suspended floor subfloor (m²)	with open	enclosed su		garage (m²)	floor above	mudbrick	
All dwellings	87.6			3		-		57.1		no	
	Floor type:										
	1		ete slab on g	round		Suspended flo	or above enclos	ed subfloor	Suspende	d floor above	open subfloor
Dwelling no.	Area (m²)	Insulation	Low emissic option	Demateria		Construction	Area (m²) I	Insulation	Construction type	Area (m²	Insulation
All dwellings	87.6			convention	al slab -				concrete - suspended	3	polystyrene
	Floor types										
		loor above hat oms or mezzan		Suspend	ed floor abo	we garage			Garage floo	r	
Dwelling	Construction	Area (m²)	Insulation	Construction type	Area (m²)	Insulation	Construction type	Area (m²)	Insulation	Low	Dematerialisatio
no.	type									option	
no. All dwellings		117.8	-	concrete - suspended	57.1	polystyrene	concrete slab on ground	87.6	-		conventional slab
no. All dwellings	type concrete -	1	-	concrete -	57.1	polystyrene	concrete slab	87.6	-		conventional slab
no. All dwellings	type concrete - suspended	1	- Exten	concrete -	57.1	polystyrene	concrete slab		- external wall typ	option	conventional slab
no. All dwellings	type concrete - suspended	al walls	Exten	concrete - suspended		r emissions	concrete slab			option	conventional slab

	External walls									
		Exter	mal wall type 1					External wa	all type 2	
Dwelling no.	Wall type	Area (m²)	Insulation	Low emis	sions \	Wall type	Area	(m²)	Insulation	Low emissions option
						H2 treated oftwood				
	External walls									
		Exter	rnal wall type 3					External wa	all type 4	
Dwelling no.	Wall type	Area (m²)	Insulation	Low emis	sions 1	Wall type	Area	(m²)	Insulation	Low emissions option
All dwellings	cavity brick	30.3	polystyrene	none	o b	amed (fibre ement sheet or oards), frame : mber - H2 eated softwood	62		fibreglass batts or roll	none
	Internal walls									
	Interna	I walls shared wi	th garage		Internal wa	II type 1			Internal wall ty	ype 2
Dwelling no.	Wall type	Area (m²)	Insulation	Wall type	Area (m²) Insulati	on	Wall type	Area (m²)	Insulation
All dwellings	-	-	-	plasterboard, frame: timber - H2 treated softwood	117.8	-		-	-	-
	Ceiling and roo	f								
	Fla	t ceiling / pitched	roof	Raked cei	iling / pitch	ed or skillion ro	of		Flat ceiling / fla	at roof
Dwelling no.	Construction type	Area (m²)	Insulation	Construction type	Area (m²) Insulati	on	Construction type	Area (m²)	Insulation
All dwellings	framed - metal roof, frame: timber - H2 treated	43.6	Ceiling:fibreglass batts or roll,Roof: foil backed blanket	-	-	Ceiling:,I	Roof:	concrete - plasterboard internal	28.9	Ceiling:polystyrer none

ı			Glazing type				Frame types		
I		Single glazing (m²)	Double glazing (m²)	Triple glazing (m²)	Aluminium frames (m²)	Timber frames (m²)	uPVC frames (m²)	Steel frames (m²)	Composite frames (m²)
	All dwellings	46	23	-	69	-	-		

(i) Water					Show on DA plans	Show on CC/CDC plans & specs	Certifie
	g out the development, the applica seet the specifications listed for it i	ant installs a showerhead, toilet, tap n the table.	or clothes washer into a common	area, then that		~	~
	systems" column of the table belo	development is serviced by) the alte low. In each case, the system must be			~	~	~
(c) A swimming pool or spa listed in the table must not have a volume (in kLs) greater than that specified for the pool or spa in the table.						_	
(d) A pool or spa listed in the table must have a cover or shading if specified for the pool or spa in the table.						_	
(e) The applican	nt must install each fire sprinkler s	system listed in the table so that the	system is configured as specified	n the table.		_	-
(f) The applican	t must ensure that the central coo	ling system for a cooling tower is co	onfigured as specified in the table.				
Common area	Showerheads rating	Toilets rating	Taps rating	CI	othes washer	s rating	_
All common	Showerheads rating no common facility	Toilets rating no common facility	Taps rating no common facility		othes washer		
Common area All common areas					common launc	try facility	
All common areas							Certifi
All common areas (ii) Energy (a) If, in carrying	no common facility g out the development, the applica		no common facility	no the table below,	Show on DA plans	lry facility Show on CC/CDC	
All common areas (ii) Energy (a) If, in carrying then that ver (b) In carrying of in the table is	no common facility gout the development, the applicantialisation system must be of the typ ut the development, the applicant below, the lighting specified for thus statabo install a centralised lightin	no common facility	no common facility ervice a common area specified in and must meet the efficiency meas ratificial lighting for each common meet the efficiency measure speci	the table below, ure specified.	Show on DA plans	Show on CC/CDC plans & specs	check

Central energy systems Type Specification	
Other	

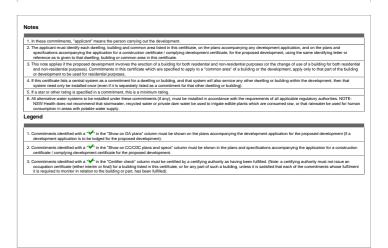





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REV.	DATE	COMMENTS	DRWN
	05.06.2025	DEVELOPMENT APPLICATION	AP
	REV.	05.06.2025	

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The Builder/Contractor shall check and verify ALL dimensions on site prior to commencement of any work, creation of shop drawings, or fabrication of components. All errors and omissions are to be verified by the Builder/Contractor/client and referred to the designer prior to the commencement of works. All window & door dimensions, orientation, glazing materials, opening types, frame types are to be confirmed by a suitably qualified person prior to the ordering of any such materials are to take place. U value takes precedence over glazing type/colour in all cases. all new glazing must meet the BASIX specified frame and glass type, *QR* meet the ecified U value and SHGC value.

CLIENT

Bill Derrin

PROJECT ADDRESS 35 Moore road,


Freshwater, NSW 2096

DA29

DRAWING NAME BASIX COMMITMENTS

DATE Thursday, 5 June, 2025

DRAWING NO.

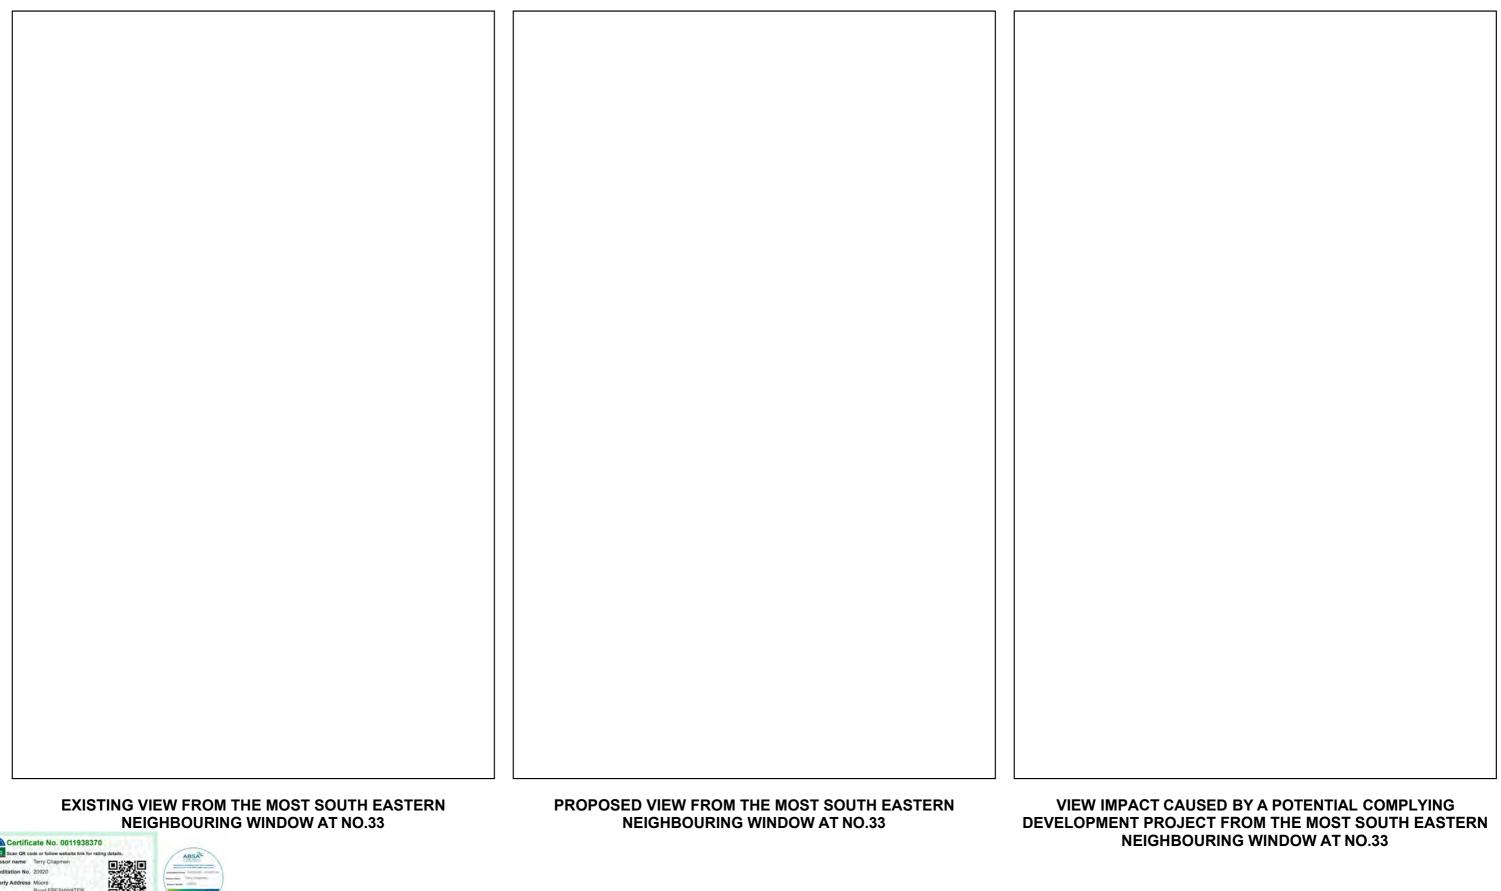



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			REV.	DATE	COMMENTS	DRWN	-
	ACTIO	N PLANS		05.06.2025	DEVELOPMENT APPLICATION	AP	
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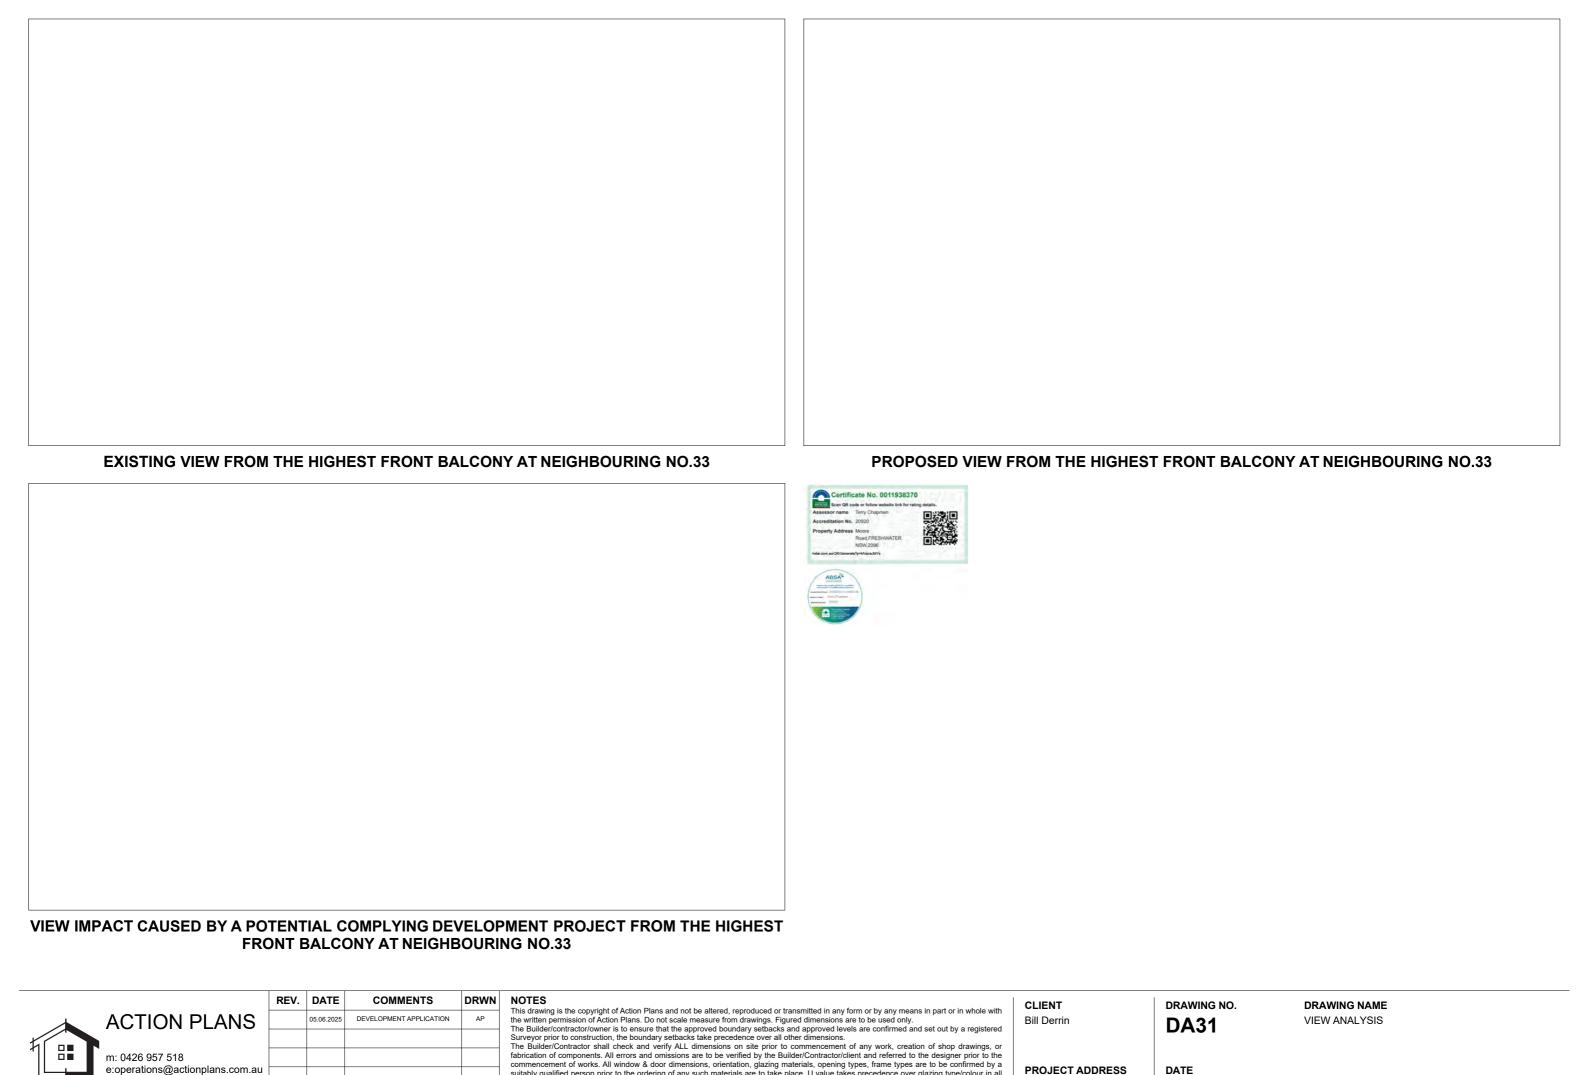
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cases, all new glazing must meet the BASIX specified frame and glass type, QR meet the ecified U value and SHGC value.
* * * * * * * * * * * * * * * * * * *

CLIENT	DRAWING NO.
Bill Derrin	DA30

DRAWING NAME VIEW ANALYSIS

PROJECT ADDRESS 35 Moore road, Freshwater, NSW 2096

DATE Thursday, 5 June, 2025



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PROJECT ADDRESS

Freshwater, NSW 2096

35 Moore road,

DATE

2025

Thursday, 5 June,

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