



# **ACTION PLANS**

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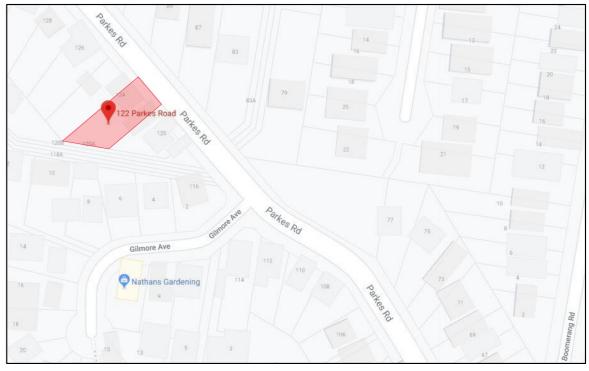
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## **DEVELOPMENT APPLICATION**

These plans are for Development Approval only.

SHEET NUMBER	SHEET NAME	DATE PUBLISHED
DA00	COVER	18/12/2019
DA01	SITE ANALYSIS	18/12/2019
DA02	SITE / ROOF / SEDIMENT EROSION / WASTE MANAGEMENT / STORMWATER CONCEPT PLAN	18/12/2019
DA03	EXISTING LOWER GROUND FLOOR PLAN	18/12/2019
DA04	EXISTING GROUND FLOOR PLAN	18/12/2019
DA05	PROPOSED LOWER GROUND FLOOR PLAN	18/12/2019
DA06	PROPOSED GROUND FLOOR PLAN	18/12/2019
DA07	NORTH / EAST ELEVATION	18/12/2019
DA08	SOUTH / WEST ELEVATION	18/12/2019
DA09	LONG / CROSS SECTION	18/12/2019
DA10	AREA CALCULATIONS	18/12/2019
DA11	SAMPLE BOARD	18/12/2019
DA12	POOL PLAN	18/12/2019
DA13	WINTER SOLSTICE 9 AM	18/12/2019
DA14	WINTER SOLSTICE 12 PM	18/12/2019
DA15	WINTER SOLSTICE 3 PM	18/12/2019
DA16	BASIX COMMITMENTS	18/12/2019

ITEM DETAILS	DEVELOPMENT APPLICATION					
ADDRESS	122 PARKES ROAD, COLLAROY PLATEAU NSW 2097					
LOT & DP/SP	LOT 18 DP 24705					
COUNCIL	NORTHERN BEACHES COUNCIL (WARRINGAH)					
SITE AREA	701.88m²					
FRONTAGE	18.290m					
CONTROLS	PERMISSIBLE / REQUIRED	EXISTING	PROPOSED	COMPLIANCE		
CONTROLS	m/m²/%	m / m² / %	m / m² / %			
<u>LEP</u>						
LAND ZONING	R2 – LOW DENSITY RESIDENTIAL	R2	R2	YES		
MINIMUM LOT SIZE	600m²	701.88m <sup>2</sup> N/A	UNCHANGED	YES		
FLOOR SPACE RATIO	NOT IDENTIFEID	N/A				
MAXIMUM BUILDING HEIGHT	8.5m 7.49m UNCHANGED YES					
<u>HAZARDS</u>						
DEVELOPMENT ON SLOPING LAND	LANDSLIP AREA: D Collaroy Plateau Area flanking slopes 5 - 15 degrees	N/A	N/A	Please read in conjunction with the Statement of Environmental Effects		
<u>DCP</u>						
WALL HEIGHT	7.2m	7.1m	UNCHANGED	YES		
NUMBER OF STOREYS	N/A	2	UNCHANGED	N/A		
SIDE BOUNDARY ENVELOPE 4m						
SIDE BOUNDARY SETBACKS 0.9m		N: 1.748m S: 1.635m	UNCHANGED	YES		
FRONT BOUNDARY SETBACK	6.5m	5.992m	UNCHANGED	NO (EXISTING)		
REAR BOUNDARY SETBACK	REAR BOUNDARY SETBACK 6.0m			YES		
LANDSCAPE OPEN SPACE	40% (280.75m²)	64.17% (450.42m²)	51.47% (361.29m2)	YES		
PRIVATE OPEN SPACE	60m <sup>2</sup>	60m²	64.45m <sup>2</sup>	YES		



#### NCC & AS COMPLIANCES SPECIFICATIONS

- EARTHWORKS - PART 3.1.1 OF NCC - EARTH RETAINING STRUCTURES - PART 3.1.2 OF NCC - DRAINAGE - PART 3.1.3 OF NCC - TERMITE-RISK MANAGEMENT - PART 3.1.4 OF NCC - FOOTINGS & SLAB - PART 3.2 OF NCC INCLUDING AS2870 - MASONRY - PART 3.3 OF NCC INCLUDING AS3700 - FRAMING - PART 3.4 OF NCC - SUB FLOOR VENTILATION - PART 3.4.1 OF NCC - ROOF CLADDING AND WALL-CLADDING - PART 3.5 OF NCC - GLAZING - PART 3.6 OF NCC INCLUDING AS1288 - FIRE SAFETY - PART 3.7 OF NCC - FIRE SEPERATION - PART 3.7.2 OF NCC - FIRE PROTECTION OF SEPERATING WALLS AND FLOORS- PART 3.7.3 OF NCC - SMOKE ALARMS - PART 3.7.5 OF NCC - WET AREAS AND EXTERNAL WATERPROOFING - PART 3.8.1 OF NCC - ROOM HEIGHTS - PART 3.8.2 OF NCC - FACILITIES - PART 3.8.3 OF NCC - LIGHT - PART 3.8.4 OF NCC - VENTILATION - PART 3.8.5 OF NCC - SOUND INSULATION - PART 3.8.6 OF NCC - STAIRWAYAND RAMP CONSTRUCTION - PART 3.9.1 OF NCC - BARRIERS AND HANDRAILS - PART 3.9.2 OF NCC - SWIMMING POOLS - PART 3.10.1 OF NCC - CONSTRUCTION IN BUSHFIRE PRONE AREAS - PART 3.10.5 OF NCC - FENCING & OTHER PROVISIONS - REGS & AS1926

DEMOLITION WORKS - AS2601-1991 THE DEMOLITION OF STRUCTURES.
 ALL WATERPROOF MEMBRANES TO COMPLY WITH WITH AS 3740-2010

- ALL STRUCTURAL STEEL WORK TO COMPLY WITH AS 4100 & AS 1554

- ALL CERAMIC TILING TO COMPLY WITH AS 3958.1-2007 & 3958.2-1992

- ALL TIMBER RETAINING WALLS ARE TO COMPLY WITH AS 1720.1-2010,

- ALL RETAINING WALLS ARE TO COMPLY WITH 3700 - 2011 & AS 3600 -2009

- ALL PLUMBING & DRAINAGE WORK TO COMPLY WITH AS 3500

- ALL PLASTERBOARD WORK TO COMPLY WITH AS 2588-1998

- ALL ROOF SHEETING WORK TO COMPLY WITH AS 1562-1992 - ALL SKYLIGHTS TO COMPLY WITH WITH AS 4285-2007


- ALL GLAZING ASSEMBLIES TO COMPLY WITH AS2047 & 1288

AS 1720.2-2006, AS 1720.4-2006, AS 1170.1-1989 & AS 1170.4-2007

- ALL CONCRETE WORK TO COMPLY WITH AS 3600

- ALL CONSTRUCTION TO COMPLY TO AS3959- 2009

- SITE CLASSIFICATION AS TO AS 2870

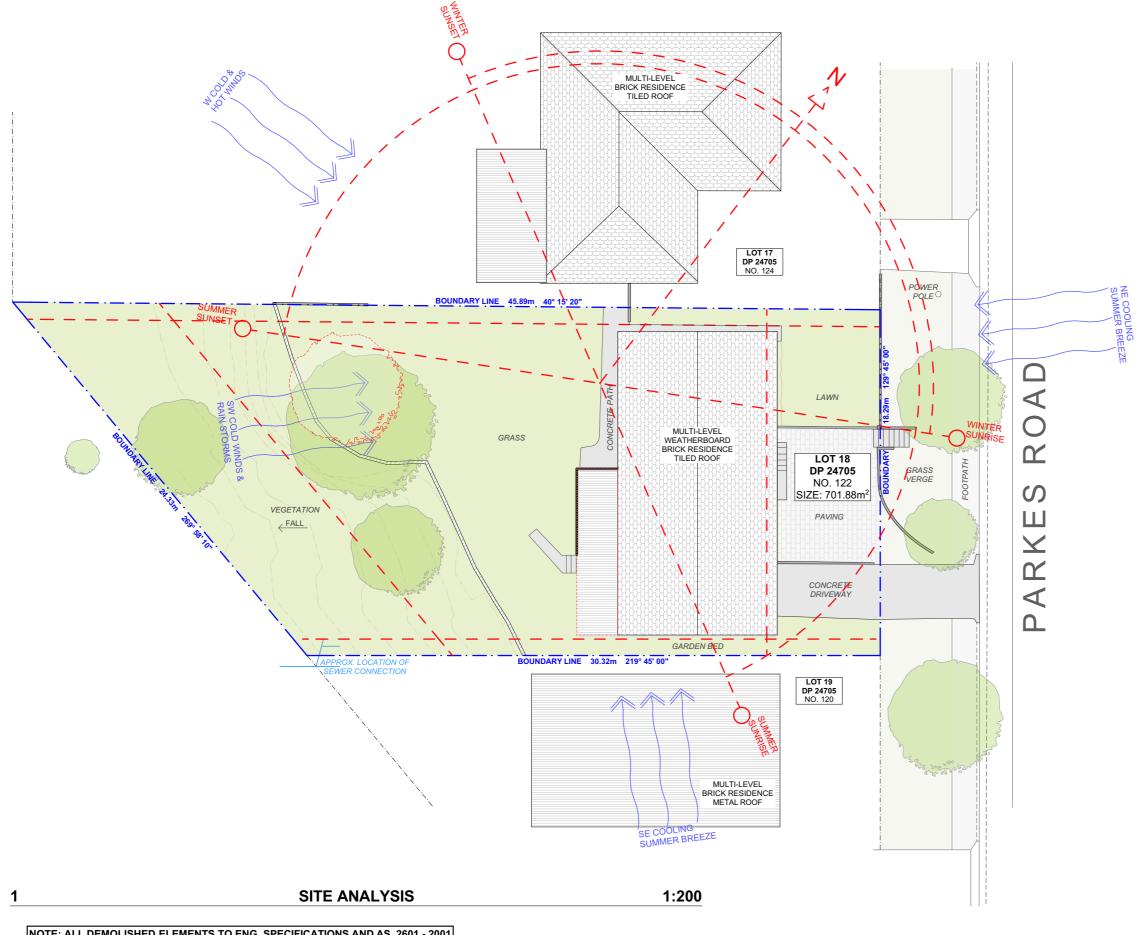








DRAWING NAME

NOTE: ALL DEMOLISHED ELEMENTS TO ENG. SPECIFICATIONS AND AS. 2601 - 2001



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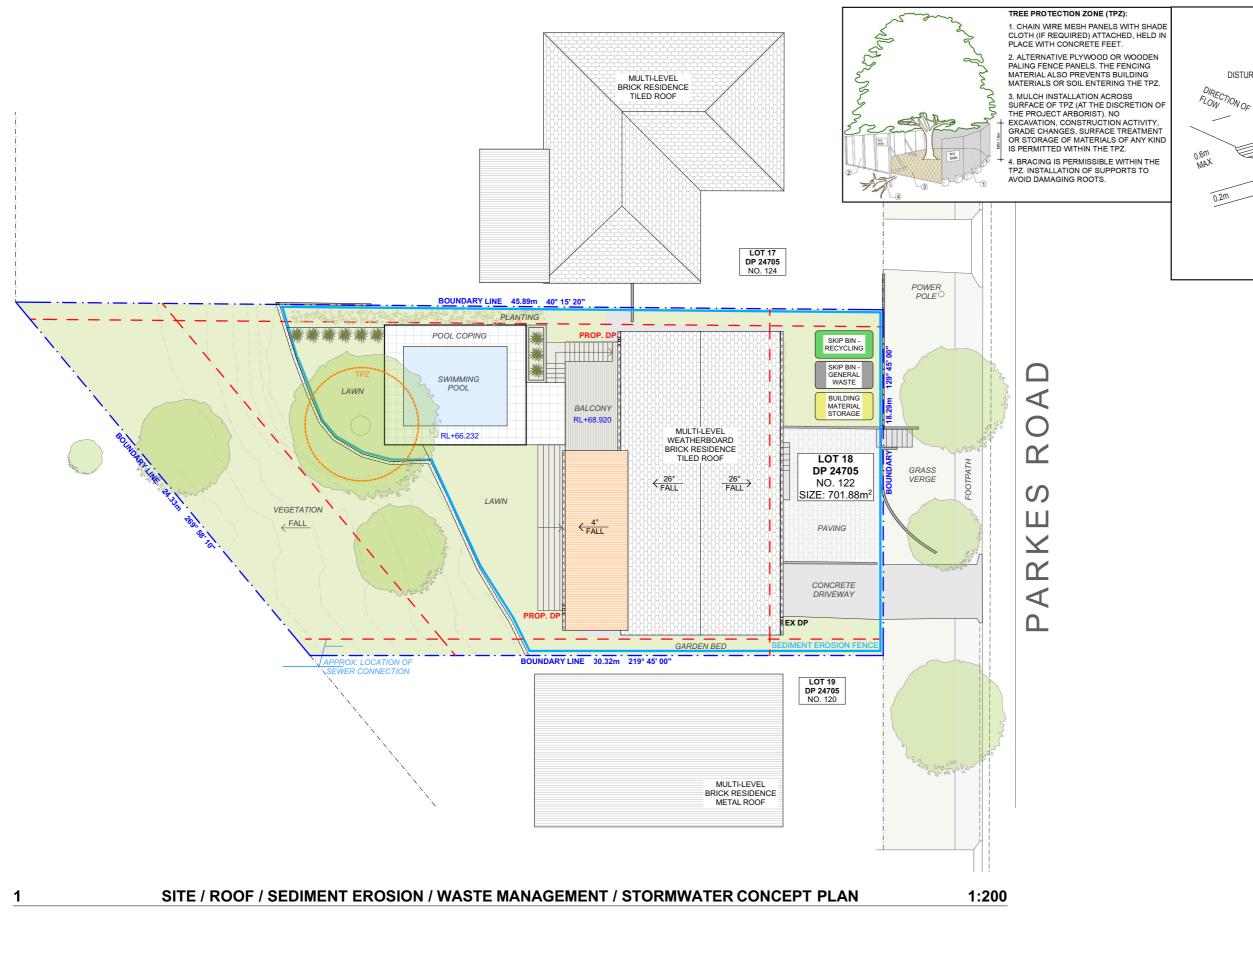
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Wednesday, 18 December 2019

DA01	SITE ANALYSIS
DATE	

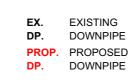



DISTURBED AREA

DISTURBED AREA

DISTURBED AREA

DISTURBED AREA

POSTS DRIVEN
0.6m INTO
GROUND

WIRE OR STEEL MESH
(WHERE REQUIRED)

V UNDISTURBED
AREA

V

SEDIMENT FENCE

#### DUST CONTROL:

TO REDUCE DUST GENERATED BY WIND ACTION, THE REMOVAL OF THE TOP SOIL IS TO BE MINIMISED. TO PREVENT DUST GENERATION, WATERING DOWN OF THE SITE, ESPECIALLY DURING THE MOVEMENT OF MACHINERY IS REQUIRED. WHERE EXCAVATING INTO ROCK, KEEP THE SURFACE MOIST TO MINIMISE DUST. CONSTRUCT A GRAVEL ENTRY/EXIT POINT USING BLUE METAL AND RESTRICT ALL VEHICLE MOVEMENTS WITHIN THE SITE TO A MINIMUM. ENSURE WIND BREAKS, SUCH AS EXISTING FENCES ARE MAINTAINED DURING THE CONSTRUCTION PHASE UNTIL NEW LANDSCAPING IS PROVIDED OR REINSTATED. PREVENT DUST BY COVERING STOCKPILES

#### SEDIMENT NOTE:

1. ALL EROSION AND SEDIMENT CONTROL MEASURES TO BE INSPECTED AND MAINTAINED DAILY BY THE SITE MANAGER.

2. MINIMISE DISTURBED AREAS, REMOVE EXCESS SOIL FROM EXCAVATED AREA AS SOON AS POSSIBLE.
3. ALL MATERIAL STOCKPILE TO BE CLEAR FROM DRAINS, GUTTERS AND FOOTPATHS, OR WITHIN SEDIMENT FENCE AREA.

4. DRAINAGE TO BE CONNECTED TO STORMWATER AS SOON AS POSSIBLE. IF STORED ON SITE, IT MUST BE FILTERED BEFORE RELEASING INTO STORMWATER SYSTEM OR WATERWAYS.

 $5.\ \mbox{ROADS}$  AND FOOTPATHS TO BE SWEPT DAILY.

#### STOCKPILES:

ALL STOCKPILES ARE TO BE KEPT ON-SITE WHERE POSSIBLE. ANY MATERIALS PLACED ON THE FOOTPATHS OR NATURE STRIPS REQUIRE COUNCIL'S PERMISSION

ALL STOCKPILES ARE TO BE PLACED AWAY FROM THE DRAINAGE LINES AND STREET GUTTERS. IT IS BEST TO LOCATE THESE ON THE HIGHEST PART OF THE SITE IF POSSIBLE. PLACE WATERPROOF COVERING OVER STOCKPILES.

IF REQUIRED PROVIDE DIVERSION DRAIN & BANK AROUND STOCKPILES.

#### **GUTTER PROTECTION:**

PROVIDE PROTECTION TO DOWNHILL GRATE IN GUTTER BY MEANS OF SAND BAGS OR BLUE METAL WRAPPED IN GEOTEXTILE FABRIC. WHEN SOIL OR SAND BUILDS UP AROUND THIS SEDIMENT BARRIER, THE MATERIAL SHOULD BE RELOCATED BACK TO THE SITE FOR DISPOSAL.

NOTE: ALL PROPOSED STORMWATER TO CONNECT WITH EXISTING

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u				dimensions on site prior to commenceme	The Builder/Contractor shall check and verify all levels and dimensions on site prior to commencement of any work, creation of shop drawings, or fabrication of components.
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**LEGEND** 



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PROJECT ADDRESS 122 PARKES ROAD COLLAROY PLATEAU NSW 2097 DRAWING NO.

DA02

DATE

Wednesday, 18 December 2019


#### DRAWING NAME

SITE / ROOF / SEDIMENT EROSION / WASTE MANAGEMENT / STORMWATER CONCEPT PLAN

SCALE

1:200 @A3




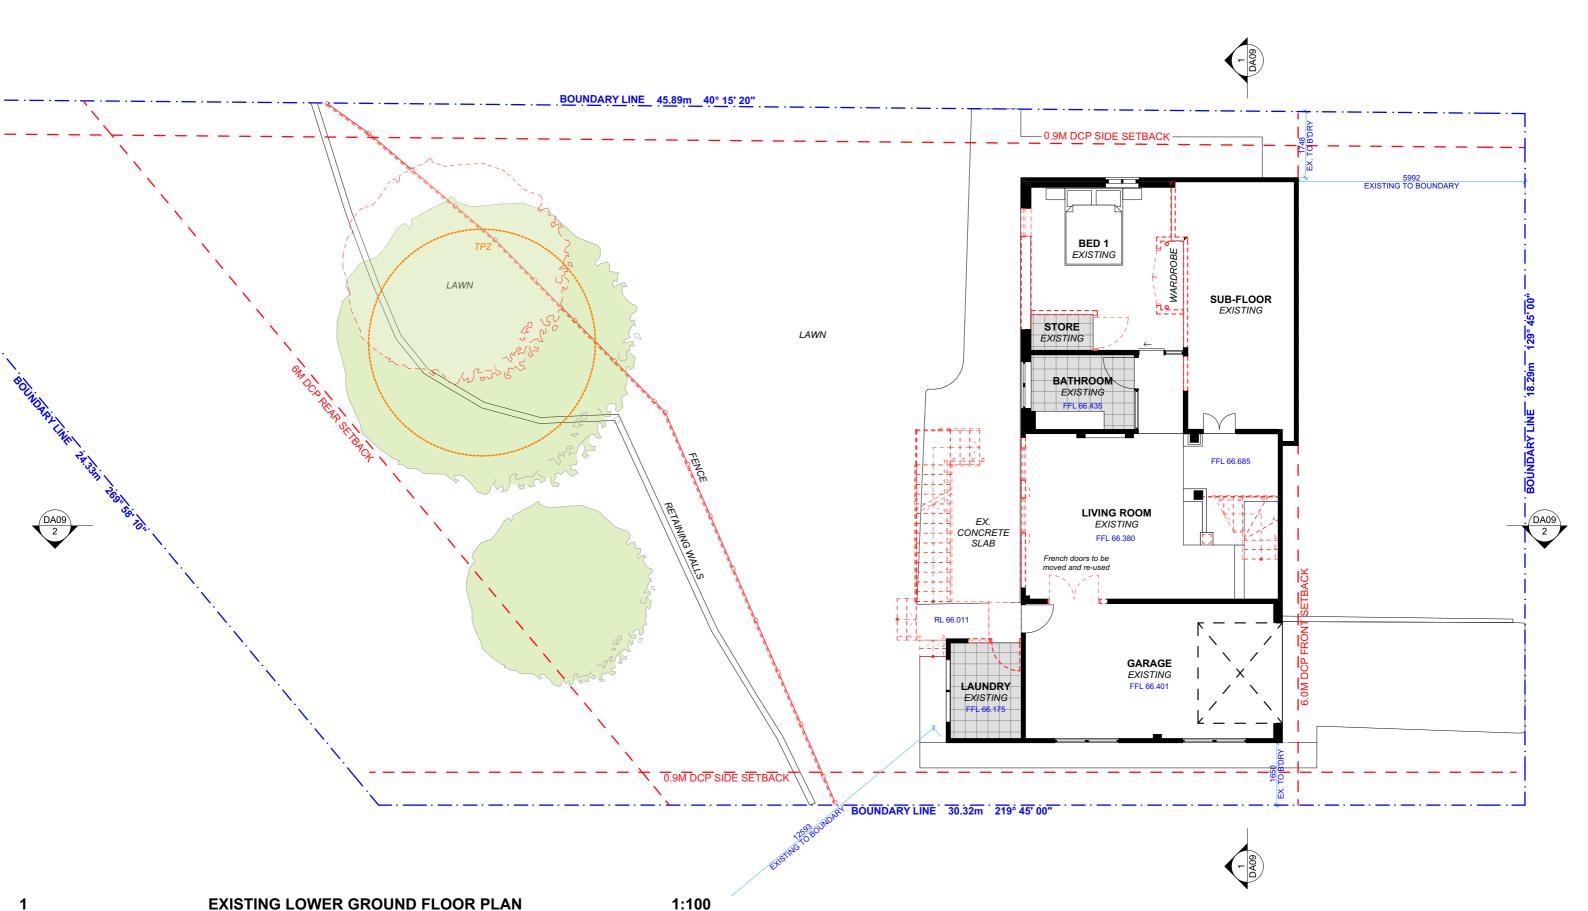

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PROJECT ADDRESS 122 PARKES ROAD COLLAROY PLATEAU NSW 2097 DA03


DRAWING NO.

DATE
Wednesday, 18
December 2019

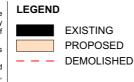**DRAWING NAME**EXISTING LOWER GROUND FLOOR PLAN

SCALE 1:100 @A3



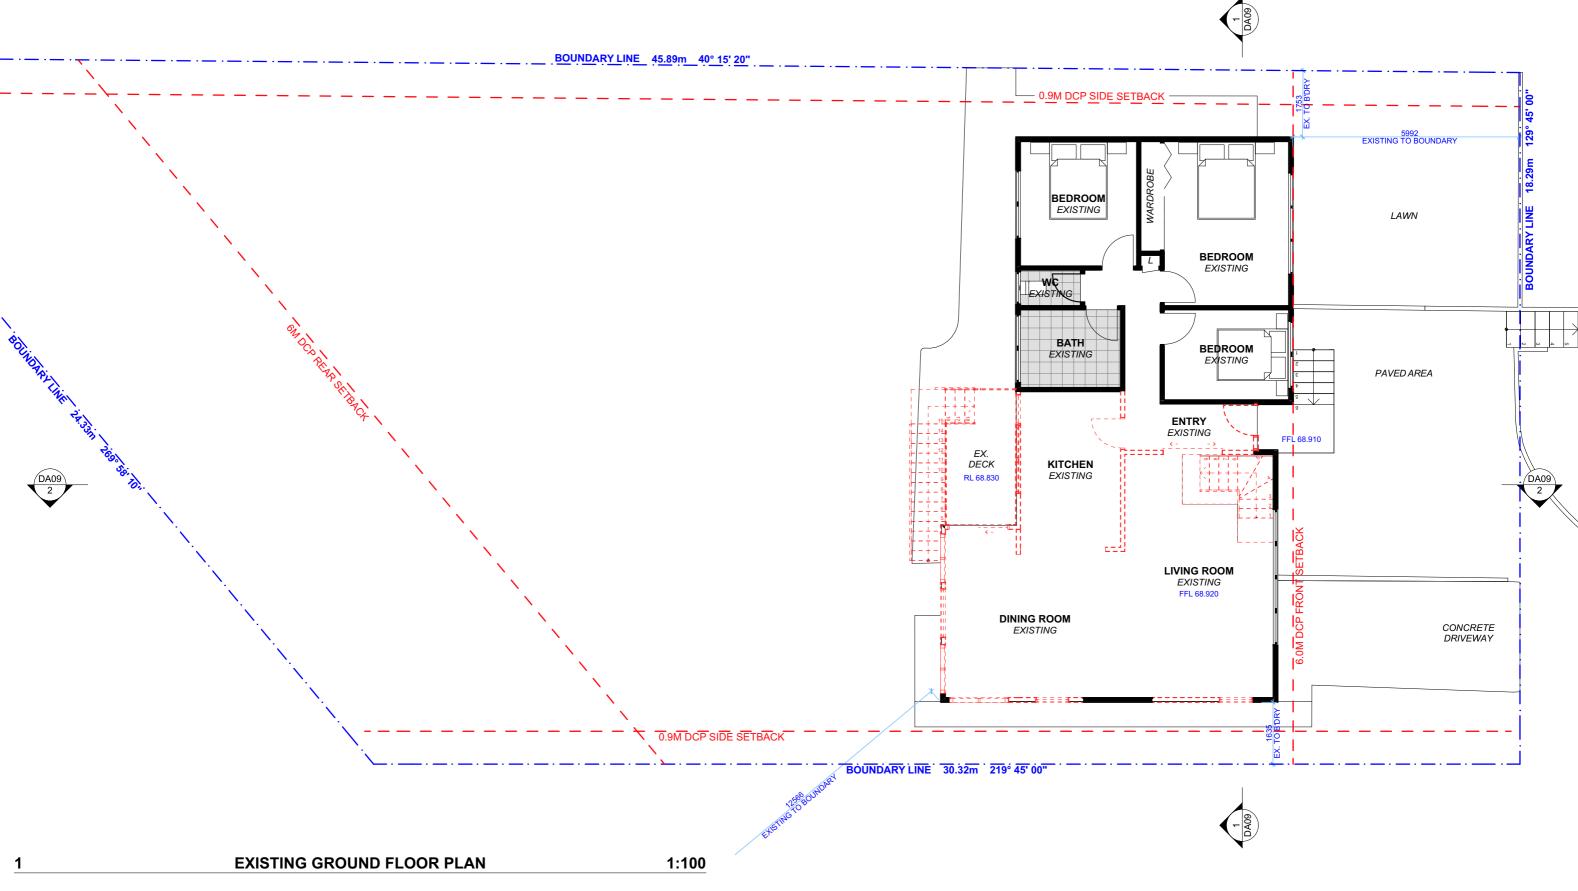

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122 PARKES ROAD
COLLAROY PLATEAU
NSW 2097


DRAWING NO. **DA04** 


DATE

Wednesday, 18 December 2019

EXISTING GROUND FLOOR PLAN




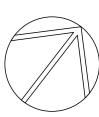

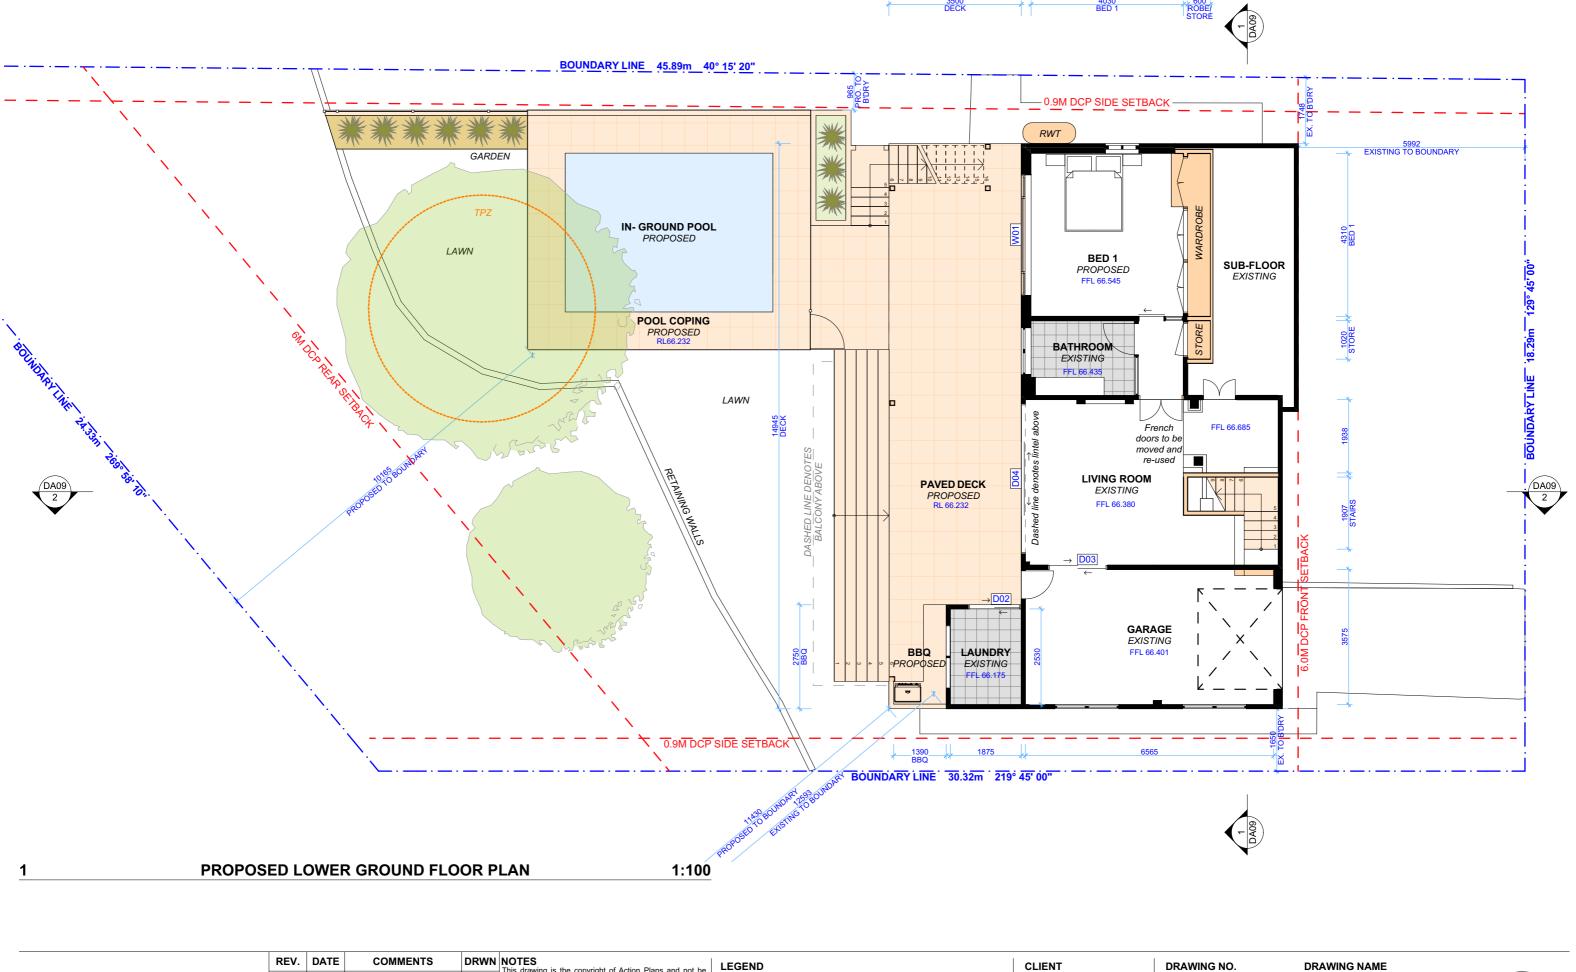



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December 2019

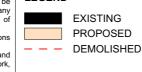
DATE
Wednesday, 18

PROPOSED LOWER GROUND FLOOR PLAN








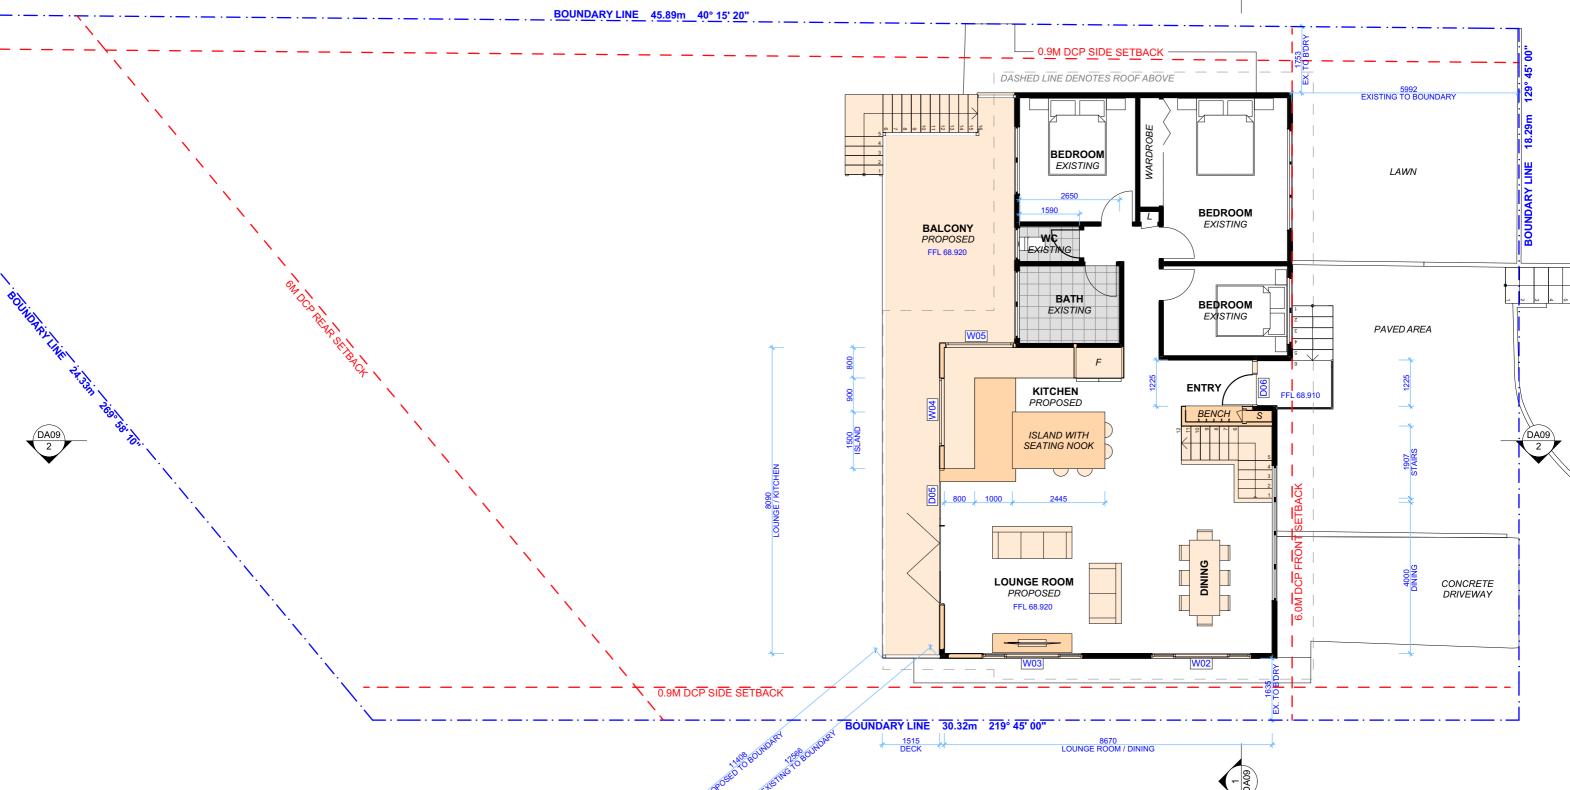

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PROPOSED GROUND FLOOR PLAN



1:100
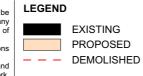
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PROJECT ADDRESS
122 PARKES ROAD
COLLAROY PLATEAU
NSW 2097


DRAWING NO.
DA06


Wednesday, 18 December 2019

DA06	PROPOSED GROUND FLOOR PLAN
DATE	

SCALE 1:100 @A3



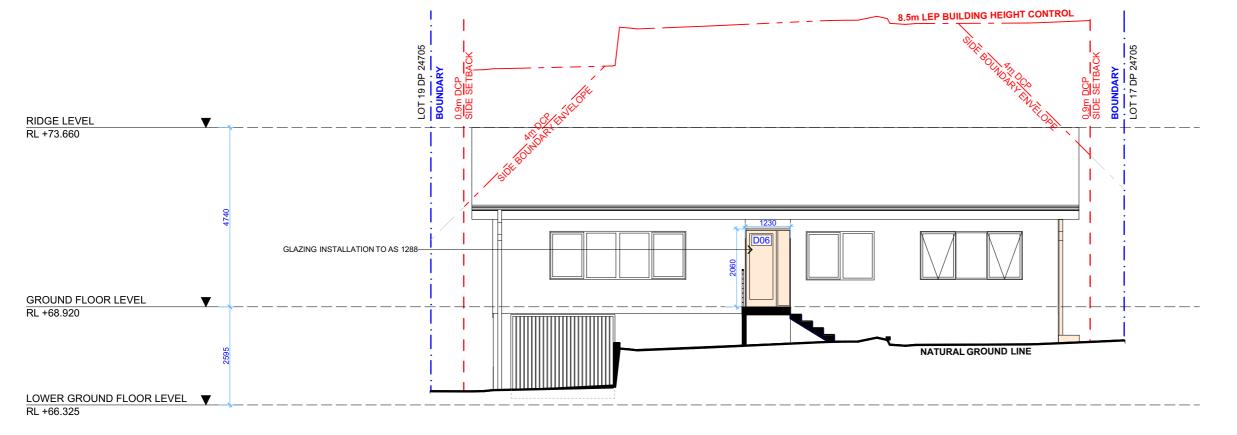

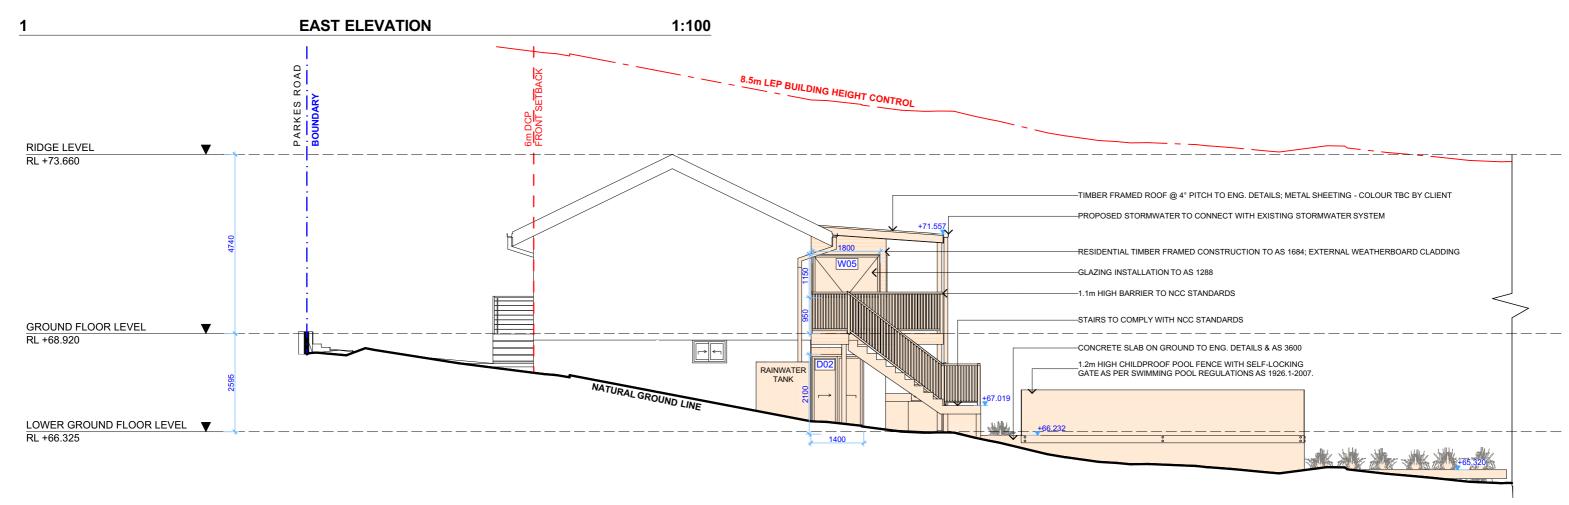


**NORTH ELEVATION** 1:100





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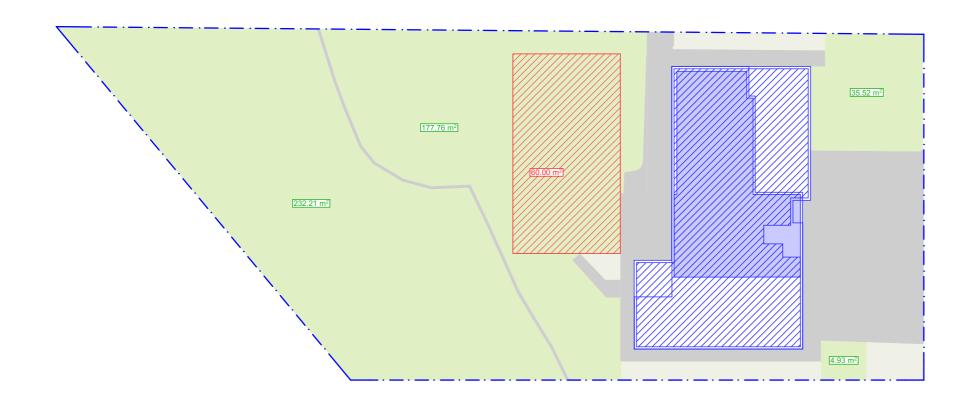
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CLIENT	DRAWING NO.	DRAWING NAME
ELKE & BRAD DUPERE	DA07	NORTH / EAST ELEVATION
PROJECT ADDRESS	DATE	
122 PARKES ROAD	Wednesday, 18	SCALE
COLLAROY PLATEAU NSW 2097	December 2019	1:100 @A3






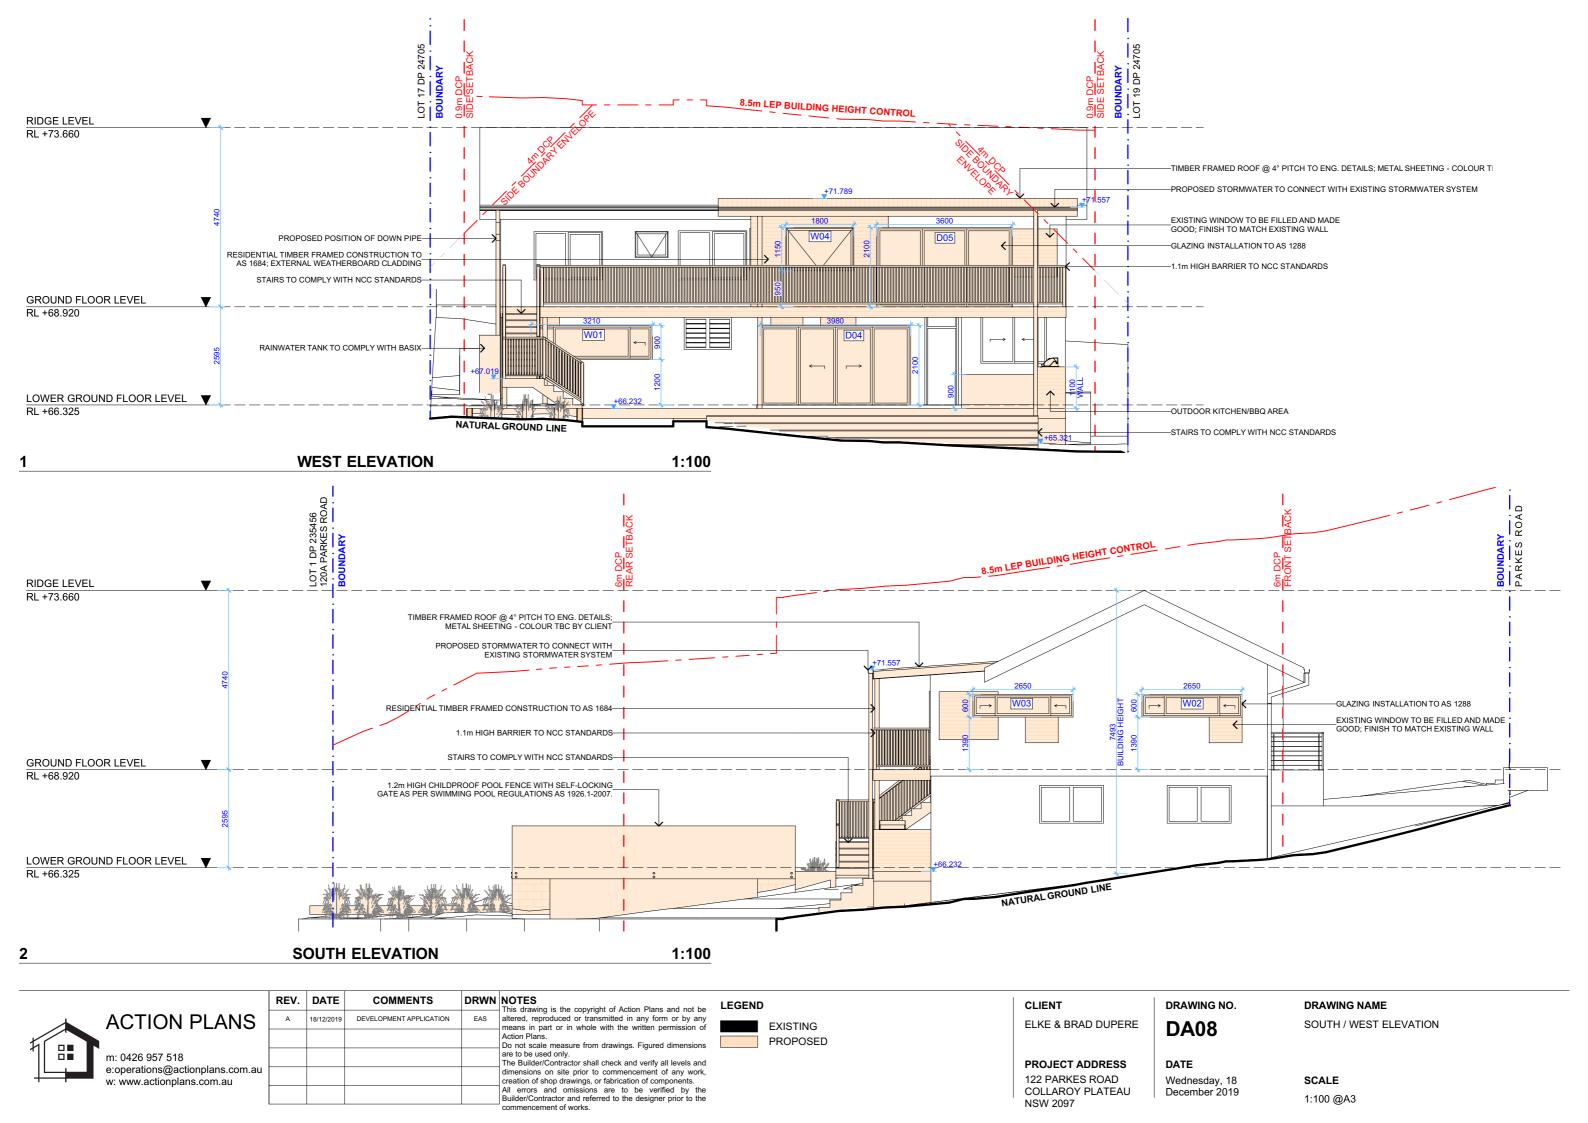

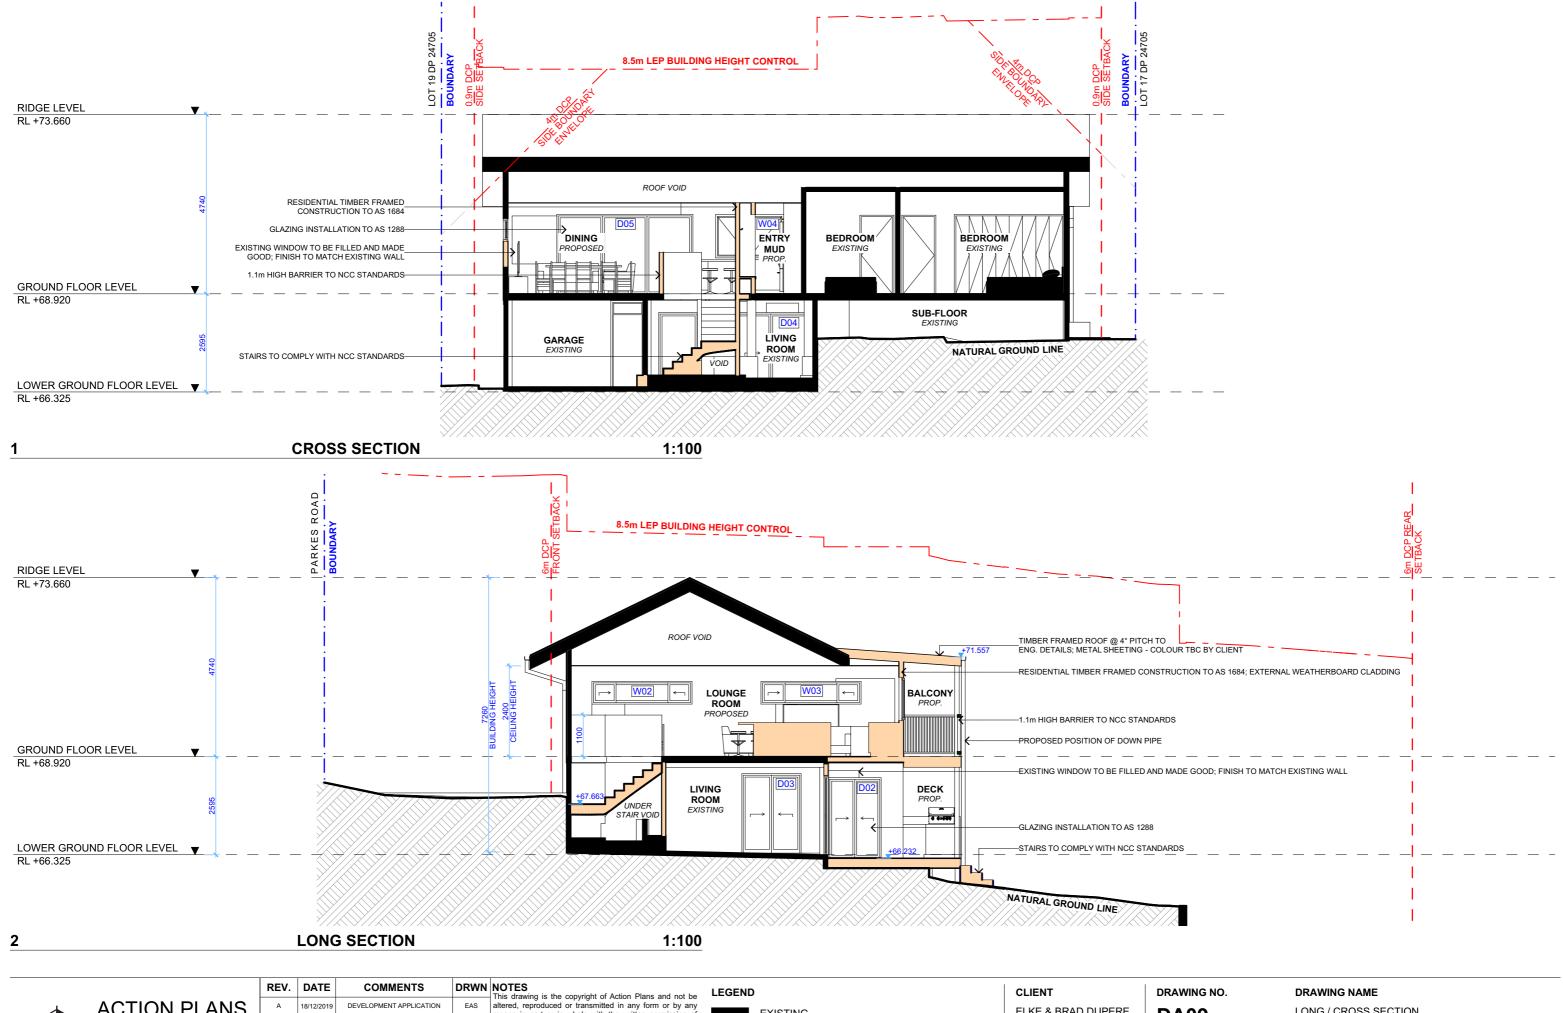

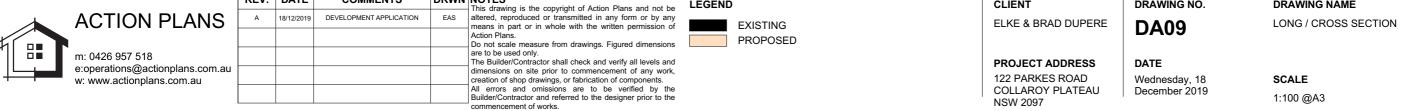**EXISTING AREA CALCULATIONS** 1:200

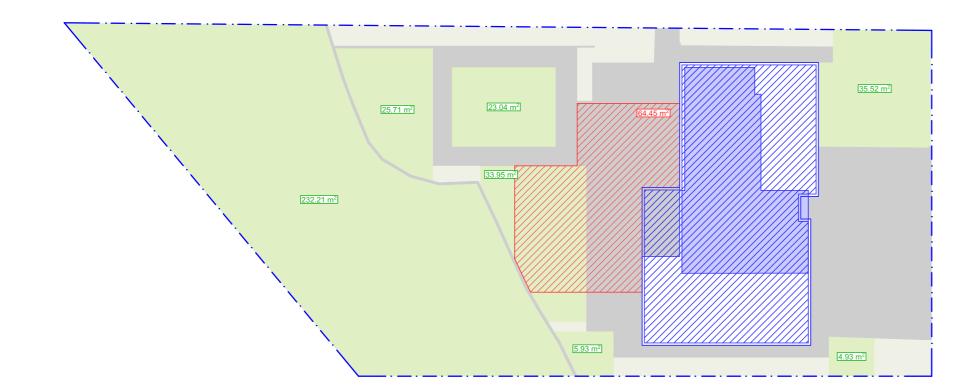

PROPOSED AREA CALCULATIONS 1:200



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#### LEGEND

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PROJECT ADDRESS

122 PARKES ROAD COLLAROY PLATEAU NSW 2097

DRAWING NO.

AREA CALCULATIONS **DA10** 

DATE

**AREA CONTROL CALCULATIONS** 

CONTROL: 40% (280.75m<sup>2</sup>)

CONTROL: 60m<sup>2</sup>

CONTROL: N/A

CONTROL: N/A

CONTROL: N/A

PRIVATE OPEN SPACE

FLOOR SPACE RATIO

HARD SURFACE AREA

PERVIOUS AREA

LANDSCAPED OPEN SPACE

EXISTING:

60m<sup>2</sup>

N/A

N/A

N/A

64.17% (450.42m<sup>2</sup>)

PROPOSED:

64.45m<sup>2</sup>

N/A

N/A

N/A


51.47% (361.29m<sup>2</sup>)


SITE AREA: 701.88m<sup>2</sup>

Wednesday, 18 December 2019

SCALE

1:200 @A3

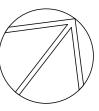

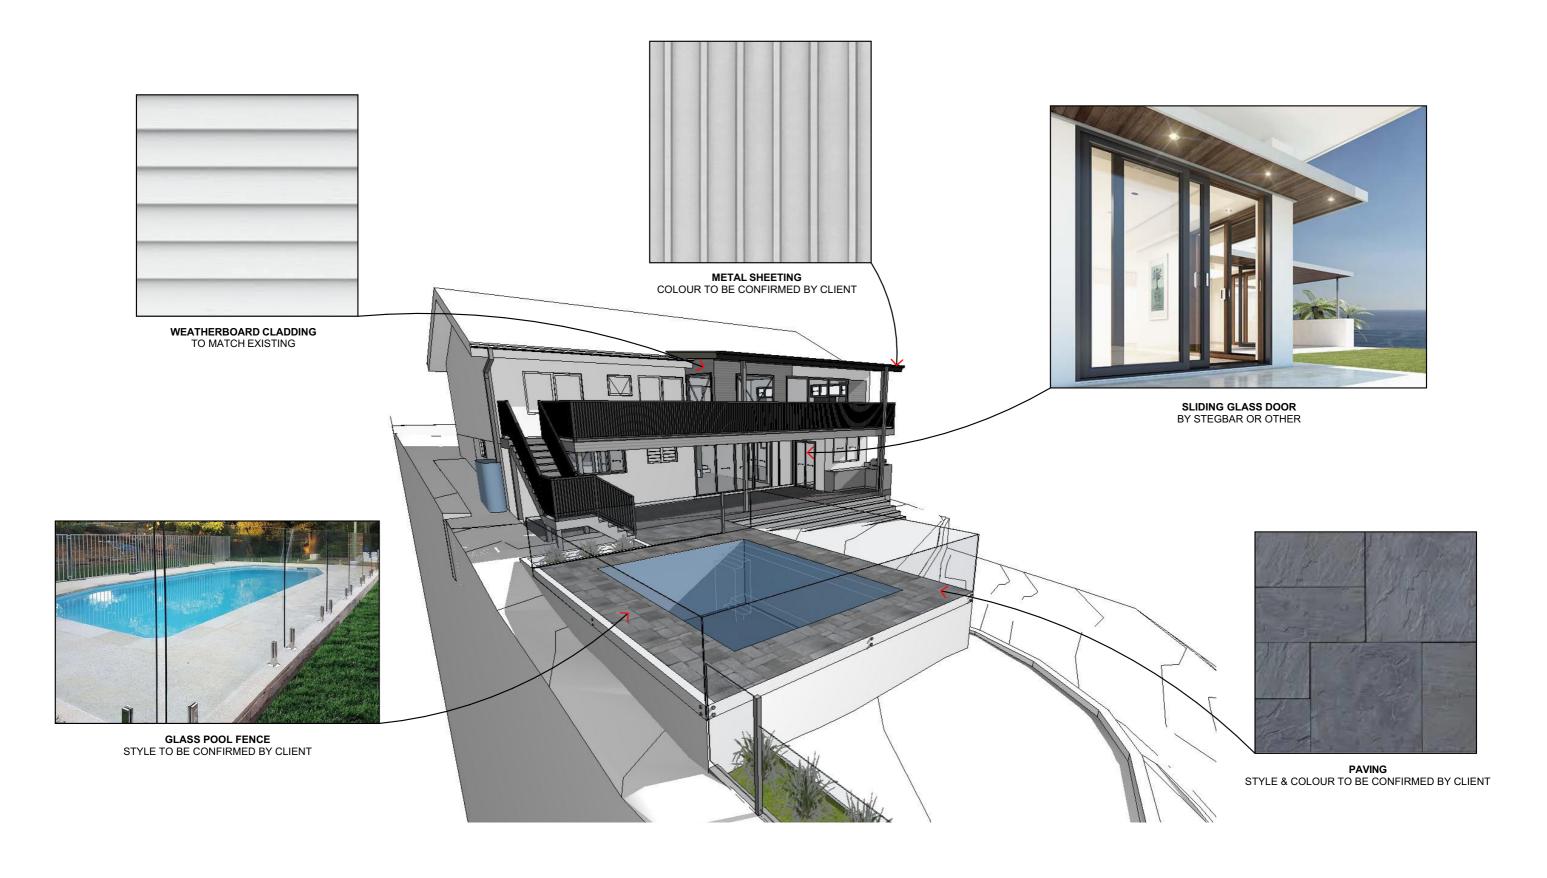

### **SAMPLE BOARD**



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LEGEND

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PROJECT ADDRESS 122 PARKES ROAD

DRAWING NO. **DA11** 


DRAWING NAME SAMPLE BOARD

COLLAROY PLATEAU NSW 2097

DATE Wednesday, 18 December 2019

SCALE

@A3

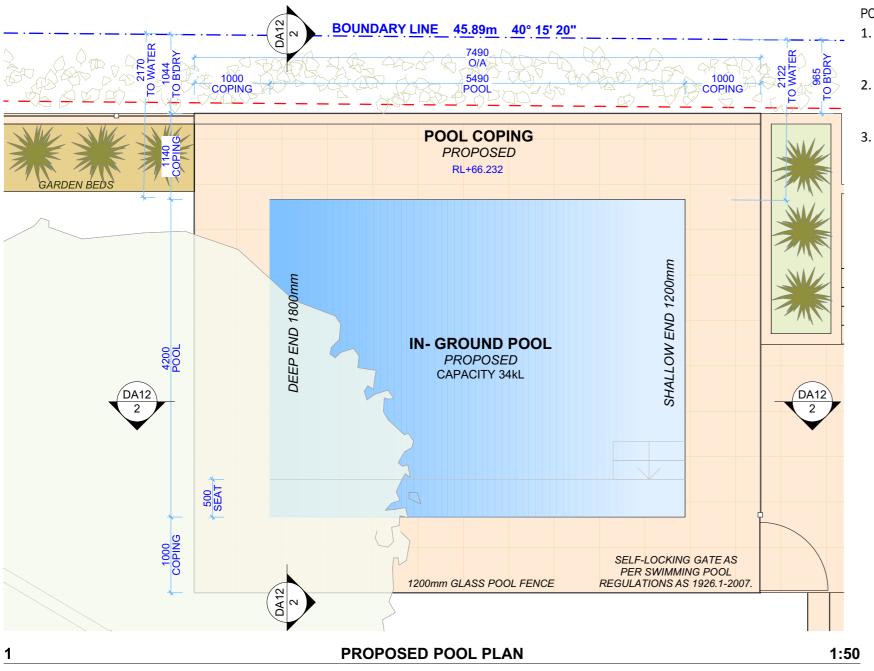

1.2m HIGH CHILDPROOF POOL FENCE WITH SELF-LOCKING GATE AS PER SWIMMING POOL REGULATIONS AS 1926.1-2007.

POOL OWNER DETAILS

1. If owner is dissatisfied with initial pool set out, location or depths, the builder should be notified BEFORE steel reinforcement is fixed.

2. The position of skimmers, lights, return lines etc. on this drawing is indicative only and final position to be determined on site

COPING END LEVEL


SHALLOW END LEVEL

RL +65.032 DEEP END LEVEL

RL +66.232

RL +64.432

3. Safety fencing should be in accordance with local councils requirements and conform to Australian standards

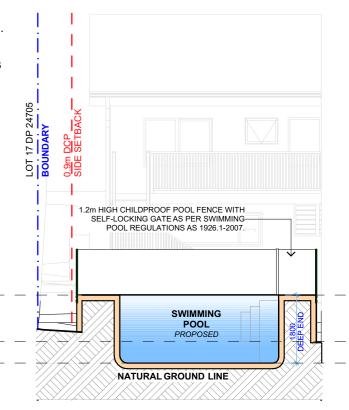


3 **POOL CROSS SECTION** 

**Building Code of Australia (BCA) requirement Design Specification** (for version of BCA applicable as on the date of submission of CC or CDC )

		Subinission of CC of CDC)
1.	All glazing including decals shall comply with AS 1288.1-2006, AS 2047-1999 and AS 1170.1-2002	Part 3.6 Glazing, requires all glazing to comply with AS 1288-2006 and AS 2047-1999. The BCA requires glazing members to comply with Structural Loading Code AS 2280.1-2002. Glass with a high potential for human impact shall strictly comply with the human impact safety requirements of the BCA
2.	Swimming Pool Safety Fencing	Part 3.9.3, of the BCA specifies all requirements of swimming pool safety fencing. Compliance with As1926.1-2012, including 1800mm high boundary fencing acting as pool fence/barriers. 1200mm high pool fence/barriers shall surround the pool with no doors of building permitted to open onto pool areas. Any windows shall be sufficiently protected in accordance with AS1926.1-2012. NCZ shall be provided to all swimming pool safety fence/barriers in accordance with AS1926.1-2012. AS 1288 2006 specifies glazing requirements when glass is incorporated into a pool fence/barrier. Certification post construction will be required.
3.	Swimming Pool Recirculation Systems	Part 3.9.4. of the BCA specifies all requirements of swimming pool and spa recirculation systems. AS1926.3-2010 shall be complied with and certified post construction

Building Code of Australia (BCA) requirement (for version of BCA applicable as on the date of submission of CC or CDC) **Design Specification** Part 3.6 Glazing, requires all glazing to comply with AS 1288-2006 and AS 2047-1999. The BCA requires glazing members to comply with Structural Loading Code AS All glazing including decals shall comply with AS 1288.1-2006, AS 2047-1999 and AS 1170.1-2002 2280.1-2002. Glass with a high potential for human impact shall strictly comply with the human impact safety requirements of the BCA Swimming Pool Safety Fencing Part 3.9.3, of the BCA specifies all requirements of swimming pool safety fencing. Compliance with As1926.1-2012, including 1800mm high boundary fencing acting as pool fence/barriers. 1200mm high pool fence/barriers shall surround the pool with no doors of building permitted to open onto pool areas. Any windows shall be sufficiently protected in accordance with AS1926.1-2012. NCZ shall be provided to all swimming pool safety fence/barriers in accordance with AS1926.1-2012. AS 1288 2006 specifies glazing requirements when glass is incorporated into a pool fence/barrier. Certification post construction will be required. 3. Swimming Pool Recirculation Systems Part 3.9.4. of the BCA specifies all requirements of swimming pool and spa recirculation systems. AS1926.3-2010 shall be complied with and certified post construction

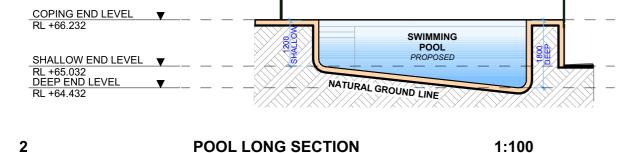

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					All errors and omissions are to be verified by the Builder/Contractor and referred to the designer prior to the
					commencement of works.

CLIENT

LEGEND

ELKE & BRAD DUPERE

PROJECT ADDRESS 122 PARKES ROAD COLLAROY PLATEAU NSW 2097

DATE

Wednesday, 18 December 2019

DRAWING NO.


**DA12** 

POOL PLAN


**DRAWING NAME** 

1:50, 1:100 @A3

**SCALE** 

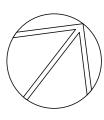


1:100

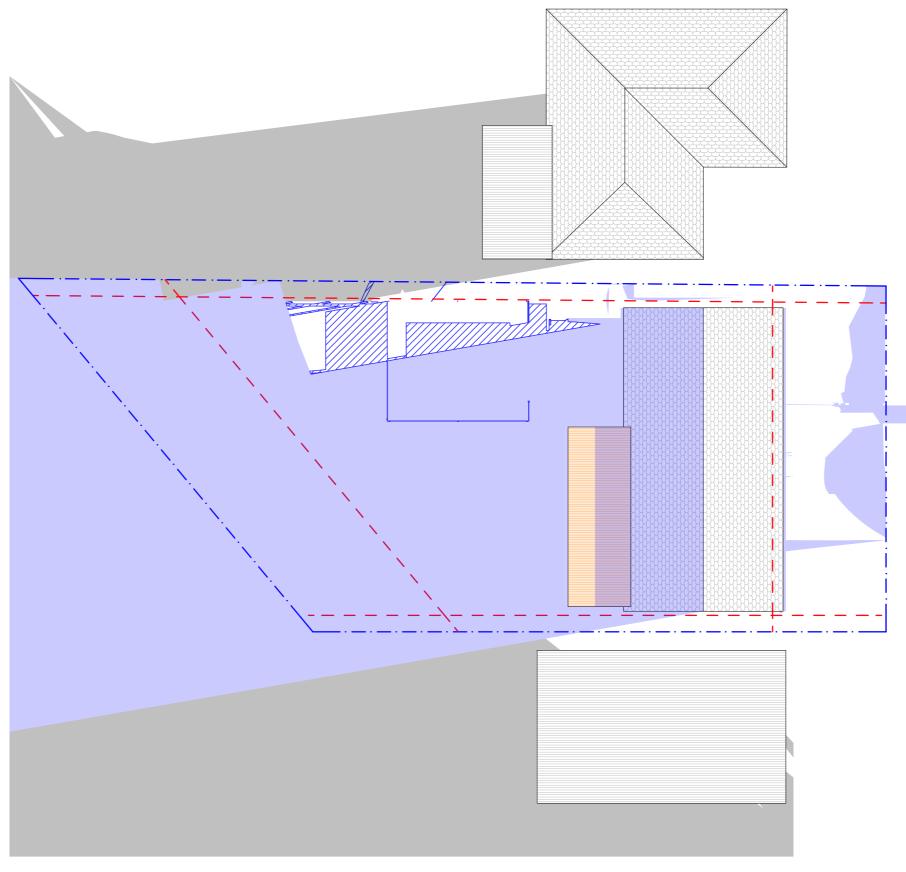

1 WINTER SOLSTICE 9AM 1:200



REV.	DATE	COMMENTS	DRWN	NOTES This drawing is the copyright of Action Plans and not be
A	18/12/2019	DEVELOPMENT APPLICATION	EAS	altered, reproduced or transmitted in any form or by any means in part or in whole with the written permission of Action Plans.  Do not scale measure from drawings. Figured dimensions are to be used only.  The Builder/Contractor shall check and verify all levels and dimensions on site prior to commencement of any work, creation of shop drawings, or fabrication of components.  All errors and omissions are to be verified by the Builder/Contractor and referred to the designer prior to the
				commencement of works.

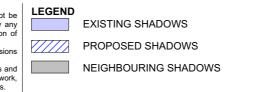


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ELKE & BRAD DUPER


PROJECT ADDRESS 122 PARKES ROAD COLLAROY PLATEAU NSW 2097 DRAWING NO.

DATE
Wednesday, 18
December 2019

**DRAWING NAME**WINTER SOLSTICE 9 AM

**SCALE** 1:200 @A3

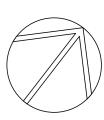


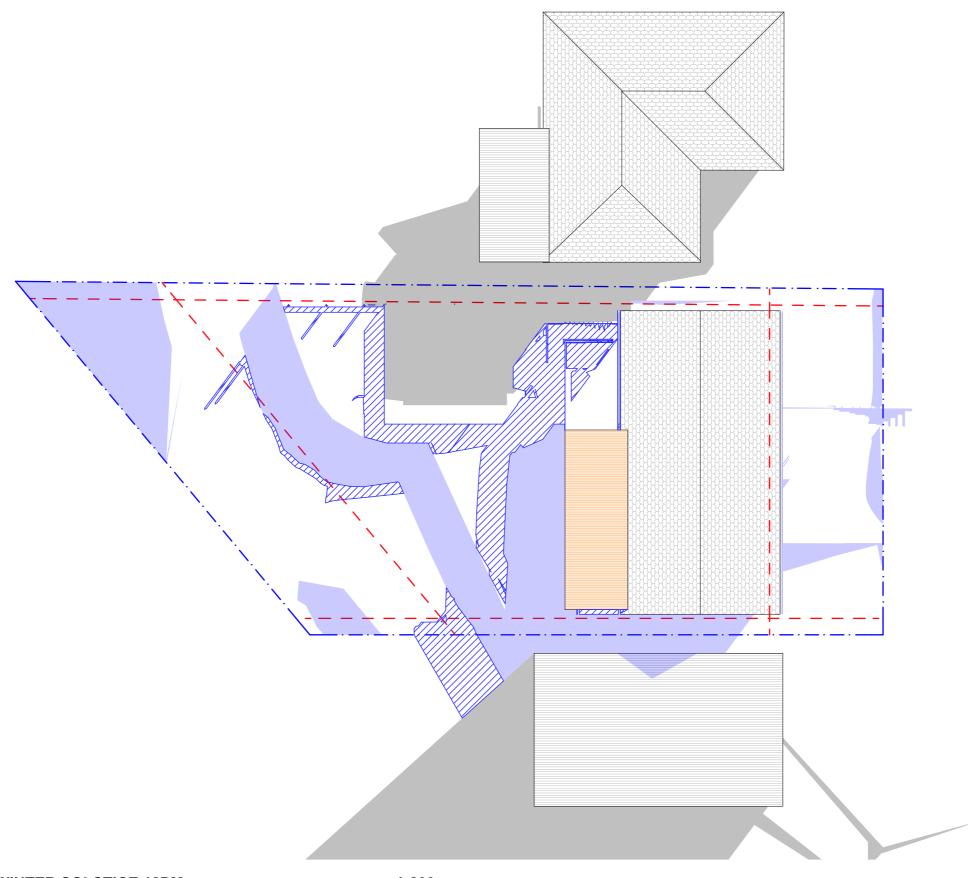

WINTER SOLSTICE 12PM 1:200



	REV.	DATE	COMMENTS	DRWN	NOTES This drawing is the copyright of Action Plans and not be	L
	Α	18/12/2019	DEVELOPMENT APPLICATION	EAS	altered, reproduced or transmitted in any form or by any means in part or in whole with the written permission of	
					Action Plans.  Do not scale measure from drawings. Figured dimensions are to be used only.	2
J					The Builder/Contractor shall check and verify all levels and dimensions on site prior to commencement of any work,	
					creation of shop drawings, or fabrication of components.  All errors and omissions are to be verified by the Builder/Contractor and referred to the designer prior to the	
					commencement of works.	

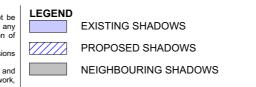

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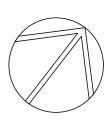
Wednesday, 18 December 2019


**DA14** 

DATE

WINTER SOLSTICE 12 PM

SCALE 1:200 @A3




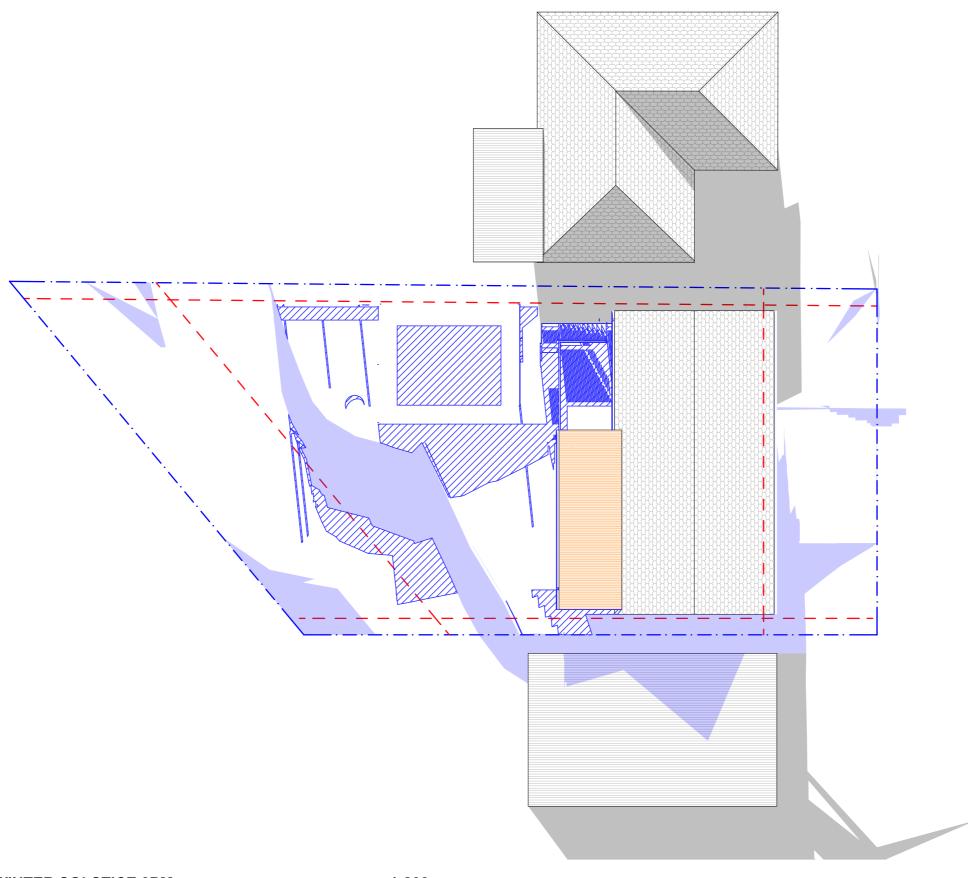

1 WINTER SOLSTICE 3PM 1:200



	REV.	DATE	COMMENTS	DRWN	NOTES	LI
	А	18/12/2019	DEVELOPMENT APPLICATION	EAS	This drawing is the copyright of Action Plans and not be altered, reproduced or transmitted in any form or by any means in part or in whole with the written permission of	
					Action Plans.  Do not scale measure from drawings. Figured dimensions	$\mathbb{Z}$
					are to be used only. The Builder/Contractor shall check and verify all levels and	
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					commencement of works.	

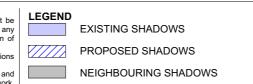


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ELKE & BRAD DUPERE

PROJECT ADDRESS 122 PARKES ROAD COLLAROY PLATEAU NSW 2097 DRAWING NO.

DATE Wednesday, 18 December 2019 **DRAWING NAME**WINTER SOLSTICE 3 PM

SCALE 1:200 @A3

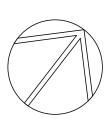



Building Sustainability Index www.basix.nsw.gov.au

#### **Alterations and Additions**

Certificate number: A365872

This certificate confirms that the proposed development will meet the NSW government's requirements for sustainability, if it is built in accordance with the commitments set out below. Terms used in this certificate, or in the commitments, have the meaning given by the document entitled "BASIX Alterations and Additions Definitions" dated 06/10/2017 published by the Department. This document is available at www.basix.nsw.gov.au

Secretary

Date of issue: Friday, 06, December 2019 To be valid, this certificate must be lodged within 3 months of the date of issue.

Planning & Environment

t	Project address				
0	Project name	122 Parkes Road			
roj	Street address	122 Parkes Road Collaroy Plateau 2097			
ĭ	Local Government Area	Northern Beaches Council			
d	Plan type and number	Deposited Plan 24705			
4-	Lot number	18			
0	Section number				
	Project type				
.0	Dwelling type	Separate dwelling house			
criptio	Type of alteration and addition	My renovation work is valued at \$50,000 or more, and includes a pool (and/or spa).			
esc					

Certificate Prepared by (please complete before submitting to Council or PCA)
Name / Company Name: Action Plans
ABN (if applicable): 17118297587

Pool and Spa	Show on DA Plans	Show on CC/CDC Plans & specs	Certifier Check
Rainwater tank			
The applicant must install a rainwater tank of at least 962 litres on the site. This rainwater tank must meet, and be installed in accordance with, the requirements of all applicable regulatory authorities.	<b>✓</b>	<b>✓</b>	<b>✓</b>
The applicant must configure the rainwater tank to collect rainwater runoff from at least 163 square metres of roof area.		✓	✓
The applicant must connect the rainwater tank to a tap located within 10 metres of the edge of the pool.		<b>✓</b>	✓
Outdoor swimming pool	1		
The swimming pool must be outdoors.	<b>✓</b>	<b>✓</b>	<b>✓</b>
The swimming pool must not have a capacity greater than 34.5 kilolitres.	✓	<b>✓</b>	✓
The swimming pool must have a pool cover.		✓	✓
The applicant must install a pool pump timer for the swimming pool.		✓	✓
The applicant must install the following heating system for the swimming pool that is part of this development: electric heat pump.		<b>✓</b>	✓

Fixtures and systems	Show on DA Plans	Show on CC/CDC Plans & specs	Certifier Check
Lighting			
The applicant must ensure a minimum of 40% of new or altered light fixtures are fitted with fluorescent, compact fluorescent, or light-emitting-diode (LED) lamps.		<b>✓</b>	~
Fixtures			
The applicant must ensure new or altered showerheads have a flow rate no greater than 9 litres per minute or a 3 star water rating.		✓	✓
The applicant must ensure new or altered toilets have a flow rate no greater than 4 litres per average flush or a minimum 3 star water rating.		~	<b>✓</b>
The applicant must ensure new or altered taps have a flow rate no greater than 9 litres per minute or minimum 3 star water rating.		✓	

Construction			Show on DA Plans	Show on CC/CDC Plans & specs	Certifier Check
Insulation requirements					
The applicant must construct the new or altered the table below, except that a) additional insula is not required for parts of altered construction	<b>~</b>	<b>√</b>	<b>~</b>		
Construction	Additional insulation required (R-value)	Other specifications			
suspended floor with enclosed subfloor: framed (R0.7).	R0.60 (down) (or R1.30 including construction)				
floor above existing dwelling or building.	nil				
external wall: framed (weatherboard, fibro, metal clad)	R1.30 (or R1.70 including construction)				
flat ceiling, pitched roof	ceiling: R3.00 (up), roof: foil/sarking	medium (solar absorptance 0.475 - 0.70)			

Glazing r	requirements						Show on DA Plans	Show on CC/CDC Plans & specs	Certifier Check
Windows	and glazed do	ors							
The applicant must install the windows, glazed doors and shading devices, in accordance with the specifications listed in the table below. Relevant overshadowing specifications must be satisfied for each window and glazed door.						~	<b>✓</b>	~	
The following requirements must also be satisfied in relation to each window and glazed door:							✓	<b>~</b>	
Each window or glazed door with standard aluminium or timber frames and single clear or toned glass may either match the description, or, have a U-value and a Solar Heat Gain Coefficient (SHGC) no greater than that listed in the table below. Total system U-values and SHGCs must be calculated in accordance with National Fenestration Rating Council (NFRC) conditions.							<b>✓</b>	<b>✓</b>	
For projections described in millimetres, the leading edge of each eave, pergola, verandah, balcony or awning must be no more than 500 mm above the head of the window or glazed door and no more than 2400 mm above the sill.						~	<b>✓</b>	<b>✓</b>	
Pergolas w	vith polycarbonate	e roof or s	imilar tran	slucent mate	erial must have a shading coefficient	t of less than 0.35.		<b>~</b>	<b>~</b>
Pergolas with fixed battens must have battens parallel to the window or glazed door above which they are situated, unless the pergola also shades a perpendicular window. The spacing between battens must not be more than 50 mm.							✓	<b>✓</b>	
	s and glazed		lazing r	equireme			-		
Window / o	door Orientation	Area of glass inc. frame (m2)	Oversha Height (m)	Distance (m)	Shading device	Frame and glass type			
W1	W	2.889	0	0	eave/verandah/pergola/balcony >=900 mm	standard aluminium, single clear, (or U-value: 7.63, SHGC: 0.75)			
W2	S	1.59	0	0	eave/verandah/pergola/balcony >=450 mm	standard aluminium, single clear, (or U-value: 7.63, SHGC: 0.75)			
W3	S	1.59	0	0	eave/verandah/pergola/balcony >=450 mm	standard aluminium, single clear, (or U-value: 7.63, SHGC: 0.75)			
W4	W	2.07	0	0	eave/verandah/pergola/balcony >=900 mm	standard aluminium, single clear, (or U-value: 7.63, SHGC: 0.75)			
W5	N	2.07	0	0	eave/verandah/pergola/balcony >=750 mm	standard aluminium, single clear, (or U-value: 7.63, SHGC: 0.75)			
		_	_	0	eave/verandah/pergola/balcony	standard aluminium, single clear, (or			
D2	N	2.94	0		>=900 mm	U-value: 7.63, SHGC: 0.75)			
	N W	2.94 8.358	0	0					
D2					>=900 mm eave/verandah/pergola/balcony	U-value: 7.63, SHGC: 0.75) standard aluminium, single clear, (or			

In these commitments, "applicant" means the person carrying out the development.

Commitments identified with a "
" in the "Show on DA plans" column must be shown on the plans accompanying the development application for the proposed development (if a development application is to be lodged for the proposed development).

Commitments identified with a "\rightarrow" in the "Show on CC/CDC plans & specs" column must be shown in the plans and specifications accompanying the application for a construction certificate / complying development certificate for the proposed development.

Commitments identified with a "

" in the "Certifier check" column must be certified by a certifying authority as having been fulfilled, before a final occupation certificate for the development may be issued.



REV.	DATE	COMMENTS	DRWN	NOTES This drawing is the copyright of Action Plans and not be altered, reproduced or transmitted in any form or by any means in part or in	CLIENT
А	18/12/2019	DEVELOPMENT APPLICATION	EAS	whole with the written permission of Action Plans and not be altered, reproduced of transmitted in any form of by any means in part of in whole with the written permission of Action Plans.  Do not scale measure from drawings. Figured dimensions are to be used only.	ELKE & BF
				The Builder/Contractor shall check and verify all levels and dimensions on site prior to commencement of any work, creation of shop drawings, or fabrication of components.	
				All errors and omissions are to be verified by the Builder/Contractor and referred to the designer prior to the commencement of works.	
				All window & door dimensions, orientation, glazing materials, opening types, frame types are to be confirmed by a suitably qualified	PROJECT
				person prior to the ordering of any such materials are to take place. U value takes precedence over glazing type/colour in all cases.	122 PARKI
				all new glazing must meet the BASIX specified frame and glass type, <u>OR</u> meet the certified U value and SHGC value.	COLLARO

ELKE & BRAD DUPERE

PROJECT ADDRESS 122 PARKES ROAD COLLAROY PLATEAU NSW 2097

DRAWING NO. **DA16** 

December 2019

DRAWING NAME BASIX COMMITMENTS

DATE Wednesday, 18