

MATTHEW PALAVIDIS VICTOR FATTORETTO MATTHEW SHIELDS

20180678.2/2707A/R3/HC

5/05/2021

Ces Koutsos

Attn: Maryam Sheedy

96 North Steyne, Manly - Section 4.55 - Condenser Unit Noise Review

1 INTRODUCTION

The purpose of preparing this letter is to provide a Section 4.55 acoustic review for the proposed condenser units to be located on levels 1, 2, 3, and roof top of the residential development at 96 North Steyne, Manly.

This assessment has been conducted based on the following documents:

- Document of '*Notice of Determination*', Development Application No.272/2017, Date of Determination: 04 April 2018.
- Revised architectural drawings (mark-up) based on the architectural drawings, provided by Squillace, job number KOU1610, Issue B, dated 11th August 2021.

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2 NOISE EMISSION ASSESSMENT

The noise emissions from the project site shall comply with the requirements of the following;

- Document of '*Notice of Determination*', Development Application No.272/2017, Date of Determination: 04 April 2018; and
- NSW EPA Industrial Noise Policy for Industry 2017.

2.1 NOISE CRITERIA

2.1.1 Document of '*Notice of Determination*', Development Application No.272/2017, Date of Determination: 04 April 2018

It is noted that the document of '*Notice of Determination*', Development Application No.272/2017, Date of Determination: 04 April 2018 does not contain any applicable acoustic criteria with respect for mechanical noise emission from the proposed development. Therefore, the following guidelines are adopted.

2.1.2 NSW EPA Industrial Noise Policy for Industry 2017

The NSW EPA Noise Policy for Industry 2017 has two criteria which need to be satisfied; namely the Intrusiveness noise level criteria and the Project amenity noise level criteria. The project noise trigger level is then established based on the lower of the intrusiveness and project amenity levels.

2.1.2.1 Intrusiveness Noise Level Criteria

The guideline is intended to limit the audibility of noise emissions at residential receivers and requires that noise emissions measured using the L_{eq} descriptor do not exceed the background noise level by more than 5dB(A). Where applicable, the intrusive noise level should be penalised (increased) to account for any annoying characteristics such as tonality.

Table 2.1 in the NSW EPA Noise Policy for Industry 2017 summarised the minimum background noise levels and minimum project intrusiveness noise levels as presented in table below. Noise emissions from the site should comply with the noise levels presented below when measured at nearby property boundary.

Time of day	Minimum assumed rating background noise level (dB(A))	Minimum project intrusiveness noise levels L _{eq(15min)} dB(A)			
Day	35	40			
Evening	30	35			
Night	30	35			

Table 1– Minimum assumed RBLs and project intrusiveness noise levels

2.1.2.2 Project Amenity Noise Level Criteria

The guideline is intended to limit the absolute noise level from all noise sources to a level that is consistent with the general environment.

The NSW EPA Industrial noise policy sets out acceptable noise levels for various localities. Table 2.2 on page 11 of the policy indicates 3 categories to distinguish different residential areas. They are rural, suburban, urban. This site is categorised by suburban receivers.

For the purposes of this condition:

- Day is defined as the period from 7am to 6pm Monday to Saturday and 8am to 6pm Sundays and Public Holidays;
- Evening is defined as the period from 6pm to 10pm.
- Night is defined as the period from 10pm to 7am Monday to Saturday and 10pm to 8am Sunday and public holidays.

The project amenity noise level is calculated by taking the recommended amenity noise level (as presented in table 2.2 of the policy), subtracting 5dB(A) and then adding 3dB(A) to convert from $L_{Aeq, period}$ to a $L_{Aeq,15}$ minute descriptor. The project amenity noise level criteria are presented in the table below.

Table 2– Project Amenity Noise Level Criteria

Location	Period/Time	Project Amenity Noise Level Criteria dB(A) L _{eq(15min)}			
	Day (7am-6pm)	53			
Nearby Residences – suburban Receiver	Evening(6pm-10pm)	43			
	Night(10pm-7am)	38			
Commercial	When in use	63			

2.1.3 Resultant Project Noise Emission Criteria

Based on the requirements stated in the sections above, table below provides a summary of the assessment criteria applicable to the future residential development at the project site. The assessment criteria are also based on the background noise monitoring data conducted at the proposed development location.

Table 3– Environmental Noise Emission Criteria

Location	Time Period	Assessment Background Noise Level dB(A)L ₉₀	Project Amenity Criteria dB(A) L _{eq}	Intrusiveness Criteria Background + 5 dB(A) L _{eq(15min)}	Resultant criteria	
Nearby Residences	Day	35	53	40	40	
	Evening	30	43	35	35	
	Night	30	38	35	35	
Commercial	When in use	-	63	-	63	

2.2 CONDENSER UNIT NOISE

Noise emission analysis has been carried out by this office based on the indicative locations of the condenser units (refer to Appendix 1), the revised architectural drawings (mark-up) based on the approved architectural drawings, provided by Squillace, job number KOU1610, Issue B, dated 11th August 2021.

Mechanical plant items are not typically selected at selected at DA stage. This office has been advised that equipment noise data and other specific details are currently unavailable.

Summary for noise emission criteria associated with the development has been summarised in table 3 of this report. All plant can be satisfactorily attenuated to levels complying with noise emission criteria through appropriate location and (if necessary) standard acoustic treatments such as noise screens to roof top plant, enclosures, in-duct treatments (silencers/lined ducting) or similar.

Indicative maximum sound power levels that may be emitted from the condenser units located at rooftop while achieving compliance with all noise criteria have been determined. The maximum indicative sound power levels are indicated in the following table.

Table 4 - Indicative Complying Condenser Units at Rooftop Emitted Sound Power Level

Time of Day	Indicative Sound Power Level dB(A)
Day	73
Evening	68
Night	68

Indicative maximum sound power levels that may be emitted from the condenser units located at levels 1,2, and 3 while achieving compliance with all noise criteria have been determined. The maximum indicative sound power levels are indicated in the following table.

Table 5 - Indicative Complying Condenser Units at Levels 1,2, and 3 Emitted Sound Power Level

Time of Day	Indictive Sound Power Level dB(A)					
Day	68					
Evening	63					
Night	63					

The levels indicated in the above table are achievable through the following treatments:

- Selection of quiet plant;
- Adoption of fan speed capacity control (as the evening and night-time capacity requirements are typically significantly lower than the design day requirement);
- Installing acoustic louver (if necessary);
- In-duct treatments (silencers/lined ducting) (if necessary);
- Any skylight shall be minimum 6.38mm laminated glazing (fixed) with minimum R_w31.
- If enclosures/ barriers are required, enclosures/ barriers shall be minimum 9mm FC sheet (gap free) or equivalent.

- Vibration isolated the proposed condenser units from the building structure by NRD mounts or equivalent;
- Acoustic louvers to be installed at levels 1,2, and 3 plant area.
- All other major plant will be located within the building and any sources of external emissions will be treated accordingly, as indicated above to ensure the combined level of noise from all sources complies with the criteria.

A detailed plant design and selection has not been undertaken at this stage. Therefore, a detailed acoustic review should be undertaken at CC stage to determine acoustic treatments to control noise emissions to levels complying with the noise emission criteria in Section 2.1.

3 CONCLUSION

A preliminary assessment of noise emission from the proposed condenser units has been conducted at the proposed residential development located at 96 North Steyne, Manly, based on information provided to this office, as well as the following documents:

- Document of '*Notice of Determination*', Development Application No.272/2017, Date of Determination: 04 April 2018.
- Revised architectural drawings (mark-up) based on the architectural drawings, provided by Squillace, job number KOU1610, Issue B, dated 11th August 2021.

Criteria limiting noise emissions from condenser units have been developed based on NSW EPA Industrial Noise Policy for Industry 2017. Indicative maximum sound power levels that may be emitted from the condenser units while achieving compliance with all noise criteria have been determined. Detailed acoustic controls for the condenser units servicing the proposed development should be determined prior to issue of the building construction certificate.

We trust this information is satisfactory. Please contact us should you have any further queries.

Yours faithfully,

Acoustic Logic Consultancy Pty Ltd Hugh Cao

APPENDIX 1: REVISED ARCHITECTURAL DRAWINGS

BELLA VISTA APARTMENTS 96 North Steyne, Manly

DRAWING LIST

- DA0001 TITLE SHEET, PHOTOMONTAGE & LOCATION PLAN
- DA0010 SITE PLAN & SITE ANALYSIS
- DA1003 DEMOLITION / PROPOSED GROUND FLOOR PLAN
- DA1004 DEMOLITION / PROPOSED LEVELS 1 & 2 FLOOR PLAN
- DA1005 DEMOLITION / PROPOSED LEVEL 3 FLOOR PLAN
- DA1006 DEMOLITION / PROPOSED LEVEL 4 FLOOR PLAN
- DA1007 DEMOLITION / PROPOSED ROOF PLAN
- DA2000 PROPOSED WEST & NORTH ELEVATIONS
- DA2001 PROPOSED EAST & WEST ELEVATIONS
- DA3000 BUILDING SECTION AA
- DA5000 EXTERNAL COLOUR SCHEDULE

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NOTES









PROJECT BELLA VISTA APARTMENTS

96 North Steyne Manly

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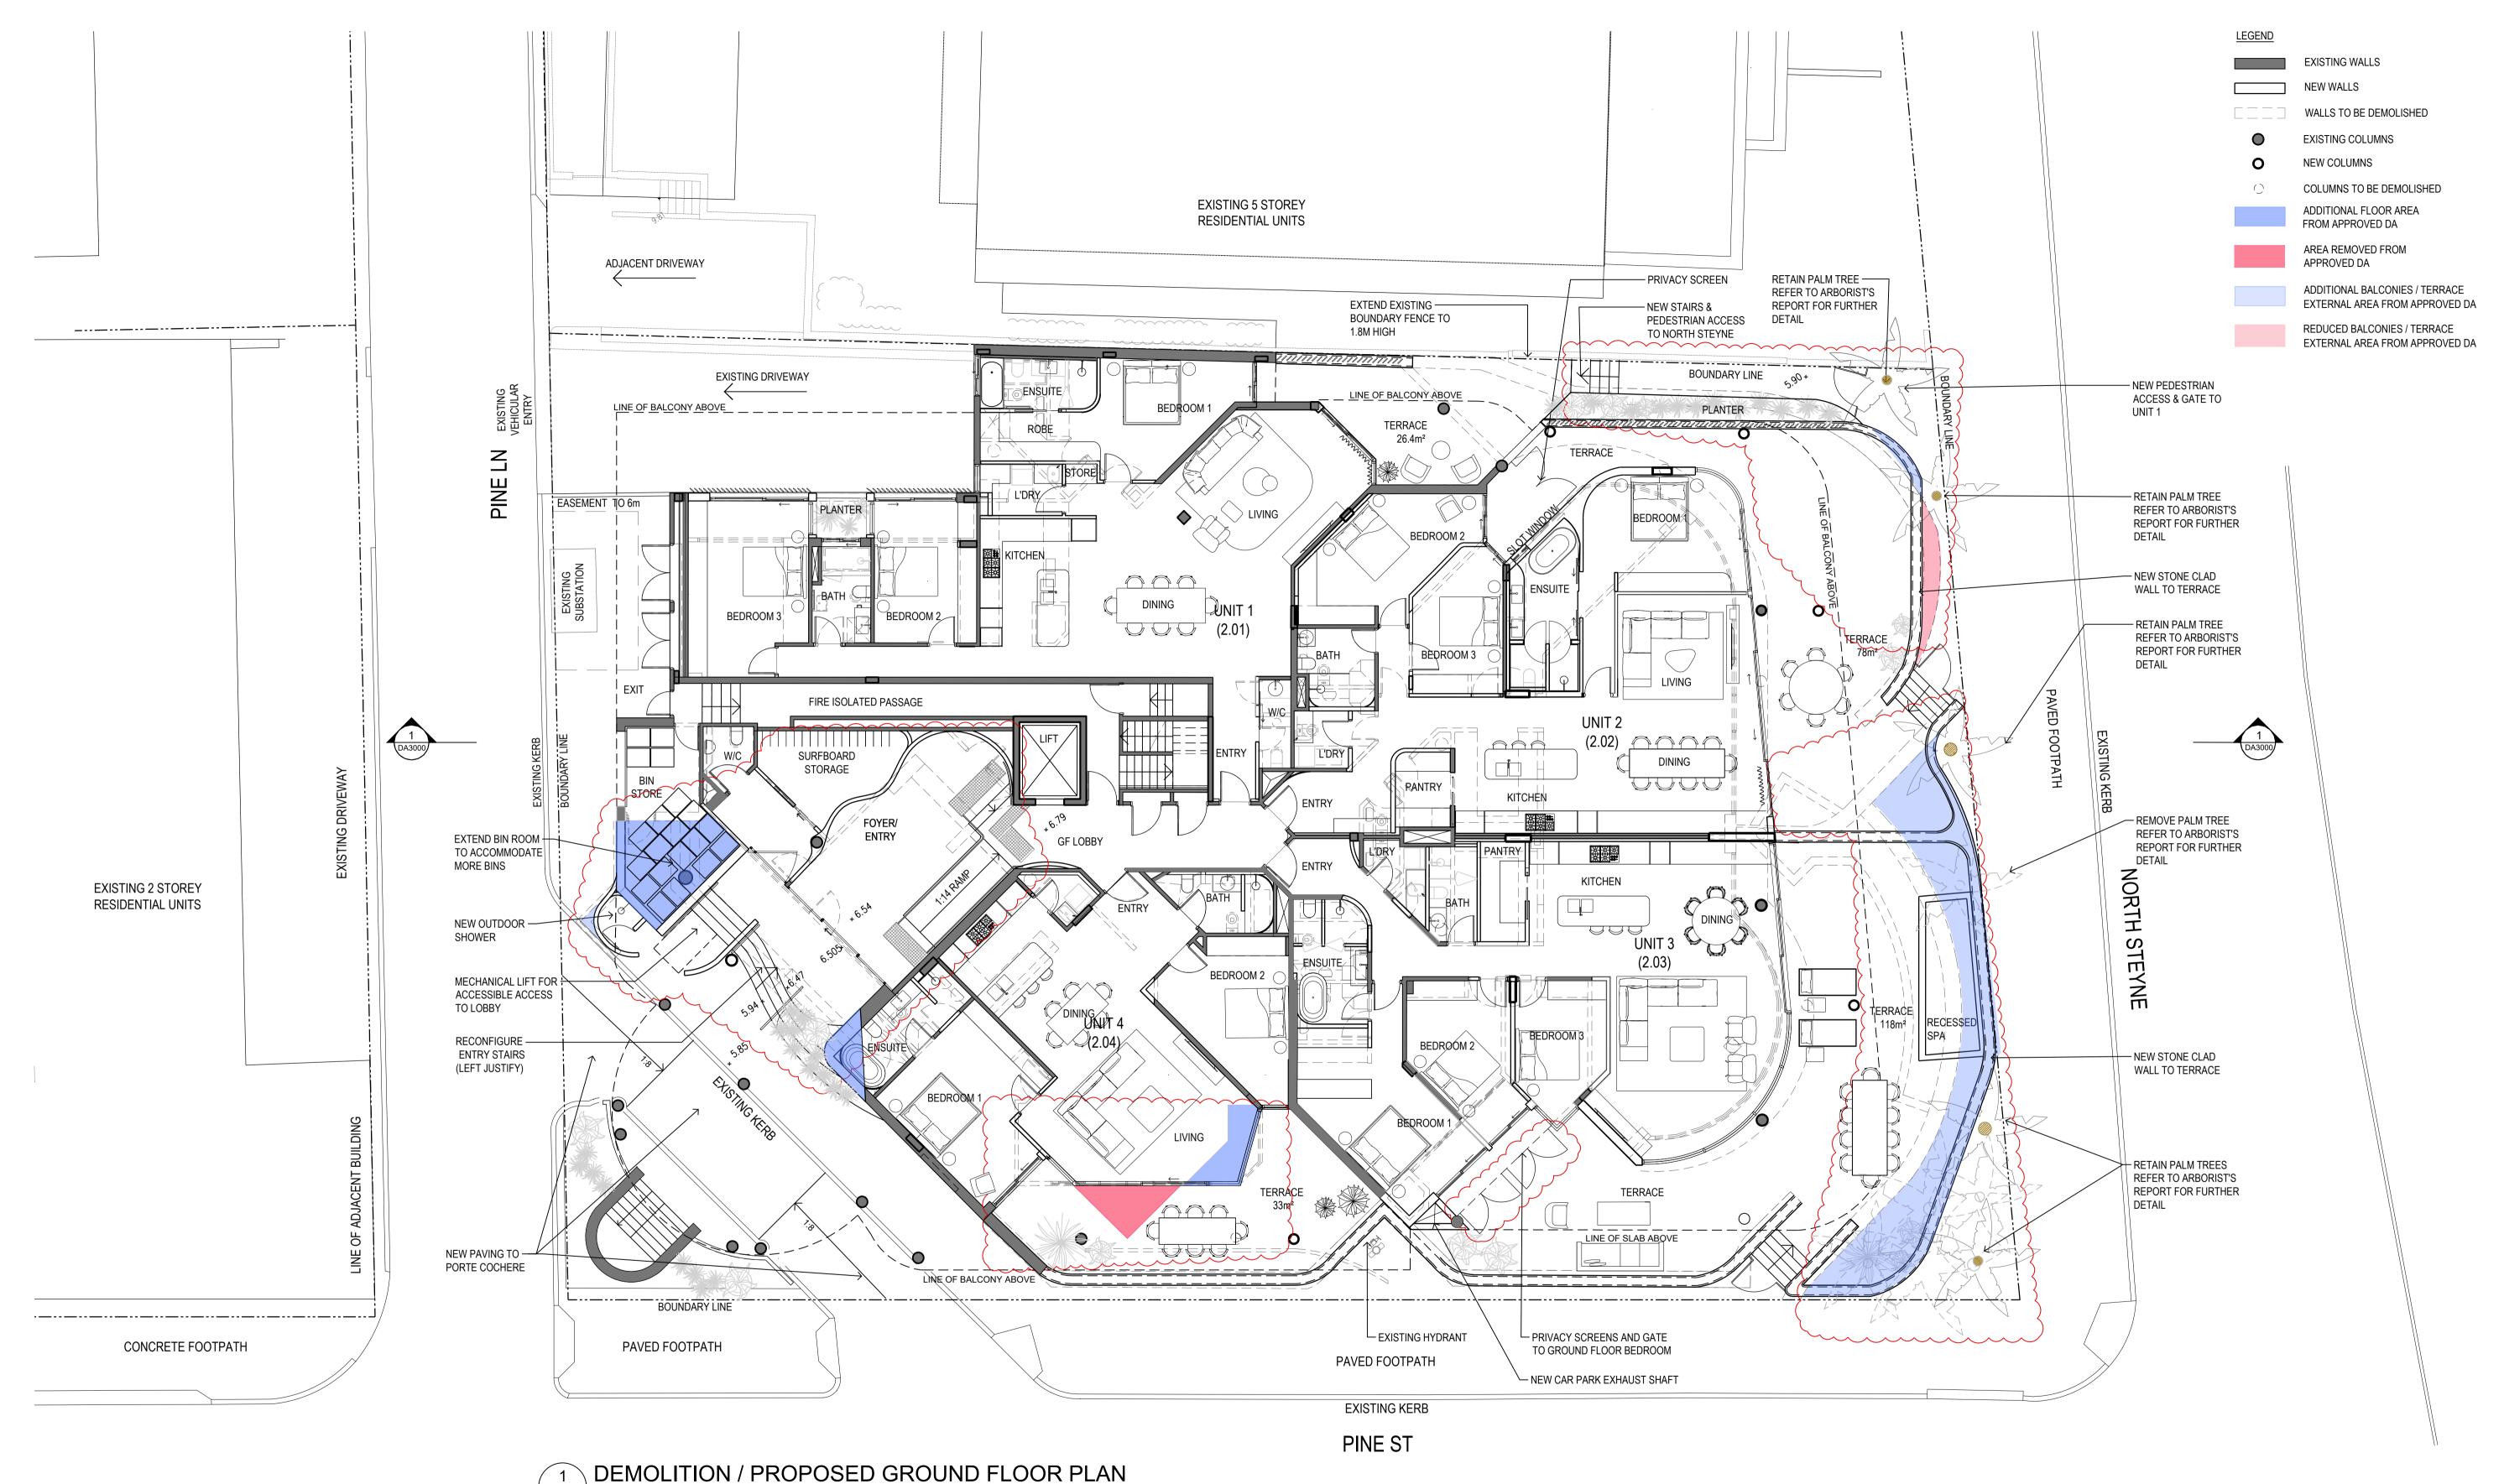
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DRAWING TITLE LOCATION PLAN & PHOTOMONTAGE



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NOTES A3: 1:200 @ A3

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LARGER WASTE ROOM TO ACCOMMODATE WALL FOR CHAIR LIFT RECONFIGURATION OF ENTRY STAIRS

ADDITIONAL NEW CHAIR CLIMBER

ADDITIONAL OUTDOOR SHOWER AT THE ENTRY

ADDITIONAL PRIVACY SCREENS AND GATE TO BEDROOM 1 AND 2 AT UNIT 3 DEMOLISHING EXISTING TERRACE WALL & REPLACE WITH NEW WALL & STONE CLADDING REMOVAL / RELOCATION OF PALM TREES AS PER ARBORIST'S ADVICE

ADDITION OF NEW POOL/SPA

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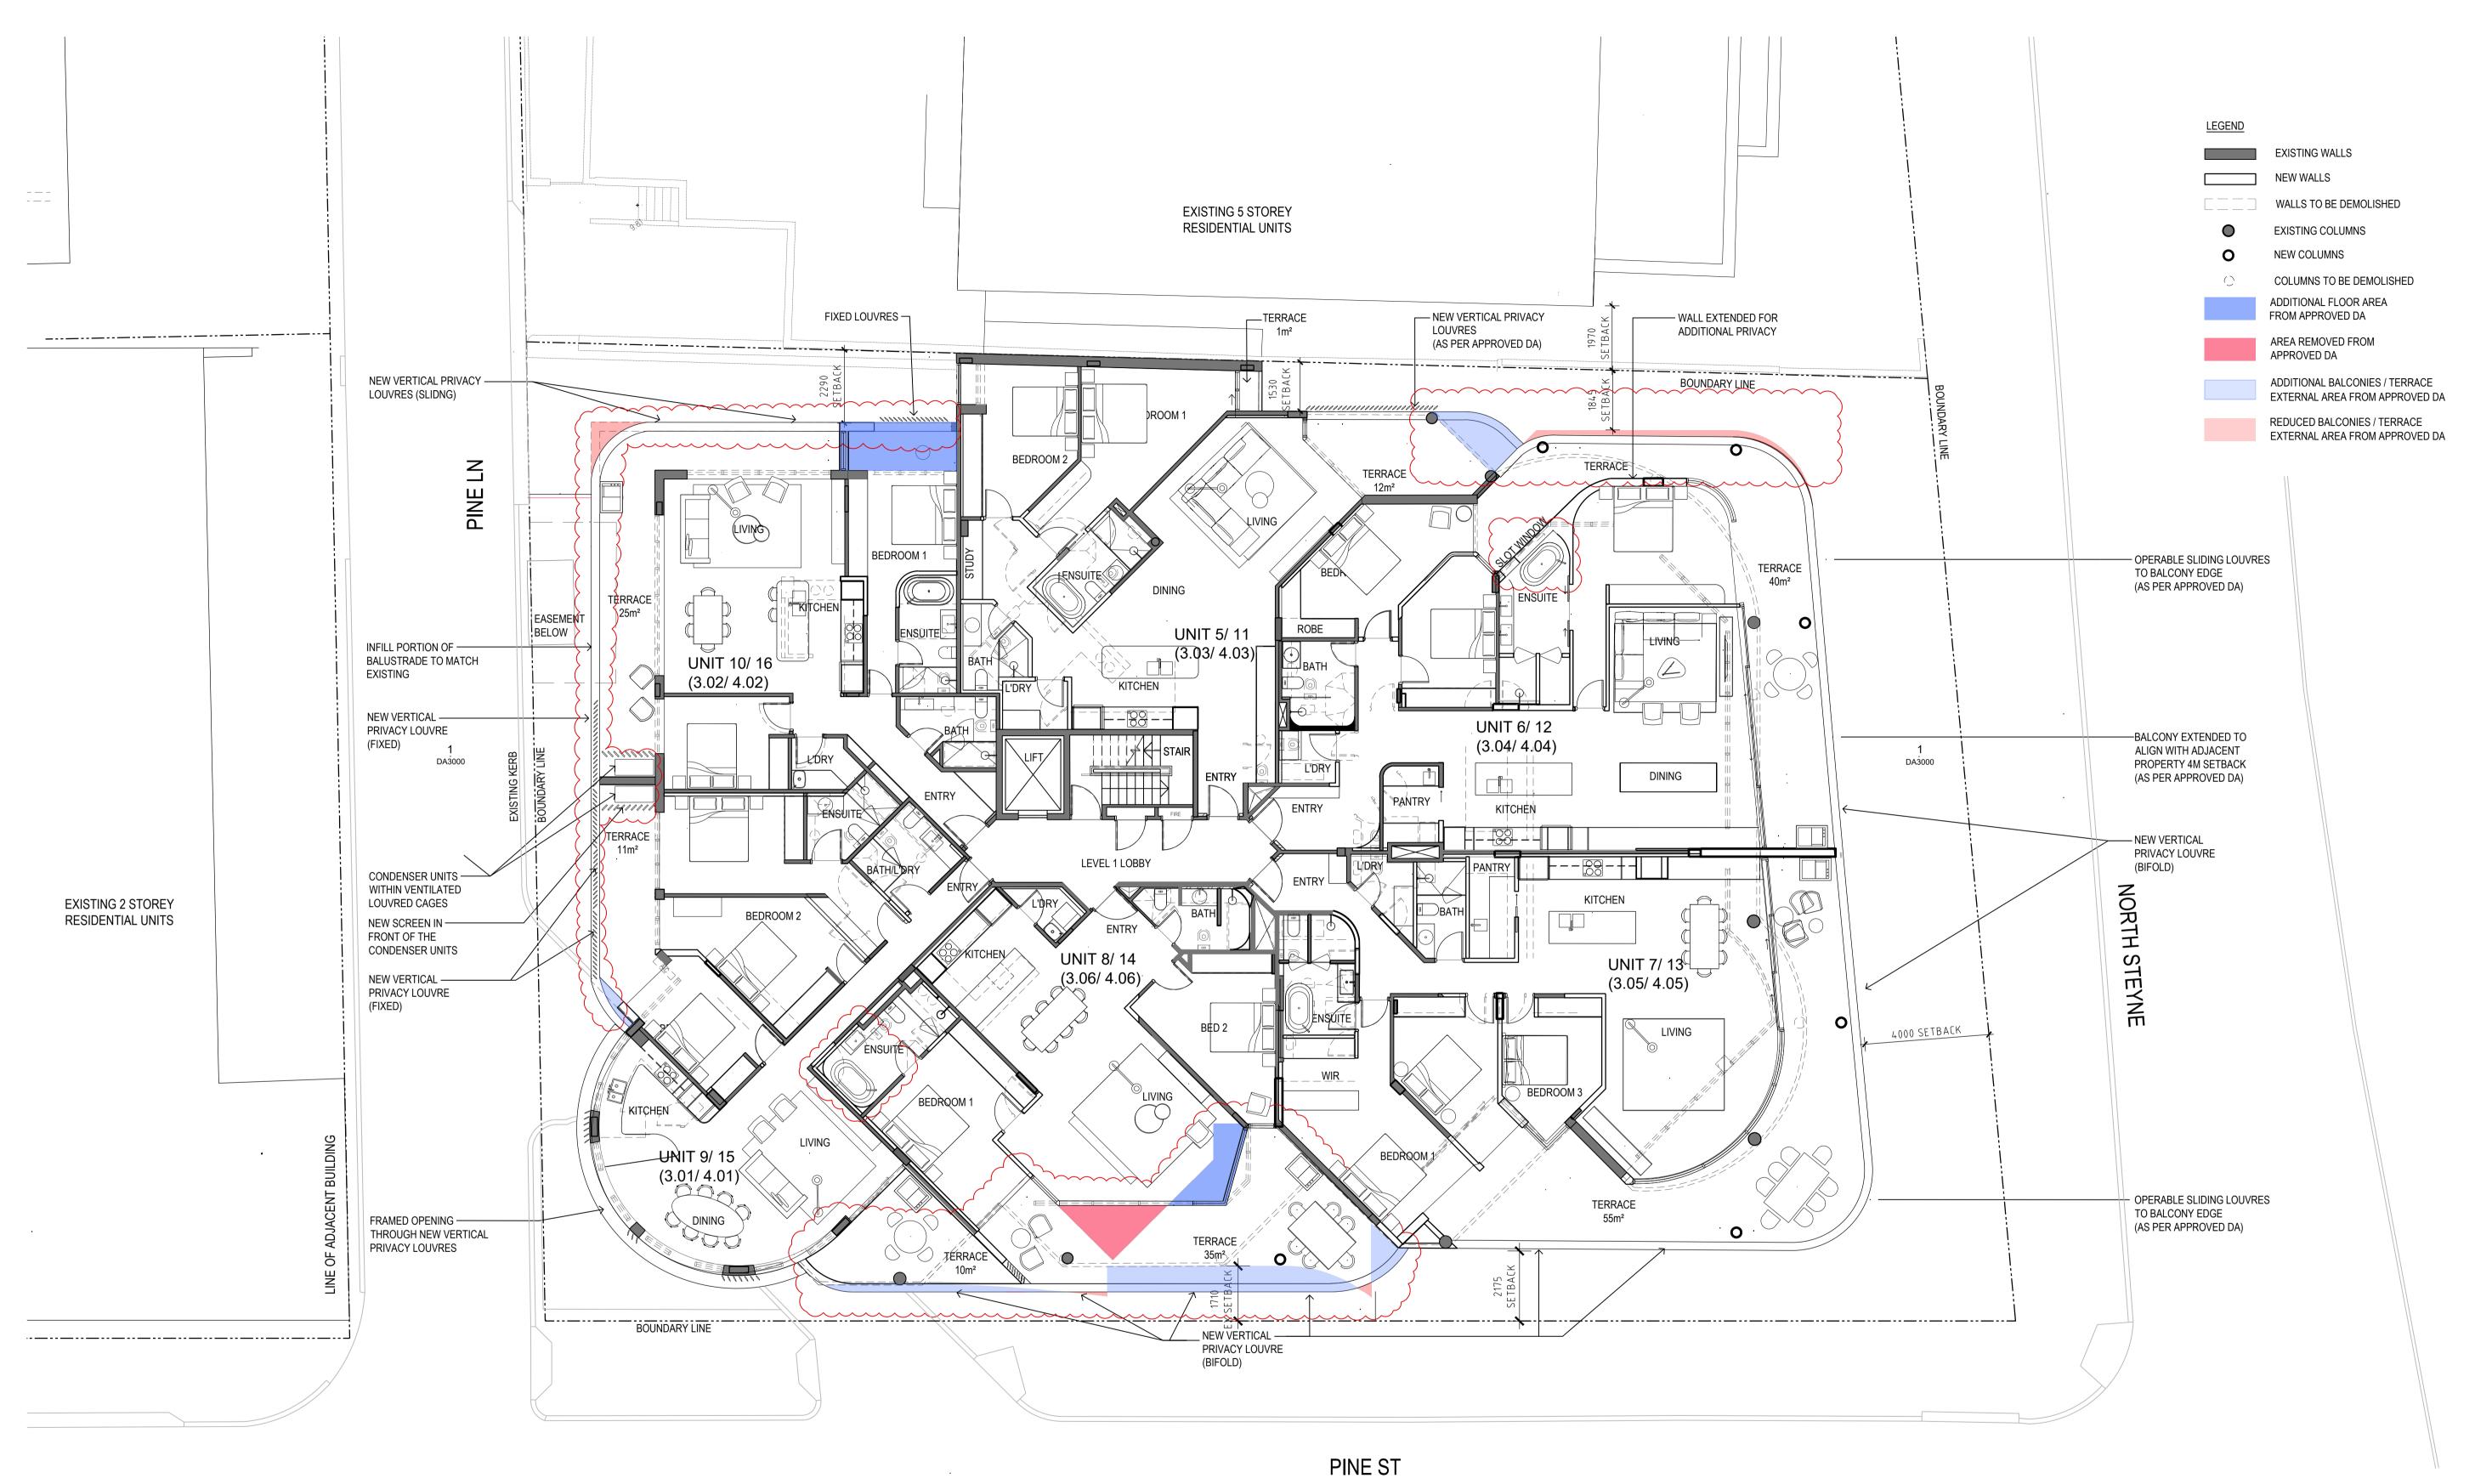
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DRAWING TITLE **DEMOLITION / PROPOSED** GROUND FLOOR PLAN





DEMOLITION / PROPOSED LEVELS 1 & 2 FLOOR PLANS 1 scale - 1:100@A1

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NOTES 1:200 @ A3 A3: REV : A1: 0 1:100 @ A1

- RE CONFIGURATION OF NEW VERTICAL PRIVACY SCREENS ALONG THE BALCONIES
- RESHAPED / CURVED THE CORNERS OF THE BALCONIES TO MATCH THE BUILDING SHAPE • RECONFIGURATION OF SOUTHERN BALCONY AND PRIVACY LOUVERS
- RECONFIGURATION OF THE EXTERNAL SOUTHERN WALL IN UNIT 8/14
- ADDITIONAL NEW CONDENSER UNITS AND NEW SCREENS IN WESTERN BALCONY FOR UNIT 8,10,14 & 16
- RE LOCATION OF INTERNAL LAUNDRY FOR UNIT 9 / 15, THE EXCESS AREA ADDED TO UNIT 8/14. • EXTENSION OF NORTHERN EXTERNAL WALL/ WINDOWS IN UNIT 10 / 16
- EXTENSION OF BALCONY FOR UNIT 5 / 11 AND REDUCTION OF BALCONY FOR UNIT 6 /12

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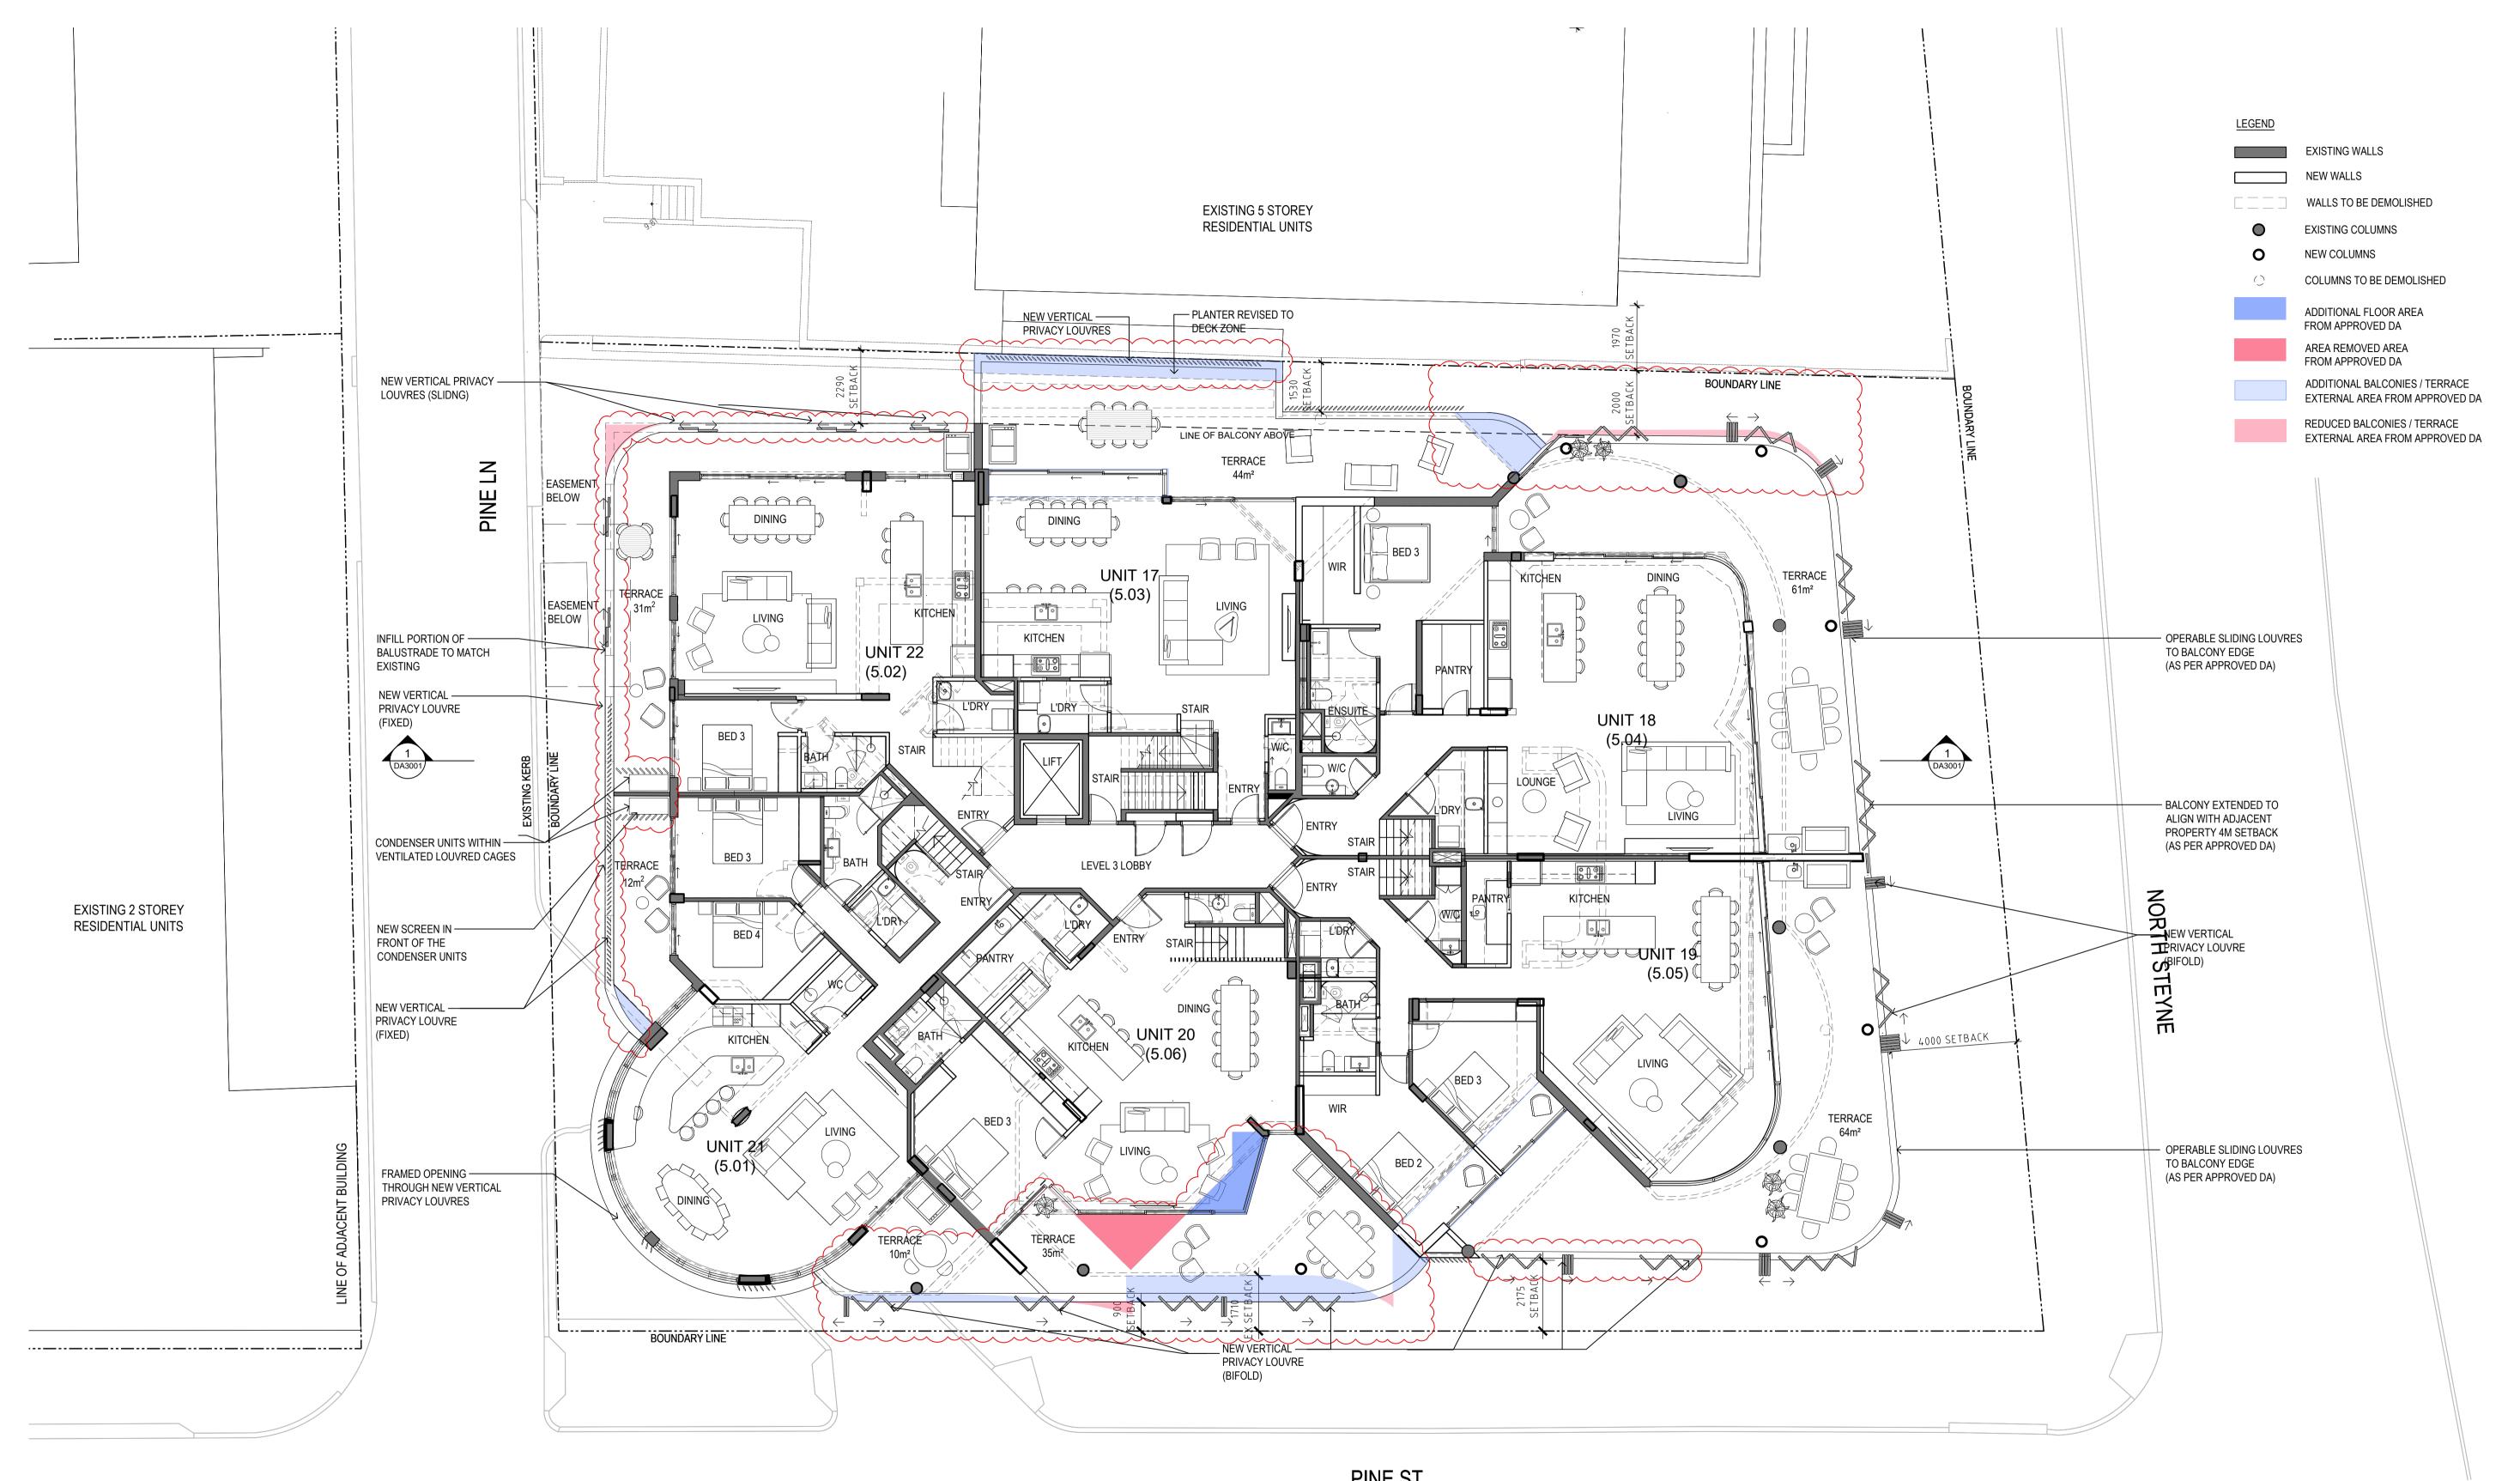
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• RE CONFIGURATION OF NEW VERTICAL PRIVACY SCREENS ALONG THE BALCONIES • RESHAPED / CURVED THE CORNERS OF THE BALCONIES TO MATCH THE BUILDING SHAPE

RECONFIGURATION OF SOUTHERN BALCONY AND PRIVACY LOUVERS

• RECONFIGURATION OF THE EXTERNAL SOUTHERN WALL IN UNIT 20

• ADDITIONAL NEW CONDENSER UNITS AND NEW SCREENS IN WESTERN BALCONY FOR UNIT 21 & 22

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LEVEL 3 FLOOR PLAN

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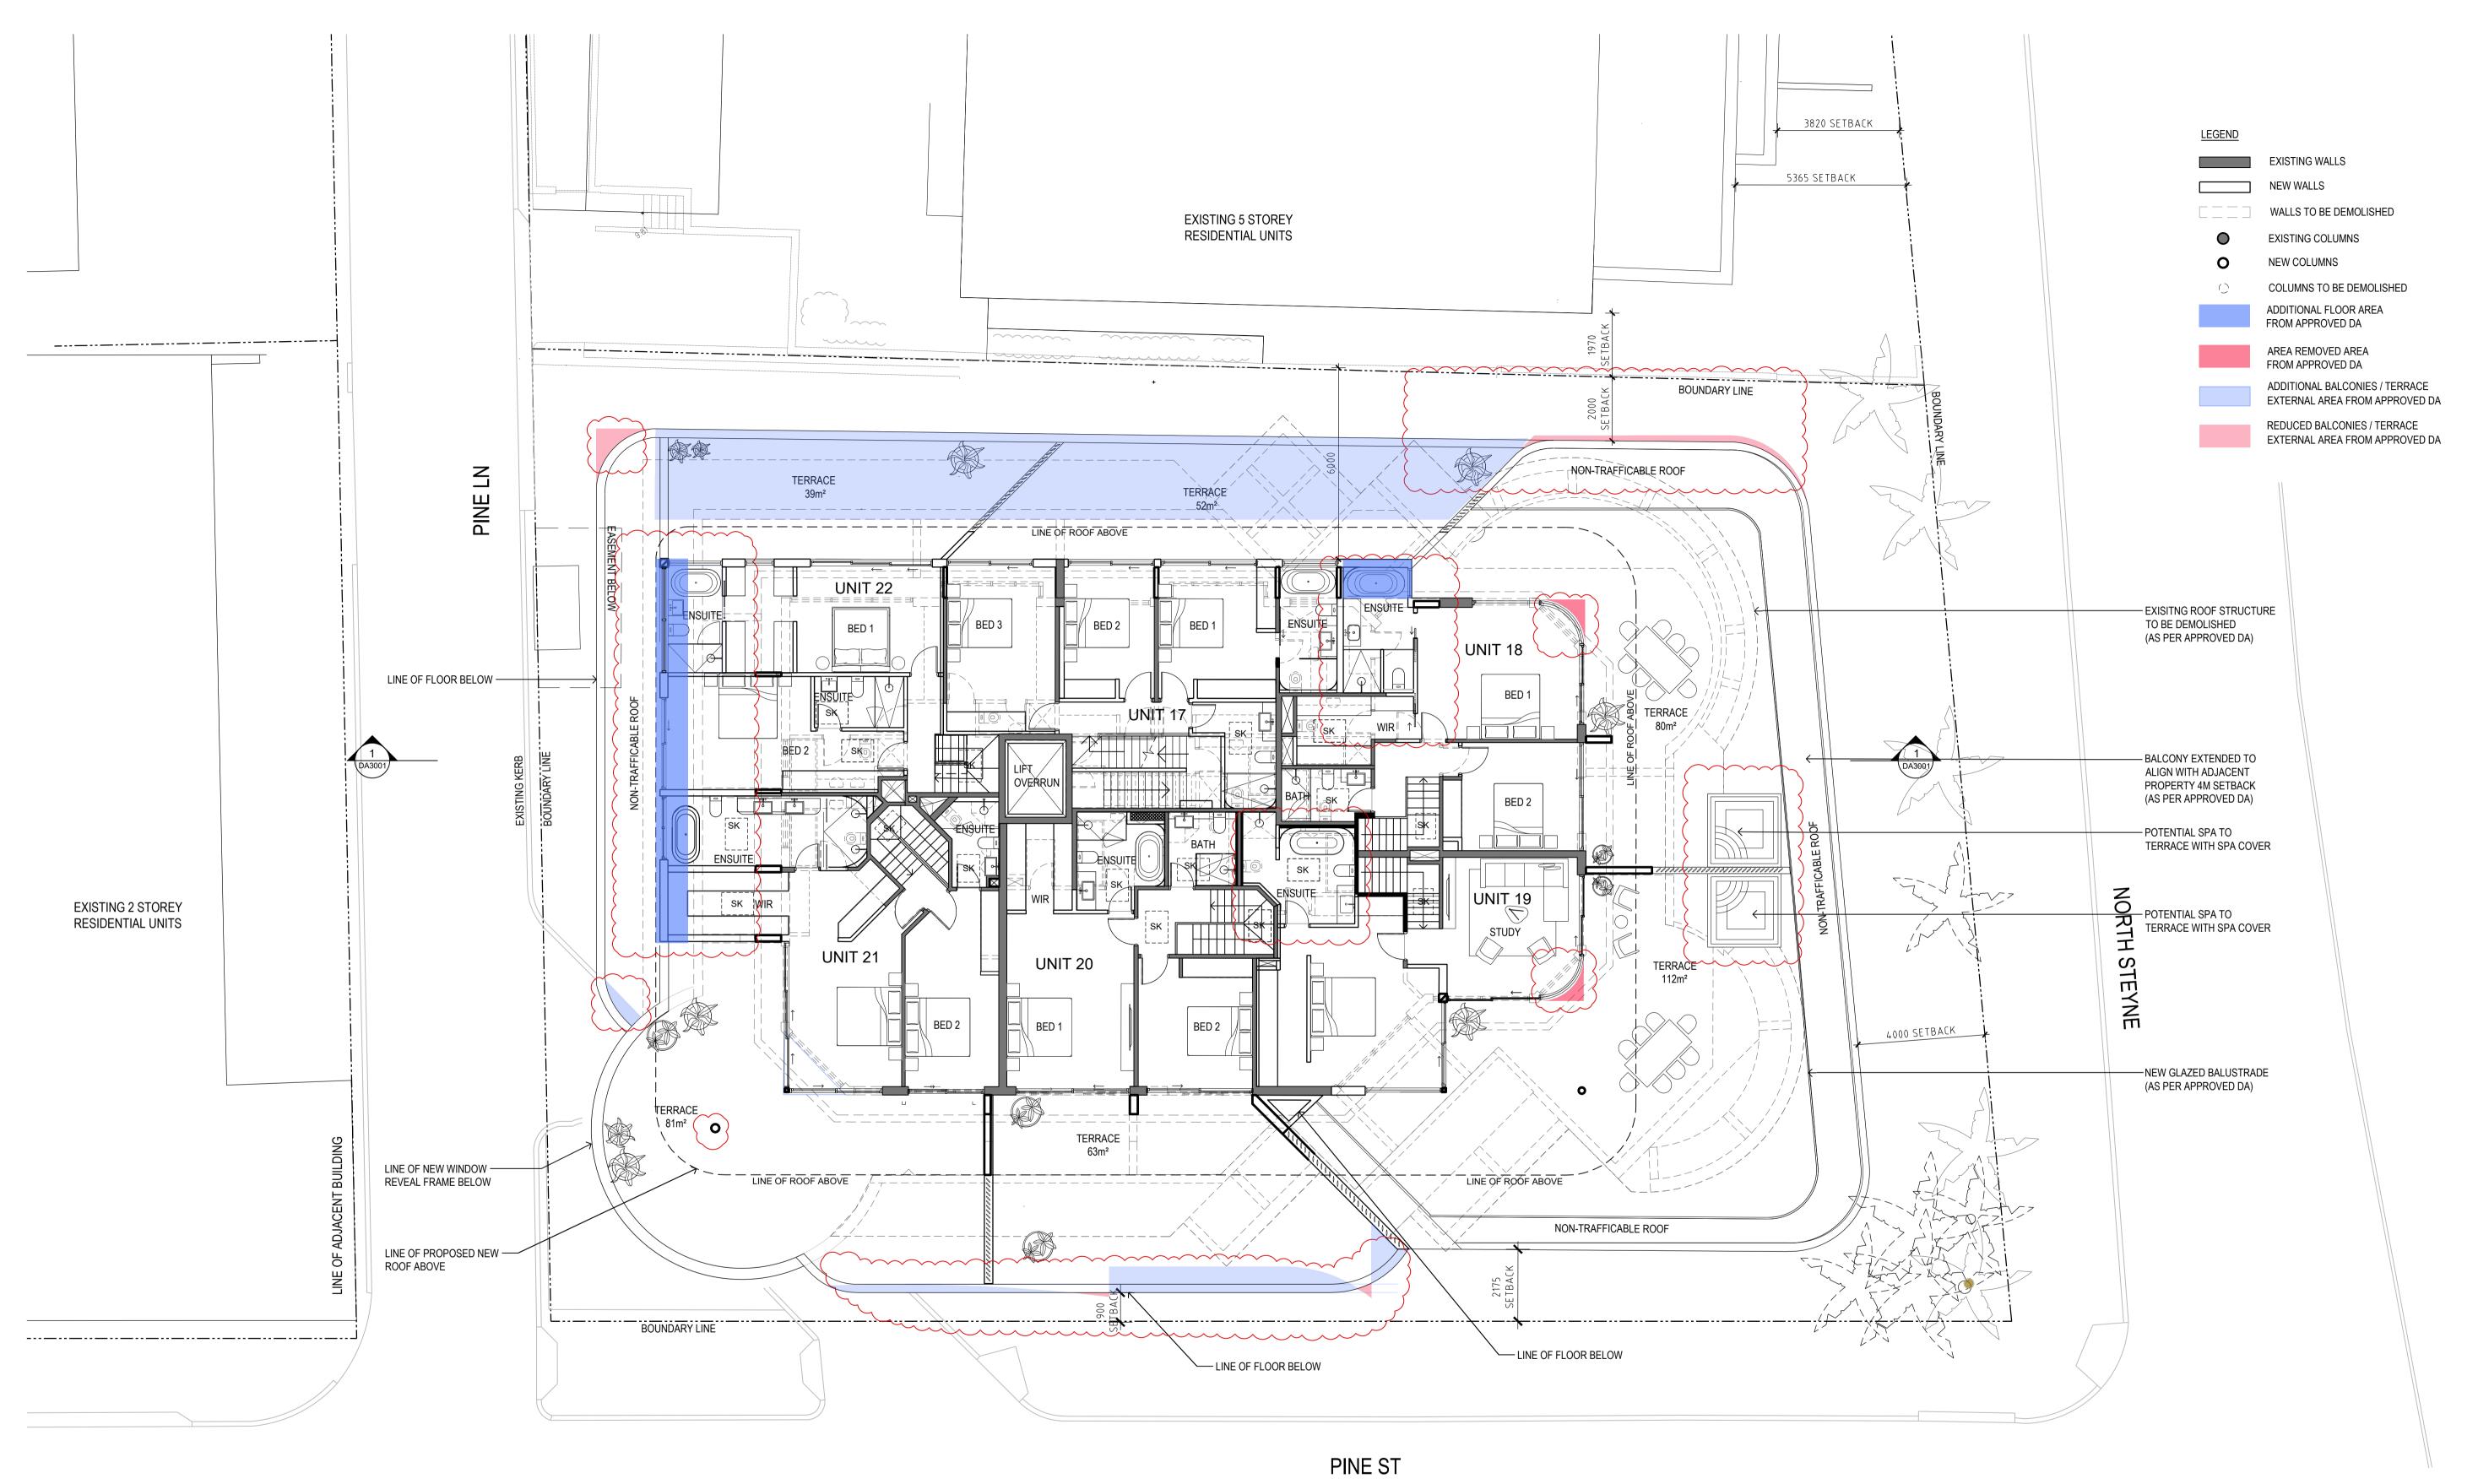
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NOTES 1:200 @ A3 A3: 1:100 @ A1 A1: 0

REV : - REVISED STAIRS IN UNIT 17 TO ACCOMMODATE ACCESS STAIR UP TO ROOF LEVEL

- EXTENSION OF UNIT 22 TO LANE
- ADDITIONAL AND RELOCATION OF SKYLIGHTS
- RECONFIGURATION OF SOUTHERN TERRACE -- ADDITIONAL PRIVACY WALLS IN SOUTHERN TERRACE
- ADDITIONAL NEW SPA FOR UNIT 18, 19, 20, AND 21

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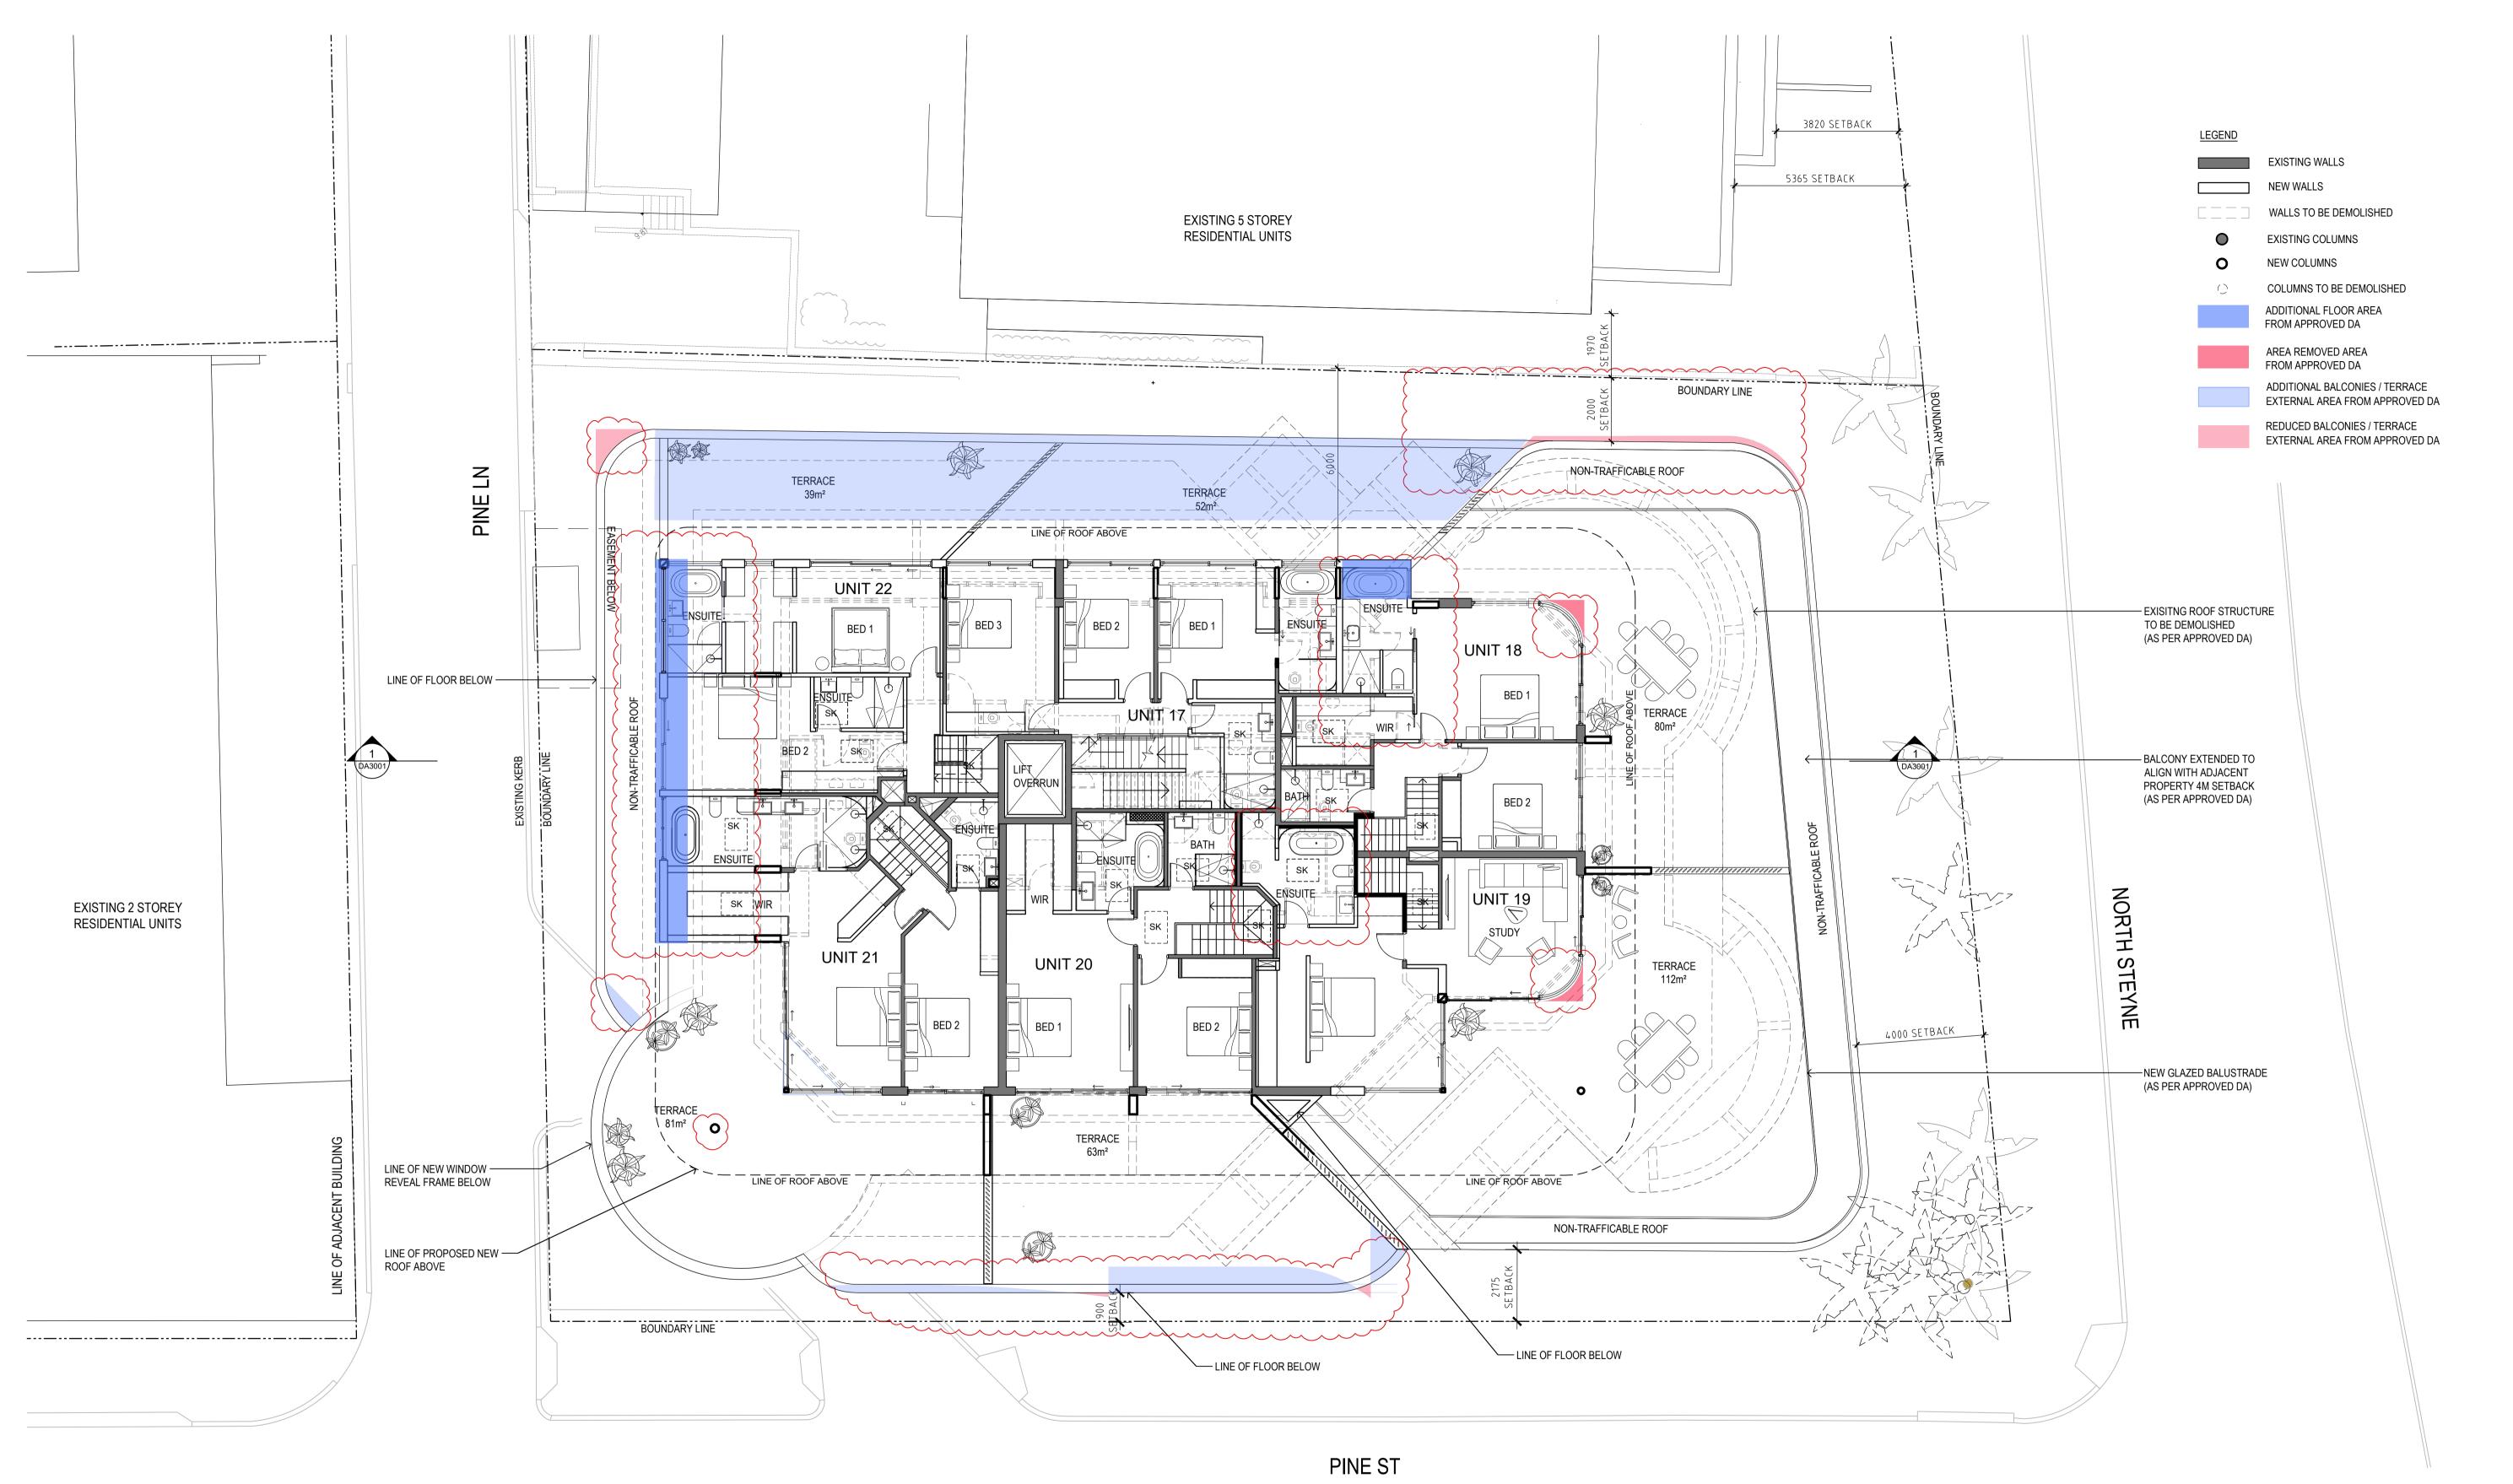
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- EXTENSION OF UNIT 22 TO LANE
- ADDITIONAL AND RELOCATION OF SKYLIGHTS RECONFIGURATION OF SOUTHERN TERRACE -
- ADDITIONAL PRIVACY WALLS IN SOUTHERN TERRACE
- ADDITIONAL NEW SPA FOR UNIT 18, 19, 20, AND 21

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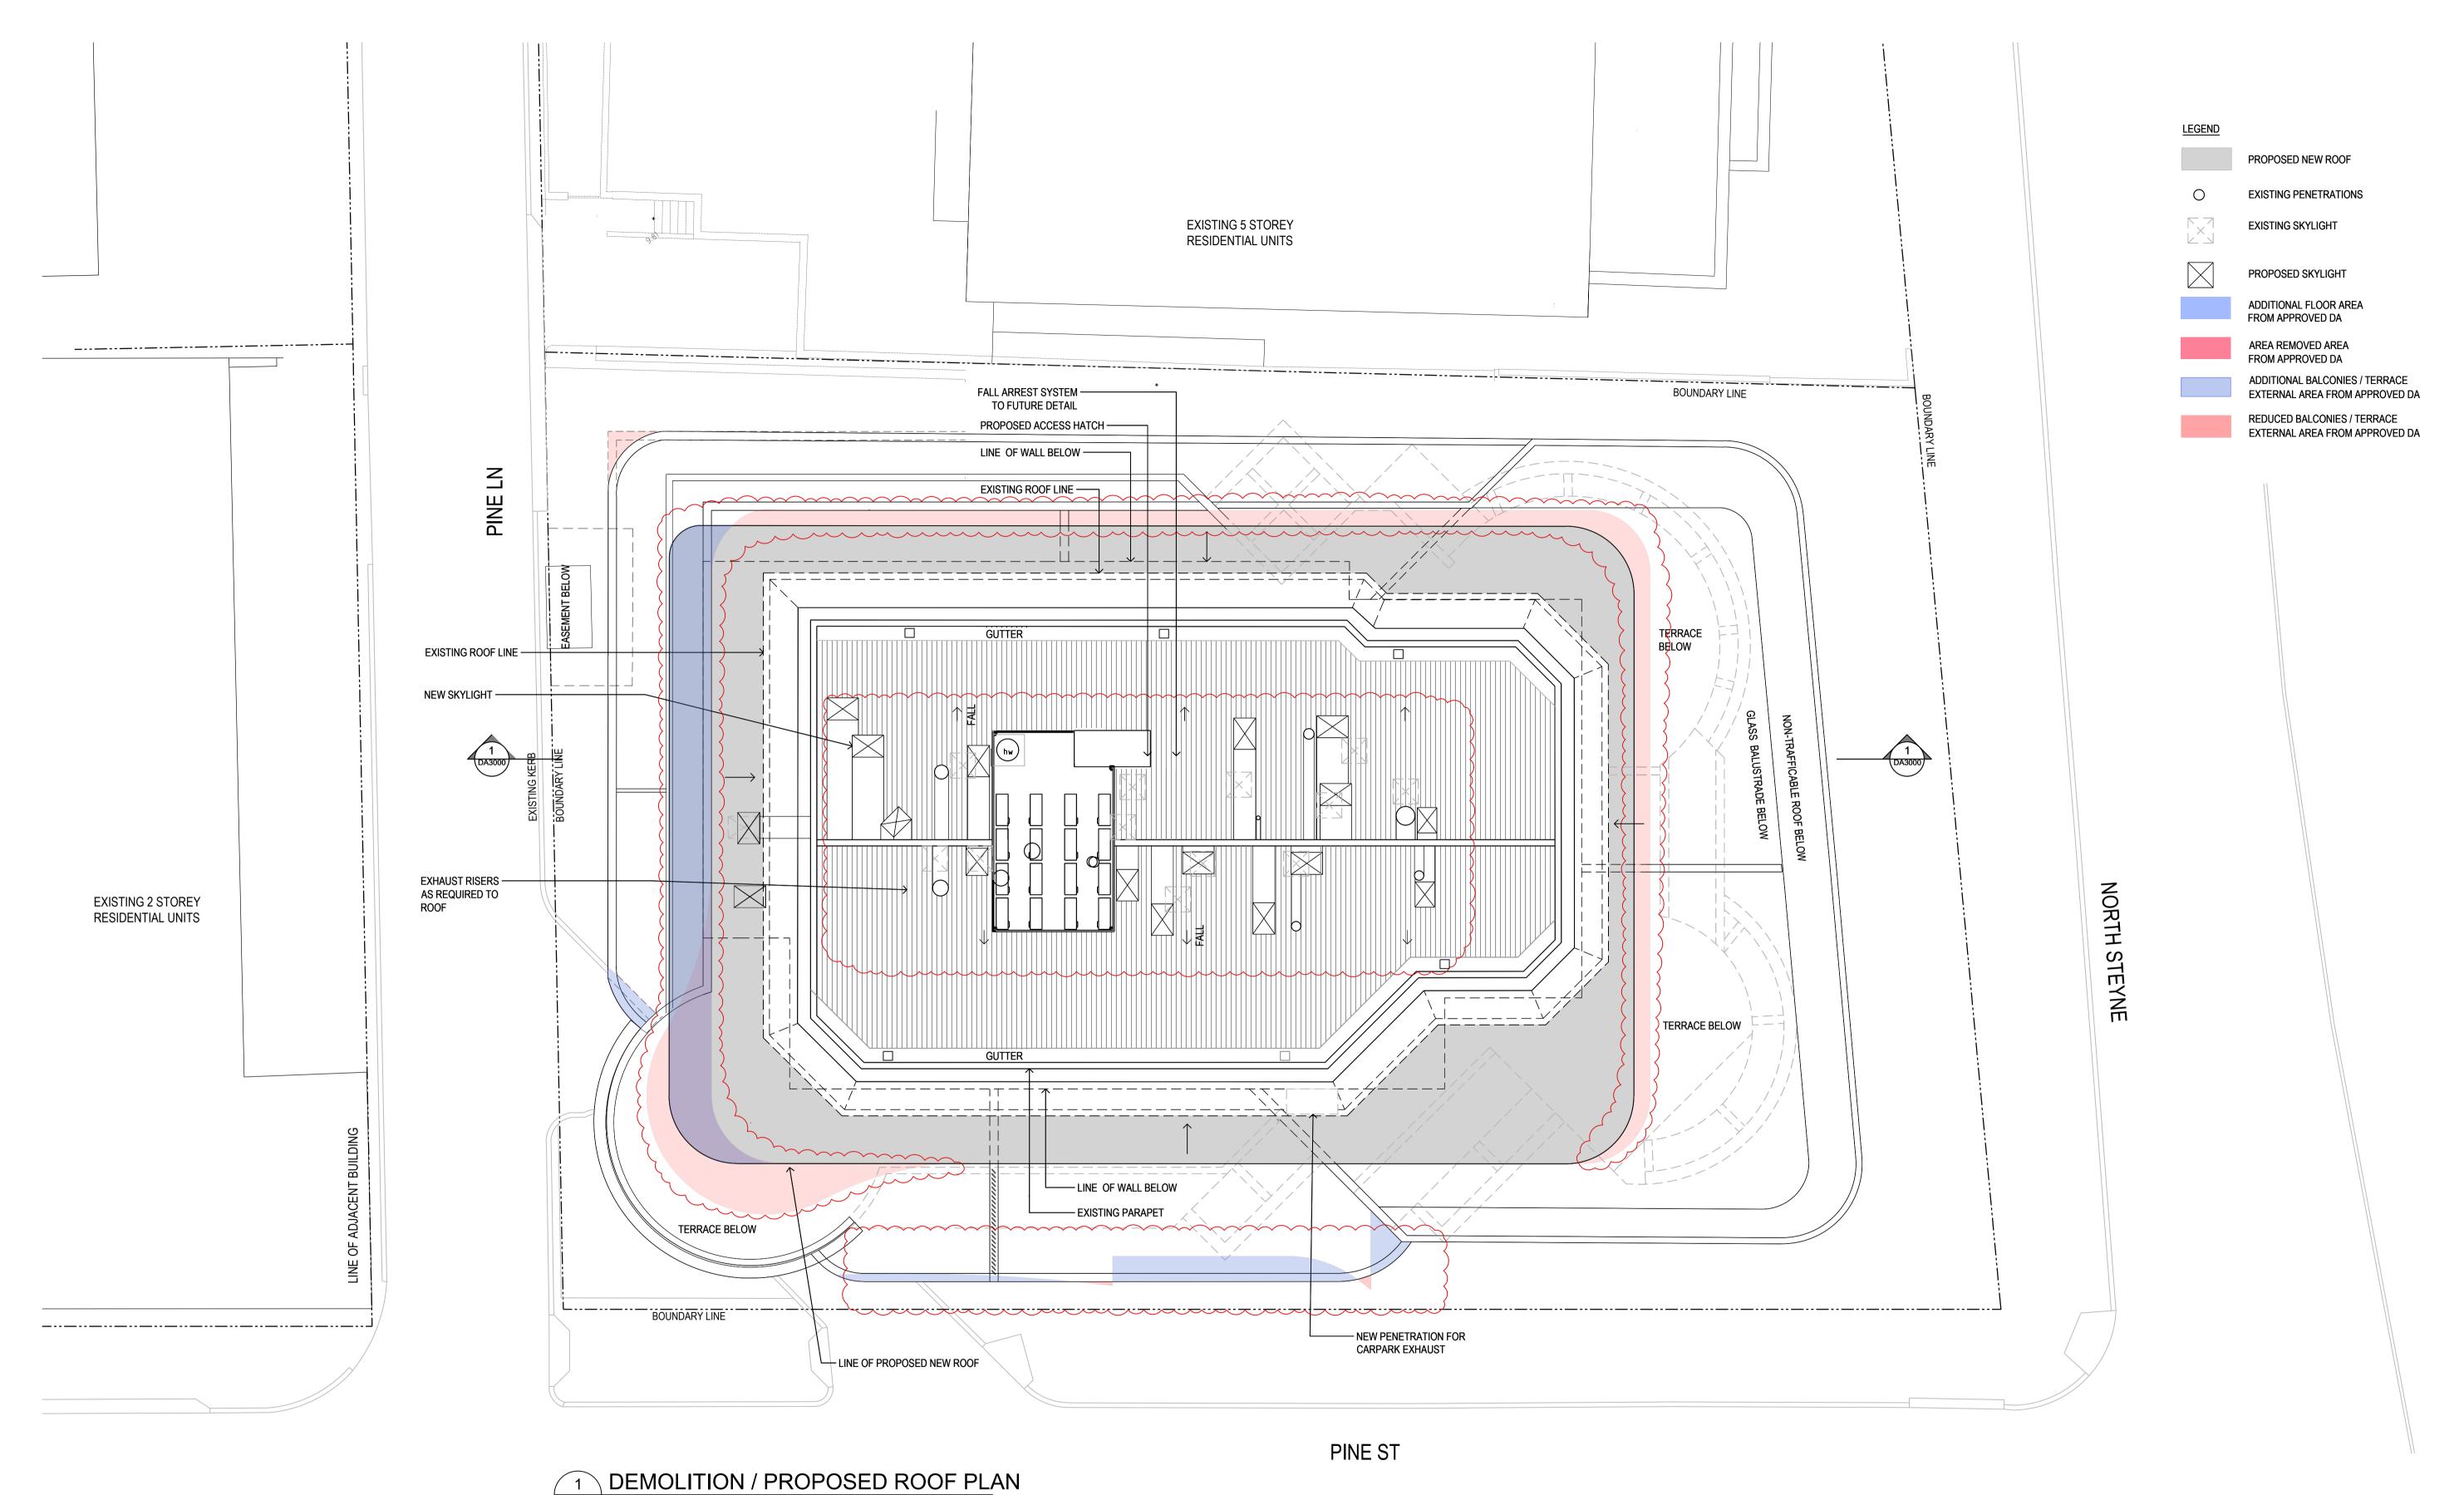
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LEVEL 4 FLOOR PLAN



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REV B: RESHAPING / REDUCING OF NEW ROOF BOUNDARY

RELOCATING NEW SLYLIGHTS

RECONFIGURATION OF NEW CONDENSER UNITS

ADDITIONAL NEW ACCESS HATCH

BELLA VISTA APARTMENTS 96 North Steyne

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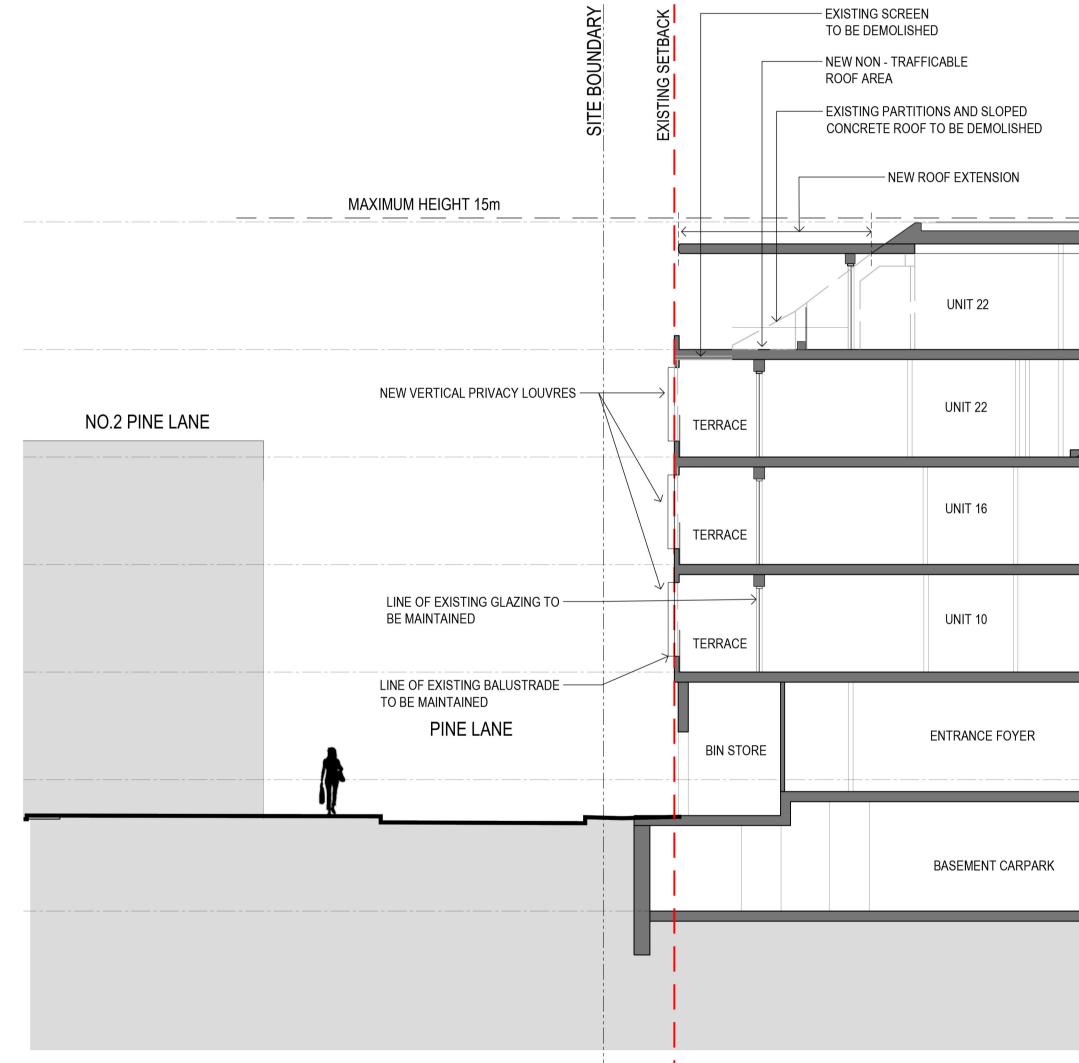
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REV : ---- ADDITION OF NEW POOL/SPA

LOUVRED ROOF PLANT -

- EXISTING SCREEN

TO BE DEMOLISHED



			 					TITION SHED	
	UNIT 17				UNIT 18		TERRACE	TERRACE	LINE OF N NEW NON ROOF ARE
		UNIT 17				UNIT 18		TERRACE	<u> </u>
		UNIT 11				UNIT 12		TERRACE	•
		UNIT 5				UNIT 6		TERRACE	۹
		UNIT 1				UNIT 2		TERRACE	
			BASE	EMENT CARF	PARK				
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NOTES

A3:

1:100 @ A1 5 A1: 0 - LARGER WASTE ROOM TO ACCOMMODATE WALL FOR CHAIR LIFT

RECONFIGURATION OF ENTRY STAIRS

ADDITIONAL NEW CHAIR CLIMBER ADDITIONAL OUTDOOR SHOWER AT THE ENTRY

ADDITIONAL PRIVACY SCREENS AND GATE TO BEDROOM 1 AND 2 AT UNIT 3 DEMOLISHING EXISTING TERRACE WALL & REPLACE WITH NEW WALL & STONE CLADDING REMOVAL / RELOCATION OF PALM TREES AS PER ARBORIST'S ADVICE

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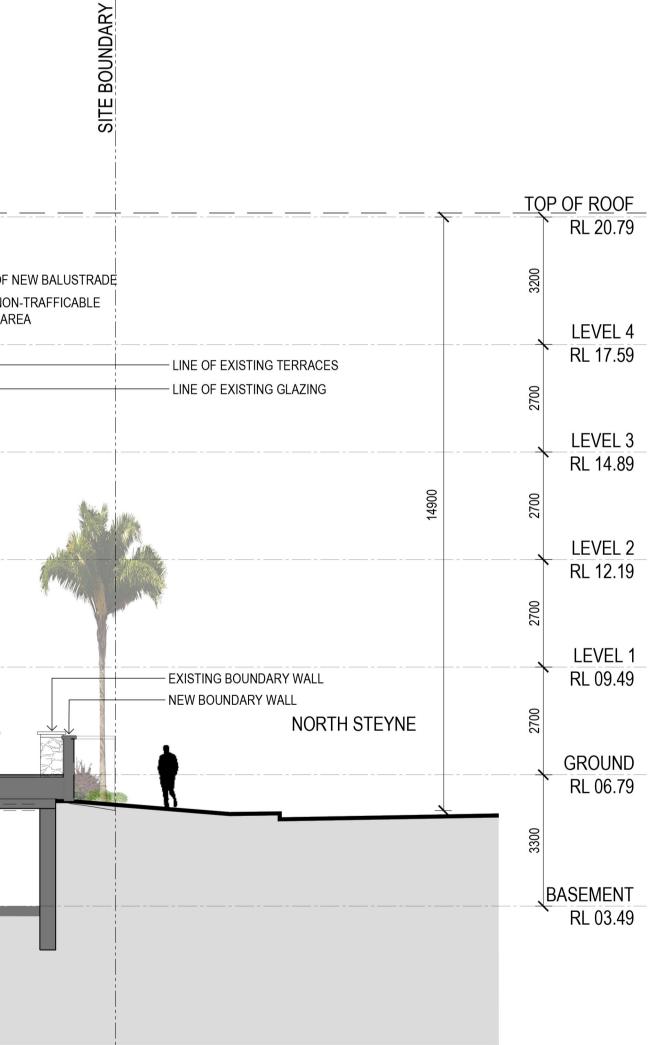
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- LARGER WASTE ROOM TO ACCOMMODATE WALL FOR CHAIR LIFT
- RECONFIGURATION OF ENTRY STAIRS
- ADDITIONAL NEW CHAIR CLIMBER
- ADDITIONAL OUTDOOR SHOWER AT THE ENTRY
- ADDITIONAL PRIVACY SCREENS AND GATE TO BEDROOM 1 AND 2 AT UNIT 3 - DEMOLISHING EXISTING TERRACE WALL & REPLACE WITH NEW WALL & STONE CLADDING
- REMOVAL / RELOCATION OF PALM TREES AS PER ARBORIST'S ADVICE - ADDITION OF NEW POOL/SPA

INTERIOR DESIGNERS

Manly

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ARCHITECTS

A RENDERED CONCRETE WHITE PAINT FINISH



B OPERABLE VERTICAL LOUVRE



C FIXED VERTICAL LOUVRE



D GLASS BALUSTRADE



E ALUMINIUM WINDOW FRAME WHITE POWDER COAT FINISH



F NEW STONE LOOK WALL



H BRONZE LOOK



G ROOF FINISH



J LIGHT GREY PAINT FINISH

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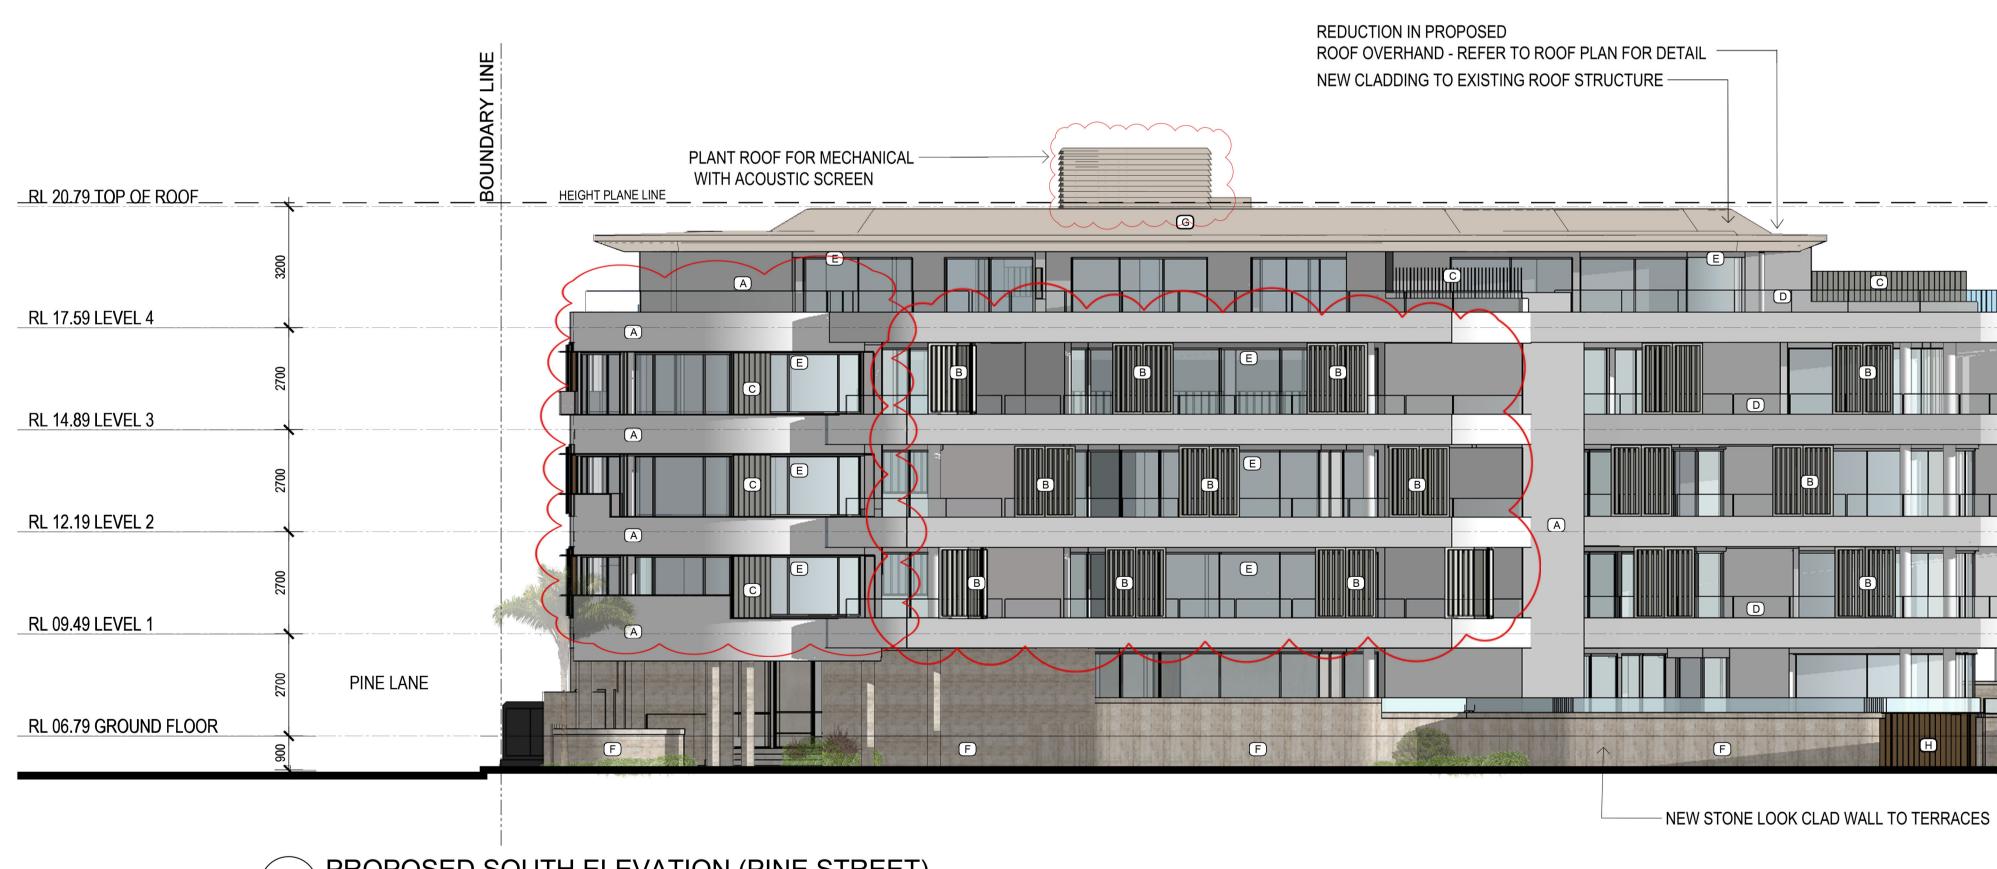
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PROPOSED SOUTH ELEVATION (PINE STREET) scale - 1:100@A1

- ISS DATE PURPOSE OF ISSUE
- A 21.11.17 DEVELOPMENT APPLICATION
- B 11.08.21 SECTION 4.55

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Do not scale drawing. Verify all dimensions on site. Report any discrepancies in documentation to architect. This drawing is for the purpose of council approval and as such, is not suitable for construction.

NOTES

- REV : A1: 0 1 1:100 @ A1 5 - LARGER WASTE ROOM TO ACCOMMODATE WALL FOR CHAIR LIFT
- RECONFIGURATION OF ENTRY STAIRS

A3:

- ADDITIONAL NEW CHAIR CLIMBER
- ADDITIONAL OUTDOOR SHOWER AT THE ENTRY - ADDITIONAL PRIVACY SCREENS AND GATE TO BEDROOM 1 AND 2 AT UNIT 3
- DEMOLISHING EXISTING TERRACE WALL & REPLACE WITH NEW WALL & STONE CLADDING - REMOVAL / RELOCATION OF PALM TREES AS PER ARBORIST'S ADVICE - ADDITION OF NEW POOL/SPA

1:200 @ A3

PROJECT BELLA VISTA APARTMENTS

96 North Steyne Manly

CLIENT CECIL KOUTSOS

squillace

ARCHITECTS INTERIOR DESIGNERS squillace.com.au

A RENDERED CONCRETE WHITE PAINT FINISH



B OPERABLE VERTICAL LOUVRE



C FIXED VERTICAL LOUVRE



D GLASS BALUSTRADE



E ALUMINIUM WINDOW FRAME WHITE POWDER COAT FINISH



F NEW STONE LOOK WALL



H BRONZE LOOK



G ROOF FINISH



J LIGHT GREY PAINT FINISH

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NOMINATED ARCHITECT

(A)

A

Vince Squillace Reg No. 6468 (NSW), 17219 (VIC), 3677 (QLD)



DEMOLITION / PROPOSED

GROUND FLOOR PLAN

DRAWN BY

DRAWING TITLE

SQA

NORTH STEYNE

Β CHECKED BY VS



JOB NO.

SCALE 1:100@A1 21.11.17 1:200@A3

ISSUE