

# **ACTION PLANS**

# 48 ABINGDON STREET, NORTH BALGOWLAH 2093

m: 0426 957 518

e: operations@actionplans.com.au

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# **DEVELOPMENT APPLICATION**

These plans are for Development Approval only.


SHEET NUMBER	SHEET NAME	DATE PUBLISHED
DA00	COVER	13/03/2020
DA01	SITE ANALYSIS	13/03/2020
DA02	SITE / ROOF / SEDIMENT EROSION / WASTE MANAGEMENT / STORMWATER CONCEPT PLAN	13/03/2020
DA03	EXISTING GROUND FLOOR PLAN	13/03/2020
DA04	EXISTING FIRST FLOOR PLAN	13/03/2020
DA05	PROPOSED GROUND FLOOR PLAN	13/03/2020
DA06	PROPOSED FIRST FLOOR PLAN	13/03/2020
DA07	NORTH / EAST ELEVATION	13/03/2020
DA08	SOUTH / WEST ELEVATION	13/03/2020
DA09	LONG / CROSS SECTION	13/03/2020
DA10	AREA CALCULATIONS / SAMPLE BOARD	13/03/2020
DA11	WINTER SOLSTICE 9 AM	13/03/2020
DA12	WINTER SOLSTICE 12 PM	13/03/2020
DA13	WINTER SOLSTICE 3 PM	13/03/2020
DA14	BASIX COMMITMENTS	13/03/2020

ITEM DETAILS	DEVELOPMENT APPLICATION				
ADDRESS	48 ABINGDON STREET, NORTH BALGOWLAH NSW 2093				
LOT & DP/SP	LOT 350 DP 12316				
COUNCIL	NORTHERN BEACHES COUNCIL (WARRINGAH)				
SITE AREA	555.6m²				
FRONTAGE	16.408m				
CONTROLS	PERMISSIBLE / REQUIRED	EXISTING	PROPOSED	COMPLIANCE	
CONTROLS	m / m² / %	m / m² / %	m / m² / %		
<u>LEP</u>					
LAND ZONING	R2 – LOW DENSITY RESIDENTIAL	R2	R2	YES	
MINIMUM LOT SIZE	600m²	555.6m²	UNCHANGED	YES	
FLOOR SPACE RATIO	NOT IDENTIFEID	N/A	N/A	N/A	
MAXIMUM BUILDING HEIGHT	8.5m	8.314m	UNCHANGED	YES	
HAZARDS					
DEVELOPMENT ON SLOPING LAND	LANDSLIP RISK AREA A: SLOPES LESS THAN 5 DEGREES AREA B: FLANKING SLOPES FROM 5 TO 25 DEGREES			PLEASE READ IN CONJUCNTION WITH GEOTECHINCAL REPORT AND	
BUSH FIRE PRONE LAND	VEGETATION BUFFER: 100m & 30m			BUSHFIRE REPORT	
DCP					
WALL HEIGHT	7.2m	7.6m	UNCHANGED	NO (EXISTING)	
NUMBER OF STOREYS	N/A	2	UNCHANGED	YES	
SIDE BOUNDARY ENVELOPE	4m			NO (EXISTING)	
SIDE BOUNDARY SETBACKS	0.9m	E: 2.103m W: 1.118m	E: 1.989m W: UNCHANGED	YES	
FRONT BOUNDARY SETBACK	6.5m	6.594m	5.856m	NO	
REAR BOUNDARY SETBACK	6.0m	11.059m	UNCHANGED STORAGE: 6.932m	YES	
LANDSCAPE OPEN SPACE	40% (222.24m²)	36.2% (201.38m²)	35.5% (197.59m²)	NO (EXISTING)	
PRIVATE OPEN SPACE	60m²	60.11m²	61.34m <sup>2</sup>	YES	




### NCC & AS COMPLIANCES SPECIFICATIONS

- EARTHWORKS PART 3.1.1 OF NCC
- EARTH RETAINING STRUCTURES PART 3.1.2 OF NCC
- DRAINAGE PART 3.1.3 OF NCC
- TERMITE-RISK MANAGEMENT PART 3.1.4 OF NCC
- FOOTINGS & SLAB PART 3.2 OF NCC INCLUDING AS2870
- MASONRY PART 3.3 OF NCC INCLUDING AS3700
- FRAMING PART 3.4 OF NCC
- SUB FLOOR VENTILATION PART 3.4.1 OF NCC
- ROOF CLADDING AND WALL-CLADDING PART 3.5 OF NCC
- GLAZING PART 3.6 OF NCC INCLUDING AS1288
- FIRE SAFETY PART 3.7 OF NCC
- FIRE SEPERATION PART 3.7.2 OF NCC
- FIRE PROTECTION OF SEPERATING WALLS AND FLOORS- PART 3.7.3 OF NCC
- SMOKE ALARMS PART 3.7.5 OF NCC
- WET AREAS AND EXTERNAL WATERPROOFING PART 3.8.1 OF NCC
- ROOM HEIGHTS PART 3.8.2 OF NCC
- FACILITIES PART 3.8.3 OF NCC
- LIGHT PART 3.8.4 OF NCC
- VENTILATION PART 3.8.5 OF NCC
- SOUND INSULATION PART 3.8.6 OF NCC
- STAIRWAYAND RAMP CONSTRUCTION PART 3.9.1 OF NCC
- BARRIERS AND HANDRAILS PART 3.9.2 OF NCC
- SWIMMING POOLS PART 3.10.1 OF NCC
- CONSTRUCTION IN BUSHFIRE PRONE AREAS PART 3.10.5 OF NCC
- FENCING & OTHER PROVISIONS REGS & AS1926
- DEMOLITION WORKS AS2601-1991 THE DEMOLITION OF STRUCTURES.
- ALL WATERPROOF MEMBRANES TO COMPLY WITH WITH AS 3740-2010
- ALL PLUMBING & DRAINAGE WORK TO COMPLY WITH AS 3500
- SITE CLASSIFICATION AS TO AS 2870
- ALL PLASTERBOARD WORK TO COMPLY WITH AS 2588-1998
- ALL STRUCTURAL STEEL WORK TO COMPLY WITH AS 4100 & AS 1554
- ALL CONCRETE WORK TO COMPLY WITH AS 3600
- ALL ROOF SHEETING WORK TO COMPLY WITH AS 1562-1992
- ALL SKYLIGHTS TO COMPLY WITH WITH AS 4285-2007
- ALL CERAMIC TILING TO COMPLY WITH AS 3958.1-2007 & 3958.2-1992
- ALL GLAZING ASSEMBLIES TO COMPLY WITH AS2047 & 1288
- ALL TIMBER RETAINING WALLS ARE TO COMPLY WITH AS 1720.1-2010, AS 1720.2-2006, AS 1720.4-2006, AS 1170.1-1989 & AS 1170.4-2007
- ALL RETAINING WALLS ARE TO COMPLY WITH 3700 2011 & AS 3600 -2009
- ALL CONSTRUCTION TO COMPLY TO AS3959- 2009

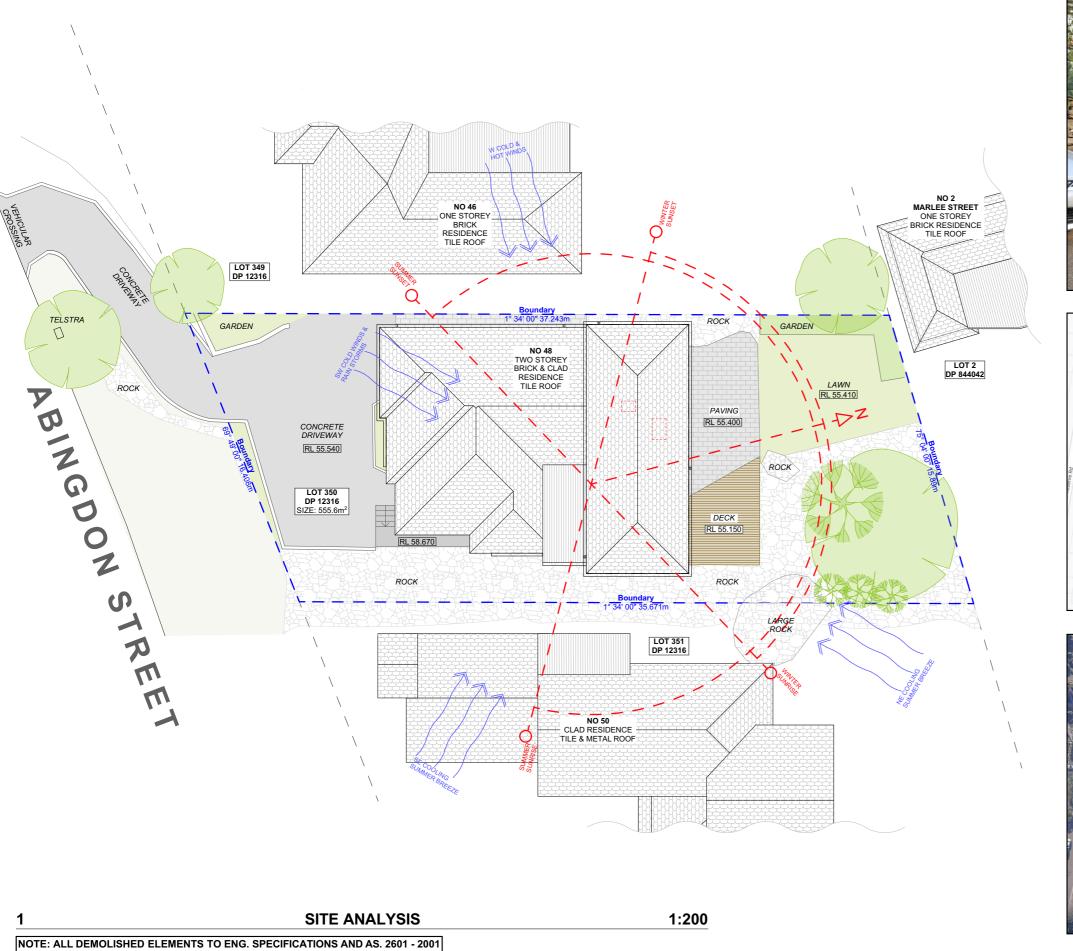



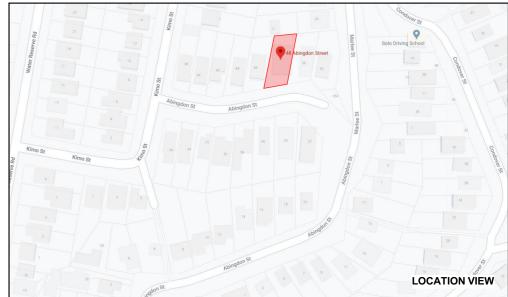




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**DP** DOWNPIPE

PROJECT ADDRESS 48 ABINGDON STREET, NORTH BALGOWLAH 2093

CLIENT

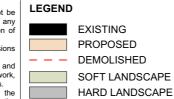
Alexander


Kerrie & James

DRAWING NO. **DA01** 

DRAWING NAME

DATE Friday, 13 March 2020 SITE ANALYSIS

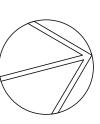

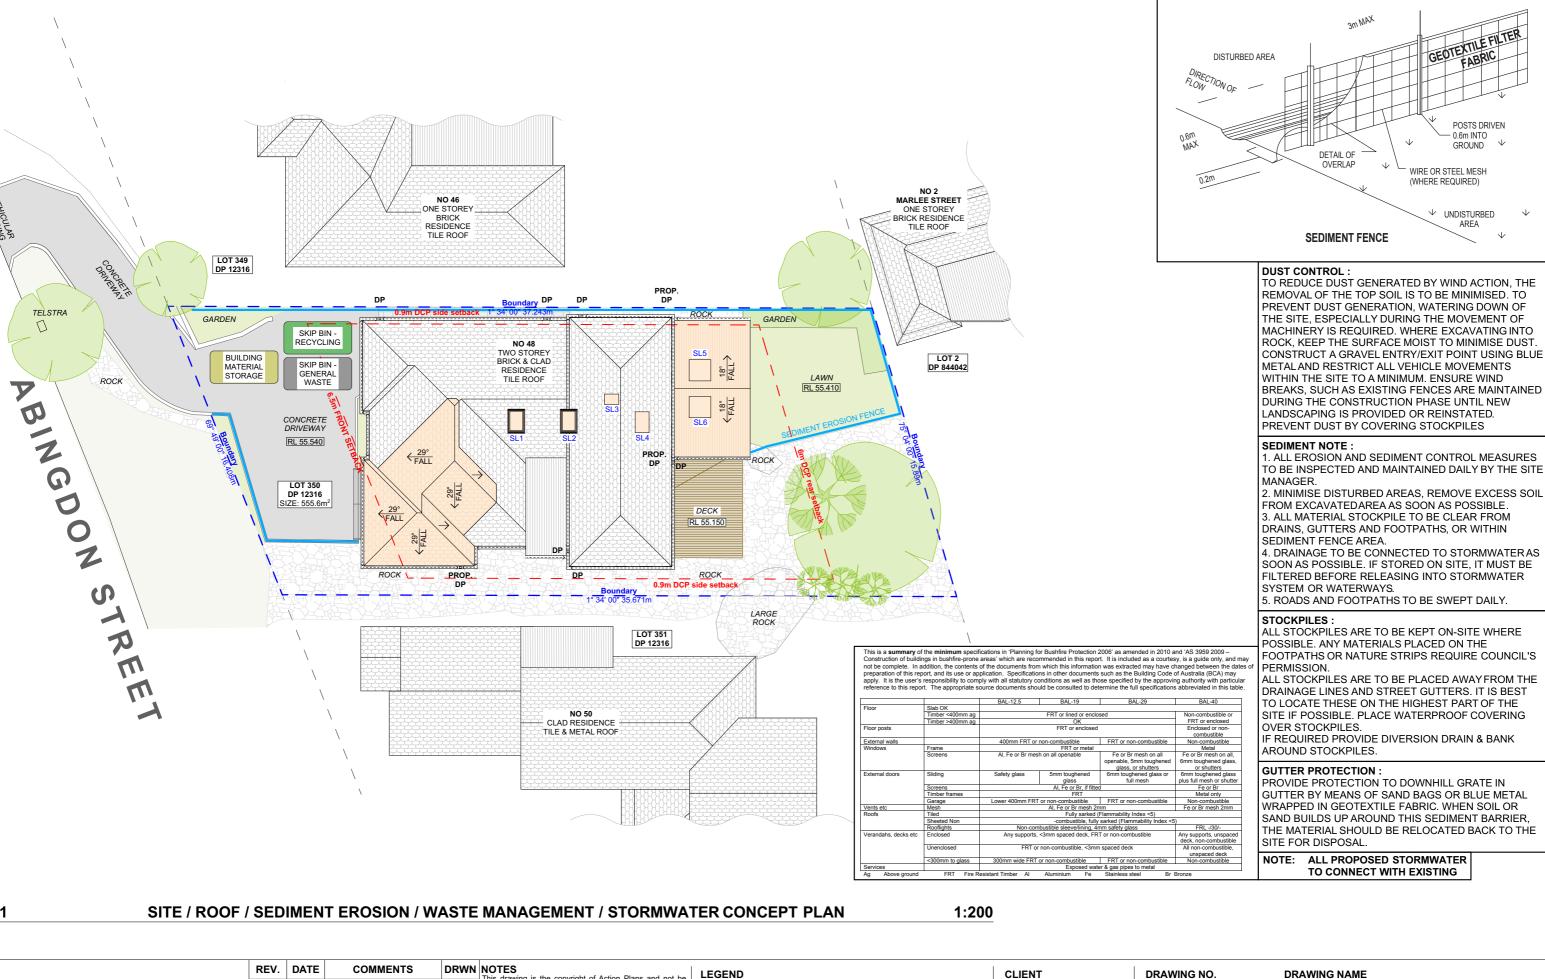

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			-		commencement of works.	



## **DP** DOWNPIPE

### Kerrie & James Alexander

#### PROJECT ADDRESS 48 ABINGDON STREET. NORTH BALGOWLAH 2093

## DRAWING NO.

# **DA02**

### DATE Friday, 13 March 2020

## **DRAWING NAME**

SITE / ROOF / SEDIMENT **EROSION / WASTE** MANAGEMENT / STORMWATER CONCEPT PLAN

TO CONNECT WITH EXISTING

3m MAX

DETAIL OF OVERLAP

**SEDIMENT FENCE** 

POSTS DRIVEN 0.6m INTO GROUND


WIRE OR STEEL MESH (WHERE REQUIRED)

↓ UNDISTURBED


AREA

#### **SCALE**

1:200 @A3

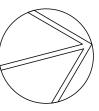

LOT 349 DP 12316

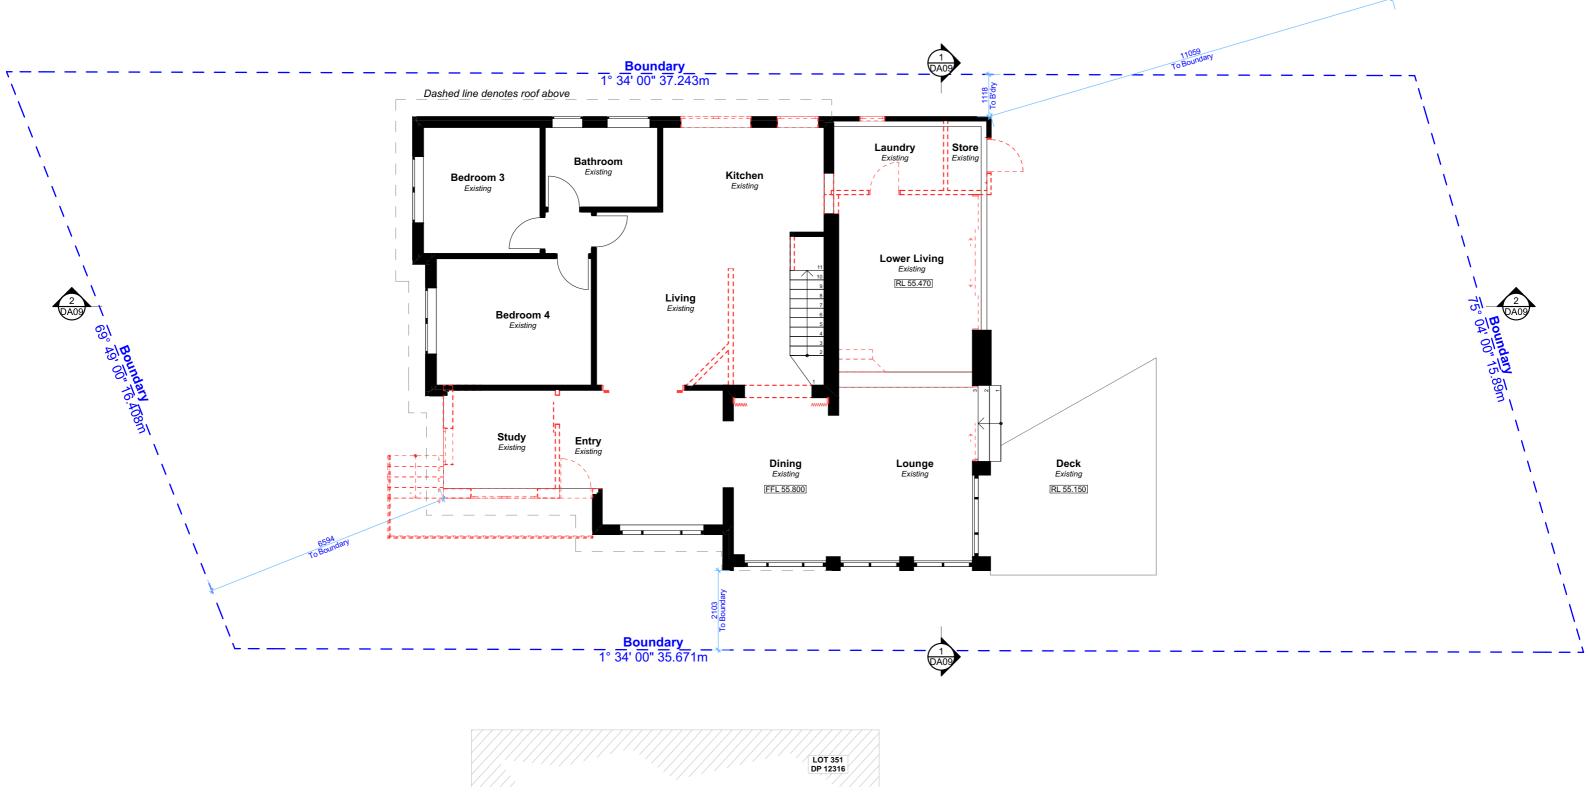


1 EXISTING GROUND FLOOR PLAN

NOTE: ALL DEMOLISHED ELEMENTS TO ENG. SPECIFICATIONS AND AS. 2601 - 2001

ACTION PLANS | REV. | DATE | | |

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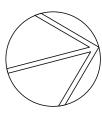
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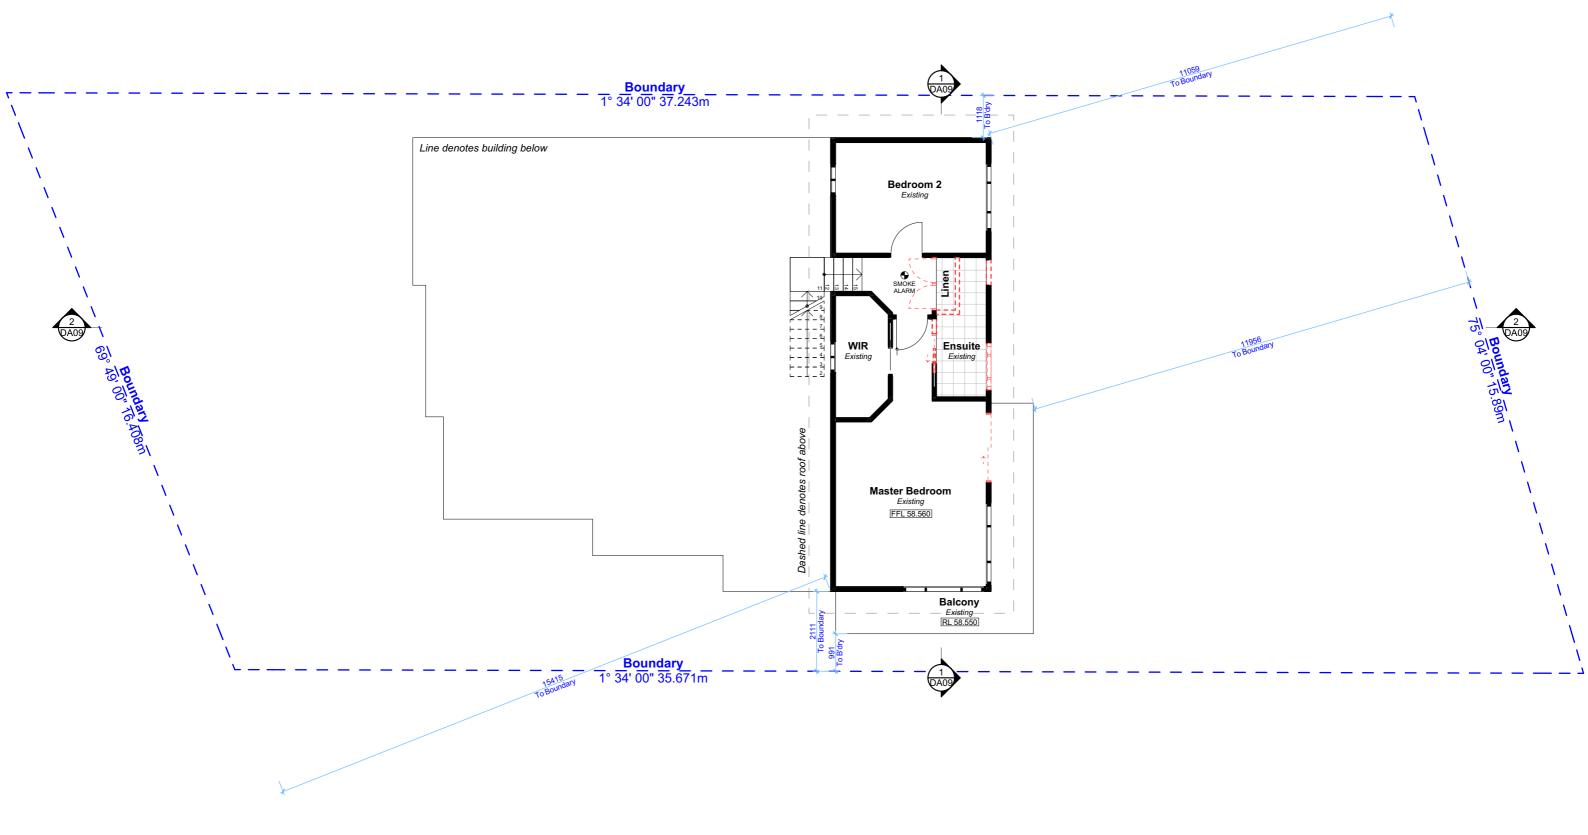
CLIENT
Kerrie & James
Alexander

PROJECT ADDRESS 48 ABINGDON STREET, NORTH BALGOWLAH 2093 DA03

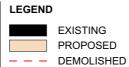**DATE**Friday, 13 March 2020

**DRAWING NAME**EXISTING GROUND FLOOR PLAN






EXISTING FIRST FLOOR PLAN

1:100

NOTE: ALL DEMOLISHED ELEMENTS TO ENG. SPECIFICATIONS AND AS. 2601 - 2001

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CLIENT	
Kerrie & James Alexander	


PROJECT ADDRESS
48 ABINGDON STREET,
NORTH BALGOWLAH
2093

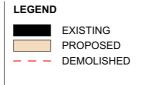DA04


**104** EXISTING

**DATE**Friday, 13 March 2020

DRAWING NAME
EXISTING FIRST FLOOR PLAN

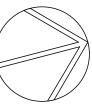


LOT 349 DP 12316

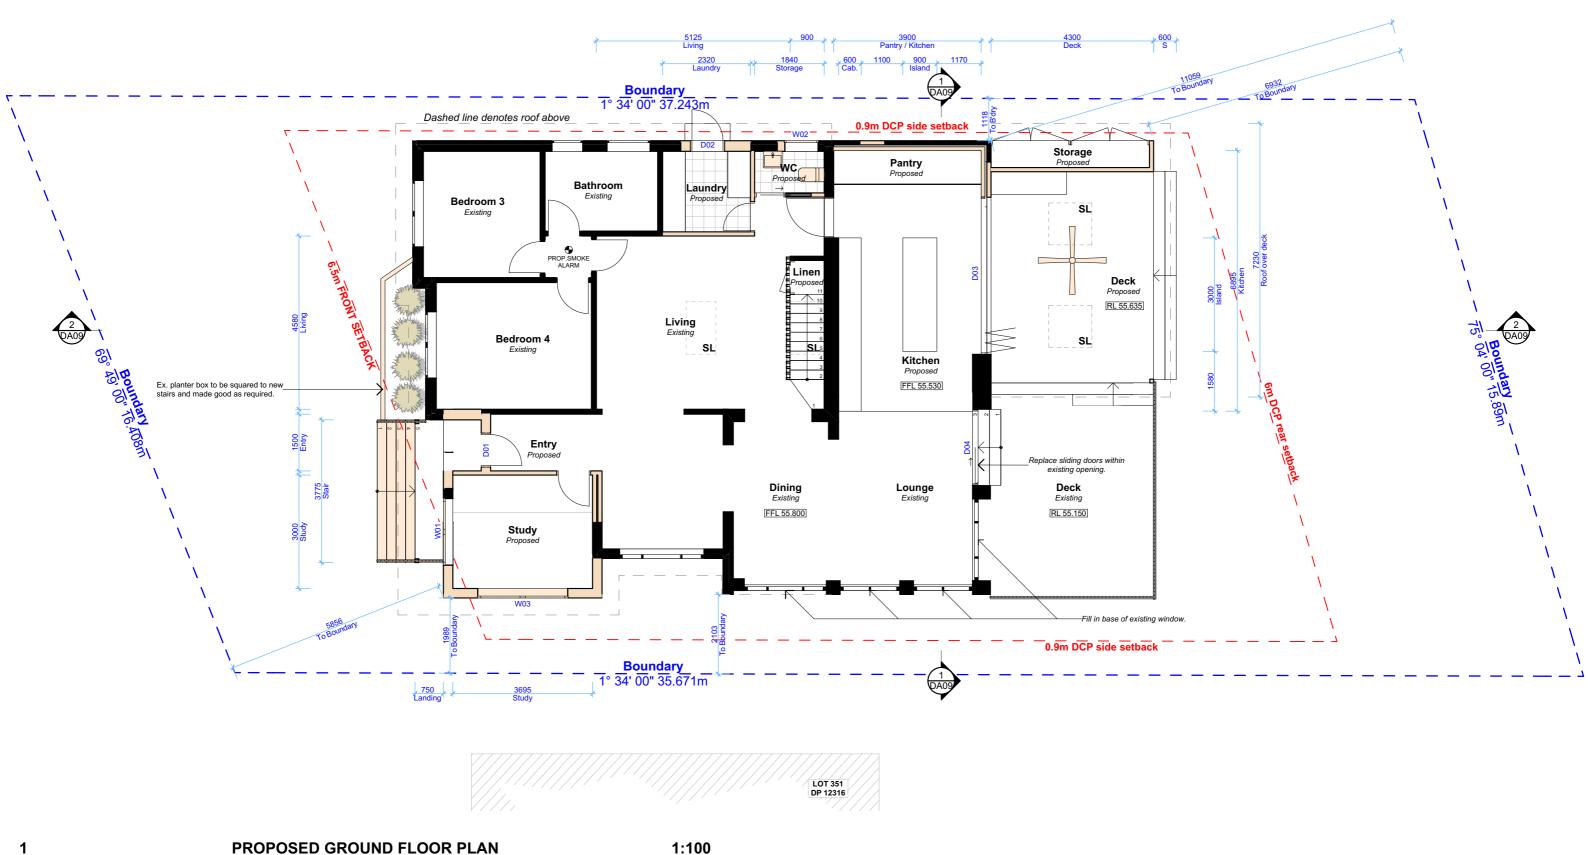

NOTE: SMOKE ALARMS TO COMPLY WITH PART 3.7.2 OF NCC

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DRAWING NO
DA05

CLIENT

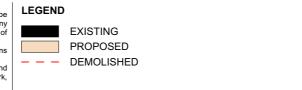Alexander

Kerrie & James

PROJECT ADDRESS


NORTH BALGOWLAH 2093


48 ABINGDON STREET,

DA05	PROPOSED GROUND FLOOR PLAN
DATE	

Friday, 13 March 2020 SCALE 1:100 @A3

DRAWING NAME

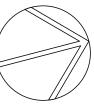

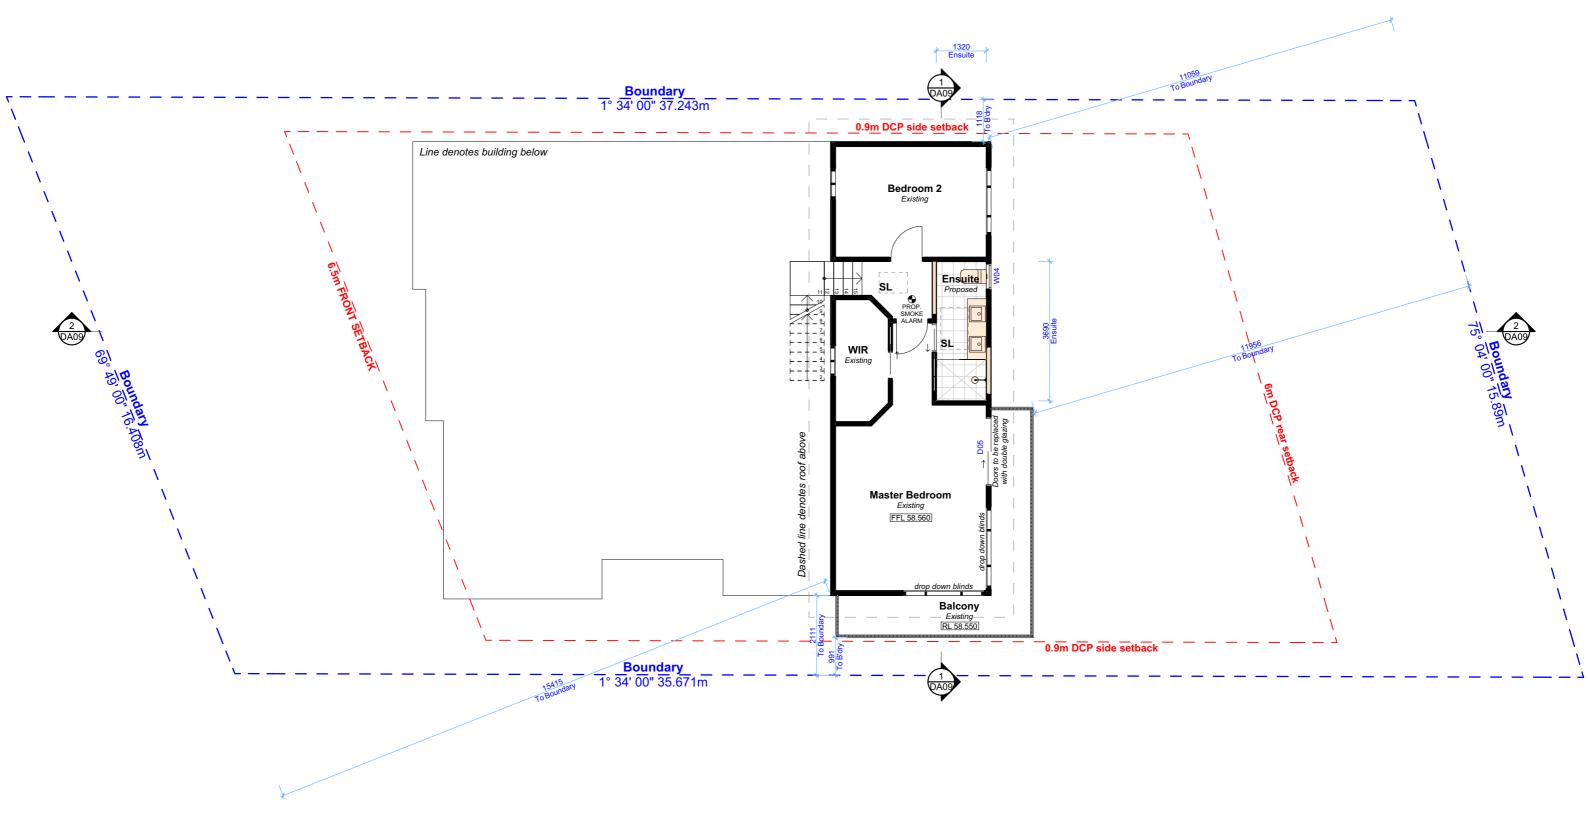


PROPOSED FIRST FLOOR PLAN

1:100

NOTE: SMOKE ALARMS TO COMPLY WITH PART 3.7.2 OF NCC

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CLIENT Kerrie & James Alexander


PROJECT ADDRESS 48 ABINGDON STREET, NORTH BALGOWLAH 2093

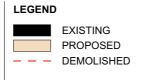
DRAWING NO. **DA06** 


PROPOSED FIRST FLOOR PLAN DATE


Friday, 13 March 2020 SCALE 1:100 @A3

DRAWING NAME

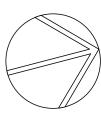


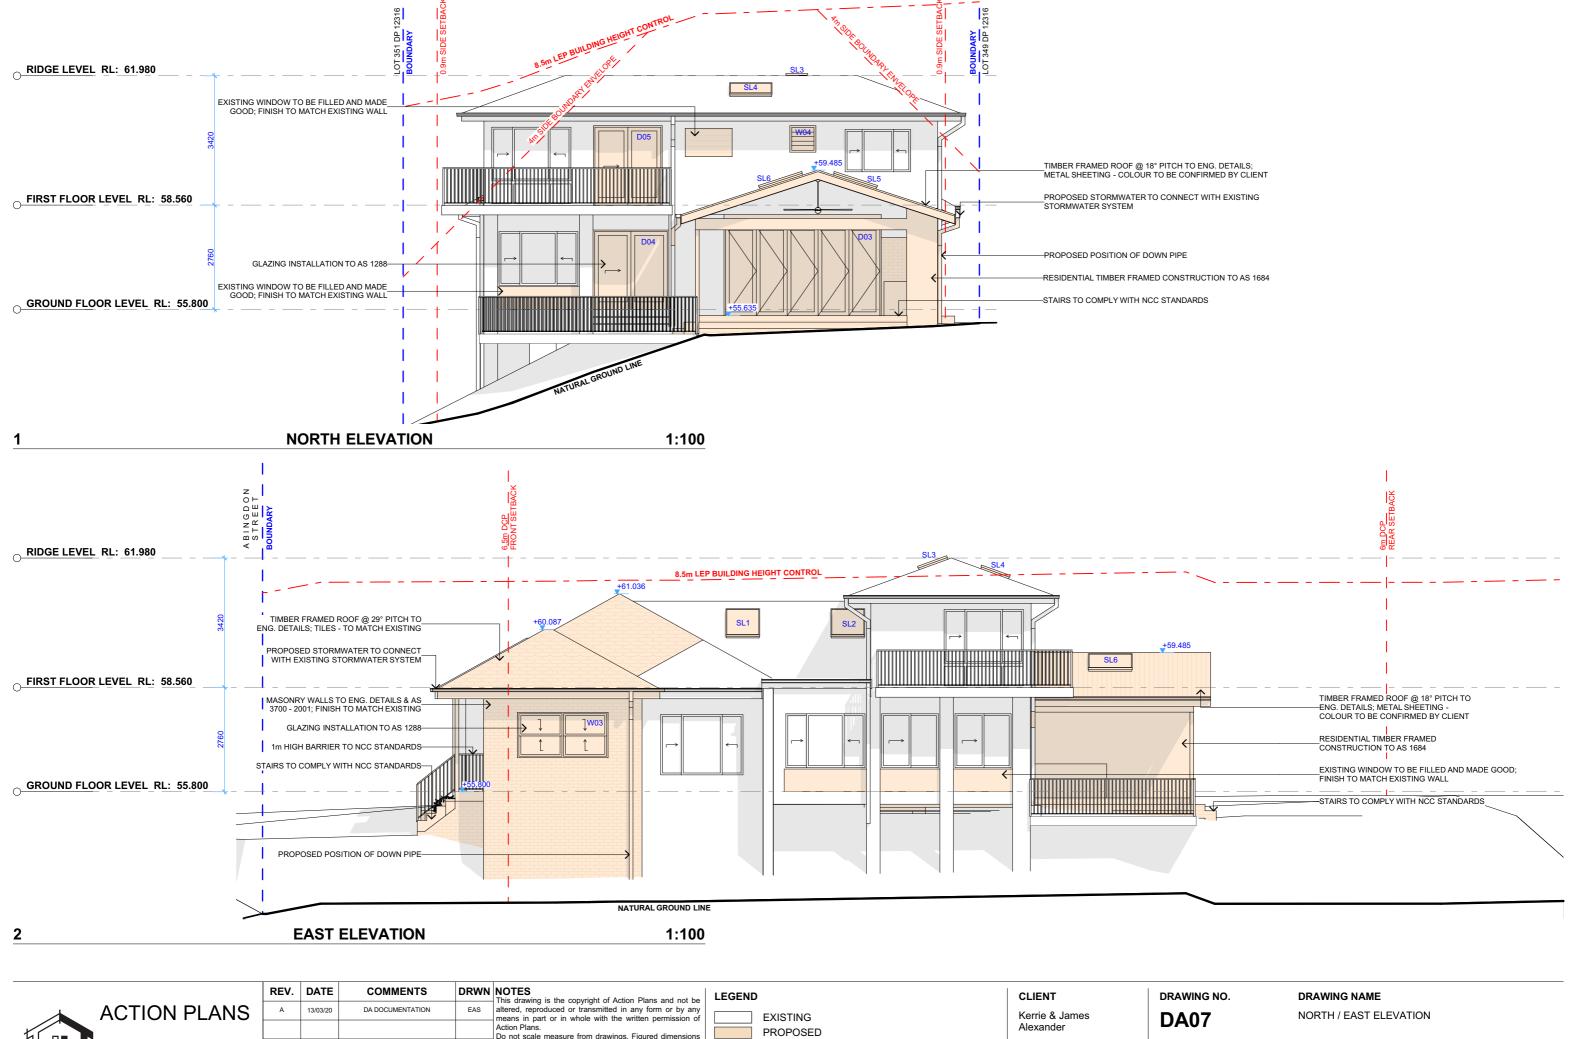


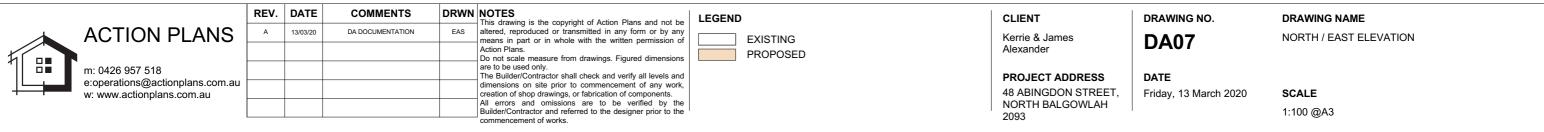

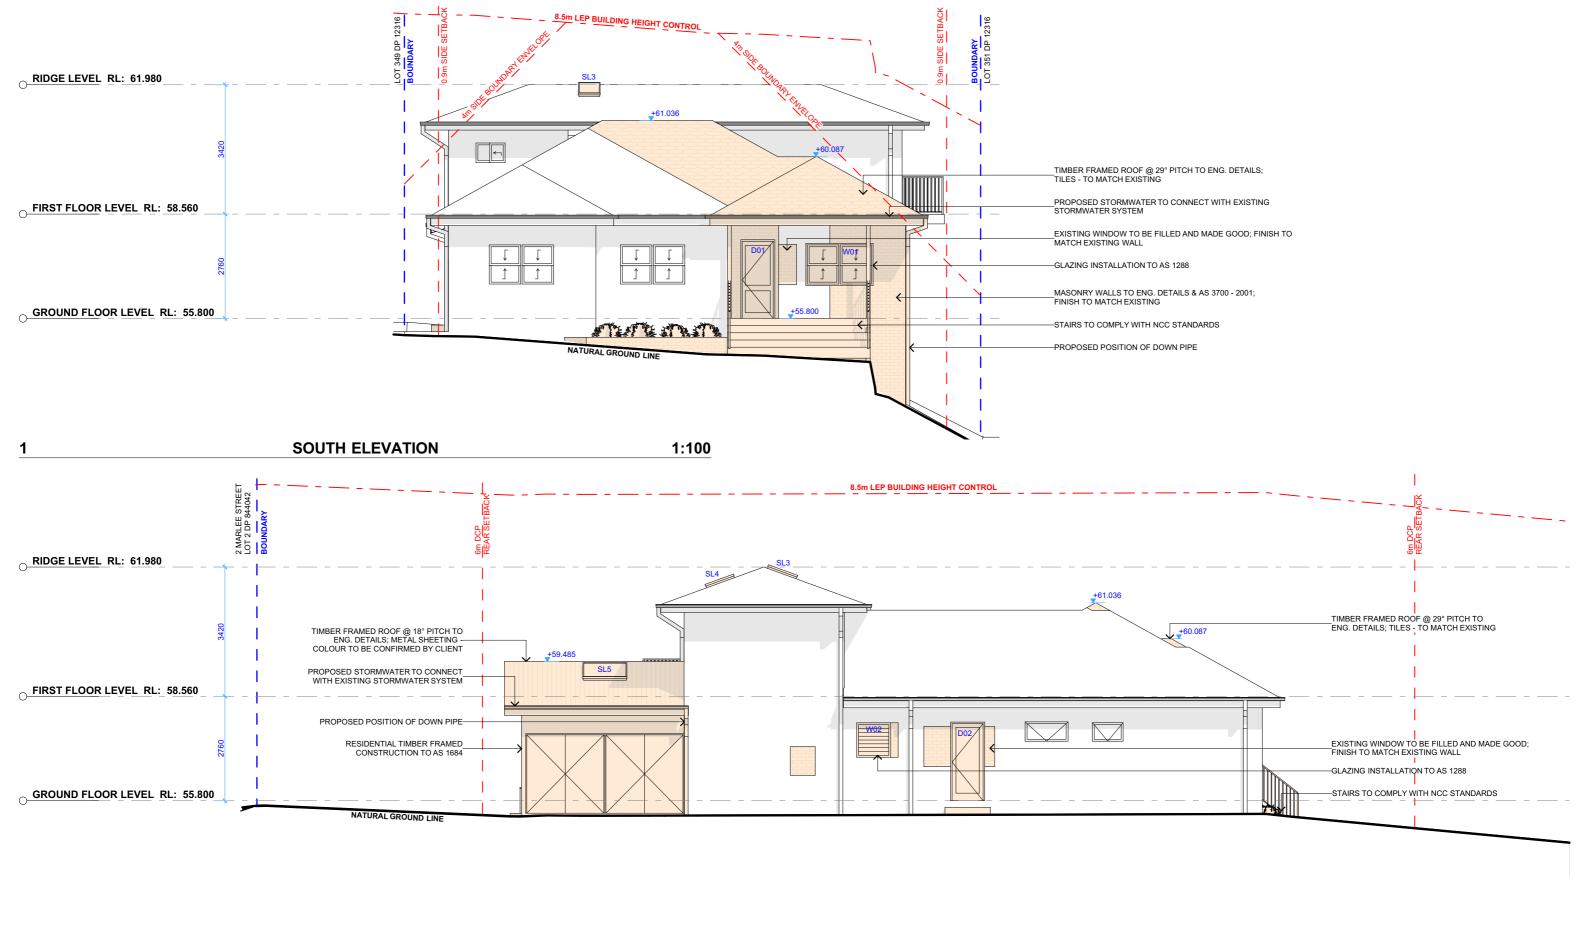



2 WEST ELEVATION 1:100

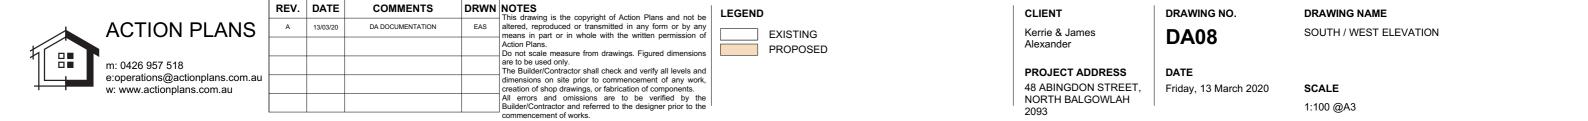

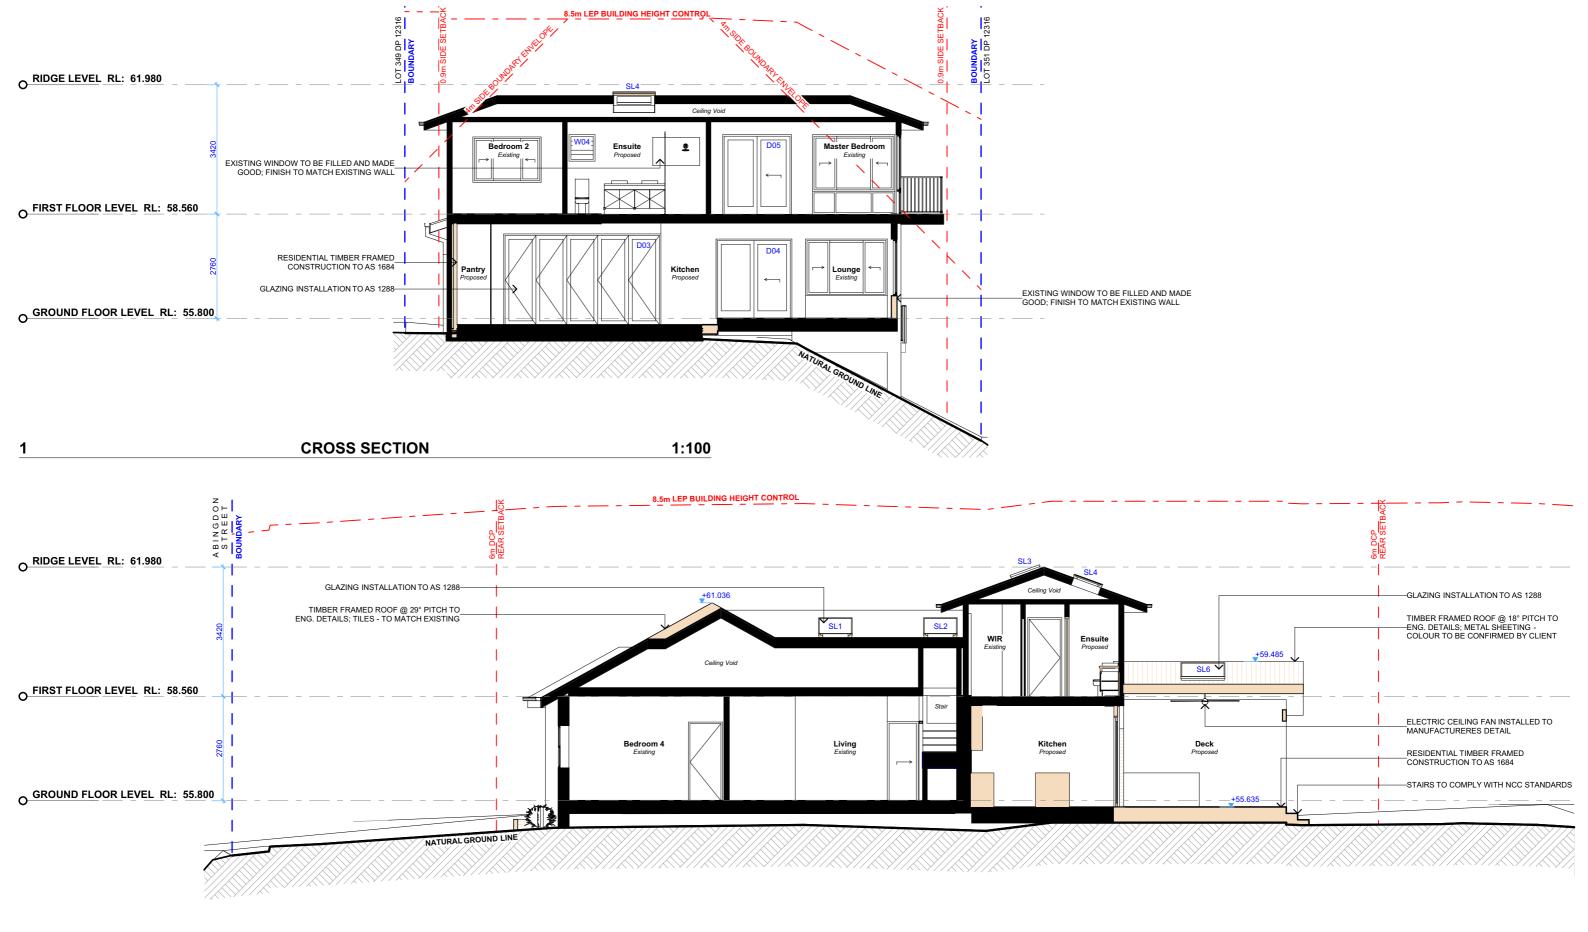


2 LONG SECTION 1:100

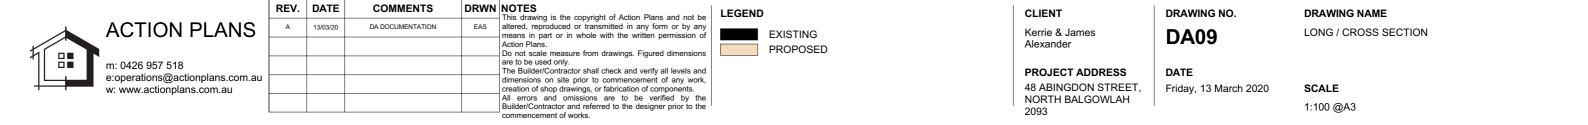

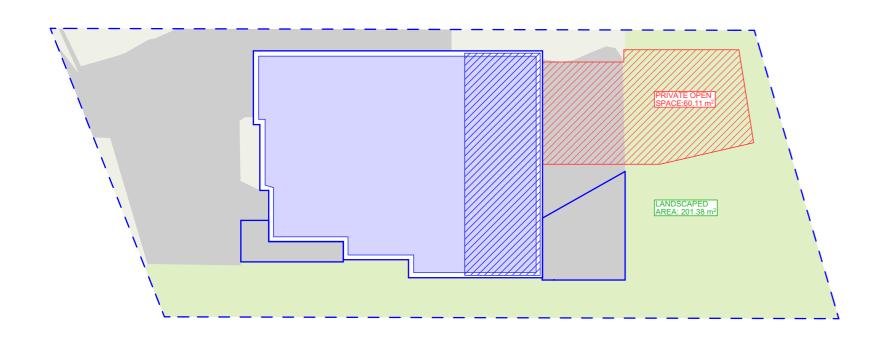

1 EXISTING AREA CALCULATIONS 1:200

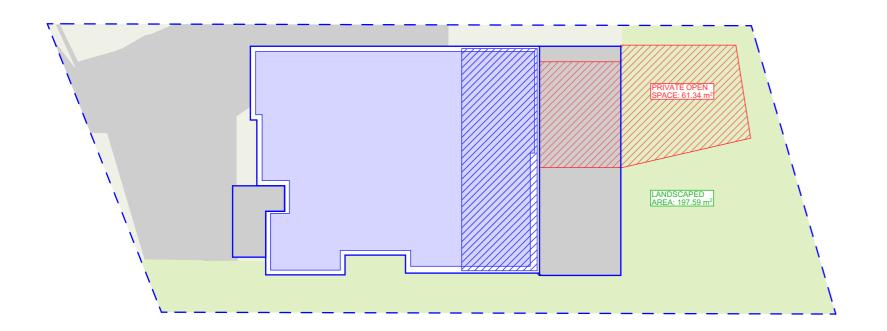

PROPOSED AREA CALCULATIONS

ACTION PLANS

A 13/03/20 DA DOCUMENTATION

EAS

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LEGEND

1:200

### **AREA CALCULATIONS**

SITE AREA: 555.6m<sup>2</sup> EXISTING PROPOSED

LANDSCAPED AREA

REQUIRED: 40% (222.24m<sup>2</sup>)

36.2% (201.38m<sup>2</sup>)

35.5% (197.59m<sup>2</sup>)



PERVIOUS AREA REQUIRED: N/A

PRIVATE OPEN SPACE REQUIRED: 60m<sup>2</sup>


60.

60.11m<sup>2</sup>

61.34m<sup>2</sup>

HA RE

HARD SURFACE AREA REQUIRED: N/A

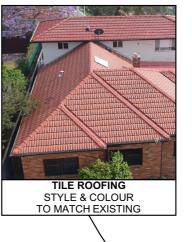





MATCH EXISTING TO MATCH EXISTING

TO MATCH EXISTING

SAMPLE BOARD

CLIENT

1 1

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48 ABINGDON STREET, NORTH BALGOWLAH 2093 DRAWING NO.


**DA10** 


DATE

Friday, 13 March 2020

DRAWING NAME


AREA CALCULATIONS / SAMPLE BOARD

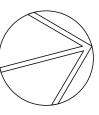

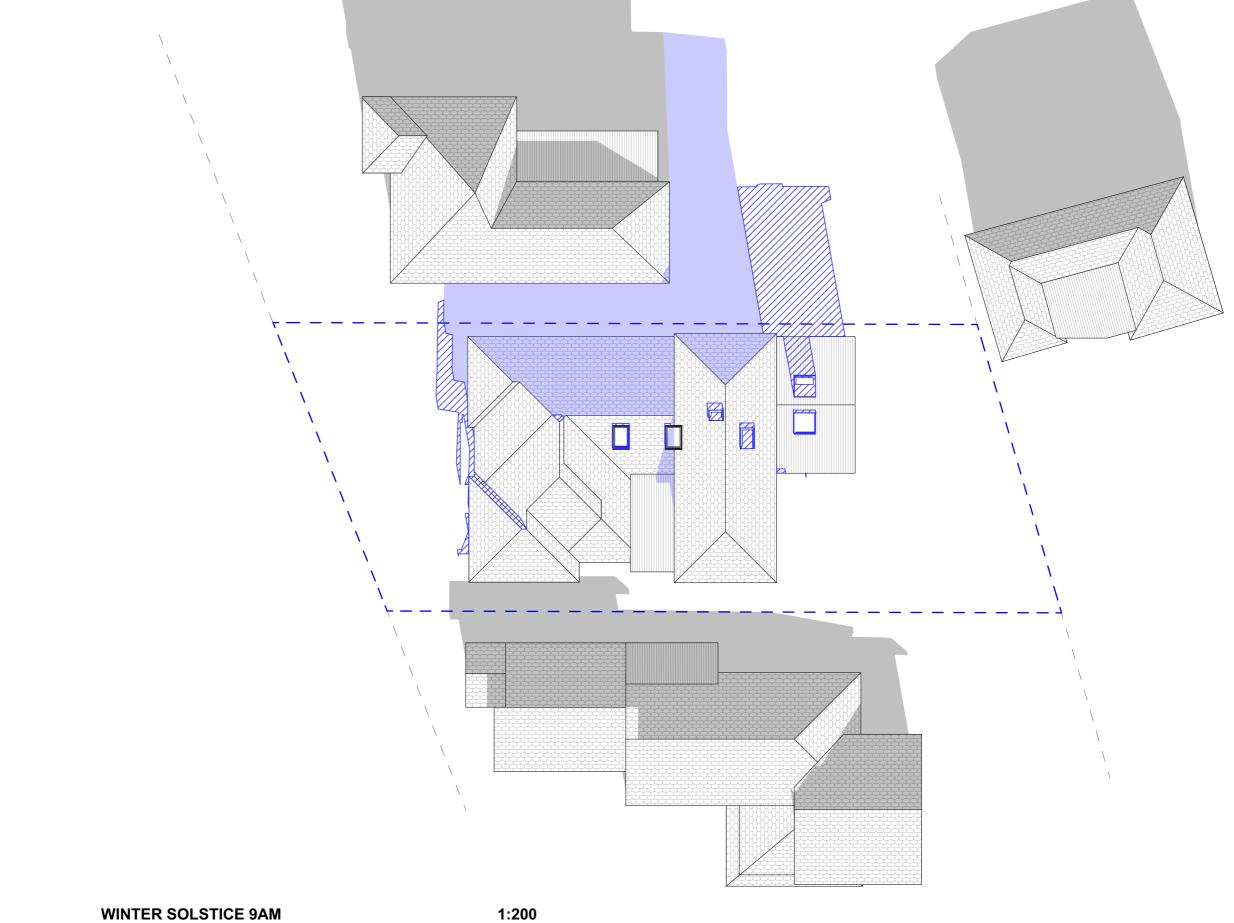



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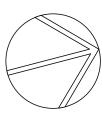
CLIENT

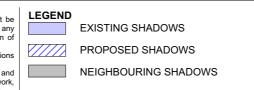
Kerrie & James Alexander

PROJECT ADDRESS 48 ABINGDON STREET, NORTH BALGOWLAH 2093 DRAWING NO.

**DA11** 

DATE Friday, 13 March 2020 DRAWING NAME WINTER SOLSTICE 9 AM




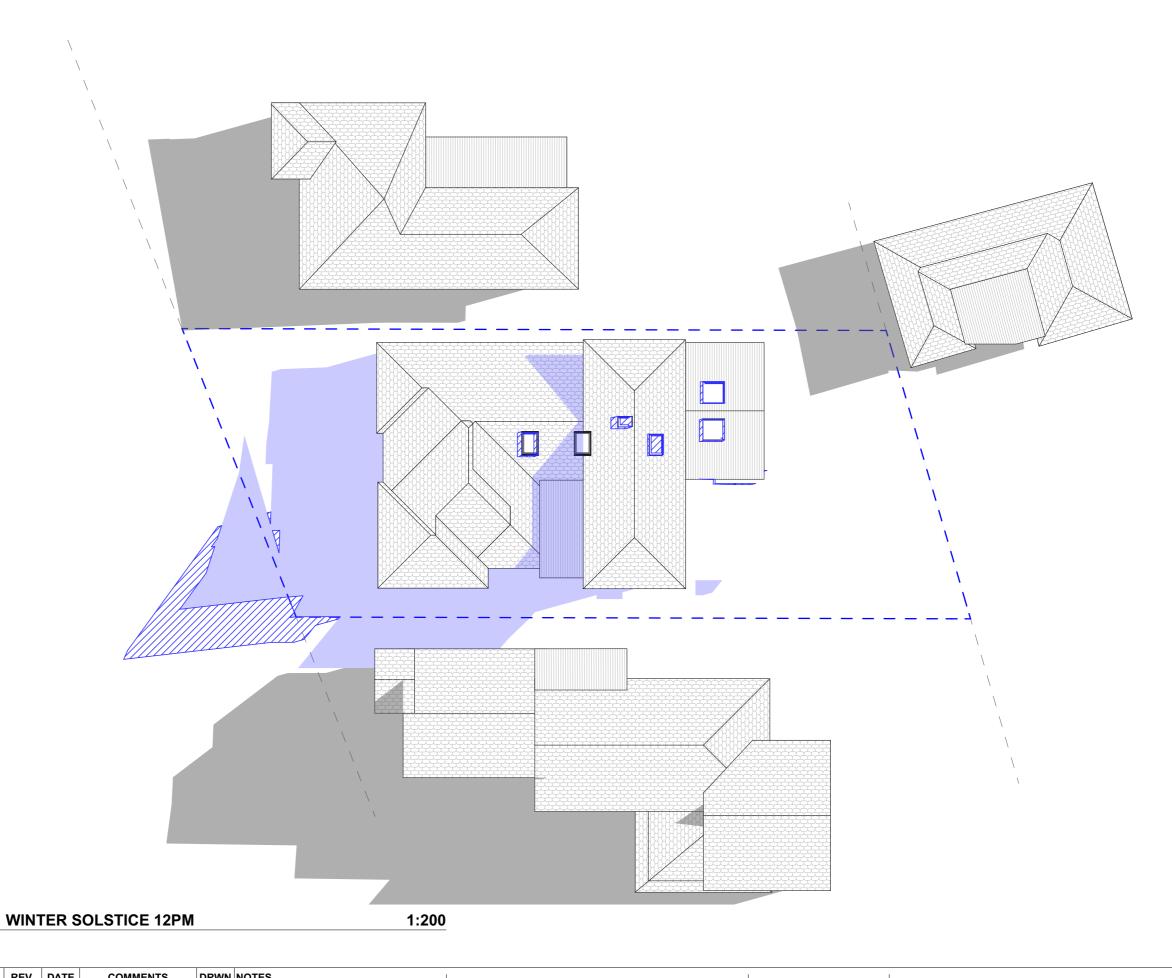



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PROJECT ADDRESS 48 ABINGDON STREET, NORTH BALGOWLAH 2093 DRAWING NO.


**DA12** 

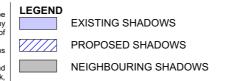
DATE

DRAWING NAME WINTER SOLSTICE 12 PM

1:200 @A3


Friday, 13 March 2020 SCALE

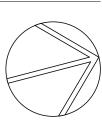

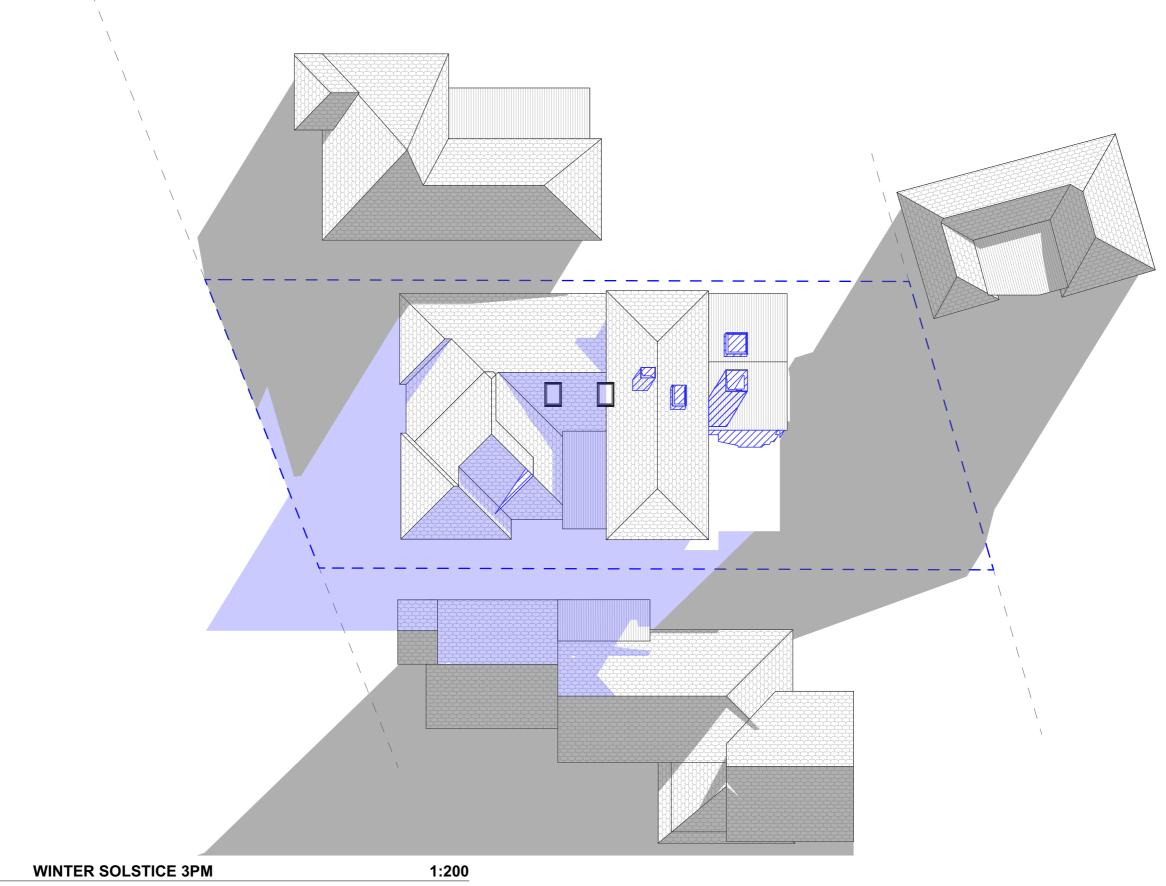



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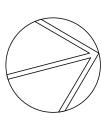
PROJECT ADDRESS 48 ABINGDON STREET, NORTH BALGOWLAH 2093 DRAWING NO.

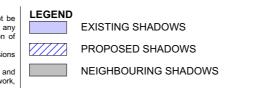**DA13** 

DATE Friday, 13 March 2020

DRAWING NAME

WINTER SOLSTICE 3 PM





Building Sustainability Index www.basix.nsw.gov.au

### Alterations and Additions

Certificate number: A370951

This certificate confirms that the proposed development will meet the NSW government's requirements for sustainability, if it is built in accordance with the commitments set out below. Terms used in this certificate, or in the commitments, have the meaning given by the document entitled "BASIX Alterations and Additions Definitions" dated 06/10/2017 published by the Department. This document is available at www.basix.nsw.gov.au

Secretary
Date of issue: Monday, 24, February 2020
To be valid, this certificate must be lodged within 3 months of the date of issue.

NISW In	anning, dustry & nvironment
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Project address	
Project name	48 Abingdon Street
Street address	48 Abingdon Street North Balgowlah 2093
Local Government Area	Northern Beaches Council
Plan type and number	Deposited Plan 12316
Lot number	350
Section number	
Project type	
Dwelling type	Separate dwelling house

Certificate Prepared by (please complete before submitting to Council or PCA)
Name / Company Name: Action Plans
ABN (if applicable): 17118297587

Fixtures and systems	Show on DA Plans	Show on CC/CDC Plans & specs	Certifier Check
Lighting			
The applicant must ensure a minimum of 40% of new or altered light fixtures are fitted with fluorescent, compact fluorescent, or light-emitting-diode (LED) lamps.		~	<b>✓</b>
Fixtures			
The applicant must ensure new or altered showerheads have a flow rate no greater than 9 litres per minute or a 3 star water rating.		✓	✓
The applicant must ensure new or altered toilets have a flow rate no greater than 4 litres per average flush or a minimum 3 star water rating.		~	<b>✓</b>
The applicant must ensure new or altered taps have a flow rate no greater than 9 litres per minute or minimum 3 star water rating.		✓	

Construction			Show on DA Plans	Show on CC/CDC Plans & specs	Certifier Check
nsulation requirements					
	d construction (floor(s), walls, and ceilings/roofs) it in is not required where the area of new construction is not required where the area of new construction is not required where insulation already exists.		<b>✓</b>	~	<b>√</b>
Construction	Additional insulation required (R-value)	Other specifications			
suspended floor with open subfloor: framed (R0.7).	R0.8 (down) (or R1.50 including construction)				
suspended floor with enclosed subfloor: framed (R0.7).	R0.60 (down) (or R1.30 including construction)				
external wall: brick veneer	R1.16 (or R1.70 including construction)				
flat ceiling, pitched roof	ceiling: R3.00 (up), roof: foil/sarking	medium (solar absorptance 0.475 - 0.70)			

#### Legend

In these commitments, "applicant" means the person carrying out the development.

Commitments identified with a "\"" in the "Show on DA plans" column must be shown on the plans accompanying the development application for the proposed development (if a development application is to be lodged for the proposed development).

Commitments identified with a "\"" in the "Show on CC/CDC plans & specs" column must be shown in the plans and specifications accompanying the application for a construction certificate / complying development certificate for the proposed development.

Commitments identified with a "v" in the "Certifier check" column must be certified by a certifying authority as having been fulfilled, before a final occupation certificate for the development may be issued.

Glazing re	equirements							Show on DA Plans	Show on CC/CDC Plans & specs	Certifier Check
Windows a	and glazed d	oors							.,	
The applicant must install the windows, glazed doors and shading devices, in accordance with the specifications listed in the table below. Relevant overshadowing specifications must be satisfied for each window and glazed door.							<b>✓</b>	<b>✓</b>	<b>✓</b>	
The following	g requirements	s must also	be satisfi	ed in relation	to each window and gl	azed door:			<b>✓</b>	<b>~</b>
have a U-va	lue and a Sola	r Heat Gair	n Coefficie	ent (SHGC) n		d in the table	d glass may either match the description, or, e below. Total system U-values and SHGCs		~	<b>✓</b>
have a U-va must be cald	llue and a Sola culated in acco	r Heat Gair rdance with	n Coefficie n National	nt (SHGC) n Fenestration	o greater than that liste	d in the table	ar glazing, or toned/air gap/clear glazing must be below. Total system U-values and SHGCs The description is provided for information		<b>✓</b>	<b>✓</b>
					each eave, pergola, ve		cony or awning must be no more than 500 mm	~	<b>✓</b>	✓
Pergolas wit	th polycarbona	te roof or s	imilar tran	slucent mate	rial must have a shadin	ng coefficient	of less than 0.35.		<b>✓</b>	<b>✓</b>
					window or glazed doo ns must not be more th		th they are situated, unless the pergola also		~	<b>✓</b>
Windows	and glazed	doors g	lazing r	equiremen	its					
Window / do no.	oor Orientation	Area of glass inc. frame (m2)	Oversha Height (m)	Distance (m)	Shading device		Frame and glass type			
W1	S	1.984	0	0	eave/verandah/pergol >=900 mm	la/balcony	standard aluminium, single clear, (or U-value: 7.63, SHGC: 0.75)			
W2	W	0.819	0	0	eave/verandah/pergol >=600 mm	la/balcony	standard aluminium, single pyrolytic low-e, (U-value: 5.7, SHGC: 0.47)			
W3	E	2.88	0	0	eave/verandah/pergol >=600 mm	la/balcony	standard aluminium, single clear, (or U-value: 7.63, SHGC: 0.75)			
W4	N	0.482	0	0	eave/verandah/pergol >=750 mm	la/balcony	standard aluminium, single clear, (or U-value: 7.63, SHGC: 0.75)			
D1	S	1.672	0	0	eave/verandah/pergol >=900 mm	la/balcony	standard aluminium, single clear, (or U-value: 7.63, SHGC: 0.75)			
D2	W	1.672	0	0	awning (fixed) >=900	mm	standard aluminium, single clear, (or U-value: 7.63, SHGC: 0.75)			
D3	N	9.984	0	0	eave/verandah/pergol >=900 mm	la/balcony	standard aluminium, single clear, (or U-value: 7.63, SHGC: 0.75)			
D4	N	4.21	0	0	eave/verandah/pergol >=900 mm	la/balcony	standard aluminium, single clear, (or U-value: 7.63, SHGC: 0.75)			
D5	N	3.822	0	0	eave/verandah/pergol >=750 mm	la/balcony	standard aluminium, single clear, (or U-value: 7.63, SHGC: 0.75)			
Skylights										
The applicar	nt must install t	he skylight	s in accor	dance with th	e specifications listed i	n the table b	elow.	<b>~</b>	<b>✓</b>	~
					to each skylight:		(0100)		<b>~</b>	<b>~</b>
the table bel		atch the de	escription,	or, have a U	-value and a Solar Hea	it Gain Coeff	icient (SHGC) no greater than that listed in		~	~
	External awnings and louvres must fully shade the skylight above which they are situated when fully drawn or closed.						fully drawn or closed.	_	<b>~</b>	<b>~</b>
	Skylights glazing requirements  Skylight number   Area of glazing   Shading device   Frame and glass type						glass type			
S1		me (m2)		adjustable av	Frame and glass type vning or blind aluminium, moulded bl		moulded plastic single clear, (or U-value:			
S2	1.218				6.21, SHGC: 0.8		c: 0.808) moulded plastic single clear, (or U-value:			
S3	0.44		no shadi			6.21, SHG0				
S4	0.858				wning or blind	6.21, SHG0				
						6.21, SHG(				

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				The Builder/Contractor shall check and verify all levels and dimensions on site prior to commencement of any work, creation of sharings, or fabrication of components.  All errors and omissions are to be verified by the Builder/Contractor and referred to the designer prior to the commencement of works.  All window & door dimensions, orientation, glazing materials, opening types, frame types are to be confirmed by a suitably qualified	p
			U value takes precedence over glazing type/colour in all cases.		
				all new glazing must meet the BASIX specified frame and glass type, <u>OR</u> meet the certified U value and SHGC value.	

CLIENT

Kerrie & James Alexander

PROJECT ADDRESS 48 ABINGDON STREET, NORTH BALGOWLAH 2093 DRAWING NO.

DRAWING NAME

DA14

BASIX COMMITMENTS

**DATE**Friday, 13 March 2020