

Zouk architects

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Wei Chen (Shirley)

Project Title
Proposed 2 Storey Residential Dwelling


Address
Forestville_7CullenSt
DP 758421

LOT 6

SITE PLAN



Drawn	Checked	Approved
AK	CH	SL
Filename	Sheet Size	Scale
-	A3	As indicated
Project Number 22-106	Drawing Number A100	Sheet Number

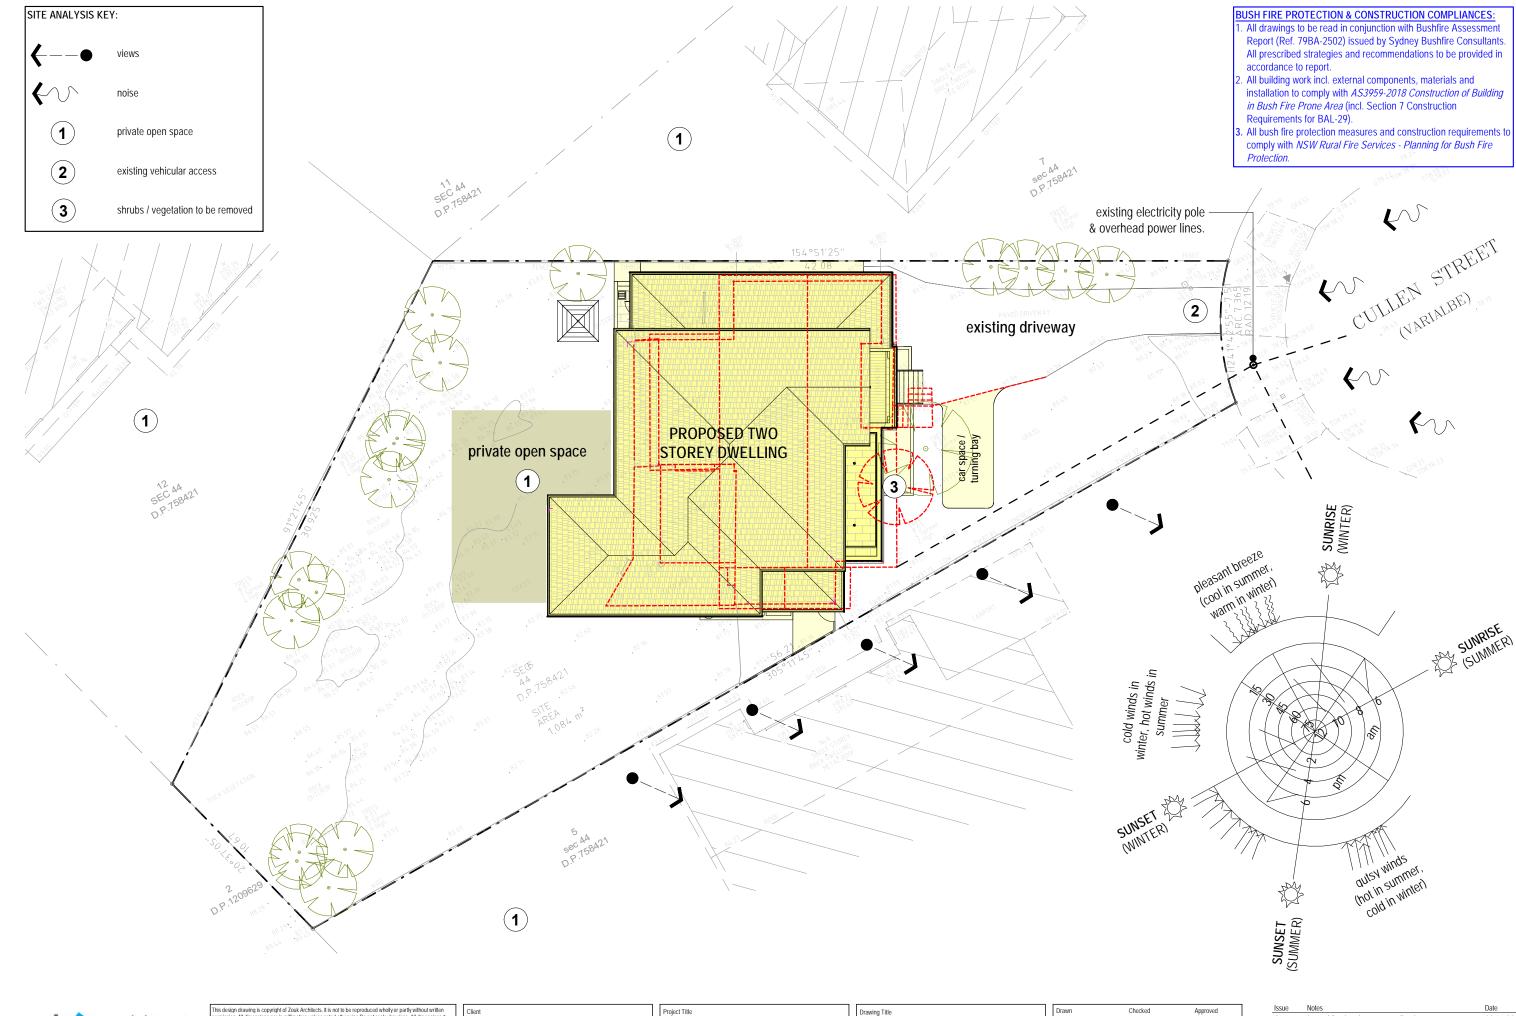

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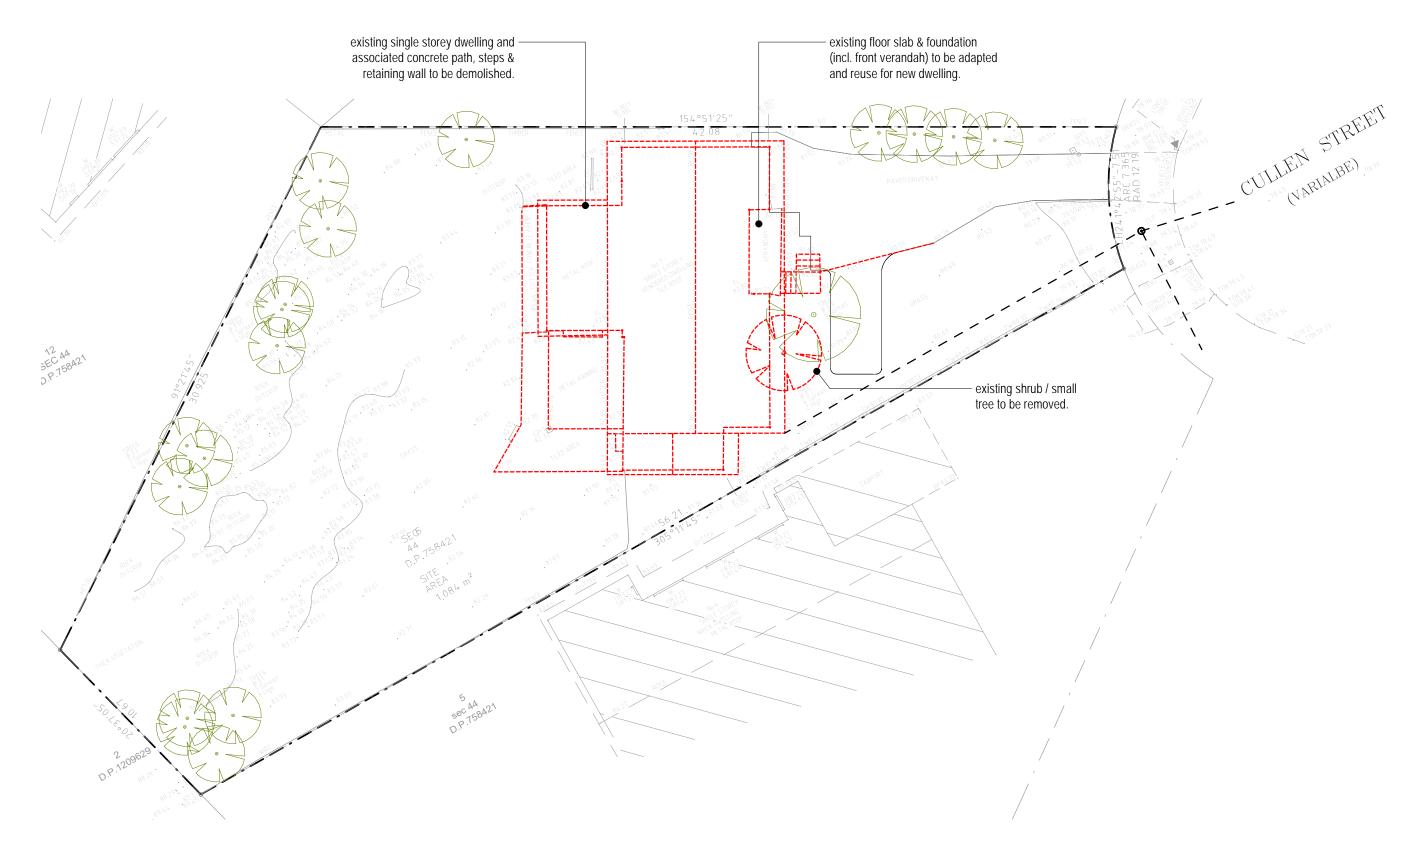
Wei Chen (Shirley)

Project Title
Proposed 2 Storey Residential Dwelling

Address
Forestville_7CullenSt
DP 758421

LOT 6

SITE ANALYSIS PLAN





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Address
Forestville_7CullenSt
DP 758421

LOT 6

Drawing Title

DEMOLITION PLAN



Drawn Author	Checked Checker	Approved Approver
Filename	Sheet Size A3	Scale 1:200
Project Number 22-106	Drawing Number A102	Sheet Number

Issue Notes



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Wei Chen (Shirley)


Project Title
Proposed 2 Storey Residential Dwelling

Address
Forestville_7CullenSt
DP 758421 LOT 6

Drawing Title

EXCAVATION PLAN


Drawn Author	Checked Checker	Approved Approver
Filename -	Sheet Size A3	Scale 1:200
Project Number 22-106	Drawing Number A103	Sheet Number

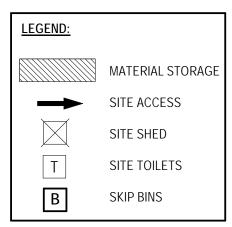

- measures as necessary and to the satisfaction of council prior to the commencement of and during construction. No disturbance to the site material shall be removed from the site without council's approval. All accordance with standards outlined in NSW department of housing's "managing urban stormwater - soils and constructions".
- drainage lines. This topsoil is to be respired later on areas to be revegetated and stabilised only, (i.e. All footpaths, batters, site If they are to remain for longer than one month stockpiles shall be protected from erosion by covering them with a mulch and hydro stockpile to retard silt laden runoff.
- by the superintendent or council.
- structures immediately after backfilling or formation.
- mix as soon as practicable after completion of earthworks and
- 7. Vehicular traffic shall be controlled during construction confining access where possible to nominated stabilised access points.
- 3. When any devices are to be handed over to council they shall be in
- (but not saturating) disturbed area
- catchment is revegetated or paved.
- 11. Revegetate all trenches immediately upon completion of backfilling.
- (i) downpipes connected
- (ii) pits constructed and protected with silt barrier





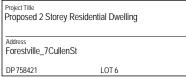


PROPOSED TWO

STOREY DWELLING




green waste bin

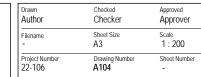

path to kerb colletion area (ongoing-waste)

existing driveway

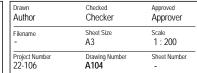

Construction Waste Sorting Area:

Demolition and construction residues from operation such as

contained on the site and treated using sedimentation settling

tanks or flocculation and disposed of in accordance with Council's

• stored well clear of any poorly drained or flood prone areas, stream banks and channel or stormwater drainage area in a designated

• provided with containment bunds, constructed around the storage


masonry-cutting, washing tools and concreting must be:


Waste Management Plan at paragraph 2.1.12


area and under cover where possible, and

areas which allow salvaging of splite materials.



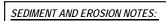

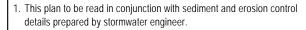

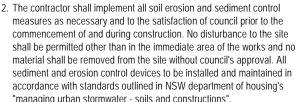

3. Topsoil shall be stripped and stockpiled outside hazard areas such as regarding areas, basins and catch drains). Topsoil shall not be respired on any other areas unless specifically instructed by the superintendent. seeding and, if necessary, by locating banks or drains downstream of a

4. The contractor shall regularly maintain all sediment and erosion control devices and remove accumulated silt from such devices such that more than 60% of their capacity is lost. All the silt is to be placed outside the limit of works. The period for maintaining these devices shall be at least until all disturbed areas are revegetated and further as may be directed

5. Lay turf strip (min 300mm wide) on 100mm topsoil. With 1.0m long returns every 6.0m behind all kerb at the top of all batters and around

b. The contractor shall grass seed all disturbed areas with an approved

clean and stable condition.

9. The contractor shall implement dust control by regular wetting down

10. Provide and maintain silt traps around all surface inlet pits until

12. All drainage pipe inlets to be capped until:

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nitects, in the event of encountering any discrepances on these drawings, sepecinicalns of rutimer ructions, the contrador shall contact the architect or appropriate authority before proceeding with any work. architectural documentations are to be read in conjunction with architectural specifications, all consultant's unmentation, details a specification. All works to comply with the BCA relevant Australian Standards. Statuto guidations and Local Authority requirements. Measurements for the fabrication of secondary components sur-windows, doors, internal frames, structural steelwork and the like, are not to be taken from these documents sesurements must be battern on site in sail the work as constructed.

recyclable & nonrecyclable waste bin

> CONSTRUCTION & WASTE MANAGEMENT PLAN

3. Any discrepancies between landscape/architectural or other project consultant's drawings shall be reported to the landscape designer prior to any works being carried

4. All works are to be carried out in accordance with drawing notation and/or written specifications where applicable.

5. Works and supply of materials not covered by drawing notation or written specification are to be carried out in accordance with AS Codes, LCA guidelines and the By-Laws and Ordinances of the relevant Building Authority and/or manufacturer's recommendations as applicable.

6. All dimensions and locations of works are to be checked on site and confirmed by the landscape/building site supervisor prior to the commencement of any works.

7. Dimensions shall not be obtained by scaling from structural drawings. Dimensions are indicated in millimeters unless otherwise specified.

8. The contractor shall at all times implement adequate erosion and sediment control measures where applicable.

9. The position of services indicated on drawings (when applicable), are approximate and must be confirmed on site prior to the commencement of any site works.

1. All proposed planting areas are to be deep ripped to a depth of 300mm and clay soils are to be treated with a clay breaker. 75mm depth of ANL Organic Garden Mix to be imported and combined with 25mm depth Greenlife compost or approced

NEW PLANTING

1. All plants shall be true to type and size, of healthy growth, disease free nursery stock, and not displaying any restricted growth or damage. Plants shall have been hardened off and suitable for planting in the climatic conditions prevailing at the site. Trees shall be of uniform appearance and have a single leading trunk and proportionate and balanced crown.

2. The Contractor shall be responsible for the health of plants from time of delivery, and no consideration will be given to any claim arising from the Contractors neglect or failure to observe any defects in the plants at time of delivery.

3. Remove plant from container without disturbing the root ball and place centrally and plumb in the hole with the top of the root-ball level with the surrounding surface level. Backfill root-ball with an Organic garden soil-mix, lightly tamp and water thoroughly to eliminate air pockets. Refer to Tree Planting Detail when applicable. Ensure soil-mix is not placed over the top of the root-ball and that the plant stem remains the same height above the ground as it was in the container. Soil-mix for backfilling of plants shall conform to AS4419-1998.

1. On completion of planting, all areas are to be mulched using Green Life compost to a depth of 75m. A water catchment dish is to be provided around the base of each

1. All newly planted areas are to be fertilized with an organic life, slow release fertilizer (Osmocote 8-9 month / Agriform (R) 21g) which is to be adequately watered in.

1. Turf is to be laid on 75mm soil compost mix/Turf underlay over 200mm deep rotary hoed prepared and leveled area. Turf shall be of even thickness, free from weed and other foreign matter and laid within 36 hours of cutting. Turf shall be laid in a stretcher bond pattern, tightly jointed and finished flush with adjacent edging/paving surfaces after tamping down. Water immediately after laying, ensuring topsoil is watered to full

2. Contractor is to provide adequate drainage facility under lawn where applicable. Lawn species: Buffalo 'Sir Walter"

IRRIGATION

1. The contractor is to liaise with the client as to the type of irrigation system required to all lawn and garden areas. The system is to comply with the latest Council, Water Board and Australian standards applicable at the time of installation.

DRAINAGE

subsoil drainage

Where applicable, a flexible 90mm subsoil, socked, drainage coil is to be installed to all planting areas defined by retaining walls, interfaces between planting/lawn areas and paving, kerb lines, footpath edges etc. on natural ground. The subsoil drainage lines are to be installed and covered with free draining gravel at the base of retaining walls and planting areas, as above, and sufficiently buried to ensure they are covered with 100mm free draining gravel and 150mm topsoil. The gravel is to be covered with 3-4 oz non-woven filter fabric.


surface drainage

The contractor is to ensure adequate drainage is provided to all newly paved/hardsurface areas, linking either to existing drainage sump pits or to new pits constructed by the contractor. The subsoil and surface drainage system is to be linked to the site's storm water system.

MAINTENANCE

10/11/2022 3:42:13 PM

The landscape contractor shall maintain the landscape area for a period of 12 weeks from the date of practical completion. Works shall include weeding, pruning, checking watering systems, fertilizing, removal of rubbish and the control of pests and disease to the plants as they arise. During the maintenance period, any plants deemed to have failed shall be replaced progressively and not all at once upon the completion of the maintenance period.

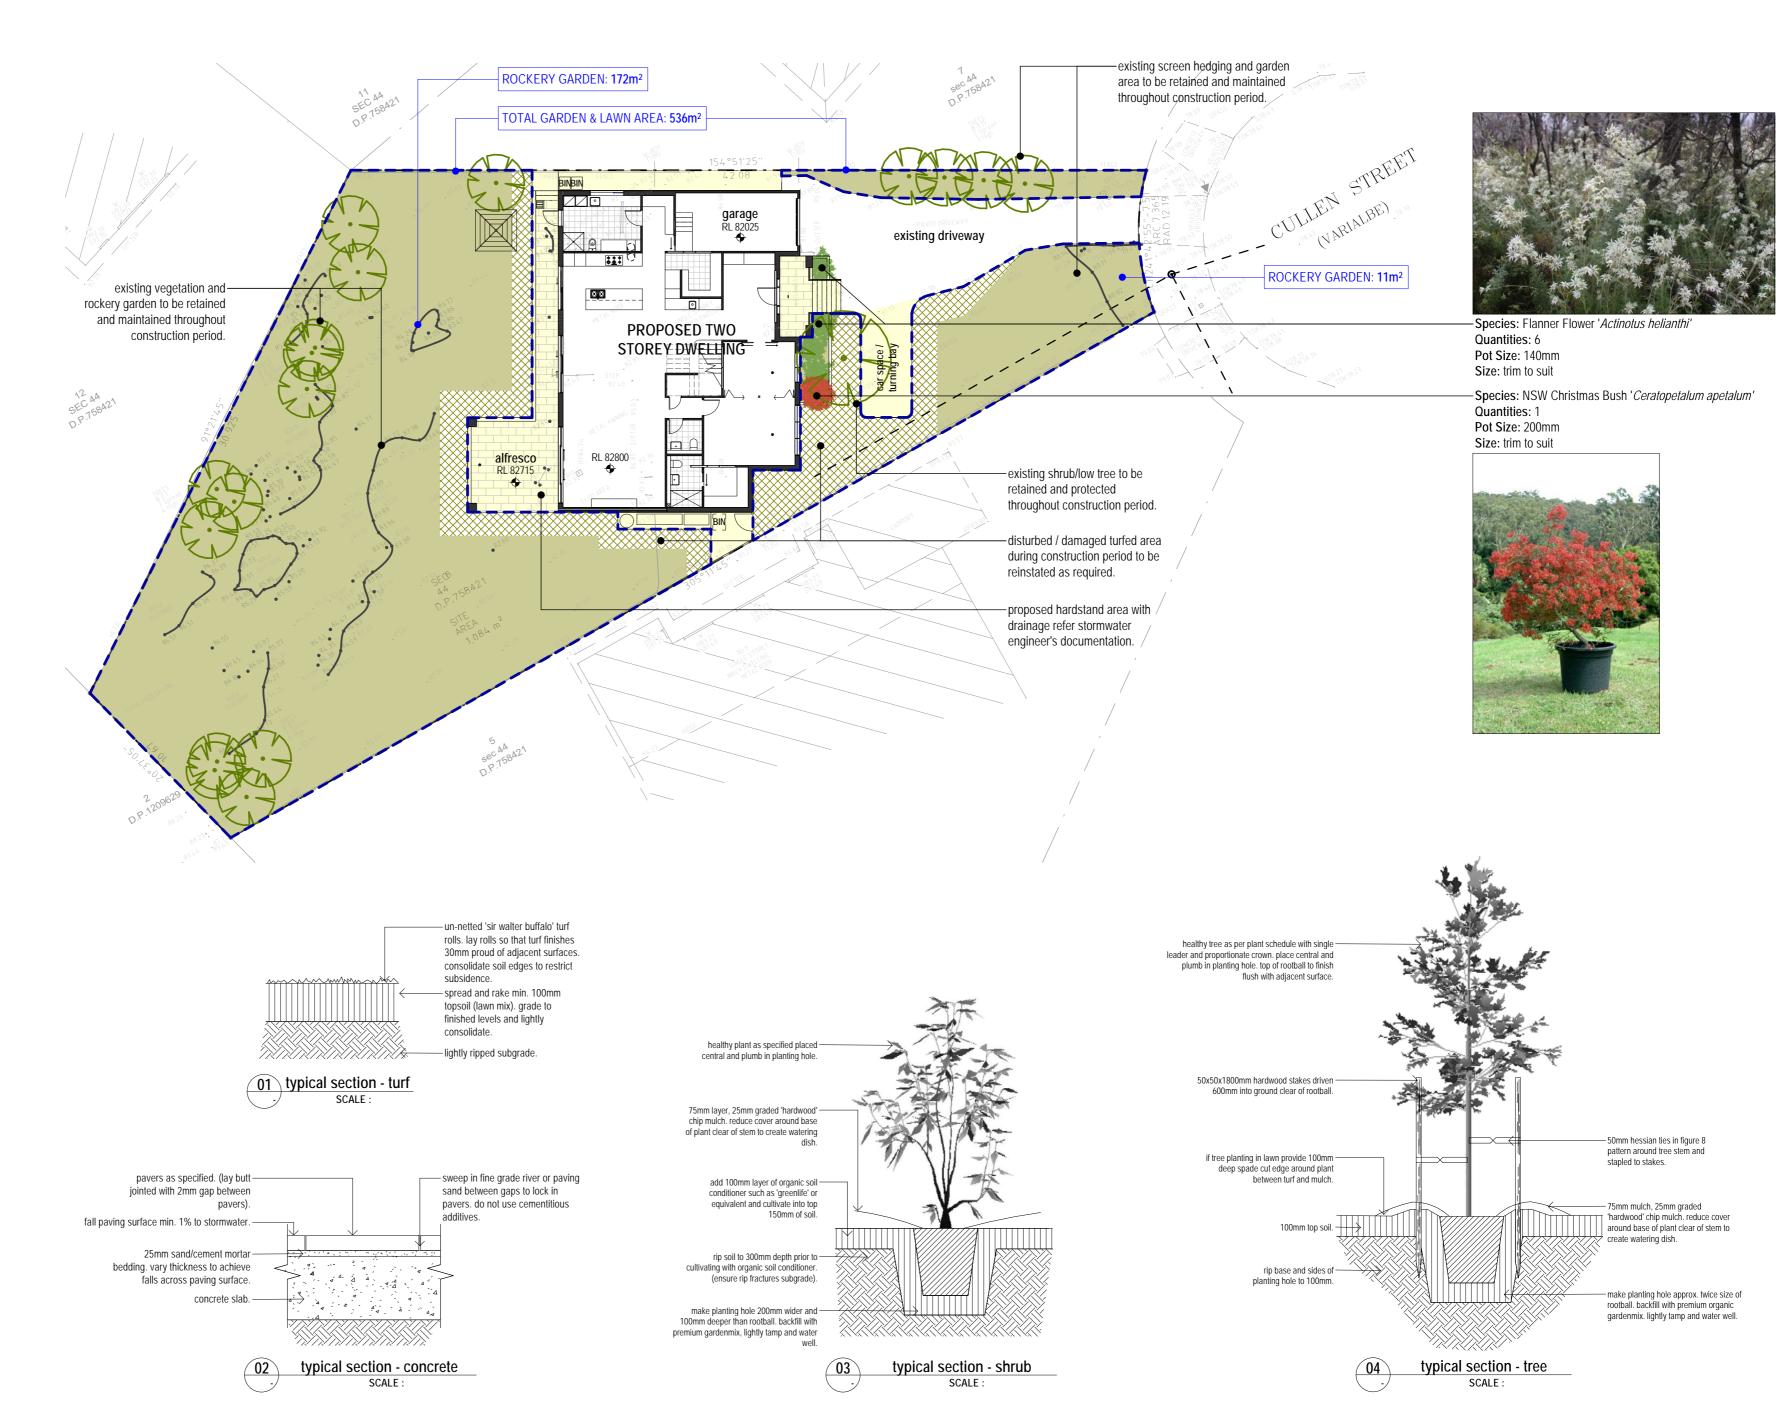



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Wei Chen (Shirley)

Proposed 2 Storey Residential Dwelling Forestville_7CullenSt DP 758421 LOT6

LANDSCAPE CONCEPT PLA


Drawn	Checked	Approved
AK	CH	SL
Filename	Size	Scale
-	A2	1:200
Project Number	Drawing Number	Sheet Number
22-106	A105	-

A issued for development application

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Proposed 2 Storey Residential Dwelling


Address
Forestville_7CullenSt
DP 758421

LOT 6

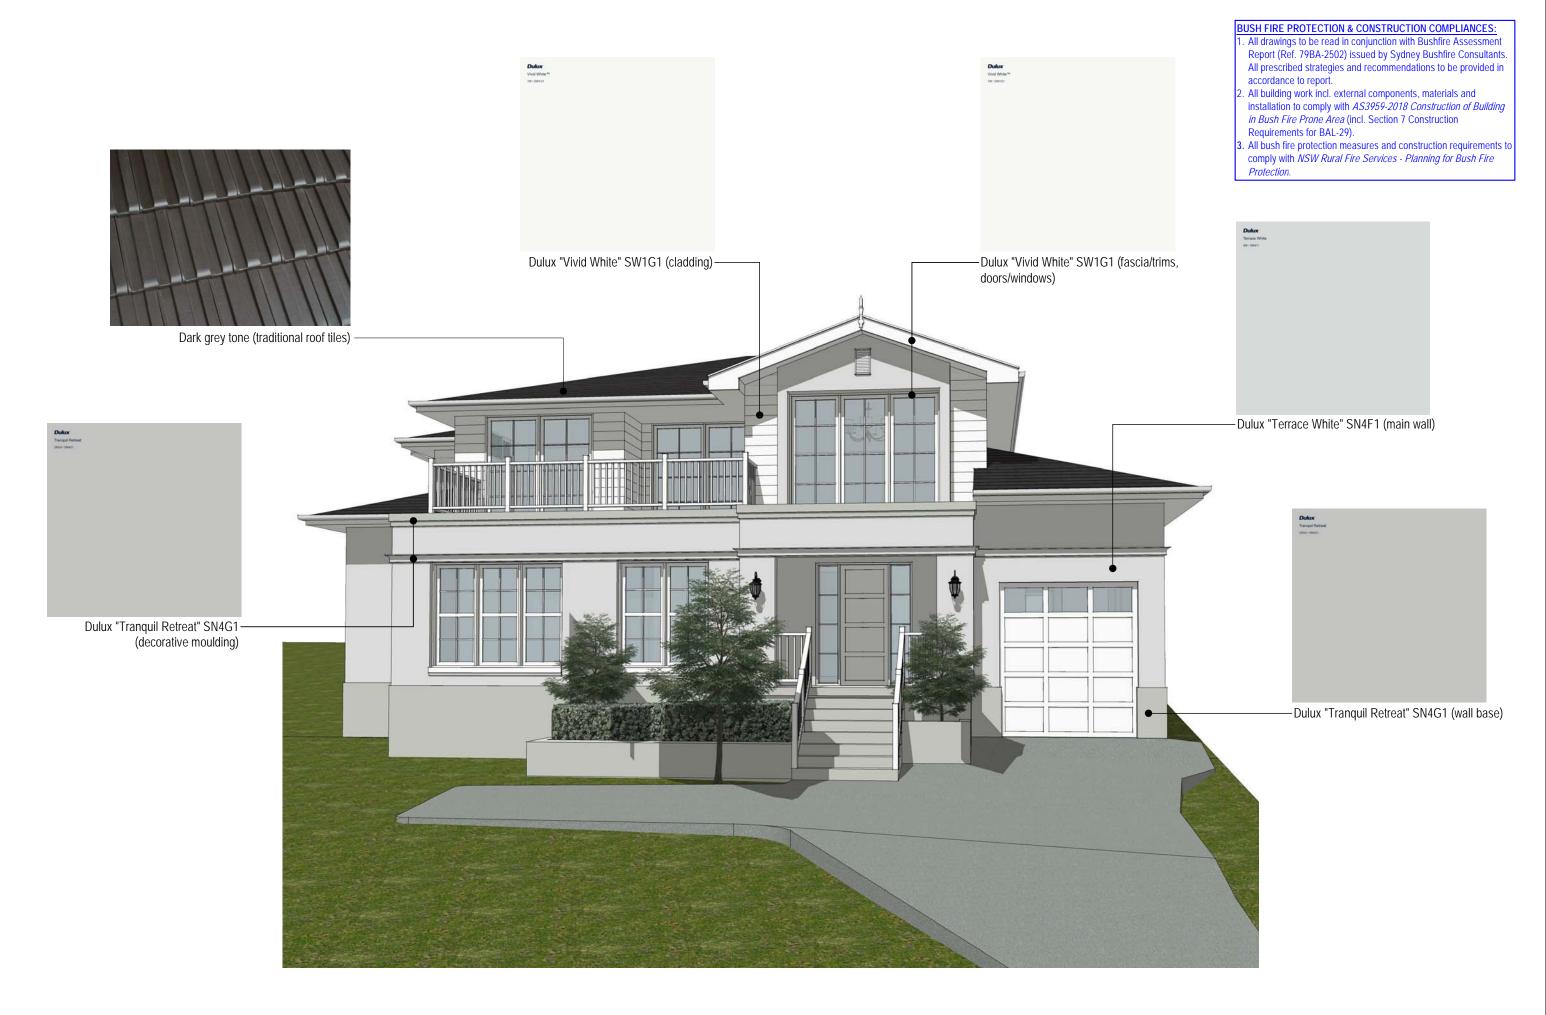Drawing Title

MATERIAL & FINISHES

Drawn	Checked	Approved
GC	CH	SL
Filename	Sheet Size	Scale
-	A3	1:100
Project Number 22-106	Drawing Number A110	Sheet Number

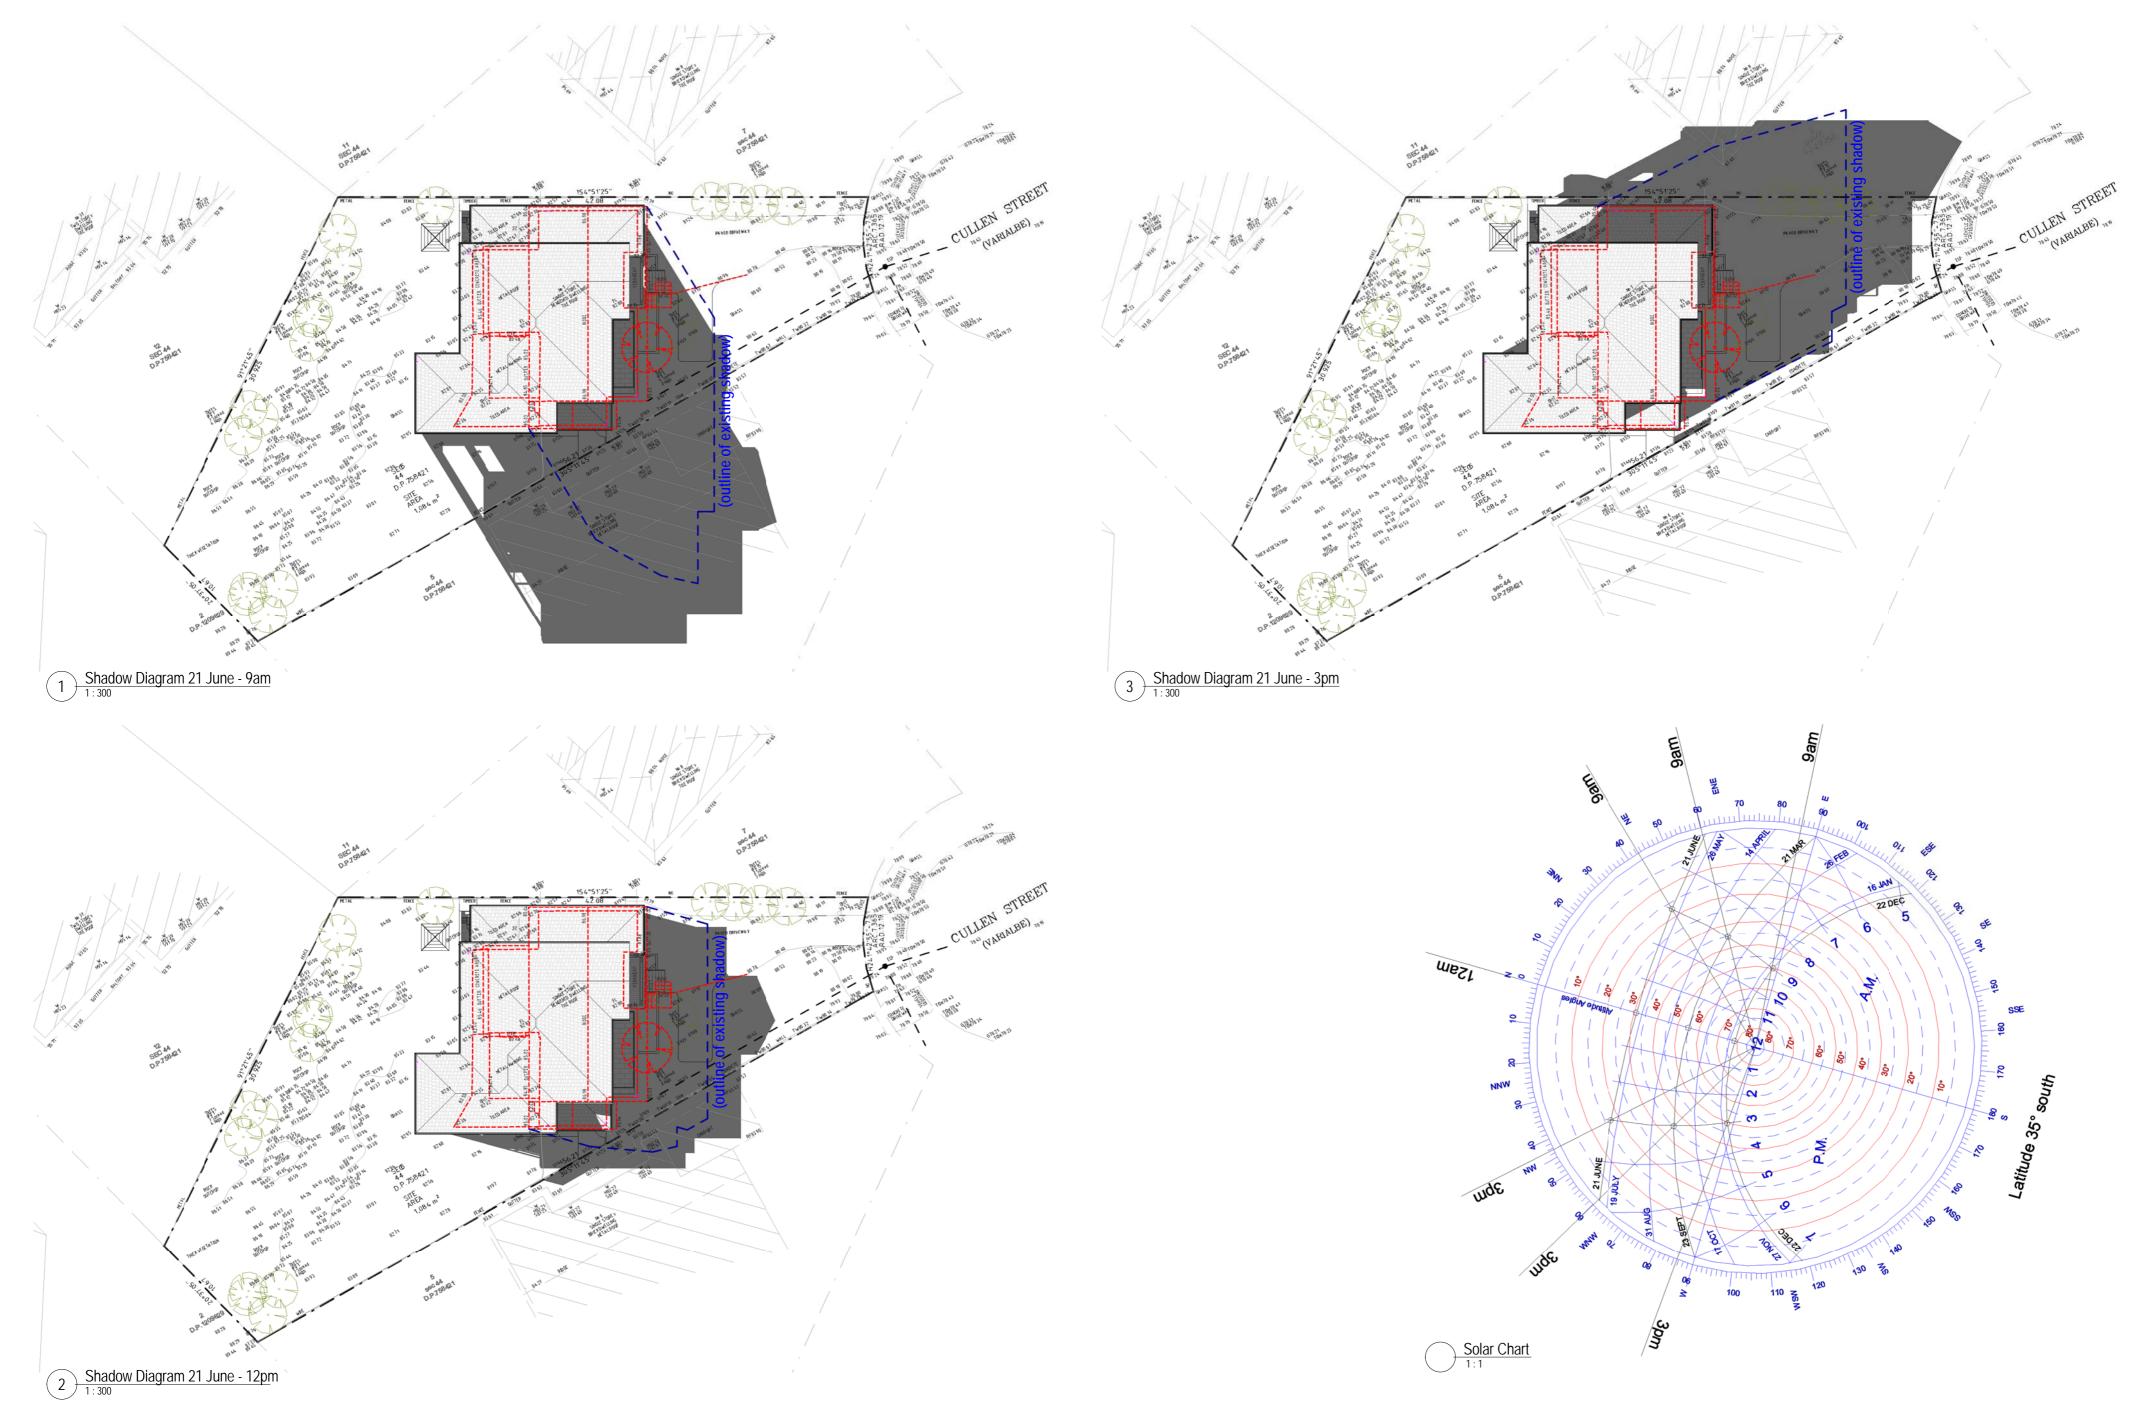

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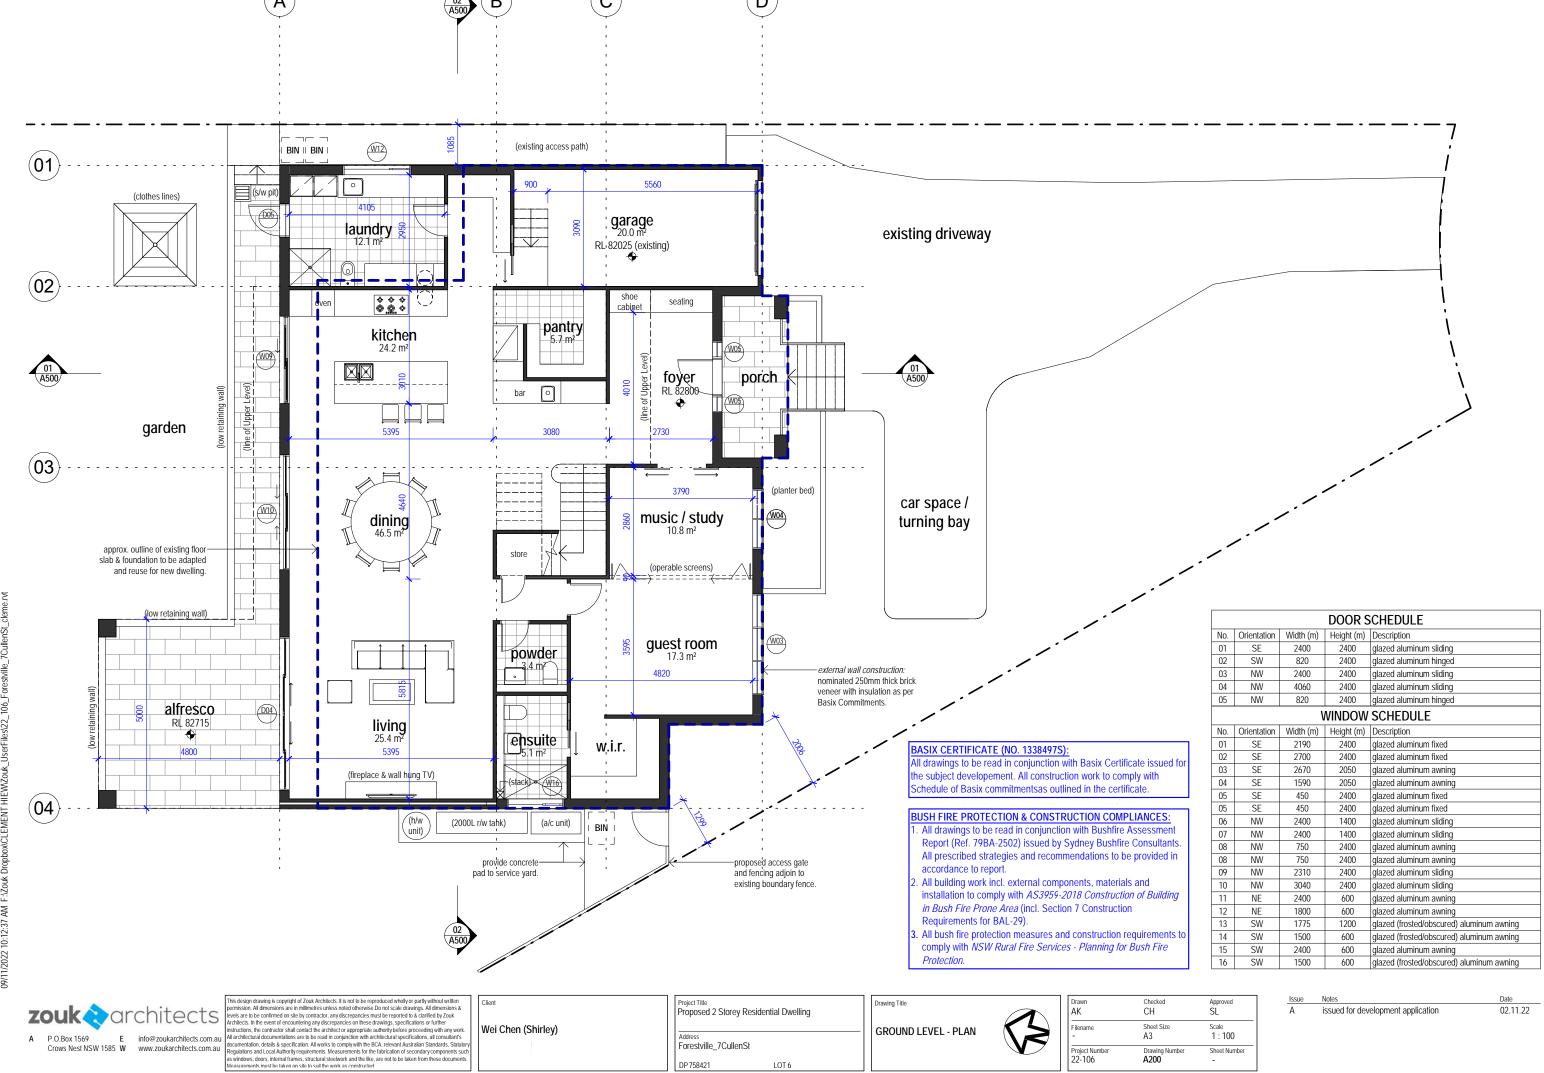
Wei Chen (Shirley)

Project Title Proposed 2 Storey F	Residential Dwelling	
Address Forestville_7CullenS	t	_
DP 758421	LOT6	

SHADOW DIAGRAMS

<u> </u>	Drawn GC	Checked CH	Approved SL
	Filename	Size A2	Scale As indicated
	Project Number 22-106	Drawing Number A120	Sheet Number

Issue Notes Date
A issued for development application 02.11.22





Forestville_7CullenSt


DP 758421

Project Numb 22-106

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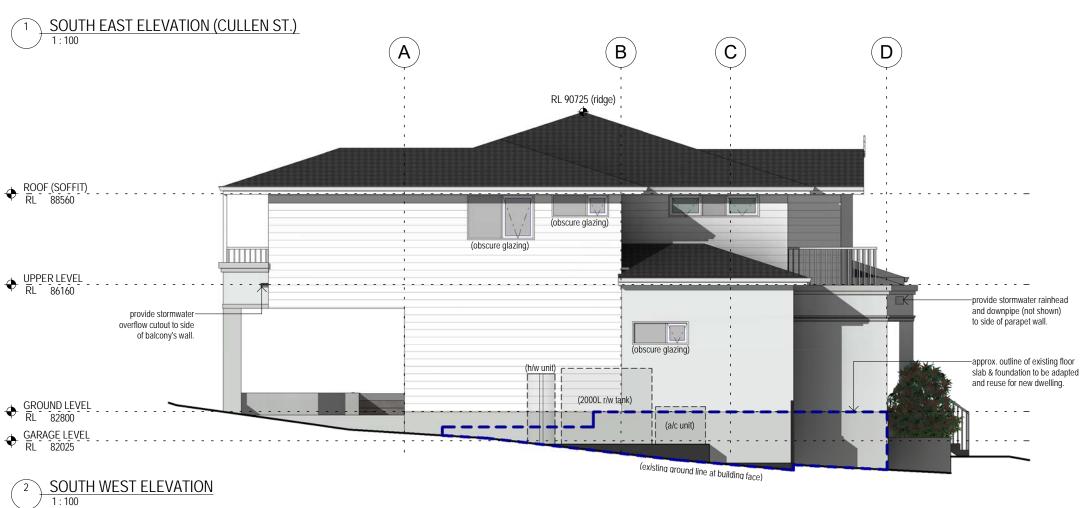


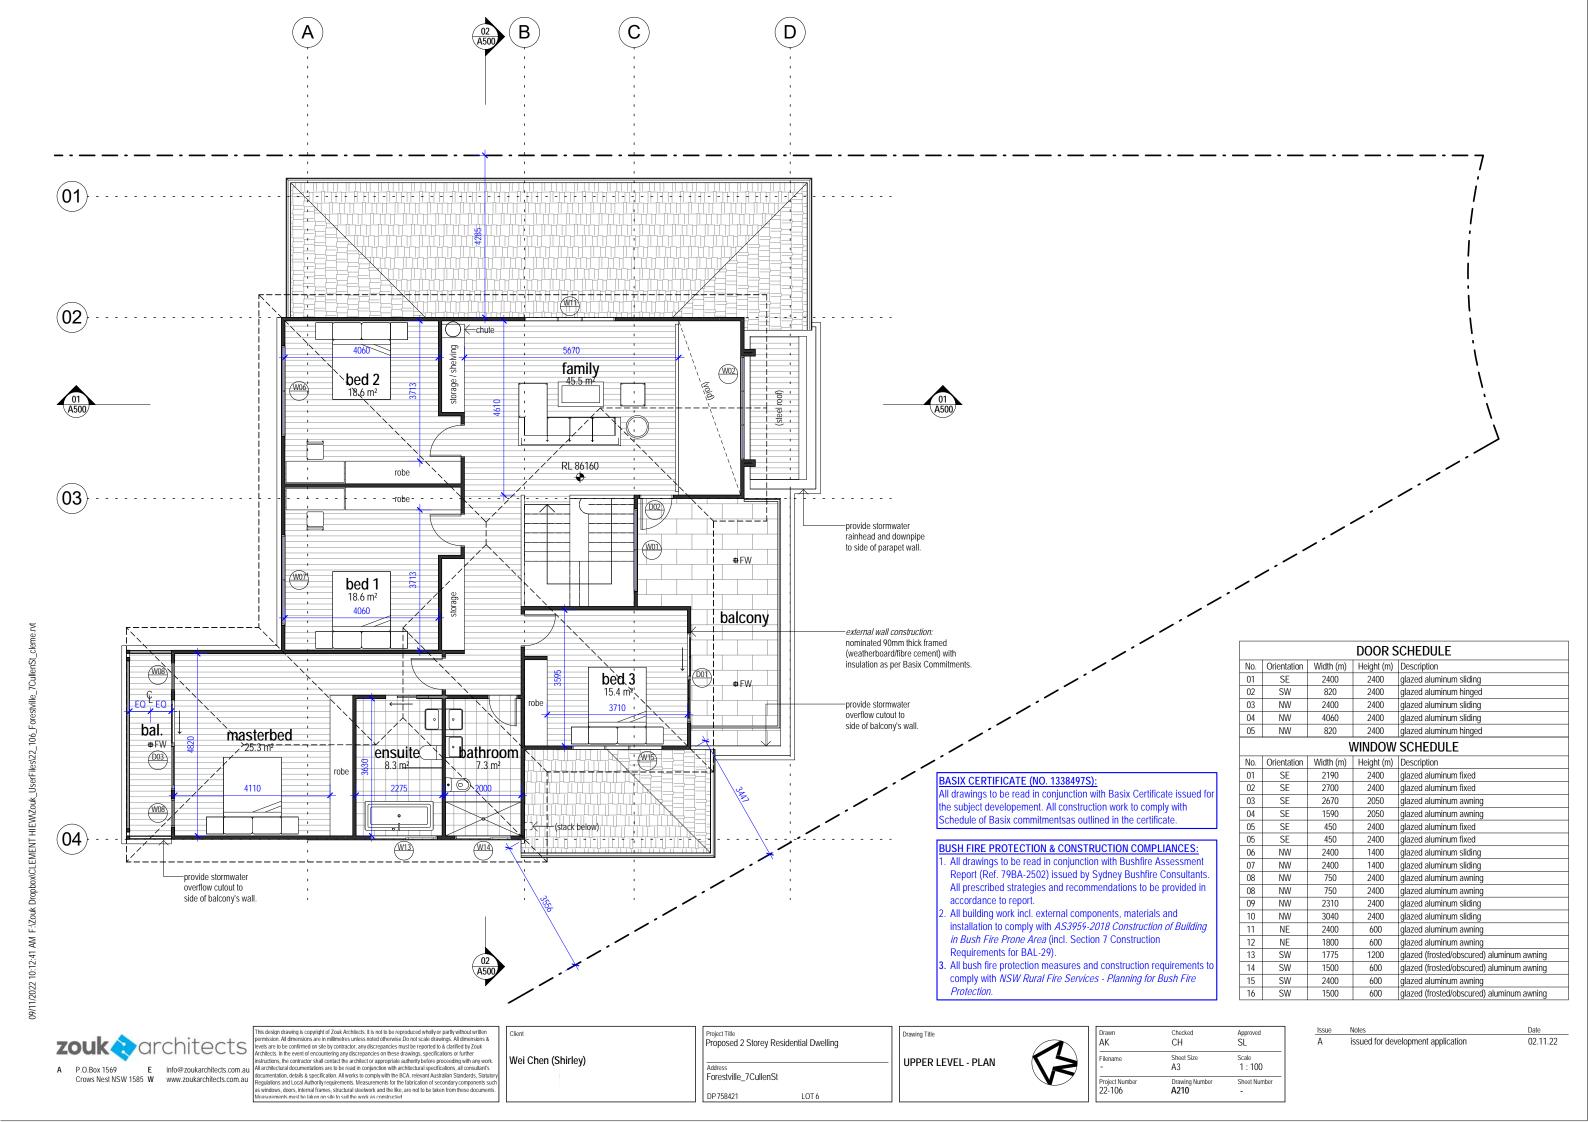BUSH FIRE PROTECTION & CONSTRUCTION COMPLIANCES:

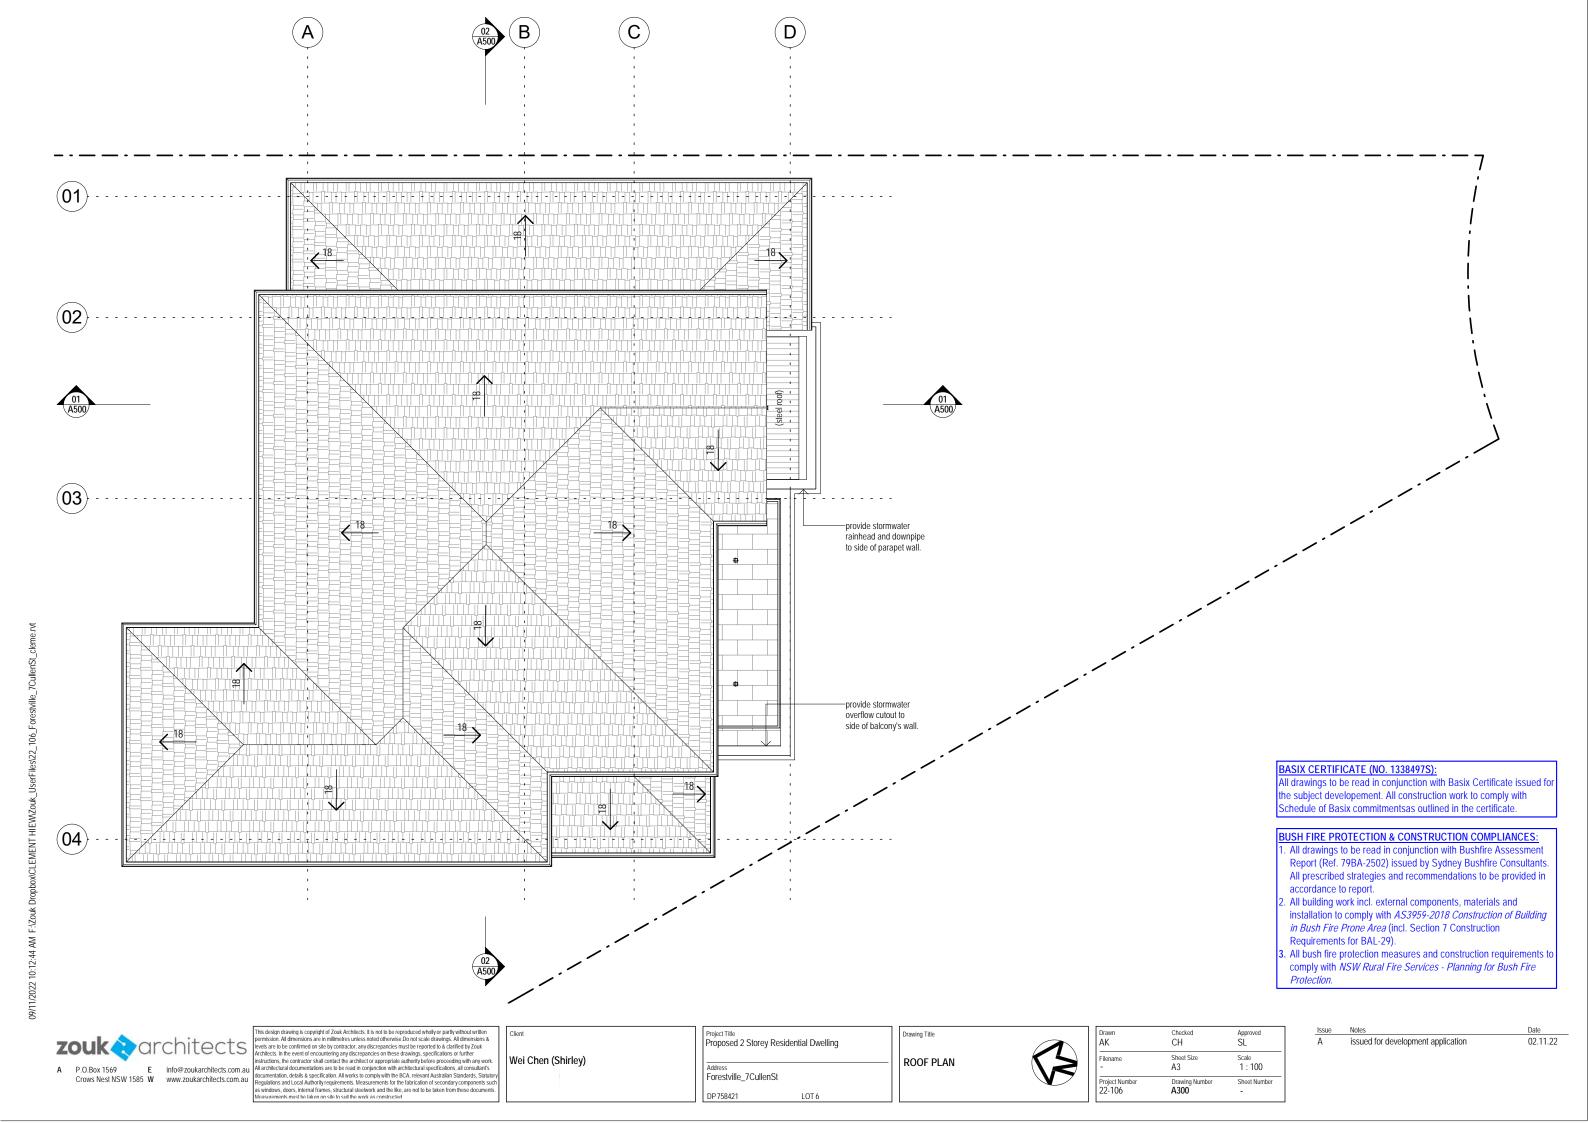- All drawings to be read in conjunction with Bushfire Assessment Report (Ref. 79BA-2502) issued by Sydney Bushfire Consultants. All prescribed strategies and recommendations to be provided in accordance to report.
- All building work incl. external components, materials and installation to comply with AS3959-2018 Construction of Building in Bush Fire Prone Area (incl. Section 7 Construction Requirements for BAL-29).
- All bush fire protection measures and construction requirements to comply with NSW Rural Fire Services - Planning for Bush Fire Protection.

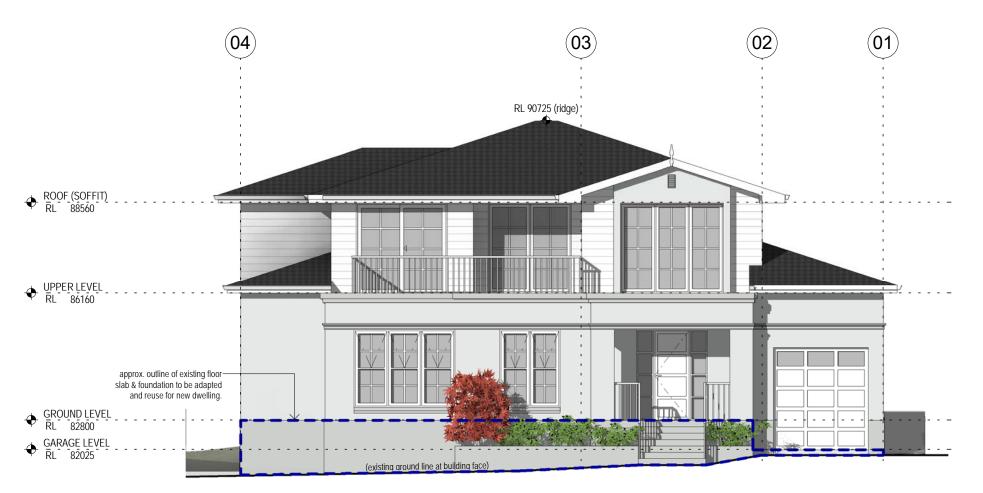BASIX CERTIFICATE (NO. 1338497S):

All drawings to be read in conjunction with Basix Certificate issued fo the subject developement. All construction work to comply with Schedule of Basix commitments as outlined in the certificate.





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Project Title
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Address
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DP 758421

LOT 6

EXTERNAL ELEVATIONS


Drawing Title

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 Approved SL

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 SL

 Filename
 Sheet Size A3
 Scale 1: 100

 Project Number
 Drawing Number Drawing Number A400
 Sheet Number C2: 106

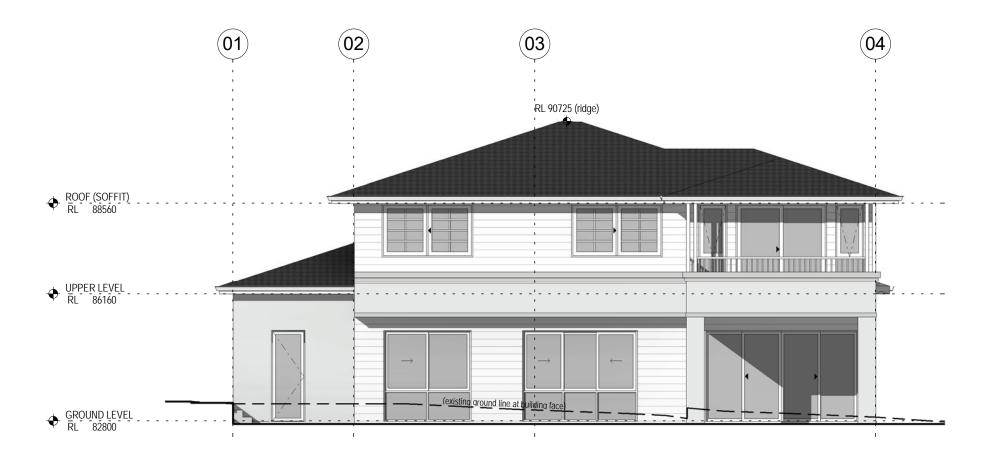


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NORTH EAST ELEVATION
1:100

Wei Chen (Shirley)

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Proposed 2 Storey Residential Dwelling

Address
Forestville_7CullenSt

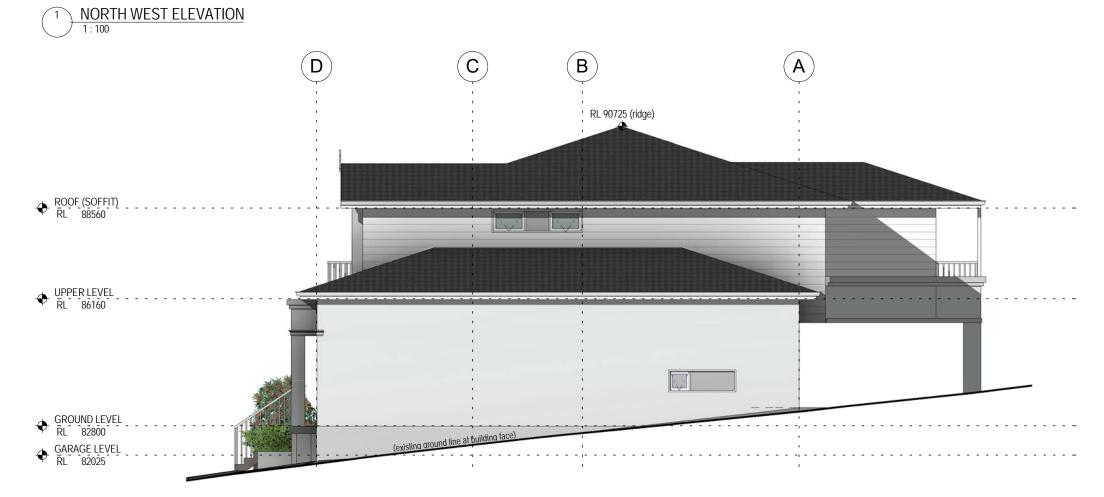
DP 758421


LOT 6


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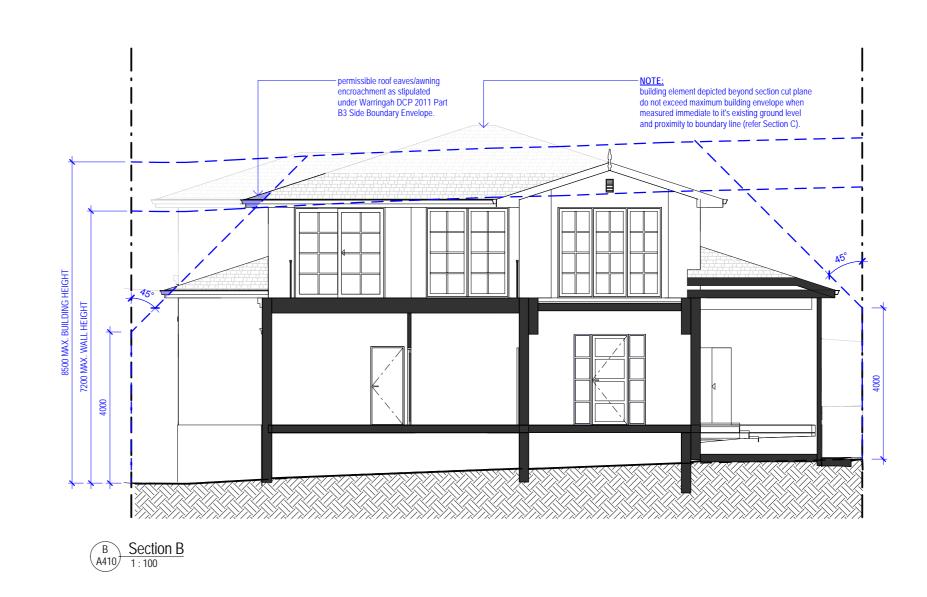
EXTERNAL ELEVATIONS

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-	A3	1:100
Project Number 22-106	Drawing Number A401	Sheet Number -



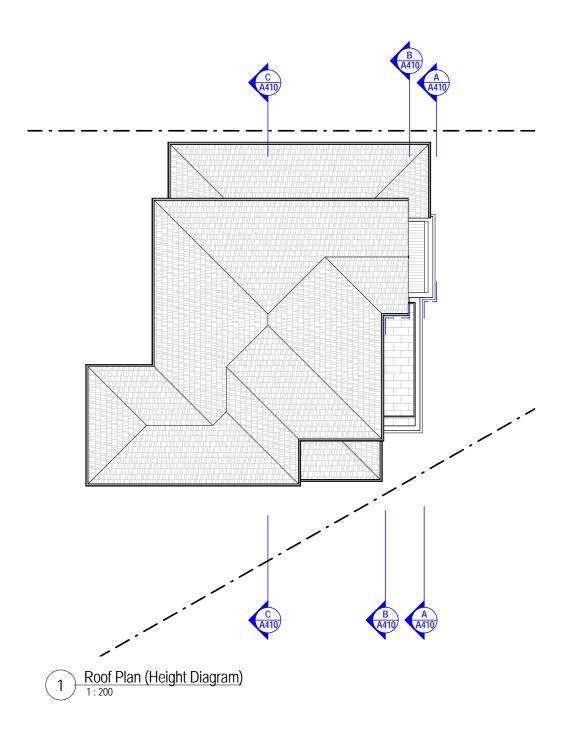

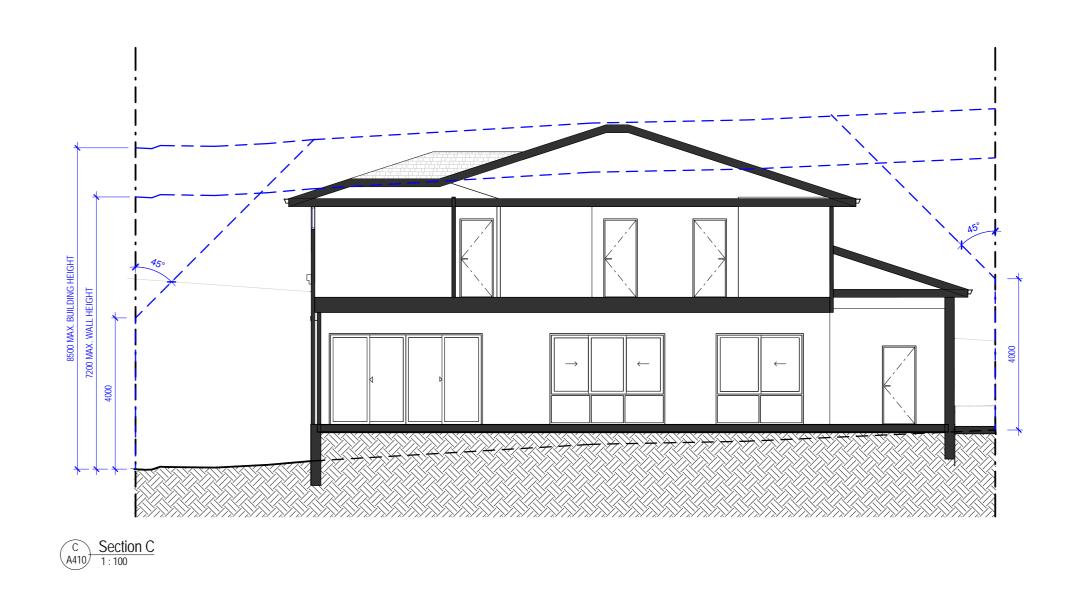

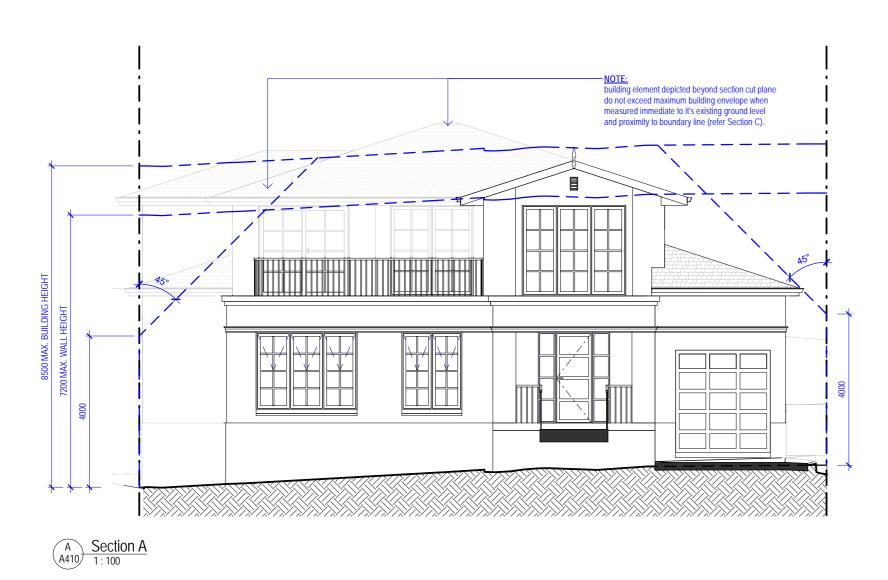



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LOT 6

BUILDING ENVELOPE ANALYSIS DIAGRAMS




Drawn GC	Checked CH	Approved SL
Filename	Size A2	Scale As indicated
Project Number 22-106	Drawing Number A410	Sheet Number


LEGEND & ABBREVIATION:

01 existing ground line at building face

7.2m maximum wall height

03 8.5m maximum building height

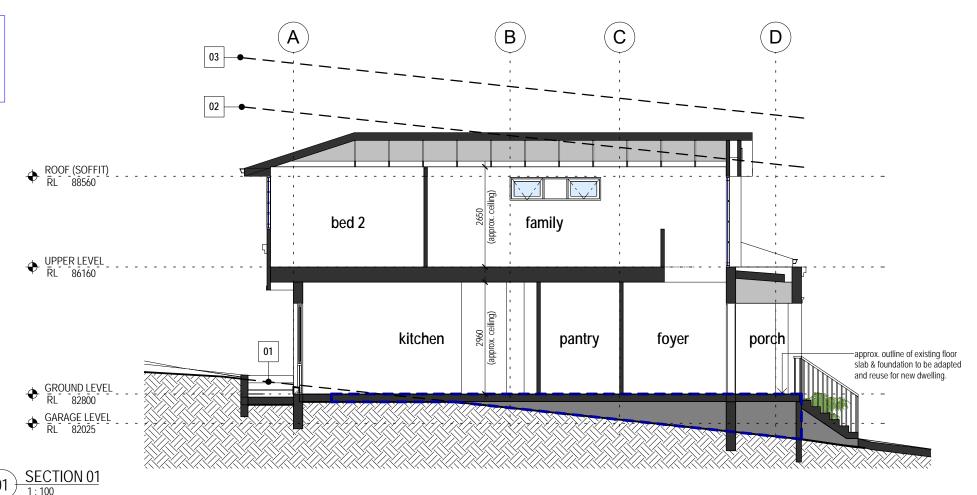

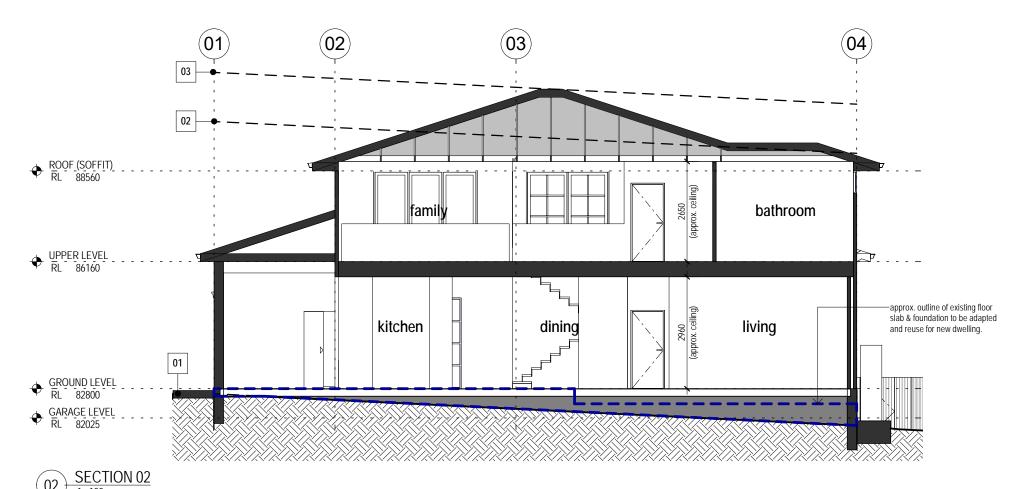



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Address
Forestville_7CullenSt

DP758421 LOT 6

Drawing Title

SECTIONS

Drawn AK	Checked CH	Approved SL
Filename	Sheet Size A3	Scale As indicated
Project Number 22-106	Drawing Number A500	Sheet Number

 Issue
 Notes
 Date

 A
 issued for development application
 02.11.2

BUSH FIRE PROTECTION & CONSTRUCTION COMPLIANCES:

All drawings to be read in conjunction with Bushfire Assessment Report (Ref. 79BA-2502) issued by Sydney Bushfire Consultants.

All prescribed strategies and recommendations to be provided in

. All building work incl. external components, materials and installation to comply with AS3959-2018 Construction of Building

. All bush fire protection measures and construction requirements to comply with NSW Rural Fire Services - Planning for Bush Fire

All drawings to be read in conjunction with Basix Certificate issued fo

the subject developement. All construction work to comply with Schedule of Basix commitments as outlined in the certificate.

in Bush Fire Prone Area (incl. Section 7 Construction

accordance to report.

Requirements for BAL-29).

BASIX CERTIFICATE (NO. 1338497S):

GENERAL NOTES

- 1. THE PLUMBER/ DRAINER SHALL INSPECT THE SITE AND CONFIRM THE EXISTING SITE STRUCTURES, SERVICES AND CONDITIONS PRIOR TO PROCEEDING, IF ANY DISCREPANCIES FOUND, CONTACT THE ENGINEER FOR DISCUSSION.
- 2. ALL WORKS TO BE CARRIED OUT IN ACCORDANCE WITH RELEVANT AUSTRALIAN STANDARDS, BUILDING CODE OF AUSTRALIA AND LOCAL GOVERNMENT'S REQUIREMENTS. IT IS THE RESPONSIBILITY OF THE PLUMBER/ DRAINER TO OBTAIN ANY APPROVALS/ PERMITS/ LICENSES ISSUED BY THE AUTHORITIES PRIOR TO PROCEEDING WITH STORMWATER WORKS.
- 3. UNLESS NOTED AS OTHERWISE, ALL DOWNPIPES TO BE \$\phi\$100 ROUND (OR 100x75) RECTANGULAR) AND FULLY SEALED. ALL EAVE GUTTERS TO BE 115 QUAD HI-FRONT OR EQUIVALENT, ALL BOX GUTTERS TO BE 200Wx150H. ALL STORMWATER PIPES TO BE Φ100 SEWER GRADE AND LAID AT 1% MIN. FALL. ALL MATERIALS USED IN THE WORK SHALL BE NEW AND CONFORM WITH RELEVANT AUSTRALIAN STANDARDS AND BEAR THE REQUIRED STANDARDS MARK
- 4. LOCATION OF STORMWATER SYSTEMS, INCLUDING DOWNPIPES, PIPES, PITS AND RAINWATER TANK ARE INDICATIVE ONLY. EXACT LOCATION SHALL BE DETERMINED ON SITE TO SUIT SITE CONDITIONS.
- 5. SUB-SOIL DRAINS FOR RETAINING WALL SHALL BE INSTALLED BY THE BUILDER AND CONNECTED TO STORMWATER LINES. ALL AGG. LINES SHALL BE 100mm DIA., UNLESS NOTED OTHERWISE.
- 6. NATURAL GROUND LEVELS ALONG ALL BOUNDARIES MUST BE MAINTAINED UNALTERED. ALL RETAINING WALLS TO BE SETBACK FROM BOUNDARIES TO AVOID CONCENTRATION OF STORMWATER FLOWS.
- 7. LEVELS ARE APPROXIMATE ONLY. THE PLUMBER/ DRAINER SHALL CONFIRM THE LEVELS PRIOR TO PROCEEDING. IF ANY DISCREPANCIES FOUND, CONTACT THE ENGINEER FOR DISCUSSION.
- 8. INSPECTION AND CERTIFICATION, IF REQUIRED, SHALL BE DONE PRIOR TO BACKFILLING. ALLOW 24 HOUR NOTICE FOR THE ENGINEER TO CARRY OUT INSPECTION.
- 9. ANY DAMAGE TO SERVICES DURING CONSTRUCTION SHALL BE REPAIRED IMMEDIATELY AT THE PLUMBER/ DRAINER'S OWN EXPENSE.
- 10. THESE DRAWINGS ARE TO BE READ IN CONJUNCTION WITH:
- ARCHITECTURAL PLAN BY ZOUK ARCHITECTS, JOB No.22-106, ISSUE C, DATED 10.08.22


BASIX REQUIREMENTS

THIS DEVELOPMENT REQUIRES A 2000L RWT. A 2000L ABOVE GROUND RWT IS PROVIDED TO MEET THE REQUIREMENT

OSD REQUIREMENTS


SITE AREA = 1084 m2

TOTAL POST-DEVELOPMENT IMPERVIOUS AREA = 350 m2 < 433.6m2 (40% OF THE SITE AREA THEREFORE, OSD SYSTEM IS NOT REQUIRED

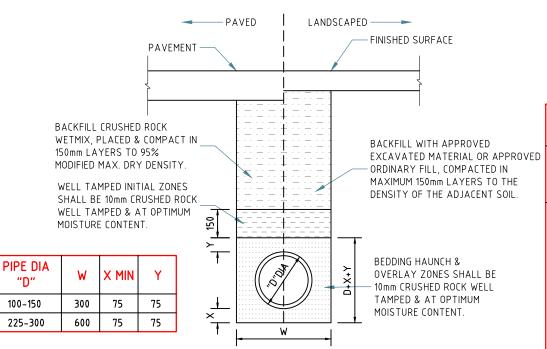

UPVC PIPE TRENCH BACKFILL TYP. DETAILS

SCALE 1:20

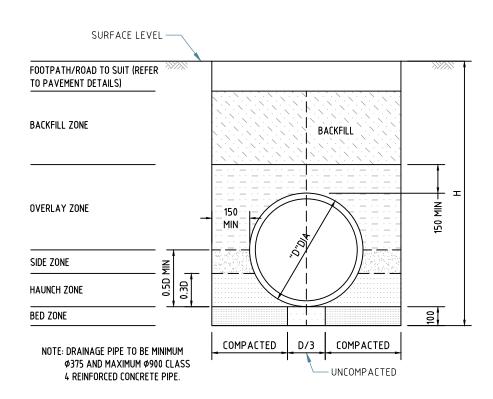

CONCRETE PIPE TRENCH BACKFILL TYP. DETAILS


SCALE 1:20



MINIMUM PIPE COVER (FROM FINISHED SURFACE TO TOP OF PIPE)

	MINIMUM (OVER (mm)
LOCATION	CAST/DUCTILE IRON GAL STEEL	OTHER AUTHORISED PRODUCTS (~)
1. NOT SUBJECT TO VEHICULAR LOADING: A. WITHOUT PAVEMENT		
i. FOR SINGLE DWELLING	0	100
ii. OTHER THAN SINGLE DWELLING B. WITH PAVEMENT OF	0	300
BRICK/UNREINFORCED CONCRETE	0(~~)	50(~~)
2. SUBJECT TO VEHICULAR LOADING: A. OTHER THAN ROAD:		
i. WITHOUT PAVEMENT ii. WITH PAVEMENT OF:	300	450
- REIFORCED CONC. FOR HEAVY VEHICLE	0(~~#)	100(~~#)
 BRICK/UNREINF. CONC. LIGHT VEHICLE 	0(~~#)	75(~~#)
B. ROAD		
i. SEALED	300	500(#)
ii. UNSEALED	300	500(#)
3. SUBJECT TO CONSTRUCTION VEHICLE OR IN ENBANKMENT CONDITION	300	500(#)

- (~) INCLUDES OVERLAY ABOVE THE TOP OF THE PIPE OF NOT LESS THAN 50mm THICK (~~) BELOW THE UNDERSIDE OF THE PAVEMENT
- (#) SUBJECT TO COMPLIANCE WITH AS1762, AS2033, AS/NZS2566.1, AS3725 OR AS4060

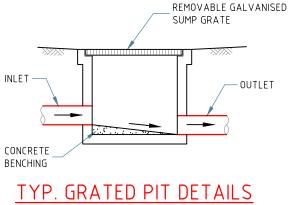

SCALE 1:20

All dimensions are in millimetres. Do not 1 scale the drawing. Use written dimensions. Dimensions must be confirmed prior to commencement. Location of services are approximate only. Dial 1100 before any excavation or demolition.

Revisions Original issue Designed: CH Checked: HN

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Approved:

Quoc Huy Nguyen

PhD (Eng), MIEAust, CPEng,

NER Reg. No. 208 2513


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PROJECT: PROPOSED ALTERATIONS AND ADDITIONS ADDRESS: 7 CULLEN ST. FORESTVILLE LGA: NORTHERN BEACHES COUNCIL

NOTES & STANDARD DETAILS

Project No: 5625H Issue: A Date: 25.10.2022 Sheet No:



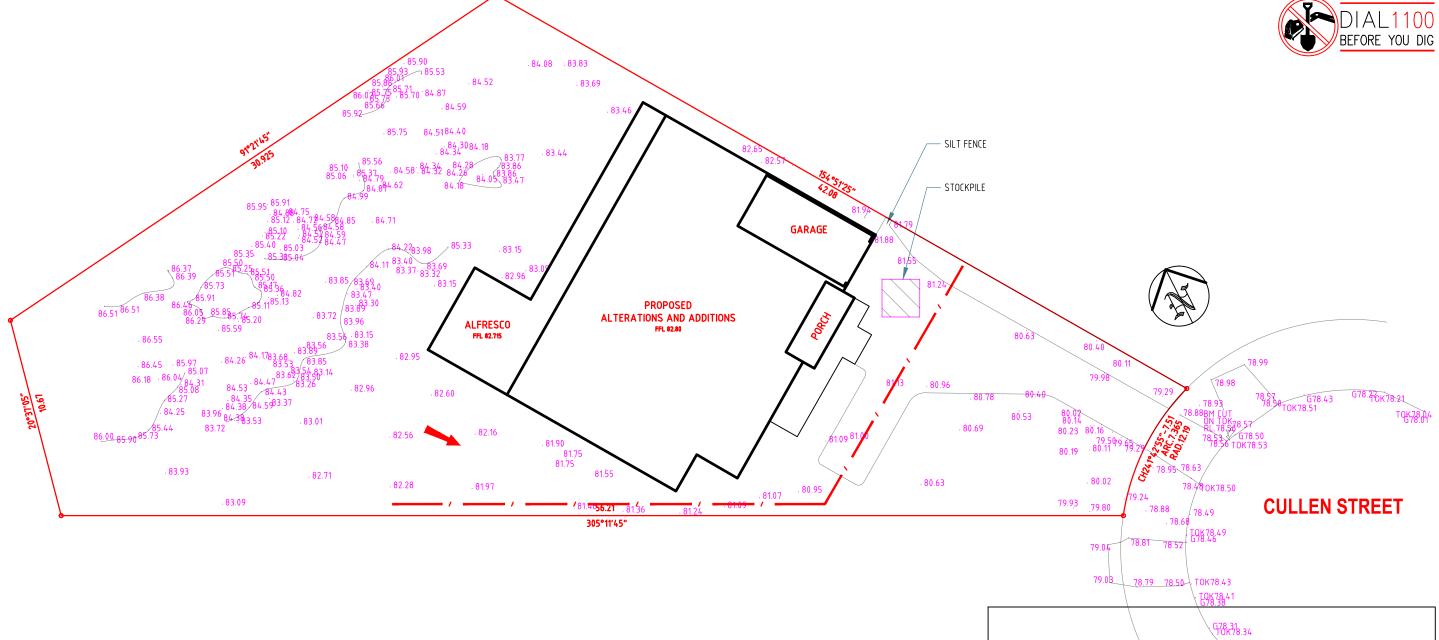

NOTES:

A3

1. ALL EROSION AND SEDIMENT CONTROL MEASURES TO BE INSPECTED AND MAINTAINED DAILY BY SITE MANAGER

- 2. MINIMISE DISTURBED AREA
- 3. ALL STOCKPILES TO BE CLEAR FROM DRAINS, GUTTERS AND FOOTPATH
- 4. DRAINAGE IS TO BE CONNECTED TO STORMWATER SYSTEM AS SOON AS POSSIBLE
- 5. ROADS AND FOOTPATH TO BE SWEPT DAILY
- 6. KERB SIDE INLET TO BE PROTECTED WITH FABRIC FILLED WITH GRAVEL

EROSION AND SEDIMENT CONTROL PLAN SCALE 1:200

GEOTEXTILE FILTER FABRIC (SUPPORTED) DISTURBED AREA POSTS DRIVEN 600 INTO GROUND (TIMBER OR STEEL) SUITALE FOR AREA OF 0.6ha MAX. SLOPE GRADIENT 1:2 MAX. SLOPE LENGTH 60m MAX. SEDIMENT FENCE DETAILS

All dimensions are in millimetres. Do not
scale the drawing. Use written dimensions.
Dimensions must be confirmed prior to
commencement. Location of services are
approximate only. Dial 1100 before any
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Nev	1510115
Original issue	
Designed: CH	Checked: HN

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Quoc Huy Nguyen


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EROSION & SEDIMENT CONTROL PLAN





3	All dimensions are in millimetres. Do not
< −	scale the drawing. Use written dimensions.
size:	Dimensions must be confirmed prior to
	commencement. Location of services are
Paper	approximate only. Dial 1100 before any
Ра	excavation or demolition.

Kev	/1510115
Original issue	
Designed: CH	Checked: HN

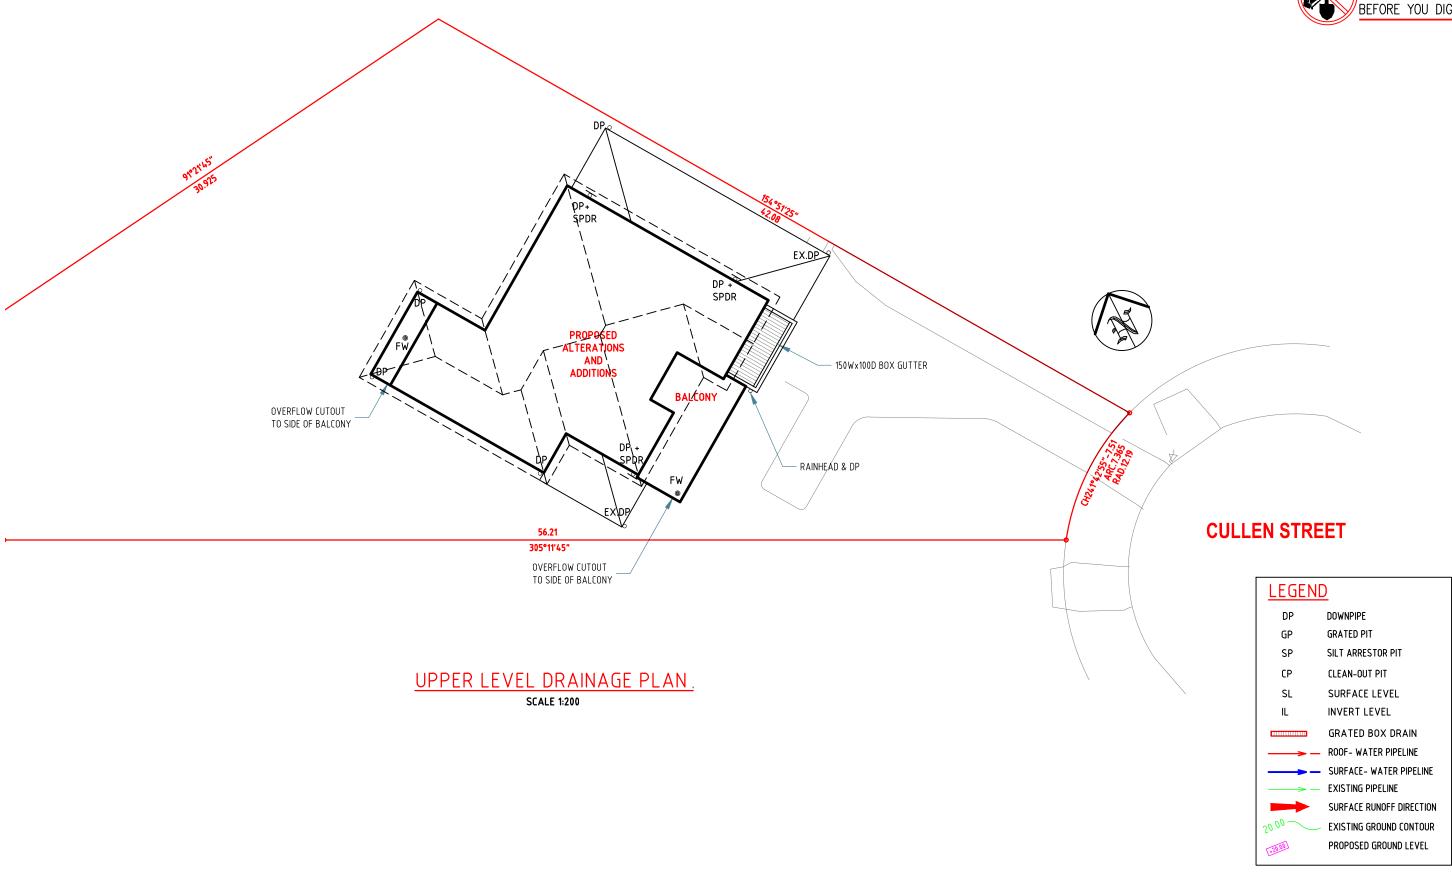Approved:

Quoc Huy Nguyen PhD (Eng), MIEAust, CPEng, NER Reg. No. 208 2513




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UPPER LEVEL DRAINAGE PLAN

Project No: 5625H Issue: A Date: 25.10.2022 Sheet No:



Paper size: A3	All dimensions are in millimetres. Do not scale the drawing. Use written dimensions. Dimensions must be confirmed prior to commencement. Location of services are approximate only. Dial 1100 before any excavation or demolition.
Paper	approximate only. Dial 1100 before any excavation or demolition.

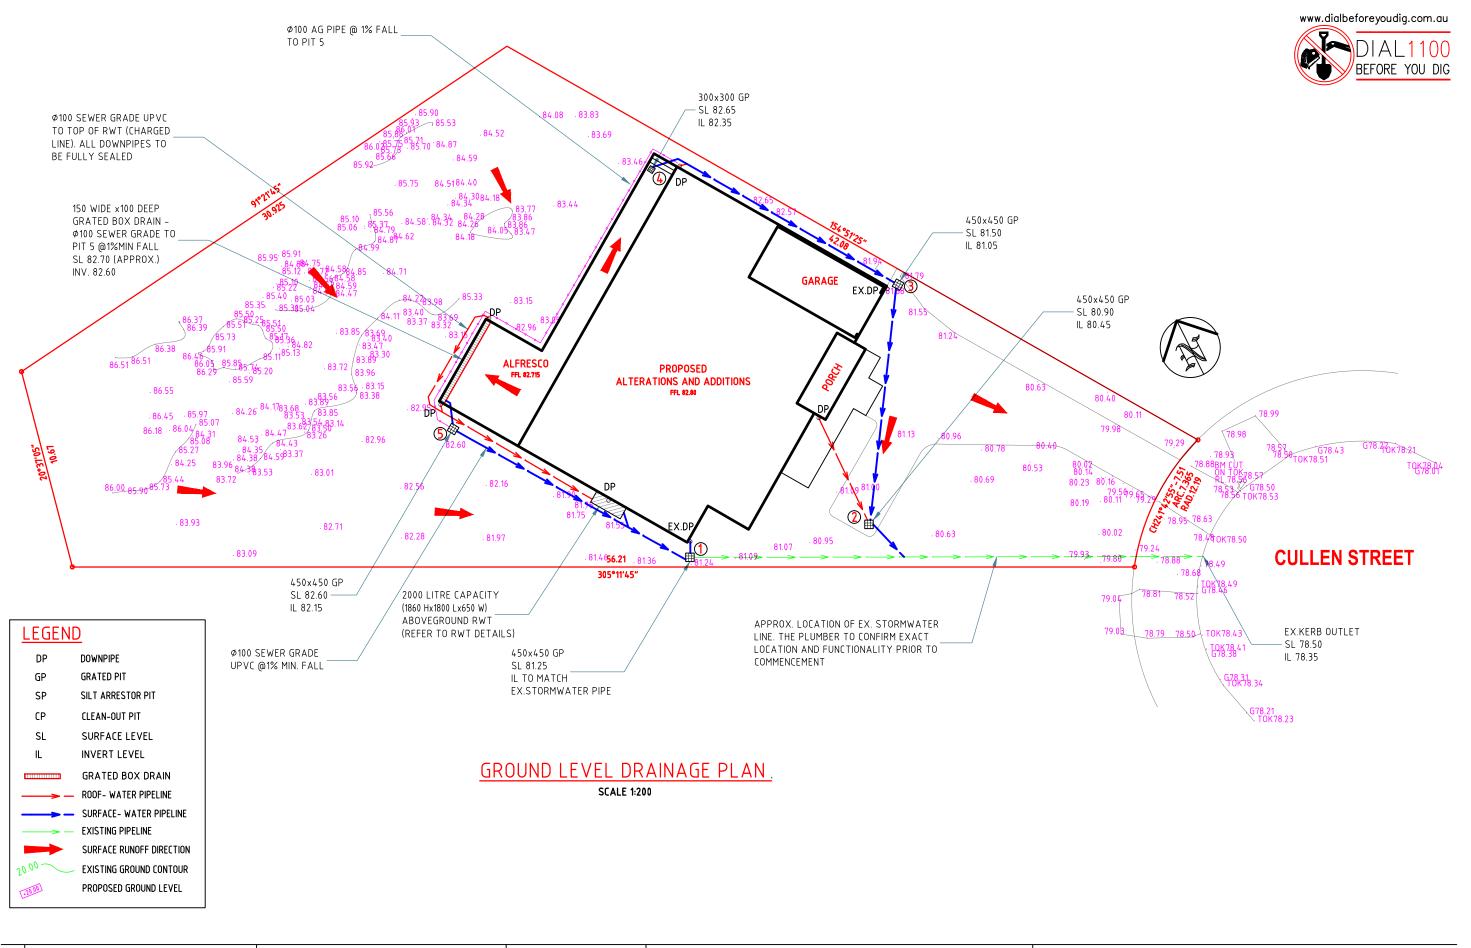Revisions Approved: Original issue Quoc Huy Nguyen PhD (Eng), MIEAust, CPEng,

Checked: HN

Designed: CH



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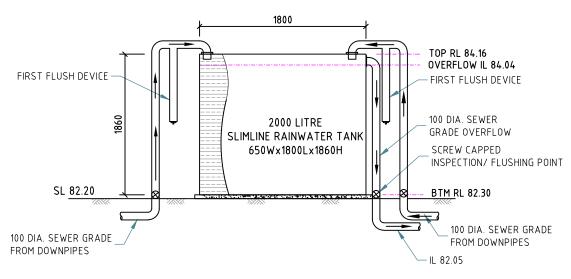
GROUND LEVEL DRAINAGE PLAN

Project No: 5625H Issue: A Date: 25.10.2022 Sheet No:




RAINWATER TANK NOTES:

- 1. RAINWATER TANKS BY TANKWORKS AUSTRALIA (TEL: 1300 736 562) OR SIMILAR. 2. DIMENSIONS ARE INDICATIVE ONLY. EXACT DETAILS TO MANUFACTURER'S SPECIFICATIONS.
- 3. A FIRST FLUSH DEVICE IN ACCORDANCE WITH MANUFACTURER'S SPECIFICATIONS SHALL BE FITTED TO RAINWATER TANK SYSTEM TO FLUSH OUT THE FIRST 0.5mm OF RUN-OFF FROM THE ROOF AREA THAT DRAINED INTO THE TANK (E.G. 0.5L/m2).
- 4. RAINWATER OUTLET CONNECTIONS AS PER BASIX CERTIFICATE.



RAINWATER TANK DETAILS. NOT TO SCALE

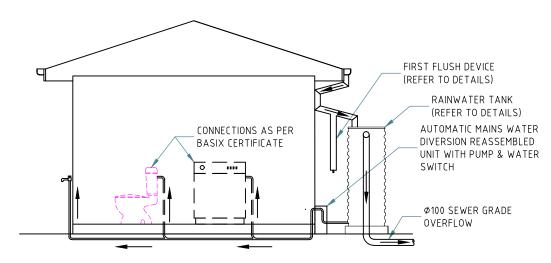


Approved:

Quoc Huy Nguyen

NER Reg. No. 208 2513

ABOVEGROUND RWT INSTALLATION. SCALE 1:50

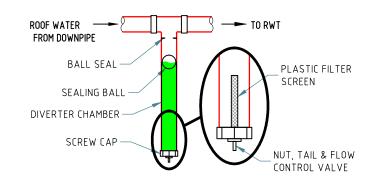

FIRST FLUSH DEVICE DETAILS. NOT TO SCALE

All dimensions are in millimetres. Do not ⋖ scale the drawing. Use written dimensions. Dimensions must be confirmed prior to commencement. Location of services are approximate only. Dial 1100 before any excavation or demolition.

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RWT DETAILS