



The builder shall check and verify all dimensions and verify all errors and omissions to the Architect. Do not scale the drawings. Drawings shall not be used for construction purposes until issued by the Architect for construction.

Client Christopher & Siobhan
Project Name Eagar Home

3 Martin St Freshwater NSW 2095

Drawing Title:
Plans Ground - Site Plan and Perspectives

Scale: as noted

Date: March 2020

Status: DA

Checked By: SH


Project No:


Drawing No.:


2019 11

DA01

t Date:

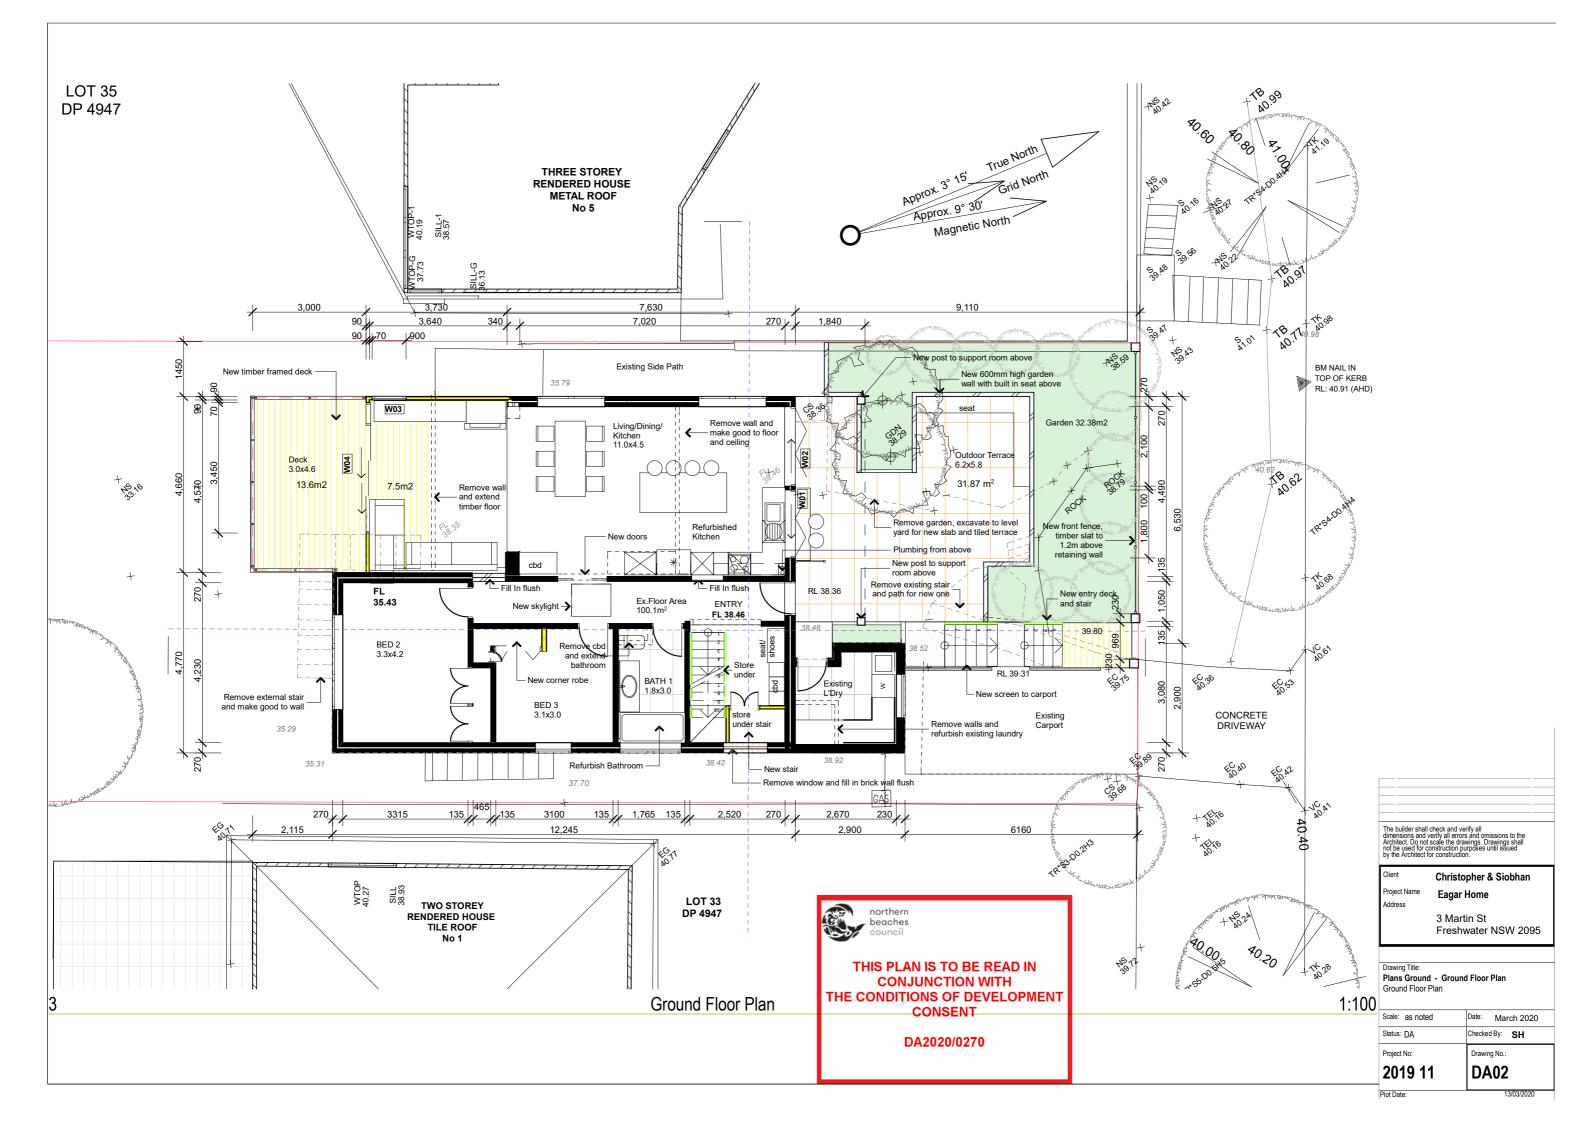

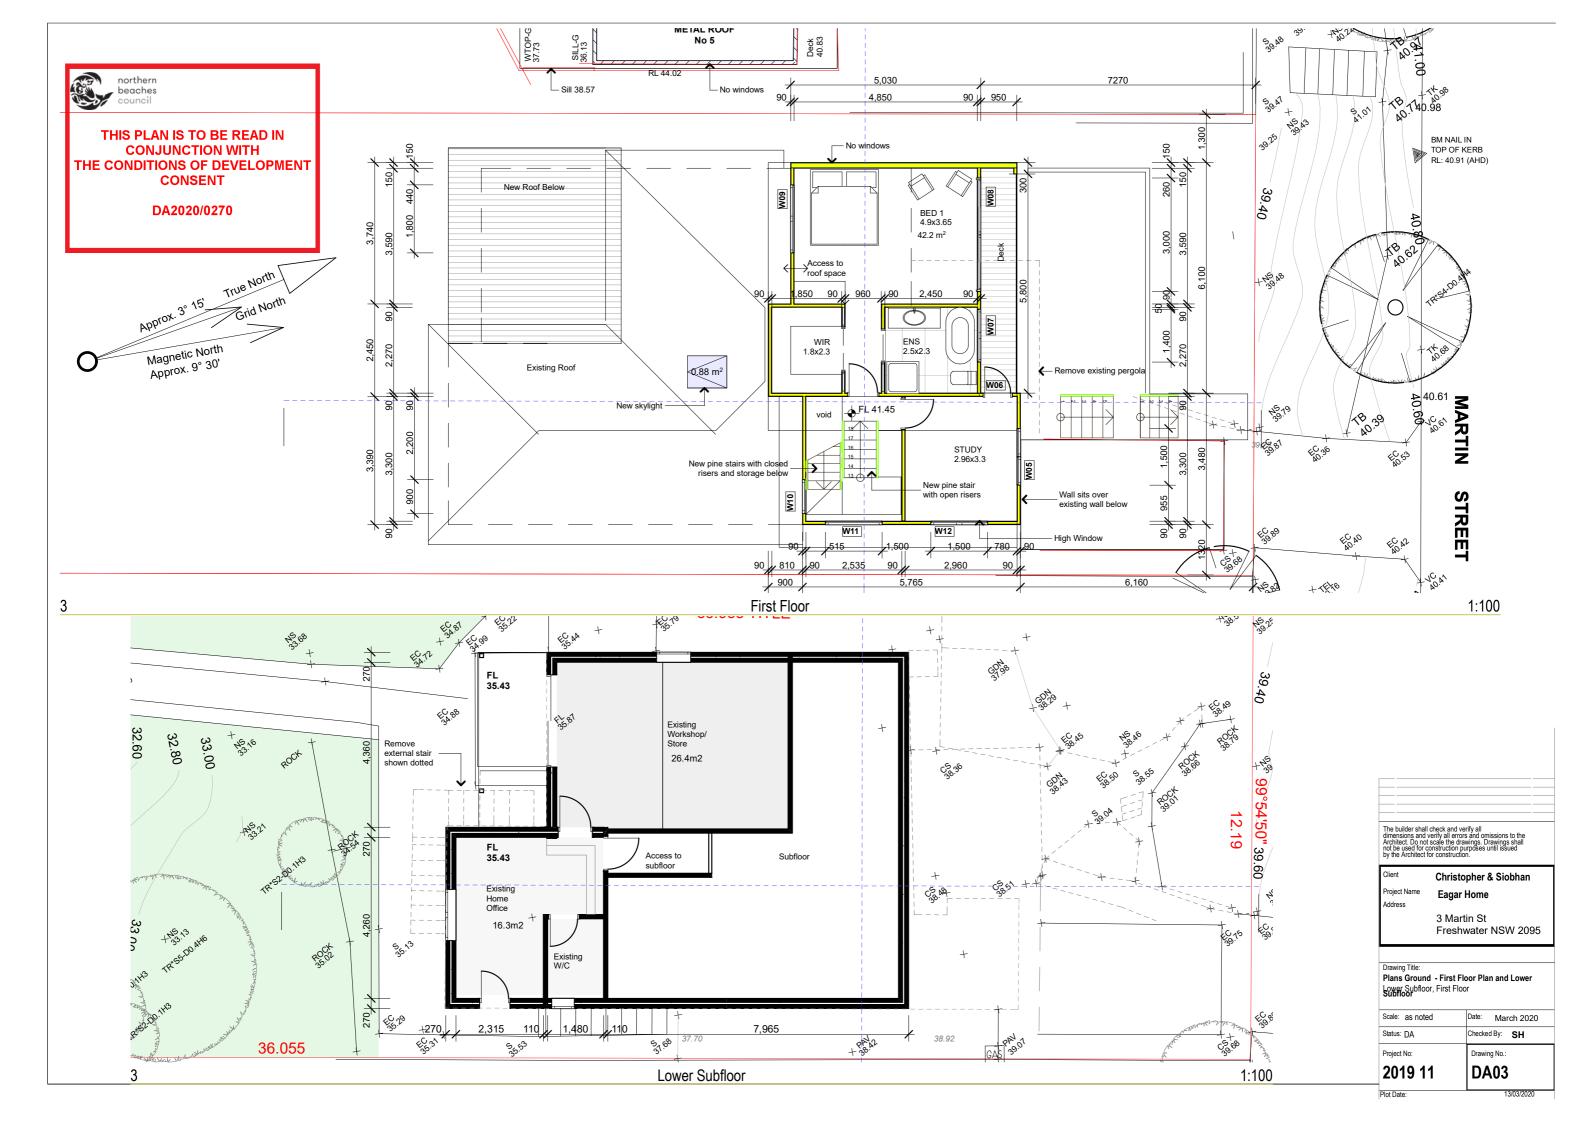

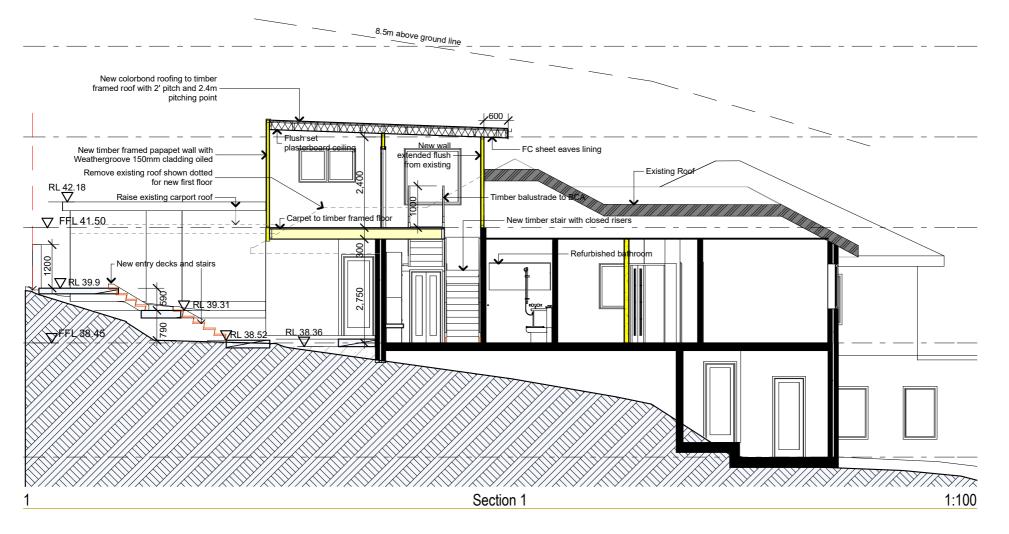

8.5m above Ground line — New colorbond roofing to timber - framed roof with 2.2m pitching point RI 44.93 and 8' pitch New colorbond roofing to timber framed roof with roof blanket and R3 0 House at No.5 Raked ceiling New timber framed stair with equal risres New timber framed floor with sturctural flooring Timber framed parapet wall House at No.1 window flush Section 2 1:100

BASIX CERTIFICATE A370228

Fixtures and Systems

Lighting
A minimum of 40% of new or
atered lights will be LED lamps,
fluorescent, or compact fluorescent

Fixtures
New Showerheads, Flow Rate
9Ltrs/min or 3 Star
New Taps, Flow Rate 9Ltrs/min or
3 Star
New Toilets, Flow Rate 4Ltrs/flush
or 3 Star

Construction

Insulation Requirements

Suspended Floor R0.8
External Walls R1.3, or R1.7 including Contruction
Raked Ceiling, R2.24 and 55mm foil back blanket, Dark Colour SA 0.70
Flat Roof/ Ceiling, R2.08 and 55mm foil back blanket, Dark Colour SA 0.70

Windows and Glazed Doors Powdercoated Aluminium

W01, W02, 900mm eave, single clear U 7.63 SHGC 0.75 W03, 450mm eave, single clear U 7.63 SHGC 0.75 W04, 900mm eave, single clear U 7.63 SHGC 0.75 W05, 600mm eave, single toned U 7.57 SHGC 0.57 W06, W07,W08, 900mm eave, single clear U 7.63 SHGC 0.75 W09, W10, 600mm eave, single clear U 7.63 SHGC 0.75 W11, W12, 600mm eave, single toned U 7.57 SHGC 0.57

S01 - 0.85m2, timber, double clear, U 4.3, SHGC 0.5



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3 Martin St Freshwater NSW 2095

Drawing Title:
Sections - Section 1 and Section 2
Section 1, Section 2


Scale: as noted Date: March 2020
Status: DA Checked By: SH

Project No: **2019 11**

16/03/

Drawing No.

DA04

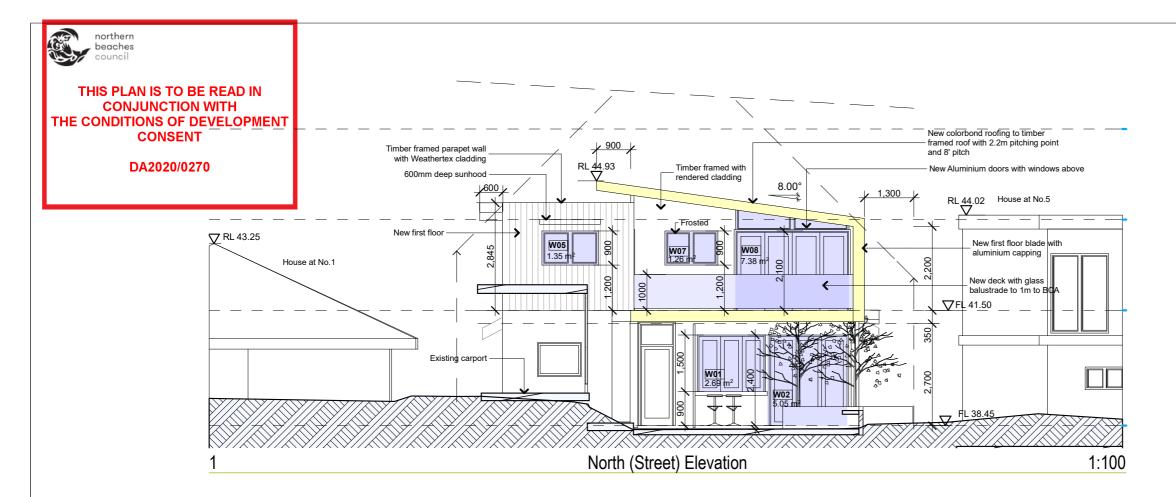

Construction


Insulation Requirements


Suspended Floor R0.8
External Walls R1.3, or R1.7 including
Contruction
Raked Ceiling, R2.24 and 55mm foil
back blanket, Dark Colour SA 0.70
Flat Roof/ Ceiling, R2.08 and 55mm foil
back blanket, Dark Colour SA 0.70

Windows and Glazed Doors Powdercoated Aluminium

W01, W02, 900mm eave, single clear U 7.63 SHGC 0.75 W03, 450mm eave, single clear U 7.63 SHGC 0.75 W04, 900mm eave, single clear U 7.63 SHGC 0.75 W05, 600mm eave, single toned U 7.57 SHGC 0.57 W06, W07,W08, 900mm eave, single clear U 7.63 SHGC 0.75 W09, W10, 600mm eave, single clear U 7.63 SHGC 0.75 W11, W12, 600mm eave, single toned U 7.57 SHGC 0.57

S01 - 0.85m2, timber, double clear, U 4.3, SHGC 0.5

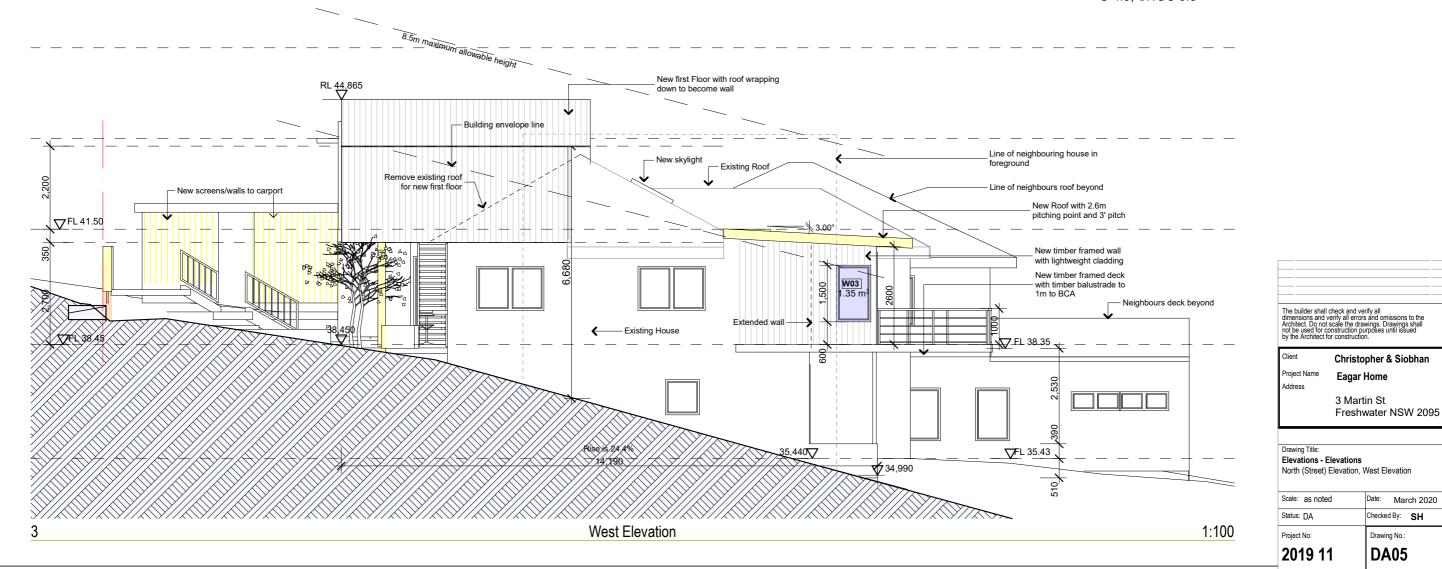

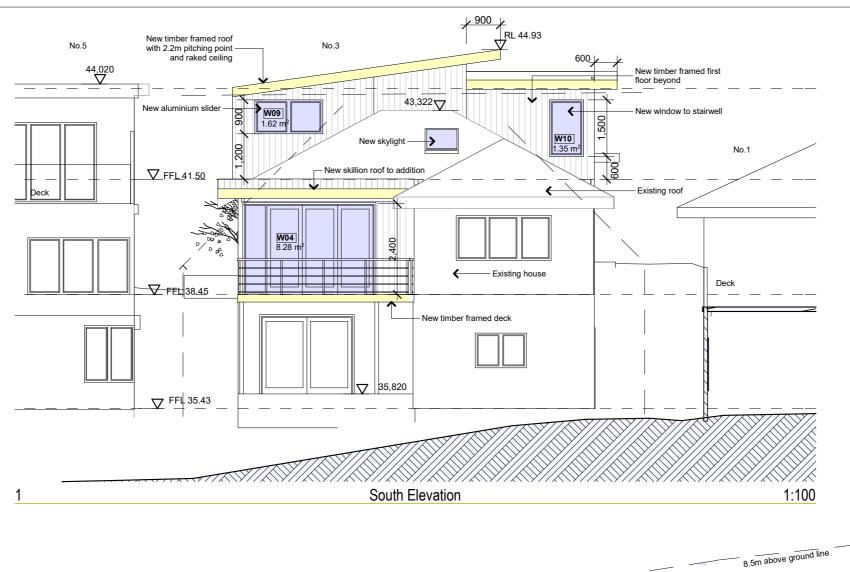

northern beaches

THIS PLAN IS TO BE READ IN CONJUNCTION WITH

THE CONDITIONS OF DEVELOPMENT

CONSENT

DA2020/0270

Construction


Insulation Requirements

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External Walls R1.3, or R1.7 including Contruction
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Project Name
Address

Eagar Home

3 Martin St
Freshwater NSW 2095

Drawing Title:
Elevations - Elevations
South Elevation, East Elevation

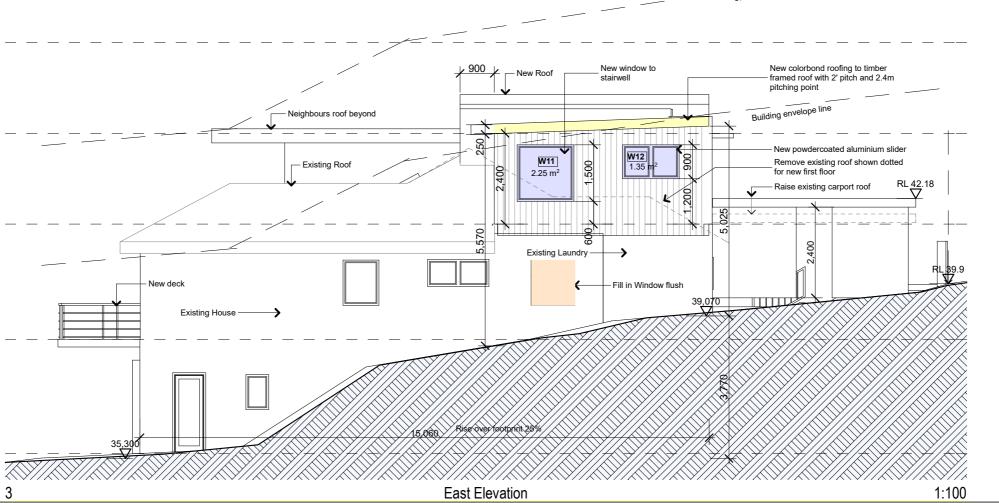Scale: as noted Date: March 2020
Status: DA Checked By: SH
Project No: Drawing No.:
2019 11 DA06

t Date:

16/03/2020



External Finishes Schedule 3 Martin Street, Freshwater March 2020



THIS PLAN IS TO BE READ IN CONJUNCTION WITH THE CONDITIONS OF DEVELOPMENT CONSENT

DA2020/0270

Item	Description	Finish	Colour	Image
Vertical Cladding	Weathergroove150 mm Natural from Weathertex	Olied	ТВА	
Timber Trims	Fascias, timber screens	Dulux super enamel	Resene Half Foundry N39- 006-259	
Doors and Windows	Aluminium external	Gloss	White	
Roof	Existing Tiles		Terracotta	
New Roof	Colorbond	Kliplok 700	Ironstone	
Gutters	Colorbond	Half Round	Ironstone	_

Item	Description	Finish	Colour	Image
External Walls	Rendered brick or FC sheeting	Dulux Render refresh weathershield	Resene Designer White B90-009-260	
External Pavers/Tiles	TBS	Matt, anti slip	Concrete	
Lights	External	Stainless Steel	Charcoal	

Notes/Additional Items


Enter Notes/Additional Items



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DA2020/0270


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Polution Prevention

Use the following measures to prevent pollution on site;

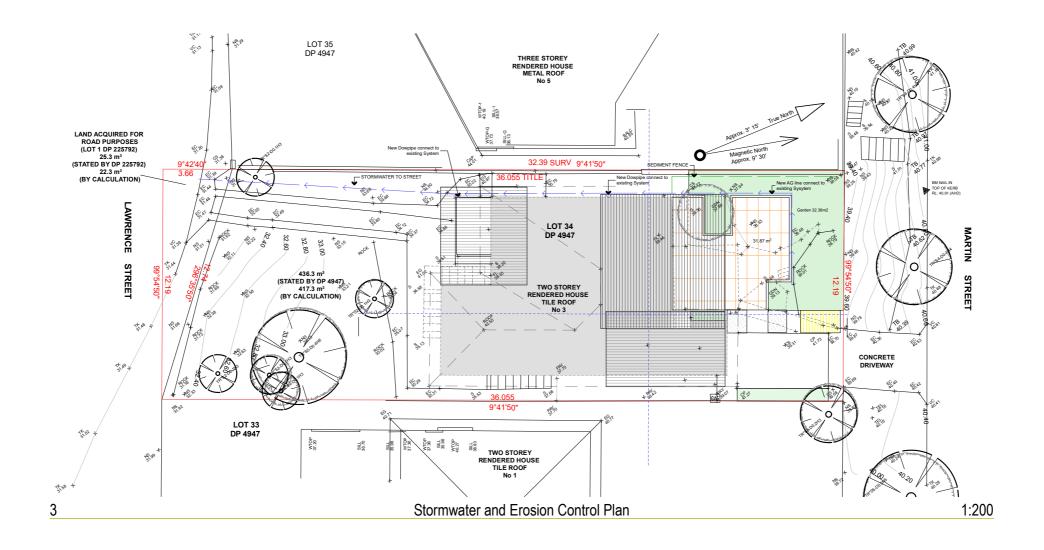- 1. restrict access to one stable entry and exit point
- 2.install and maintain adequate sediment and erosion controls
- 3. preserve grassed area and the maximum cover of natural vegetation by minimising the amount of land disturbed.
- ensure that stockpiles of sand, gravel, soil, and similar materials are located so that the material doesn't spill onto the road or pavement, wash into drainage lines, watercourses or depressions.
- 5. minimise on site vehicle activity during wet weather
- 6. Do not pump or allow any unclean water to enter the stormwater system from excess materials or cleaning tools.
- 7. Sediment fences are to be laid along the contour as much as possible and are to be of suitable geotextile fabric and supported every three metres with star pickets and a lower trench depth of 150mm



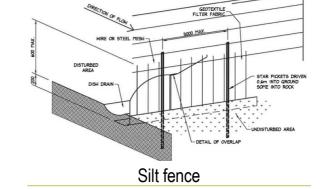

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3 Martin St Freshwater NSW 2095

Drawing Title:
Plans Ground - Stormwater and Erosion Plan
Stormwater and Erosion Control Plan, polution, Silt

letice	
Scale: as noted	Date: March 2020
Status: DA	Checked By: SH
Project No:	Drawing No.:

2019 11

16/03/2020

S01