OLIVARES CASTRO-SYKES HOUSE

SECTION NAME	DRAWING No.	DESCRIPTION
01 DEVELOPMEN	IT APPLICATION	
	A01	COVER PAGE
	A02	SCHEDULES
	A03	SURVEY
	A04	SITE PLAN/WASTE MANAGEMENT PLAN
	A05	SITE ANALYSIS AND LOCATION MAP
	A06	EXISTING DRAWINGS 1
	A07	EXISTING DRAWINGS 2
	A08	EXISTING DRAWINGS 3
	A09	PERSPECTIVES
	A10	STUDY/PARKING LEVEL
	A11	LOWER LEVEL PLAN
	A12	GROUND FLOOR
	A13	ROOF PLAN
	A14	ELEVATION STREET E1
	A15	ELEVATION E2 & E3
	A16	ELEVATION E4, E5 & E6
	A17	SECTION A
	A18	SECTION B AND C
	A19	BASIX 1
	A20	BASIX 2
	A21	BASIX 3
	A22	SHADOWS JUNE 21-9AM
	A23	SHADOWS JUNE 21-12NOON
	A24	SHADOWS JUNE 21-3PM
	A25	LANDSCAPE CALCULATION
	A26	FINISHES SCHEDULE





DEVELOPMENT APPLICATION A

BASIX:

ROOFS:

SPECIFIED.

STORMWATER: REFER TO STORMWATER DRAWINGS FOR DETAILS.

STRUCTURAL: REFER TO STRUCTURAL DRAWINGS FOR DETAILS.

GEOTECHNICAL: REFER TO GEOTECHNICAL REPORT FOR DETAILS.

ARBORIST: REFER TO ARBORIST REPORT FOR DETAILS.

INSULATION: REFER TO SPECIFICATION FOR FLOOR, WALL, ROOF ACOUSTIC AND THERMAL INSULATION.

MAYA OLIVARES CASTRO AND LUKE SYKES 9 CAREEBONG ROAD FRENCHS FOREST NSW 2086

REFER TO BASIX FOR SUSTAINABILITY REQUIREMENTS.

ROOF STRUCTURE: TIMBER FRAMED ALL ROOFS TO BE SARKED AS SPECIFIED. ALL ROOFS CONNECTED TO STORMWATER SYSTEM. NEW GUTTERS AND DOWNPIPES IN LOCATIONS AS

GENERAL CONSTRUCTION NOTES

FLOOR SCH	LOOR SCHEDULE	
CODE ID	DESCRIPTION	
F-CON1	NEW concrete structure. As per engineer's detail.	
F-D1	NEW timber structure with NEW timber decking. As per	
	engineer's detail.	
F-ECON	EXISTING concrete slab, keep and protect.	
F-ET1	EXISTING concrete slab, with NEW floorboards.	
	Timber and finish as specified.	
F-ETL1	EXISTING concrete slab, with NEW tiles. Waterproof as required.	
F-T1	NEW timber floor structure with NEW floorboards. Timber and finish as specified.	
F-TL1	NEW (INTERNAL) timber floor structure with NEW tiles. Waterproof as required.	

ROOF SCHEDULE		
CODE ID	DESCRIPTION	
DP	NEW downpipe, as specifie	
R-M1	NEW framed roof structure custom orb) metal sheet, a engineer's detail.	

WALL SCH	WALL SCHEDULE	
CODE ID	DESCRIPTION	
W-BR1	NEW brick wall with NEW render and paint as	
	specificed. As per engineers detail.	
W-EB	EXISTING face brick wall. Make good and patch new	
VV-ED	openings as required.	
W-EBR	EXISTING brick wall. Provide NEW render and paint	
	finish.	
	NEW framed wall structure with NEW FC (LINEA	
W-LW1	SCYON OR EQUIVALENT) cladding with NEW paint,	
	as specified.	

WINDOW, DOOR & SKYLIGHT SCHED		
CODE ID	DESCRIPTION	
D01	(D01, D02 etc) NEW alu Powdercoated. Refer to B/	
W01	(W01,W02etc) NEW alu Powdercoated. Refer to B/	

		DEVELOPMENT	DRAGONFLY	Architect - Catherine Seeto - Reg. 8345 14 Cook Street, Forestville 2087 NSW T: 0421 846 288 E: studio@dfarch.com.au	9 CAREEBONG ROAD FRENCHS FOREST NSW 2086
		APPLICATION	ARCHITECTS	www.dragonflyarchitects.com.au SCALE : NTS DATE PRINTED : 1/04/2 DRAWN BY : ES	
A DEVELOPMENT APPLICATION	1/04/2025	DOCUMENTS ARE NOT TO BE DISTRIBUTED OR SHARED WITH OTHER PARTIES WITHOUT THE PRIOR	ABN 78 158 837 962	CLIENT: MAYA OLIVARES CAS AND LUKE SY The Architect retains copyright. Authority should be requested for any reproductions.	KES DFA2408-A02
ID DESCRIPTION	DATE	CONSENT OF THE ARCHITECT.		Should be requested for any reproductions.	A

fied. re with NEW corrugated (e.g. as specified. As per

DULE

uminium framed door. BASIX requirements. uminium framed window. BASIX requirements.

NOTES:

BOUNDARY IDENTIFICATION HAS BEEN UNDERTAKEN WALL TO BOUNDARY DIMENSIONS SHOWN HEREON MUST NOT BE JSED FOR CONSTRUCTION.

ISG NORTH APPROX. TRUE NORTH

IF CONSTRUCTION IS INTENDED TO BE UNDERTAKEN ON OR ADJACE TO PROPERTY BOUNDARIES THE BOUNDARIES OF THE LAND MUST BE MARKED OR THE BUILDING SETOUT.

THIS SURVEY IS FOR DESIGN PURPOSES OF THE SUBJECT LAND ONLY
THIS PLAN MUST NOT BE USED FOR ANY OTHER MATTER, PURPOSE OR
CONSTRUCTION SETOUT.

TREE SIZES ARE ESTIMATES ONLY. THIS PLAN HAS BEEN PREPARED FOR THE EXCLUSIVE USE OF MAYA OLIVARES CASTRO AND LUKE SYKES.

RELATIONSHIP OF IMPROVEMENTS TO BOUNDARIES IS DIAGRAMMATIC ONLY. WHERE OFFSETS ARE CRITICAL THEY SHOULD BE CONFIRMED BY FURTHER SURVEY.

EXCEPT WHERE SHOWN BY DIMENSION LOCATION OF DETAIL WITH RESPECT TO BOUNDARIES IS INDICATIVE ONLY.

I. CAN LO UN TO BUSINEMED IS INDURINE ONLY. O NUY VISIBLE SERVICES HAVE BEEN LOCATED. UNDERGROUND SERVICES HAVE NOT BEEN LOCATED. BEFORE YOU DIG AUSTRALIA (www.syda.com.au) SHOULD BE USED AND A FULL UTILITY INVESTIGATION, BEFORE CARRYING OUT ANY CONSTRUCTION ACTIVITY IN OR NEAR THE SURVEYED AREA.

• SEWER MAIN PLOTTED FROM SYDNEY WATER SEWER DIAGRAM. LOCATION SHOULD BE MARKED ON SITE IF CRITICAL.

CRITICAL SPOT LEVELS SHOULD BE CONFIRMED WITH SURVEYOR.

CONTOURS SHOWN DEPICT THE TOPOGRAPHY. THEY DO NOT REPRESENT THE EXACT LEVEL AT ANY PARTICULAR POINT. ONLY SPOT LEVELS SHOULD BE USED FOR CALCULATIONS OF QUANTITIES WITH CAULIS SHOULD BE USED FOR CALCULATIONS OF QUANTITIES WITH

CONTOUR INTERVAL - 0.5 metre. - SPOT LEVELS SHOULD BE ADOPTED POSITION OF RIDGE LINES ARE DIAGRAMMATIC ONLY (NOT TO SCALE).

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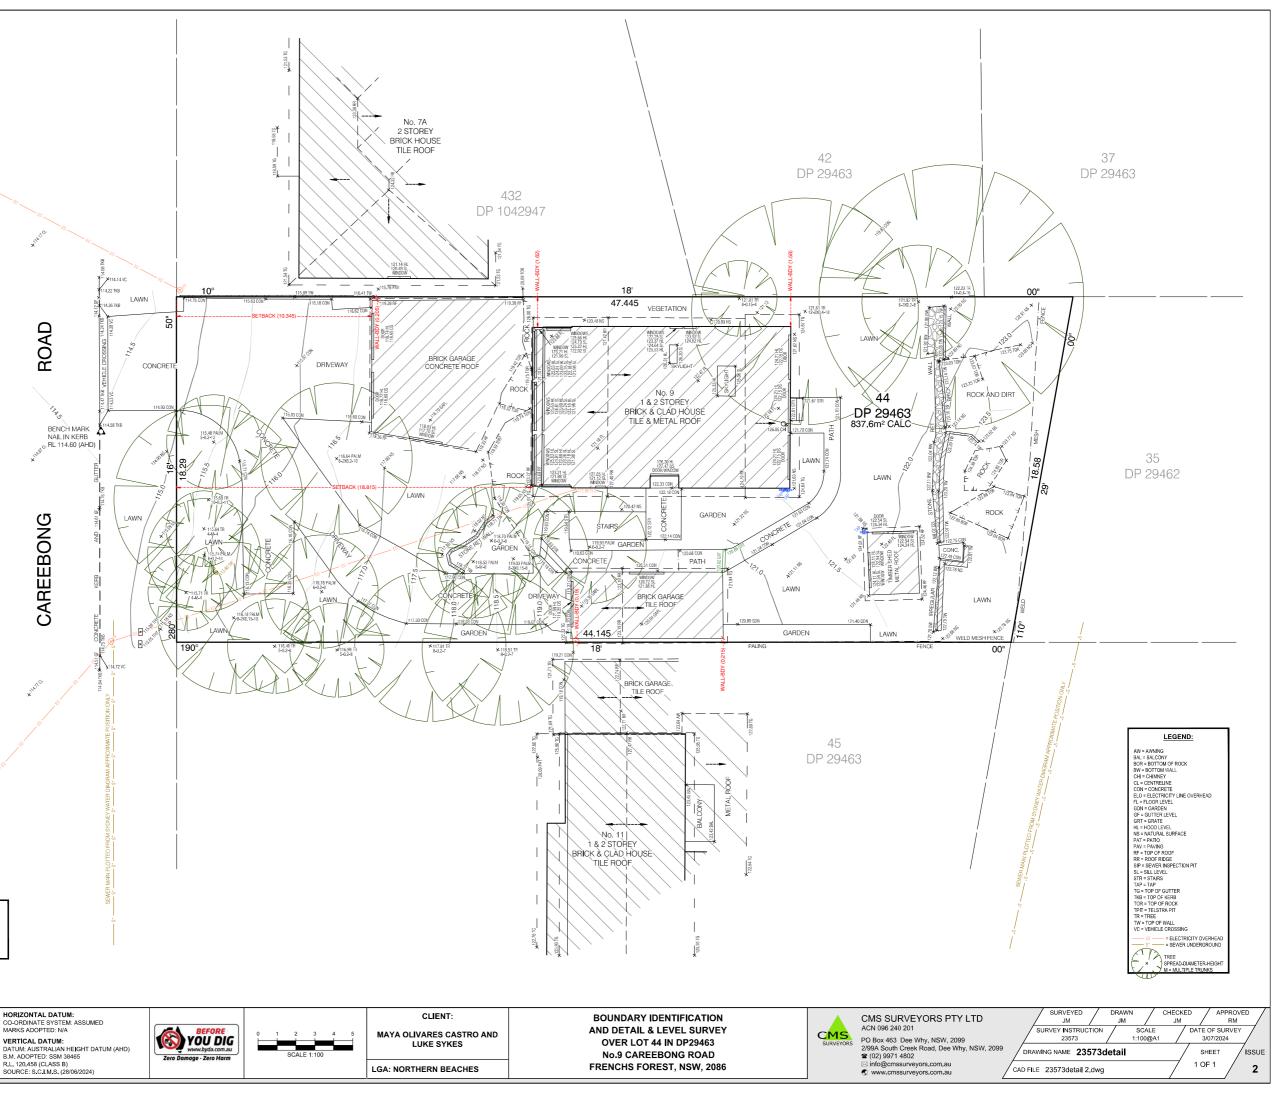
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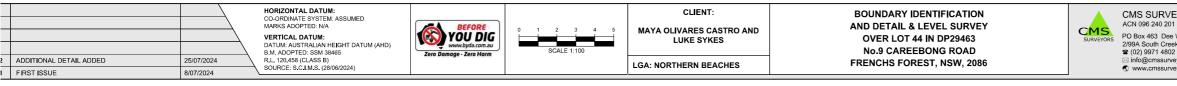
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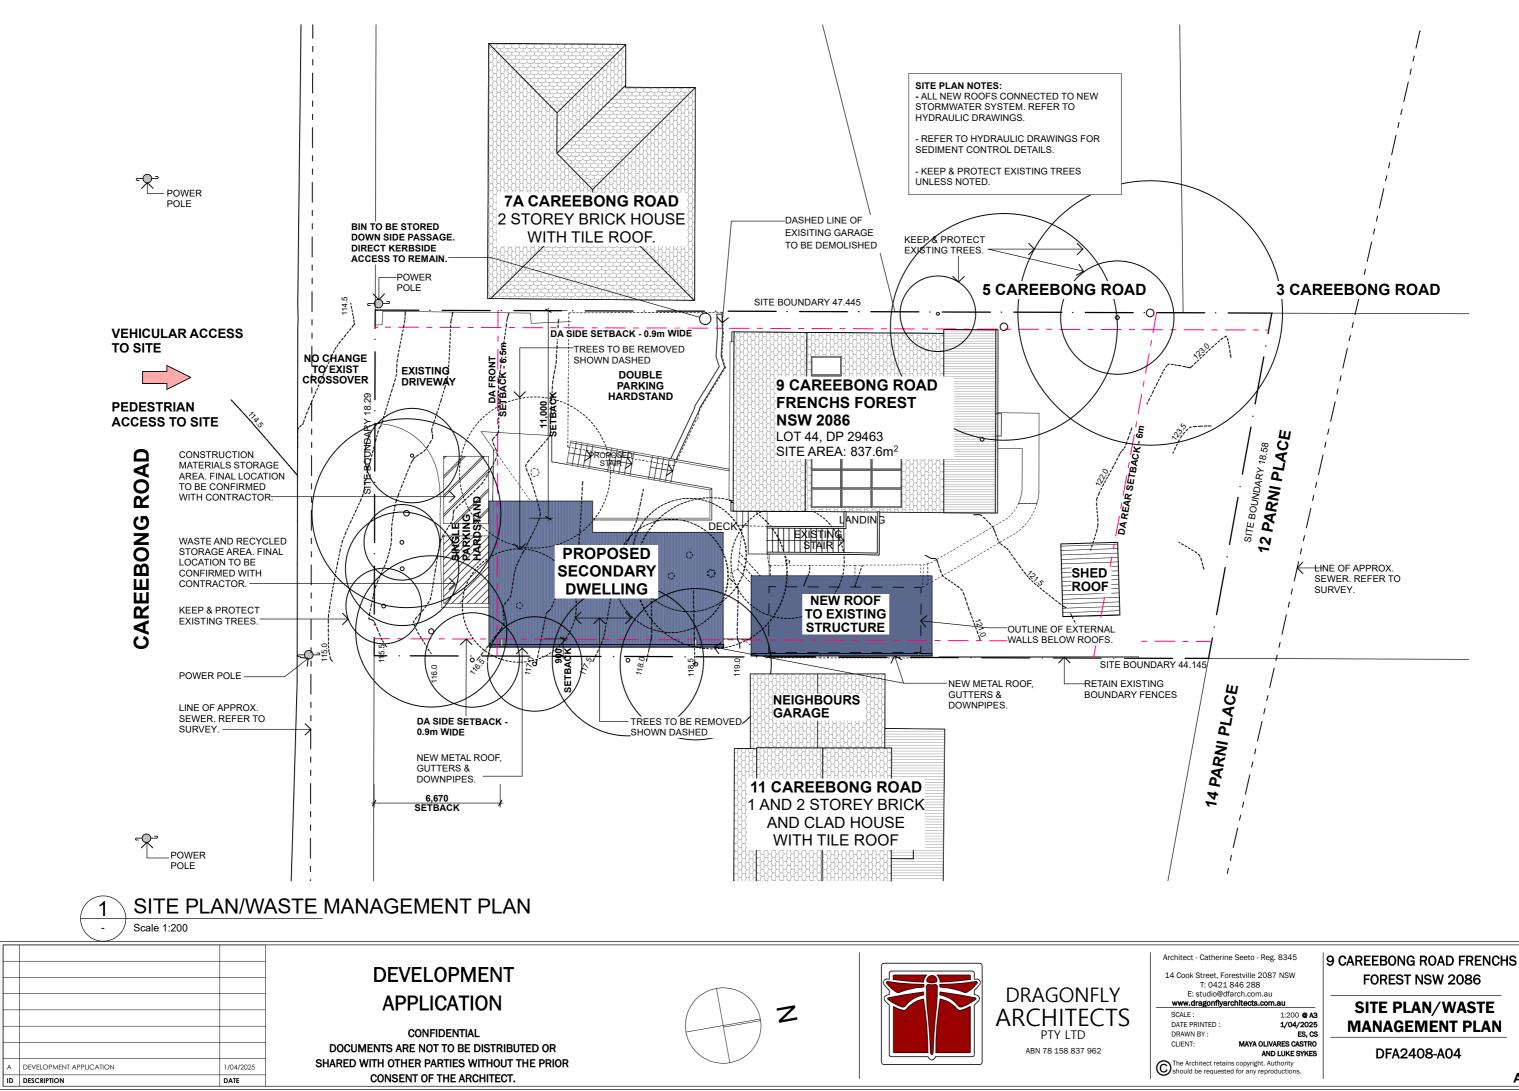
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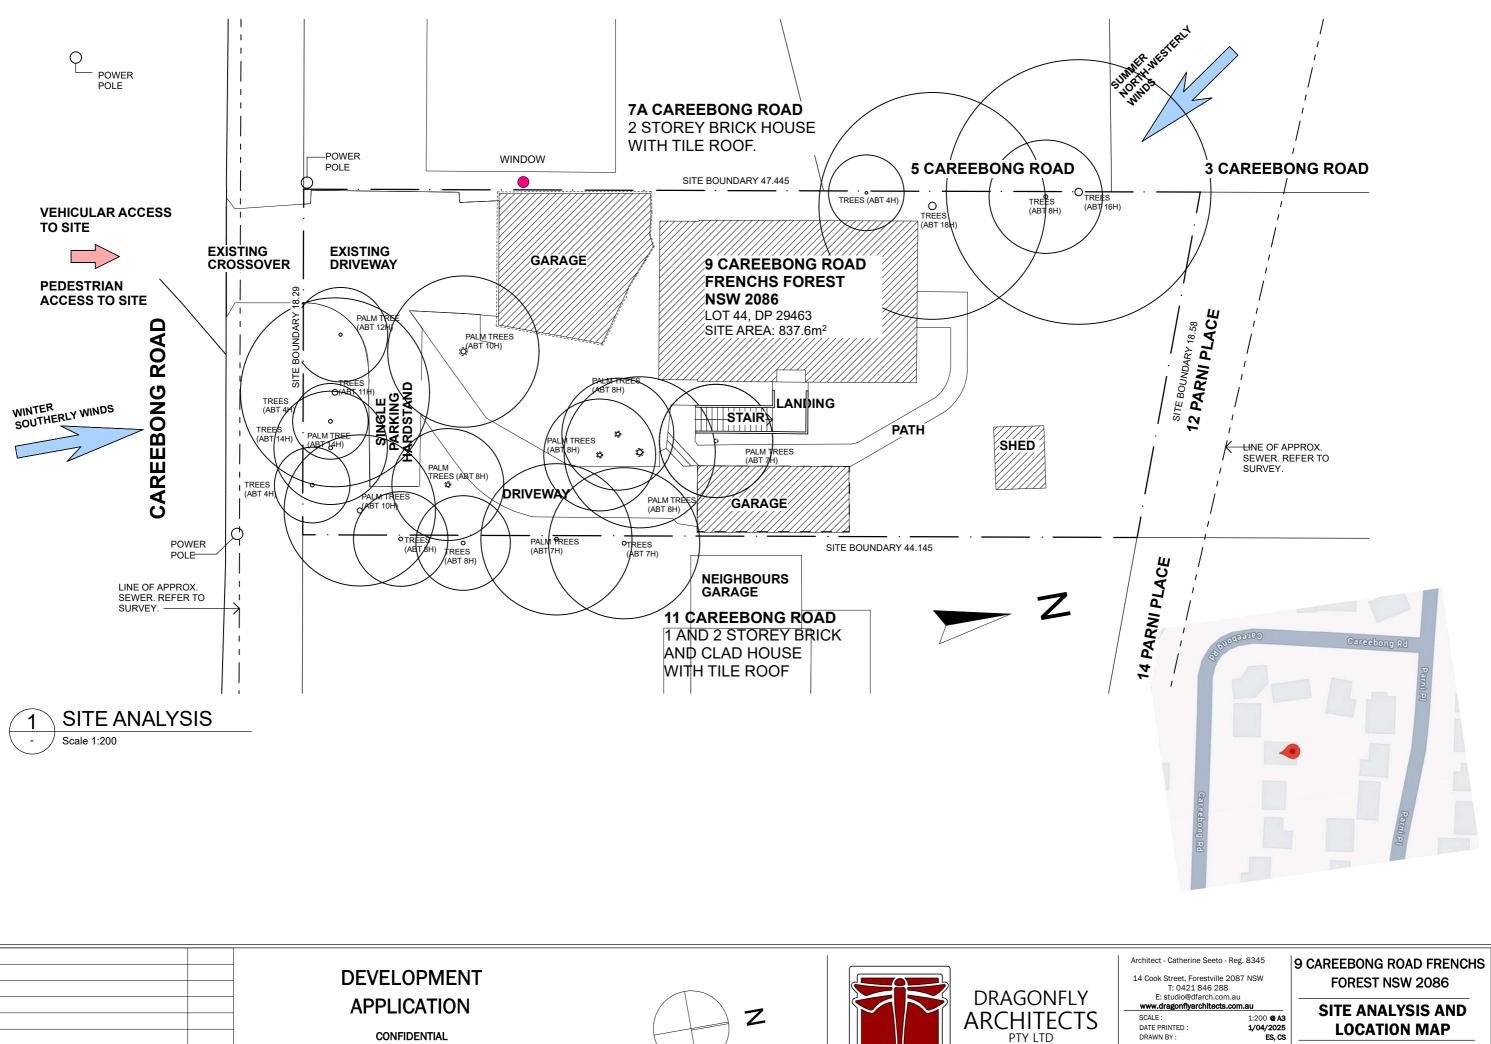
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TITLE INDICATES THAT LOT 44 IN D.P.29463 IS SUBJECT TO: RESERVATIONS AND CONDITIONS IN THE CROWN GRANT(S). LAND EXCLUDES MINERALS BY THE CROWN GRANT OF PORTION 1598 LAND EAULUPES MINIERALS BT THE GROWN GROWT OF TO REAL 1999 H405033 COVENANT (NOT INVESTIGATED) RIGHT OF CARRIAGEWAY APPURTENANT TO THE PART OF THE LAND FORMERLY IN OL 6921 FOL 50 AFFECTING THE LAND SHOWN SO BURDENED IN DP29463










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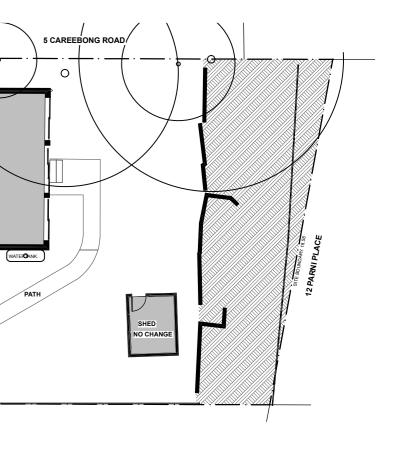
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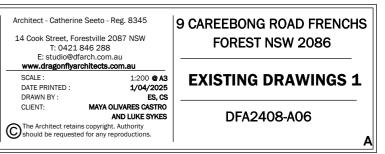
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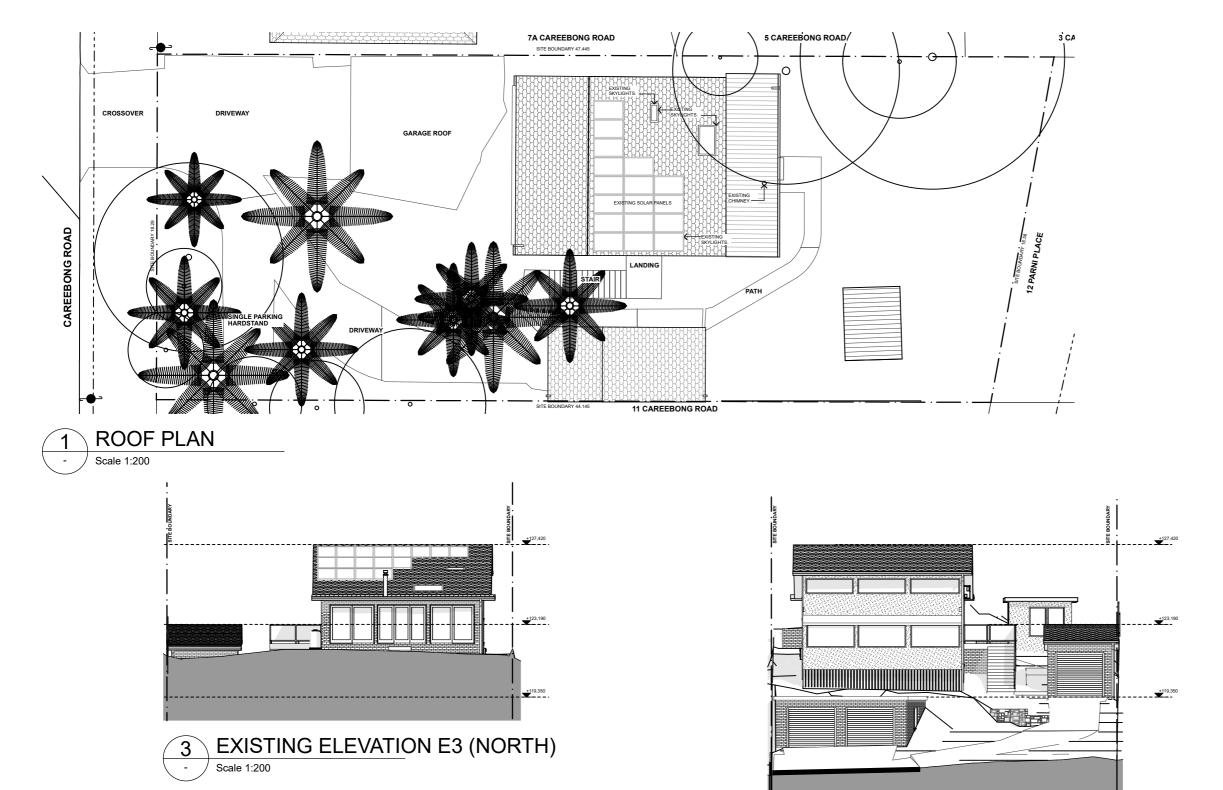
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AND LUKE SYKES







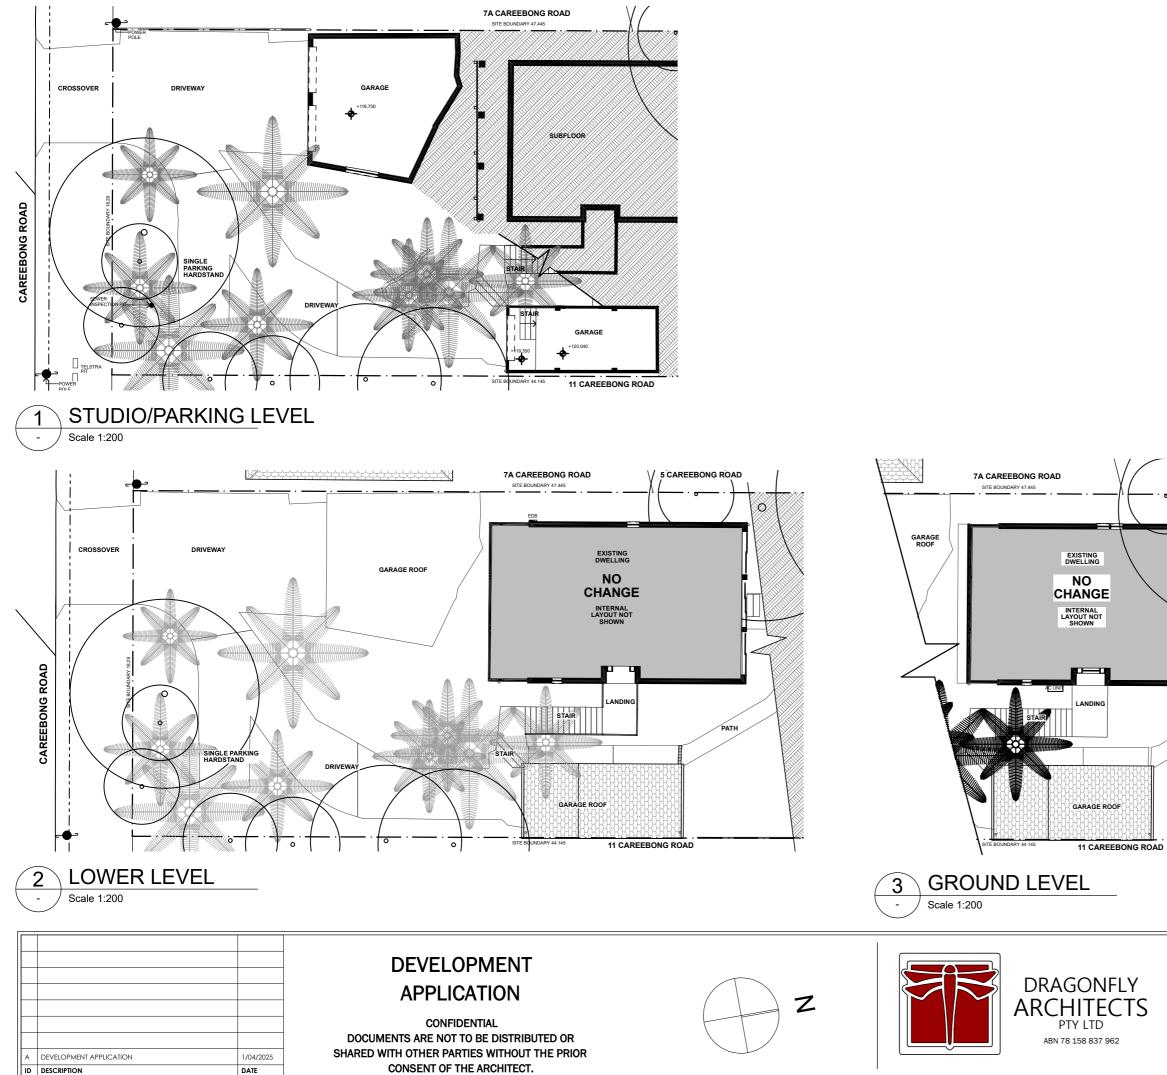



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ID	DESCRIPTION	DATE	CONSENT OF THE ARCHITECT.		 	<u> </u>

EXISTING ELEVATION E1 (SOUTH)

2

Scale 1:200

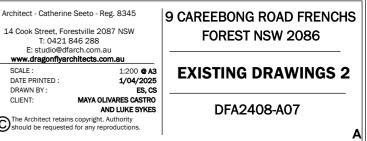

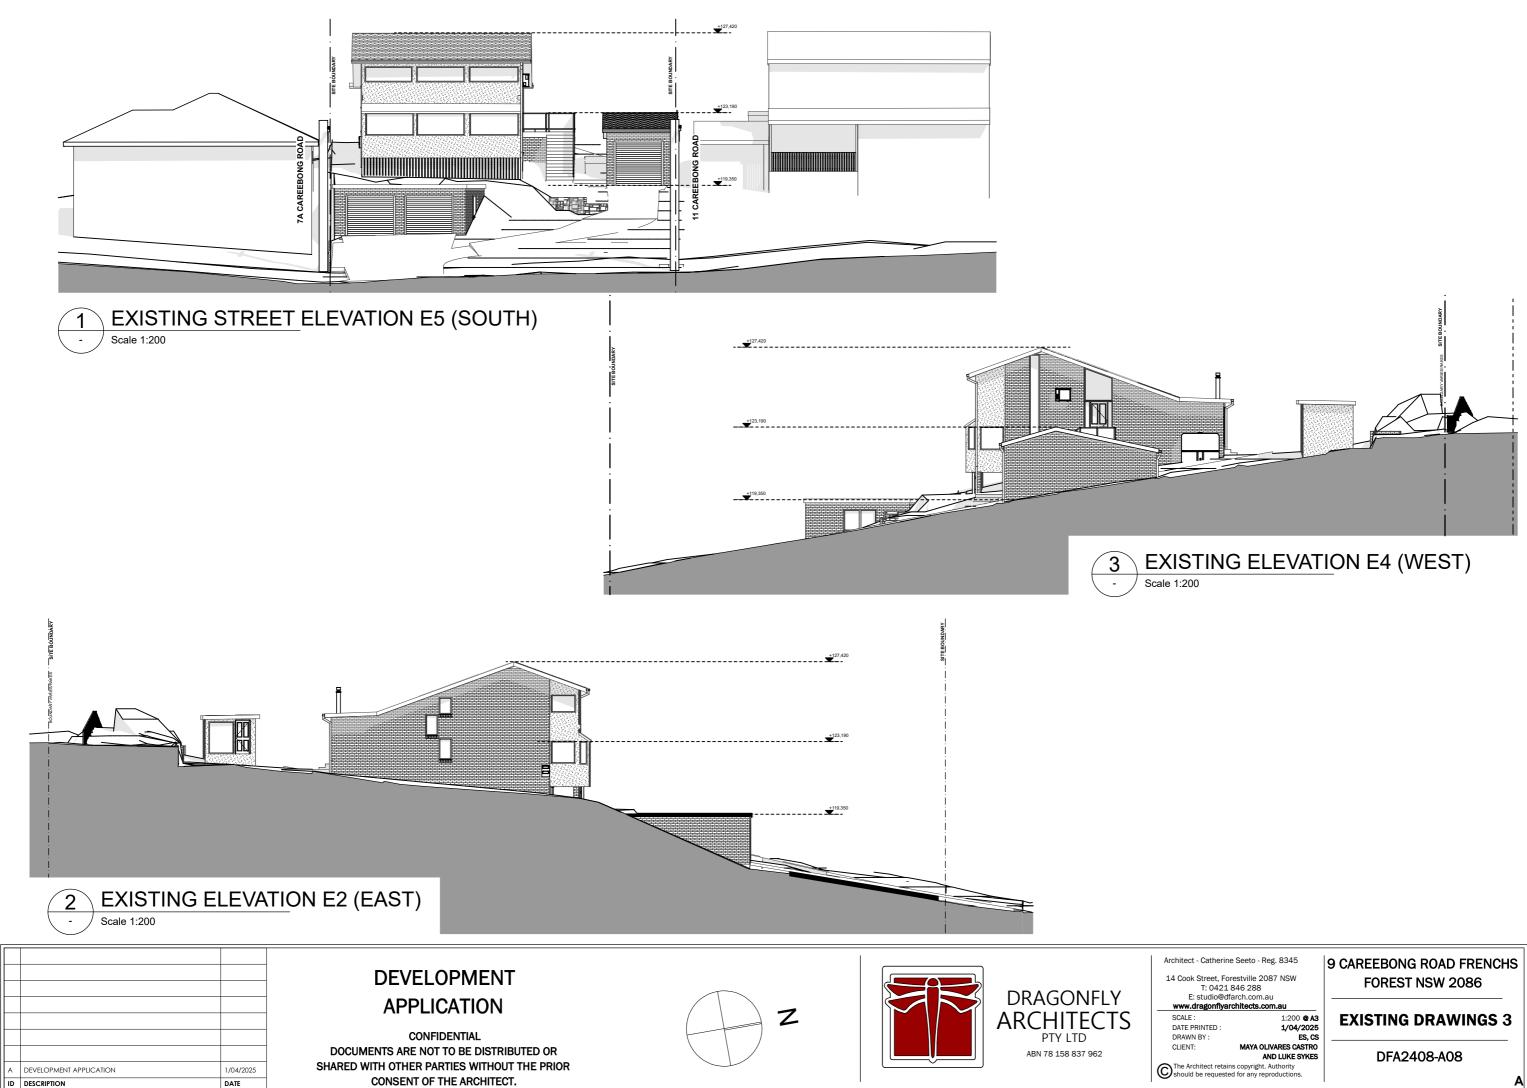







2 FRONT VIEW 2

1 FRONT VIEW 1




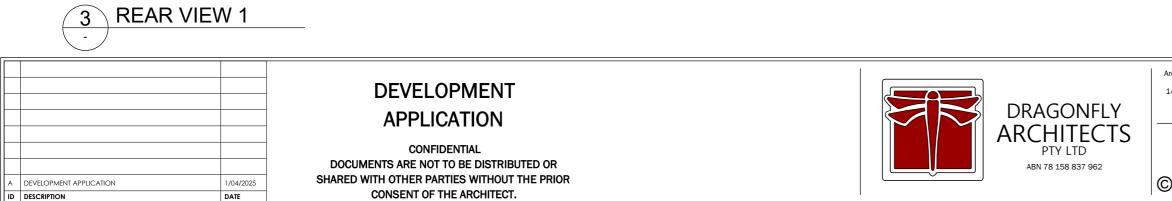



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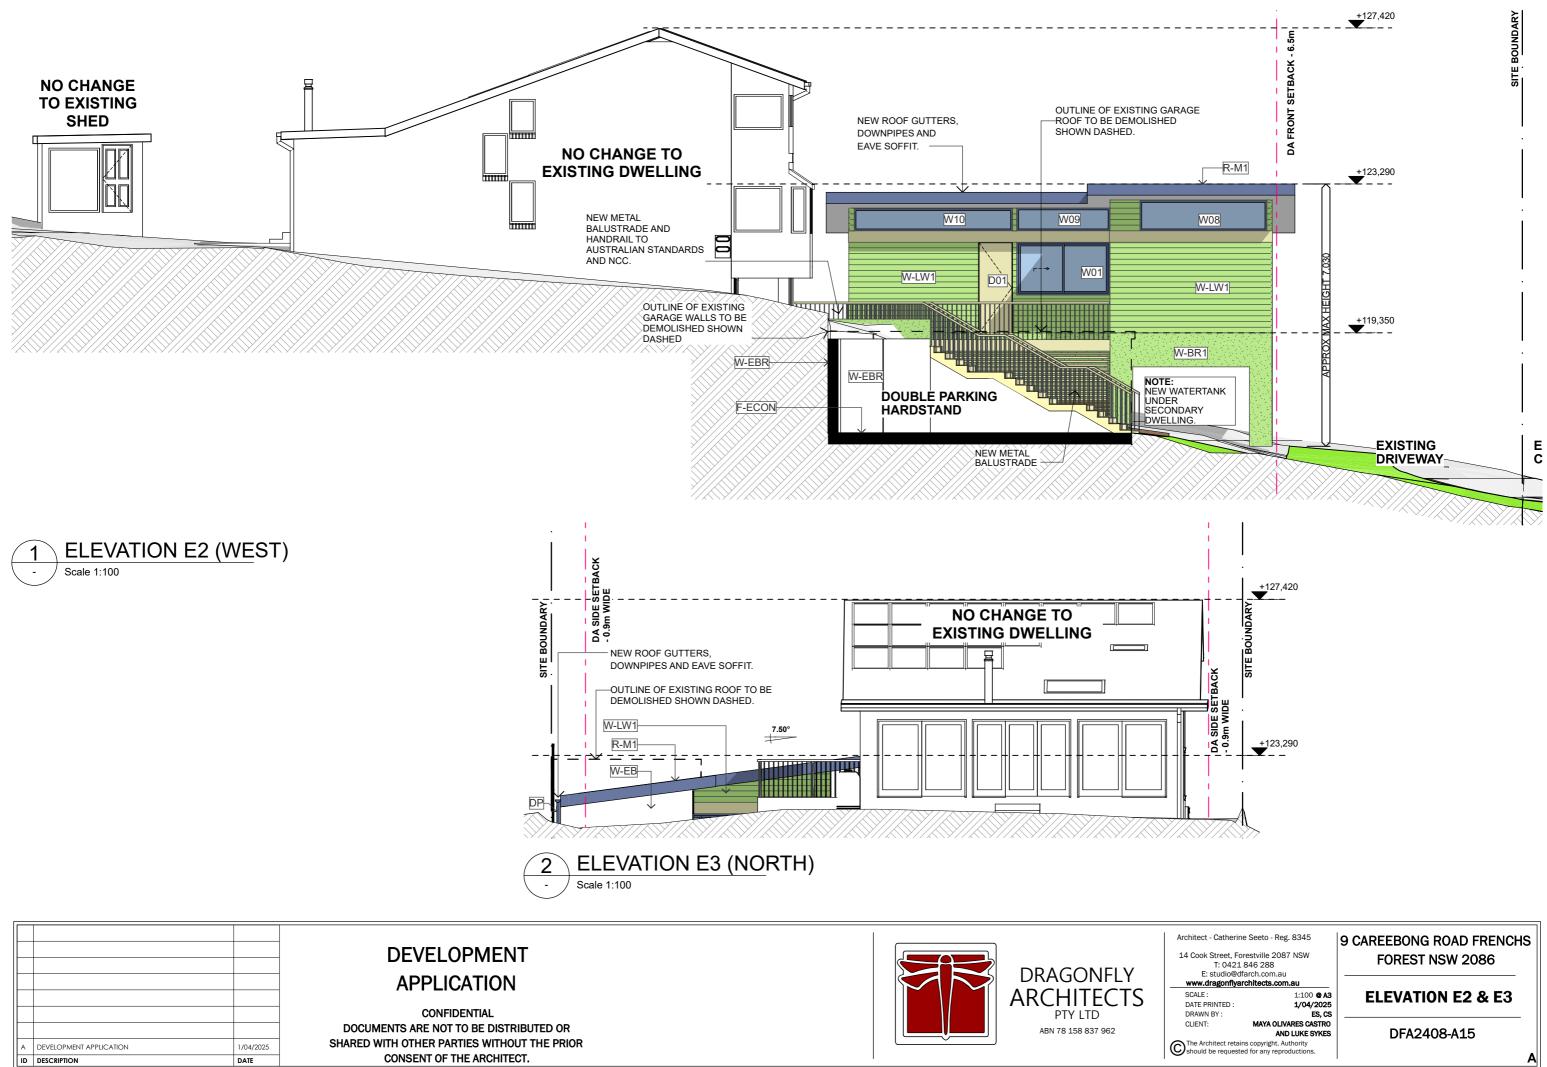


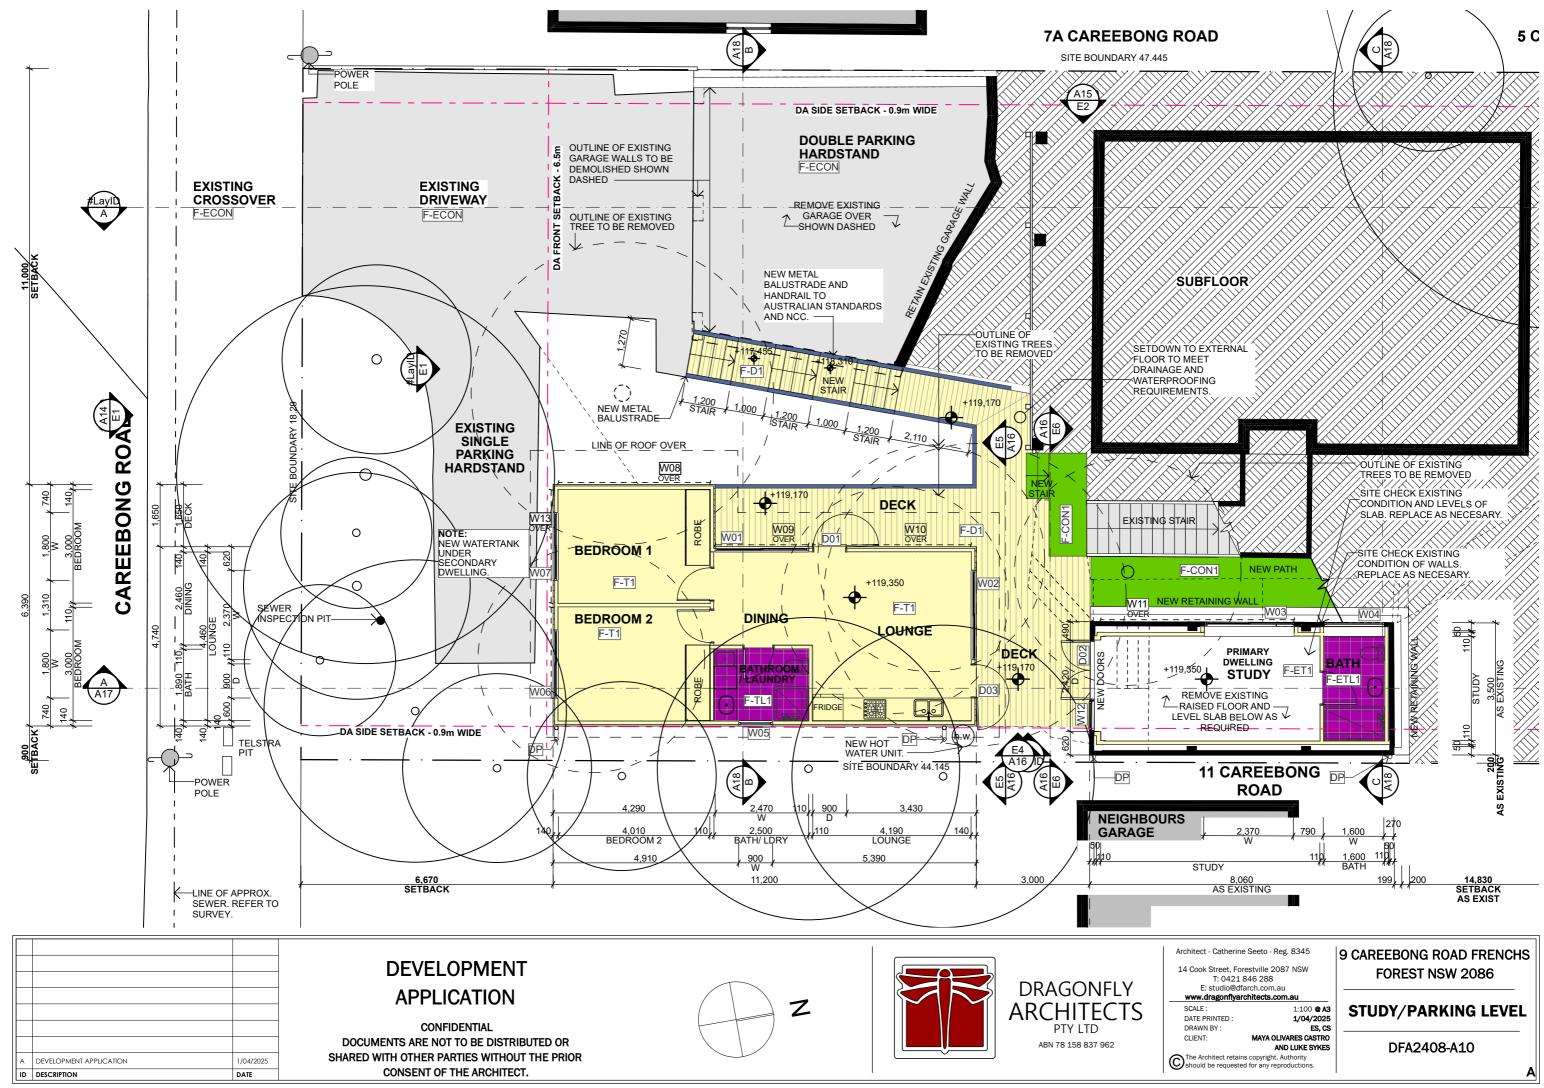

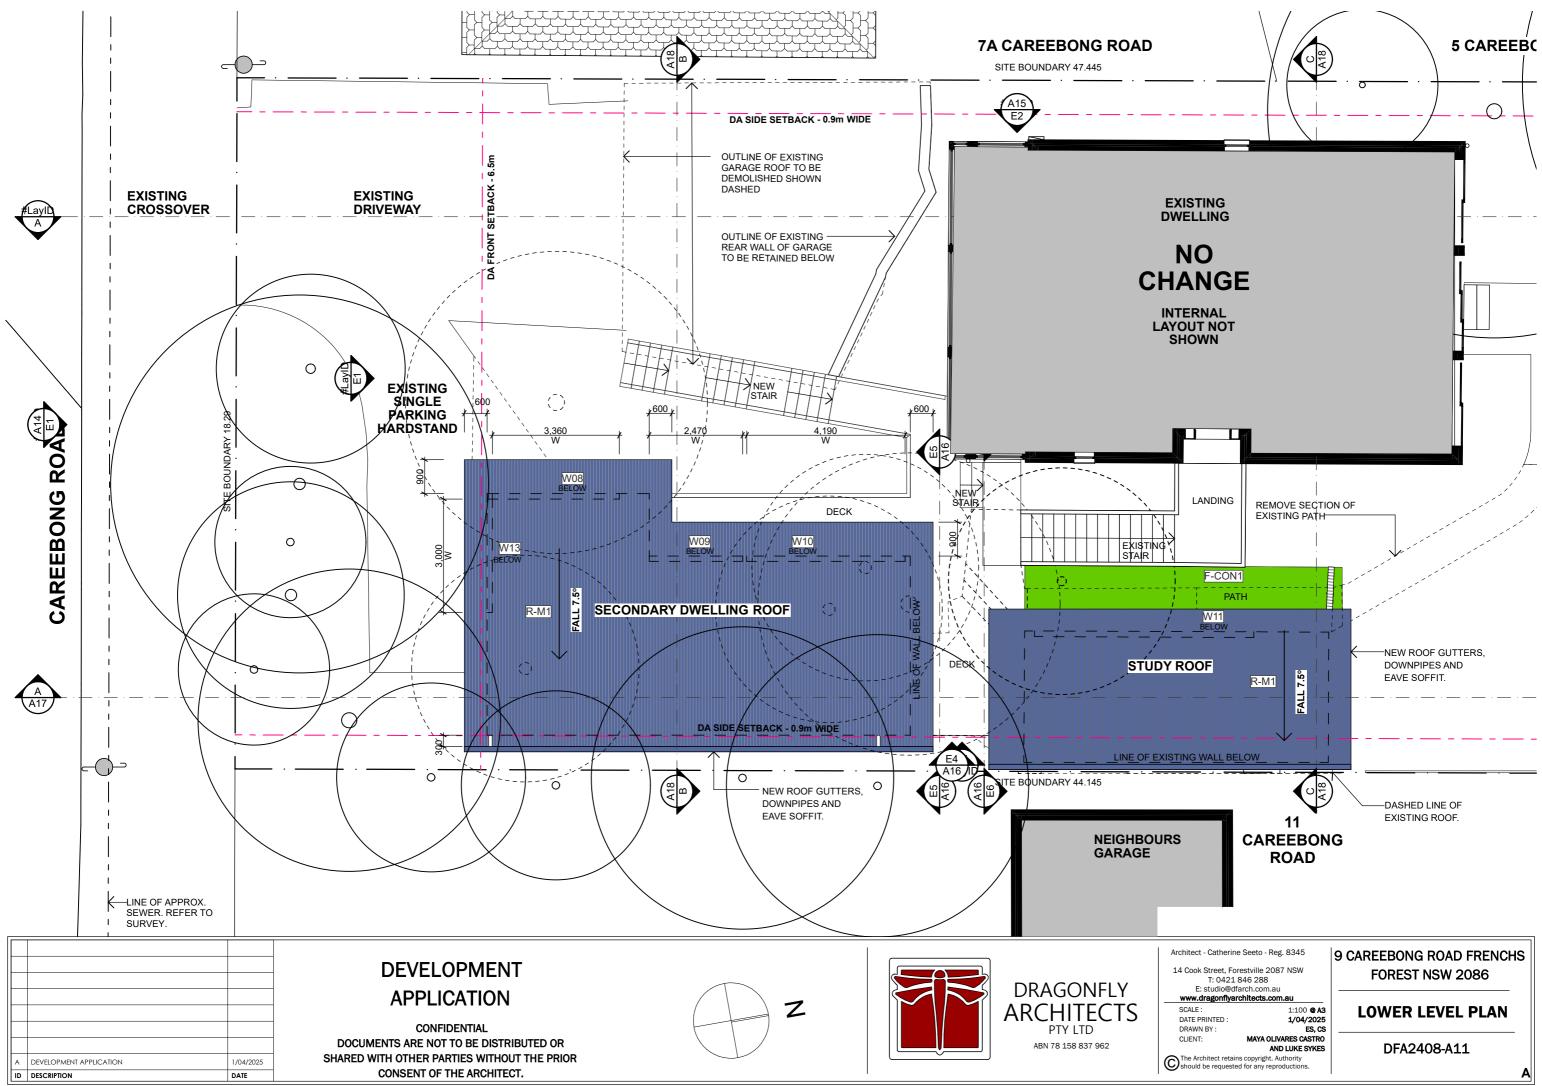


STREET ELEVATION E1 (SOUTH)

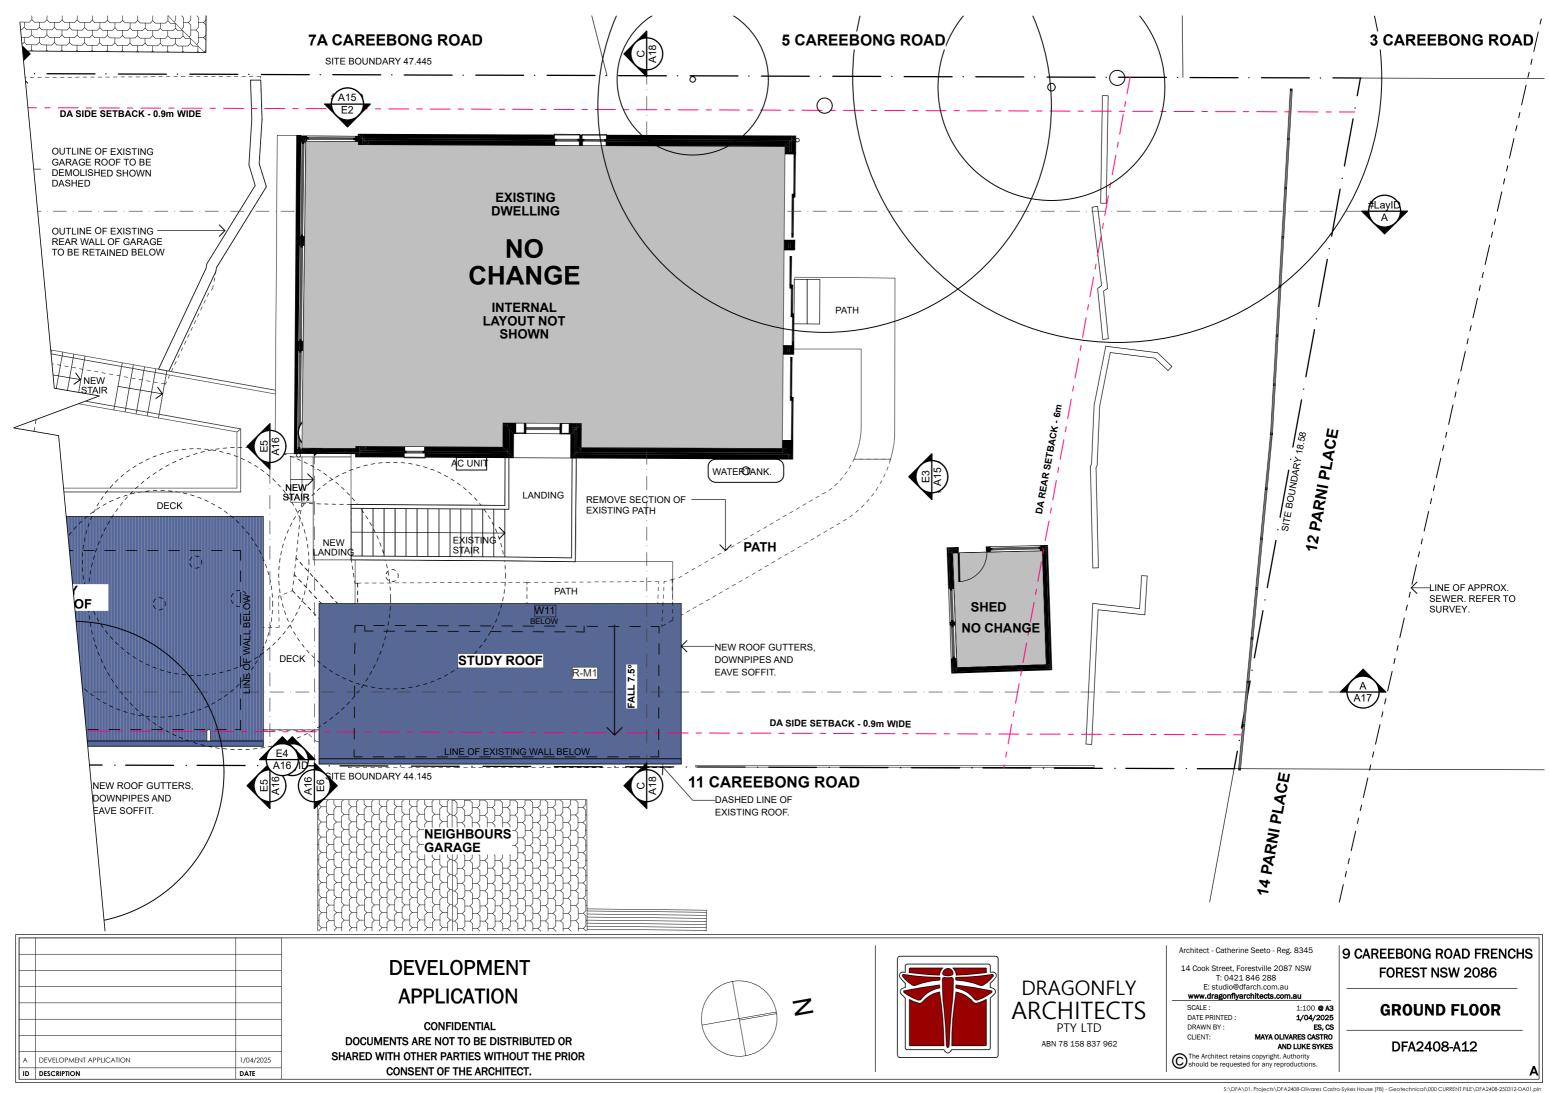


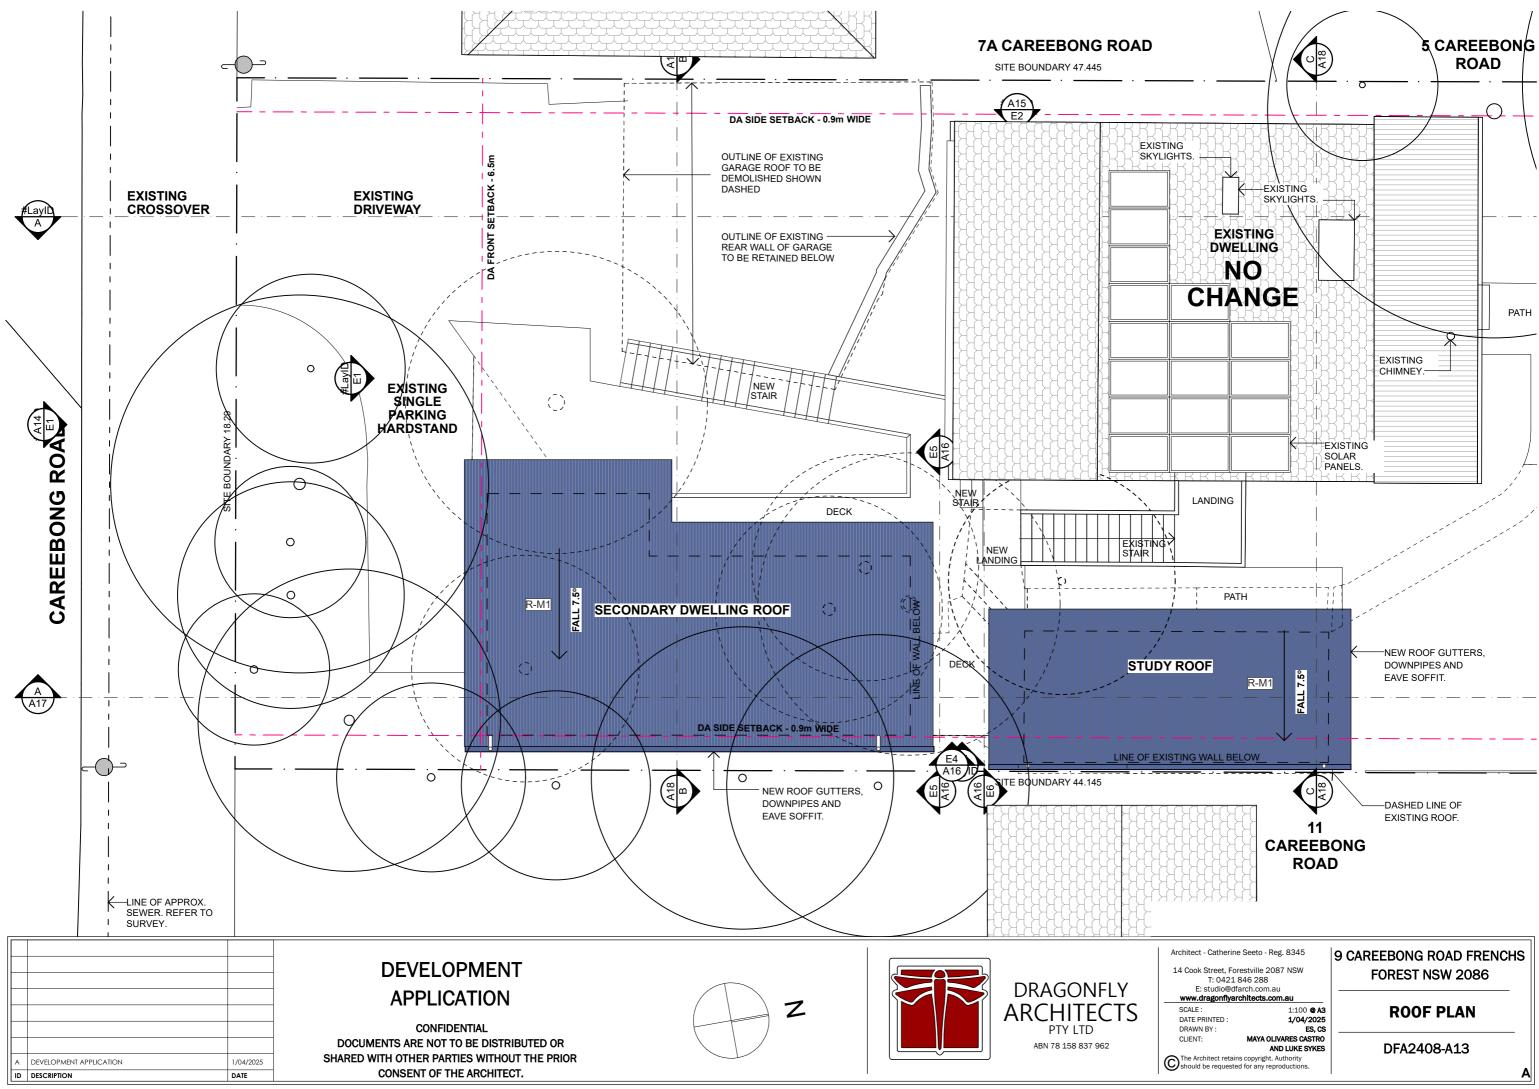




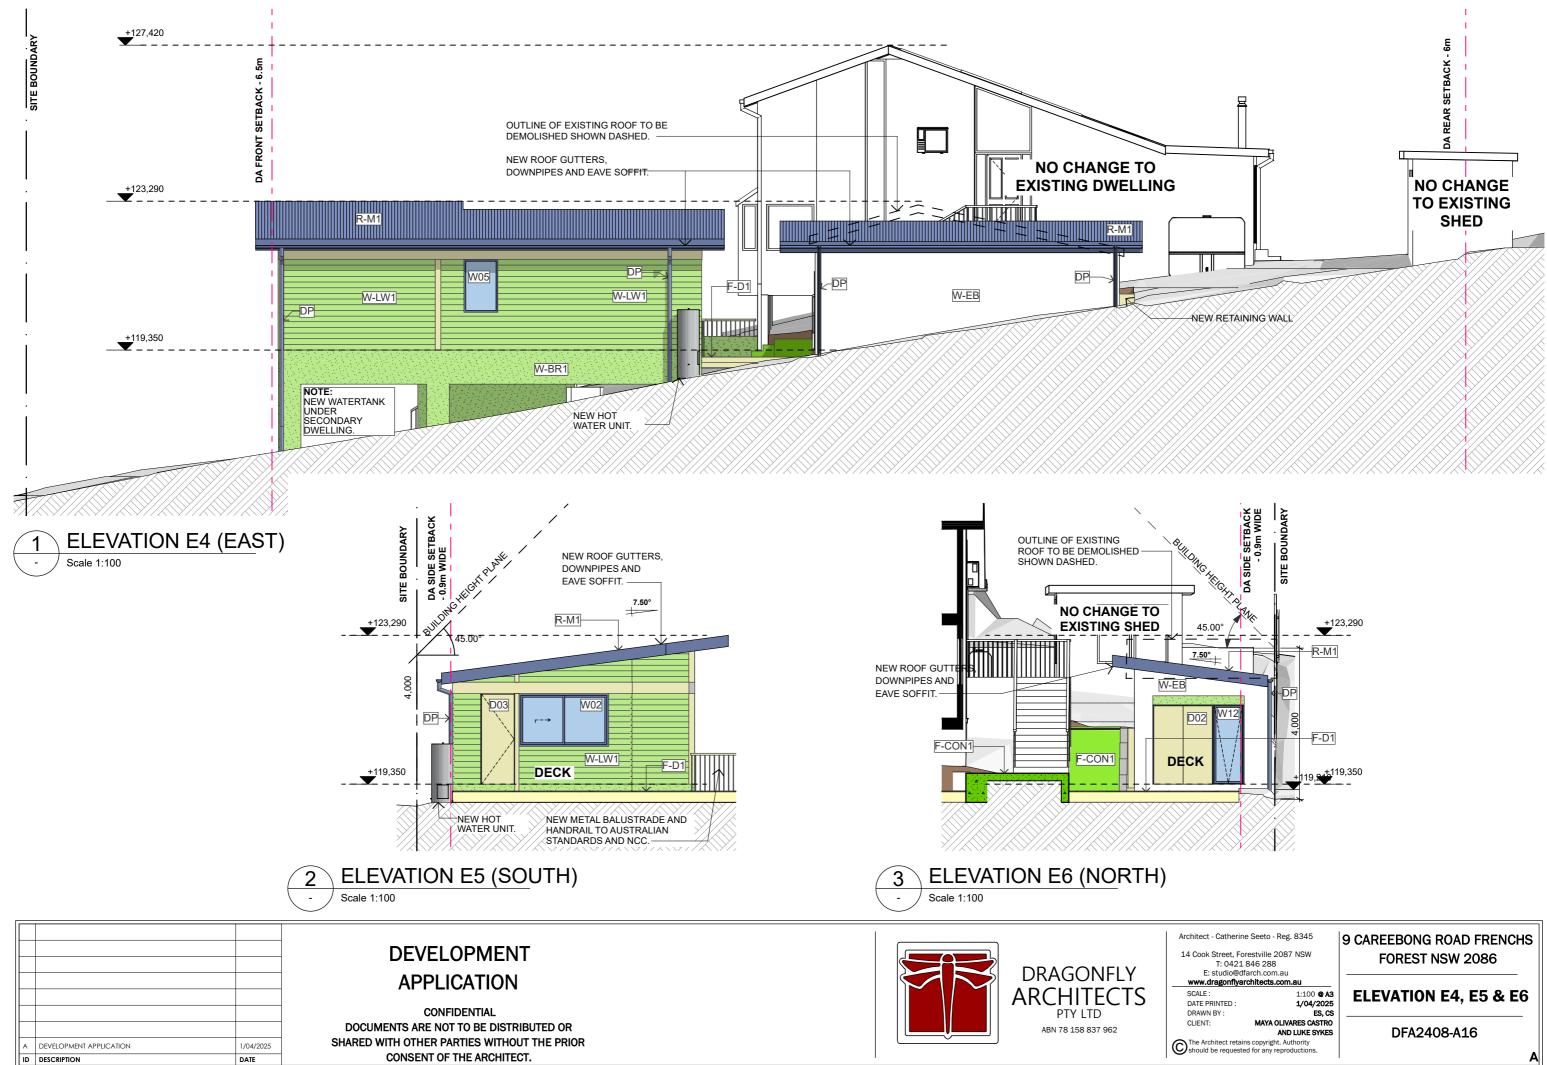


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Building Sustainability Index www.basix.nsw.gov.au

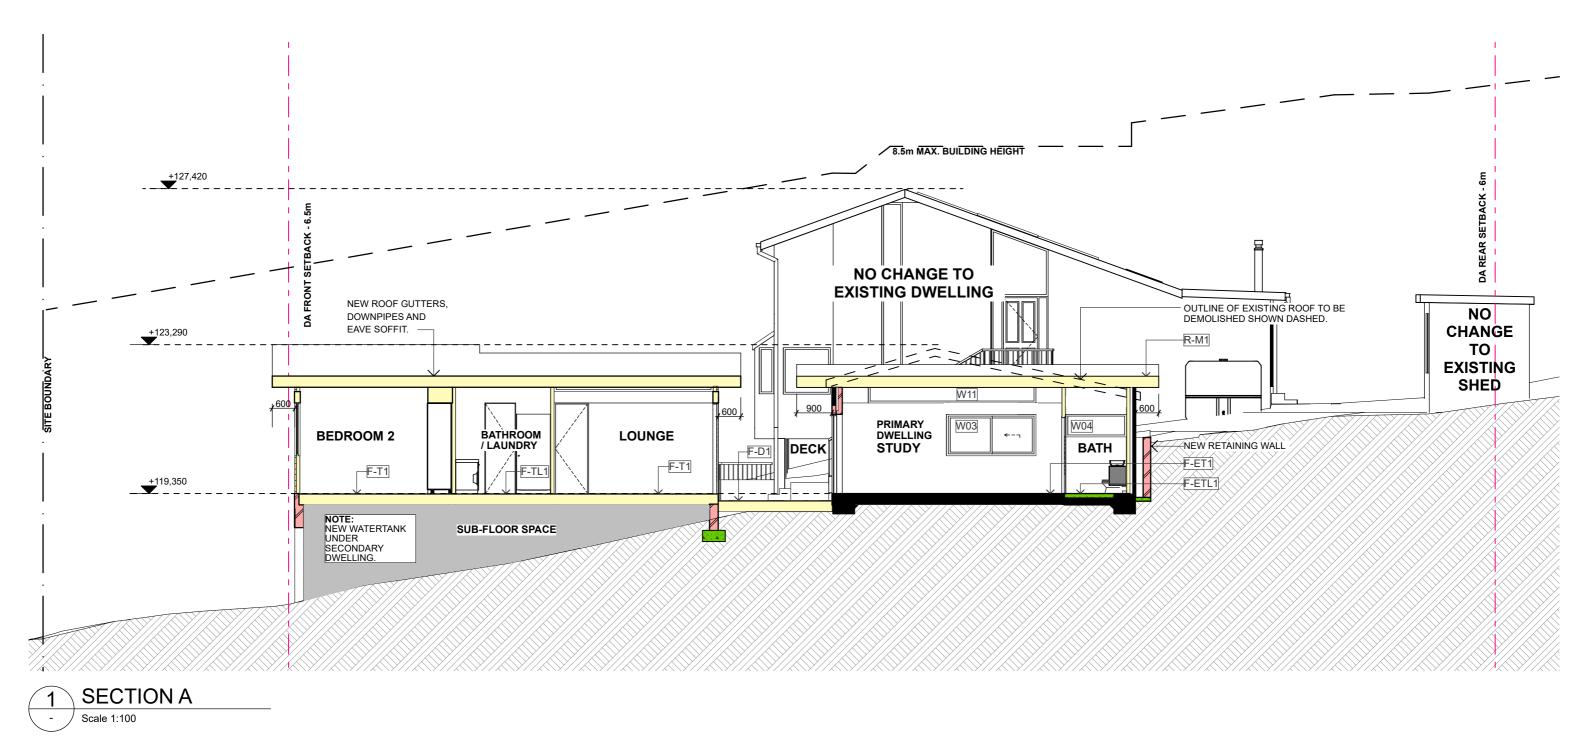Project summary						
Project name	Granny Flat Project					
Street address	9 CAREEBONG Road F 2086	9 CAREEBONG Road FRENCHS FOREST 2086				
Local Government Area	Northern Beaches Coun	cil				
Plan type and plan number	Deposited Plan DP2946	3				
Lot no.	44					
Section no.	-					
Project type	dwelling house (detache	dwelling house (detached) - secondary dwelling				
No. of bedrooms	2	2				
Project score						
Water	46	Target 40				
Thermal Performance	Pass	Target Pass				
Energy	100	Target 68				
Materials	20	Target n/a				
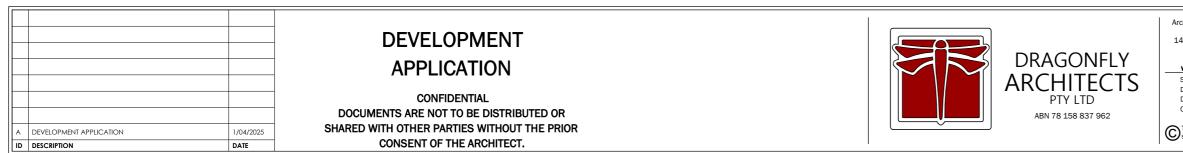
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Target 40

Target Pass

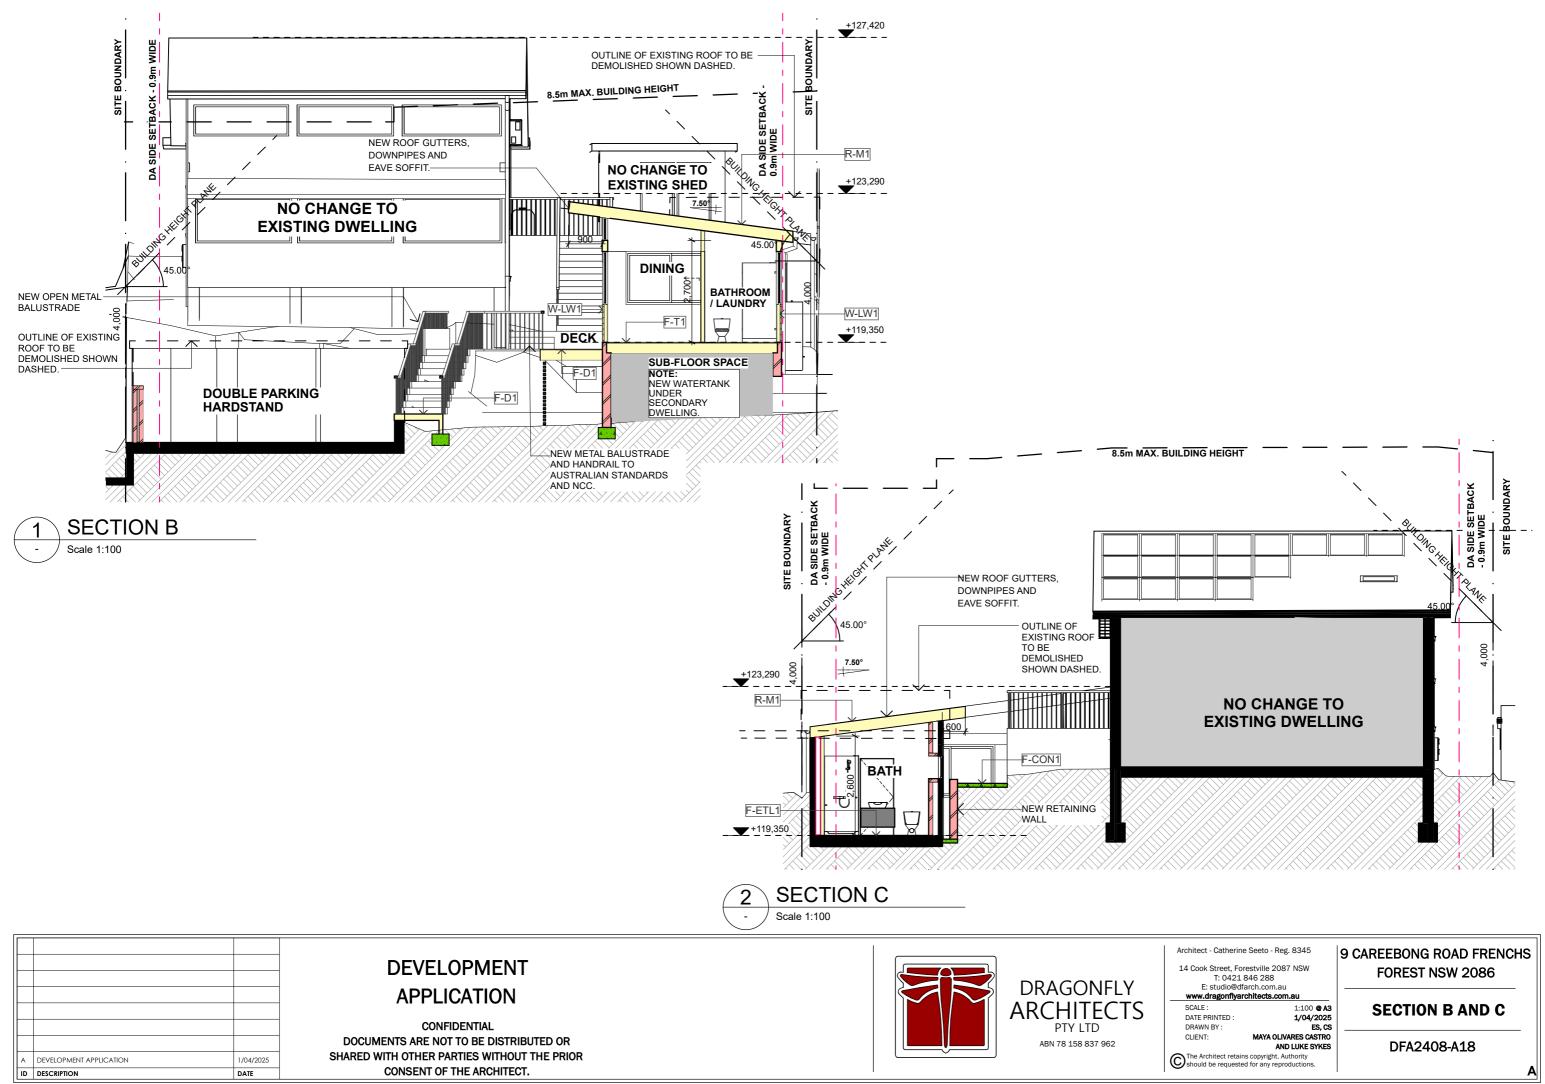Target 68

Target n/a

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Schedule of BASIX commitments

The com develop

Water Commitments	Show on DA plans	Show on CC/CDC plans & specs	Certifier check
Landscape			
The applicant must plant indigenous or low water use species of vegetation throughout 330 square metres of the site.	~	~	
Fixtures			
The applicant must install showerheads with a minimum rating of 4 star (> 6 but <= 7.5 L/min plus spray force and/or coverage tests) in all showers in the development.		~	~
The applicant must install a toilet flushing system with a minimum rating of 6 star in each toilet in the development.		v	~
The applicant must install taps with a minimum rating of 6 star in the kitchen in the development.		J	
The applicant must install basin taps with a minimum rating of 6 star in each bathroom in the development.		~	
Alternative water			
Rainwater tank			
The applicant must install a rainwater tank of at least 3000 litres on the site. This rainwater tank must meet, and be installed in accordance with, the requirements of all applicable regulatory authorities.	~	~	~
The applicant must configure the rainwater tank to collect rain runoff from at least 122.07 square metres of the roof area of the development (excluding the area of the roof which drains to any stormwater tank or private dam).		~	~
The applicant must connect the rainwater tank to:			1
all toilets in the development		.	u
 at least one outdoor tap in the development (Note: NSW Health does not recommend that rainwater be used for human consumption in areas with potable water supply.) 		_	U 🗸


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Thermal Performance and M	laterials commitments	
Do-it-yourself Method		
General features		
The dwelling must be a Class 1 dwe	lling according to the National Constru	uction Code, and must not have
The conditioned floor area of the dw	elling must not exceed 300 square me	etres.
The dwelling must not contain open	mezzanine area exceeding 25 square	metres.
The dwelling must not contain third I	evel habitable attic room.	
Floor, walls and ceiling/roof		
The applicant must construct the floo below.	or(s), walls, and ceiling/roof of the dwe	elling in accordance with the sp
The applicant must adopt one of the ceiling/roof of the dwelling.	options listed in the tables below to a	ddress thermal bridging in met
The applicant must show through re the tables below.	ceipts that the materials purchased fo	r construction are consistent wi
Construction	Area - m²	Additional insulation requi
floor - suspended floor above garage, hard wood; frame: timber - H2 treated softwood.	93.16	nil;foil-foam composite board
external wall: framed (fibre cement sheet or boards); frame: timber - H2 treated softwood.	all external walls	3.00 (or 3.50 including construction);foil-foam comp board + reflective foil in the
external garage wall: concrete panel/plasterboard; frame: timber - H2 treated softwood.	0	foil-foam composite board

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Description of project

Project name	Granny Flat Project	NatHERS assessor number	n/a
Street address	9 CAREEBONG Road FRENCHS FOREST	NatHERS certificate number	n/a
	2086	Climate zone	n/a
Local Government Area	Northern Beaches Council	Area adjusted cooling load (MJ/	n/a
Plan type and plan number	Deposited Plan DP29463	m².year)	
Lot no.	44	Area adjusted heating load (MJ/	n/a
Section no.	-	m².year)	
Project type		Project score	_
Project type	dwelling house (detached) - secondary dwelling	Water	46
No. of bedrooms	2	Thermal Performance	Pass
Site details			
Site area (m²)	838	Energy	100
Roof area (m²)	114	Materials	20
Conditioned floor area (m ²)	100.0		
Unconditioned floor area (m ²)	0.0		
Total area of garden and lawn (m ²)	339		
Roof area of the existing dwelling (m ²)	135		
Number of bedrooms in the existing dwelling	3		

page 3/11

		_		
		Show on DA plans	Show on CC/CDC plans & specs	Certifier check
t have more t	han 2 storeys.	~	~	~
		~	~	~
		v	v	~
		~	~	v
		<u></u>	*	
the specificati	ons listed in the table	v	v	•
n metal frame	d floor(s), walls and	~	~	~
ent with the s	pecifications listed in			~
		·		
required	Options to address t bridging	hermal	Other specifications	6
board	nil			
composite in the cavity	nil		wall colour: Light (sol absorptance < 0.48)	
ard	nil			

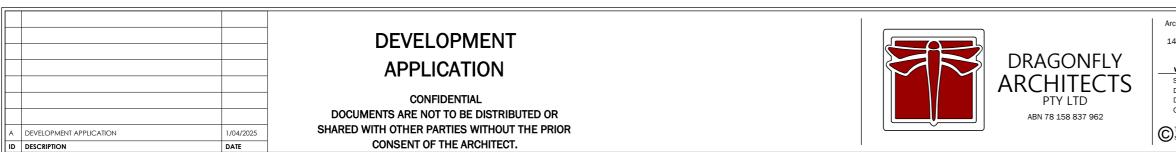page 4/11

rchitect - Catherin	e Seeto - Reg. 8345	9 CAREEBONG ROAD FRENCHS
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Construction	Area - m²	Additional insulation required	Options to address thermal bridging	Other specifications
internal wall: plasterboard; frame timber - H2 treated softwood.	: 35.5	not specified	nil	
ceiling and roof - flat ceiling / flat roof, framed - metal roof, timber H2 treated softwood.		ceiling: 5 (up), roof: foil backed blanket ;ceiling: rockwool batts, roll or pump-in; roof: foil backed blanket.	nil	roof colour: medium (solar absorptance 0.48-0.59); ceiling area fully insulated
Note Insulation specified in	this Certificate must be installe	d in accordance with the ABCB Housing Provisi	ions (Part 13.2.2) of the National Con	struction Code.
Note • If the additional ceiling	insulation listed in the table ab	ove is greater than R3.0, refer to the ABCB Ho	using Provisions (Part 13.2.3 (6)) of t	he National Construction Code.
Note • In some climate zones	s, insulation should be installed	with due consideration of condensation and as	sociated interaction with adjoining bui	Iding materials.
Note · Thermal breaks must	be installed in metal framed wa	Ils and applicable roofs in accordance with the	ABCB Housing Provisions of the Nati	onal Construction Code.

Thermal Performance	and Materials commitm	ents			Show on DA plans	Show on CC/CDC plans & specs	Certifier check
Glazed windows, doors and s	kylights						
		ading devices described in the ta becifications must be satisfied fo	able below, in accordance with th r each glazed window and door.	e	~	~	~
The dwelling may have 1 sky	light (<0.7 square metres) whic	h is not listed in the table.			~	~	~
The following requirements m	nust also be satisfied in relation	to each window and glazed doo	r:		~	~	~
 The applicant must install w table. 	vindows and glazed doors in ac	cordance with the height and wi	dth, frame and glazing types liste	d in the	~	~	~
			r Heat Gain Coefficient (SHGC) v nal Fenestration Rating Council (~	~
 Overshadowing buildings/v as specified in the 'overshad 		and distance from the centre an	d the base of the window and gla	azed door,	~	~	~
skylight area must not excee		e metre limit does not include th	specifications listed in the table. T e optional additional skylight of le		~	~	~
Glazed window/door no.	Maximum height (mm)	Maximum width (mm)	Frame and glass specification	Shading (Dimensi	device on within 109	Overshadowir %)	ıg
North facing							
W02	1400.00	2000.00	aluminium, single glazed (U- value: <=2.0, SHGC: 0.40 - 0.49)		hang 610 mm re head of win I door		n away
East facing				·			
W05	1400.00	900.00	aluminium, double glazed (U-value: <=3.0, SHGC: 0.60 - 0.74)		mm, 50 mm ad of window	or >4 m high, 8-1	2 m away
South facing			*				

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Show on Show on CC/CDC Certifier DA plans plans & specs check Thermal Performance and Materials commitments

Ceiling fans				
The applicant must install at least one ceiling fan in at least one daytime h	abitable space, such as living room.	~	~	~
The applicant must install at least one ceiling fan in each bedroom.		v	*	~
The minimum number and diameter of ceiling fans in a daytime habitabl Housing Provisions (Part 13.5.2) of the National Construction Code .	e space must be installed in accordance with the ABCB	v	v	v
is not a valid certificate	Version: 4.03 / ELICALYPTUS_03_01_0			nage f

Glazed window/door no.	Maximum height (mm)	Maximum width (mm)	Frame and glass specification	Shading device (Dimension within 10%)	Overshadowing
W06	1400.00	1800.00	aluminium, double glazed (U-value: <=2.0, SHGC: 0.33 - 0.40)	eave 600 mm, 900 mm above head of window or glazed door	>4 m high, 8-12 m away
W07	1400.00	1800.00	aluminium, double glazed (U-value: <=2.0, SHGC: 0.33 - 0.40)	eave 600 mm, 900 mm above head of window or glazed door	>4 m high, 8-12 m away
W13	600.00	3000.00	aluminium, double glazed (U-value: <=2.5, SHGC: 0.60 - 0.74)	eave 600 mm, 900 mm above head of window or glazed door	>4 m high, 8-12 m away
West facing					
W01	800.00	200.00	thermally broken aluminium, double glazed (U-value: <=3.0, SHGC: 0.40 - 0.49)	solid overhang 910 mm, 450 mm above head of window or glazed door	>4 m high, 5-8 m away
W03	800.00	2370.00	aluminium, double glazed (U-value: <=2.0, SHGC: 0.33 - 0.40)	eave 400 mm, 400 mm above head of window or glazed door	>4 m high, 2-5 m away
W04	600.00	1605.00	thermally broken aluminium, double glazed (U-value: <=2.0, SHGC: 0.27 - 0.33)	eave 400 mm, 400 mm above head of window or glazed door	>4 m high, 2-5 m away
W08	800.00	3360.00	thermally broken aluminium, double glazed (U-value: <=2.0, SHGC: 0.33 - 0.40)	solid overhang 910 mm, 50 mm above head of window or glazed door	>4 m high, 8-12 m away
W09	604.00	2470.00	aluminium, double glazed (U-value: <=2.5, SHGC: 0.22 - 0.27)	solid overhang 910 mm, 50 mm above head of window or glazed door	>4 m high, 8-12 m away
W10	582.00	4190.00	aluminium, double glazed (U-value: <=2.5, SHGC: 0.22 - 0.27)	solid overhang 910 mm, 50 mm above head of window or glazed door	>4 m high, 2-5 m away
W11	600.00	4400.00	thermally broken aluminium, double glazed (U-value: <=2.0, SHGC: 0.27 - 0.33)	eave 400 mm, 50 mm above head of window or glazed door	2-4 m high, 2 m away

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page 8/11

rchitect - Catherin	e Seeto - Reg. 8345	9 CAREEBONG ROAD FRENCHS
	restville 2087 NSW 846 288	FOREST NSW 2086
E: studio@d	farch.com.au	
www.dragonflya	rcnitects.com.au	
SCALE :	NTS @ A3	BASIX 2
DATE PRINTED :	1/04/2025	BACIAL
DRAWN BY :	ES, CS	
CLIENT:	MAYA OLIVARES CASTRO	
	AND LUKE SYKES	DFA2408-A20
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Energy Commitments	Show on DA plans	Show on CC/CDC plans & specs	Certifier check
Hot water			
The applicant must install the following hot water system in the development, or a system with a higher energy rating: electric heat pump with a performance of 15 to 20 STCs or better.	~	~	~
Cooling system			
The applicant must install the following cooling system, or a system with a higher energy rating, in at least 1 living area: 1-phase airconditioning - ducted; Energy rating: 7 star (average zone)		~	~
The applicant must install the following cooling system, or a system with a higher energy rating, in at least 1 bedroom: 1-phase airconditioning - ducted; Energy rating: 7 star (average zone)		v	~
Heating system			
The applicant must install the following heating system, or a system with a higher energy rating, in at least 1 living area: 1-phase airconditioning - ducted; Energy rating: 7 star (average zone)		~	~
The applicant must install the following heating system, or a system with a higher energy rating, in at least 1 bedroom: 1-phase airconditioning - ducted; Energy rating: 7 star (average zone)		~	~
Ventilation			
The applicant must install the following exhaust systems in the development:			1
At least 1 Bathroom: individual fan, open to façade; Operation control: please select		U 🗸	_
Kitchen: individual fan, ducted to façade or roof; Operation control: manual on / timer off		_	_
Laundry: natural ventilation only, or no laundry; Operation control: n/a		~	~
Artificial lighting			
The applicant must ensure that a minimum of 80% of light fixtures are fitted with fluorescent, compact fluorescent, or light-emitting- diode (LED) lamps.		v	~
Natural lighting			
The applicant must install a window and/or skylight in the kitchen of the dwelling for natural lighting.	U		

In these	commitments, "	applicant" means	the person carry	ing out the devel	opment.	
Commit deve l op	nents identified ment application	with a У in the ' n is to be lodged	Show on DA plar	ns" column must development).	be shown on the p	ans accomp
			Show on CC/CD		s" column must b	e shown in th
		with a У in the ' Int may be issued		o l umn must be c	ertified by a certify	ving authority

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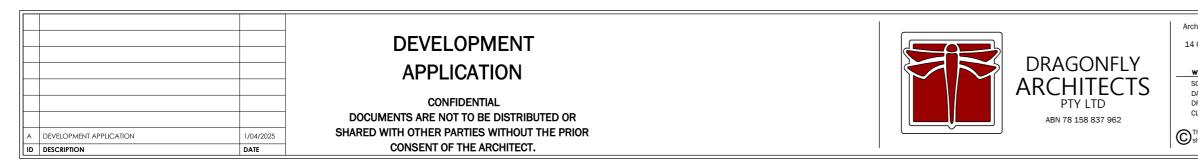
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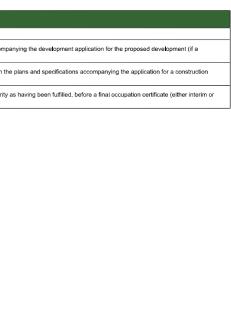
Energy Commitments	Show on DA plans	Show on CC/CDC plans & specs	Certifier check
The applicant must install a window and/or skylight in 2 bathroom(s)/toilet(s) in the development for natural lighting.	~	~	~
Alternative energy		1	
The applicant must install a photovoltaic system as part of the development. The applicant must connect this system to the development's electrical system.	~	~	~
The photovolatic system must consist of:			
 photovolatic collectors with the capacity to generate at least 6,6 peak kilowatts of electricity, installed at an angle between 0 degrees and 10 degrees to the horizontal facing east 	V .	~	v
Other			
The applicant must install a fixed outdoor clothes drying line as part of the development.		_	
		•	

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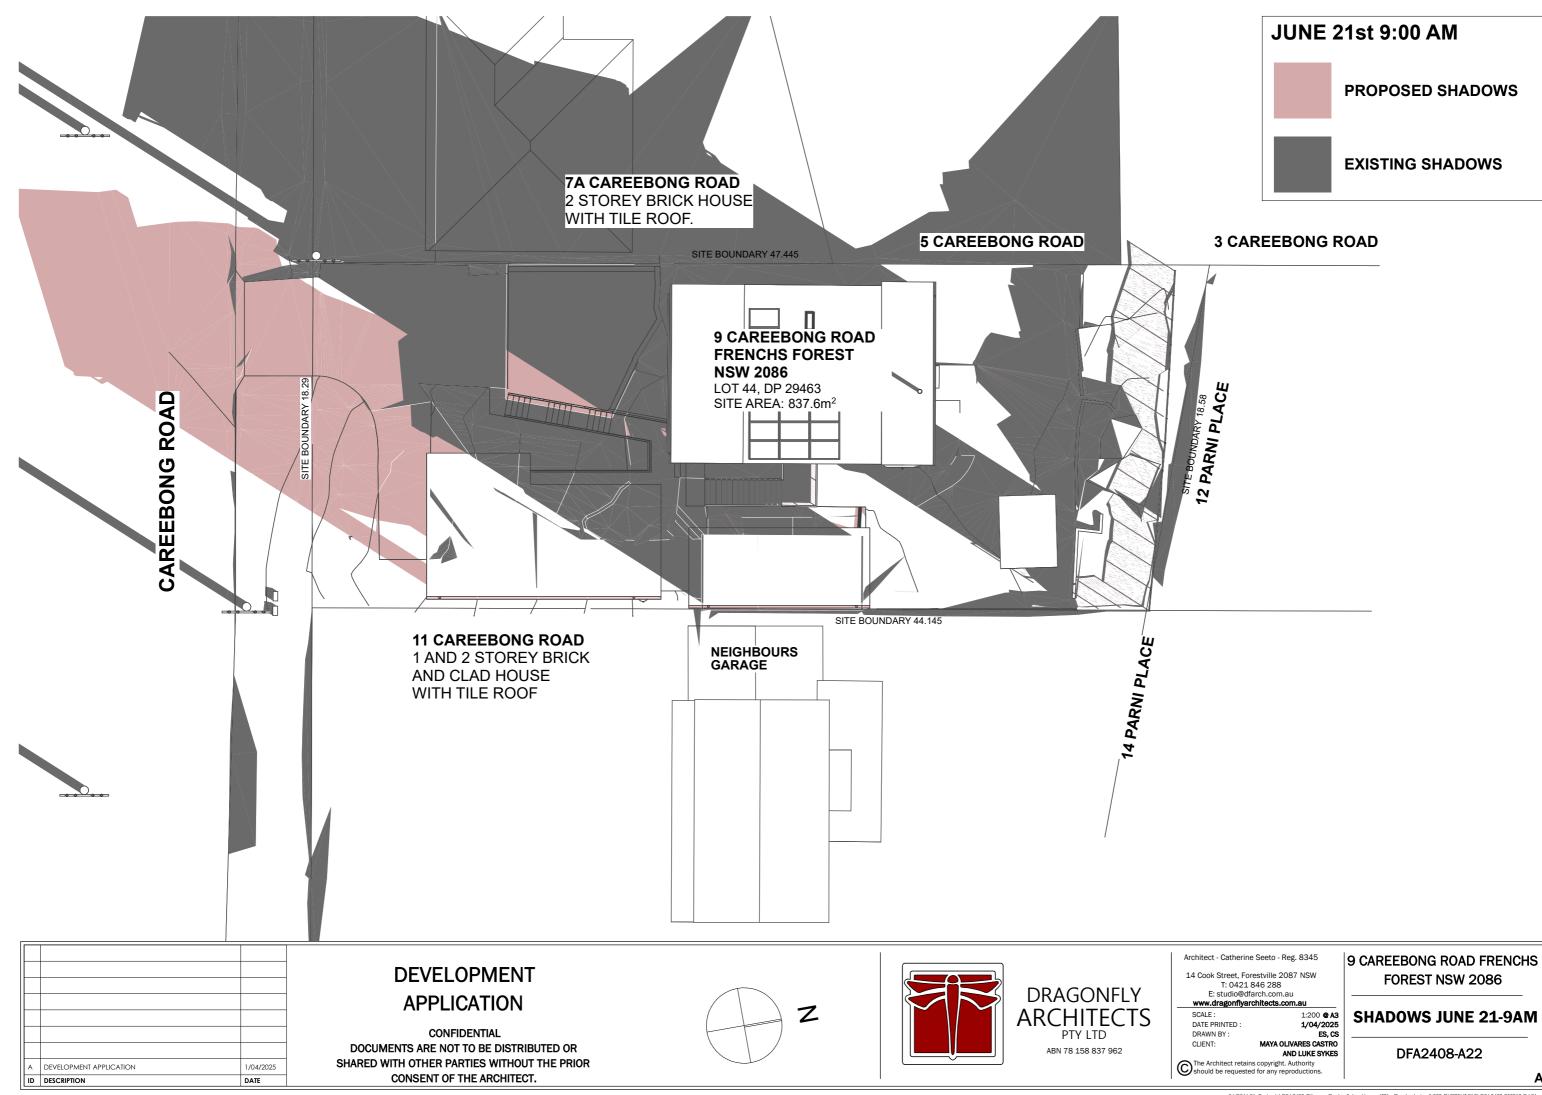
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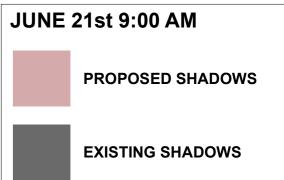






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hitect - Catherir	ne Seeto - Reg. 8345	9 CAREEBONG ROAD FRENCHS
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CALE :	NTS @A3	BASIX 3
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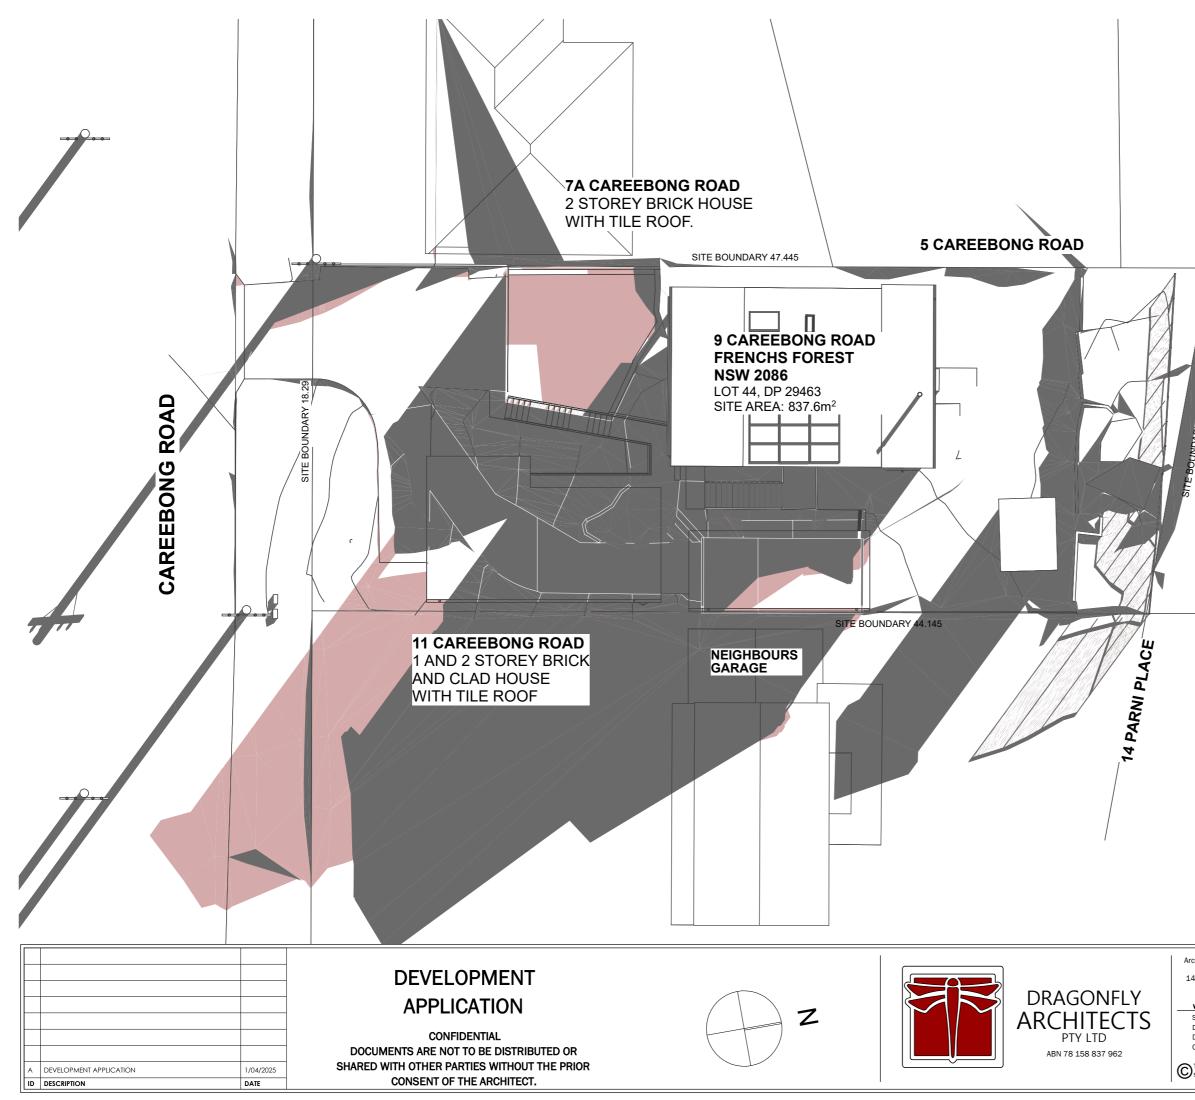





3 CAREEBONG ROAD

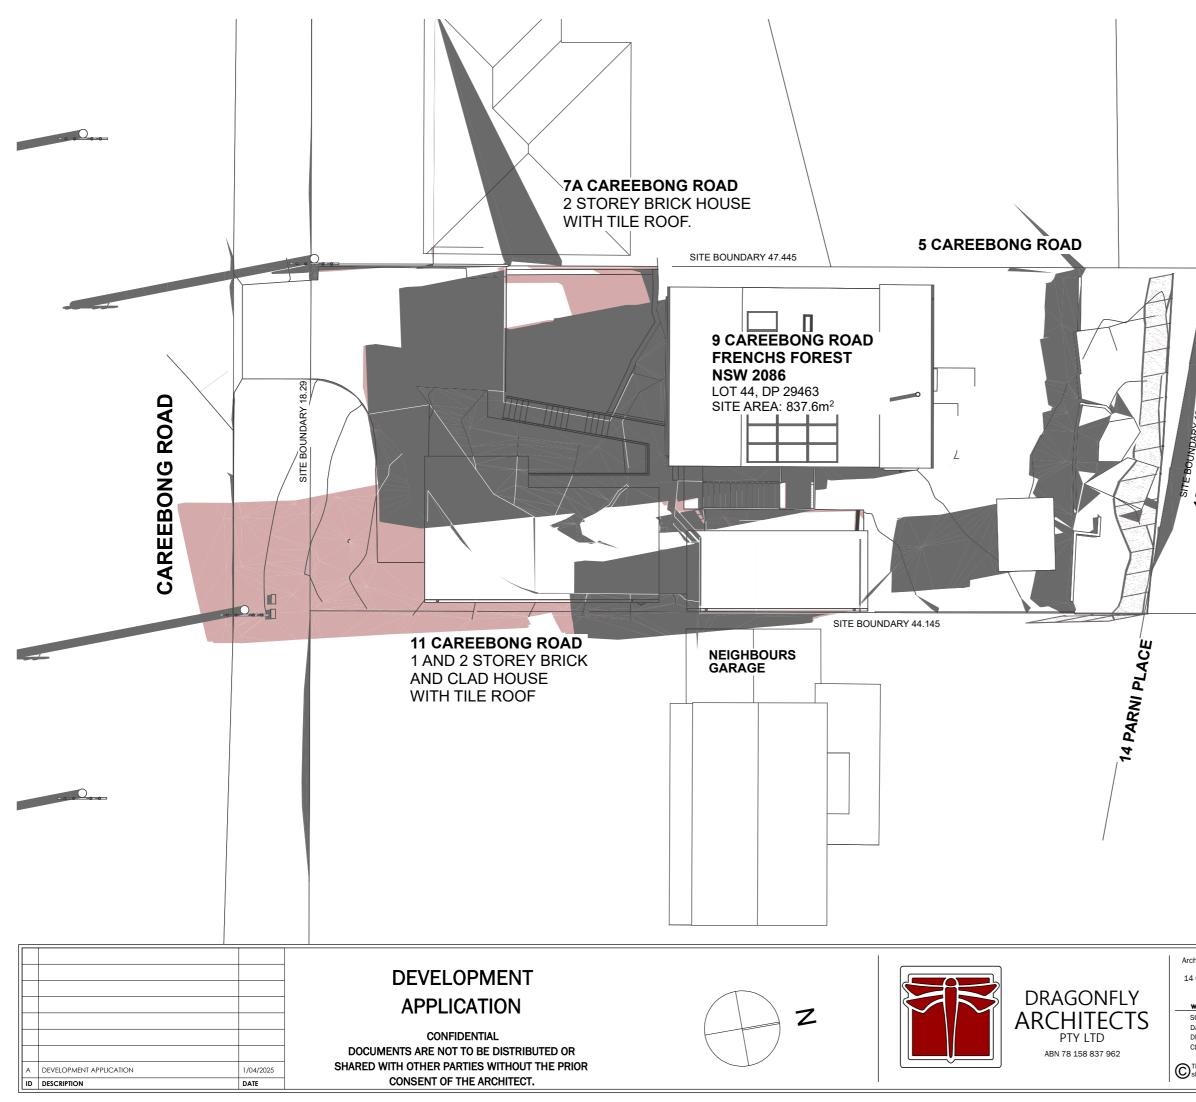

chitect - Cather	ine Seeto - Reg. 8345	9 CAREEBONG ROAD FRENCH	s
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	dfarch.com.au architects.com.au	SHADOWS JUNE	
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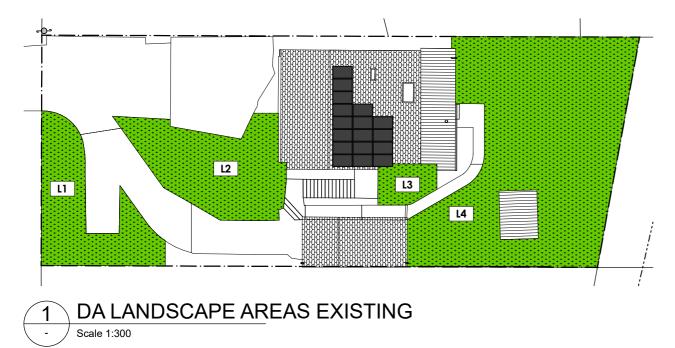


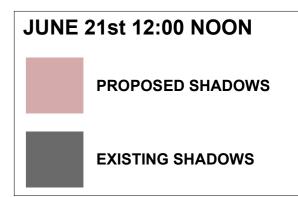

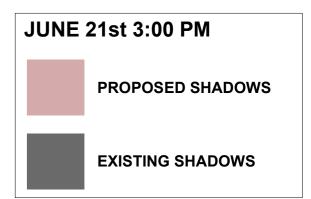3 CAREEBONG ROAD



rchitect - Catherir	ne Seeto - Reg. 8345	9 CAREEBONG ROAD FRENCHS
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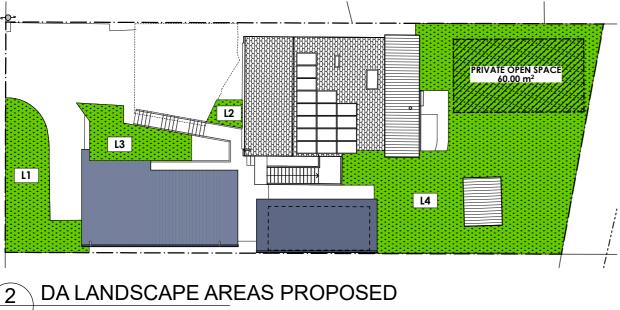


LANDSCAPE EXISTING		
NAME	AREA	
L1	61.87	
L2	74.93	
L3	16.43	
L4	234.73	
	387.96 m ²	
	COMPLIE	

MIN LANDSCAPE REQUIRED IS 40% MIN. LANDSCAPE (0.40 X 837.6m²)= 335.04m²

PRIVATE OPEN SPACE NORTHERN BEACHES COUNCIL DCP - PART D2

3 OR MORE BEDROOMS WITH A MIN. DIMENSION OF 5m. MIN. REQUIRED PRIVATE OPEN SPACE = 60m²



LANDSCAPE PROPOSED	
NAME	AREA
L1	48.51
L2	5.01
L3	26.26
L4	256.45
	336.23 m ²
	COMPLIES

Architect - Catherine Seeto - Reg. 8345 9 CAREEBONG ROAD FRENCHS DEVELOPMENT 14 Cook Street, Forestville 2087 NSW FOREST NSW 2086 T: 0421 846 288 E: studio@dfarch.com.au DRAGONFLY **APPLICATION** www.dragonflyarchitects.co LANDSCAPE Ζ ARCHITECTS SCALE : 1:300 @ A3 CALCULATION DATE PRINTED 1/04/2025 CONFIDENTIAL PTY LTD DRAWN BY ES, CS MAYA OLIVARES CASTRO CLIENT: DOCUMENTS ARE NOT TO BE DISTRIBUTED OR ABN 78 158 837 962 AND LUKE SYKES DFA2408-A25 SHARED WITH OTHER PARTIES WITHOUT THE PRIOR The Architect retains copyright. Authority should be requested for any reproduction A DEVELOPMENT APPLICATION 1/04/2025 CONSENT OF THE ARCHITECT. ID DESCRIPTION DATE

Scale 1:300

LANDSCAPE CALCULATIONS **NORTHERN BEACHES COUNCIL DCP - PART D1 NOTE: SOFT LANDSCAPE AREAS WITH MIN. DIMENSION**

GREATER THAN 2,000mm

TOTAL SITE IS 837.6m²

MIN. REQUIRED SOFT LANDSCAPE = 335.04m²


COMPLIES

METAL ROOFS COLORBOND COLOUR - MID-DARK GREY

EXTERNAL LIGHTWEIGHT WALLS PAINT - BEIGE OR GREY TONES





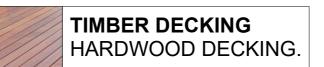

		DEVELOPMENT		Ari 14
		APPLICATION	DRAGONFLY ARCHITECTS	-
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IC	D DESCRIPTION DATE	CONSENT OF THE ARCHITECT.	1	

DOWNPIPES & GUTTERS COLORBOND COLOUR - MID-DARK GREY

WINDOWS AND DOOR ALUMINIUM FRAMES POWDERCOATED - MID-DARK GREY/BEIGE OR WHITE

EXTERNAL RENDERED WALLS PAINT - BEIGE OR GREY TONES

chitect - Catherine Seeto - Reg. 8345 9 CAREEBONG ROAD FRENCHS Cook Street, Forestville 2087 NSW FOREST NSW 2086 T: 0421 846 288 E: studio@dfarch.com.au www.dragonflyarchitects.c NTS @ A3 1/04/2025 ES, CS SCALE : **FINISHES SCHEDULE** DATE PRINTED ORAWN BY MAYA OLIVARES CASTRO AND LUKE SYKES CLIENT: DFA2408-A26 copyright. Authority The Architect d for any repro