

ACTION PLANS

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DEVELOPMENT APPLICATION

SHEET NUMBER		SHEET NAME	DATE PUBLISHED
DA00	COVER		06/02/2019
DA01	SITE ANALYSIS		06/02/2019
DA02	SITE / ROOF / SEDIMENT EROSION / WASTE MANAGEMENT / STORMWATER CON	ICEPT PLAN	06/02/2019
DA03	EXISTING GROUND FLOOR PLAN		06/02/2019
DA04	PROPOSED GROUND & SECONDARY DWELLING FLOOR PLAN		06/02/2019
DA05	PROPOSED CARPORT PLAN		06/02/2019
DA06	NORTH / EAST ELEVATION		06/02/2019
DA07	SOUTH / WEST ELEVATION		06/02/2019
DA08	SECONDARY DWELLING ELEVATIONS		06/02/2019
DA09	LONG / CROSS SECTION		06/02/2019
DA10	SECONDARY DWELLING SECTIONS		06/02/2019
DA11	AREA CALCULATIONS / SAMPLE BOARD		06/02/2019
DA12	WINTER SOLSTICE 9 AM		06/02/2019
DA13	WINTER SOLSTICE 12 PM		06/02/2019
DA14	WINTER SOLSTICE 3 PM		06/02/2019
DA15	BASIX COMMITMENTS - ALTERATIONS & ADDITIONS		06/02/2019
DA16	BASIX COMMITMENTS - SECONDARY DWELLING		06/02/2019


ITEM DETAILS	DEVELOPMENT APPLICATION		
ADDRESS	120 Garden Street, NORTH NARRABEEN, 2101		
OT & DP/SP	LOT 6 DP 6555		
COUNCIL	NORTHERN BEACHS COUNCIL (PITTWATER)		
SITE AREA	695.6m²		
RONTAGE	15.24m		
CONTROLS	PERMISSIBLE / REQUIRED	EXISTING	PROPOSED
JONTROLS	m / m² / %	m / m² / %	m / m² / %
<u>EP</u>			
AND ZONING	R2 – LOW DENSITY RESIDENTIAL	R2	R2
INIMUM LOT SIZE	550m²	695.6m²	UNCHANGED
LOOR SPACE RATIO	NOT IDENTIFEID	N/A	N/A
MAXIMUM BUILDING HEIGHT	8.5m	5.72m	UNCHANGED
IAZARDS			
CID SULFATE SOILS	CLASS 5	N/A	N/A
HIGH/MED/LOW FLOOD RISK PRECINCT	LOW TO HIGH RISK	N/A	N/A
<u>CP</u>			
UMBER OF STOREYS	1	1	
PRIMARY DWELLING SIDE BOUNDARY SETBACKS	North: 2.5m South: 1.0m	N: 1.559m (House) S: 2.901m (House)	N: 1.559m (House) S: 1.160m (House) N: 1.559m (Carport)
PRIMARY DWELLING FRONT BOUNDARY SETBACK	6.5m	House: 12.434m	House: 12.434m Carport: 2.600m
RIMARY DWELLING REAR OUNDARY SETBACK	6.5m	14.297m	14.297m
ANDSCAPE OPEN SPACE	50% (347.8m²)	49% (339.93m²)	50% (347.94m²)
RIVATE OPEN SPACE	Primary Dwelling: 80m² Secondary Dwelling: 15% of floor area (5.97m²)	139.17m² N/A	135.25m² 35.23m²
ECONDARY DWELLING SIDE	2.5m: North	N: 6.813m	N: 6.813m
OUNDARY SETBACKS	1.0m: South	S: 2.404m	S: 2.404m
CONDARY DWELLING FRONT DUNDARY SETBACK	6.5m	37.241m	37.241m
ECONDARY DWELLING REAR DUNDARY SETBACK	6.5m	1.360m	1.360m


120 GARDEN STREET, NORTH NARRABEEN, 2101




NCC & AS COMPLIANCES SPECIFICATIONS

- EARTHWORKS: METHOD OF EXCAVATIONAND FILL - PART 3.1.1 OF NCC - SURFACE SUBSOIL-STORMWATER DRAINAGE - PART 3.1.2 OF NCC - TERMITE-RISK MANAGEMENT - PART 3.1.3 OF NCC - FOOTINGS & SLAB - PART 3.2 OF NCC INCLUDING AS2870 - MASONRY CONSTRUCTION - PART 3.3 OF NCC INCLUDING AS3700 - SUB FLOOR VENTILATION - PART 3.4.1 OF NCC - FRAMING - PART 3.4 OF NCC - ROOF, WALL-CLADDING, GUTTERS & DOWNPIPES - PART 3.5 OF NCC - GLAZING - PART 3.6 OF NCC INCLUDING AS1288 - FIRE SEPARATION - PART 3.7.1 OF NCC - SMOKE ALARMS - PART 3.7.2 OF NCC - HEATING APPLIANCES - PART 3.7.3 OF NCC - WET AREAS-PROTECTION OF WALLS & FLOORS - PART 3.8.1 OF NCC - MINIMUM ROOF HEIGHTS - PART 3.8.3 OF NCC - FACILITIES REQUIRRED & SANITARY DOOR CONSTRUCTION - PART 3.8.3 OF NCC - LIGHT: NATURAL AND ARTIFICIAL - PART 3.8.4 OF NCC - VENTILATION & LOCATION OF TOILETS - PART 3.8.5 OF NCC - SOUND INSULATION - PART 3.8.6 OF NCC - STAIR CONSTRUCTION INCLUDING DIMENSIONS - PART 3.9.1 OF NCC - BALUSTRADES & OTHER BARRIERS - PART 3.9.2 OF NCC - FENCING & OTHER PROVISIONS - REGS & AS1926 - DEMOLITION WORKS - AS2601-1991 THE DEMOLITION OF STRUCTURES. - ALL WATERPROOF MEMBRANES TO COMPLY WITH WITH AS 3740-2004 - ALL PLUMBING & DRAINAGE WORK TO COMPLY WITH AS 3500 - SITE CLASSIFICATION AS TO AS 2870 - ALL PLASTERBOARD WORK TO COMPLY WITH AS 2588-1998 - ALL STRUCTURAL STEEL WORK TO COMPLY WITH AS 4100 & AS 1554 - ALL CONCRETE WORK TO COMPLY WITH AS 3600 - ALL ROOF SHEETING WORK TO COMPLY WITH AS 1562-1992 - ALL SKYLIGHTS TO COMPLY WITH WITH AS 4285-2007 - ALL CERAMIC TILING TO COMPLY WITH AS 3958.1-2007 & 3958.2-1992 - ALL GLAZING ASSEMBLIES TO COMPLY WITH AS2047 & 1288 - ALL TIMBER RETAINING WALLS ARE TO COMPLY WITH AS 1720.1-2010, AS 1720.2-2006, AS 1720.4-2006, AS 1170.1-1989 & AS 1170.4-1993 - ALL RETAINING WALLS ARE TO COMPLY WITH 3700 - 2011 & AS 3600 -2001 - ALL CONSTRUCTION TO COMPLY TO AS3959- 1991

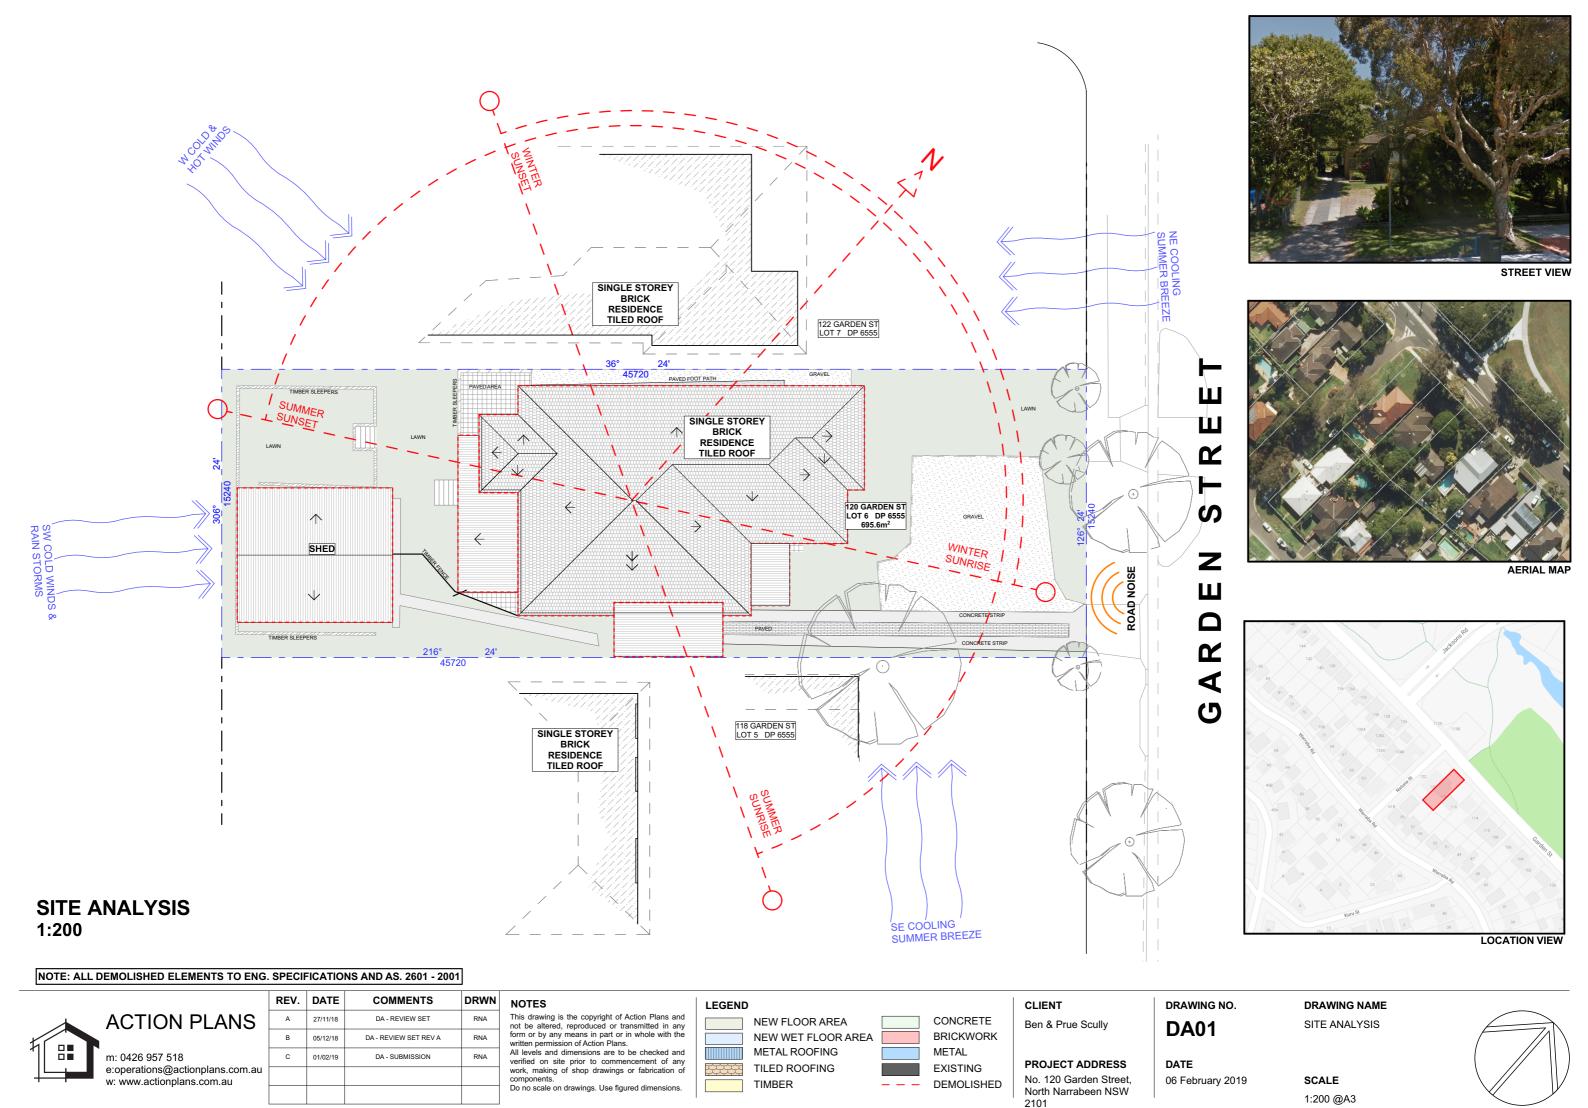

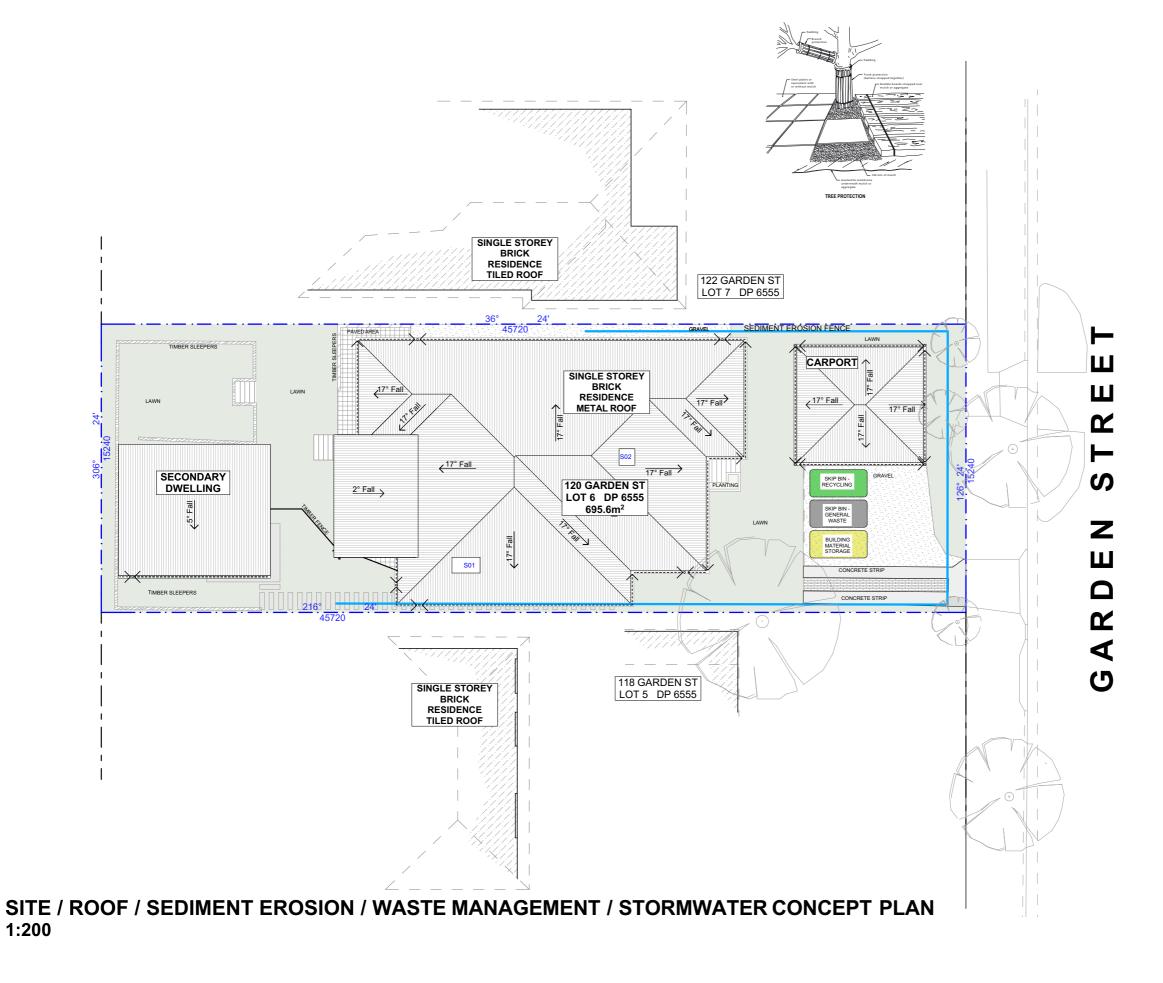

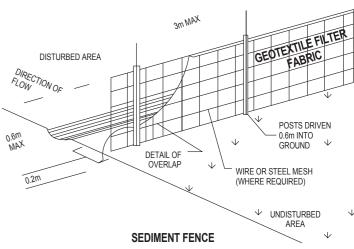

DUST CONTROL:

TO REDUCE DUST GENERATED BY WIND ACTION, THE REMOVAL OF THE TOP SOIL IS TO BE MINIMISED. TO PREVENT DUST GENERATION, WATERING DOWN OF THE SITE, ESPECIALLY DURING THE MOVEMENT OF MACHINERY IS REQUIRED. WHERE EXCAVATING INTO ROCK, KEEP THE SURFACE MOIST TO MINIMISE DUST. CONSTRUCT A GRAVEL ENTRY/EXIT POINT USING BLUE METAL AND RESTRICT ALL VEHICLE MOVEMENTS WITHIN THE SITE TO A MINIMUM. ENSURE WIND BREAKS, SUCH AS EXISTING FENCES ARE MAINTAINED DURING THE CONSTRUCTION PHASE UNTIL NEW LANDSCAPING IS PROVIDED OR REINSTATED. PREVENT DUST BY COVERING STOCKPILES

SEDIMENT NOTE:

1. ALL EROSION AND SEDIMENT CONTROL MEASURES TO BE INSPECTED AND MAINTAINED DAILY BY THE SITE MANAGER.

2. MINIMISE DISTURBED AREAS, REMOVE EXCESS SOIL FROM EXCAVATED AREA AS SOON AS POSSIBLE.
3. ALL MATERIAL STOCKPILE TO BE CLEAR FROM DRAINS, GUTTERS AND FOOTPATHS, OR WITHIN SEDIMENT FENCE AREA.

4. DRAINAGE TO BE CONNECTED TO STORMWATER AS SOON AS POSSIBLE. IF STORED ON SITE, IT MUST BE FILTERED BEFORE RELEASING INTO STORMWATER SYSTEM OR WATERWAYS.

5. ROADS AND FOOTPATHS TO BE SWEPT DAILY.

STOCKPILES:

ALL STOCKPILES ARE TO BE KEPT ON-SITE WHERE POSSIBLE. ANY MATERIALS PLACED ON THE FOOTPATHS OR NATURE STRIPS REQUIRE COUNCIL'S PERMISSION


ALL STOCKPILES ARE TO BE PLACED AWAY FROM THE DRAINAGE LINES AND STREET GUTTERS. IT IS BEST TO LOCATE THESE ON THE HIGHEST PART OF THE SITE IF POSSIBLE. PLACE WATERPROOF COVERING OVER STOCKPILES.

IF REQUIRED PROVIDE DIVERSION DRAIN & BANK AROUND STOCKPILES.

GUTTER PROTECTION:

PROVIDE PROTECTION TO DOWNHILL GRATE IN GUTTER BY MEANS OF SAND BAGS OR BLUE METAL WRAPPED IN GEOTEXTILE FABRIC. WHEN SOIL OR SAND BUILDS UP AROUND THIS SEDIMENT BARRIER, THE MATERIAL SHOULD BE RELOCATED BACK TO THE SITE FOR DISPOSAL.

NOTE: ALL PROPOSED STORMWATER TO CONNECT WITH EXISTING

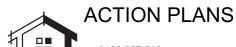

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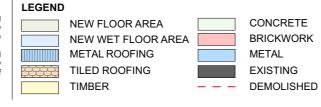
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All levels and dimensions are to be checked and

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Do no scale on drawings. Use figured dimensions.



CLIENT

Ben & Prue Scully

PROJECT ADDRESS
No. 120 Garden Street,
North Narrabeen NSW
2101

DRAWING NO.

DA02

DATE06 February 2019


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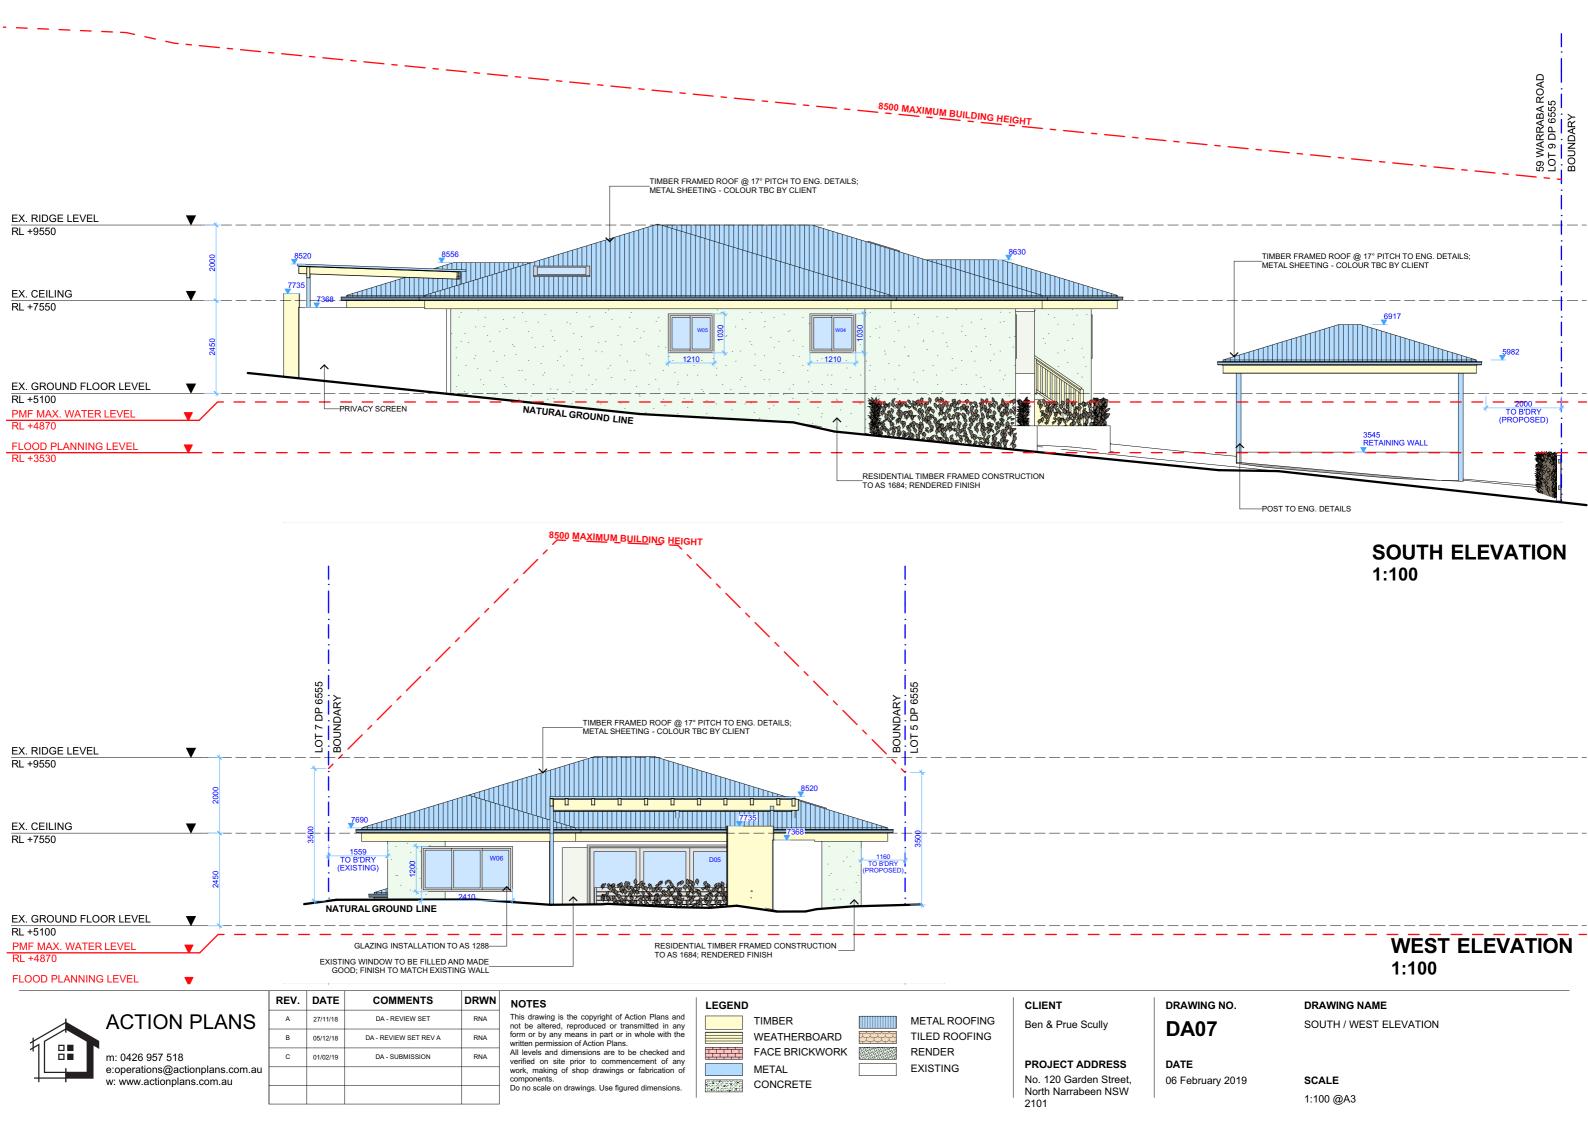
SITE / ROOF / SEDIMENT EROSION / WASTE MANAGEMENT / STORMWATER CONCEPT PLAN

SCALE

1:200 @A3





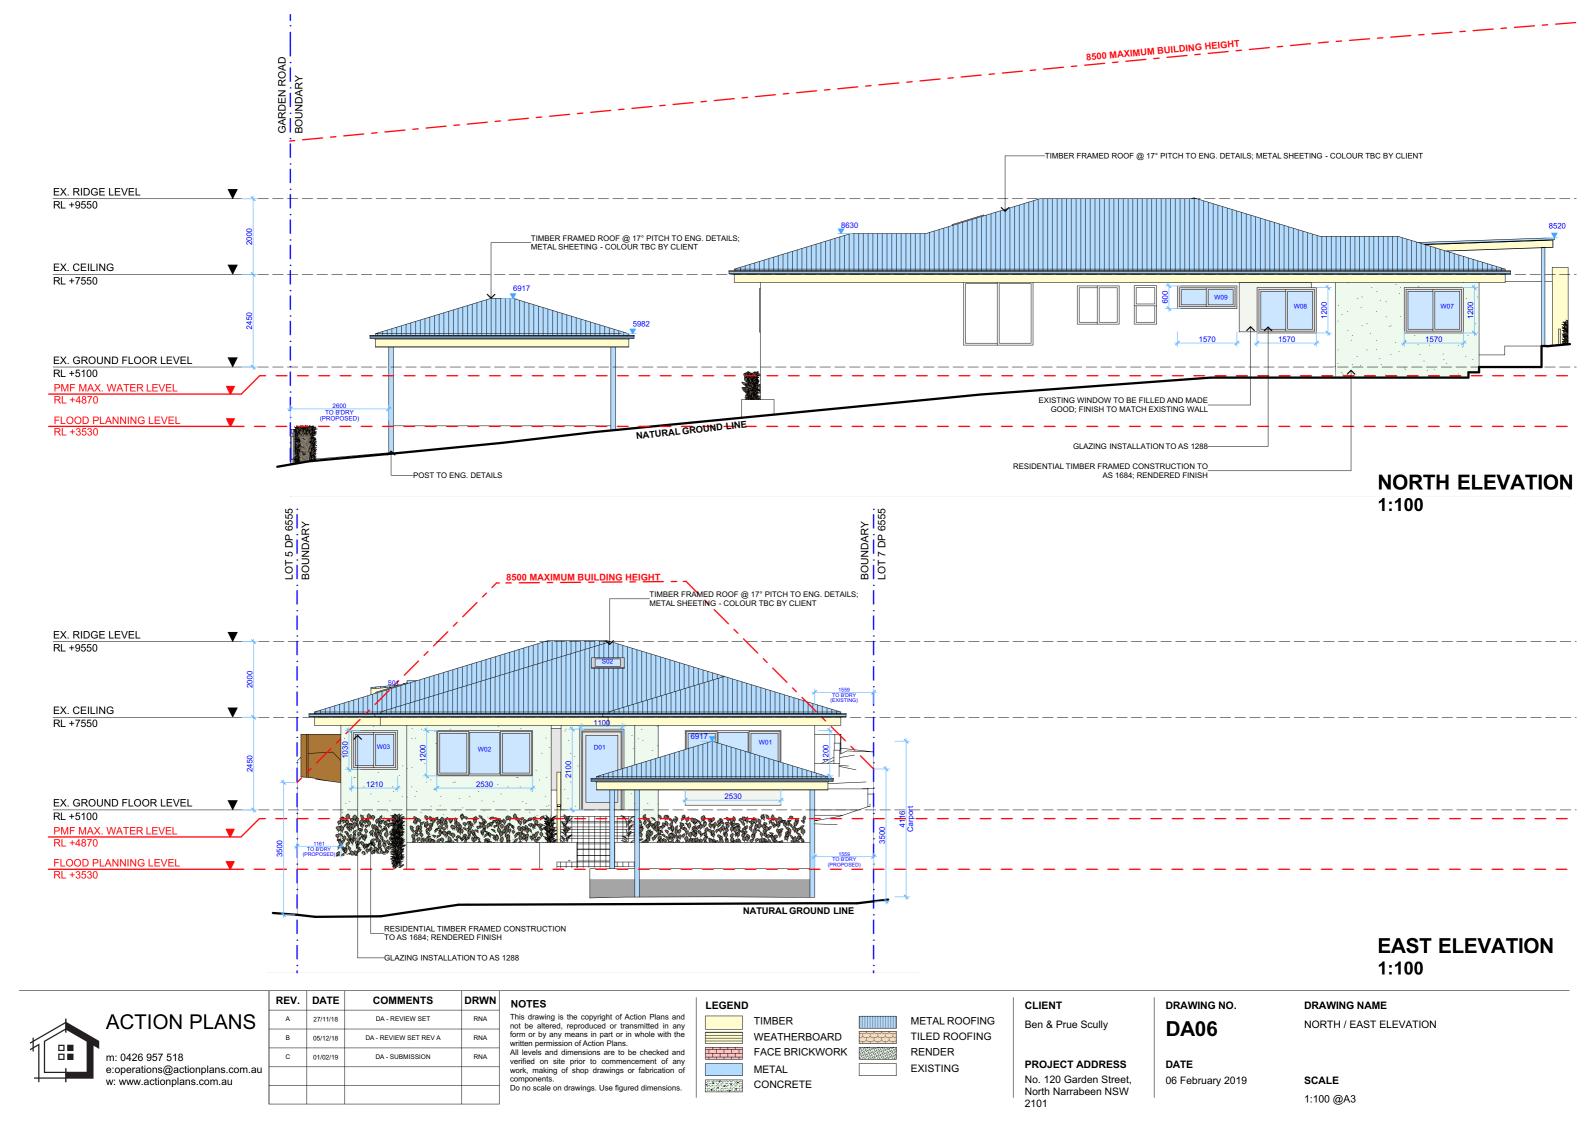


LANDSCAPE REQUIREMENTS

Landscaped Area - General: 50% (347.8m²) Existing: 49% (339.93m²) Proposed:50% (347.94m²)

> 6% Landscaped Variations (41.74m²) Proposed: 6% (41.74m²)

Building Footprint Primary Dwelling: 184.34m² Secondary Dwelling: 39.81m²

Private Open Space: Primary Dwelling: 80m² per dwelling & Secondary Dwelling 15% of floor area Existing Primary Dwelling: 80m² per dwelling (139.17m²) Proposed Primary Dwelling: 80m² per dwelling (135.25m²) Secondary Dwelling: 15% of floor area: 5.97m² (35.23m²)

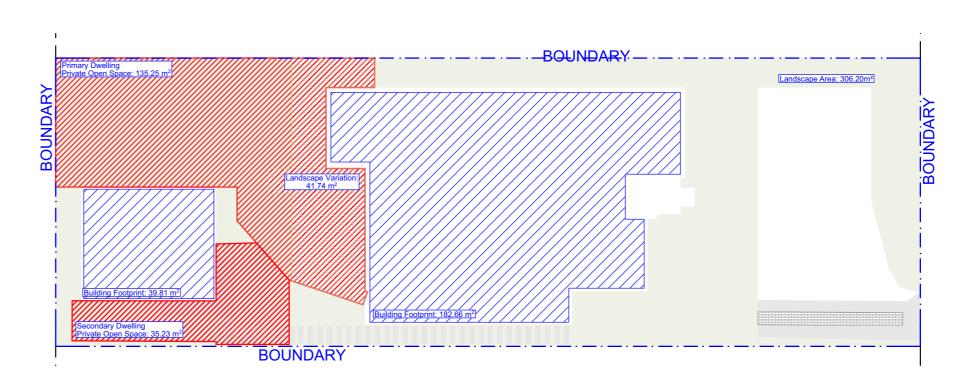

AREA CALCULATIONS 1:200



WHERE REPLACING DOORS AND WINDOWS WALL TO BE FIXED AND MATCH EXISTING



RENDERED WALL TO MATCH EXISTING



ALUMINIUM FRAMED WINDOWS BY STEGBAR



FIXED SKYLIGHT WINDOWS **BY VELUX**

SAMPLE BOARD

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LEGEND

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No. 120 Garden Street. North Narrabeen NSW 2101

DRAWING NO.

DA11

DATE


06 February 2019

DRAWING NAME

AREA CALCULATIONS / SAMPLE BOARD

SCALE 1:200 @A3



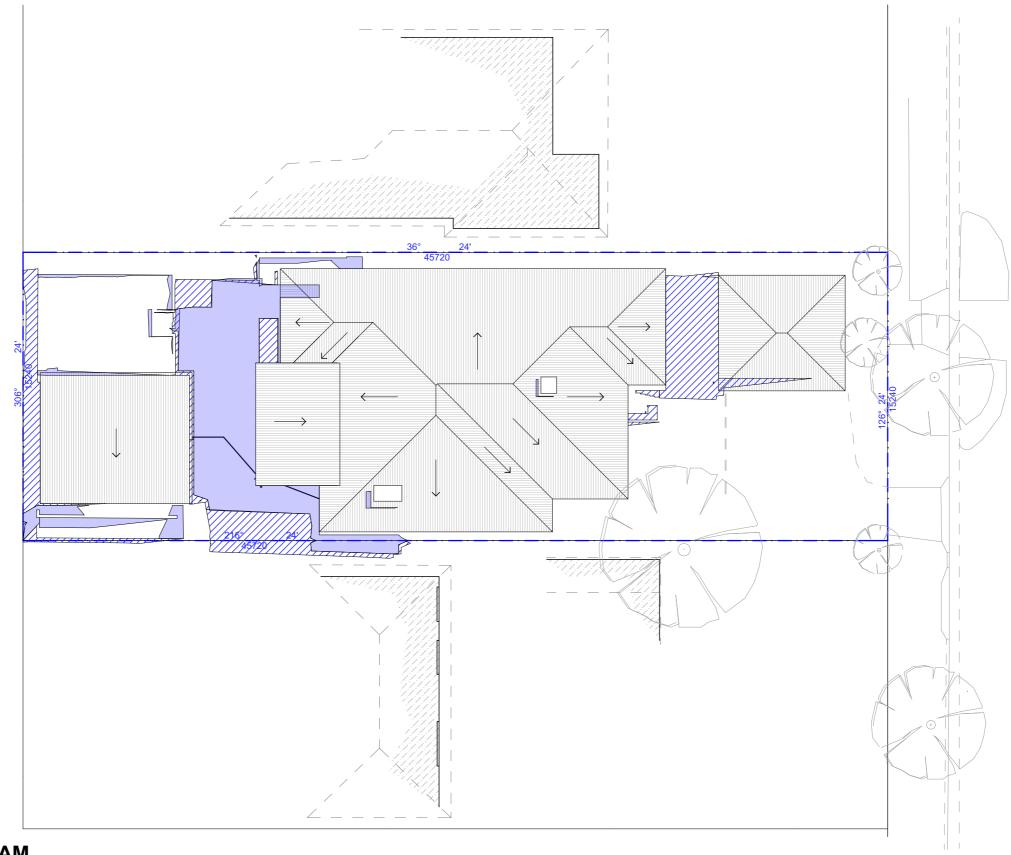

WINTER SOLSTICE 9 AM 1:200



	REV.	DATE	COMMENTS	DRWN	
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2101

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PROJECT ADDRESS
No. 120 Garden Street,
North Narrabeen NSW

DRAWING NO.

DA12


06 February 2019


DATE

DRAWING NAME WINTER SOLSTICE 9 AM

SCALE

1:200 @A3

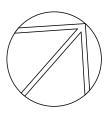

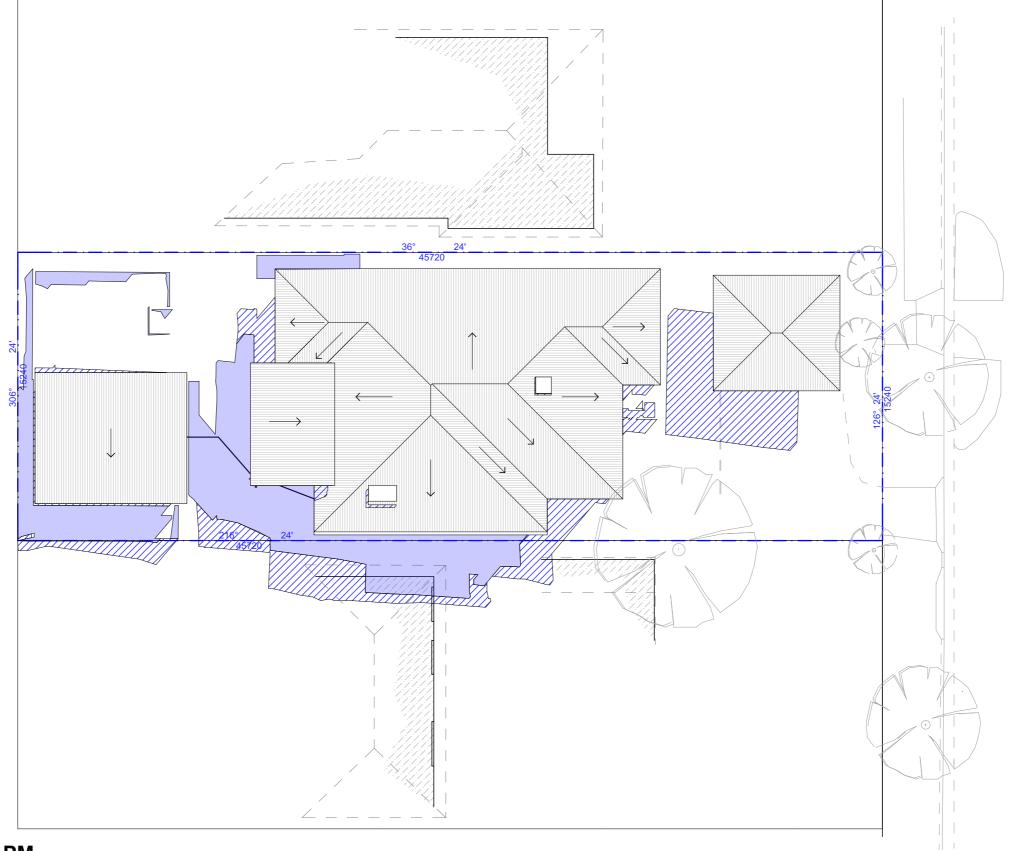

WINTER SOLSTICE 12 PM 1:200



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DA13

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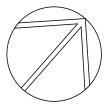
DATE


DRAWING NO.

WINTER SOLSTICE 12 PM

SCALE 1:200 @A3

DRAWING NAME



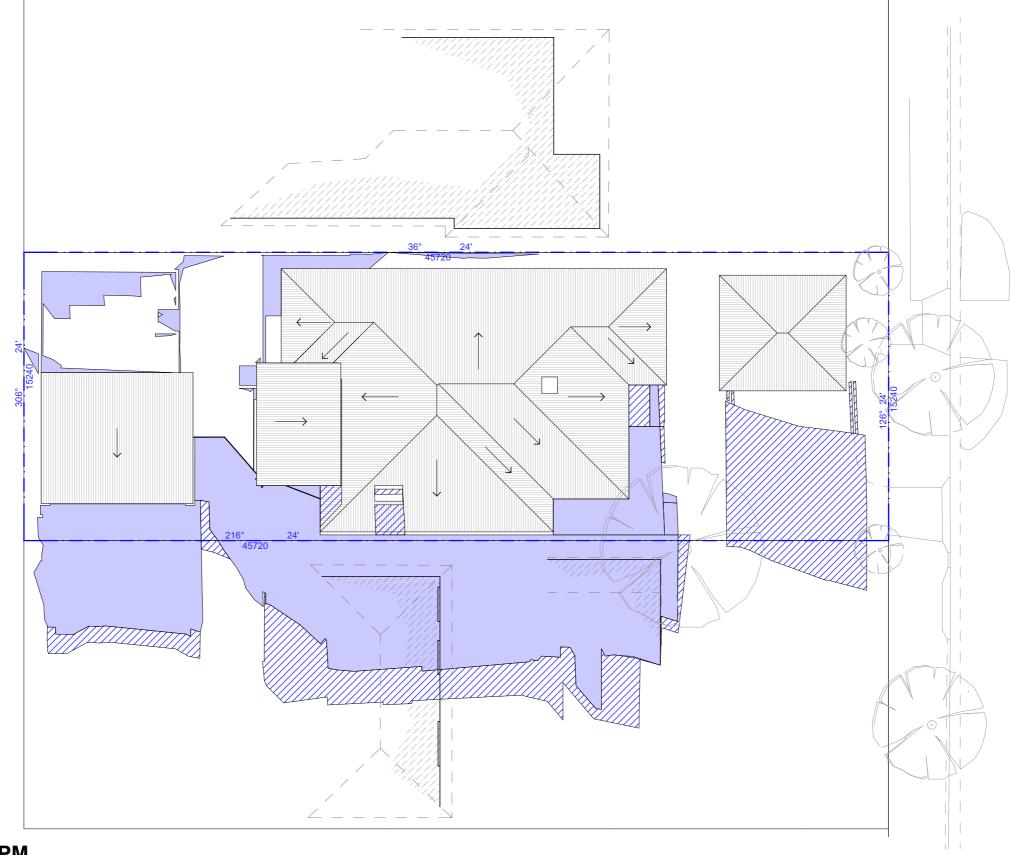

WINTER SOLSTICE 3 PM 1:200



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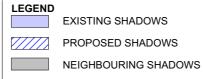
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DRAWING NO.

DA14


DATE

06 February 2019

DRAWING NAME

WINTER SOLSTICE 3 PM

SCALE 1:200 @A3

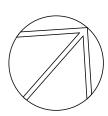



Building Sustainability Index www.basix.nsw.gov.au

Alterations and Additions

Certificate number: A334985

This certificate confirms that the proposed development will meet the NSW government's requirements for sustainability, if it is built in accordance with the commitments set out below. Terms used in this certificate, or in the commitments, have the meaning given by the document entitled "BASIX Alterations and Additions Definitions" dated 06/10/2017 published by the Department. This document is available at www.basix.nsw.gov.au

Secretary
Date of issue: Friday, 23, November 2018
To be valid, this certificate must be lodged within 3 months of the date of issue.



Fixtures and systems

Project name	120 Garden St North Narrabeen -Job 457
Street address	120 Garden Street North Narrabeen 2101
Local Government Area	Northern Beaches Council
Plan type and number	Deposited Plan 6555
Lot number	6
Section number	0
Project type	
Dwelling type	Separate dwelling house
Type of alteration and	My renovation work is valued at \$50,000 or more and does not include a pool (and/or spa).

Certificate Prepared by (please complete before submitting to Council or PCA)
Name / Company Name: Action Plans
ABN (if applicable): 17118297587

				specs		
Lighting						
The applicant must ensure a minimum of 40% light-emitting-diode (LED) lamps.	of new or altered light fixtures are fitted with flu	orescent, compact fluorescent, or		✓	✓	
Fixtures						
The applicant must ensure new or altered sho	werheads have a flow rate no greater than 9 litr	es per minute or a 3 star water rating.		~	~	
The applicant must ensure new or altered toile	oplicant must ensure new or altered toilets have a flow rate no greater than 4 litres per average flush or a minimum 3 star water rating.					
The applicant must ensure new or altered taps	olicant must ensure new or altered taps have a flow rate no greater than 9 litres per minute or minimum 3 star water rating.					
Construction			Show on DA Plans	Show on CC/CDC Plans & specs	Certifier Check	
Insulation requirements						
	ation is not required where the area of new cons	s) in accordance with the specifications listed in struction is less than 2m2, b) insulation specified	✓	✓	~	
Construction	Additional insulation required (R-value)	Other specifications				
suspended floor with enclosed subfloor: framed (R0.7).	R0.60 (down) (or R1.30 including construction)					
external wall: framed (weatherboard, fibro, metal clad)	R1.30 (or R1.70 including construction)					

Legend

metal clad)

flat ceiling, pitched roof

In these commitments, "applicant" means the person carrying out the development.

Commitments identified with a "\sqrt{"} in the "Show on DA plans" column must be shown on the plans accompanying the development application for the proposed development (if a development application is to be lodged for the proposed development).

R1.30 (or R1.70 including construction)

ceiling: R3.00 (up), roof: foil/sarking

Commitments identified with a "\sqrt{"} in the "Show on CC/CDC plans & specs" column must be shown in the plans and specifications accompanying the application for a construction certificate / complying development certificate for the proposed development.

Commitments identified with a "v" in the "Certifier check" column must be certified by a certifying authority as having been fulfilled, before a final occupation certificate for the development may be issued.

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external wall: framed (weatherboard, fibro,

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NOTES

medium (solar absorptance 0.475 - 0.70)

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Glazing req	uirements						Show on DA Plans	Show on CC/CDC Plans & specs	Certifier Check
Windows an	d glazed do	ors							
The applicant must install the windows, glazed doors and shading devices, in accordance with the specifications listed in the table below. Relevant overshadowing specifications must be satisfied for each window and glazed door.								✓	~
The following requirements must also be satisfied in relation to each window and glazed door:								✓	✓
Each window or glazed door with standard aluminium or timber frames and single clear or toned glass may either match the description, or, have a U-value and a Solar Heat Gain Coefficient (SHGC) no greater than that listed in the table below. Total system U-values and SHGCs must be calculated in accordance with National Fenestration Rating Council (NFRC) conditions.								✓	~
For projections described in millimetres, the leading edge of each eave, pergola, verandah, balcony or awning must be no more than 500 mm above the head of the window or glazed door and no more than 2400 mm above the sill.								✓	✓
Pergolas with polycarbonate roof or similar translucent material must have a shading coefficient of less than 0.35.								✓	~
Pergolas with fixed battens must have battens parallel to the window or glazed door above which they are situated, unless the pergola also shades a perpendicular window. The spacing between battens must not be more than 50 mm.								✓	~
Windows a	nd glazed	doors g	lazing r	equiremer	nts				
	Vindow / door Orientation Area of Overshadowing Shading device Frame and glass type								
no.		glass inc. frame (m2)	Height (m)	Distance (m)					
W1	E	3.036	0	0	eave/verandah/pergola/balcony >=750 mm	standard aluminium, single toned, (or U-value: 7.57, SHGC: 0.57)			
W2	E	3.036	0	0	eave/verandah/pergola/balcony >=750 mm	standard aluminium, single toned, (or U-value: 7.57, SHGC: 0.57)			
W3	E	1.24	0	0	eave/verandah/pergola/balcony >=750 mm	standard aluminium, single toned, (or U-value: 7.57, SHGC: 0.57)			
W4	S	1.24	0	0	eave/verandah/pergola/balcony >=750 mm	standard aluminium, single clear, (or U-value: 7.63, SHGC: 0.75)			
W5	S	1.24	0	0	eave/verandah/pergola/balcony >=750 mm	standard aluminium, single clear, (or U-value: 7.63, SHGC: 0.75)			
Glazing req	uirements						Show on DA Plans	Show on CC/CDC	Certifier Check

Glazing req	uirements							DA Plans	CC/CDC Plans & specs	Check
Window / doo no.	r Orientation	Area of glass inc. frame (m2)	Oversha Height (m)	Distance (m)	Shading device		Frame and glass type			
W6	W	2.89	0	0	eave/verandah/pergola >=750 mm	a/balcony	standard aluminium, single clear, (or U-value: 7.63, SHGC: 0.75)			
W7	N	1.88	0	0	eave/verandah/pergola >=750 mm	a/balcony	standard aluminium, single clear, (or U-value: 7.63, SHGC: 0.75)			
W8	N	1.88	0	0	eave/verandah/pergola >=750 mm	a/balcony	standard aluminium, single clear, (or U-value: 7.63, SHGC: 0.75)			
W9	N	0.94	0	0	eave/verandah/pergola >=750 mm	a/balcony	standard aluminium, single clear, (or U-value: 7.63, SHGC: 0.75)			
D1	E	2.16	0	0	eave/verandah/pergola >=900 mm	a/balcony	standard aluminium, single clear, (or U-value: 7.63, SHGC: 0.75)			
D5	W	5.42	0	0	eave/verandah/pergola >=900 mm	a/balcony	standard aluminium, single clear, (or U-value: 7.63, SHGC: 0.75)			
Skylights									_	
The applicant	must install th	e skylight	s in accor	dance with th	ne specifications listed in	n the table b	elow.	✓	✓	~
The following requirements must also be satisfied in relation to each skylight:							✓	~		
Each skylight may either match the description, or, have a U-value and a Solar Heat Gain Coefficient (SHGC) no greater than that listed in the table below.							✓	✓		
Skylights g	lazing requ	uiremen	ts					1		
Skylight number Area of glazing inc. frame (m2) Shading device Frame and glass type										
S1	1.29 no shading timber, low-E internal/argon fill/clear external, (or U-value: 2.5, SHGC: 0.456)									
S2	0.75		no shad	o shading aluminium, moulded plastic single clear, (or U-value:						

Glazing require	ments			Show or DA Plan	Certifier Check
Skylight number	Area of glazing inc. frame (m2)	Shading device	Frame and glass type		
			6.21, SHGC: 0.808)		

CLIENT

Ben & Prue Scully

DRAWING NO.

DRAWING NAME

BASIX COMMITMENTS -ALTERATIONS & ADDITIONS

PROJECT ADDRESS

No. 120 Garden Street. North Narrabeen NSW 2101

DATE 06 February 2019

DA15

SCALE

@A3