



60 HUDSON PRD, AVALON BEACH, NSW 2170 ALTERATIONS & ADDITIONS TO EXISTING RESIDENCE

ARCHITECTURAL DRAWING LIST

DV	VG NO.	TITLE
DA	A_000	COVER SHEET
DA	A_001	BASIX COMMITMENTS
DA	A_002	SITE ANALYSIS PLAN
DA	A_003	SITE PLAN
DA	A_004	${\tt DEMOLITION\ PLANS\ _LOWER\ GROUND\ +\ GROUND\ FLOOR}$
DA	A_005	DEMOLITION PLANS _ LEVEL 01 + ROOF
DA	A_100	PROPOSED LOWER GROUND FLOOR PLAN
DA	A_101	PROPOSED GROUND FLOOR PLAN
DA	A_102	PROPOSED FIRST FLOOR PLAN
DA	A_103	PROPOSED ROOF PLAN
DA	A_112	CUT AND FILL PLAN
DA	A_200	EAST + WEST ELEVATIONS
DA	A_201	NORTH + SOUTH ELEVATIONS
DA	A_210	LONGITUDINAL SECTION
DA	A_211	CROSS SECTIONS
DA	A_301	SHADOW DIAGRAMS - SUN'S EYE VIEW
DA	A_302	SHADOW DIAGRAMS - SUN'S EYE VIEW

SCHEDULE OF COLOURS AND MATERIALS

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ION SCHEDU	ILE		LEGEND / KE
Date	Issued By	Revision Notes	
27/9/22	AH	DEVELOPMENT APPLICATION	
	Date	27/9/22 AH	Date Issued By Revision Notes



Project:
ALTS & ADS TO EXISTING HOUSE
60 HUDSON PDE, CLAREVILLE NSW 2107

OLIVER & NICOLA HARTLEY

Drawing Name: COVER SHEET

DA_500

Job Number:	Z
2130	-
Scale:	
NTS	
Plot Date:	
27/9/22	
Drawing Status:	Drawn By:

DA

Drawing No: **DA_000**

LR

Revision:

BASIX INCLUSIONS FOR ALTERATIONS AND ADDITIONS TO EXISTING DWELLING AS PER CERTIFICATE A470828:

STORMWATER TANK

THE APPLICANT MUST INSTALL A RAINWATER TANK OF AT LEAST 2056 LITRES ON THE SITE. THIS RAINWATER TANK MUST MEET, AND BE INSTALLED IN ACCORDANCE WITH, THE REQUIREMENTS OF ALL APPLICABLE REGULATORY AUTHORITIES.

THE APPLICANT MUST CONFIGURE THE RAINWATER TANK TO COLLECT RAINWATER RUNOFF FROM AT LEAST 90 SQUARE METRES OF ROOF AREA.

THE APPLICANT MUST CONNECT THE RAINWATER TANK TO A TAP LOCATED WITHIN 10 METRES OF THE EDGE OF THE POOL.

POOL AND SPA

THE SWIMMING POOL MUST BE OUTDOORS.

THE SWIMMING POOL MUST NOT HAVE A CAPACITY GREATER THAN 75 KILOLITRES.

THE SWIMMING POOL MUST HAVE A POOL COVER.

THE APPLICANT MUST INSTALL A POOL PUMP TIMER FOR THE SWIMMING POOL.

THE APPLICANT MUST INSTALL THE FOLLOWING HEATING SYSTEM FOR THE SWIMMING POOL THAT IS PART OF THIS DEVELOPMENT: SOLAR (ELECTRIC BOOSTED).

HOT WATER

THE APPLICANT MUST INSTALL THE FOLLOWING HOT WATER SYSTEM IN THE DEVELOPMENT: ELECTRIC STORAGE PLUS PHOTOVOLTAIC SYSTEM.

THE APPLICANT MUST INSTALL A PHOTOVOLTAIC SYSTEM WITH A CAPACITY TO GENERATE AT LEAST 2.9 PEAK KILOWATTS OF ELECTRICITY AS PART OF THE DEVELOPMENT. THE APPLICANT MUST CONNECT THIS SYSTEM TO THE DEVELOPMENT'S ELECTRICAL SYSTEM.

CONSTRUCTION

THE APPLICANT MUST CONSTRUCT THE NEW OR ALTERED CONSTRUCTION (FLOOR(S), WALLS, AND CEILINGS/ROOFS) IN ACCORDANCE WITH THE SPECIFICATIONS LISTED IN THE TABLE BELOW, EXCEPT THAT A) ADDITIONAL INSULATION IS NOT REQUIRED WHERE THE AREA OF NEW CONSTRUCTION IS LESS THAN 2M2, B) INSULATION SPECIFIED IS NOT REQUIRED FOR PARTS OF ALTERED CONSTRUCTION WHERE INSULATION ALREADY EXISTS.

Construction	Additional insulation required (R-value)	Other specifications
concrete slab on ground floor.	nil	
suspended floor with open subfloor: concrete (R0.6).	R0.9 (down) (or R1.50 including construction)	
external wall: framed (weatherboard, fibro, metal clad)	R1.30 (or R1.70 including construction)	
external wall: concrete panel/plasterboard (concrete: 200 mm)	R1.35 (or R1.70 including construction)	
internal wall shared with garage: plasterboard (R0.36)	nil	
raked ceiling, pitched/skillion roof: framed	ceiling: R3.00 (up), roof: foil/sarking	medium (solar absorptance 0.475 - 0.70)
flat ceiling, flat roof: concrete/bare internal	ceiling: R3.00 (up), roof: foil/sarking	medium (solar absorptance 0.475 - 0.70)

WINDOWS AND GLAZED DOORS

PROJECT, AND FOR THE PURPOSE SHOWN AT "STATUS."

THE APPLICANT MUST INSTALL THE WINDOWS, GLAZED DOORS AND SHADING DEVICES, IN ACCORDANCE WITH THE SPECIFICATIONS LISTED IN THE TABLE BELOW. RELEVANT OVERSHADOWING SPECIFICATIONS MUST BE SATISFIED FOR EACH WINDOW AND GLAZED DOOR.

THE FOLLOWING REQUIREMENTS MUST ALSO BE SATISFIED IN RELATION TO EACH WINDOW AND GLAZED DOOR:

EACH WINDOW OR GLAZED DOOR WITH STANDARD ALUMINIUM OR TIMBER FRAMES AND SINGLE CLEAR OR TONED GLASS MAY EITHER MATCH THE DESCRIPTION, OR, HAVE A U-VALUE AND A SOLAR HEAT GAIN COEFFICIENT (SHGC) NO GREATER THAN THAT LISTED IN THE TABLE BELOW. TOTAL SYSTEM U-VALUES AND SHGCS MUST BE CALCULATED IN ACCORDANCE WITH NATIONAL FENESTRATION RATING COUNCIL (NFRC) CONDITIONS.

FOR PROJECTIONS DESCRIBED IN MILLIMETRES, THE LEADING EDGE OF EACH EAVE, PERGOLA, VERANDAH, BALCONY OR AWNING MUST BE NO MORE THAN 500 MM ABOVE THE HEAD OF THE WINDOW OR GLAZED DOOR AND NO MORE THAN 2400 MM ABOVE THE SILL.

PERGOLAS WITH POLYCARBONATE ROOF OR SIMILAR TRANSLUCENT MATERIAL MUST HAVE A SHADING COEFFICIENT OF LESS THAN 0.35.

PERGOLAS WITH FIXED BATTENS MUST HAVE BATTENS PARALLEL TO THE WINDOW OR GLAZED DOOR ABOVE WHICH THEY ARE SITUATED, UNLESS THE PERGOLA ALSO SHADES A PERPENDICULAR WINDOW. THE SPACING BETWEEN BATTENS MUST NOT BE MORE THAN 50 MM.

OVERSHADOWING BUILDINGS OR VEGETATION MUST BE OF THE HEIGHT AND DISTANCE FROM THE CENTRE AND THE BASE OF THE WINDOW AND GLAZED DOOR, AS SPECIFIED IN THE 'OVERSHADOWING' COLUMN IN THE TABLE BELOW.

Window / door	Orientation	Area of	Oversha	dowing	Shading device	Frame and glass type
no.		glass inc. frame (m2)	Height (m)	Distance (m)		
WLG.1	W	6.2	13.5	6.5	eave/verandah/pergola/balcony >=600 mm	timber or uPVC, single toned, (or U-value: 5.67, SHGC: 0.49)
WLG.2	N	7.9	0	0	eave/verandah/pergola/balcony >=600 mm	timber or uPVC, single toned, (or U-value: 5.67, SHGC: 0.49)
WLG.6	N	4.1	0	0	eave/verandah/pergola/balcony >=750 mm	timber or uPVC, single toned, (or U-value: 5.67, SHGC: 0.49)
WLG.7	W	2.2	7.2	2	none	timber or uPVC, single toned, (or U-value: 5.67, SHGC: 0.49)

Window / door no.	Orientation	Area of glass	Oversha		Shading device	Frame and glass type
		inc. frame (m2)	Height (m)	Distance (m)		
W1.6, W1.7	N	7.5	0	0	eave/verandah/pergola/balcony >=900 mm	timber or uPVC, single toned, (or U-value: 5.67, SHGC: 0.49)
W1.8	N	3.1	0	0	eave/verandah/pergola/balcony >=750 mm	timber or uPVC, single toned, (or U-value: 5.67, SHGC: 0.49)
W1.9	N	5.8	0	0	eave/verandah/pergola/balcony >=900 mm	timber or uPVC, single toned, (or U-value: 5.67, SHGC: 0.49)
W1.10	E	2.3	0	0	eave/verandah/pergola/balcony >=900 mm	timber or uPVC, single toned, (or U-value 5.67, SHGC: 0.49)
W1.11,1.12	S	5.3	0	0	none	timber or uPVC, single toned, (or U-value 5.67, SHGC: 0.49)
W1.13	W	1.25	4.5	2	none	timber or uPVC, single toned, (or U-value 5.67, SHGC: 0.49)
W2.5	N	1.5	0	0	eave/verandah/pergola/balcony >=900 mm	timber or uPVC, single toned, (or U-value 5.67, SHGC: 0.49)
W2.6	W	3.1	0	0	eave/verandah/pergola/balcony >=900 mm	timber or uPVC, single toned, (or U-value 5.67, SHGC: 0.49)
W2.7	N	4.8	0	0	eave/verandah/pergola/balcony >=600 mm	timber or uPVC, single toned, (or U-value 5.67, SHGC: 0.49)
W2.8	Е	1.5	0	0	eave/verandah/pergola/balcony >=750 mm	timber or uPVC, single toned, (or U-value 5.67, SHGC: 0.49)
W2.9	N	1.5	0	0	eave/verandah/pergola/balcony >=900 mm	timber or uPVC, single toned, (or U-value: 5.67, SHGC: 0.49)
W2.10	N	7	0	0	eave/verandah/pergola/balcony >=600 mm	timber or uPVC, single toned, (or U-value 5.67, SHGC: 0.49)
W2.11	Е	3.8	0	0	eave/verandah/pergola/balcony >=600 mm	timber or uPVC, single toned, (or U-value 5.67, SHGC: 0.49)
W2.12	E	2.9	0	0	eave/verandah/pergola/balcony >=900 mm	timber or uPVC, single toned, (or U-value 5.67, SHGC: 0.49)
W213,14,15	S	8.5	0	0	eave/verandah/pergola/balcony >=450 mm	timber or uPVC, single toned, (or U-value 5.67, SHGC: 0.49)
W2.21	N	10.1	0	0	eave/verandah/pergola/balcony >=900 mm	timber or uPVC, single toned, (or U-value 5.67, SHGC: 0.49)
W2.22	N	8.6	0	0	eave/verandah/pergola/balcony >=900 mm	timber or uPVC, single toned, (or U-value: 5.67, SHGC: 0.49)
W2.23	N	10.1	0	0	eave/verandah/pergola/balcony >=900 mm	timber or uPVC, single toned, (or U-value 5.67, SHGC: 0.49)
W3.1 32 33	W	17	0	0	eave/verandah/pergola/balcony >=750 mm	timber or uPVC, single toned, (or U-value 5.67, SHGC: 0.49)
W3.4	E	11.6	0	0	eave/verandah/pergola/balcony >=900 mm	timber or uPVC, single toned, (or U-value 5.67, SHGC: 0.49)
W3.5	Е	2.7	2.7	1.2	eave/verandah/pergola/balcony >=600 mm	timber or uPVC, single toned, (or U-value 5.67, SHGC: 0.49)
W4.1	W	2	0	0	eave/verandah/pergola/balcony >=750 mm	timber or uPVC, single toned, (or U-value 5.67, SHGC: 0.49)
W4.2	N	3.5	0	0	eave/verandah/pergola/balcony >=900 mm	timber or uPVC, single toned, (or U-value 5.67, SHGC: 0.49)
W4.3	W	2.8	0	0	eave/verandah/pergola/balcony >=900 mm	timber or uPVC, single toned, (or U-value 5.67, SHGC: 0.49)
W4.4,W4.5	N	1.9	0	0	eave/verandah/pergola/balcony >=900 mm	timber or uPVC, single toned, (or U-value 5.67, SHGC: 0.49)
W4.6	N	4.7	0	0	eave/verandah/pergola/balcony >=600 mm	timber or uPVC, single toned, (or U-value 5.67, SHGC: 0.49)
W4.7	N	3.7	0	0	eave/verandah/pergola/balcony >=900 mm	timber or uPVC, single toned, (or U-value 5.67, SHGC: 0.49)
W4.8	N	2.4	0	0	eave/verandah/pergola/balcony >=900 mm	timber or uPVC, single toned, (or U-value 5.67, SHGC: 0.49)
W4.9	S	3.24	0	0	eave/verandah/pergola/balcony >=450 mm	timber or uPVC, single toned, (or U-value 5.67, SHGC: 0.49)
WLG.5	Е	6.1	0	0	eave/verandah/pergola/balcony >=900 mm	timber or uPVC, single toned, (or U-value 5.67, SHGC: 0.49)
W2.16	W	2.2	2.8	2	none	timber or uPVC, single toned, (or U-value 5.67, SHGC: 0.49)
W3.6	N	2.7	0	0	eave/verandah/pergola/balcony >=900 mm	timber or uPVC, single toned, (or U-value 5.67, SHGC: 0.49)
W3.7	W	2.6	0	0	eave/verandah/pergola/balcony >=750 mm	timber or uPVC, single toned, (or U-value 5.67, SHGC: 0.49)
W4.10	W	3.5	0	0	eave/verandah/pergola/balcony >=900 mm	timber or uPVC, single toned, (or U-value 5.67, SHGC: 0.49)
WR.3,4,5	N	5	0	0	eave/verandah/pergola/balcony >=450 mm	timber or uPVC, single toned, (or U-value 5.67, SHGC: 0.49)

Skylights glazing requirements

Skylights glazing requirements						
Skylight number	Area of glazing inc. frame (m2)	Shading device	Frame and glass type			
S1	1.1	no shading	timber, low-E internal/argon fill/clear external, (or U-value: 2.5, SHGC: 0.456)			
S2	0.8	no shading	timber, low-E internal/argon fill/clear external, (or U-value: 2.5, SHGC: 0.456)			
S3	0.3	no shading	timber, low-E internal/argon fill/clear external, (or U-value: 2.5, SHGC: 0.456)			

NOTES

NOTES

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LEGEND / KEY



Project:
ALTS & ADS TO EXISTING HOUSE
60 HUDSON PDE, CLAREVILLE NSW 2107

Client:
OLIVER & NICOLA HARTLEY

Drawing Name:
BASIX COMMITMENTS

Job Number:

2130

Scale:
NTS


Plot Date:
27/9/22


Drawing Status:
DA

Drawing No:
DA

Drawing No:
DA_001

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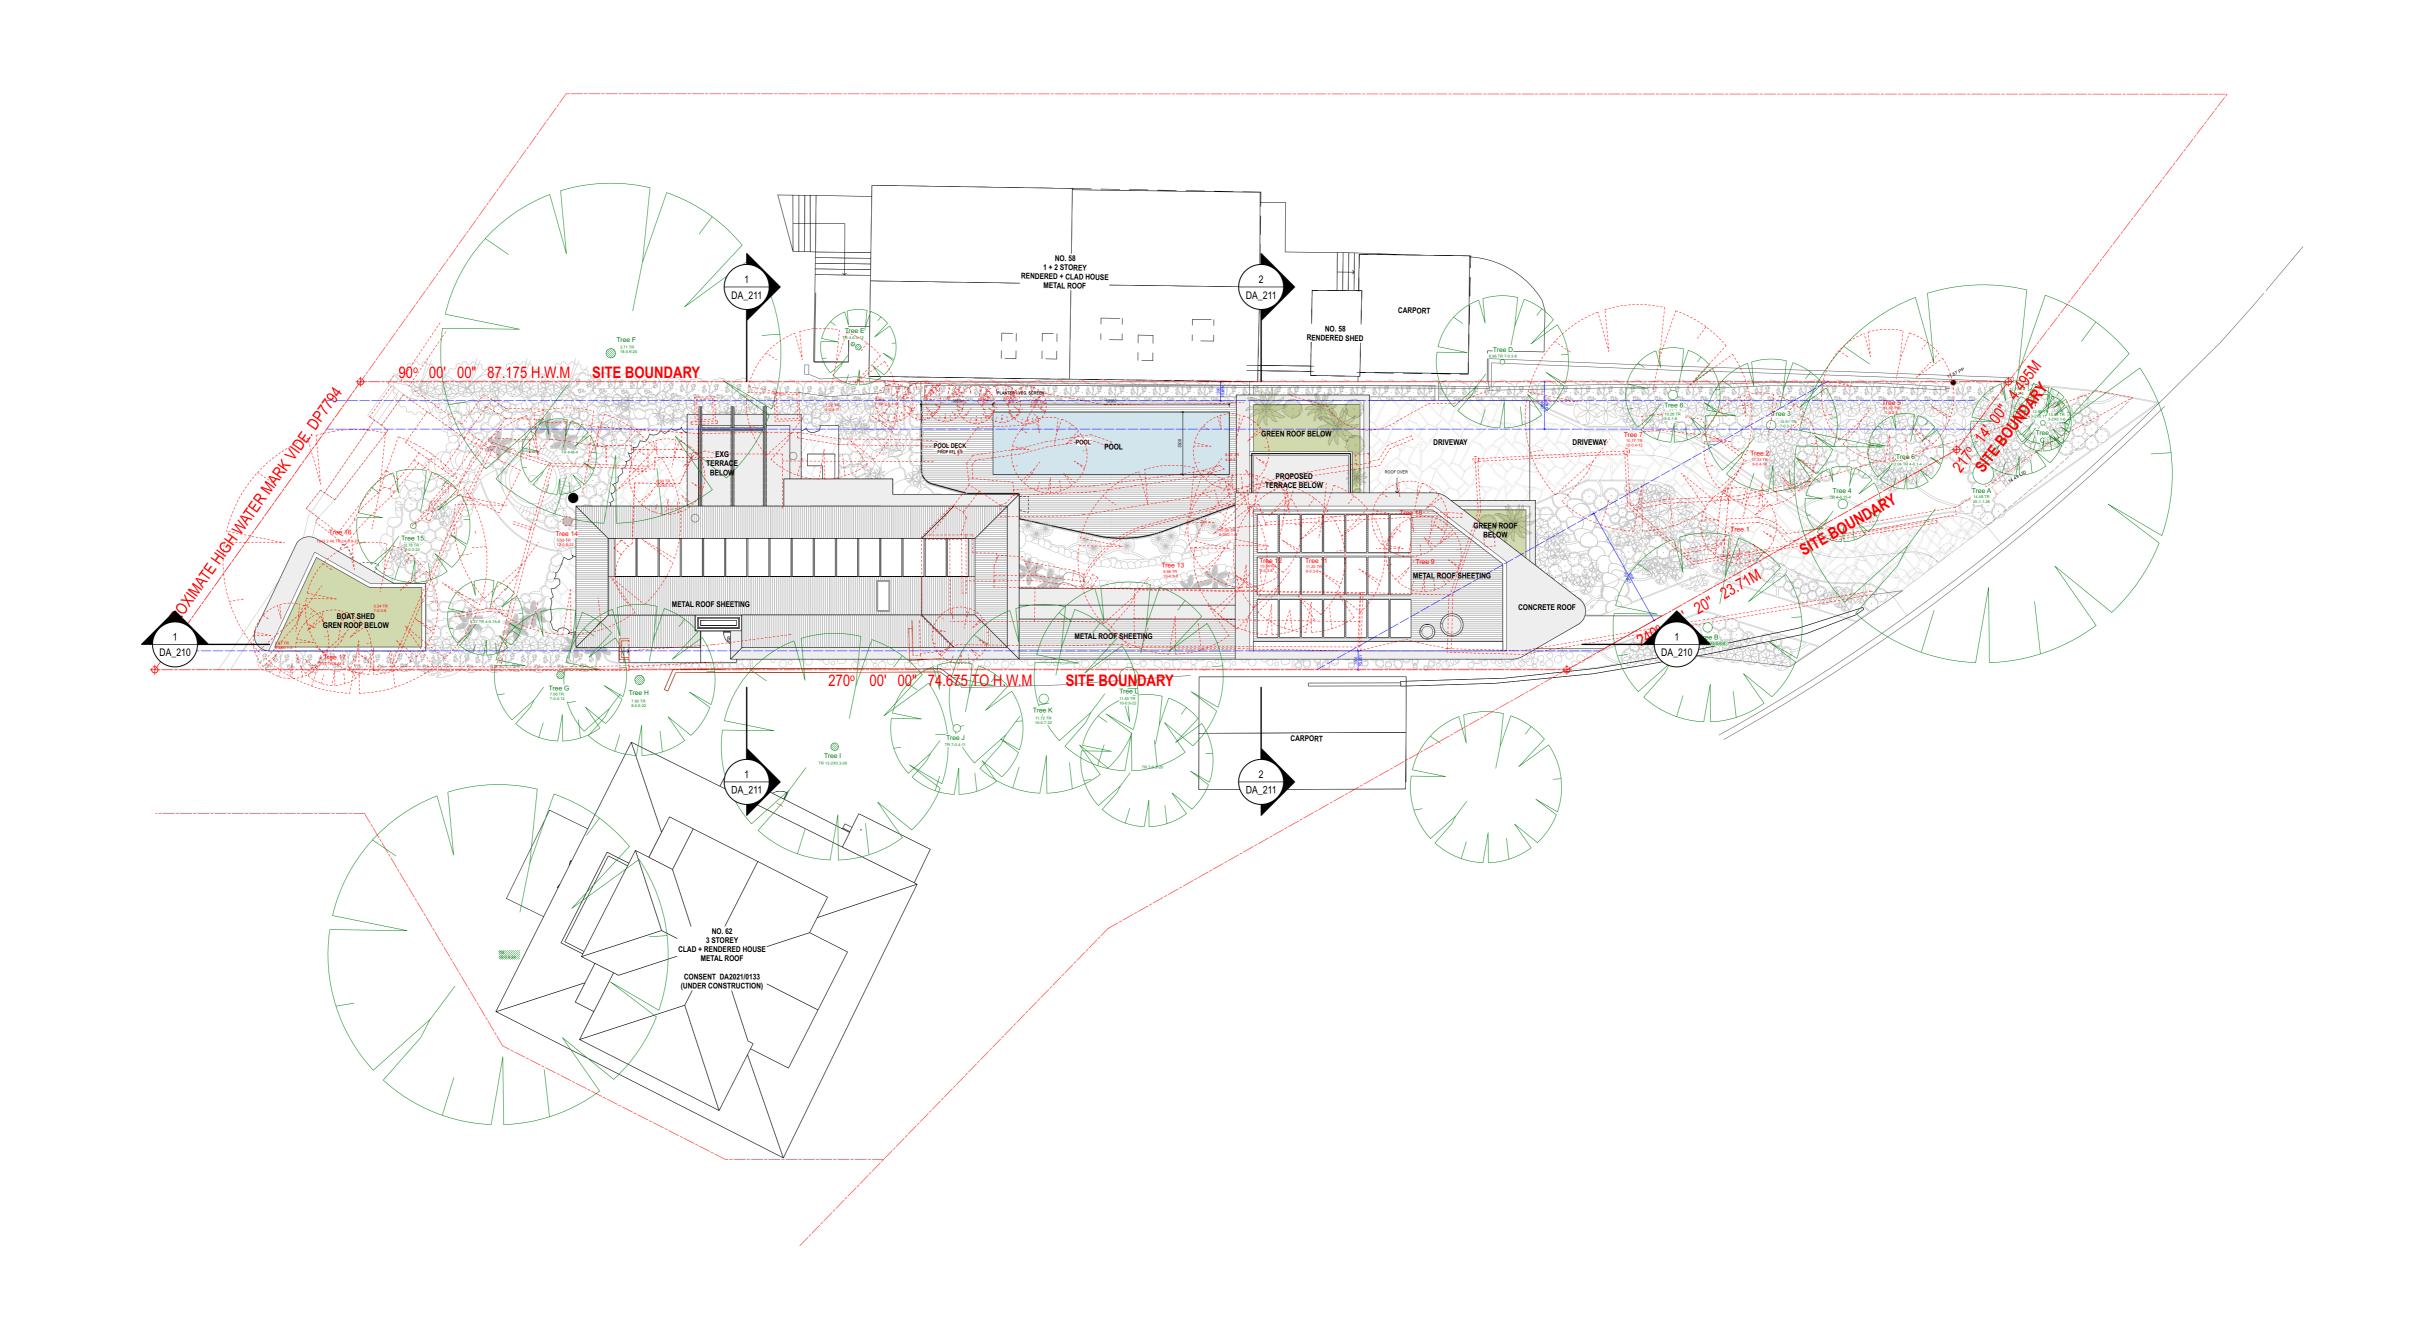
REVIS	ION SCHEDULE	=		LEGEND / KEY		
Rev.	Date	Issued By	Revision Notes	EXISTING LANDSCAPED AREA		
_A	27/9/22	AH	DEVELOPMENT APPLICATION	Externite Butbook Ebyther		
				EXISTING DEVELOPMENT		
				- BOUNDARY		
				-		
				DRIVEWAY ACCESS 🗸 00000	VIEWS	
				_		
				PEDESTRIAN ACCESS		
				- ·		

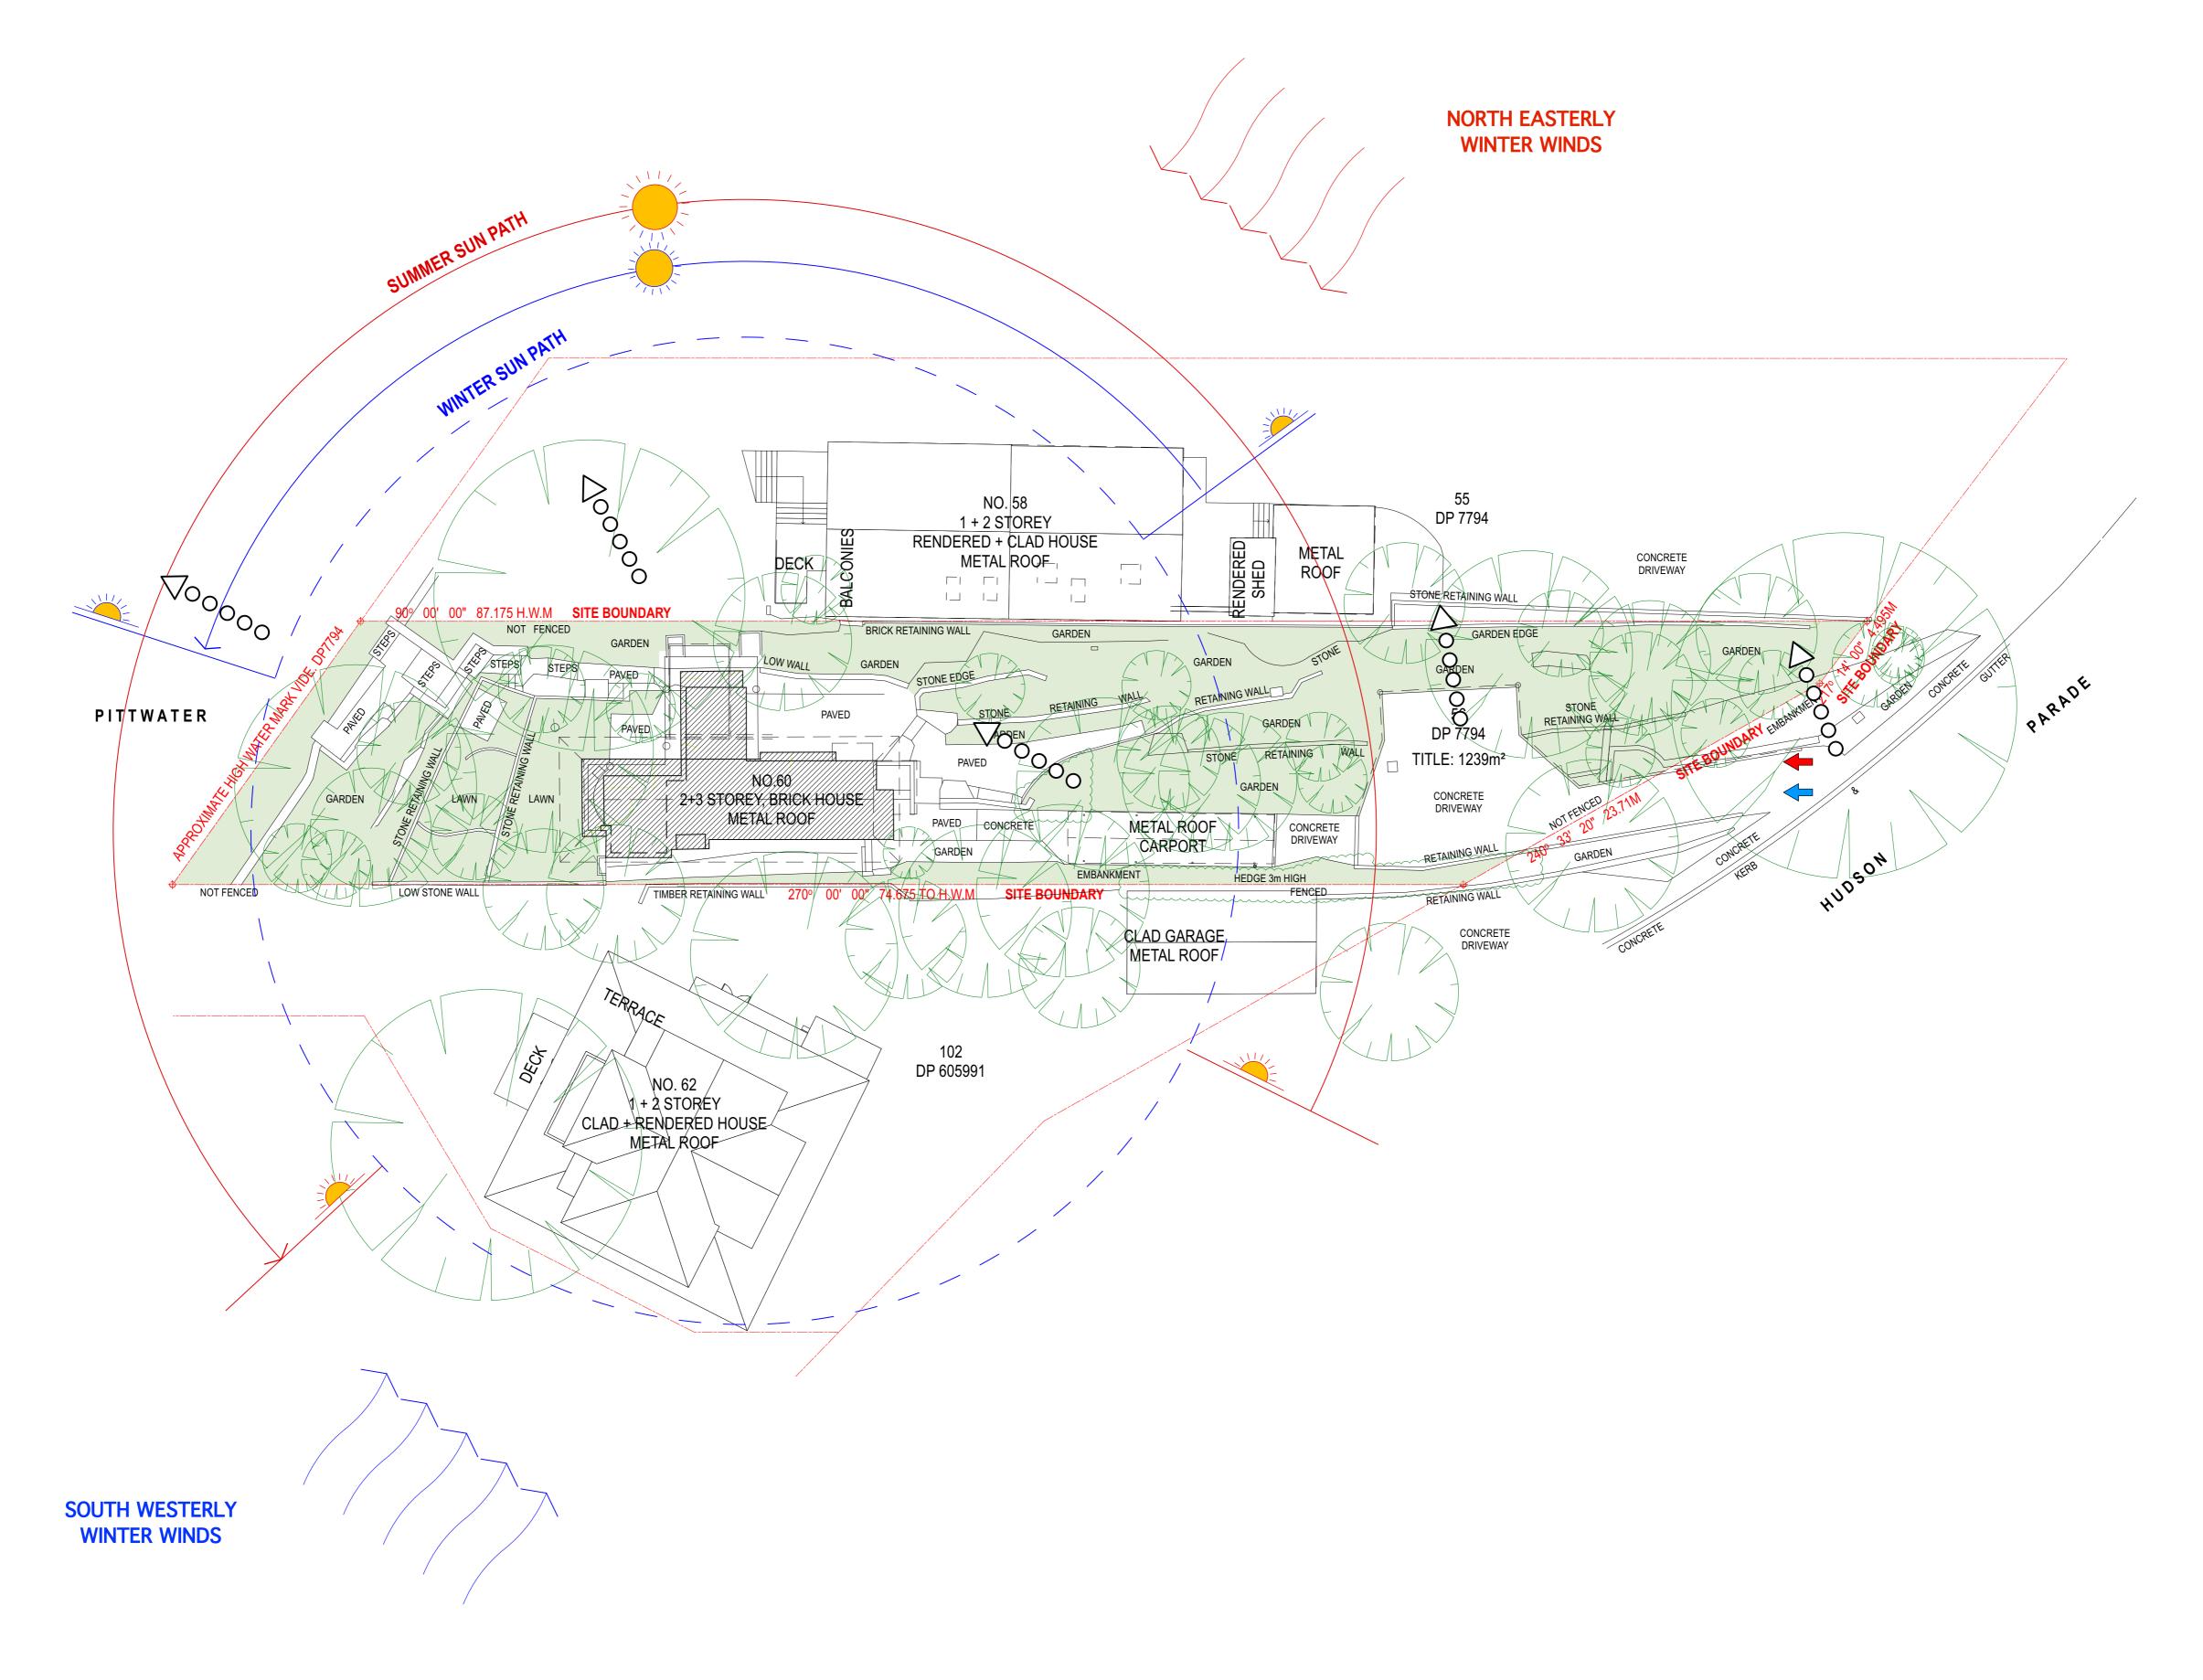

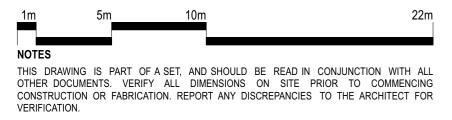Project: ALTS & ADS TO EXISTING HOU 60 HUDSON PDE, CLAREVILLE	
Client:	
OLIVER & NICOLA HARTLEY	

Job Number: 2130	Z
Scale: 1:200	
Plot Date: 27/9/22	
Drawing Status:	Drawn By:
DA	LR
Drawing No:	Revision:
DA_002	Α

SITE ANALYSIS PLAN



1m	5m	10m		22r
OTHER DO	OCUMENTS. VERIF	Y ALL DIMENSIONS	ON SITE PR	CONJUNCTION WITH AL IOR TO COMMENCIN TO THE ARCHITECT FO

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REVIS	ION SCHEDULE	•		LEGEND / KEY
Rev.	Date	Issued By	Revision Notes	- — - DEMOLISHED
Α	27/9/22	AH	DEVELOPMENT APPLICATION	- SETBACK
				DEMOLISHED TREE
				EXISTING TREE
				-



Project:		
ALTS & ADS TO EX	ISTING HOUSE LAREVILLE NSW 2107	
<u>, </u>	EARL VILLE NOW 2107	
Client: OLIVER & NICOLA	HADTLEV	
OLIVER & NICOLA	MARILET	

	Job Number: 2130	Ž	
_	Scale: 1:200		
	Plot Date: 27/9/22		
_	Drawing Status:	Drawn By:	
	DA	LR	
	Drawing No:	Revision:	
	DA 003	A	




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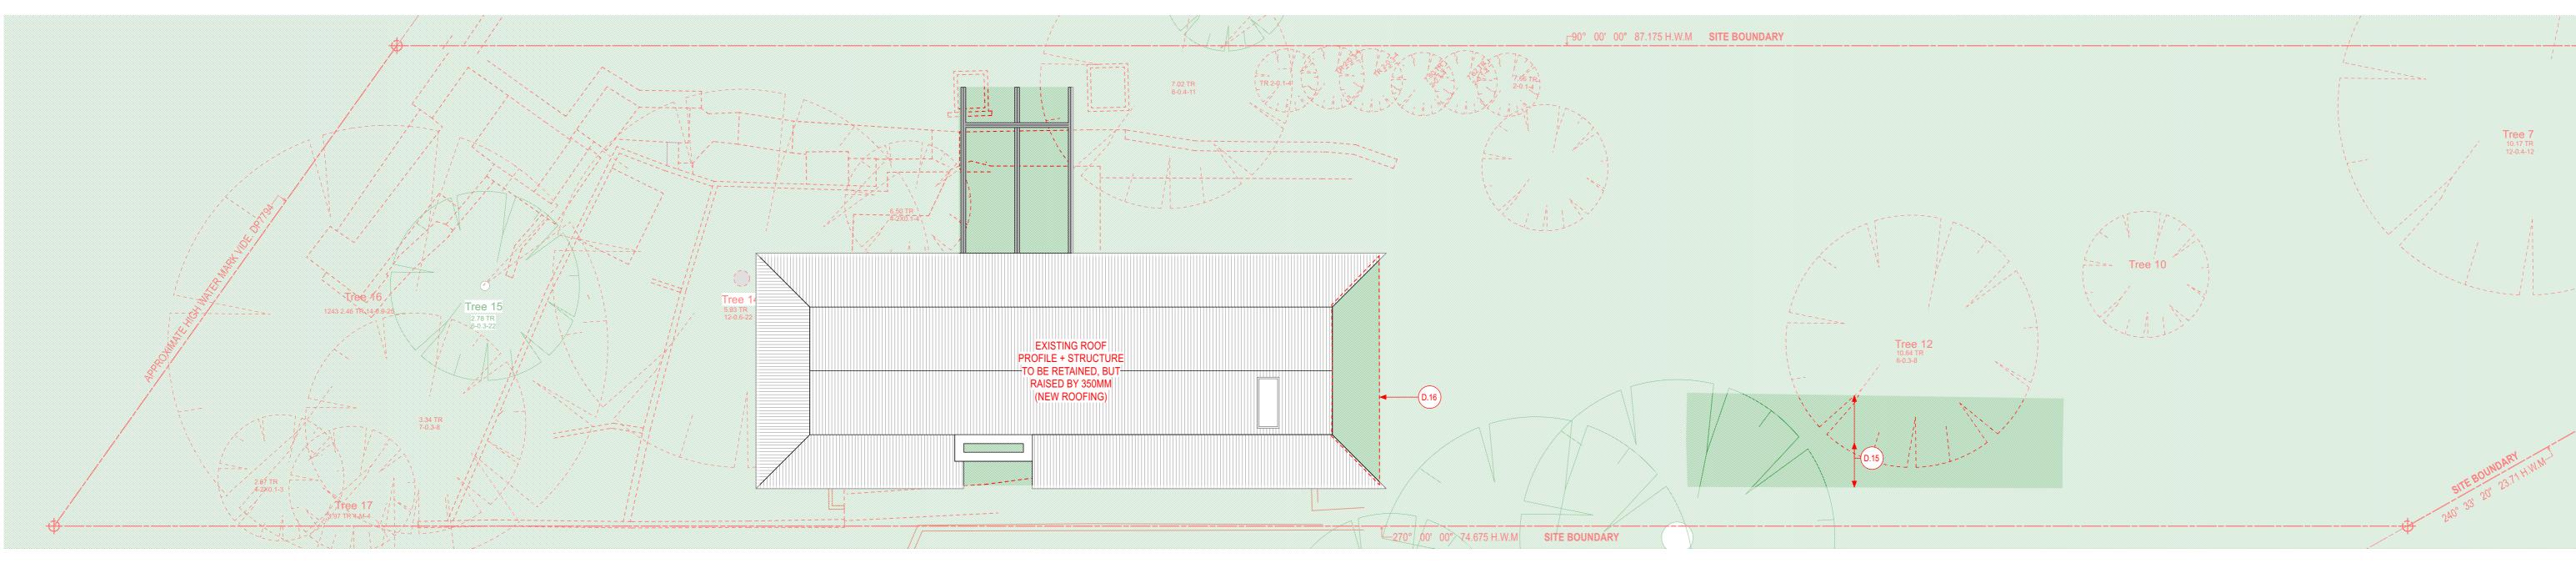
Bennett Murada Architects

nominated architect: Dominic Bennett 7365 (NSW)

DA_004

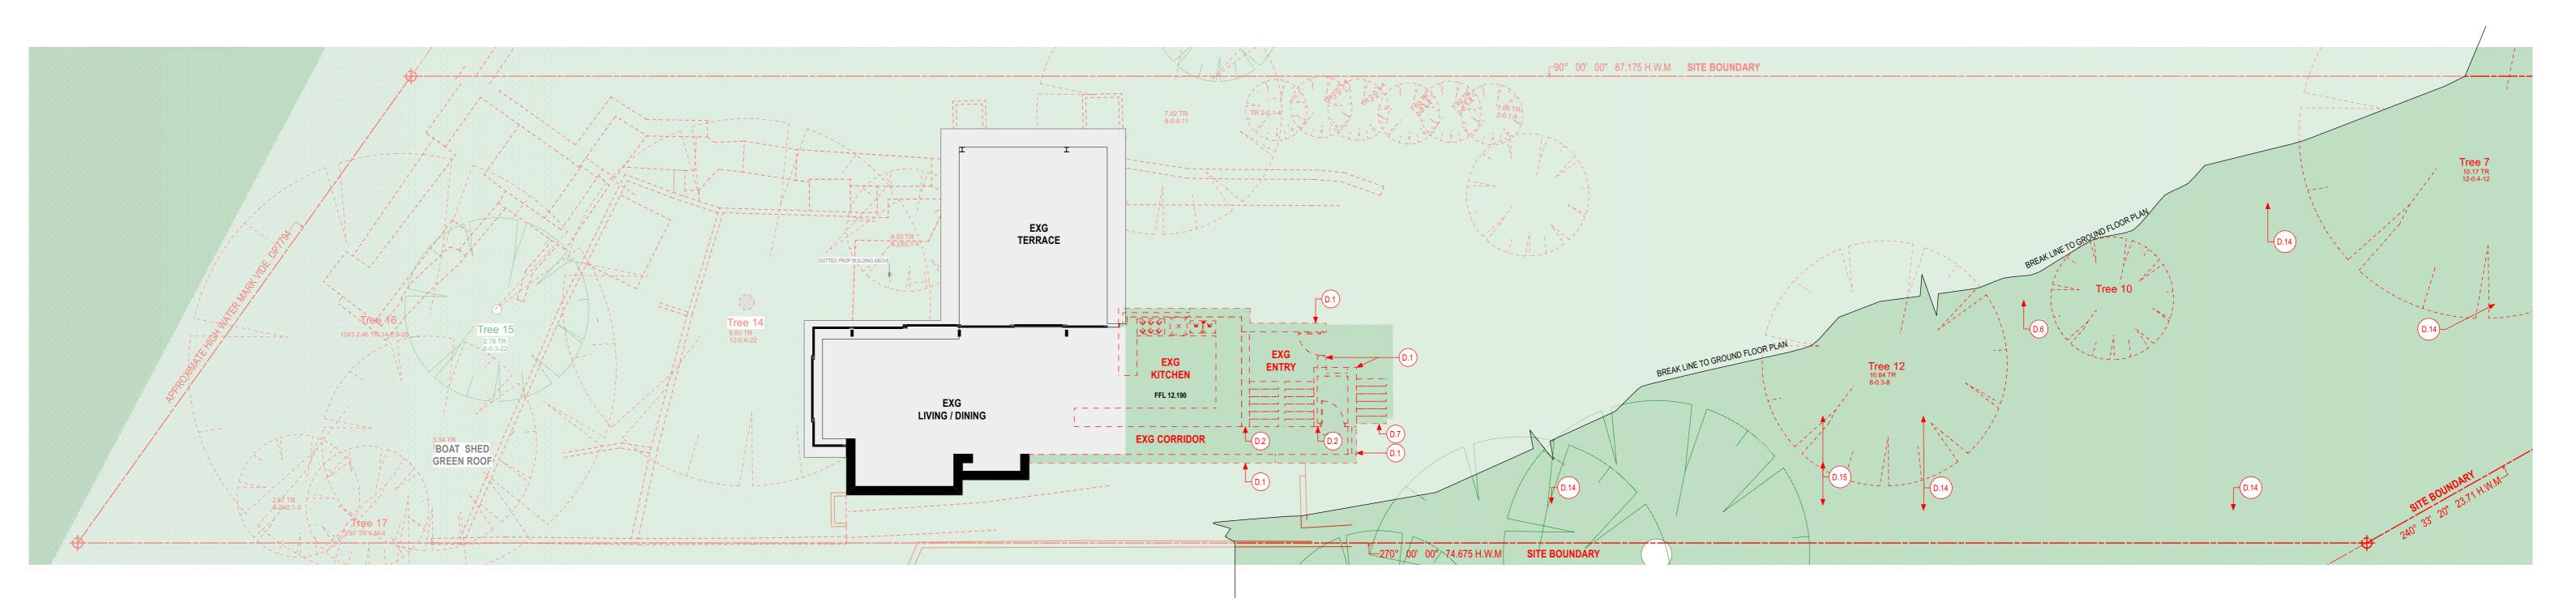

DEMOLITION PLAN_EXISTING FIRST FLOOR
Scale: 1:100



DEMOLITION PLAN_EXISTING ROOF PLAN
Scale: 1:100

- DEMOLITION NOTES

 1. DEMOLISH EXG EXTERNAL WALL AND ALL OPENINGS. EXTENT AS SHOWN ON DEMOLITION PLAN

 2. DEMOLISH EXG INTERNAL WALL AND ALL OPENINGS. EXTENT AS SHOWN ON DEMOLITION PLAN
- 3. N/A 4. N/A
- 5. N/A 6. DEMOLISH EXG LOW HEIGHT GARDEN EDGE7. DEMOLISH EXG EXTERNAL STAIRS
- 8. N/A
- 9. N/A 10. N/A
- 11. N/A
- 12. N/A 13. N/A
- 14. DEMOLISH EXG CONCRETE DRIVEWAY AND PATH
- 15. DEMOLISH EXG CARPORT ROOF STRUCTURE
 16. DEMOLISH PORTION OF METAL ROOF TO EXTEND

.5m 1m	2m		5m				10r	n	
NOTES									
OTHER DO	CUMENTS	PART OF A SE . VERIFY AL FABRICATION.	L DIMEN	SIONS ON	SITE	PRIOR TO	COM	IMENCING	i

VERIFICATION.	
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REVIS	ION SCHEDU	LEGEND / KEY		
Rev.	Date	Issued By	Revision Notes	EXISTING WALL
A	27/9/22	AH	DEVELOPMENT APPLICATION	DEMOLISHED WALL

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M	R/	0	
Bennett	Murada	Archite	ects

Drawing Name:

DEMOLITION PLANS - LEVEL 01 + ROOF


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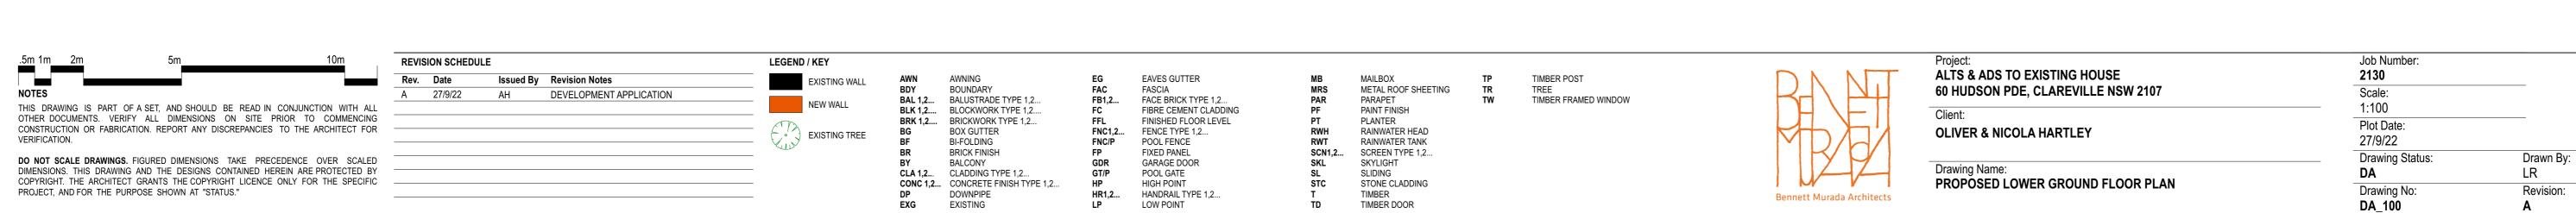
Project: ALTS & ADS TO EXISTING HOUSE	Job Number: 2130
60 HUDSON PDE, CLAREVILLE NSW 2107 Client:	Scale: 1:100
OLIVER & NICOLA HARTLEY	Plot Date:


Scale: 1:100 Plot Date: 27/9/22 Drawing Status: DA Drawing No: **DA_005**

Drawn By: LR

Revision:



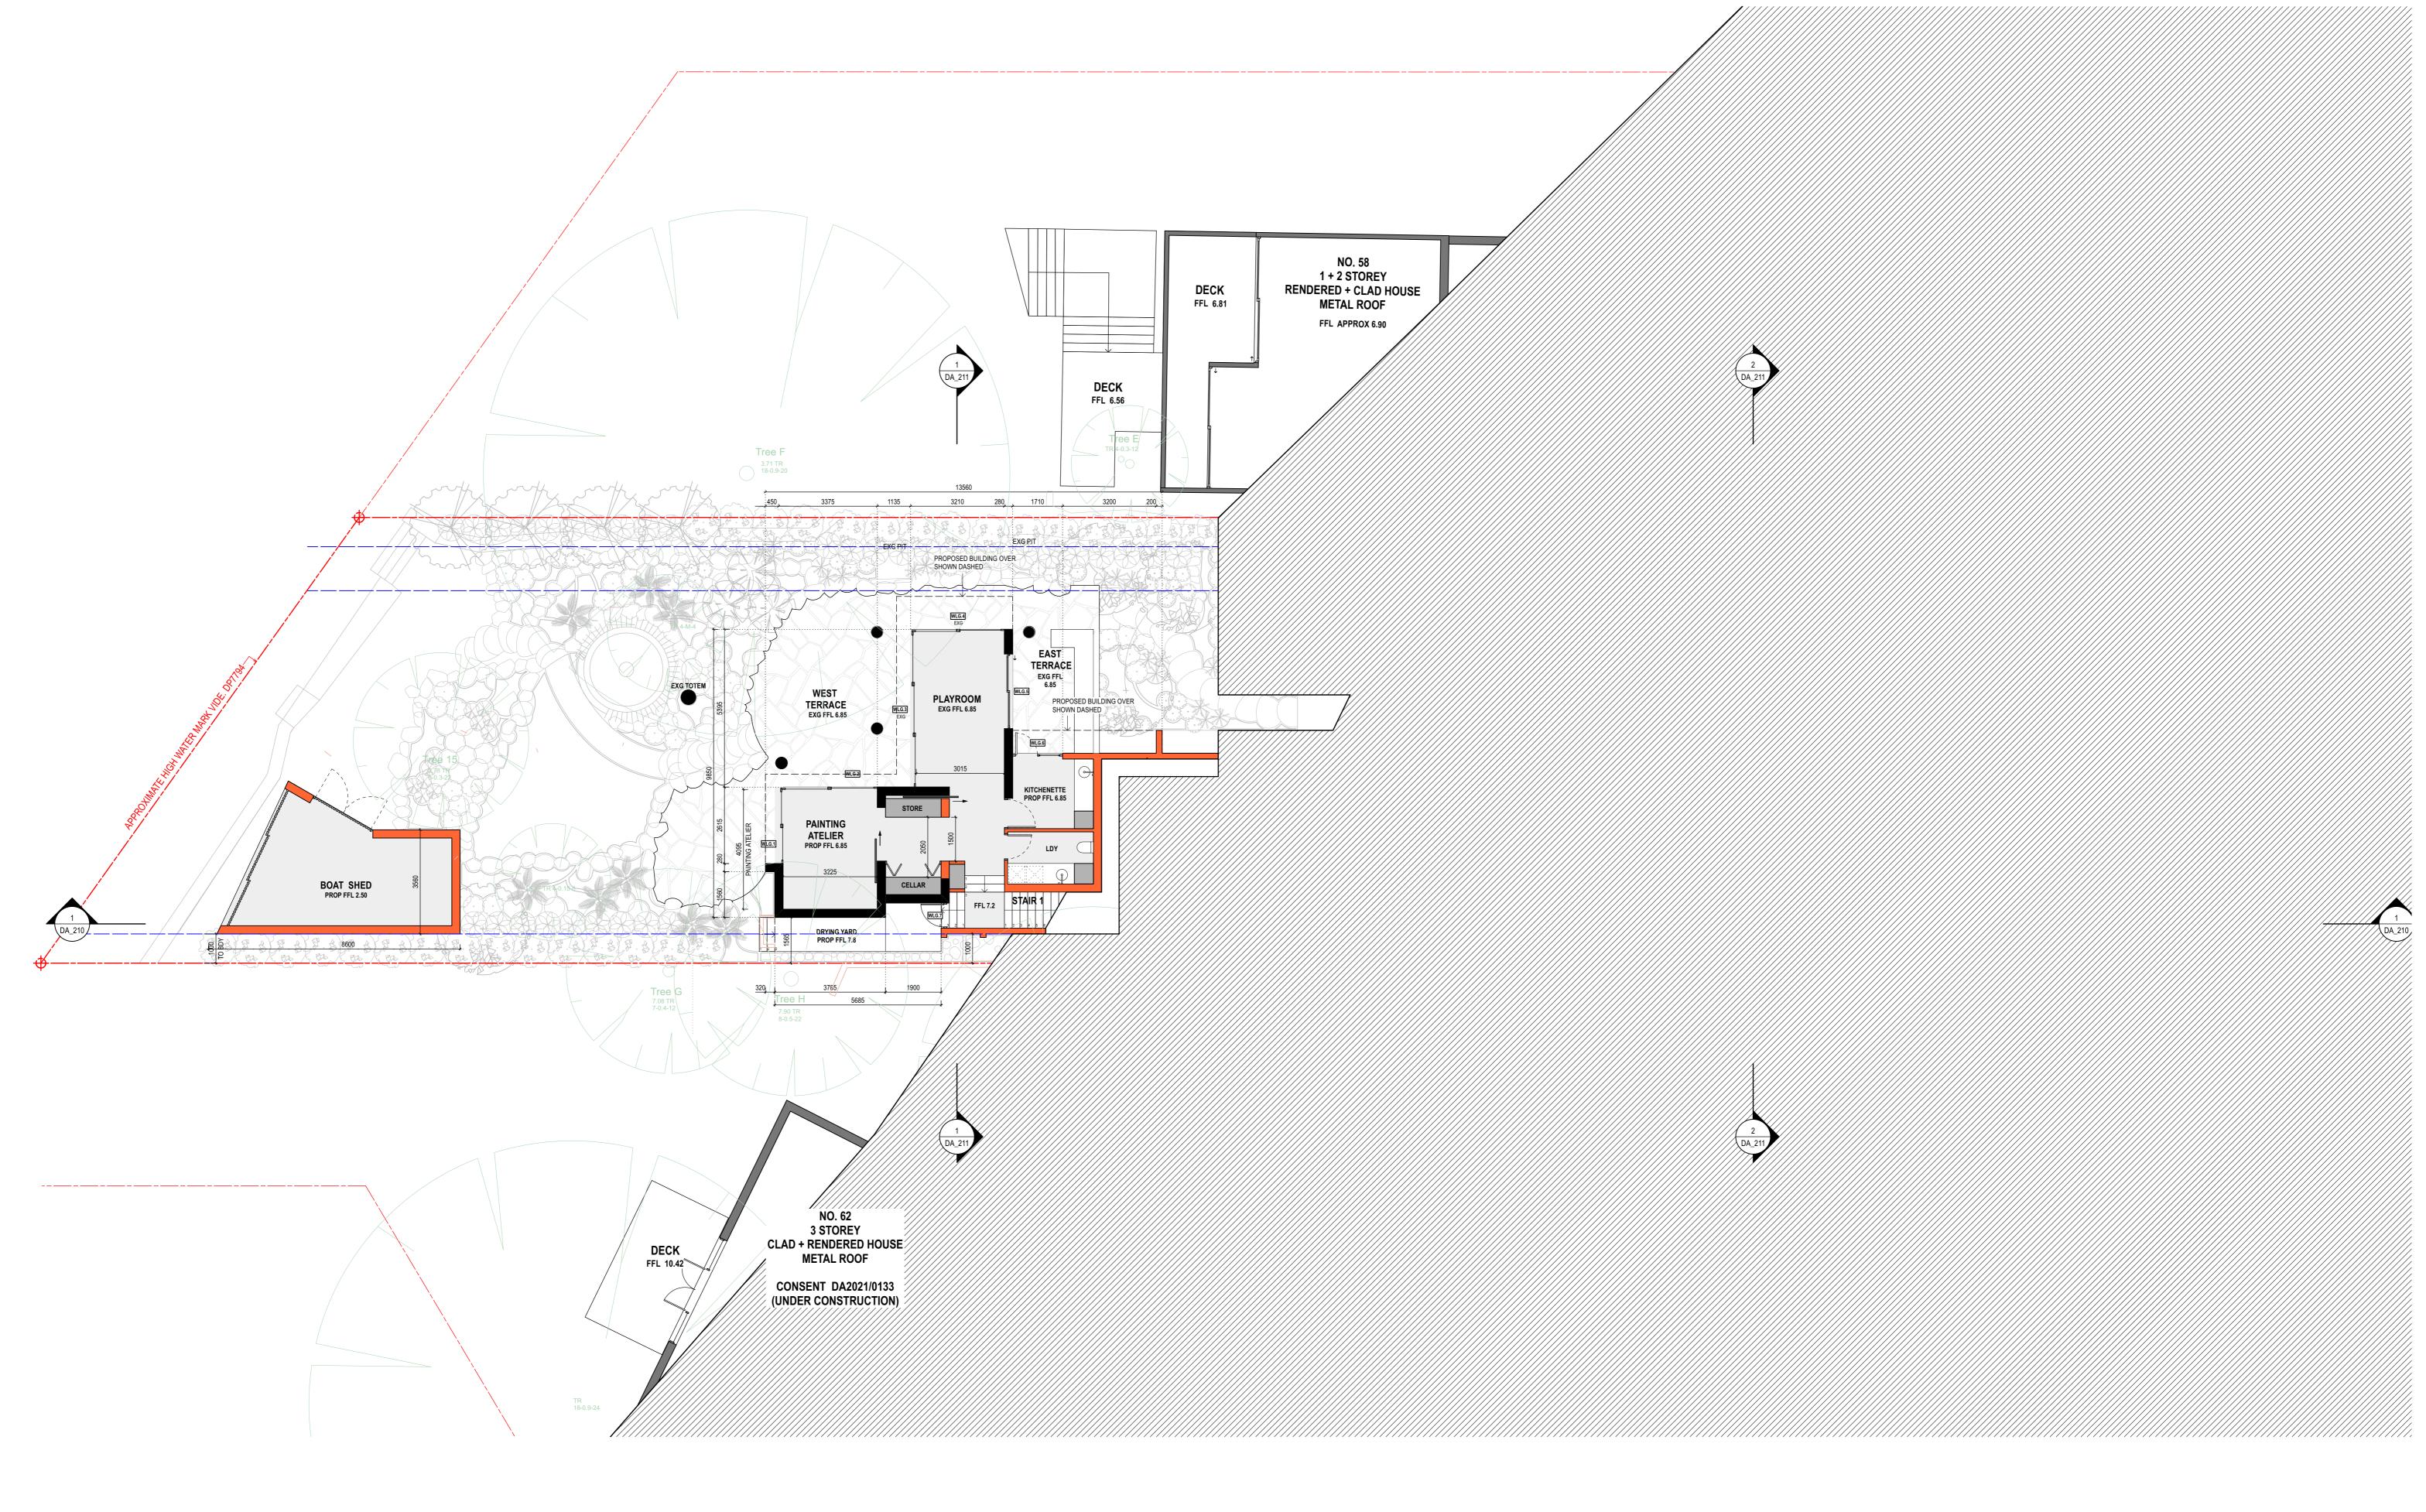

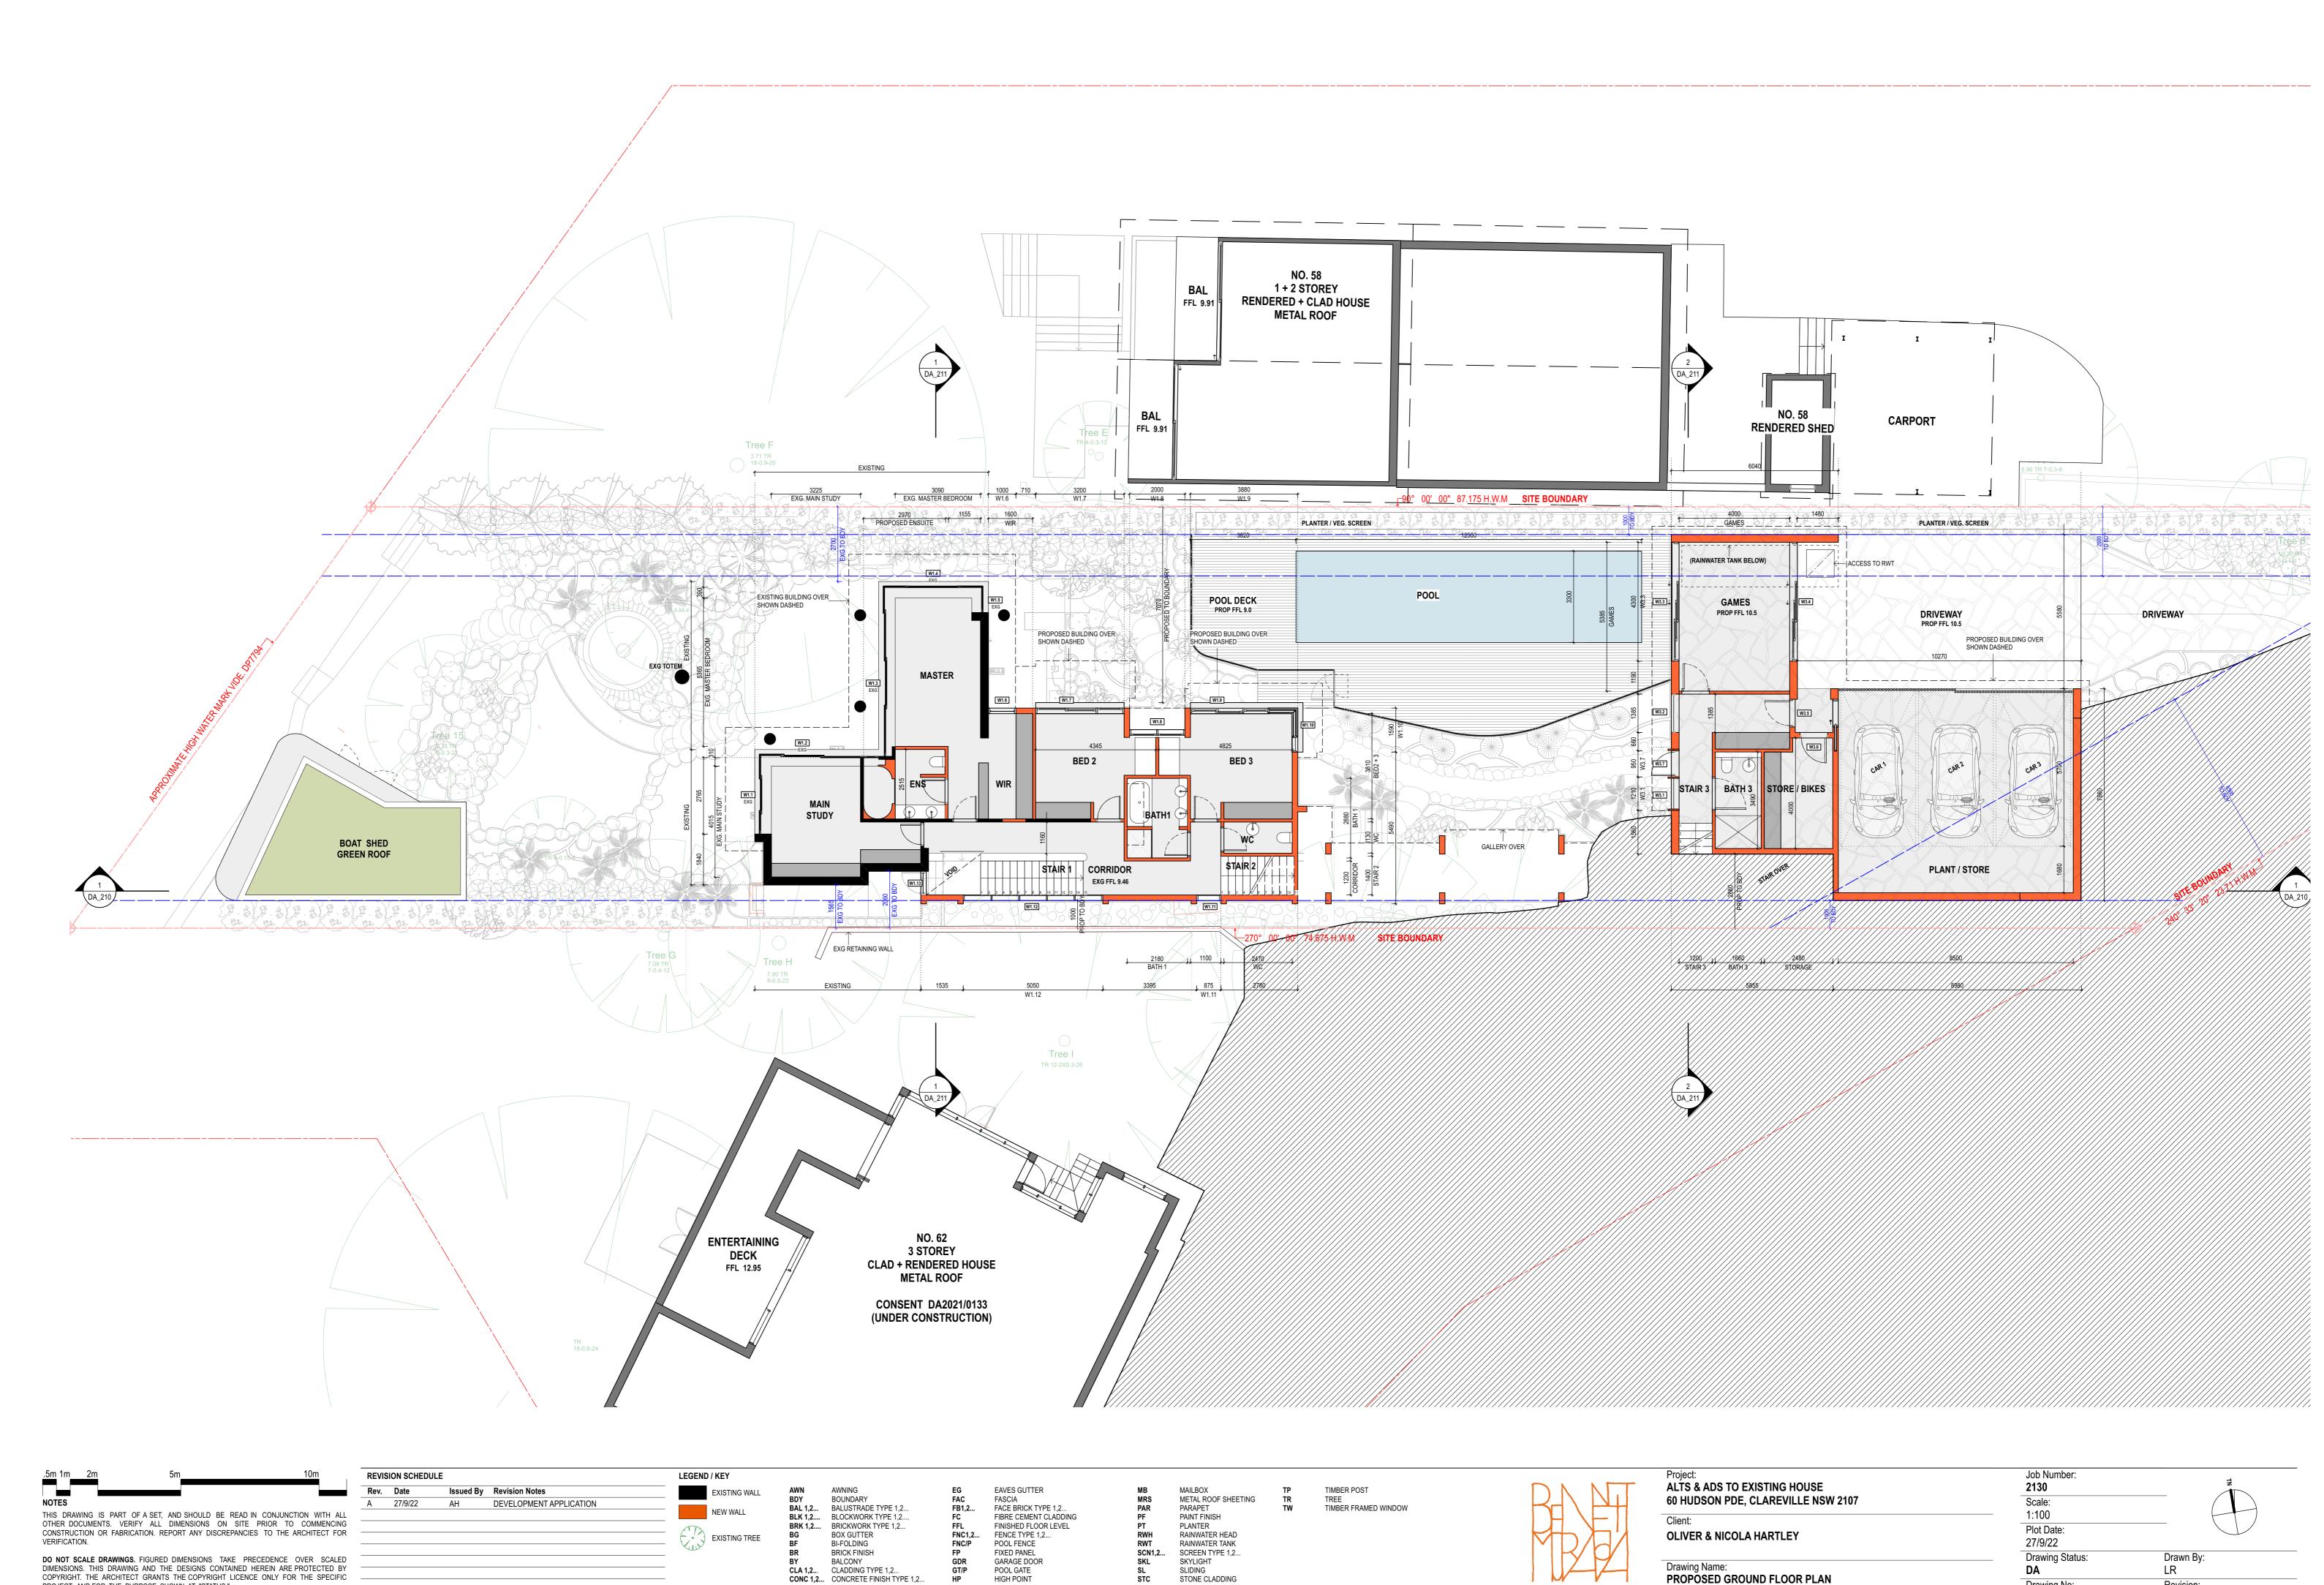

CONC 1,2... CONCRETE FINISH TYPE 1,2...
DP DOWNPIPE
EXG EXISTING

PROJECT, AND FOR THE PURPOSE SHOWN AT "STATUS."

HIGH POINT

LOW POINT

HANDRAIL TYPE 1,2...

STONE CLADDING

TIMBER DOOR

Suite 404, 1 Chandos Street, St Leonards, NSW 2065 ph.(02) 9043 9968 e.info@bennettmurada.com.au


Bennett Murada Architects


nominated architect: Dominic Bennett 7365 (NSW)


Revision:


Drawing No:

DA_101

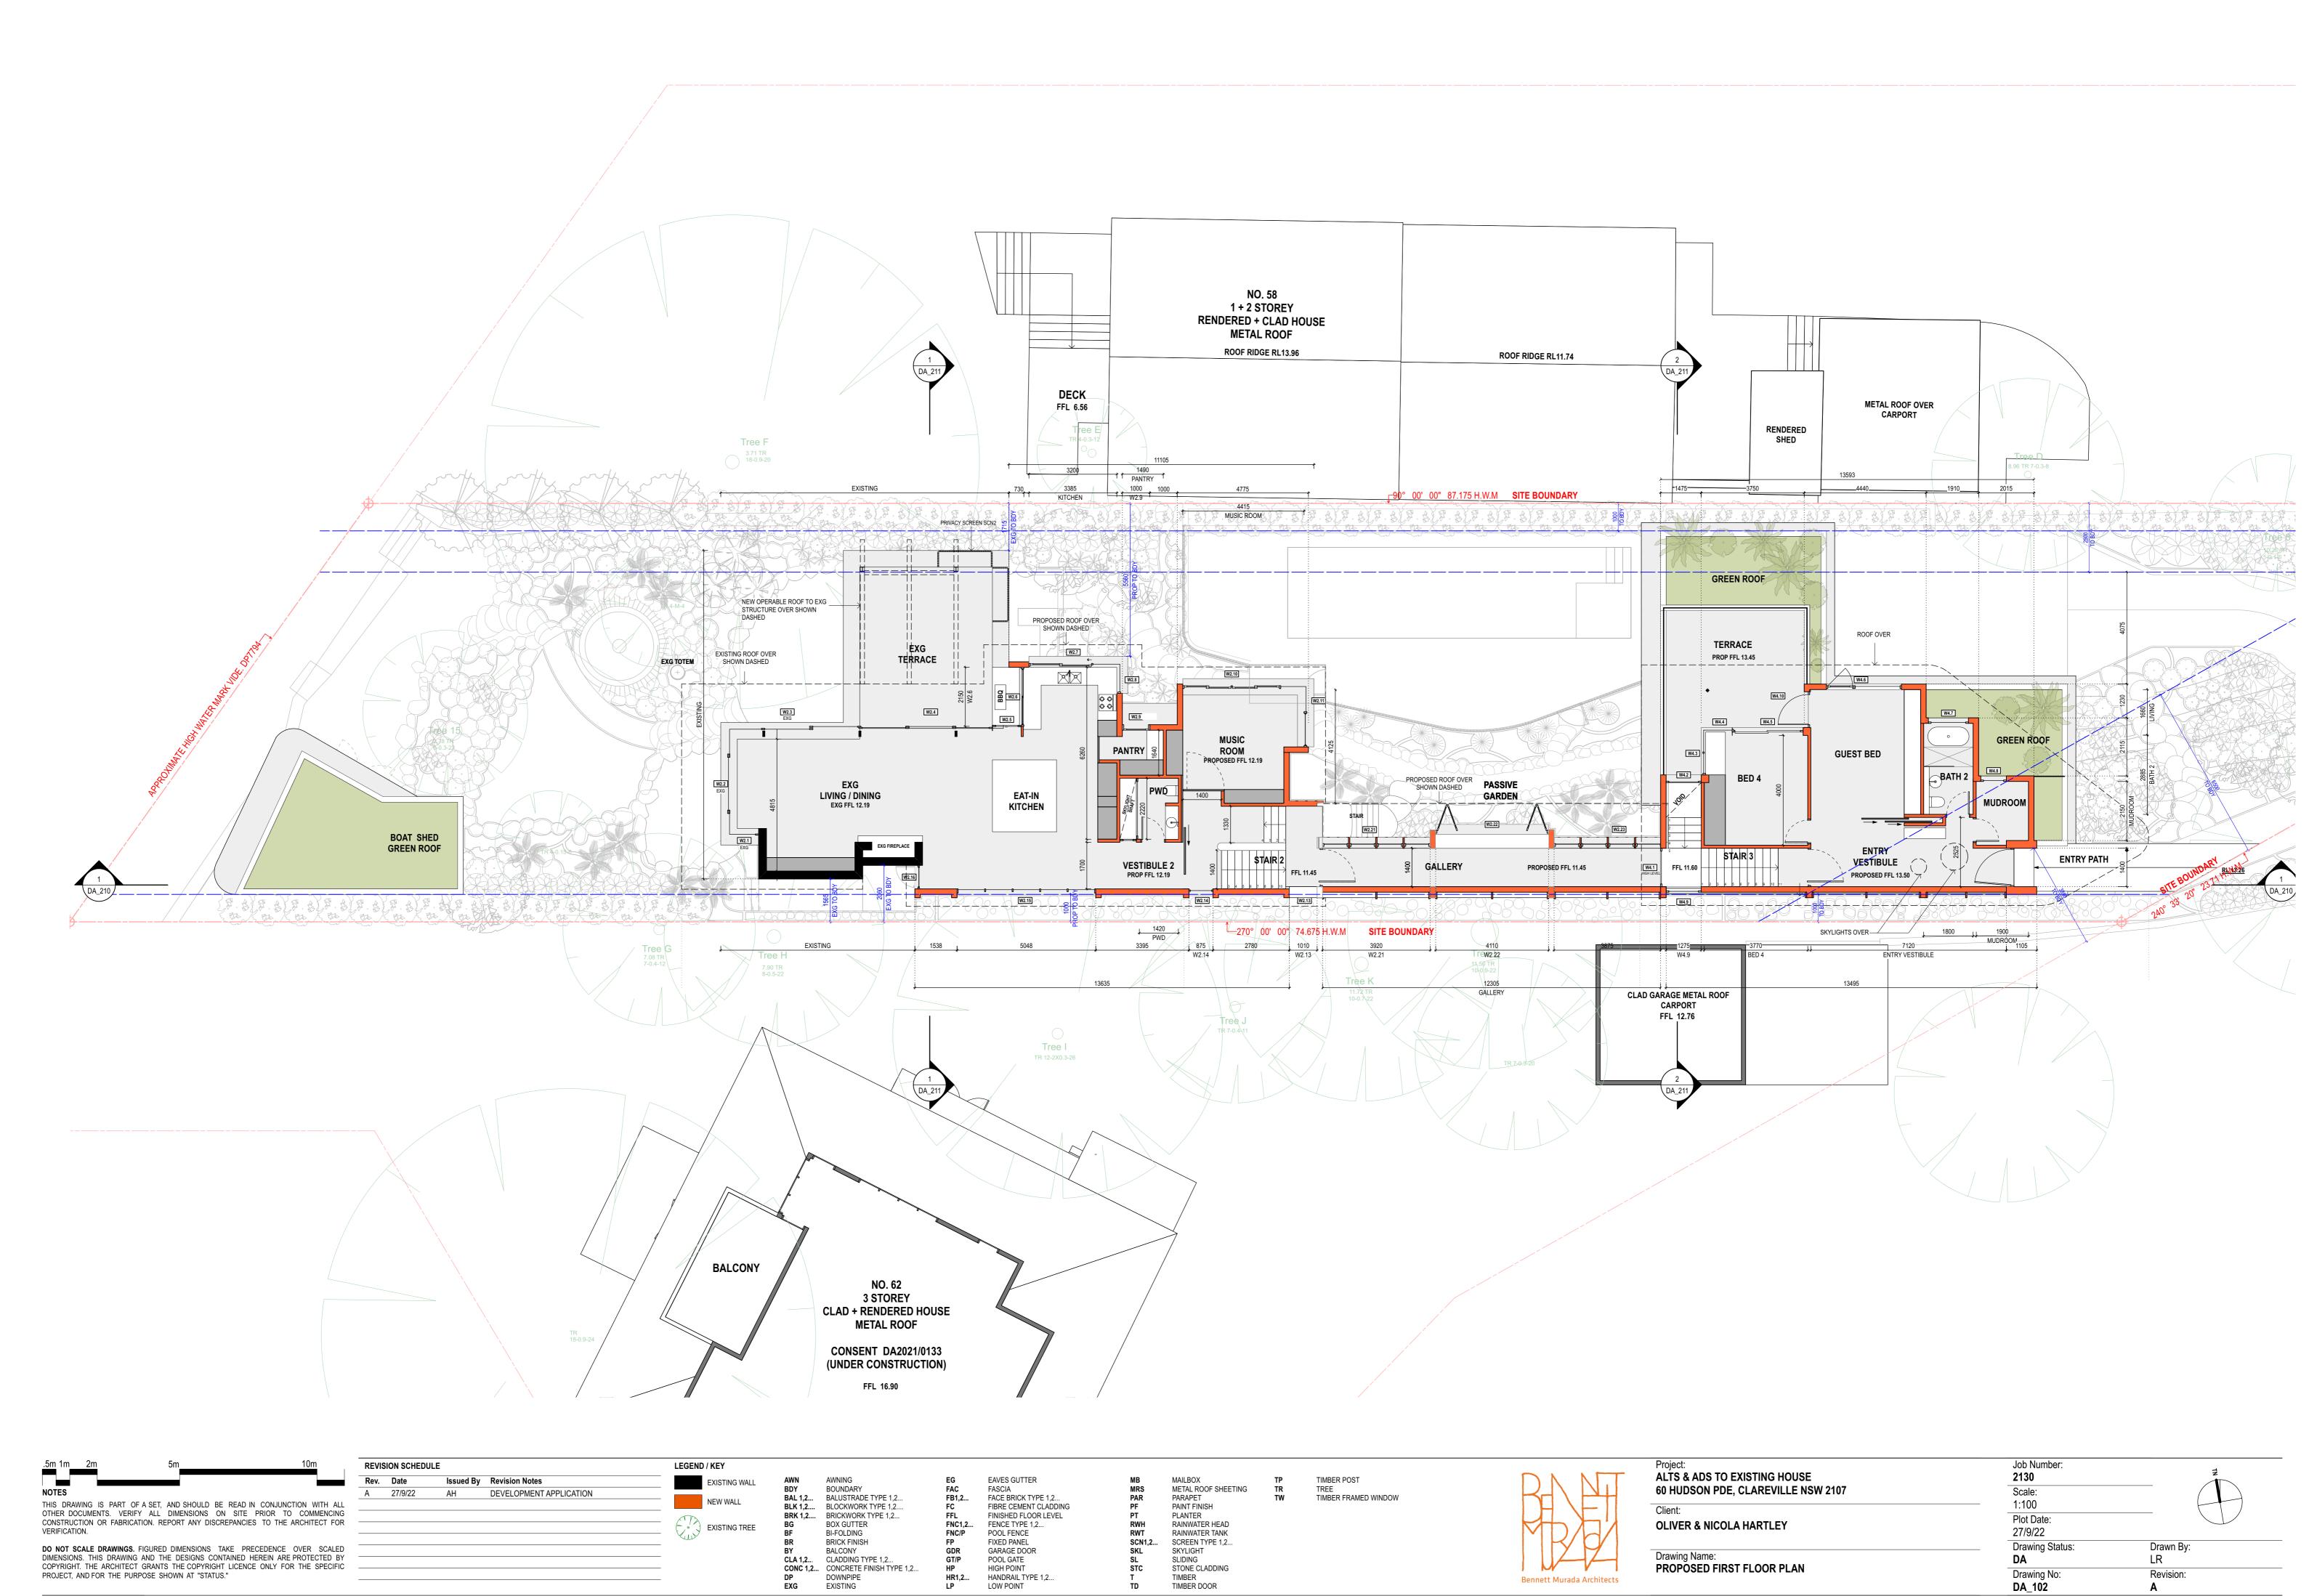

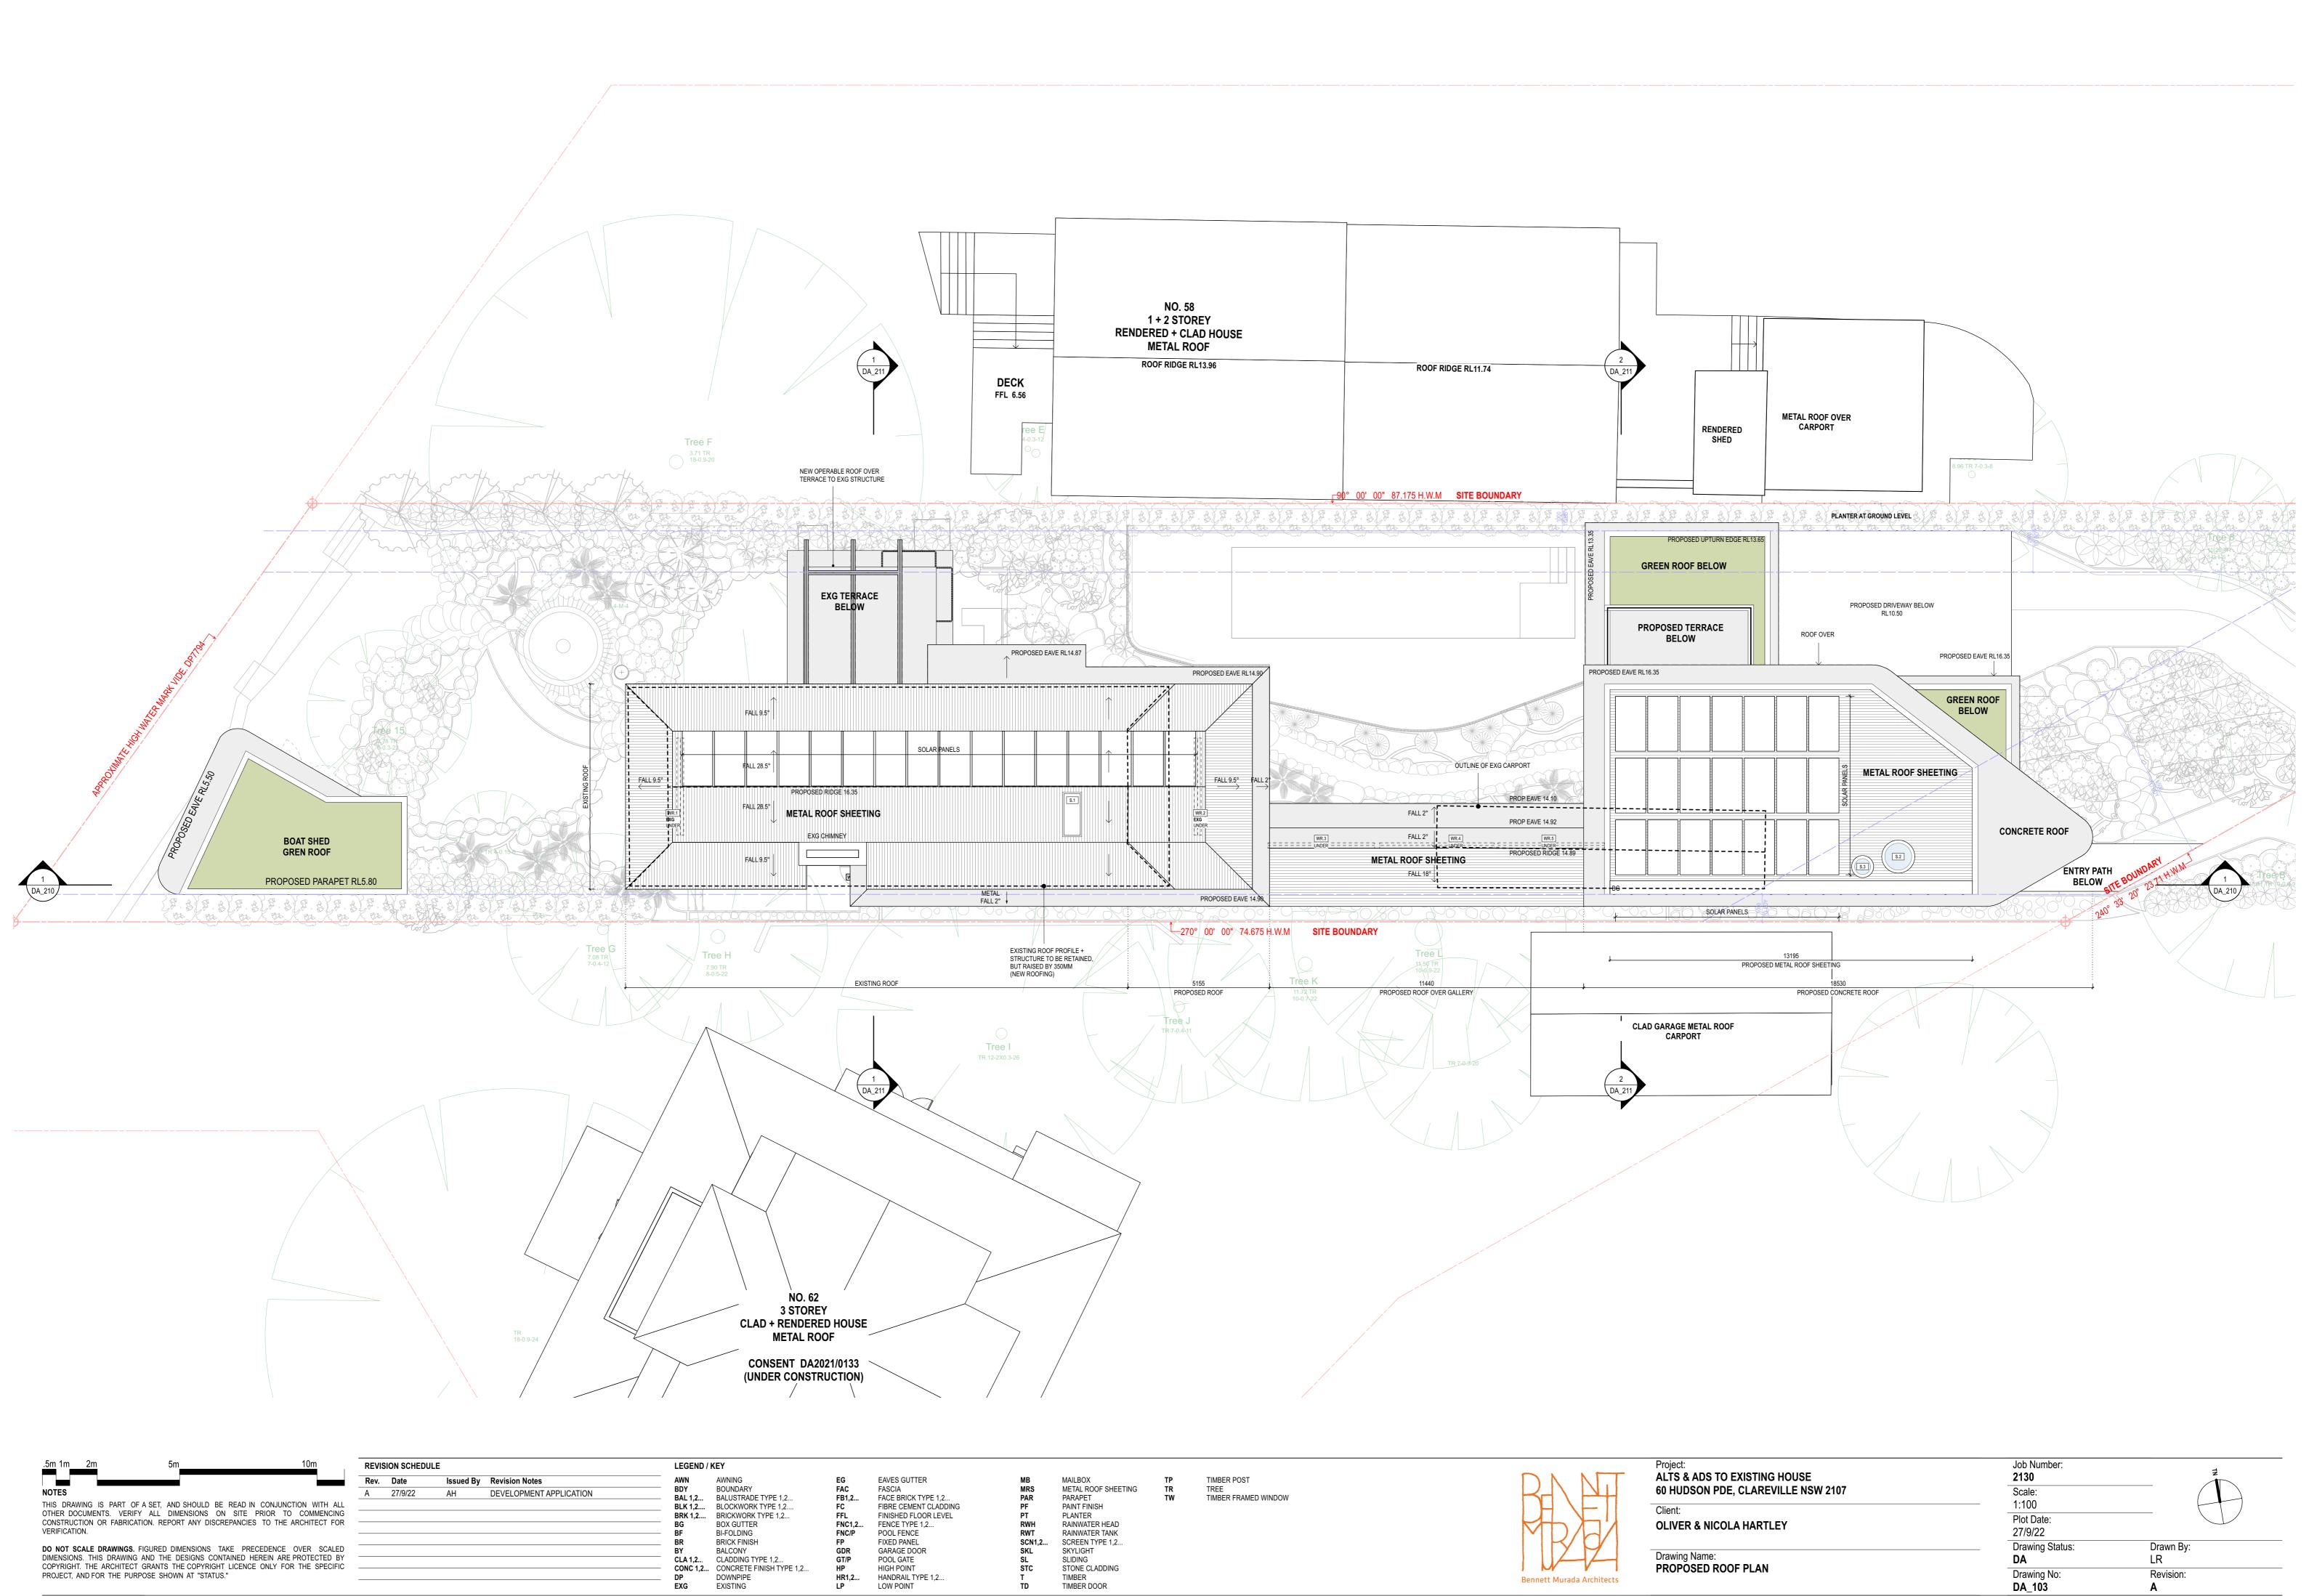

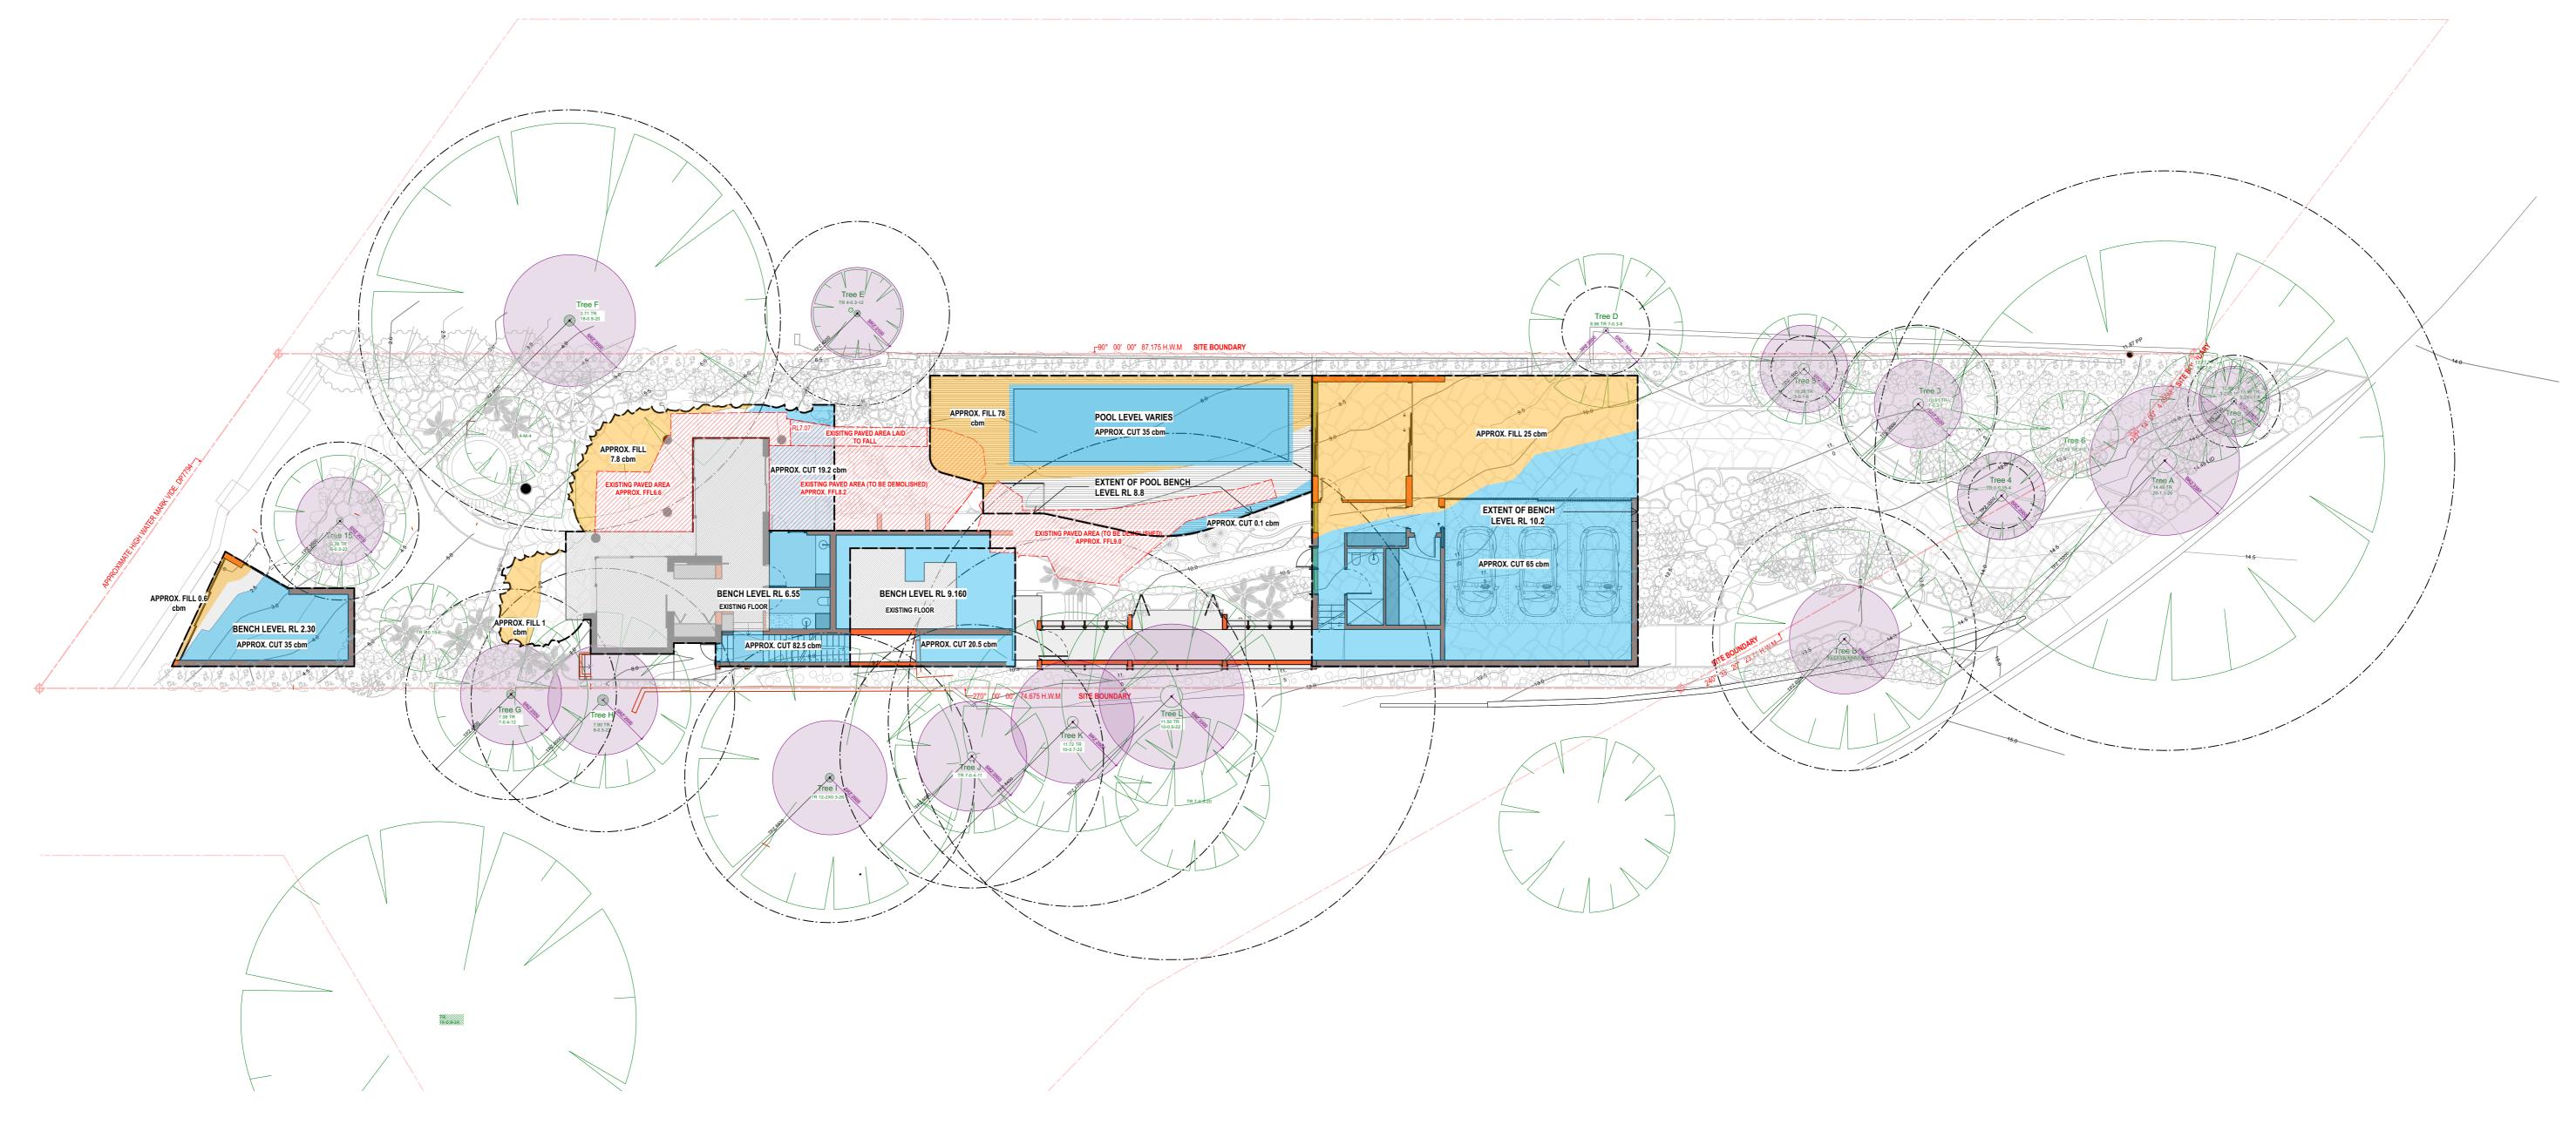

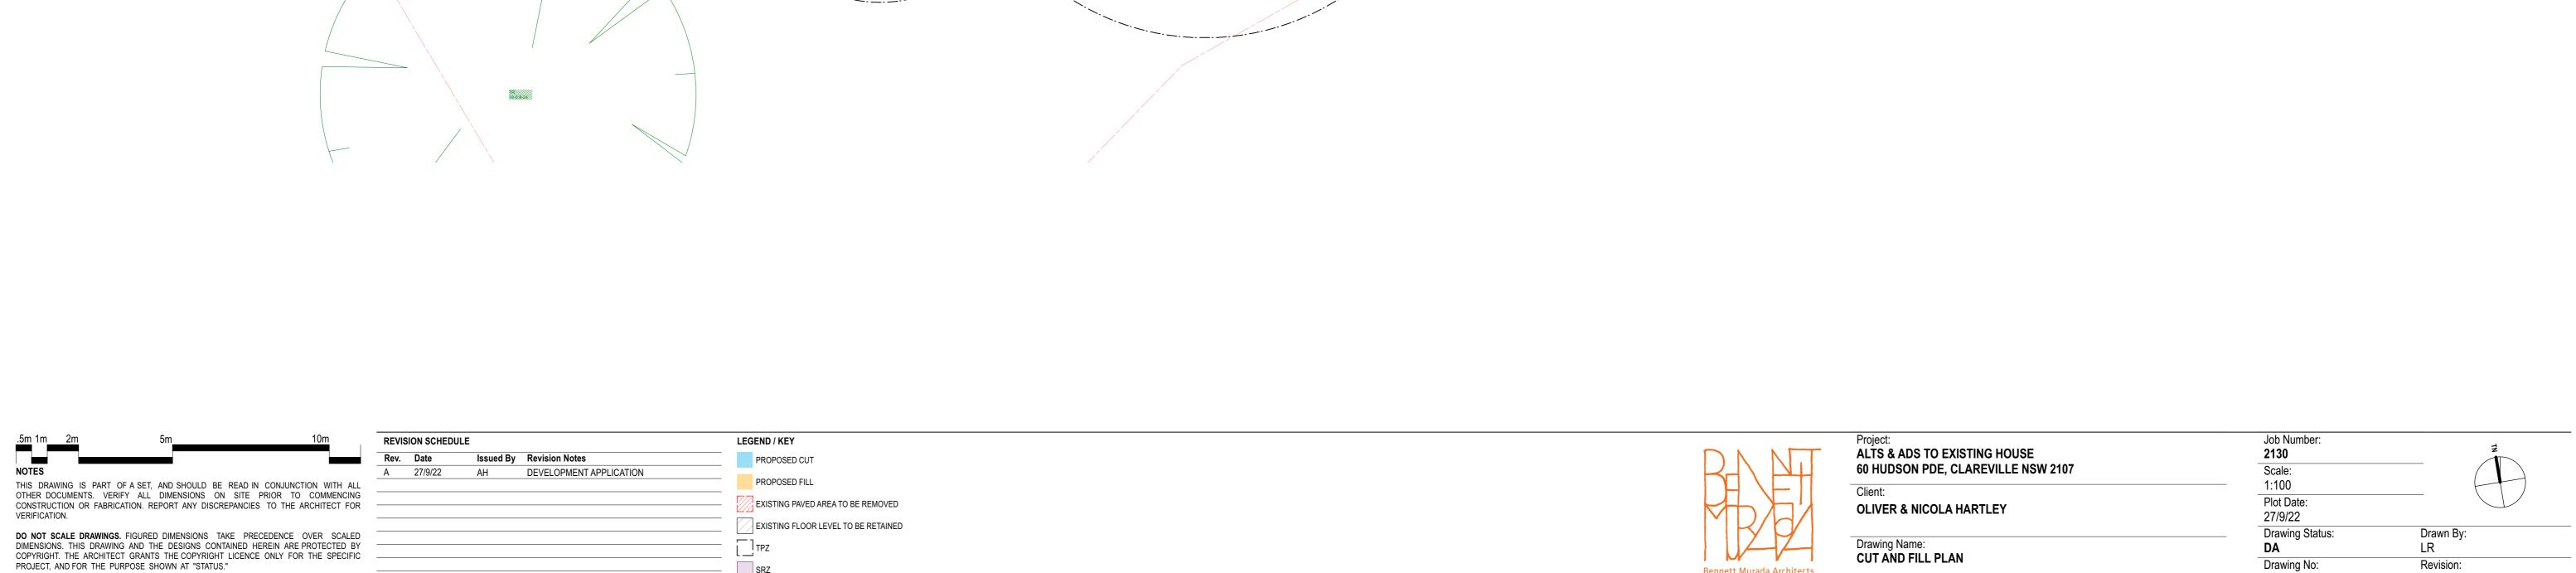

TPZ

SRZ

Drawing Name:

Bennett Murada Architects

CUT AND FILL PLAN


LR


Revision:

DA

Drawing No:

DA_112

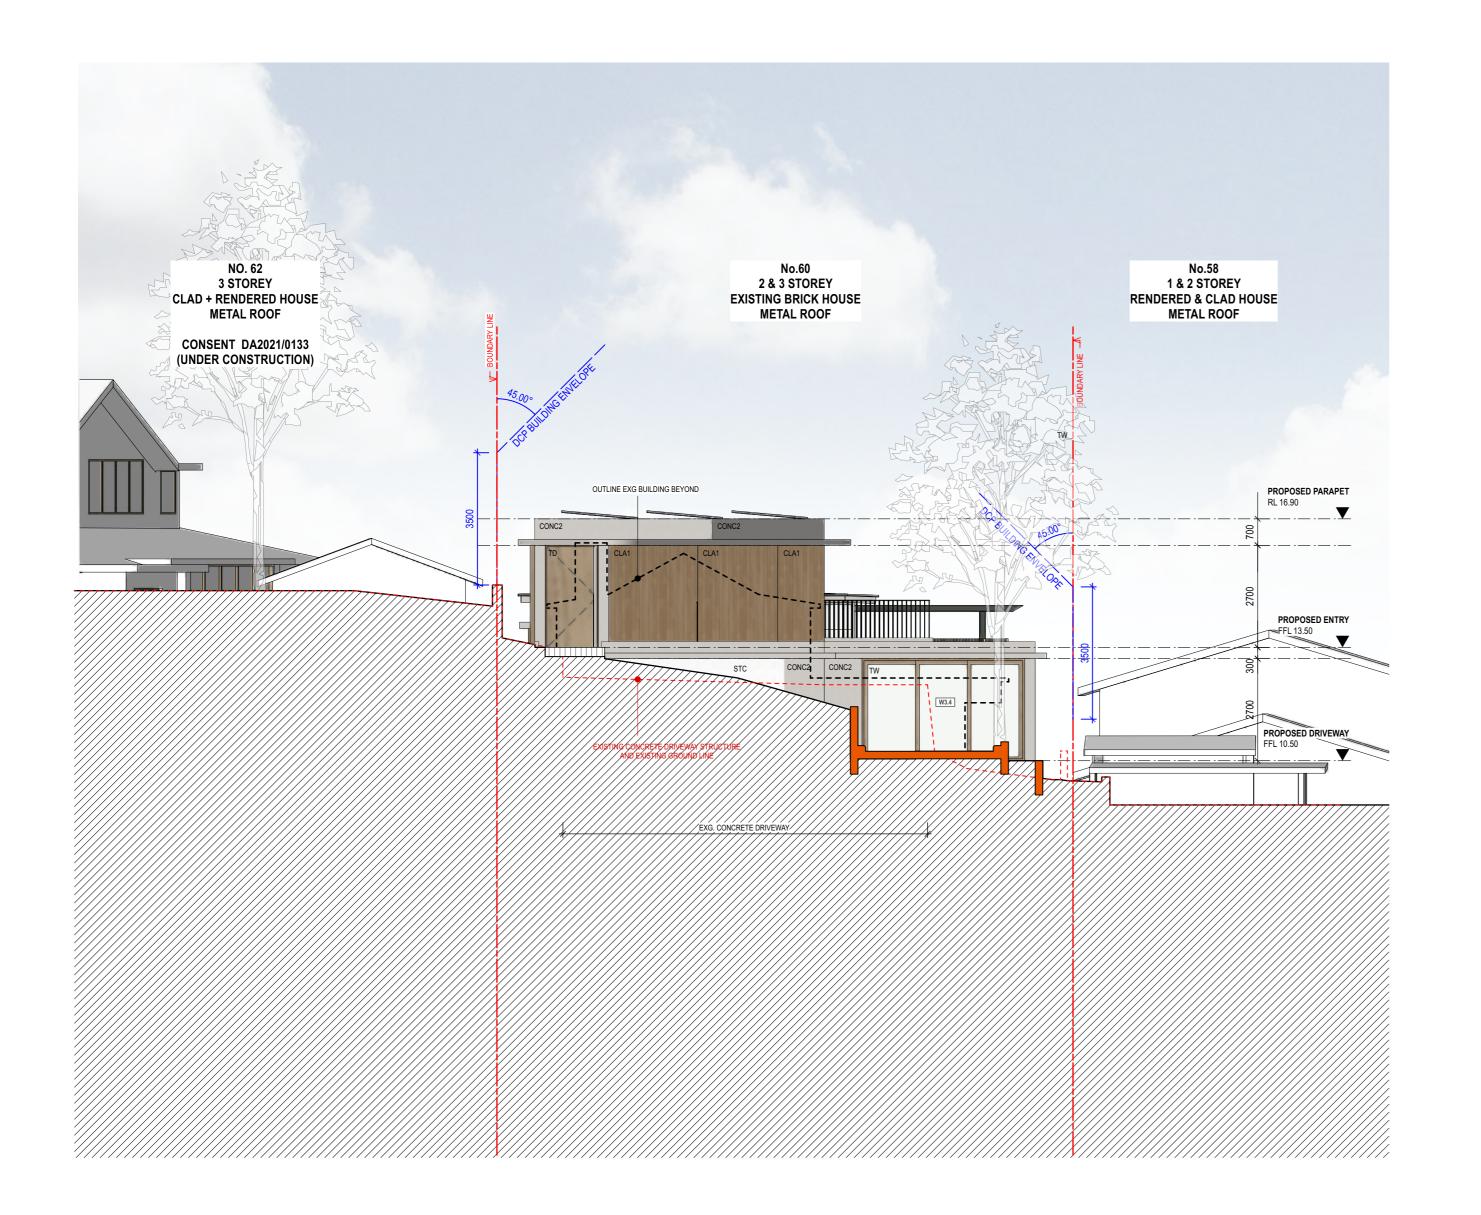

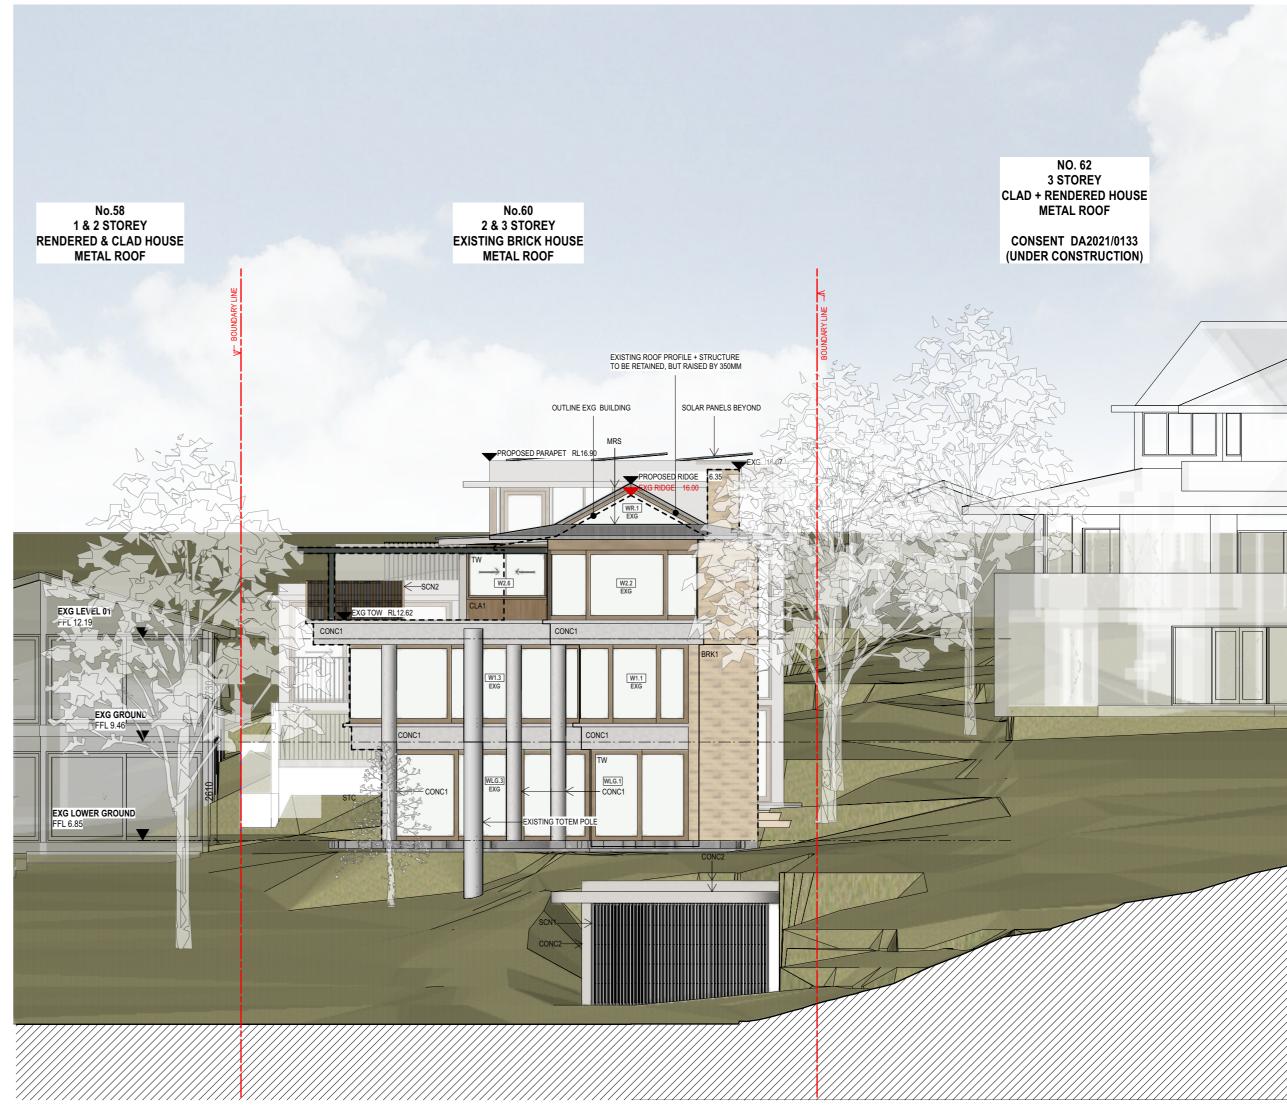

East Elevation
Scale: 1:100

West Elevation
Scale: 1:100

NOTE: REFER TO LANDSCAPE DRAWINGS FOR LANDSCAPING AND SITE GRADING DETAILS

II IIIC.	II ZII			OIII				101	H	
NOTES	;									
OTHER	DOCUME RUCTION	NTS. VEF	OF A SET, RIFY ALL CATION. RE	DIMENSIO	NS ON	SITE F	PRIOR TO	COM	MENCING	

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Rev.	Date	Issued By	Revision Notes	
4	27/9/22	AH	DEVELOPMENT APPLICATION	

EVELOPMENT APPLICATION AWN AWNING EG EAVES GUTTER BDY BOUNDARY FAC FASCIA FAC FASCIA FAC FASCIA	
EVELOPMENT APPLICATION BDY BOUNDARY FAC FASCIA	
BAL 1,2 BALUSTRADE TYPE 1,2 FB1,2 FACE BRICK TYPE 1,2	
BLK 1,2 BLOCKWORK TYPE 1,2 FC FIBRE CEMENT CLADDING	
BRK 1,2 BRICKWORK TYPE 1,2 FFL FINISHED FLOOR LEVEL	
BG BOX GUTTER FNC1,2 FENCE TYPE 1,2	
BR BRICK FINISH FP FIXED PANEL	
BY BALCONY GDR GARAGE DOOR	
CLA 1,2 CLADDING TYPE 1,2 GT/P POOL GATE	
CONC 1,2 CONCRETE FINISH TYPE 1,2 HP HIGH POINT	
DP DOWNPIPE HR1,2 HANDRAIL TYPE 1,2	
EXG EXISTING LP LOW POINT	


MB MRS PAR PF PT RWH RWT SCN1,2 SKL SL STC T	MAILBOX METAL ROOF SHEETING PARAPET PAINT FINISH PLANTER RAINWATER HEAD RAINWATER TANK SCREEN TYPE 1,2 SKYLIGHT SLIDING STONE CLADDING TIMBER TIMBER TIMBER DOOR	TP TR TW	TIMBER POST TREE TIMBER FRAMED WINDOW
TD	TIMBER DOOR		

Bennett Murada Architects

Project: ALTS & ADS TO EXISTING HOUSE	Job Number: 2130	
60 HUDSON PDE, CLAREVILLE NSW 2107 Client:	Scale: 1:100	
OLIVER & NICOLA HARTLEY	Plot Date: 27/9/22	
Drawing Name:	Drawing Status: DA	Drawn By: LR
EAST + WEST ELEVATIONS	Drawing No: DA_200	Revision: A





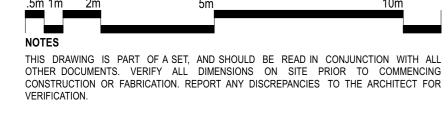

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REVIS	SION SCHEDU	LEGEND / KEY		
Rev.	Date	Issued By	Revision Notes	EXISTING WALL
Α	27/9/22	АН	DEVELOPMENT APPLICATION	NEW WALL

AWN	AWNING
BDY	BOUNDARY
BAL 1,2	BALUSTRADE TYPE 1,2
BLK 1,2	BLOCKWORK TYPE 1,2
BRK 1,2	BRICKWORK TYPE 1,2
BG	BOX GUTTER
BF	BI-FOLDING
BR	BRICK FINISH
BY	BALCONY
CLA 1,2	CLADDING TYPE 1,2
CONC 1,2	CONCRETE FINISH TYPE 1,2
DP	DOWNPIPE
EXG	EXISTING

EG FAC FB1,2... FC FFL FNC1,2... EAVES GUTTER FASCIA FACE BRICK TYPE 1,2... FIBRE CEMENT CLADDING FINISHED FLOOR LEVEL FENCE TYPE 1,2... POOL FENCE FNC/P FIXED PANEL GARAGE DOOR POOL GATE HIGH POINT

HANDRAIL TYPE 1,2...

LOW POINT

HR1,2...

MB MRS PAR PF PT RWH RWT SCN1,2... MAILBOX METAL ROOF SHEETING PARAPET PAINT FINISH PLANTER RAINWATER HEAD RAINWATER TANK SCREEN TYPE 1,2... SKYLIGHT SLIDING STONE CLADDING

TIMBER DOOR

TIMBER POST TREE
TIMBER FRAMED WINDOW



ALTS & ADS TO EXISTING HOUSE 60 HUDSON PDE, CLAREVILLE NSW 2107

OLIVER & NICOLA HARTLEY

Job Number: 2130 Scale: 1:100 Plot Date: 27/9/22 Drawing Status: Drawn By: DA LR Drawing No: Revision: DA_201

NORTH + SOUTH ELEVATIONS

Drawing Name:



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REVIS	ION SCHEDU	LE		LEGEND / KEY
Rev.	Date	Issued By	Revision Notes	EXISTING WALL
Α	27/9/22	AH	DEVELOPMENT APPLICATION	NEW WALL

AWN	AWNING
BDY	BOUNDARY
BAL 1,2	BALUSTRADE TYPE 1,2
BLK 1,2	BLOCKWORK TYPE 1,2
BRK 1,2	BRICKWORK TYPE 1,2
BG	BOX GUTTER
BF	BI-FOLDING
BR	BRICK FINISH
BY	BALCONY
CLA 1,2	CLADDING TYPE 1,2
CONC 1,2	CONCRETE FINISH TYPE 1,2
DP	DOWNPIPE
EXG	EXISTING

EG FAC FB1,2... FC FFL FNC1,2... FNC/P EAVES GUTTER FASCIA FACE BRICK TYPE 1,2... FIBRE CEMENT CLADDING FINISHED FLOOR LEVEL FENCE TYPE 1,2... POOL FENCE FIXED PANEL GARAGE DOOR GT/P HP HR1,2... LP POOL GATE HIGH POINT HANDRAIL TYPE 1,2...

LOW POINT


MB MRS PAR PF PT RWH RWT SCN1,2... MAILBOX METAL ROOF SHEETING PARAPET PAINT FINISH PLANTER
RAINWATER HEAD
RAINWATER TANK
SCREEN TYPE 1,2...
SKYLIGHT SLIDING STONE CLADDING


TIMBER DOOR

TIMBER POST TREE TIMBER FRAMED WINDOW



Job Number: ALTS & ADS TO EXISTING HOUSE 2130 60 HUDSON PDE, CLAREVILLE NSW 2107 Scale: 1:100 Plot Date: 27/9/22 **OLIVER & NICOLA HARTLEY** Drawing Status: Drawn By: Drawing Name: DA LR LONGITUDINAL SECTION Drawing No: **DA_210** Revision:

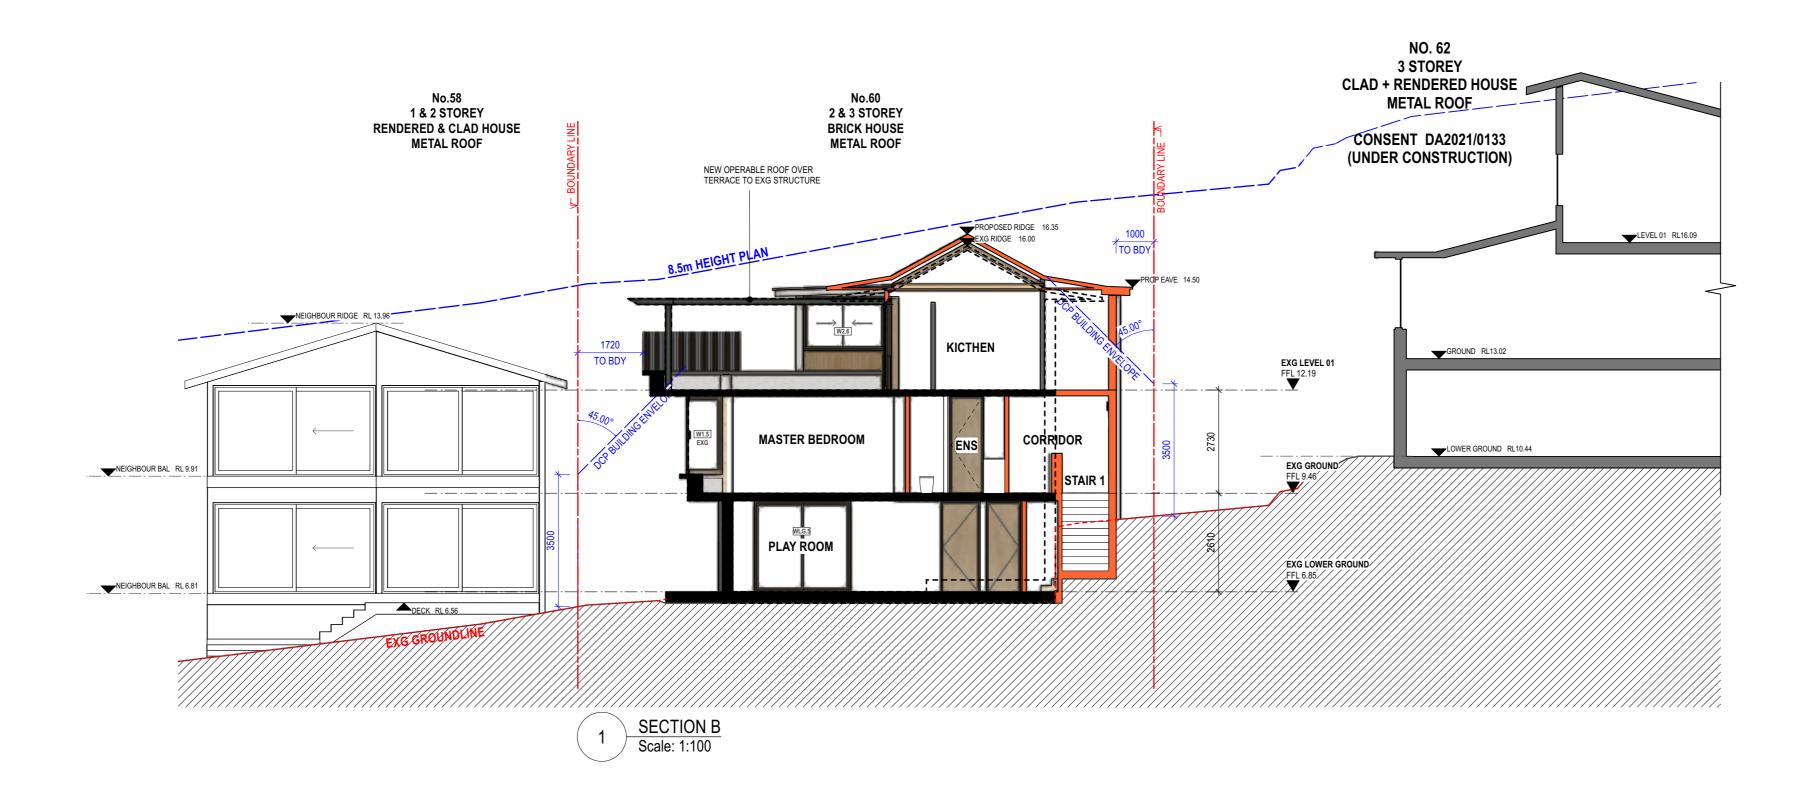

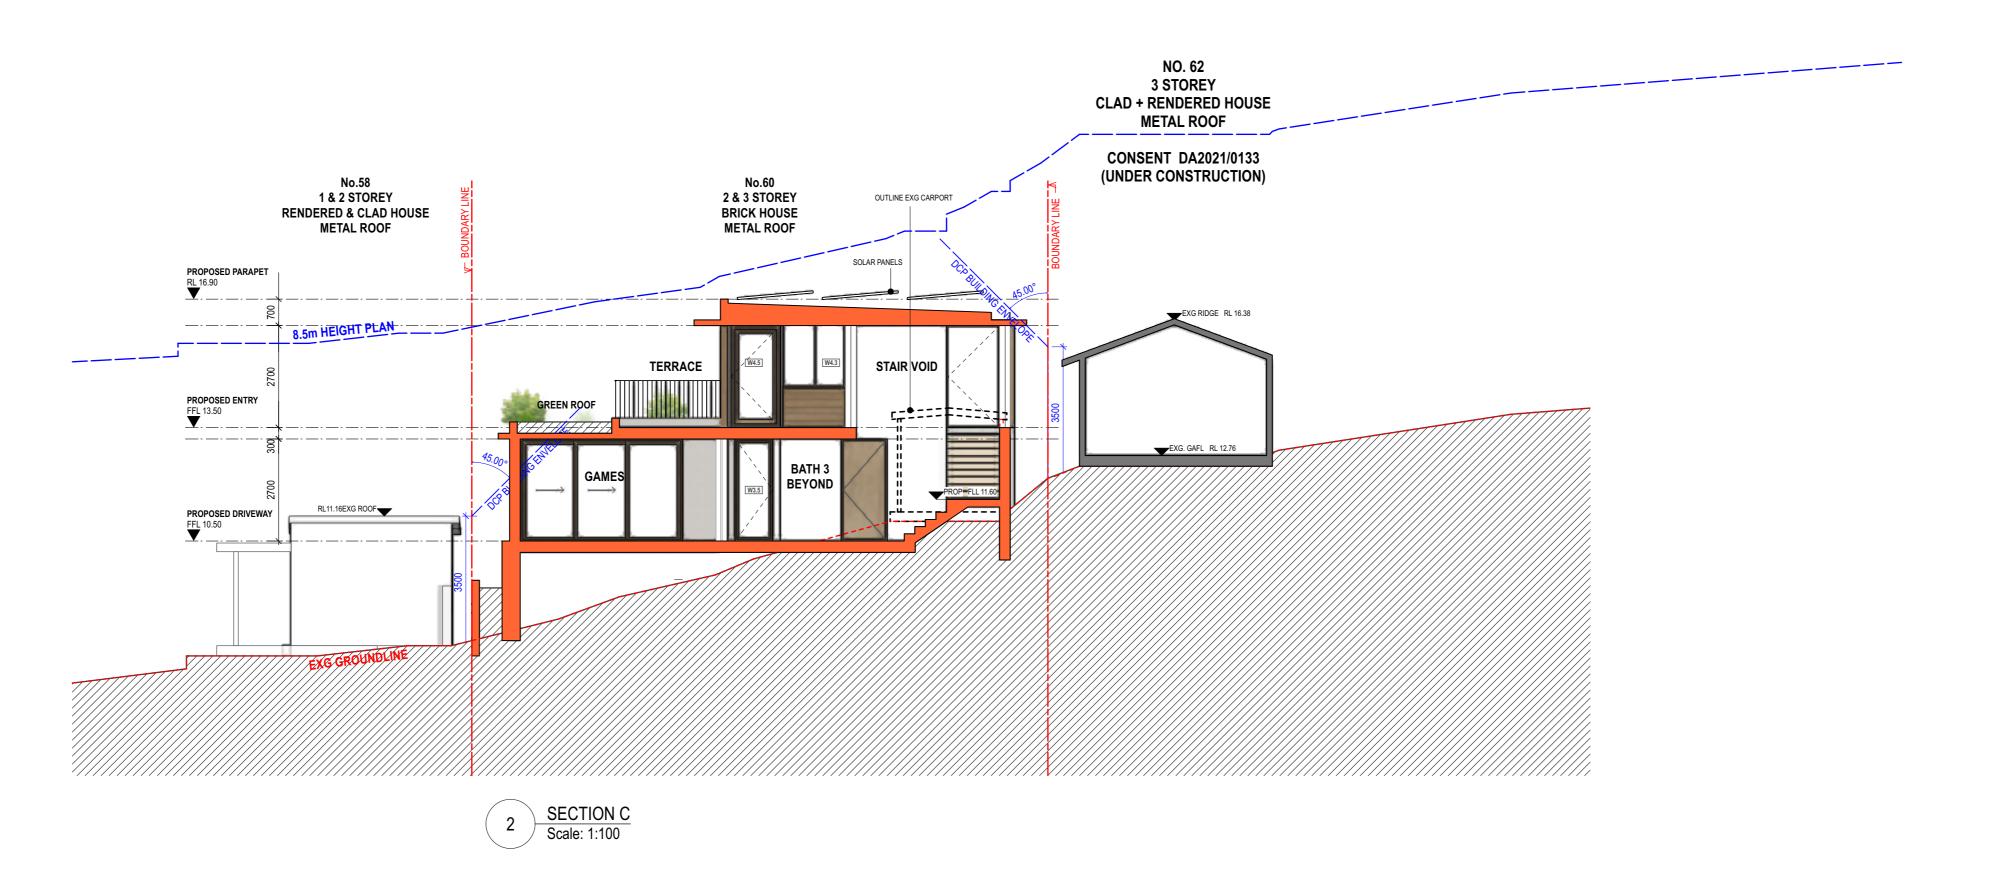


.5m 1m	2m	5m		10m
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NOTES				_
THIS DRAW	ING IS PART OF A SE	T, AND SHOULD	BE READ IN CONJUN	NCTION WITH ALL
OTHER DOO	CUMENTS. VERIFY AL	L DIMENSIONS	ON SITE PRIOR	TO COMMENCING
CONSTRUCT	TION OR FABRICATION.	REPORT ANY DI	SCREPANCIES TO THE	ARCHITECT FOR -
VERIFICATIO	N.			-

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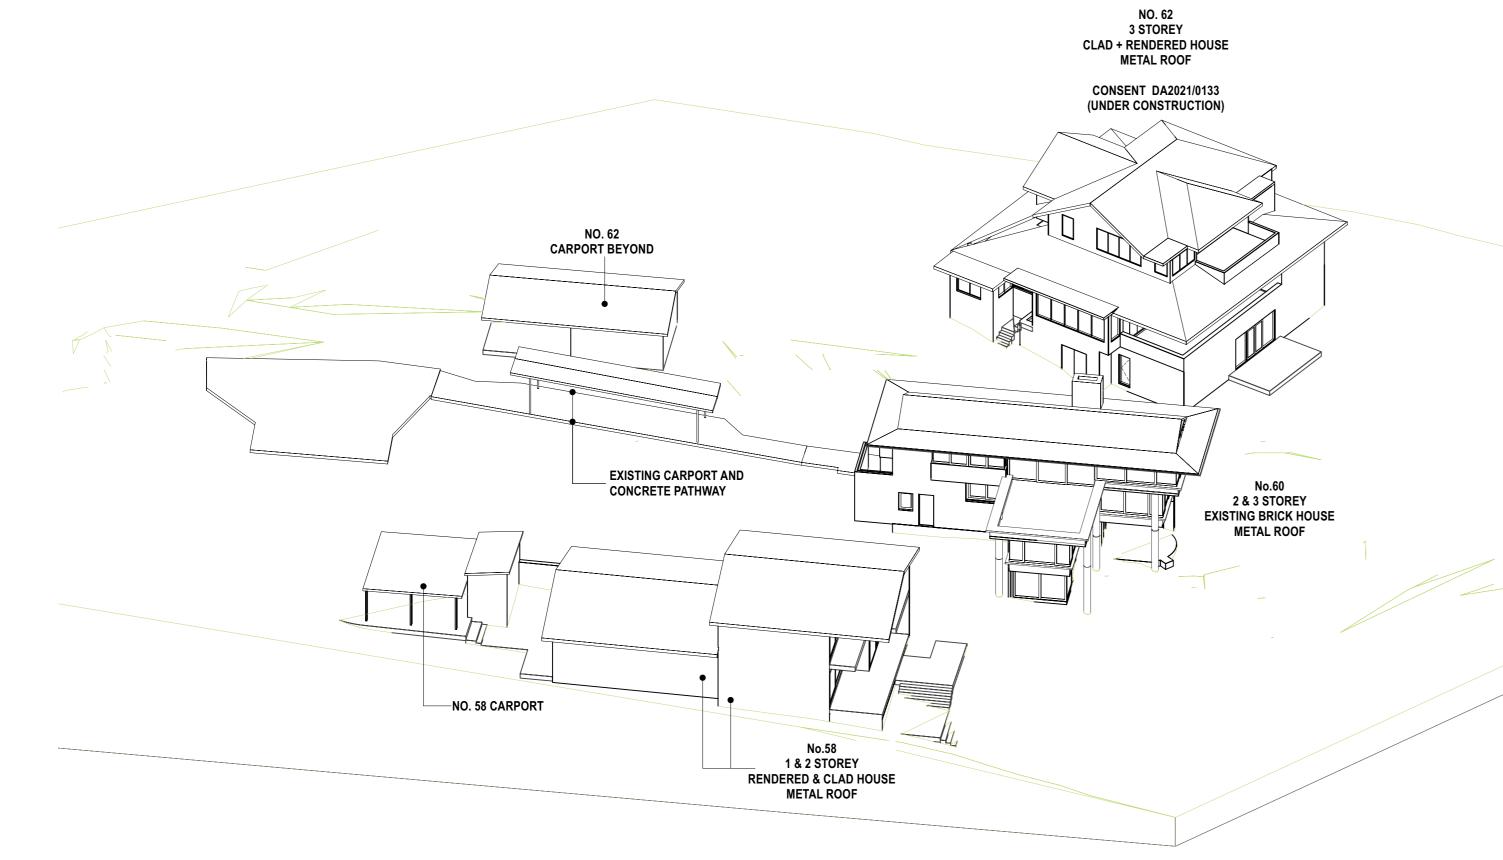
REVISION SCHEDULE		LEGEND / KEY							
Rev. Date Issued B		AWN BDY	AWNING BOUNDARY	EG FAC	EAVES GUTTER FASCIA	MB MRS	MAILBOX METAL ROOF SHEETING	TP TR	TIMBER POST TREE
A 27/9/22 AH	DEVELOPMENT APPLICATION	BAL 1,2 BLK 1,2 BRK 1,2 BG BF BF BR BR CLA 1,2	BALUSTRADE TYPE 1,2 BLOCKWORK TYPE 1,2	FB1,2 FC FFL FNC1,2 FNC/P FP GDR GT/P HP HR1,2	FACE BRICK TYPE 1,2 FIBRE CEMENT CLADDING FINISHED FLOOR LEVEL FENCE TYPE 1,2 POOL FENCE FIXED PANEL GARAGE DOOR POOL GATE HIGH POINT LOW POINT	PAR PF PT RWH RWT SCN1,2 SKL SL STC T TD	PARAPET PAINT FINISH PLANTER RAINWATER HEAD RAINWATER TANK SCREEN TYPE 1,2 SKYLIGHT SLIDING STONE CLADDING TIMBER TIMBER TIMBER DOOR	TW	TIMBER FRAMED WINDOW




Project: ALTS & ADS TO EXISTING HOUSE	Job Number: 2130	
60 HUDSON PDE, CLAREVILLE NSW 2107 Client:	Scale: 1:100	
OLIVER & NICOLA HARTLEY	Plot Date: 27/9/22	
Drawing Name:	Drawing Status: DA	Drawn By: LR
CROSS SECTIONS	Drawing No: DA_211	Revision: A

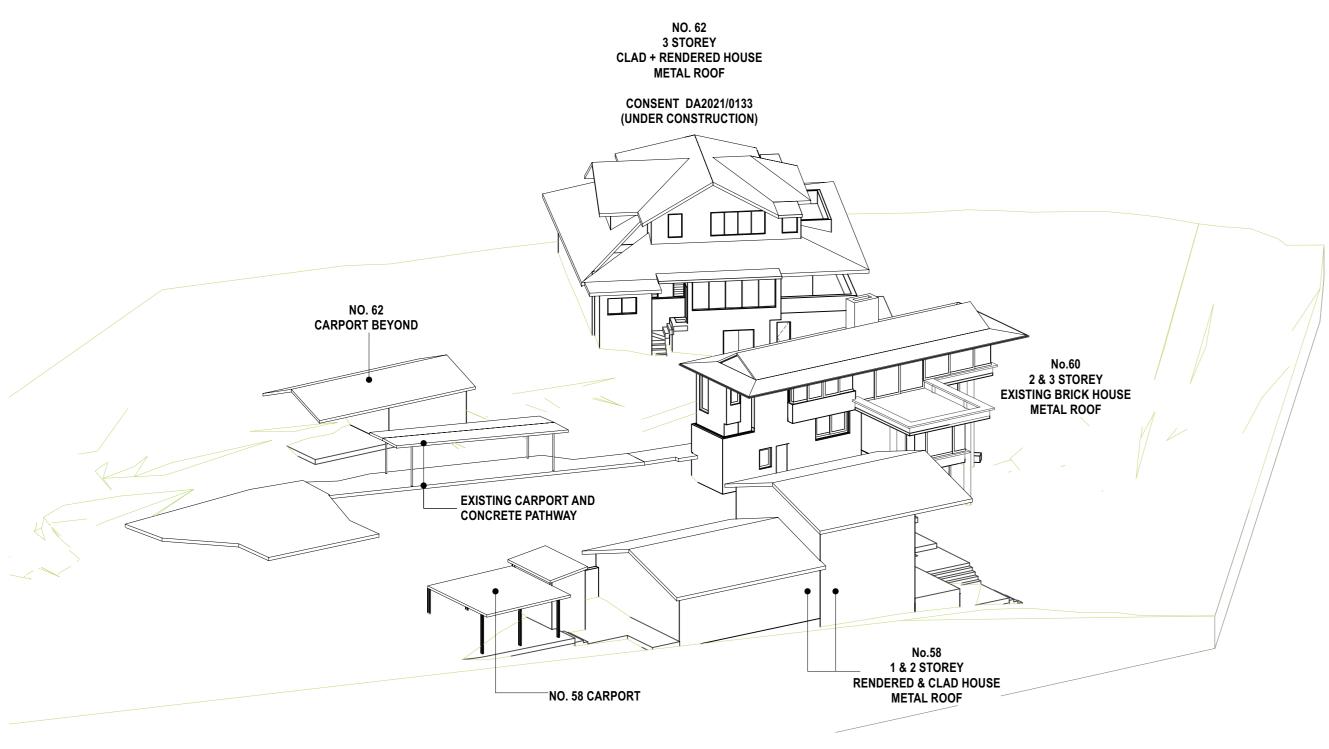


9AM - JUNE 21 - EXISTING Scale: NTS



12PM - JUNE 21 - EXISTING Scale: NTS

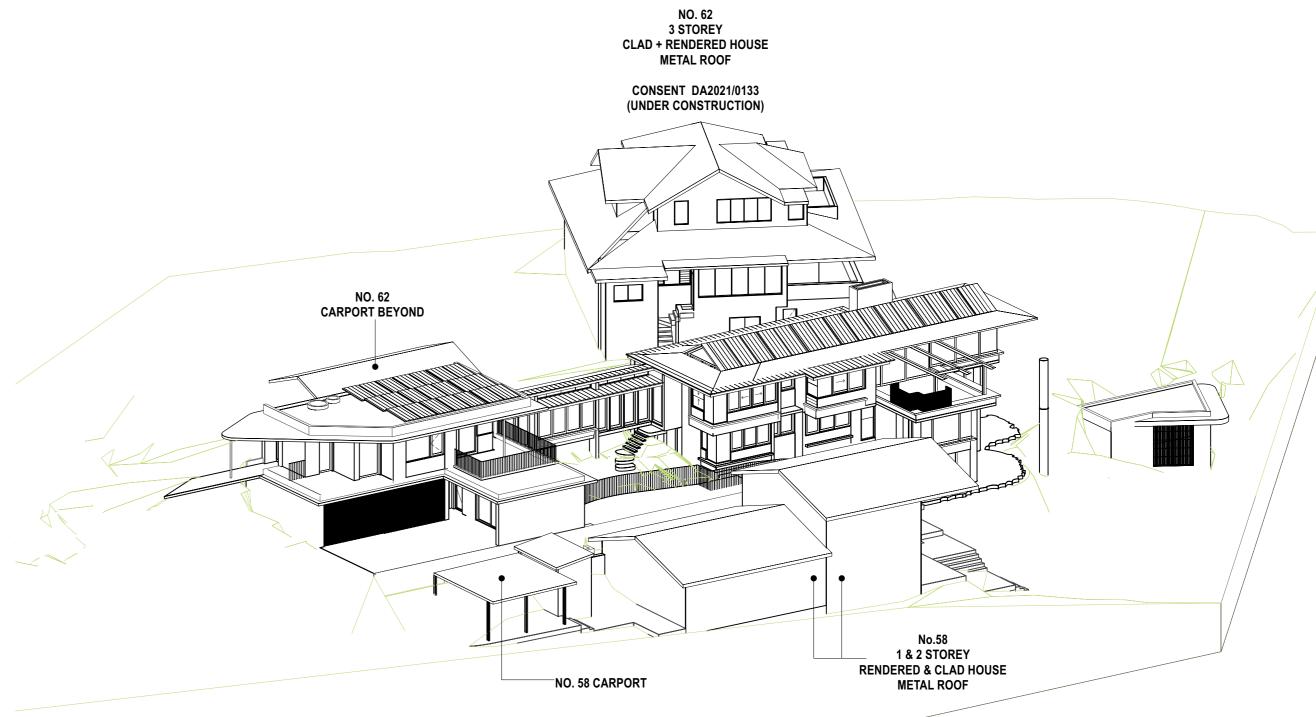

9AM - 21ST JUNE - PROPOSED Scale: NTS

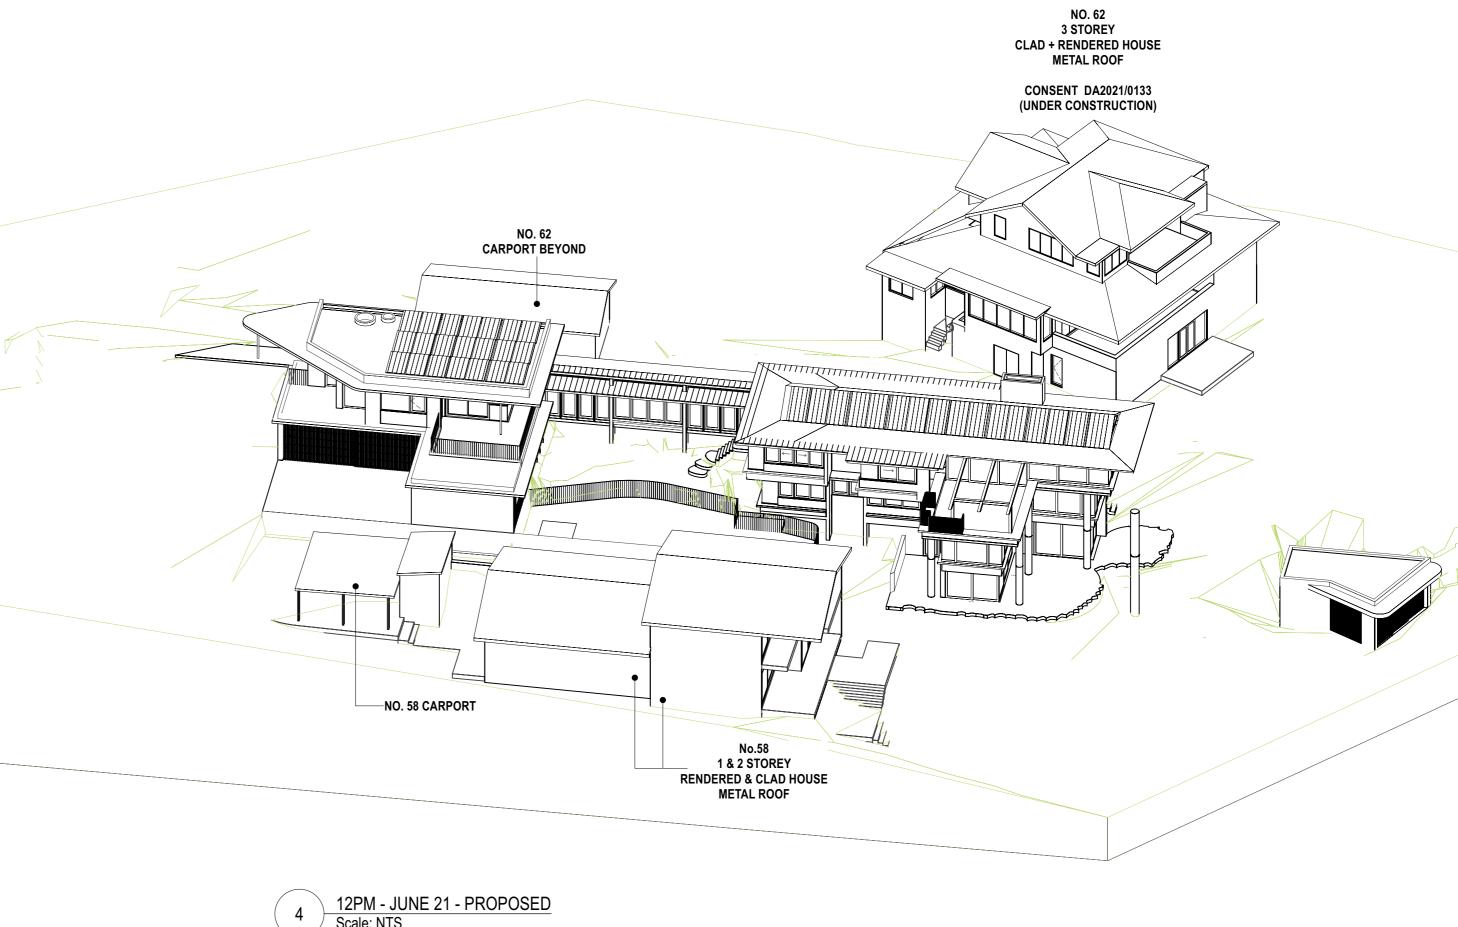

Scale: NTS

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Rev.	Date	Issued By	Revision Notes
Α	27/9/22	AH	DEVELOPMENT APPLICATION

LEGEND / KEY


REVISION SCHEDULE


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Bennett Murada Architects

Project: ALTS & ADS TO EXISTING HOUSE	Job Number: 2130
60 HUDSON PDE, CLAREVILLE NSW 2107 Client:	Scale: NTS
OLIVER & NICOLA HARTLEY	Plot Date:

60 HUDSON PDE, CLAREVILLE NSW 2107	Scale:	
Client: OLIVER & NICOLA HARTLEY	NTS Plot Date: 27/9/22	
Drawing Name:	Drawing Status: DA	Drawn By: AH
SHADOW DIAGRAMS - SUN'S EYE VIEW	Drawing No: DA_301	Revision: A



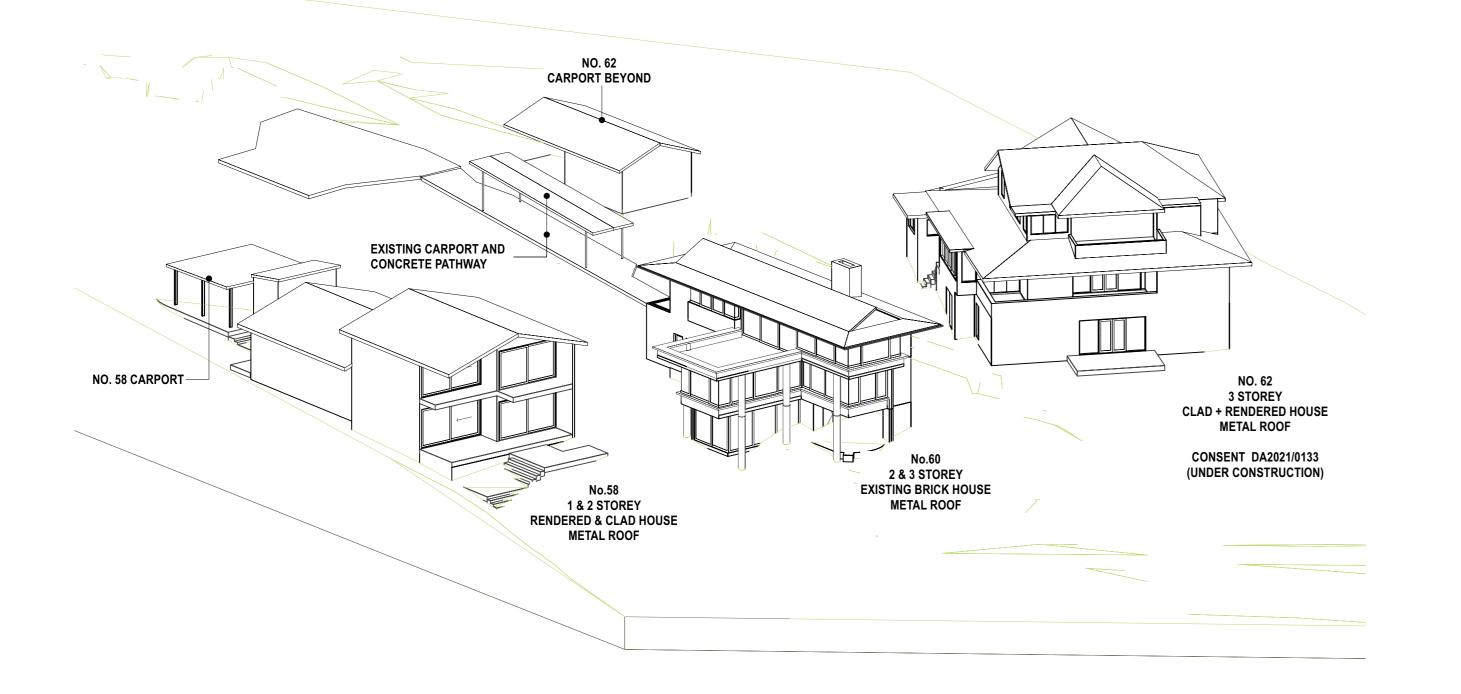

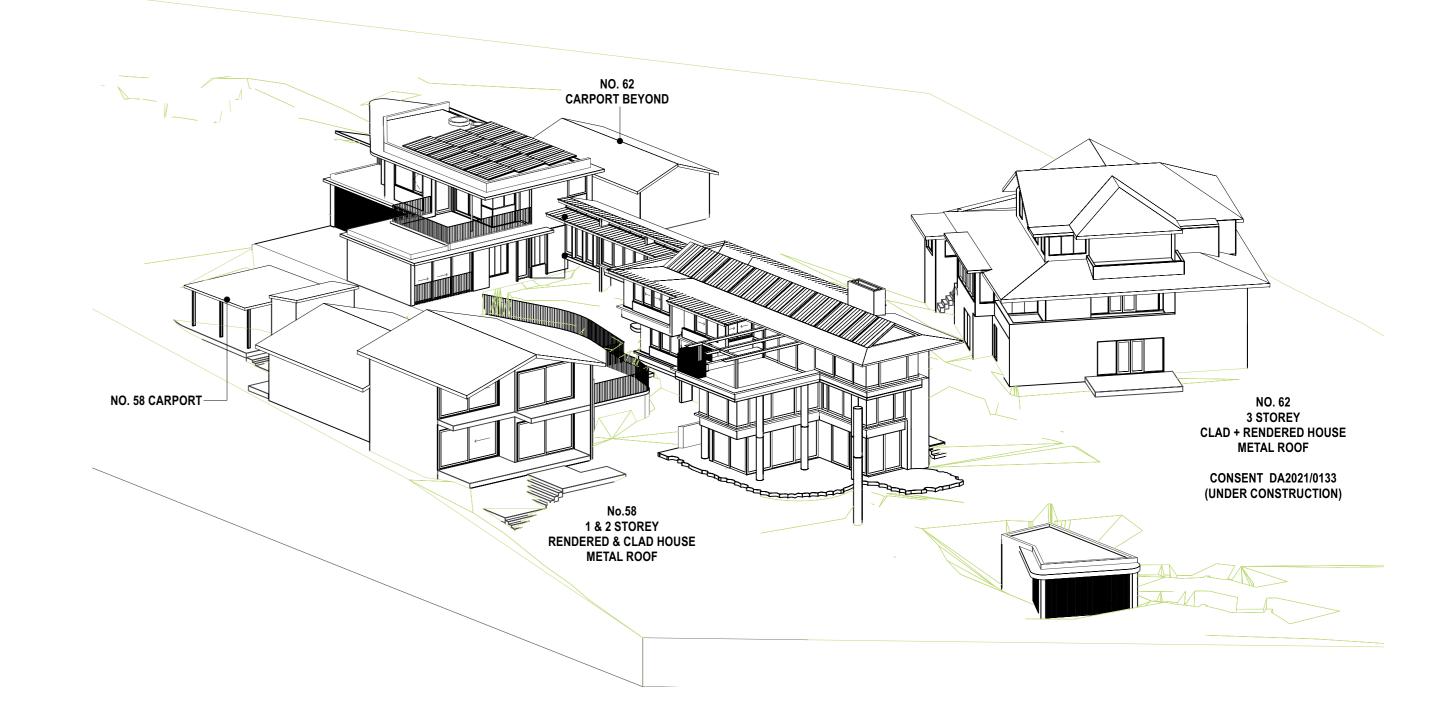3PM - JUNE 21 - EXISTING
Scale: NTS

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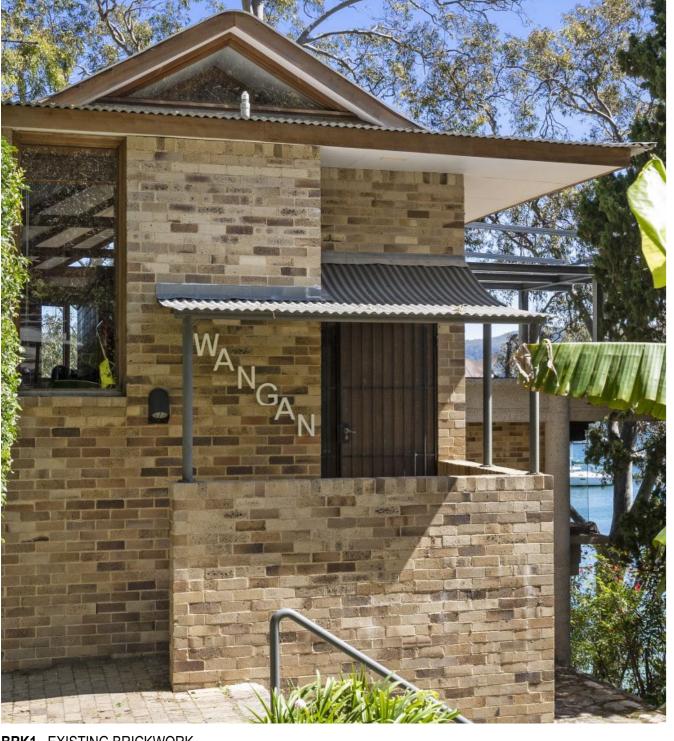
REVIS	ION SCHEDU	LE		LEGEND / KEY
Rev.	Date	Issued By	Revision Notes	
Α	27/9/22	AH	DEVELOPMENT APPLICATION	



Project: ALTS & ADS TO EXISTING HOUSE	Job Number: 2130	
60 HUDSON PDE, CLAREVILLE NSW 2107	Scale: NTS	
Client: OLIVER & NICOLA HARTLEY	Plot Date: 27/9/22	
Drawing Name: SHADOW DIAGRAMS - SUN'S EYE VIEW	Drawing Status: DA	Drawn By: AH
SHADOW DIAGRAMS - SUN SETE VIEW	Drawing No:	Revision:

Revision:

Drawing No: **DA_302**








CONC1 _ EXISTING CONCRETE




 $\mathbf{MRS1} \,_\, \mathbf{METAL}\,\, \mathbf{ROOF}\,\, \mathbf{SHEETING}$






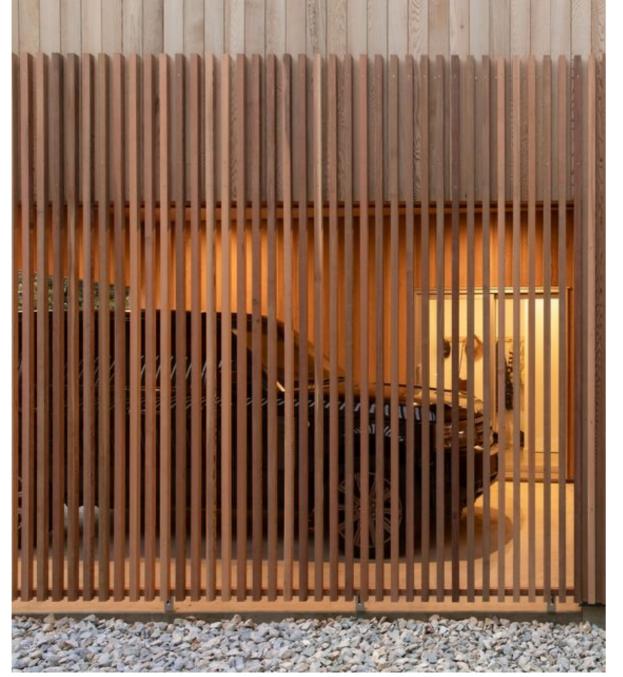


SCN 1 _ TIMBER SCREENS

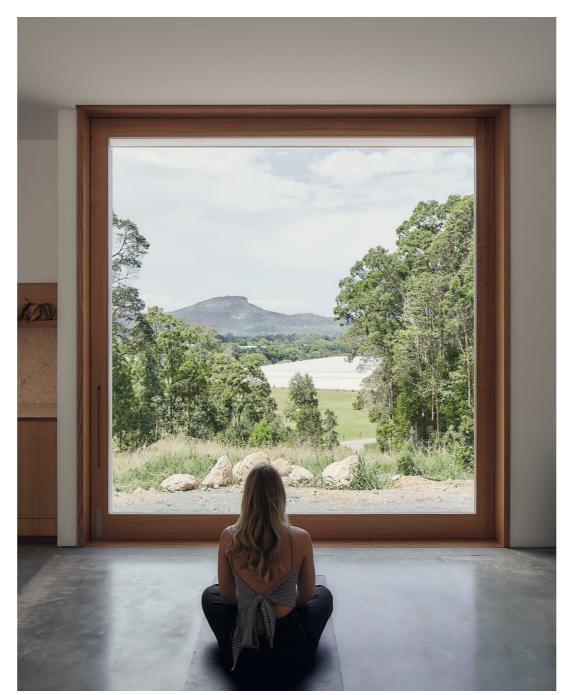

TM + GL1 _ TIMBER WINDOWS + CLEAR GLASS

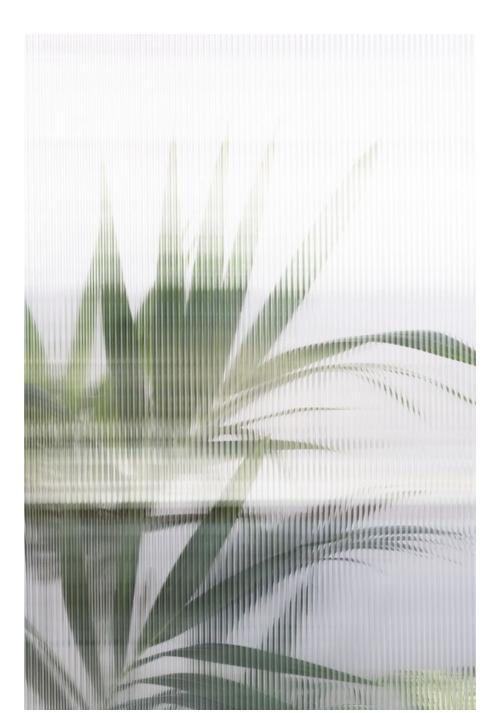

TM + GL2 _ TIMBER WINDOWS + PRIVACY GLASS

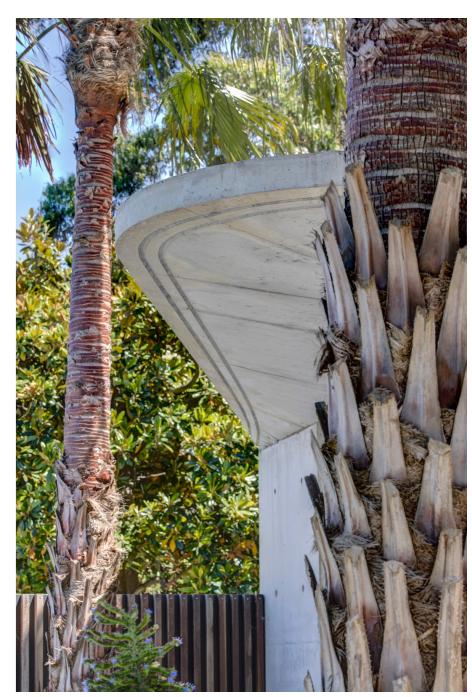

CONC2 _ NEW OFF-FORM CONCRETE

NOTES	

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REVISION SCHEDULE				LEGEND / KEY
Rev.	Date	Issued By	Revision Notes	
Α	27/9/22	AH	DEVELOPMENT APPLICATION	

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Ronne	Murada	Archite	-

Project:
ALTS & ADS TO EXISTING HOUSE
60 HUDSON PDE, CLAREVILLE NSW 2107

OLIVER & NICOLA HARTLEY

Drawing Name: SCHEDULES OF COLOURS AND MATERIALS

Job Number: 2130	
Scale: NTS	
 NIS	
Plot Date:	
27/9/22	
 Drawing Status:	Drawn By:
DA	LR
Drawing No:	Revision:
DA_500	Α