GENERAL NOTES:

ALL WORK TO BE CARRIED OUT IN ACCORDANCE WITH THE REQUIREMENTS OF THE PRINCIPAL CERTIFYING AUTHORITY AND BCA 2020.

ALL DEMOLITION WORK TO BE CARRIED OUT IN ACCORDANCE WITH AS

SILT SEDIMENT CONTROL MEASURES TO BE IN PLACE PRIOR EXCAVATION OR CONSTRUCTION WORK.

PEDESTRIAN ACCESS, INCLUDING DISABLED AND PRAM ACCESS DURING ROAD WORK TO BE MAINTAINED AS PER AS 17423. 'PART 3 $\,$ - TRAFFIC CONTROL DEVICES FOR WORKS ON ROADS

BUILDER SHALL MAKE GOOD ALL DISTURBED AREAS ADJACENT TO THE WORKS ON COUNCILS ROAD. FOOTPATH ARE TO BE RESTORED TO THE SATISFACTION OF THE PRINCIPAL CERTIFYING AUTHORITY.

ALL CONCRETE FOOTINGS, FLOOR SLABS AND TIMBER ROOF FRAMING TO STRUCTURAL ENGINEERS DETAILS.

THE REFLECTIVITY INDEX OF GLASS USED IN THE EXTERNAL FACADE OF THE BUILDING IS NOT TO EXCEED 20%.

ONGOING WASTE FROM THE PROPOSED DEVELOPMENT IS TO BE ADDED TO THE EXISTING WASTE COLLECTION SYSTEM CURRENTLY IN USE BY THE EXISTING DEVELOPMENT ON SITE

SAFETY GLASS SHALL BE USED IN EVERY GLASS DOOR OR PANEL ENCLOSING OR PARTLY ENCLOSING A SHOWER OR BATH.

ALL BATHROOM AND WC WINDOWS SHALL BE FITTED AND MAINTAINED WITH OBSCURE GLASS.

BCA COMPLIANCE:

SECTION A GENERAL PROVISIONS

PART A3 CLASSIFICATION OF BUILDINGS AND STRUCTURES -CLASS 1:

ONE OR MORE BUILDINGS WHICH IN ASSOCIATION CONSTITUTE-(A) CLASS 1A - A SINGLE DWELLING BEING-(I) A DETACHED HOUSE; OR

(I) ONE OF A GROUP OF TWO OR MORE ATTACHED DWELLINGS, EACH BEING A BUILDING, SEPARATED BY A FIRE-RESISTING WALL, INCLUDING A ROW HOU DWELLINGS, EACH BEING HOUSE. TERRACE HOUSE, TOWN HOUSE OR VILLA UNIT: OR

SECTION B STRUCTURE PART B1 STRUCTURAL PROVISIONS

- SEE ENGINEERS PLANS

*SECTION C FIRE RESISTANCE

PART C1 FIRE RESISTANCE AND STABILITY -C1.1 TYPE OF CONSTRUCTION REQUIRED

TYPE C CONSTRUCTION FOR 1 STOREY CLASS 6 BUILDING -C1.12 NON-COMBUSTIBLE MATERIALS THE FOLLOWING MATERIALS, THOUGH COMBUSTIBLE OR CONTAINING COMBUSTIBLE FIBRES, MAY BE USED WHEREVER A NON-COMBUSTIBLE

MATERIAL IS REQUIRED: (A) PLASTERBOARD.

LOCATION MAP

[/]NTS

(B) PERFORATED GYPSUM LATH WITH A NORMAL PAPER FINISH. (C) FIBROUS-PLASTER SHEET.

(D) FIBRE-REINFORCED CEMENT SHEETING. (E) PRE-FINISHED METAL SHEETING HAVING A COMBUSTIBLE SURFACE NOT EXCEEDING 1 MM THICKNESS AND WHERE THE FINISH NOT SPREAD-OF-FLAME INDEX OF THE PRODUCT IS NOT GREATER

THAN 0 (F) BONDED LAMINATED MATERIALS WHERE-

EACH LAMINATE IS NON-COMBUSTIBLE; AND (II) EACH ADHESIVE LAYER DOES NOT EXCEED 1 MM IN THICKNESS; AND

(III) THE TOTAL THICKNESS OF THE ADHESIVE LAYERS DOES NOT EXCEED 2 MM: AND

(IV) THE SPREAD-OF-FLAME INDEX AND THE SMOKE-DEVELOPED INDEX OF THE LAMINATED MATERIAL AS A WHOLE DOES NOT EXCEED 0 AND 3 RESPECTIVELY

3.7.1.3 EXTERNAL WALLS OF CLASS 1 BUILDINGS AN EXTERNAL WALL OF A CLASS 1 BUILDING, AND ANY OPENINGS IN MUST COMPLY WITH 3.7.1.5 IF THE WALL IS LESS THAT WALL,

THAN-(A) 900MM FROM THE ALLOTMENT BOUNDARY OTHER THAN THE BOUNDARY ADJOINING A ROAD ALIGNMENT OR OTHER PUBLIC SPACE,

(B) 1.8M FROM ANOTHER BUILDING ON THE SAME ALLOTMENT OTHER THAN AN APPURTENANT CLASS 10 BUILDING OR A DETACHED PART OF THE SAME CLASS 1 3.7.1.4 MEASUREMENT OF DISTANCES (A) THE DISTANCE FROM ANY POINT ON A EXTERNAL WALL OF A BUILDING TO AN ALLOTMENT BOUNDARY OR ANOTHER BUILDING IS THE DISTANCE TO THAT POINT MEASURED ALONG A LINE AT RIGHT ANGLES FROM THE ALLOTMENT

BOUNDARY OR EXTERNAL WALL OF THE OTHER BUILDING WHICH INTERSECTS THAT WITHOUT OBSTRUCTED BY A WALL COMPLYING WITH 3.7.1.5. (B) WHERE A WALL WITHIN A SPECIFIED DISTANCE IS REQUIRED TO EB CONSTRUCTED

IN A CERTAIN MANNER, ONLY THAT PART OF THE WALL (INCLUDING ANY OPENINGS) WITHIN THE SPECIFIED DISTANCE NEED BE CONSTRUCTED IN THAT MANNER. 3.7.1.5 CONSTRUCTION OF EXTERNAL WALLS

(A) EXTERNAL WALLS (INCLUDING GABLES) REQUIRED TO BE FIRE RESISTING (REFERRED TO IN 3.7.1.3 OR 3.7.1.6) MUST EXTEND TO THE UNDERSIDE OF A NON COMBUSTIBLE ROOF COVERING OR NON COMBUSTIBLE EAVES LINING AND MUST:

(1) HAVE AN FRL OF NOT LESS THAN 60/60/60 WHEN TESTED FROM THE OUTSIDE, OR (2) BE OF MASONRY VENEER CONSTRUCTION IN WHICH THE

EXTERNAL MASONRY VENEER IS NOT LESS THAN 90MM THICK, OR (3) BE OF MASONRY CONSTRUCTION NOT LESS THAN 90MM THICK. (B) OPENINGS IN EXTERNAL WALLS REQUIRED TO BE FIRE RESITING (REFERRED TO IN 3.7.1.3 OR 3.7.1.6) MUST BE PROTECTED BY

(1) NON-OPERABLE FIRE WINDOWS OR OTHER CONSTRUCTION WITH AN FRL OF NOT LESS THAN -/60/-, OR (2) SELF-CLOSING SOLID CORE DOORS NOT LESS THAN 35MM THICK.

(C) SUB-FLOOR VENTS, ROOF VENTS, WEEPHOLES AND PENETRATIONS FOR PIPES, CONDUITS AND THE LIKE NEED NOT COMPLY WITH (B) (D) CONCESSIONS FOR NON-HABITABLE ROOM WINDOWS CONDUITS AND

DESPITE THE REQUIREMENTS IN (B), IN A NON HABITABLE ROOM, A WINDOW THAT FACES THE BOUNDARY OF AN ADJOINING ALLOTMENT MAY BE NOT LESS THAN 600MM FROM THAT BOUNDARY OR, WHERE THE WINDOW FACES ANOTHER BUILDING ON THE SAME ALLOTMENT, NOT LESS THAN

1200MM FROM THAT BUILDING PROVIDED THAT-(1) IN A BATHROOM, LAUNDRY OR TOILET, THE OPENING HAS AN AREA OF NOT MORE THAN 1.2SQM, OR (2) IN A ROOM OTHER THAN REFERRED TO IN (1), OPENING HAS AN AREA OF NOT MORE THAN 0.54SQM AND-AREA OF NOT

(A) THE WINDOW IS STEEL FRAMED, THERE ARE NO OPENING SASHES AND IT IS GLAZED IN WIRED GLASS, OR (B) THE OPENING IS ENCLOSED WITH TRANSLUCENT HALLOW GLASS

BLOCKS 3.7.1.8 SEPARATING WALLS

(A) A WALL THAT SEPERATES CLASS 1 DWELLINGS, OR SEPARATES A CLASS BUILDING FROM A CLASS 10A BUILDING WHICH IS NOT APPURTENANT TO THAT CLASS 1 BUILDING MUST HAVE AN FRL OF NOT LESS THAN 60/60/60

(1) COMMENCE AT THE FOOTINGS OR GROUND SLAB (2) FXTEND-

(A) IF THE BUILDING HAS A NON COMBUSTIBLE ROOF COVERING, TO THE UNDERSIDE OF THE ROOF COVERING, OR (B) IF THE BUILDING HAS A COMBUSTIBLE ROOF COVERING, TO NOT LESS T 450MM ABOVE THE ROOF COVERING.

THAI 400/ME ADUVE THE ROOT CONCERNMENT SPECIFICATION C1.10: FIRE HAZARD PROPERTIES-MATERIALS USED IN THE BUILDING HAVING FLAMMABILITY, SMOKE DEVELOPED AND SPREAD OF FLAME INDICES AS SET OUT IN SPECIFICATION C1.10.

PART 3.7.2 : SMOKE ALARMS

- AUTOMATIC FIRE DETECTION AND ALARM SYSTEM TO BE PROVIDED IN AUTOMATIC FIRE DETECTION AND ALARM STSTEM TO BE PROVID ACCORDANCE WITH PART 3.7.2.2 REQUIREMENTS FORSMOKE ALARMS
 (A) SMOKE ALARMS MUST BE INSTALLED IN-

(1) ANY STOREY CONTAINING BEDROOMS-PART 3.8 : HEALTH AND AMENITY

- WET AREAS WITHIN THE PROPOSED BUILDING TO COMPLY WITH THE REQUIREMENTS OF PART 3.8.1 (Wet areas). PART 3.8.5 : VENTILATION

3.8.5.0 PERFORMANCE REQUIREMENT P2.4.5 IS SATISFIED FOR A MECHANICAL VENTILATION SYSTEM IF IT IS INSTALLED IN

ACCORDANCE WITH AS 1668.2

3.8.5.1 APPLICATION 3.8.5.2 VENTILATION REQUIREMENT

PART 3.8.6 SOUND INSULATION

3.8.6.1 APPLICATION COMPLIANCE WITH THIS PART SATISFIES PERFORMANCE REQUIREMENT P2.4.6 FOR SOUND INSULATION, 3.8.6.2 SOUND INSULATION REQUIREMENTS

(A) TO PROVIDE INSULATION FROM AIRBORNE AND IMPACT SOUND, A SEPARATING WALL BETWEEN 2 OR MORE CLASS 1 BUILDING MUST-

(1) ACHEIVE THE WEIGHTED SOUND REDUCTION INDEX WITH SPECTRUM ADAPTION TERM (RW+CTR) AND DISCONTINUOUS CONSTRUCTION REQUIREMENTS, AS REQUIRED BY TABLE 3.8.6.1, AND

(2) BE INSTALLED IN ACCORDANCE WITH THE APPROPRIATE REQUIREMENTS OF 3.8.6.3 AND 3.8.6.4. (B) FOR THE PURPOSE OF THIS PART, THE RW + CTR MUST BE

DETERMINED IN ACCORDANCE WITH AS/NZS 1276.2 OR ISO717.1, USING RESULTS FROM LABORATORY MEASUREMENTS.

PART 3.9 : SAFE MOVEMENT AND ACESS - THE TREADS AND RISERS OF THE PROPOSED STAIRS ARE TO COMPLY WITH PART 3.9.1.2 (GENERAL REQUIREMENTS).

 SECTION E (SERVICES AND EQUIPMENT)

 BUILDING TO COMPLY WITH THE CATEGORY 1 FIRE SAFETY PROVISIONS.

 THIS TO BE
 ACHEIVED BY MEETING THOSE PERFORMANCE REQUIREMENTS

OF THE BCA APPLICABLE TO THE BUILDING CLASSIFICATION, FROM THE FOLLOWING LIST: EP13 (FIRE HYDRANTS) EP14 (SPRINKI ER SYSTEMS) EP16(FIRE CONTROL

CENTERS), EP2.1 (AUTOMATIC SMOKE DETECTION AND WARNING), EP2.2 (EVACUATION ROUTES), EP3.2 (FIRE FIGHTING LIFT) P2.3.2(FIRE DETECTION IN SINGLE DWELLING) PART E1 : FIRE FIGHTING EQUIPMENT

- SEE FINAL ESSENTIAL SERVICES PLAN FOR FIRE FIGHTING EQUIPMENT WHICH IS TO COMPLY WITH E1.3 (FIRE HYDRANTS), E1.4 (HOSE REELS), E1.6 (PORTABLE FIRE EXTINGUISHERS),

E1.7 (FIRE AND SMOKE ALARMS), SPECIFICATION E1.17 (FIRE DETECTION AND ALARM SYSTEM) AND E1.9 (FIRE PRECAUTIONS <u>DURING</u> CONSTRUCTION).

SECTION F (HEALTH AND AMENITY) PART F1: DAMP AND WEATHERPROOFING

- STORMWATER DRAINAGE MUST COMPLY WITH AS/NZS 3500.3.2.
- -ROOF COVERING TO COMPLY WITH F1.5. -SARKING MUST COMPLY WITH AS/NZS 4200 PARTS 1 AND 2

-WATER PROOFING OF WET AREAS IN BUILDINGS, TO COMPLY WITH F1.7. -DAMP PROOFING OF FLOORS ON GROUND, TO COMPLY WITH F1.10. -PROVISION OF FLOOR WASTES, TO COMPLY WITH F1.11.

PART F4: LIGHT AND VENTIL ATION -VENTILATION OF BASEMENT CARPARK TO COMPLY WITH F4.11 (PUBLIC

CARPARKS). -OTHER PORTION OF BUILDING NOT RECEIVING NATURAL VENTILATION TO THE STANDARDS SET OUT IN PART F4, SHALL BE PROVIDED WITH A SYSTEM OF MECHANICAL VENTILATION COMPLYING WITH F4.5 (VENTILATION OF ROOMS).

STANDARDS AUSTRALIA

COMPLIANCE THE BUILDING SHALL BE CONSTRUCTED IN ACCORDANCE WITH BUT NOT LIMITED TO THE FOLLOWING AUSTRALIAN STANDARDS.

- AS2293 EMERGENCY EVACUATION LIGHTING IN BUILDINGS
- AS3700 MASONRY STRUCTURES
- AS1670 FIRE DETECTION, WARNING, CONTROL AND INTERCOM SYSTEMS-SYSTEM DESIGN. INSTALLATION AND COMMISSIONING AS1668 THE USE OF MECHANICAL VENTILATION AND AIR CONDITIONING IN
- BUILDINGS
- AS1428 GENERAL REQUIREMENTS FOR ACCESS NEW BUILDING WORK AS2293 EMERGENCY ESCAPE LIGHTING AND EXIT SIGNS FOR BUILDINGS
- AS3500 PLUMBING AND DRAINAGE: PART 3 STORMWATER DRAINAGE ALUMINUM STRUCTURES
- COMPONENTS FOR THE PROTECTION OF OPENINGS IN FIRE ASNZS1905 RESISTANT WALLS
- INSTALLATION OF ROOF TILES WINDOWS IN BUILDINGS - SELECTION AND INSTALLATION AS2047
- COMPOSITE STRUCTURES RESIDENTIAL SLABS AND FOOTINGS CONSTRUCTION AS2327
- AS2870 AS1684 RESIDENTIAL TIMBER-FRAMED CONSTRUCTION
- MASONRY STRUCTURES
- AS3013 ELECTRICAL INSTALLATIONS
- THE USE OF MECHANICAL VENTILATION AND AIR CONDITIONING IN BUILDINGS AS1668
- AS2444 PORTABLE FIRE EXTINGUISHERS AND FIRE BLANKETS-SELECTION AND LOCATION AS3786 SMOKE ALARMS

- COMPONENTS FOR THE PROTECTION OF OPENINGS IN FIRE-RESISTANT WALLS ASNZS1905
- AS1288 GLASS IN BUILDINGS- SELECTION AND INSTALLATION
- AS2107 ACOUSTICS- RECOMMENDED DESIGN SOUND LEVELS AND REVERBERATION TIMES FOR BUILDING INTERIORS AS3660.1 TERMITE MANAGEMENT-NEW BUILDING WORK
- AS3740 WATERPROOFING OF WET AREAS IN RESIDENTIAL BUILDING. AS1926.1 SAFETY BARRIERS FOR SWIMMING POOLS
- AS1926.2 LOCATION OF SAFETY BARRIERS FOR SWIMMING POOLS

ADDITIONAL NOTES

-PROVIDE SIGNAL MASTER TV ANTENNA -PROVIDE FIXED OUTDOOR CLOTHES DRYER

-ALL WALL FIXTURES TO BE INSTALLED ARE TO BE RATED AAA STANDARD

-ANY NEW HOT WATER SYSTEM IS TO ACHIEVE A MINIMUM 4 STARS -ALL EXTERNAL TILES ARE TO BE SLIP RESISTANT

PROPOSED DWELLING - 312 WARRINGAH ROAD FRENCHS FOREST 2086 - LOT 100 DP592389 (LOT 03)



REV	DATE	DESCRIPTION	BY
A	30.01.20	ISSUE TO CLIENT FOR REVIEW	EF
В	12.02.20	ISSUE TO CLIENT FOR REVIEW	EF
С	17.04.20	ISSUE TO CLIENT FOR APPROVAL	EF
D	15.05.20	ISSUE TO CLIENT FOR APPROVAL	EF
E	22.05.20	ISSUE TO CONSULTANTS FOR REVIEW	EF
F	26.05.20	ISSUE TO CLIENT & CONSULTANTS FOR REVIEW	VF
G	28.05.20	ISSUE TO CLIENT & CONSULTANTS FOR REVIEW	EF
Н	01.06.20	ISSUE TO CLIENT & CONSULTANTS FOR REVIEW	EF
J	12.06.20	ISSUE TO CLIENT & CONSULTANTS FOR REVIEW	VF
K	19.06.20	ISSUE TO CLIENT & CONSULTANTS FOR REVIEW	EF
L	01.07.20	S4.55 SUBMISSION TO COUNCIL	EF
М	07.07.20	AMENDED \$4.55 SUBMISSION TO COUNCIL	VF

DESIGN FACTS

LOT 03		
SITE AREA		603.1m ²
	PROPOSED	PERMITTED
FSR	0.52:1	
MAX. BUILDING HEIGHT	8.32m	8.5m
LANDSCAPED AREA	(30%)	30%
SITE COVERAGE	41%	
PRIVATE OPEN SPACE	60m²	60m²
TOTAL FLOOR AREA	(312.3m ²)	
ROOF AREA	(299.6m ²)	

DRAWING SCHEDULE

SHEET NO. 000	TITLE COVER SHEET	SCALE NTS	REV M
201	GROUND FLOOR PLAN	1:100	L
202	FIRST FLOOR PLAN	1:100	J
203	ROOF PLAN	1:100	Е
301	SECTIONS	1:100	J
302	ELEVATIONS	1:100	L
303	ELEVATION & WINDOW SCHEDULE	1:100	L
401	AREA SCHEDULE	1:200	E

CLIENT

Qasabian Family Investment PTY LTD 312 Warringah Road 63 Dareen Street Frenchs Forest

PROJECT ADDRESS

ALVARO ARCHITECTS PTY LTD ABN 71 604 570 309 Nom. Architect R. Alvaro 9221 0402 529 840 M Unit 24, 2-8 Daniel Street A Wetherill Park, NSW 2164 info@alvaroarchitects.com.au

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Proposed Dwelling Frenchs Forest

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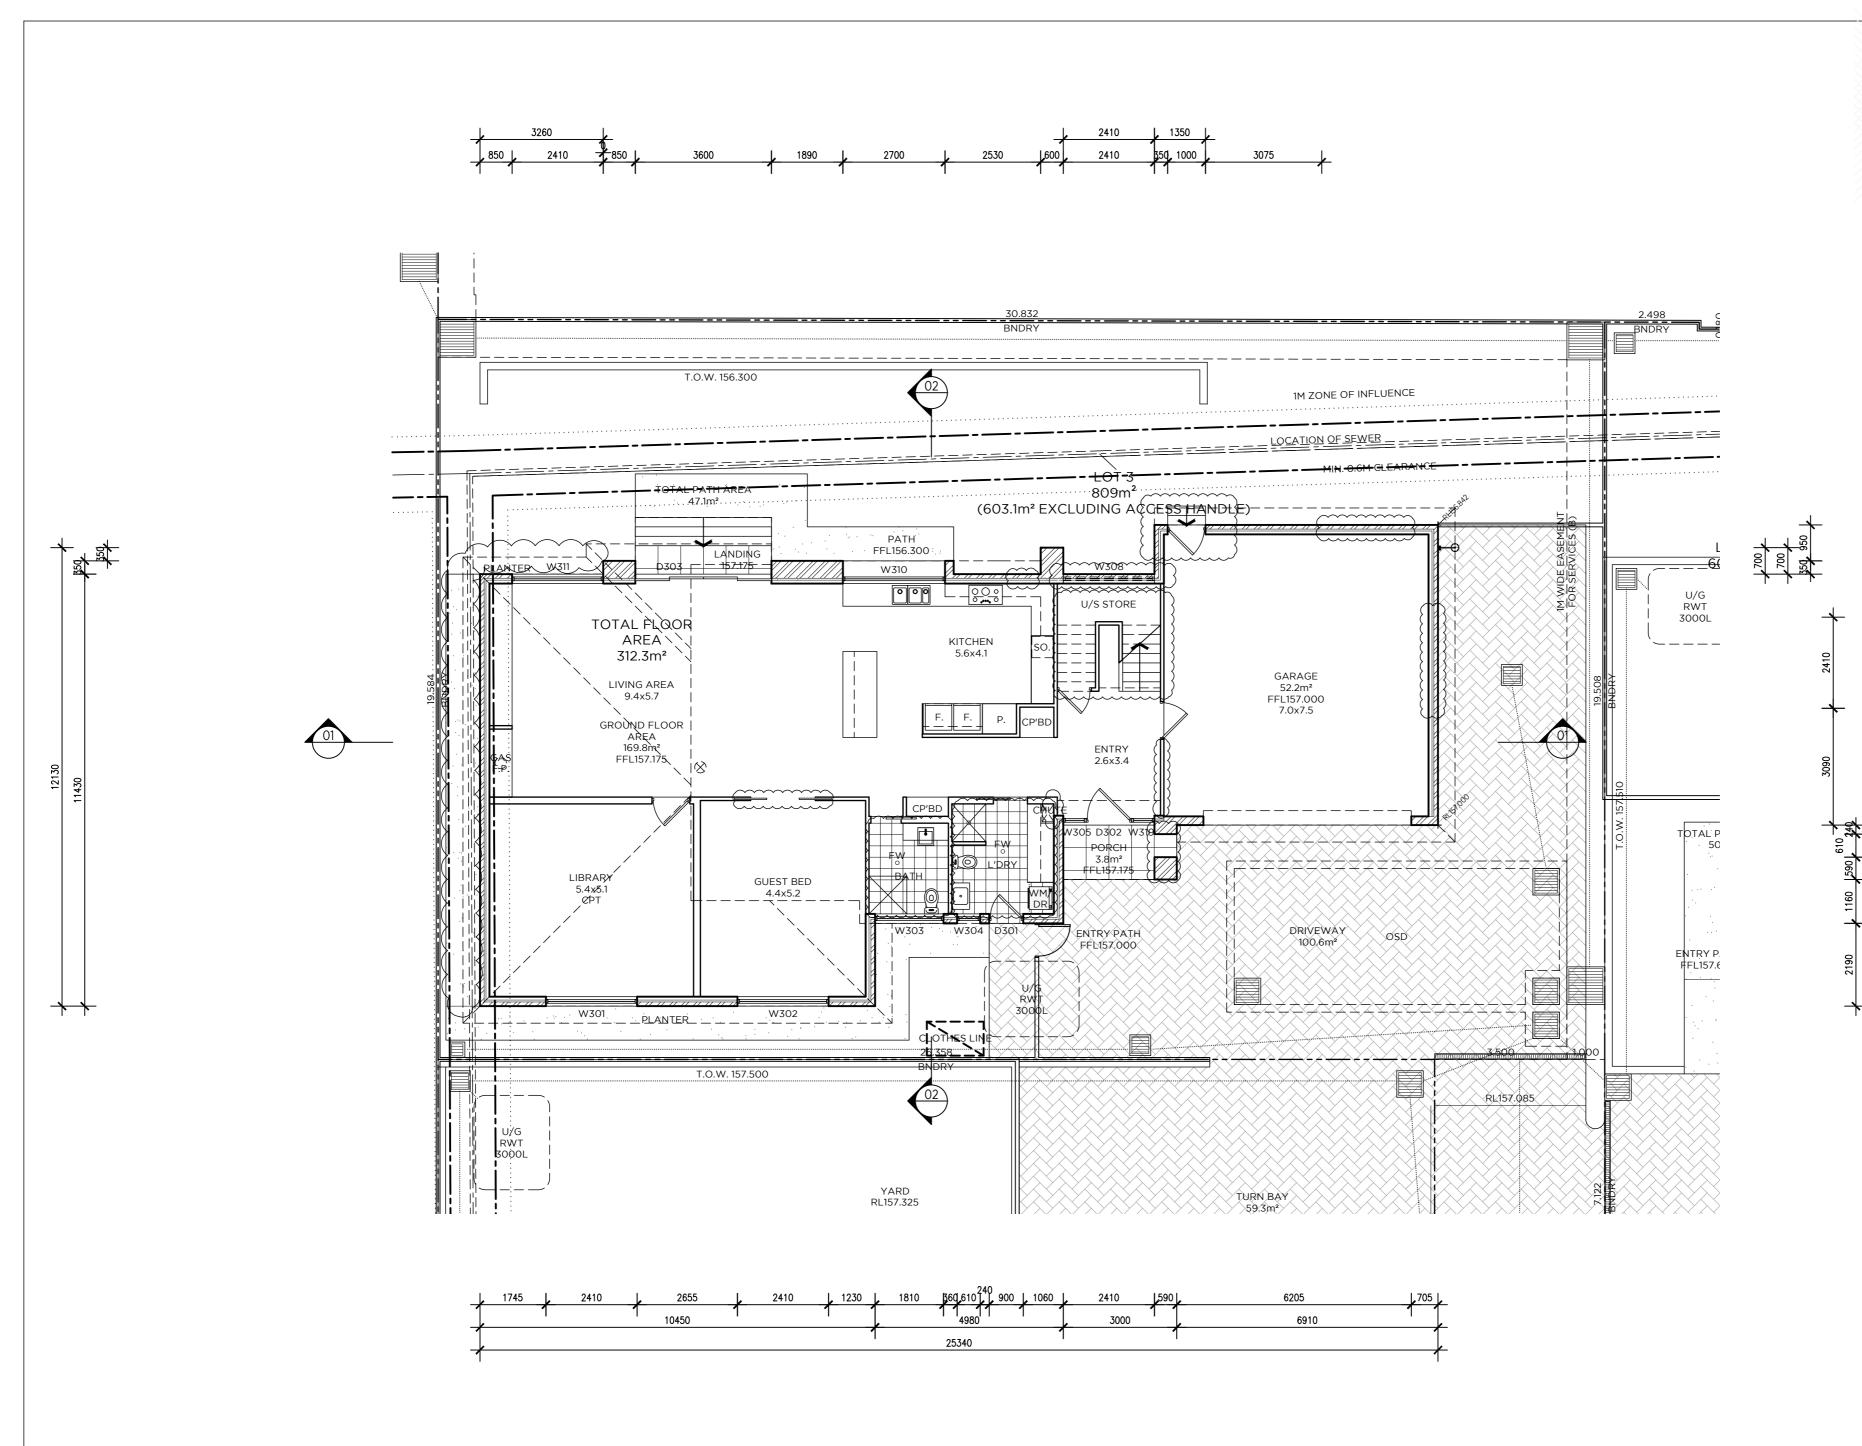
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S4.55 ISSUE DRAWING TITLE

RA

NORTH

COVER SHEET CHECKED SCALE @A2 JOB NUMBER NTS 0234 APPROVED DRAWING N RA 000



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 A
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 D
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 E
 22.05.20
 ISSUE TO CLIENT FOR REVIEW

 F
 26.05.20
 ISSUE TO CLIENT & CONSULTANTS FOR REVIEW

 H
 12.06.20
 ISSUE TO CLIENT & CONSULTANTS FOR REVIEW

 H
 12.06.20
 ISSUE TO CLIENT & CONSULTANTS FOR REVIEW

 J
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 K
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NOTES BASIX NOTES

FIXTURES ALL SHOWERHEADS 3 STAR (>7.5 <=9L/MIN)

ALL TAPS & TOILETS 3 STAR

ALTERNATIVE WATER RAINWATER TANK CONNECTED TO ALL TOILETS, LAUNDRY COLD WATER TAP & 1 OUTDOOR TAP

HOT WATER

GAS INSTANTANEOUS 6 STARS

HEATING & COOLING SYSTEM

1 LIVING AREA 3 PHASE AIRCONDITIONING EER 3.0-3.5 1 BEDROOM 3 PHASE AIRCONDITIONING EER 3.0-3.5

VENTILATION

1 BATHROOM INDIVIDUAL FAN DUCTED TO FAÇADE OR ROOF MANUAL SWITCH $\ensuremath{\mathsf{ON}}\xspace{\mathsf{OFF}}$

KITCHEN INDIVIDUAL FAN NOT DUCTED MANUAL SWITCH ON/OFF

ARTIFICIAL LIGHTING DEDICATED LED/FLOURESCENT LIGHTING TO 4 BEDROOMS/STUDY DEDICATED LED/FLOURESCENT LIGHTING TO 3 LIVING/DINING DEDICATED LED/FLOURESCENT LIGHTING TO KITCHEN/LAUNDRY/ALL

NATURAL LIGHTING

BATHROOMS/ALL HALLWAYS

WINDOW/SKYLIGHT IN KITCHEN & 3 BATHROOMS

OTHER

GAS COOKTOP & ELECTRIC OVEN FIXED OUTDOOR CLOTHES DRYING LINE

LEGEND	
CODE	DESCRIPTION
BIR	BUILT IN ROBE
С	CUPBOARD
CL	CLOTHES LINE
DP	DOWNPIPE
F	FRIDGE
FC	FIBRE CEMENT
FW	FLOOR WASTE
HWS	HOT WATER SYSTEM
L	LINEN CUPBOARD
NGL	NATURAL GROUND LINE
0	OVEN
OSD	ON-SITE DETENTION
Р	PANTRY
PB	PLASTERBOARD
RWT	RAINWATER TANK
TOW	TOP OF WALL
WIR	WALK IN ROBE
\bigotimes	SMOKE ALARM

 CLIENT
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 312 Warringah Road

 63 Dareen Street
 Frenchs Forest 2086

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 0402 529 840

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 Proposed Dwelling

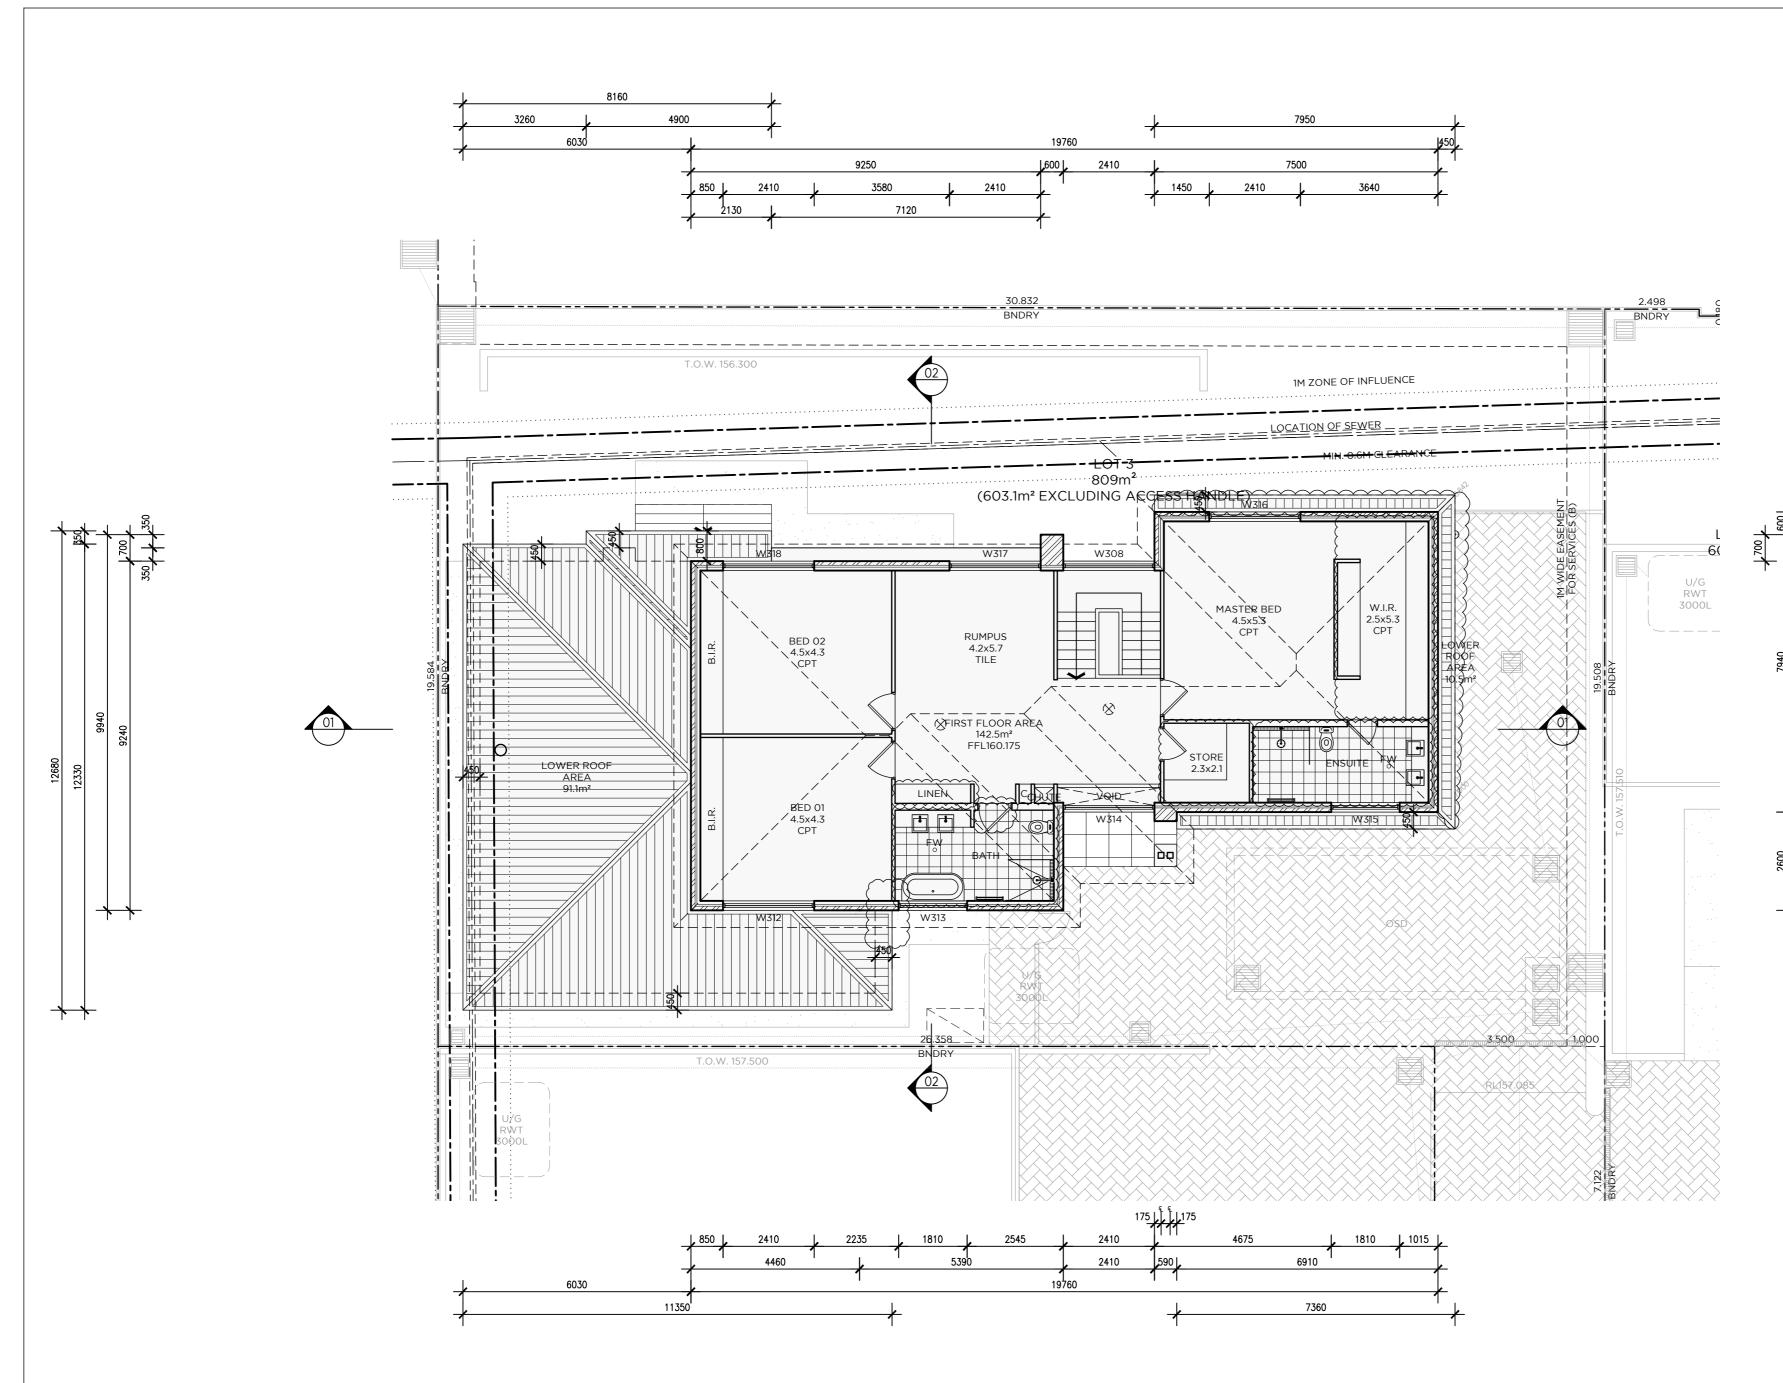
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NORTH

AP

	S4.5	5 ISSUE
DRAWN	DRAWING TITLE	
VF	GROUND FL	OOR PLAN
CHECKED	SCALE @A2	JOB NUMBER
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APPROVED	DRAWING NO.	REV
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PB	PLASTERBOARD	
RWT	RAINWATER TANK	
TOW	TOP OF WALL	
WIR	WALK IN ROBE	
\otimes	SMOKE ALARM	

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S4.55 ISSUEDRAWNDRAWING TITLEVFFIRST FLOOR PLAN

NORTH

 VF
 FIRST FLOOR PLAN

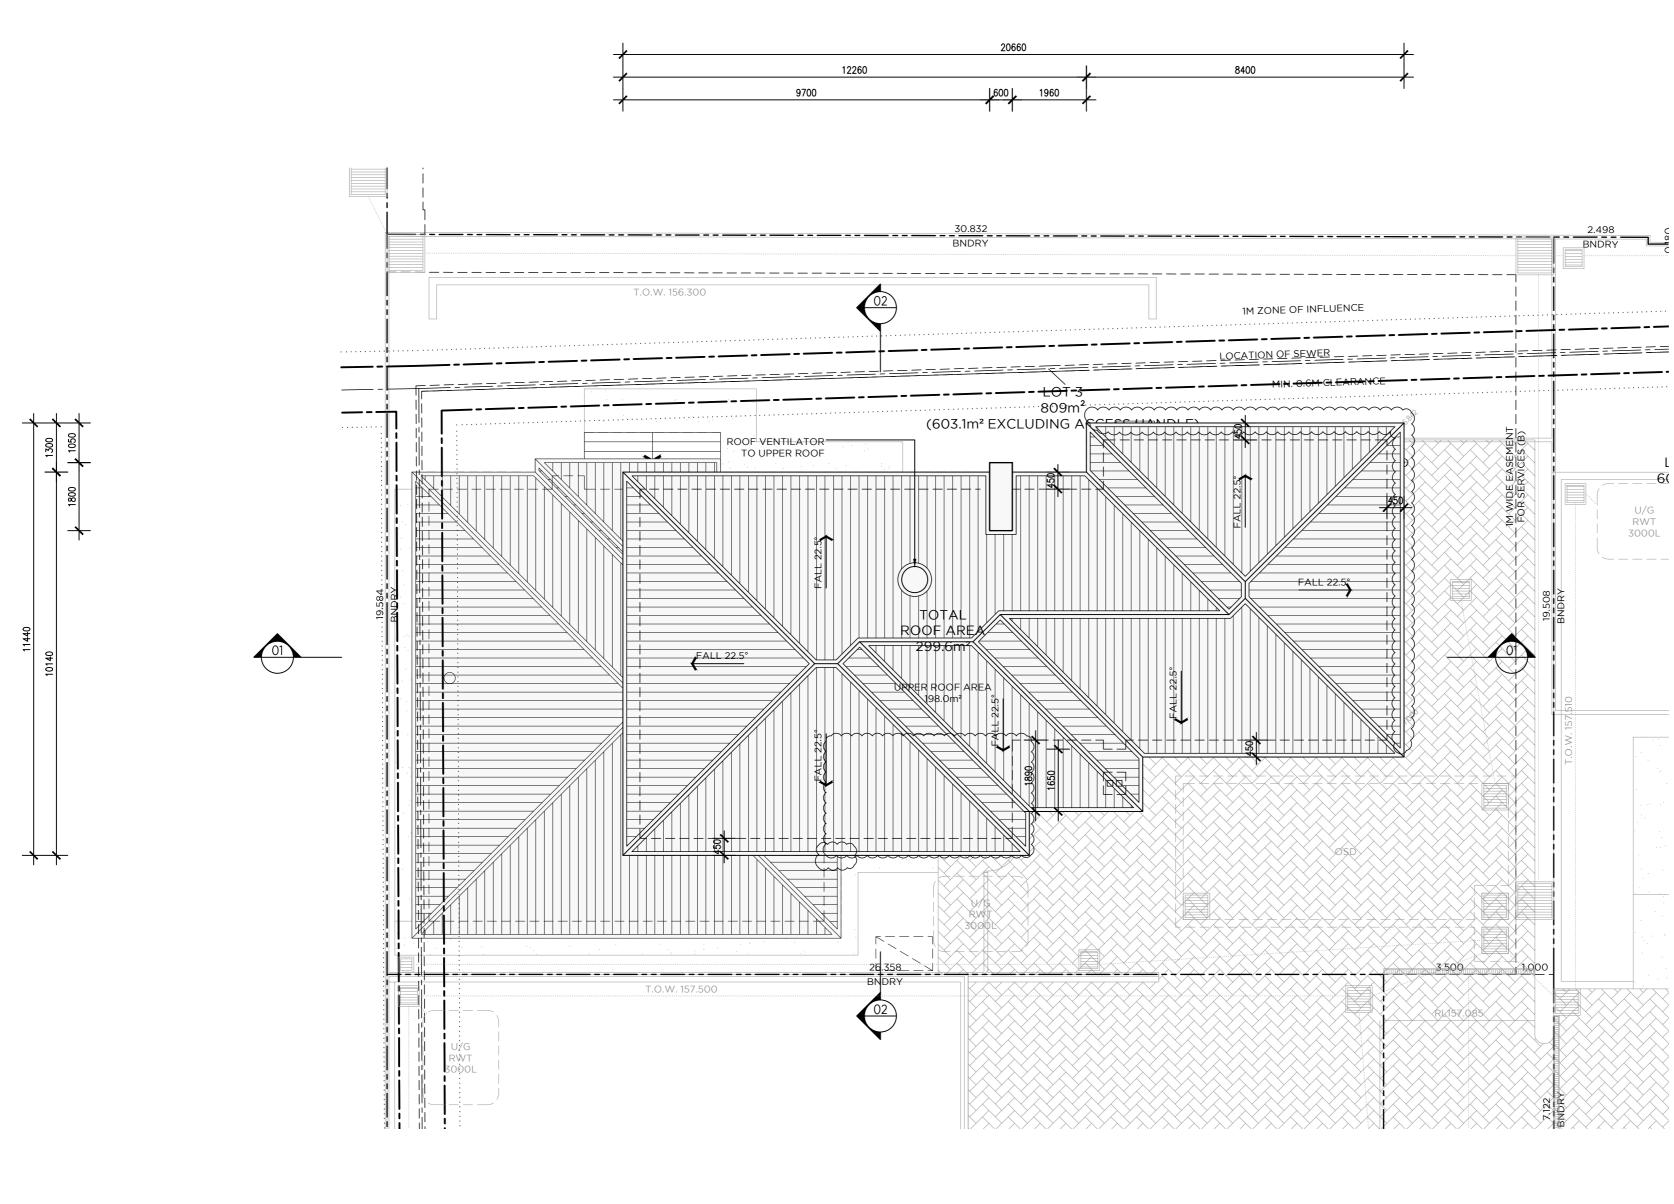
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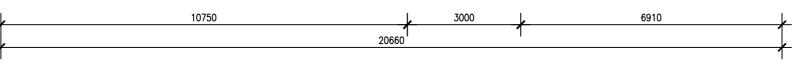
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DOKTOP & ELECTRIC OVEN
OUTDOOR CLOTHES DRYING LINE
DESCRIPTION
BUILT IN ROBE
CUPBOARD
CLOTHES LINE
DOWNPIPE
FRIDGE
FIBRE CEMENT
FLOOR WASTE
HOT WATER SYSTEM
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BATHROOMS/ALL HALLWAYS

NATURAL LIGHTING WINDOW/SKYLIGHT IN KITCHEN & 3 BATHROOMS

OTHER GAS CO FIXED O

SMOKE ALARM

Qasabian Family Investment PTY LTD 312 Warringah Road 63 Dareen Street Frenchs Forest 2086

LEGEND CODE

BIR

FC FW

HWS

NGL

OSD

PB RWT

TOW WIR

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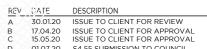
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ALL SHOWERHEADS 3 STAR (>7.5 <=9L/MIN)

ALL TAPS & TOILETS 3 STAR

GAS INSTANTANEOUS 6 STARS

HEATING & COOLING SYSTEM

ALTERNATIVE WATER

HOT WATER

NOTES BASIX NOTES FIXTURES

 D
 01.07.20
 S4.55 SUBMISSION TO COUNCIL

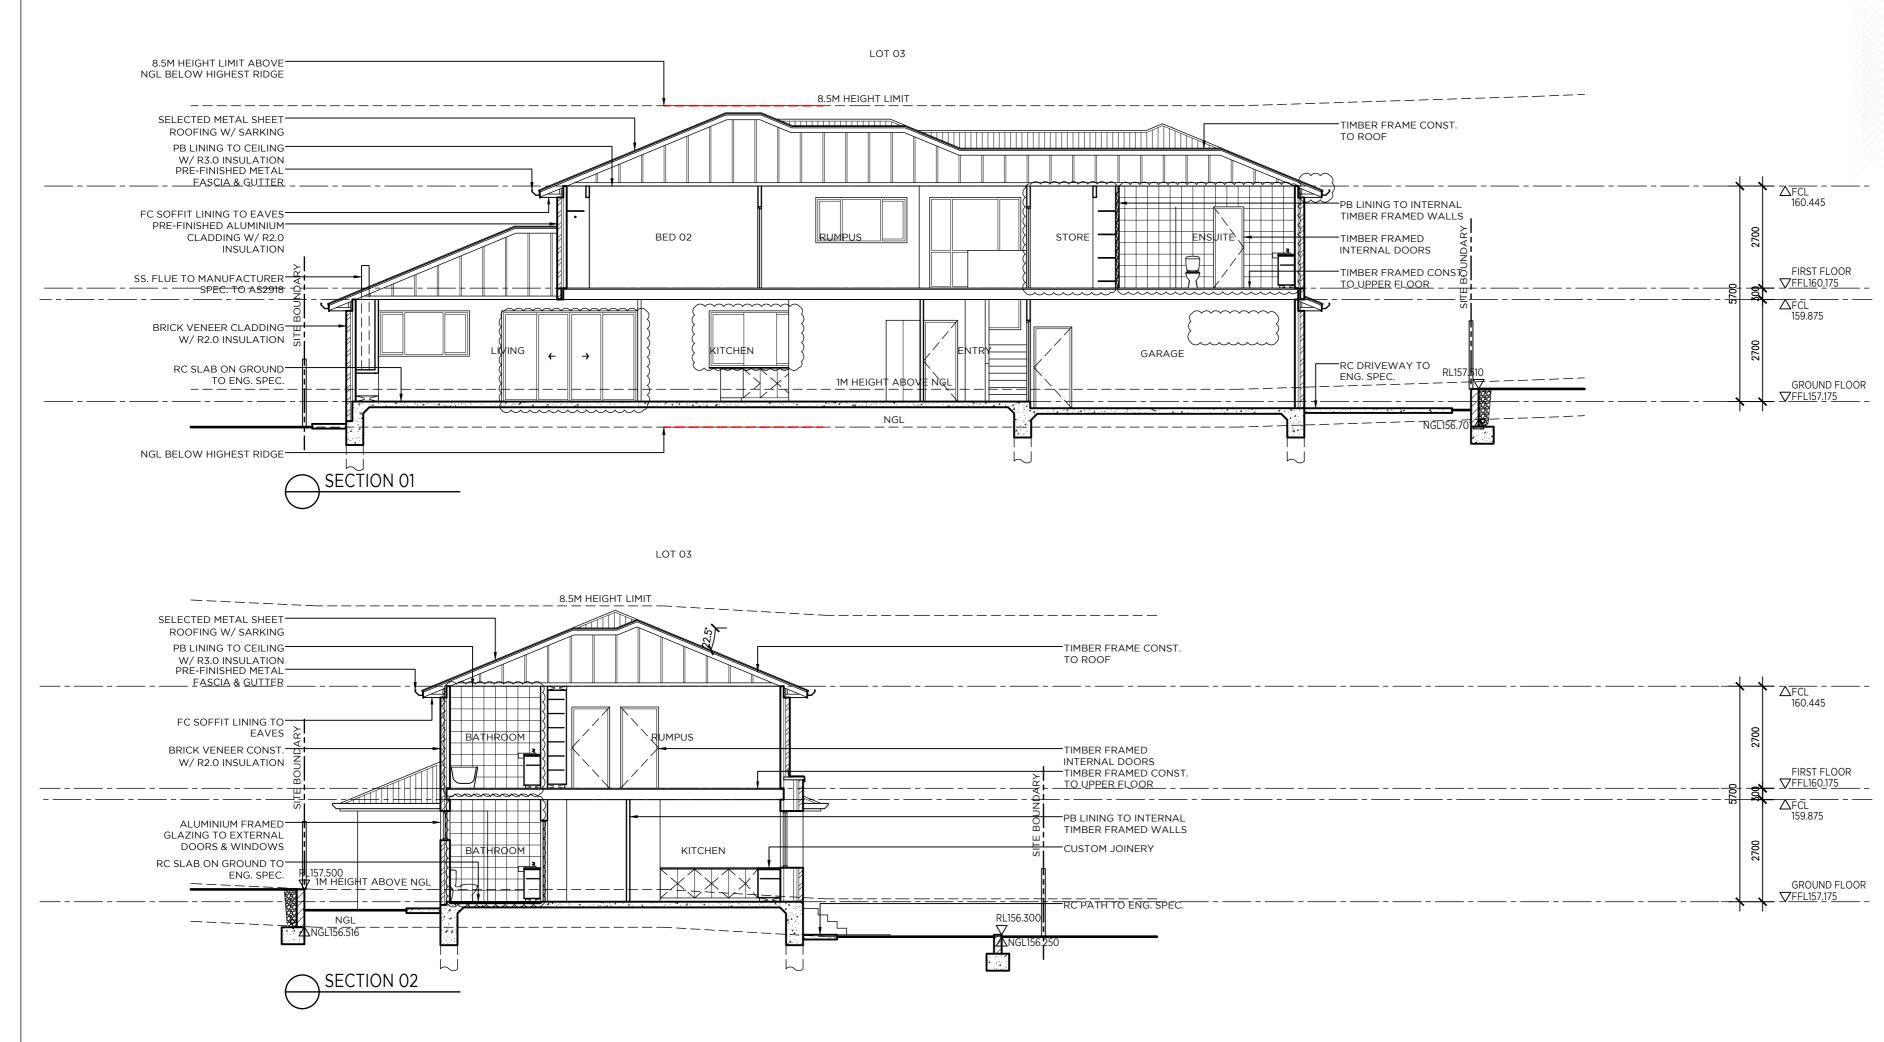
 E
 07.07.20
 AMENDED S4.55 SUBMISSION TO COUNCIL

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Proposed Dwelling Frenchs Forest Use figured dimesnions only. Verify all levels and dimensions on site before commenceing construction, fabrication, or shop drawings. © Copyright - All rights reserved. S4.55 ISSUE DRAWING TITLE NORTH DRAWN VF JOB NUMBER SCALE @A2 CHECKED RA 1:100 APPROVED DRAWING NO. RA 203 REV E

PROJECT ADDRESS

ALVARO



 REV
 CATE
 DESCRIPTION

 A
 30.0120
 ISSUE TO CLIENT FOR REVIEW

 B
 17.04.20
 ISSUE TO CLIENT FOR APPROVAL

 C
 22.05.20
 ISSUE TO CONSULTANTS FOR REVIEW

 D
 26.05.20
 ISSUE TO CLIENT & CONSULTANTS FOR REVIEW

 E
 01.06.20
 ISSUE TO CLIENT & CONSULTANTS FOR REVIEW

 F
 12.06.20
 ISSUE TO CLIENT & CONSULTANTS FOR REVIEW

 G
 19.06.20
 ISSUE TO CLIENT & CONSULTANTS FOR REVIEW

 H
 01.07.20
 S4.55 SUBMISSION TO COUNCIL

 J
 07.07.20
 AMENDED S4.55 SUBMISSION TO COUNCIL

NOTES BASIX NOTES

FIXTURES ALL SHOWERHEADS 3 STAR (>7.5 <=9L/MIN) ALL TAPS & TOILETS 3 STAR

ALTERNATIVE WATER RAINWATER TANK CONNECTED TO ALL TOILETS, LAUNDRY COLD WATER TAP & 1 OUTDOOR TAP

HOT WATER

GAS INSTANTANEOUS 6 STARS HEATING & COOLING SYSTEM

1 LIVING AREA 3 PHASE AIRCONDITIONING EER 3.0-3.5 1 BEDROOM 3 PHASE AIRCONDITIONING EER 3.0-3.5

VENTILATION 1 BATHROOM INDIVIDUAL FAN DUCTED TO FAÇADE OR ROOF MANUAL

SWITCH ON/OFF KITCHEN INDIVIDUAL FAN NOT DUCTED MANUAL SWITCH ON/OFF

ARTIFICIAL LIGHTING

DEDICATED LED/FLOURESCENT LIGHTING TO 4 BEDROOMS/STUDY DEDICATED LED/FLOURESCENT LIGHTING TO 3 LIVING/DINING DEDICATED LED/FLOURESCENT LIGHTING TO KITCHEN/LAUNDRY/ALL BATHROOMS/ALL HALLWAYS

NATURAL LIGHTING

WINDOW/SKYLIGHT IN KITCHEN & 3 BATHROOMS

OTHER GAS COOKTOP & ELECTRIC OVEN FIXED OUTDOOR CLOTHES DRYING LINE

LEGEND

CLIENT

PROJECT ADDRESS Qasabian Family Investment PTY LTD 312 Warringah Road 63 Dareen Street Frenchs Forest 2086 Frenchs Forest

ALVARO ARCHITECTS PTY LTD ABN 71 604 570 309 Nom. Architect R. Alvaro 9221 0402 529 840 M Unit 24, 2-8 Daniel Street, A Wetherill Park, NSW 2164 E info@alvaroarchitects.com.au

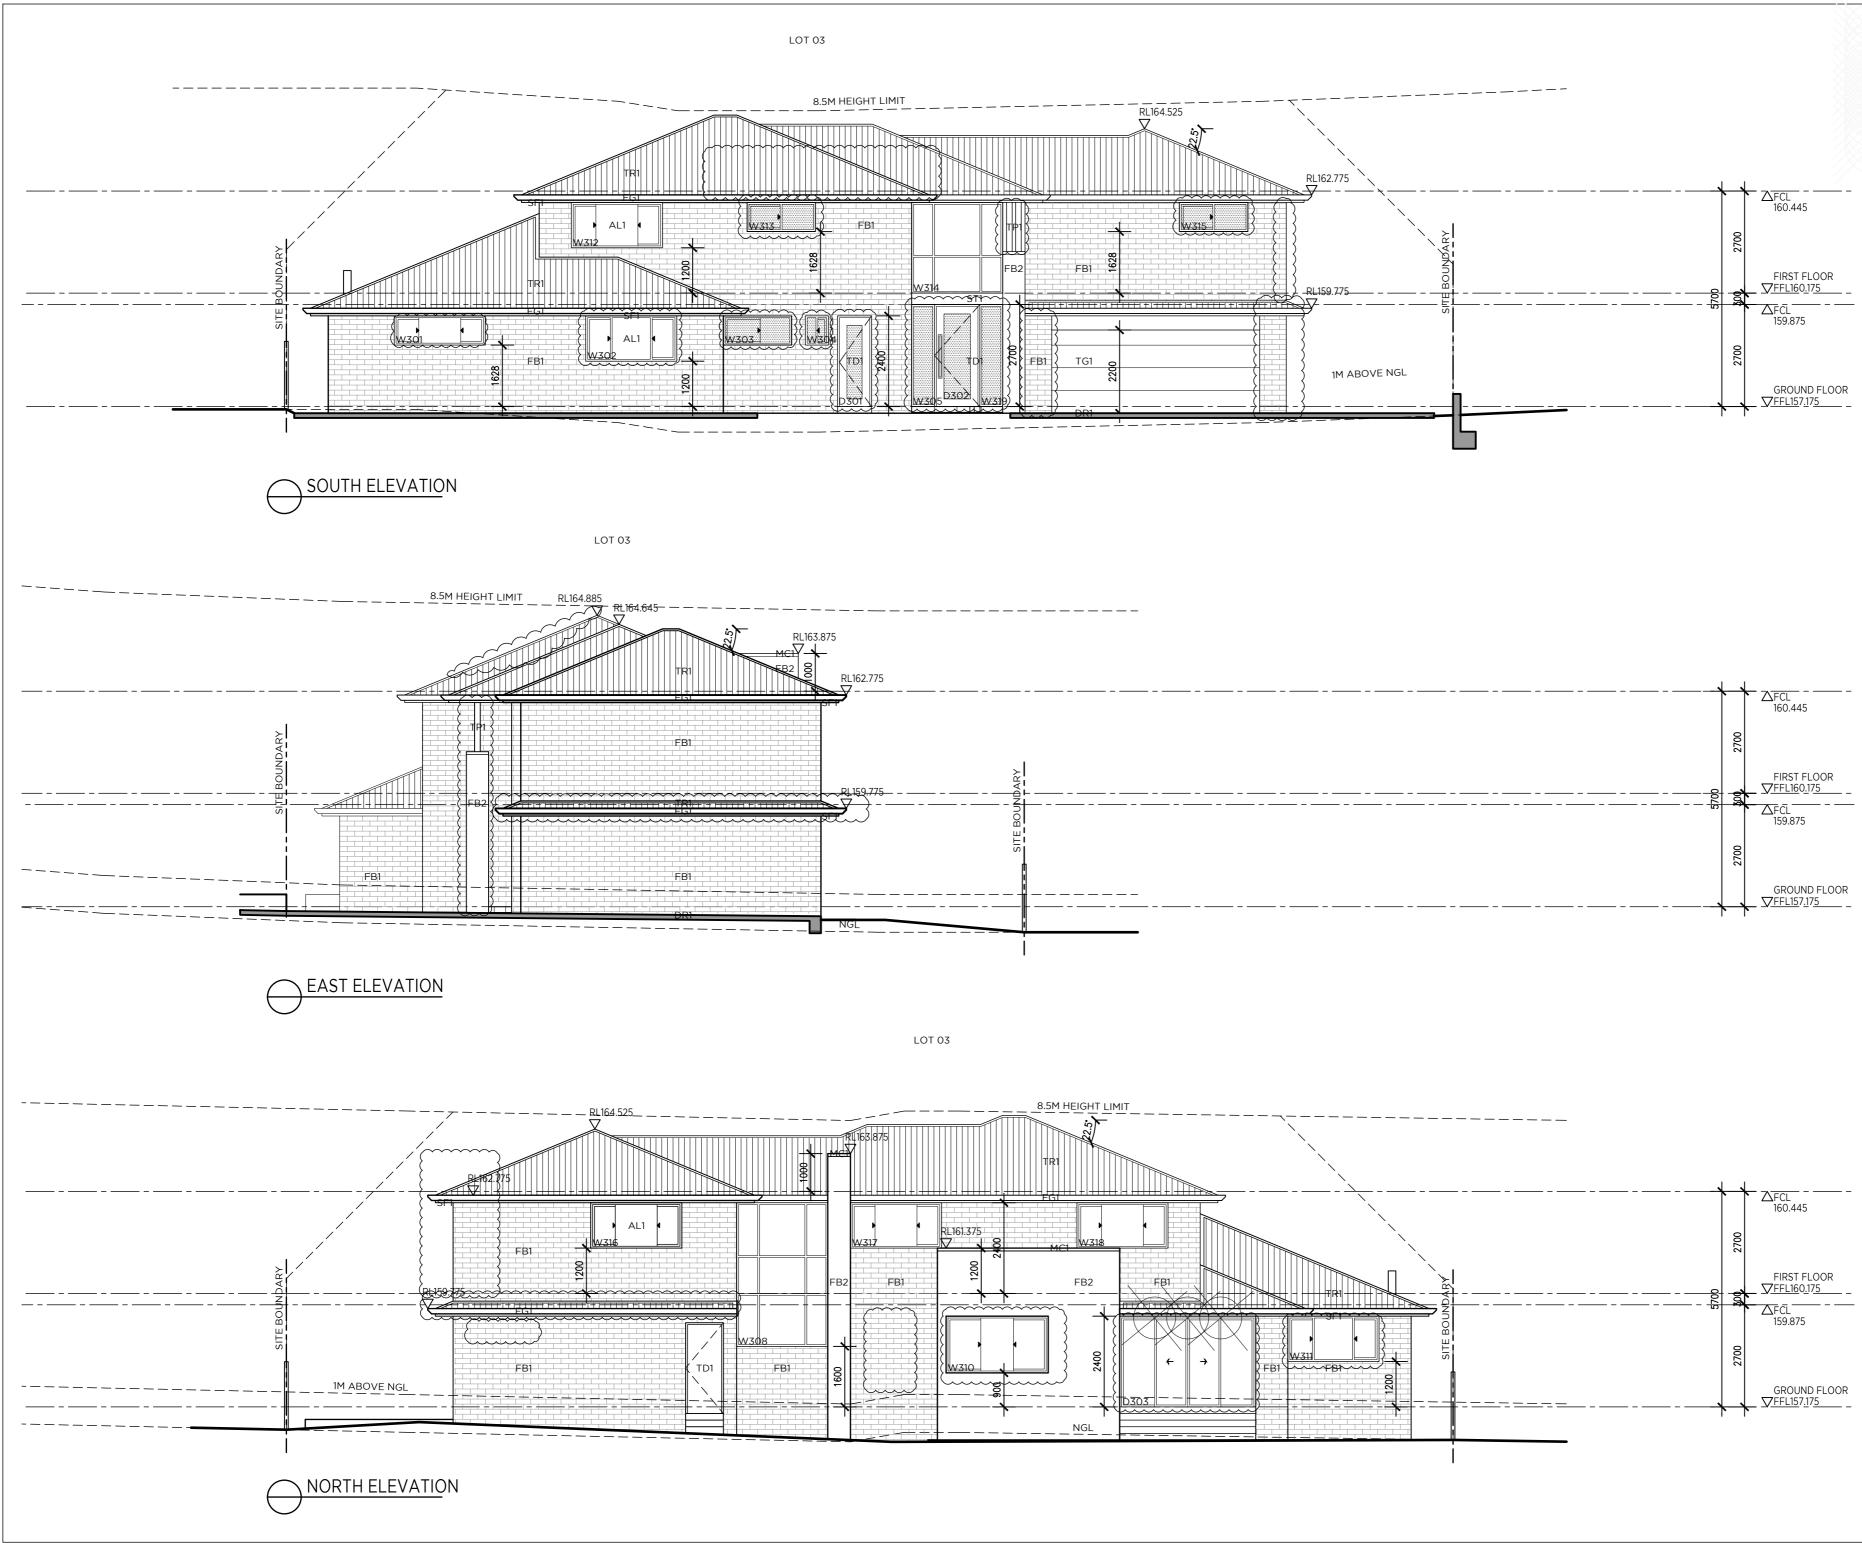
ALVAROARCHITECTS.COM.AU

ALVARO

PROJECT Proposed Dwelling Frenchs Forest

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	S4.5	5 ISSUE
DRAWN	DRAWING TITLE	
VF	SECTIONS	
CHECKED	SCALE @A2	JOB NUMBER
RA	1:100	0234
APPROVED	DRAWING NO.	REV
RA	301	J
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REV CATE DESCRIPTION A 30.0120 ISSUE TO CLIENT FOR REVIEW B 17.04.20 ISSUE TO CLIENT FOR APPROVAL C 15.05.20 ISSUE TO CLIENT FOR APPROVAL D 22.05.20 ISSUE TO CLIENT FOR APPROVAL E 26.05.20 ISSUE TO CLIENT & CONSULTANTS FOR REVIEW F 28.05.20 ISSUE TO CLIENT & CONSULTANTS FOR REVIEW G 01.06.20 ISSUE TO CLIENT & CONSULTANTS FOR REVIEW H 12.06.20 ISSUE TO CLIENT & CONSULTANTS FOR REVIEW J 19.06.20 ISSUE TO CLIENT & CONSULTANTS FOR REVIEW K 01.07.20 S4.55 SUBMISSION TO COUNCIL L 07.07.20 AMENDED \$4.55 SUBMISSION TO COUNCIL

NOTES BASIX NOTES

FIXTURES ALL SHOWERHEADS 3 STAR (>7.5 <=9L/MIN) ALL TAPS & TOILETS 3 STAR

ALTERNATIVE WATER

RAINWATER TANK CONNECTED TO ALL TOILETS, LAUNDRY COLD WATER TAP & 1 OUTDOOR TAP

HOT WATER

GAS INSTANTANEOUS 6 STARS

HEATING & COOLING SYSTEM

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DEDICATED LED/FLOURESCENT LIGHTING TO 4 BEDROOMS/STUDY DEDICATED LED/FLOURESCENT LIGHTING TO 3 LIVING/DINING DEDICATED LED/FLOURESCENT LIGHTING TO KITCHEN/LAUNDRY/ALL BATHROOMS/ALL HALLWAYS

NATURAL LIGHTING

WINDOW/SKYLIGHT IN KITCHEN & 3 BATHROOMS

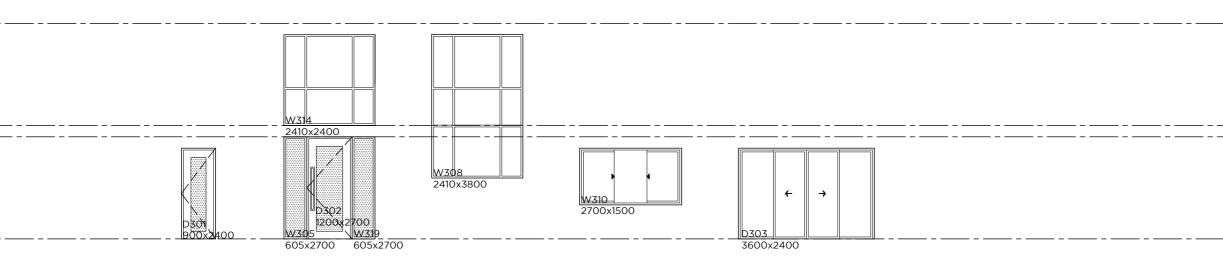
OTHER

GAS COOKTOP & ELECTRIC OVEN FIXED OUTDOOR CLOTHES DRYING LINE

GEND	
AL1	PRE-FINISHED ALUMINIUM FRAMED GLAZING
DR1	COLOURED CONCRETE DRIVEWAY
FB1	FACE BRICK FINISH - MAJOR
FB2	PAINT & RENDER FINISH TO COLUMNS & FIN WALLS
FG1	PRE-FINISHED METAL FASCIA AND GUTTER
MC1	PRE-FINISHED METAL CAPPING
SF1	PAINT FINISH TO FIBRE CEMENT SOFFIT LINING
ST1	PAINT FINISH TO EXPOSED STEEL FRAMEWORK
TD1	PRE-FINISHED ALUMINIUM FRAMED EXTERNAL DOOR
TG1	PRE-FINISHED GARAGE DOOR
TL1	SELECTED NON-SLIP OUTDOOR TILE
TR1	METAL SHEET ROOFING
TP1	FACE TIMBER FINISH TO POSTS
WP1	PRE-FINISHED ALUMINIUM CLADDING

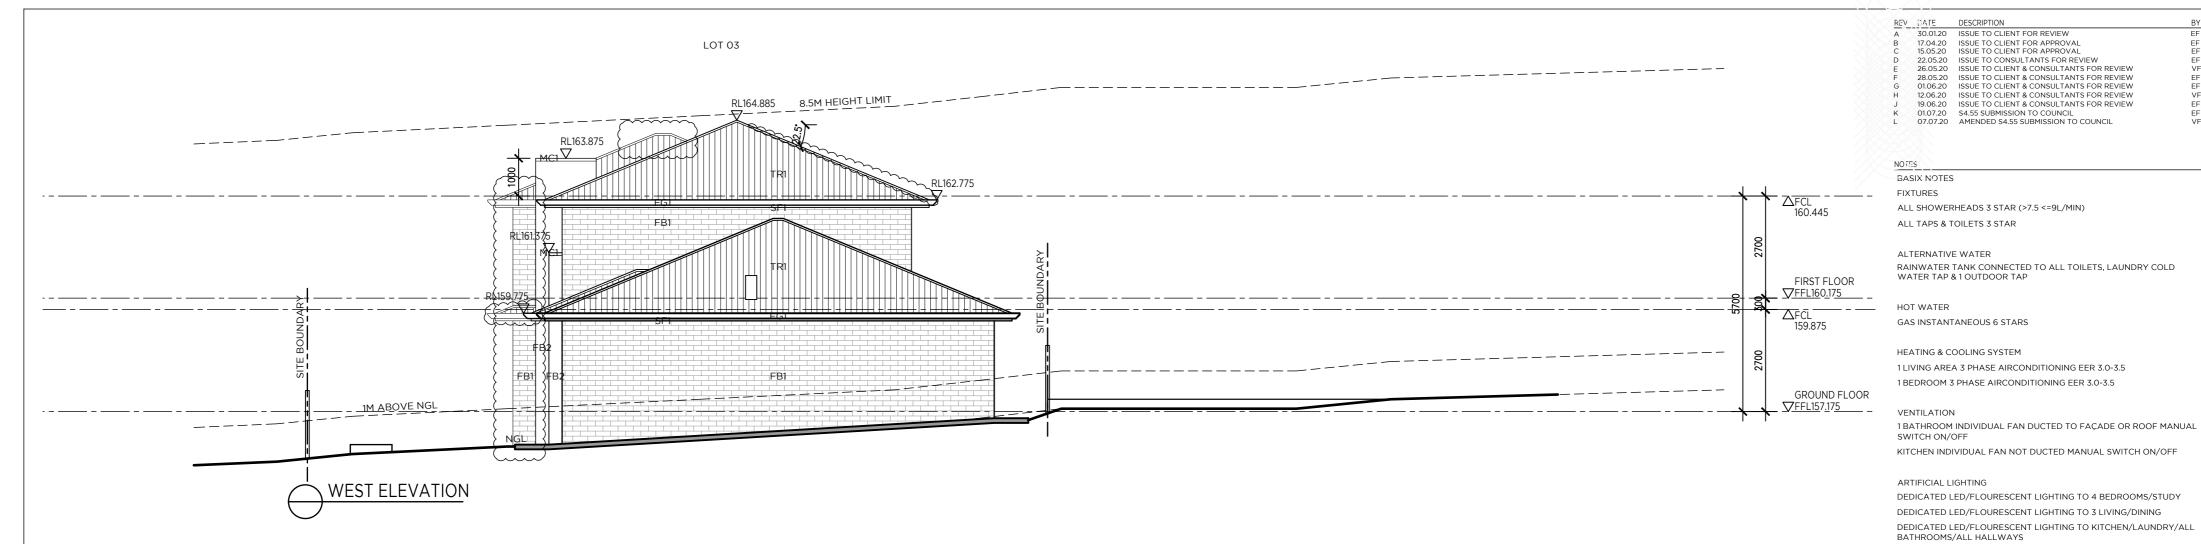
	CLIENT PROJECT ADDRESS
	Qasabian Family Investment PTY LTD 312 Warringah Road 63 Dareen Street Frenchs Forest 2086 Frenchs Forest
AFCL 160.445 FIRST FLOOR VFFL160.175 FIRST FLOOR VFFL160.175 FIRST FLOOR VFFL160.175 GROUND FLOOR VFFL157.175 GROUND FLOOR VFFL157.175	ALVARO ARCHITECTS PTY LTD ABN 71 604 570 309 Nom. Architect R. Alvaro 9221 0402 529 840 M Unit 24, 2-8 Daniel Street, A Wetherill Park, NSW 2164 E info@alvaroarchitects.com.au ALVAROARCHITECTS.COM.AU PROJECT PROJECT Proposed Dwelling Frenchs Forest Use figured dimesnions only. Verify all levels and dimensions on site before commenceing construction, fabrication, or shop drawings. © Copyright - All rights reserved.
	S4.55 ISSU
	VF ELEVATIONS CHECKED SCALE @A2 JOB NUMBER RA 1:100 0234 APPROVED DRAWING NO. REV







		SIZE (m	m)				EAVE (mm)		
No.	STYLE	WIDTH	HEIGHT	AREA(m ²) REMARKS	CODE	ORIENTATION	WIDTH (INCL. GUTTER) HEIGHT	BOVE WINDOW	SILL HEIGHT (mm)
W301	SLIDING WINDOW	2410	772	1.86 ALUMINIUM B DG AIR FILL CLEAR (U=4.8 SHGC=0.59)	SW0724	S	600	0	1628
W302	SLIDING WINDOW	2410	1200	2.89 ESS SG 3CLR (U=6.4 SHGC=0.76)	SW1224	S	600	0	1200
W303	OPAQUE SLIDING WINDOW	1810	772	1.40 ESS SG 3CLR (U=6.4 SHGC=0.76)	SW0718	S	600	3000	1628
W304	OPAQUE SLIDING WINDOW	610	772	0.47 ESS SG 4CLR (U=6.5 SHGC=0.67)	SW0706	S	600	3000	1628
W305	OPAQUE FIXED WINDOW	605	2700	1.63 ESS SG 4CLR (U=6.5 SHGC=0.67)	CUSTOM	S	2040	2700	0
W308	FIXED WIDOW	2410	3800	9.16 SIG SG 4 CLR (U=6.0 SHGC=0.78)	CUSTOM	N	600	0	1600
W310	SLIDING WINDOW	2700	1500	4.05 ESS SG 3CLR (U=6.4 SHGC=0.76)	CUSTOM	N	0	N/A	900
W311	SLIDING WINDOW	2410	1200	2.89 ESS SG 3CLR (U=6.4 SHGC=0.76)	SW1224	N	600	0	1200
W312	SLIDING WINDOW	2410	1200	2.89 ESS SG 3CLR (U=6.4 SHGC=0.76)	SW1224	S	600	0	1200
W313	OPAQUE SLIDING WINDOW	1810	772	1.40 ESS SG 3CLR (U=6.4 SHGC=0.76)	SW0718	S	600	0	1628
W314	FIXED WIDOW	2410	2400	5.78 SIG SG 4 CLR (U=6.0 SHGC=0.78)	CUSTOM	S	2040	0	0
W315	OPAQUE SLIDING WINDOW	1810	772	1.40 ESS SG 3CLR (U=6.4 SHGC=0.76)	SW0718	S	600	0	1628
W316	SLIDING WINDOW	2410	1200	2.89 ESS SG 3CLR (U=6.4 SHGC=0.76)	SW1224	N	600	0	1200
W317	SLIDING WINDOW	2410	1200	2.89 ESS SG 3CLR (U=6.4 SHGC=0.76)	SW1224	N	600	0	1200
W318	SLIDING WINDOW	2410	1200	2.89 ESS SG 3CLR (U=6.4 SHGC=0.76)	SW1224	N	600	0	1200
W319	OPAQUE FIXED WINDOW	605	2700	1.63 ESS SG 4CLR (U=6.5 SHGC=0.67)	CUSTOM	S	2040	2700	0
D301	OPAQUE GLAZED INSERT LAUNDRY DOOR	900	2400	2.16 ALUMINIUM B SG CLEAR (U=6.7 SHGC=0.70)	CUSTOM	S	600	3000	0
D302	OPAQUE GLAZED INSERT ENTRY DOOR	1200	2700	3.24 ALUMINIUM B SG CLEAR (U=6.7 SHGC=0.70)	CUSTOM	S	2040	2700	0
D303	GLAZED DOUBLE SLIDING DOOR	3600	2400	8.64 ESS SG 4CLR (U=6.2 SHGC=0.74)	CUSTOM	N	950	0	0



		CLIENT	PROJECT ADDRESS
		Qasabian Family Investment PTY L 63 Dareen Street Frenchs Forest	TD 312 Warringah Road Frenchs Forest 2086
 	► <u>AFCL</u> 160.445		
2700		ALVARO ARCHITECTS PTY LTD ABN 71 604 570 309 Nom. Architect R. Alvaro 9221 0402 529 840	
 2100 200	FIRST FLOOR ∇ FFL160.175 Δ FCL	M Unit 24, 2-8 Daniel Street, A Wetherill Park, NSW 2164 E info@alvaroarchitects.com.au ALVAROARCHITECTS.COM.AU	ALVARO
2700	159.875	PROJECT Proposed Dwellin Frenchs Forest	ıg
 	GROUND FLOOR	Use figured dimesnions only. Verify all levels a commenceing construction, fabrication, or sho © Copyright - All rights reserved.	

NATURAL LIGHTING

GAS COOKTOP & ELECTRIC OVEN FIXED OUTDOOR CLOTHES DRYING LINE

OTHER

LEGEND AL1

DR1

FB1

FB2 FG1

MC1 SF1

ST1

TD1

TG1

TL1

TR1 TP1

WP1

WINDOW/SKYLIGHT IN KITCHEN & 3 BATHROOMS

PRE-FINISHED ALUMINIUM FRAMED GLAZING

PRE-FINISHED METAL FASCIA AND GUTTER

PAINT FINISH TO FIBRE CEMENT SOFFIT LINING

PAINT FINISH TO EXPOSED STEEL FRAMEWORK

PRE-FINISHED ALUMINIUM FRAMED EXTERNAL DOOR

PAINT & RENDER FINISH TO COLUMNS & FIN WALLS

COLOURED CONCRETE DRIVEWAY

FACE BRICK FINISH - MAJOR

PRE-FINISHED METAL CAPPING

PRE-FINISHED GARAGE DOOR

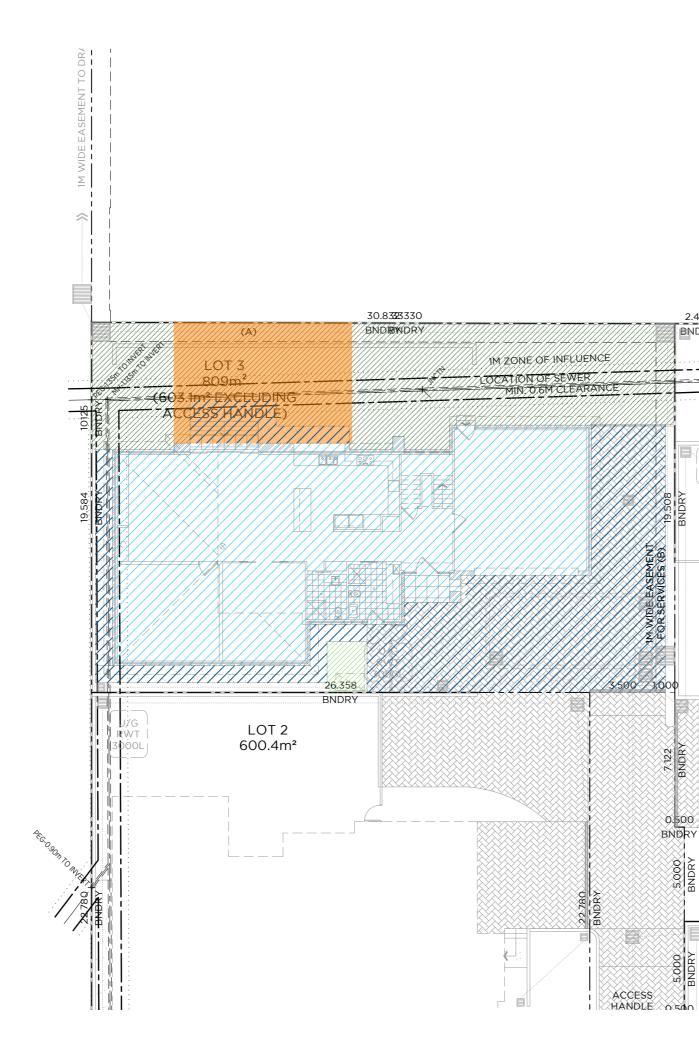
FACE TIMBER FINISH TO POSTS PRE-FINISHED ALUMINIUM CLADDING

METAL SHEET ROOFING

SELECTED NON-SLIP OUTDOOR TILE

	DRAWN	DRAWING TITLE	
	VF	ELEVATION & WINDOW	
		SCHEDULE	
	CHECKED	SCALE @A2	JOB NUMBER
	RA	1:100	0234
	APPROVED	DRAWING NO.	REV
	RA	303	L
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 REV
 DATE
 DESCRIPTION

 A
 30.0120
 ISSUE TO CLIENT FOR REVIEW

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01.07.20 S4.55 SUBMISSION TO COUNCIL 07.07.20 AMENDED S4.55 SUBMISSION TO COUNCIL

ΒY EF EF EF

EF VF

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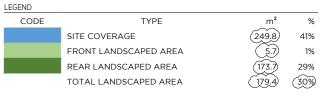
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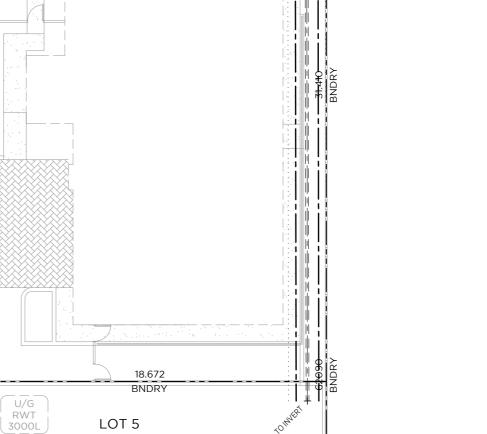




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10%

26%



MH.

~_==

16.675

BNDRY

600.5m²

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LOT 5

600.5m²

2.498

RWT

3000

7,122 MDD

0.500 BNDRY

8

5.000

BNDR



S4.55 ISSUE

NORTH VF RA <u>14</u>

DRAWN

DRAWING TITLE JOB NUMBER SCALE @A2 CHECKED 1:200 APPROVED DRAWING NO. RA 401 REV