# PROPOSED ALTERATIONS AND ADDITIONS AT 39 CUMBERLAND AVENUE, COLLAROY NSW

LEGEND			
DP ●	DOWNPIPE		
>>>	STORMWATER LINE		
>>>	STORMWATER LINE DRAINING TO RWT		
—— OF ——	OVER FLOW PIPE		
SSD	SUBSOIL LINE		
SWRM	STORMWATER RISING MAIN		
e	EXISTING STORMWATER LINE		
SWSW	AUTHORITY STORMWATER LINE		
HL HL	HIGH LEVEL STORMWATER LINE		
s	AUTHORITY SEWER LINE		
w	AUTHORITY WATER LINE		
—— G —— G ——	AUTHORITY GAS LINE		
— — E —	AUTHORITY ELECTRICITY LINE		
— F0— F0— F0—	AUTHORITY FIBRE OPTIC LINE		
TEL	AUTHORITY COMMS LINE		
//	FENCE LINE		
	GRATED SURFACE INLET PIT		
	GRATED SURFACE INLET PIT WITH ENVIROPOD INSERT		
	JUNCTION PIT		
	KERB INLET PIT		
	EXISTING GRATED SURFACE INLET PIT		
	GRATED TRENCH DRAIN		
	EXISTING JUNCTION PIT		
	EXISTING KERB INLET PIT		
eTEL	EXISTING TELSTRA PIT		
⊞ eHYD	EXISTING HYDRANT		
⊠ eSV	EXISTING STOP VALVE		
□ eGAS	EXISTING GAS VALVE		
O ePP	EXISTING POWER POLE		

<u>LEGEN<sup>®</sup>D</u>					
FF Ø	FIRST FLUSH				
eSMH	EXISTING SEWER MANHOLE				
OFP	OVERLAND FLOW PATH				
RWO ∅	RAINWATER OUTLET				
PS •	PIPE STAND				
CO Ø	CLEAR OUT POINT				
DDO Ø	DISH DRAIN OUTLET				
PD Ø	PLANTER DRAIN				
3	CAPPING				
1.01	PIT TAG/NUMBER				
RH 🖸	RAINHEAD				
•	DOWNPIPE DROP				
$\bowtie$	NON RETURN VALVE				
<u> </u>	WALL PENETRATION				
DP •	DOWNPIPE SPREADER				
-	WARNING LIGHT				
0.00 �	SPOT LEVELS				
Δ	BENCHMARK				



DIAL BEFORE YOU DIG SHOULD BE CONTACTED PRIOR TO ANY EXCAVATION ON SITE

TM: TRADE MARK OF THE ASSOCIATION OF DIAL BEFORE YOU DIG SERVICES LTD. USED UNDER LICENSE.

DRAWING REGISTER					
NUMBER	REVISION				
SW001	COVER SHEET	A			
SW010	SITE STORMWATER AND ROOF PLAN & DETAILS	А			
ER001	EROSION AND SEDIMENT CONTROL PLAN	A			

#### **DRAINAGE NOTES:**

ALL PIPES TO BE LAID ON 75mm SAND BED WITH THE BARRELS FULLY

100mm AND 150mm DIAMETER PIPES TO BE LAID ON MINIMUM 1%

MINIMUM DEPTH OF COVER FOR PIPES NOT SUBJECT TO VEHICULAR LOADING TO BE 300mm

ALL DRAINAGE PIPES LAID UNDER PAVEMENT SHALL BE REINFORCED CONCRETE WITH RUBBER RING JOINTS

BACKFILL TRENCHES WITH COMPACTED SAND OR APPROVED AGGREGATE MATERIAL

ALL PITS TO HAVE 600x600mm INTERNAL DIMENSIONS (U.N.O.)

SILT ARRESTORS TO HAVE 900x900mm INTERNAL DIMENSIONS

HEAVY DUTY GRATES AND COVERS ARE TO BE PROVIDED IN TRAFFICABLE AREAS

PIT GRATE TO BE TYPE WELDLOK OR APPROVED EQUIVALENT

ALL PITS SHALL BE PROVIDED WITH A LOCKING CLIP

ALL PITS SHALL BE MAINTAINED REGULARLY

TOP OF BENCHING SHALL BE TO THE HALF OF THE OUTLET PIPE DIAMETER

MAXIMUM FRONT ENTRY PIPE: -STRAIGHT ENTRY - Ø750 SKEW ENTRY 45° - Ø525

Ø100 SUBSOIL DRAINAGE PIPE 3000mm LONG WRAPPED IN FABRIC SOCK TO BE PROVIDED ADJACENT TO INLET PIPES

COMPRESSIVE STRENGTH f'c FOR CAST IN SITU CONCRETE TO BE A MINIMUM OF 20MPa AT 28 DAYS

PROVIDE CLEANING EYES TO ALL DOWNPIPES NOT DIRECTLY CONNECTED

ISOLATED JOINTS TO BE PROVIDED TO ISOLATE CONCRETE PAVEMENTS FROM PITS

ALL TRENCH GRATES PROVIDED SHALL HAVE A MINIMUM CLEAR WIDTH OF 200mm

STORMWATER DRAINAGE CONNECTIONS TO THE MAIN SYSTEM SHALL BE TO THE REQUIREMENTS AND THE SATISFACTION OF LOCAL COUNCIL

#### ABBREVIATIONS:

ø or DIA DIAMETER CALIFORNIA BEARING RATIO CHAINAGE CENTER LINE CO CLEAR OUT DD DISH DRAIN DDO DISH DRAIN OUTLET DEJ DOWELLED EXPANSION JOINT DGB DENSE GRADED BASECOURSE DGS DENSE GRADED SUB-BASE DP DOWNPIPE **EXISTING** FFL FINISHED FLOOR LEVEL GTD GRATED TRENCH DRAIN GSIP GRATED SURFACE INLET PIT HYDHYDRANT ISOLATING JOINT INTEGRAL KERB INTERSECTION POINT KIP KERB INLET PIT ΚO KERB ONLY KERB & GUTTER KR KERB RETURN LONGITUDINAL SECTION NGL NATURAL GROUND LEVEL OFP OVERLAND FLOW PATH OSD ON-SITE DETENTION RADIUS REINFORCED CONCRETE PIPE ROLL KERB & GUTTER REDUCED LEVEL RWRETAINING WALL RAINWATER TANK SAWN CONTROL JOINT SEWER MAN HOLE STORMWATER SW

STORMWATER PIT

STOP VALVE

TOP OF KERB

TOP OF WALL

CHLORIDE

TYPICAL

TOP WATER LEVEL

TANGENT POINT

BENCH MARK

STORMWATER SUMP

STORMWATER RISING MAIN

UNPLASTICISED POLYVINYL

UNLESS NOTED OTHERWISE

WEAKENED PLANE JOINT

FIRST FLUSH DEVICE

SWP

SWS

TOK

TOW

TWL

UPVC

UNO

SV

**SWRM** 

### STORMWATER PIPE BEDDING/PAVING **NOTES:**

WHERE TRENCH BASE IS ROCK A MINIMUM OF 75mm BEDDING TO BE PROVIDED UNDER PIPE COLLARS.

STORMWATER PIPE BEDDING DETAIL TO BE IN ACCORDANCE WITH LOCAL COUNCIL REQUIREMENTS. BEDDING DETAILS TO BE CONFIRMED UPON EXCAVATION & PRIOR TO INSTALLATION OF PIPEWORK.

#### FOOTPATH REINSTATEMENT NOTES:

REMOVE ALL SAND FILL WITHIN THE FOOTPATH AREA TO THE EXISTING SUBGRADE.

SUPPORT ALL AUTHORITY SERVICES TO STRUCTURAL ENGINEERS DETAILS DURING EXCAVATION.

REINSTATE FOOTPATH SUBGRADE.

THE CONTRACTOR SHALL PROVIDE CERTIFICATION OF COMPACTION FROM A NATA REGISTERED TESTING AUTHORITY. MINIMUM THREE TESTS PER LAYER AS FOLLOWS:

SELECT FILL 95% MODIFIED SELECT FILL (LESS THAN 300mm 98% MODIFIED

BELOW BASE COURSE) BASE COURSE

100% MODIFIED

#### **EROSION & SEDIMENT CONTROL NOTES:**

PROVIDE SILT FENCE/HAY BAIL BARRIERS TO THE LOW SIDE OF ALL EXPOSED EARTH EXCAVATIONS (TYPICAL).

ISOLATE EXISTING STORMWATER PITS WITH HAY BALES TO FILTER ALL INCOMING FLOWS.

DO NOT STOCK PILE EXCAVATED MATERIAL ON THE ROAD WAY.

#### SURVEY

THE EXISTING SITE CONDITIONS SHOWN ON THE FOLLOWING DRAWINGS HAVE BEEN INVESTIGATED BY REGISTERED SURVEYORS. THE INFORMATION IS SHOWN TO PROVIDE A BASIS FOR DESIGN. CAPITAL ENGINEERING CONSULTANTS DOES NOT GUARANTEE THE ACCURACY OR COMPLETENESS OF THE SURVEY BASE OR ITS SUITABILITY AS A BASIS FOR CONSTRUCTION DRAW.

SHOULD DISCREPANCIES BE ENCOUNTERED DURING CONSTRUCTION BETWEEN THE SURVEY DATA AND ACTUAL FIELD DATA, CONTACT CAPITAL ENGINEERING CONSULTANTS.

ADOPT DATUM BM CUT IN KERB RL: 13.47 (A.H.D)

SERVICES SHOWN ON PLAN ARE INDICATIVE, EXACT DEPTH AND LOCATION TO BE CONFIRMED ONSITE. CONTRACTOR TO CARRY OUT DIAL BEFORE YOU DIG APPLICATION AND ENGAGE A REGISTERED SURVEYOR TO PEG OUT ALL EXISTING SERVICES PRIOR TO ANY WORK COMMENCING ONSITE.

> IT IS THE BUILDERS RESPONSIBILITY TO MAKE SURE ALL SURVEY MARKS TO BE PRESERVED AT ALL

Chk. App. Description Date H.Y R.F. P.E. 3/12/2020 ISSUED FOR DEVELOPMENT APPLICATION



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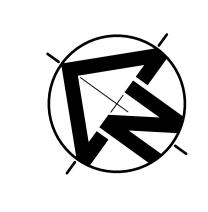
Client

39 CUMBERLAND AVENUE, COLLAROY

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Title

**COVER SHEET** 



Scale

DEVELOPMENT APPLICATION (DA)	Approved

FOR APPROVAL

3/12/2020


Paper Size Datum Drawn Checked Design PAUL EL-BAYEH H.Y R.F. AHD

B.E., M.E., FIEAust, CPEng, NER, RPEQ Date Project Number Drawing Number Revision


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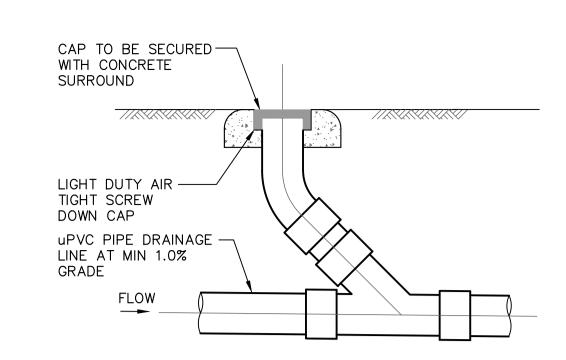
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120




SCALE 1:100

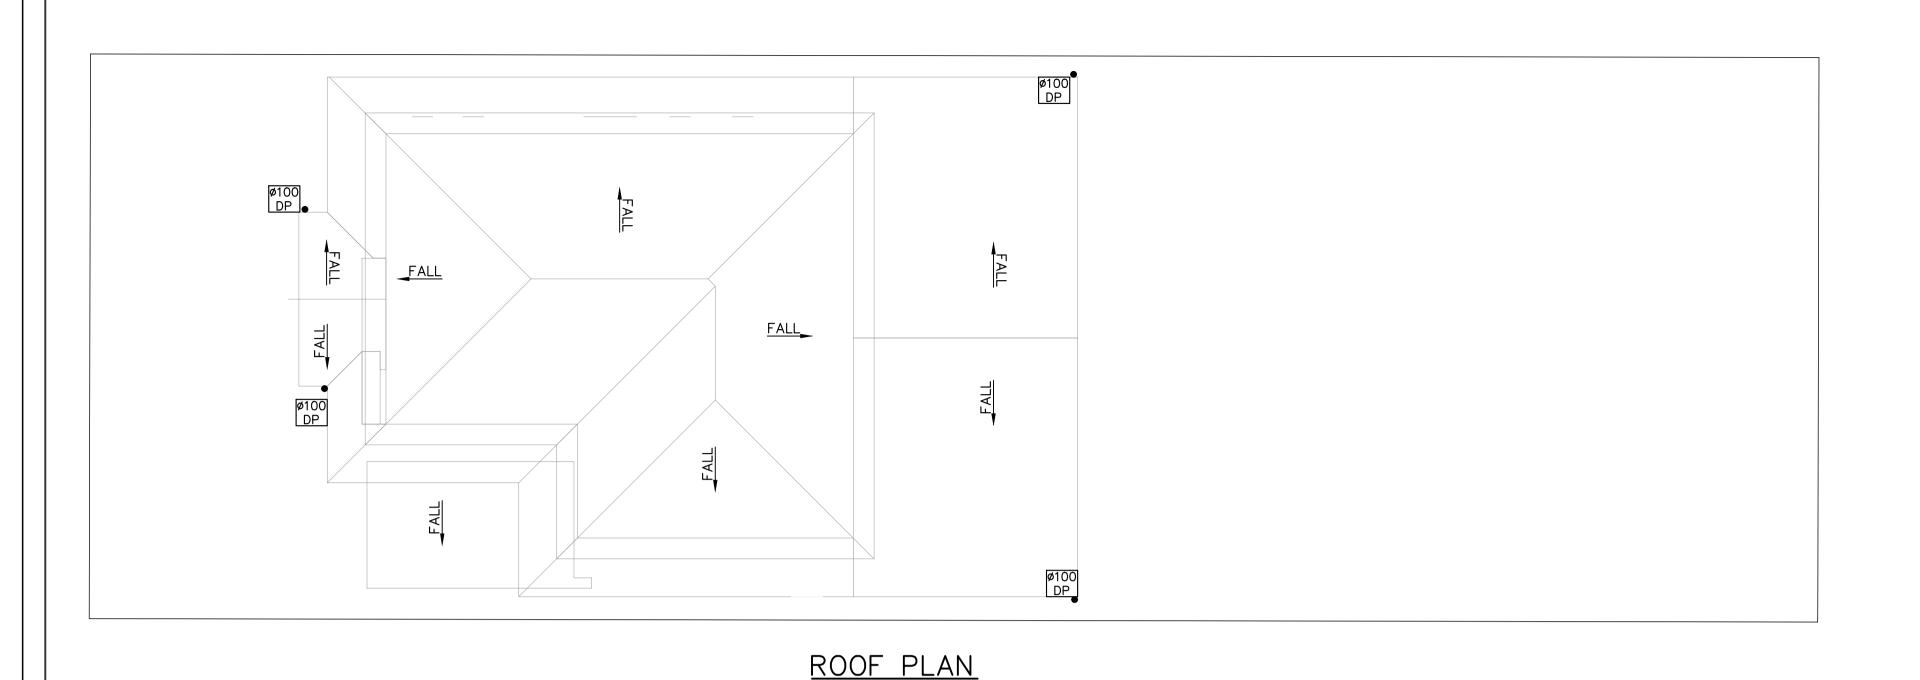

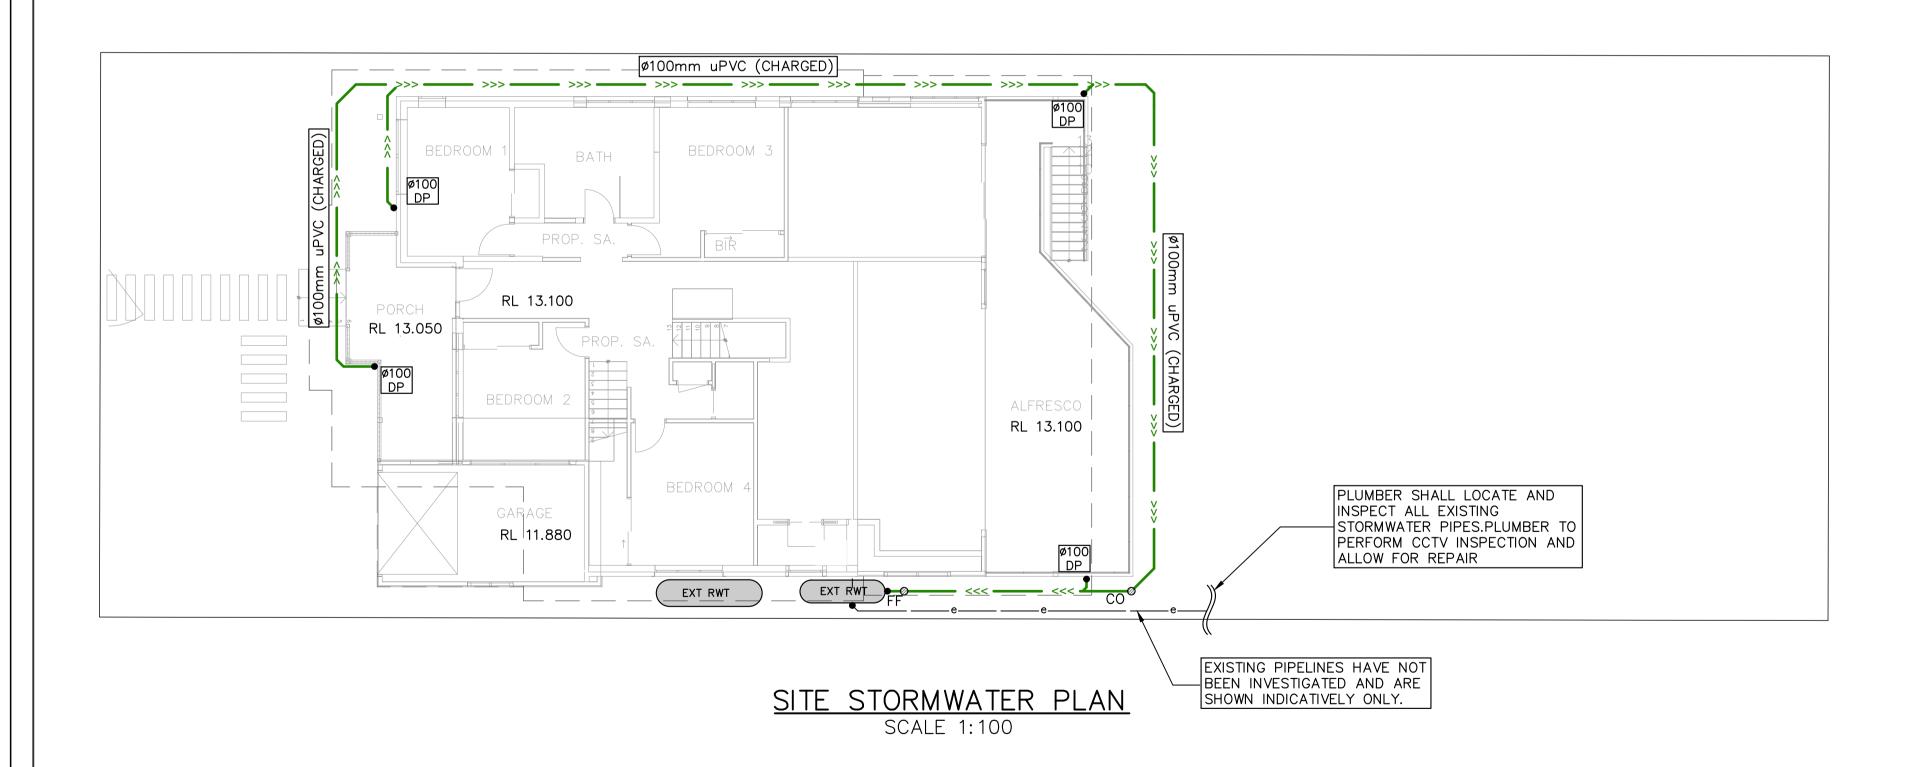

CLEANING EYE DETAIL
SCALE: 1: 20

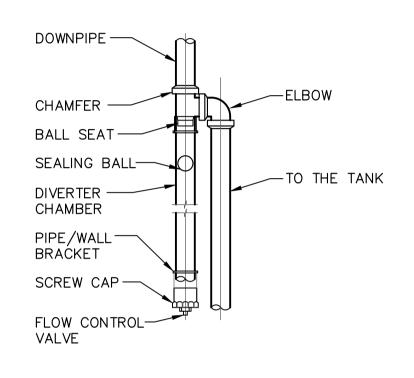

FIRST FLUSH DIVERTER
SCALE: 1:20

## DESIGN NOTES:

ACCORDANCE WITH AS3500.3.

**CHARGED LINES:** 

GUTTER INVERT LEVEL.

FROM THE SUN.

SYSTEM.

ALL CHARGED LINES SHALL BE MIN. 100mm SEWER GRADE uPVC FROM CONNECTION POINT TO THE

ALL EXPOSED PIPEWORK SHALL BE PAINTED IN A

COLOUR TO COMPLIMENT THE DEVELOPMENT AND TO PROTECT AGAINST ULTRA-VIOLET LIGHT DAMAGE

ALL JOINTS WITHIN THE CHARGED SYSTEM MUST BE

CLEAR-OUT POINTS (IN ADDITION TO THOSE SHOWN

ON PLAN) SHALL BE PROVIDED AT 20m INTERVALS

AND AT CRITICAL BENDS WITHIN THE CHARGED

SOLVENT WELDED AND PRESSURE TESTED IN

THE SITE IS LOCATED IN NORTHERN BEACHES COUNCIL.

SITE AREA =  $682.8m^2$  (BY CALC'S)

THE DEVELOPMENT PROPOSAL IS FOR ALTERATIONS AND ADDITIONS TO AN EXISTING DWELLING.

OSD IS NOT REQUIRED AS PER NORTHERN BEACHES COUNCIL WATER MANAGEMENT POLICY


ALL NEW STORMWATER PIPES TO HAVE A MINIMUM OF 100mm CONCRETE OR 300mm TOPSOIL COVER U.N.O.

INSTALL CLEAR OUT FOR INSPECTION AND MAINTENANCE PURPOSES WHERE REQUIRED.


RAINWATER TANK TO BE EQUIPPED WITH FIRST FLUSH AND MOSQUITO PROTECTION DEVICES (REFER DETAIL).

LOCATION OF RAINWATER TANK SHOWN ON PLAN IS INDICATIVE. TO BE CONFIRMED DURING CONSTRUCTION.

ALL STORMWATER PIPES ARE TO BE A MINIMUM OF 600mm CLEAR FROM EXISTING SEWER LINE (TYP).

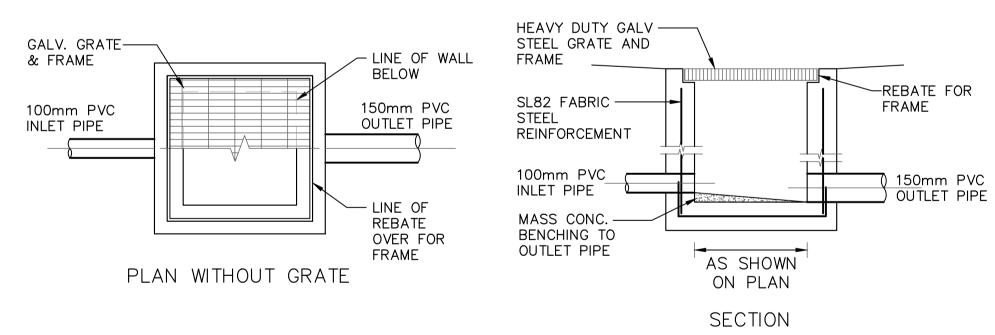

TYPICAL GRATED INLET PIT DETAIL
SCALE: 1: 20

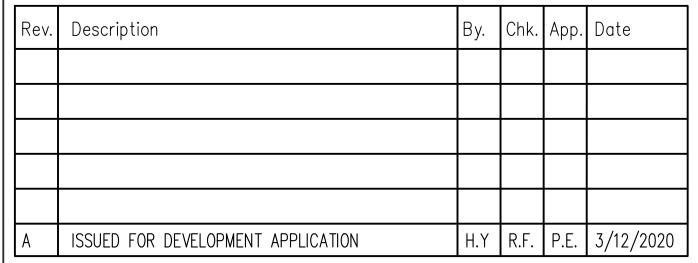



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Project


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SITE STORMWATER PLAN & DETAILS

Title



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	DEVELOPMENT APPLICATION (DA)					Approved	
	FOR APPROV	DR APPROVAL			P.E.		
	Paper Size A1	Design <b>H.Y</b>	Drawn <b>H.Y</b>	Checked R.F.	Datum AHD	PAUL EL-BAYEH B.E., M.E., FIEAust, CPEng, NER, RPEQ	
	Scale 1:100	Date 3/12/	2020	Project N SW20		Drawing Number SW010	Revision A

A1 0 20 40 60 80 100 120 140 160 180 200 220 240 260 280

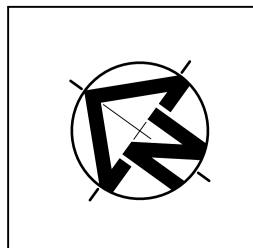